# Port Authority connecting people to life

# PORT AUTHORITY OF ALLEGHENY COUNTY CONTRACT DRAWINGS BUS RAPID TRANSIT (BRT) UPTOWN TO OAKLAND CONSTRUCTION CONTRACT NO. BRT-001

FTA GRANT NO.: PA-2023-002-00

**PROJECT NO.:** CCA-G-22-23-PAAC-00702

CCA-21-22-PAAC-00764 CCA-20-21-PAAC-00715 CAA-19-20-PAAC-00538

**ISSUE DATE:** MAY 1, 2024

# **VOLUME 1 OF 3**

**INDEX OF DRAWINGS** 

INDEX SHEETS

GENERAL NOTES

PROJECT COORDINATES

STATION CONTROL POINTS

SUMMARY AND TABULATIONS

TYPICAL SECTIONS

SPECIAL DETAILS

DRAINAGE DATA & DRAINAGE

PROFILES

INTERSECTION DETAILS & DATA

CIVIL LAYOUT PLANS

REMOVAL AND ADJUSTMENT PLANS


ROADWAY PLANS

**ROADWAY PROFILES** 

KIRKPATRICK ST PARKING LOT

**DETAILS** 

EROSION & SEDIMENTATION CONTROL PLANS

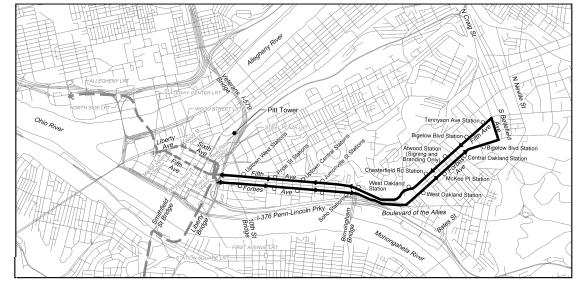

NORTH

LOCATION MAP

CITY OF PITTSBURGH


(NOT FOR CONSTRUCTION)

NORTH
CITY OF
PITTSBURGH
e mossiler many
La tracket
Pin (7 ) The Silver
PROJECT
LOCATION
VICINITY PLAN
VICHNII I ETAIN

NO SCALE

THE PREPARATION OF THESE DRAWINGS HAS BEEN FINANCED, IN PART, THROUGH A GRANT FROM THE U.S. DEPARTMENT OF TRANSPORTATION, FEDERAL TRANSIT ADMINISTRATION, UNDER THE URBAN MASS TRANSPORTATION ACT OF 1964, AS AMENDED.

		APPROVAL	DATE
ARED BY: <b>AECOM</b>	AECOM		
Gulf Tower 707 Grant Street 5th Floor		ASSISTANT DIRECTOR OF PLANNING, POLICY AND PERMITTING	
Pittsburgh, PA 15219	Project Manager Date REGISTERED PROFESSIONAL ENGINEER, PENNSYLVANIA	MUNICIPAL TRAFFIC ENGINEER	
	PORT AUTHORITY OF ALLEGHENY COUNTY	CHIEF ENGINEER	
		- CHIEF ENGINEER	
	Approved Date CHIEF ENGINEER - ENGINEERING AND TECHNICAL SUPPORT	DIRECTOR	

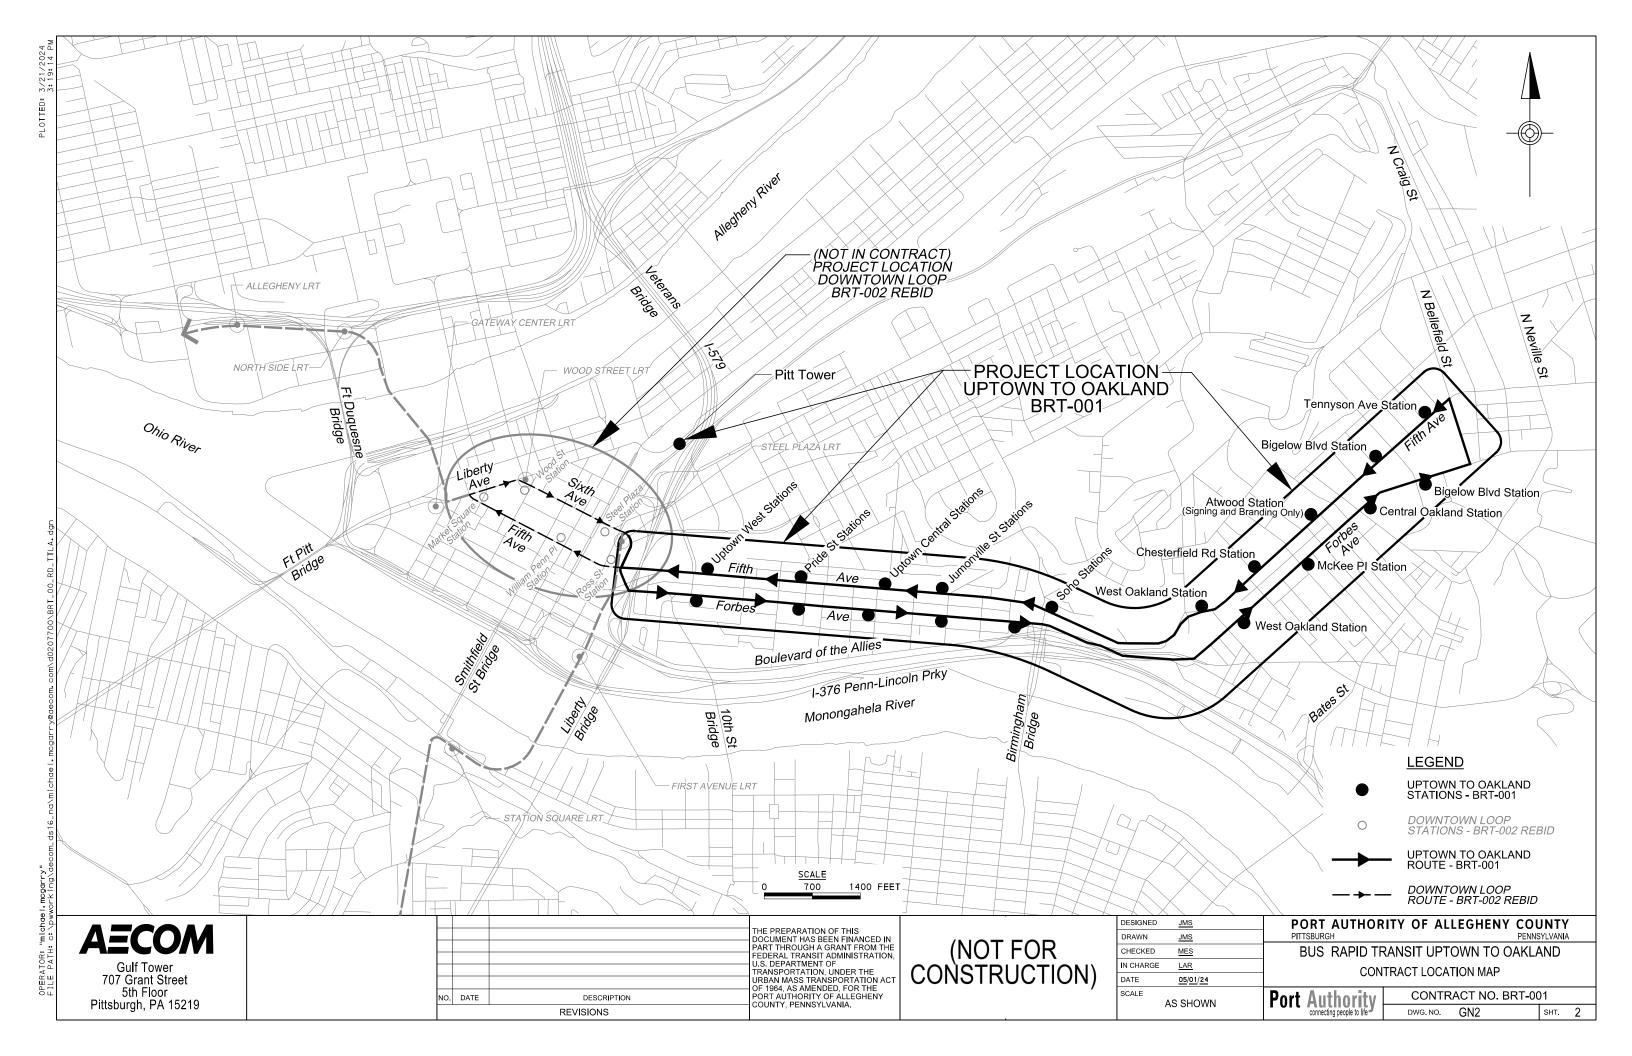

GENERAL NOTES/ABBREVIATIONS/SYMBOLOGY SHEETS  BN21 21 AND STANDARD DATAINOS  BN22 22 LIST OF PUBLICATIONS  BN21 21 AND STANDARD DATAINOS  BN22 22 LIST OF PUBLICATIONS  BN23 23 STANDARD CARRESTIATIONS  BN24 24 STANDARD ABBREVIATIONS  BN25 25 STANDARD CURVE DATA AND SURVEY TERMS  BN26 25 STANDARD CURVE DATA AND SURVEY TERMS  BN27 27 STANDARD SYMBOLOGY  BN27 27 STANDARD SYMBOLOGY  BN28 25 ROADBAY TABULATION SHEET  BN26 26 STANDARD SYMBOLOGY  BN26 26 STANDARD SYMBOLOGY  BN27 27 STANDARD SYMBOLOGY  BN27 27 STANDARD SYMBOLOGY  BN27 27 STANDARD SYMBOLOGY  BN28 25 ROADBAY TABULATION SHEET  BN28 25 ROADBAY TABULATION SHEET  BN27 27 STANDARD SYMBOLOGY  BN27 27 STANDARD SYMBOLOGY  BN27 27 STANDARD SYMBOLOGY  BN28 25 ROADBAY TABULATION SHEET  BN28 25 STANDARD SYMBOLOGY  BN28 25 ROADBAY TABULATION SHEET  BN29 25 ROADBAY TAB	DRAWING NUMBER	SHEET NUMBER	TITLE	DRAWING NUMBER	SHEET NUMBER	TITLE	DRAWING NUMBER	SHEET NUMBE	R TITLE		DRAWING NUMBER	SHEET NUMBER	TITLE
1			GENERAL PLANS			PROJECT COORDINATES		SUM	MMARY / TABULATION SHEETS	(CONT'D)			TYPICAL SECTIONS (CONT'D)
### 1	GN1	1		GN28	28	PROJECT COORDINATES FIFTH AVE, FORBES AVE AND SIDE STRE	ETS GN55	55	ROADWAY TABULATION SHEET -	· TOTALS	CV9	84	TYPICAL SECTIONS FIFTH AVE / BIRMINGHAM BRIDGE TO SUNSHINE
The control	GN2	2	CONTRACT LOCATION MAP	GN29	29		GN56	56	ROADWAY TABULATION SHEET -	- TOTALS	CV10	85	
20 1 102 0 10 102 0 10 10 10 10 10 10 10 10 10 10 10 10 1	GN3	3	INDEX OF DRAWINGS				GN57	57	ROADWAY TABULATION SHEET -	- TOTALS	CV11	86	TYPICAL SECTIONS FIFTH AVE / BLVD OF THE ALLIES TO CRAFT ST
Part	GN4	4	INDEX OF DRAWINGS			STATION CONTROL POINTS	GN58	58	DRAINAGE TABULATION SH	HEET	CV12	87	
Page	GN5	5	INDEX OF DRAWINGS	GN30	30		GN59	59	DRAINAGE TABULATION SH	IEET	CV13	88	TYPICAL SECTIONS FIFTH AVE / HALKET ST TO MCKEE PL
ABSTRACE   1997   199	GN6	6	INDEX OF DRAWINGS	GN31	31		ATION GN60	60	DRAINAGE TABULATION SH	IEET	CV14	89	TYPICAL SECTIONS FIFTH AVE / MCKEE PL TO BOUQUET ST
99 \$ 3005 0 FORMAND 31570 6 SHEWE \$5 \$77120 50 5 BRANCH SHEWE \$5 \$1100 50 5 FORMAND 31570 6 SHEWE \$5 \$77120 50 5 BRANCH SHEWE \$5 \$1100 50 5 FORMAND 31570 6 SHEWE \$5 \$77120 50 5 FORMAND 31570	GN7	7	INDEX OF DRAWINGS	GN32	32		ON GN61	61	DRAINAGE TABULATION SH	IEET	CV15	90	TYPICAL SECTIONS FIFTH AVE BOUQUET ST TO BIGELOW BLVD
ARCO STATUS	GN8	8	INDEX OF DRAWINGS	GN33	33		STATION GN62	62	DRAINAGE TABULATION SH	IEET	CV16	91	TYPICAL SECTIONS FIFTH AVE / BIGELOW BLVD TO LYTTON AVE
Col.   1	GN9	9	INDEX OF DRAWINGS	GN34	34	STATION CONTROL POINTS ATWOOD STATION & BIGELOW BLVD STAT	ION GN63	63	DRAINAGE TABULATION SH	IEET	CV17	92	
Direct   D	GN10	10	INDEX OF DRAWINGS	GN35	35		GN64	64	DRAINAGE TABULATION SH	IEET	CV18	93	
1013   13	GN11	11	INDEX OF DRAWINGS	GN36	36	STATION CONTROL POINTS UPTOWN WEST STATION & PRIDE ST STAT	ION GN65	65	DRAINAGE TABULATION SH	IEET	CV19	94	
11   1   1   1   1   1   1   1   1	GN12	12	INDEX OF DRAWINGS	GN37	37	STATION CONTROL POINTS UPTOWN CENTRAL STATION & JUMONVILLE ST	STATION GN66	66	DRAINAGE TABULATION SH	IEET	CV20	95	
Section   Sect	GN13	13	INDEX OF DRAWINGS	GN38	38		ION GN67	67	DRAINAGE TABULATION SH	IEET	CV21	96	
Display   15   Color of Dearwines   15   C	GN14	14	INDEX OF DRAWINGS	GN39	39	STATION CONTROL POINTS MCKEE PLACE STATION & CENTRAL OAKLAND S	STATION GN68	68	DRAINAGE TABULATION SH	IEET	CV22	97	
OUIT 17 DOWNTON TO UPTONS OUIT 17 DOWNTON TO UPTON TO UPTO	GN15	15	INDEX OF DRAWINGS	GN40	40		GN69	69	DRAINAGE TABULATION SH	HEET	CV23	98	
DOWNTOWN TO LETTOWN   STILE ROAD   STILE R	GN16	16	INDEX OF DRAWINGS				GN70	70	DRAINAGE TABULATION SH	IEET	CV24	99	
Color   Colo	GN17	17				SUMMARY / TABULATION SHEE	GN71	71	DRAINAGE TABULATION SH	HEET	CV25	100	
CHARGE   19   19   19   19   19   19   19   1	GN18	18		GN41	41	SUMMARY OF QUANTITIES	GN72	72	DRAINAGE TABULATION SH	IEET	CV26	101	TYPICAL SECTIONS PRIDE ST
STANDARD CARRY TERMS   SUMMARY OF QUANTITIES   ONTO 75   DRAINING TABULATION SHEET   TOTALS   CV23   104   STANDARD CARRY STANDARD CARRY   SUMMARY OF QUANTITIES   ONTO 75   DRAINING TABULATION SHEET   TOTALS   CV30   105   TYPICAL SECTIONS   CV30	GN19	19		GN42	42	SUMMARY OF QUANTITIES	GN73	73	DRAINAGE TABULATION SH	HEET	CV27	102	
CENERAL NOTES / ABBREVIATIONS / SYMBOLOGY SHEETS ON2 2 1 AUDITOR SYMBOLOGY SHEETS ON2 2 2 LIST OF PUBLIC UTILITIES AND PA ONE CALLS ON3 2 STANDARD ABBREVIATIONS ON46 46 ROADMAY TABULATION SHEET ON2 1 1 FIFTH AVE / LOADMAY TO CHARMS STANDARD ABBREVIATIONS ON46 46 ROADMAY TABULATION SHEET ON2 1 1 TYPICAL SECTIONS ON46 47 ROADMAY TABULATION SHEET ON2 2 2 LIST OF PUBLIC UTILITIES AND PA ONE CALLS ON47 47 ROADMAY TABULATION SHEET ON48 49 ROADMAY TABULATION SHEET ON49 49 ROADMAY TABULATION SHEET ON49 5 STANDARD ABBREVIATIONS ON49 49 ROADMAY TABULATION SHEET ON49 5 STANDARD SURVEY TERMS ON40 5 STANDARD CURVE DATA AND SURVEY TERMS ON50 50 ROADMAY TABULATION SHEET ON50 5 STANDARD SYMBOLOGY ON50 5 ROADMAY TABULATION SHEET ON50 5 ROADM	GN20	20		GN43	43	SUMMARY OF QUANTITIES	GN74	74	DRAINAGE TABULATION SHEET	- TOTALS	CV28	103	
Column	900			GN44	44	SUMMARY OF QUANTITIES	GN75	75	DRAINAGE TABULATION SHEET	- TOTALS	CV29	104	TYPICAL SECTIONS SR 2085 BIRMINGHAM BRIDGE AND BELLEFIELD AVE
ARCOMAN   1	GENE	RAL NO	TES/ABBREVIATIONS/SYMBOLOGY SHEETS	GN45	45	SUMMARY OF QUANTITIES					CV30	105	
CM23   23   STANDARD ABBREVIATIONS   CM24   24   STANDARD ABBREVIATIONS   CM24   24   STANDARD ABBREVIATIONS   CM34   39   ROADWAY TABULATION SHEET   CV3   78   F1FTH AVE / MODEL SET TO PRIDE ST   CV34   109   TYPICAL SECTIONS PORCES AVE   CM25   25   STANDARD CURVE DATA AND SURVEY TERMS   CM50   50   ROADWAY TABULATION SHEET   CV4   79   F1FTH AVE / MODEL SET TO DININIDDIE ST   CV35   110   TYPICAL SECTIONS PORCES AVE   CM26   STANDARD SYMBOLOGY   CM52   52   ROADWAY TABULATION SHEET   CV5   80   F1FTH AVE / F7TICE ST TO DININIDDIE ST   CV36   111   TYPICAL SECTIONS PORCES AVE   CM50   CM50   STANDARD SYMBOLOGY   CM52   52   ROADWAY TABULATION SHEET   CV6   81   F1FTH AVE / MODEL SECTIONS   CM50   STANDARD SYMBOLOGY   CM52   52   ROADWAY TABULATION SHEET   CV6   81   F1FTH AVE / MODEL SECTIONS   CM50   STANDARD SYMBOLOGY   CM52   52   ROADWAY TABULATION SHEET   CV6   81   F1FTH AVE / CM10   CM50	GN21	21	AND STANDARD DRAWINGS	GN46	46	ROADWAY TABULATION SHEET			TYPICAL SECTION	NS	CV31	106	
GN24 24 STANDARD ABBREVIATIONS GN39 49 ROADWAY TABULATION SHEET GN25 25 STANDARD CURVE DATA AND SURVEY TERMS GN30 50 ROADWAY TABULATION SHEET GN32 26 STANDARD SYMBOLOGY GN31 51 ROADWAY TABULATION SHEET GN32 27 STANDARD SYMBOLOGY GN32 33 ROADWAY TABULATION SHEET GN32 34 ROADWAY TABULATION SHEET GN32 35 ROADWAY TABULATION SHEET GN32 36 STANDARD SYMBOLOGY GN30 35 ROADWAY TABULATION SHEET GN30 50	GN22	22		GN47	47	ROADWAY TABULATION SHEET	CV1	76	TYPICAL SECTIONS FIFTH AVE / DIAMAND ST TO C	CHATAM SQ	CV32	107	FORBES AVE
ONZ 25 STANDARD CURVE DATA AND SURVEY TERMS ONS 0 50 ROADWAY TABULATION SHEET ONZ 25 STANDARD SYMBOLOGY ONS 1 51 ROADWAY TABULATION SHEET ONZ 27 STANDARD SYMBOLOGY ONS 2 52 ROADWAY TABULATION SHEET ONS 25 STANDARD SYMBOLOGY ONS 2 52 ROADWAY TABULATION SHEET ONS 25 STANDARD SYMBOLOGY ONS 2 52 ROADWAY TABULATION SHEET ONS 2 52 ROADWAY TABULATION SHEET ONS 2 52 ROADWAY TABULATION SHEET ONS 3 53 ROADWAY TABULATION SHEET ONS 3 53 ROADWAY TABULATION SHEET ONS 3 54 ROADWAY TABULATION SHEET ONS 3 55 ROADWAY TABULATION SHEET ONS 3 56 ROADWAY TABULATION SHEET ONS 3 57 ROADWAY TABULATION SHEET ONS 3 57 ROADWAY TABULATION SHEET ONS 3 58 FIFTH AVE / CHICANE AND MOULTRIE ST ONS 3 59 ROADWAY TABULATION SHEET ONS 3 50 ROADWAY TABULATION SHEET ONS 5 FIFTH AVE / CHICANE AND MOULTRIE ST ONS 5 FIFTH AVE / MOULTRIE ST ONS 5 FIFTH AVE / MOULTRIE ST ONS 5 FORBES AVE   ABCOM  ONS 5 FIFTH AVE / MOULTRIE ST ONS 5 FORBES AVE  ONS 5 FORBES AVE  ONS 5 FORBES AVE  ONS 5 FORBES AVE  ONS 5 FORBES AVE ONS 5 FORBES AVE  ONS 5 FORBES AVE ONS 5 F	GN23	23		GN48	48	ROADWAY TABULATION SHEET	CV2	77	TYPICAL SECTIONS FIFTH AVE / CHATHAM SQ TO	MAGEE ST	CV33	108	TYPICAL SECTIONS FORBES AVE
AECOM  Gulf Tower 707 Grant Street  Gulf Towe	GN24	24		GN49	49	ROADWAY TABULATION SHEET	CV3	78	TYPICAL SECTIONS FIFTH AVE / MAGEE ST TO P	RIDE ST	CV34	109	TYPICAL SECTIONS FORBES AVE
AECOM  Gulf Tower 707 Grant Street  Gulf Tower 707 Grant Street  Gulf Tower 707 Grant Street  StanDard Symbology  Gulf Tower 707 Grant Street  Gulf Tower 707 Grant Street  Gulf Tower 707 Grant Street  StanDard Street  Gulf Tower 707 Grant Street  Gulf Tower 990124  Gulf Tower 990124  FORT Authority Of Allegheny Country  Fort Street 990124  FORT Authority Control of 1984 As Makened Exp Fort Hills  For Street 1008 Fights As Makened Exp Fort Hills  For Street 1008 Fights As Makened Exp Fort Hills  For Street 1008 Fights As Makened Exp Fort Hills  For Street 1008 Fights As Makened Exp Fort Hills  For Street 1008 Fights As Makened Exp Fort Hills  For Street 1008 Fights As Makened Exp Fort Hills  For Street 1008 Fights As Makened Exp Fort Hills  For Street 1008 Fights As Makened Exp Fort Hills  For Street 1008 Fights As Makened Exp Fort Hills  For Street 1008 Fights As Makened Exp Fort Hills  For Street 1008 Fights As Makened Exp Fort Hills  For Street 1008 Fights As Makened Exp Fort Hills  For Street 1008 Fights As Makened Exp Fort Hills  For Street 1008 Fights As Makened Exp Fort Hills  For Street 1008 Fights As Makened Exp Fort Hills  For Street 1008 Fights As Makened Exp Fort Hills  For Street 1008 Fights A	GN25	25	STANDARD CURVE DATA AND SURVEY TERMS	GN50	50	ROADWAY TABULATION SHEET	CV4	79	TYPICAL SECTIONS FIFTH AVE / MAGEE ST TO P	RIDE ST	CV35	110	TYPICAL SECTIONS FORBES AVE
GN53 53 ROADWAY TABULATION SHEET  CV7 82 FIFTH AVE / CHICANE AND MOULTRIE ST  GN54 54 ROADWAY TABULATION SHEET  CV8 83 FIFTH AVE / CHICANE AND MOULTRIE ST  TYPICAL SECTIONS FORBES AVE  TYPICAL SECTIONS FORBES AVE  CV38 113 TYPICAL SECTIONS FORBES AVE  CV38 114 TYPICAL SECTIONS FORBES AVE  TYPICAL SECTIONS FORBES AVE  CV39 114 TYPICAL SECTIONS FORBES AVE  CV39 114 TYPICAL SECTIONS FORBES AVE  TYPICAL SECTIONS FORBES AVE  CV39 114 TYPICAL SECTIONS	GN26	26	STANDARD SYMBOLOGY	GN5 1	51	ROADWAY TABULATION SHEET	CV5	80	TYPICAL SECTIONS FIFTH AVE / PRIDE ST TO DIN	WIDDIE ST	CV36	111	
AECOM  Gulf Tower  707 Grant Street  5th Floor  GNS 53  ROADWAY TABULATION SHEET  CV8 83  ROADWAY TABULATION SHEET  CV8 83  FIFTH AVE / CHICANE AND MOULTRIE ST  TYPICAL SECTIONS  FORBES AVE  CV39  114  TYPICAL SECTIONS  TYPICAL SECTIONS  TYPICAL SECTIONS  TYPICAL SECTIONS  TYPICAL SECTIONS  TYPICAL SECTIONS  TYPICAL SECTIO	GN27	27	STANDARD SYMBOLOGY	GN52	52	ROADWAY TABULATION SHEET	CV6	81	TYPICAL SECTIONS FIFTH AVE AT CHICAN	E	CV37	112	FORBES AVE
AECOM  Gulf Tower 707 Grant Street 5th Floor  THE PREPARATION OF THIS DOCUMENT HAS BEEN FINANCED IN PART HARDING MAN BRIDGE  THE PREPARATION OF THIS DOCUMENT HAS BEEN FINANCED IN PART HARDING MAN STRANSPORTATION, UNDER THE URBAN MASS TRANSPORTATION, UNDER THE URBAN MASS TRANSPORTATION, UNDER THE URBAN MASS TRANSPORTATION UNDER THE URBAN MASS TRANSPORTATION AND FORTH URBAN MASS TRANSPORTA	SD III			GN53	53	ROADWAY TABULATION SHEET	CV7	82		JLTRIE ST	CV38	113	
Gulf Tower 707 Grant Street 5th Floor  The Preparation of Final Ced in Document has been financed in Part Thansit administration, Under the Construction of Transportation act 10 of the Street 1	7097			GN54	54	ROADWAY TABULATION SHEET	CV8	83	TYPICAL SECTIONS FIFTH AVE / MOULTRIE ST TO BIRM	INGHAM BRIDGE	CV39	114	TYPICAL SECTIONS FORBES AVE
AECOM  Gulf Tower 707 Grant Street 5th Floor  The PREPARAI FROM THE DESCRIPTION  GULF TOWER THAN SET THROUGH A GRANT FROM THE PEDERAL TRANSIT ADMINISTRATION, UNDER THE OF THE TRANSIT STRUCK TOWER THROUGH A GRANT FROM THE STRUCK THROUGH A GRANT FROM	Z												
AECOM  Gulf Tower 707 Grant Street 5th Floor  The PREPARAI FROM THE DESCRIPTION  GULF TOWER THAN SET THROUGH A GRANT FROM THE PEDERAL TRANSIT ADMINISTRATION, UNDER THE OF THE TRANSIT STRUCK TOWER THROUGH A GRANT FROM THE STRUCK THROUGH A GRANT FROM	low d							1	<u>.</u>	DESIGNED JMS		D.C.	DT AUTHODITY OF ALLEGUENY COUNTY
Gulf Tower 707 Grant Street 5th Floor  Gulf Tower 708 Grant Street 5th Floor  Gulf Tower 709 Grant Street 5th Floor  Gulf Tower 709 Grant Street 5th Floor  Gulf Tower 707 Grant Street 5th Floor  Gulf Tower 708 Grant Street 708 Grant Street 709 Grant Street 700		EC	OM			DOC	CUMENT HAS BEEN FINANCE		(NOT FOD	DRAWN JMS		PITTS	SBURGH PENNSYLVANIA
707 Grant Street    Total Contract   Contrac						FED U.S.	ERAL TRANSIT ADMINISTRA DEPARTMENT OF	TION,				BI	
		707 Grant	Street			URB OF 1	BAN MASS TRANSPORTATION 1964. AS AMENDED, FOR THE	E I	CONSTRUCTION)			Desi	
REVISIONS Connecting people to life DWG. NO. GN3 SHT.	Pit			NO. DATE		COL	RT AUTHORITY OF ALLEGHEI JNTY, PENNSYLVANIA.	INY		AS SHOWN	I	Port /	GULIIVIIIV

DRAWI DRAWI		HEET JMBER	TITLE	DRAWING NUMBER	SHEET NUMBER	TITLE	DRAWING NUMBER	SHEET NUMBEI		DRAWIN NUMBE		TITLE
) ) ]			TYPICAL SECTIONS (CONT'D)			SPECIAL DETAILS (CONT'	D)		DRAINAGE PROFILES (	CONT' D)		INTERSECTION DETAILS (CONT'D)
CV4	0 1	115	TYPICAL SECTIONS FORBES AVE	CV69	144	SPECIAL DETAILS PWSA - LARGE DIAMETER SEWER CONNEC	CTION CV96	171	DRAINAGE PROFILES DRAINAGE STRUCTURES		200	INTERSECTION DATA FIFTH AVE & JUMONVILLE ST/WYANDOTTE ST
CV4	1 1	116	TYPICAL SECTIONS FORBES AVE				CV97	172	DRAINAGE PROFILES DRAINAGE STRUCTURES GO5	1025	201	INTERSECTION DETAILS FIFTH AVE & SENECA ST
CV4	2 1	117	TYPICAL SECTIONS FORBES AVE			DRAINAGE DATA SHEETS	CV98	173	DRAINAGE PROFILES DRAINAGE STRUCTURES GO6	1036	202	INTERSECTION DATA FIFTH AVE & SENECA ST
CV4	3 1	118	TYPICAL SECTIONS FORBES AVE	CV70	145	DRAINAGE DATA DRAINAGE STRUCTURES A14 - A16	CV99	174	DRAINAGE PROFILES DRAINAGE STRUCTURES GO7	1027	203	INTERSECTION DETAILS FIFTH AVE & MOULTRIE ST
CV4	4 1	119	TYPICAL SECTIONS FORBES AVE	CV71	146	DRAINAGE DATA DRAINAGE STRUCTURES A16 - A18	CV100	175	DRAINAGE PROFILES DRAINAGE STRUCTURES GO9		204	INTERSECTION DATA FIFTH AVE & MOULTRIE ST
CV4	5 12	120	TYPICAL SECTIONS FORBES AVE	CV72	147	DRAINAGE DATA DRAINAGE STRUCTURES A19- A20	CV101	176	DRAINAGE PROFILES DRAINAGE STRUCTURES G11		205	INTERSECTION DETAILS FIFTH AVE & KIRKPATRICK ST/BIRMINGHAM BR
CV4	6 1:	121	TYPICAL SECTIONS MARION ST AND JUMONVILLE ST	CV73	148	DRAINAGE DATA DRAINAGE STRUCTURES A21 - A22	:			ID30	206	INTERSECTION DATA FIFTH AVE & KIRKPATRICK ST/BIRMINGHAM BR
				CV74	149	DRAINAGE DATA DRAINAGE STRUCTURES A23 - A25	i		INTERSECTION DET	AILS ID31	207	INTERSECTION DATA FIFTH AVE & KIRKPATRICK ST/BIRMINGHAM BR
			SPECIAL DETAILS	CV75	150	DRAINAGE DATA DRAINAGE STRUCTURES A25 - A28	ID1	177	INTERSECTION DETAIL FIFTH AVE & DIAMOND		208	INTERSECTION DETAILS FIFTH AVE & BLVD OF THE ALLIES RAMP
CV4	7 13	122	SPECIAL DETAILS DRIVEWAY APRON & CONCRETE BUFFER	CV76	151	DRAINAGE DATA DRAINAGE STRUCTURES A29 - A35	ID2	178	INTERSECTION DATA FIFTH AVE & DIAMOND		209	INTERSECTION DATA FIFTH AVE & BLVD OF THE ALLIES RAMP
CV4	8 12	123	SPECIAL DETAILS CONCRETE AND GRANITE CURB	CV77	152	DRAINAGE DATA DRAINAGE STRUCTURES A36 - A38	ID3	179	INTERSECTION DETAIL FIFTH AVE & CHATHAM SQ/WASH		210	INTERSECTION DETAILS FIFTH AVE & CRAFT AVE
CV4	9 1:	124	SPECIAL DETAILS REINFORCED CONCRETE SIDEWALK AND JOINTS	CV78	153	DRAINAGE DATA DRAINAGE STRUCTURES GO1 - GO6	ID4	180	INTERSECTION DATA FIFTH AVE & CHATHAM SQ/WASH		211	INTERSECTION DATA FIFTH AVE & CRAFT AVE
CV5	0 12	125	SPECIAL DETAILS ISLAND REMOVAL / PAVEMENT PATCHING	CV79	154	DRAINAGE DATA DRAINAGE STRUCTURES GO6 - G11	ID5	181	INTERSECTION DETAIL FIFTH AVE & MAGEE S		212	INTERSECTION DETAILS FIFTH AVE & HALKET ST/CHESTERFIELD RD
CV5	1 12	126	SPECIAL DETAILS SIDEWALK CUT THROUGH	CV80	155	DRAINAGE DATA DRAINAGE STRUCTURES G11 - G21	ID6	182	INTERSECTION DATA FIFTH AVE & MAGEE S		213	INTERSECTION DATA FIFTH AVE & HALKET ST/CHESTERFIELD RD
CV5	2 13	127	SPECIAL DETAILS DIRECTIONAL INDICATOR	CV81	156	DRAINAGE DATA TRENCH DRAIN DATA TABLE	ID7	183	INTERSECTION DETAIL FIFTH AVE & LOGAN S	ST ID38	214	INTERSECTION DETAILS FIFTH AVE & MCKEE PL/DARRAGH ST
CV5	3 12	128	SPECIAL DETAILS SURVEY MONUMENT & BRICK SURFACING				ID8	184	INTERSECTION DATA FIFTH AVE & LOGAN S	ST ID3a	215	INTERSECTION DATA FIFTH AVE & MCKEE PL/DARRAGH ST
Бр CV5	4 12	129	SPECIAL DETAILS SUBGRADE UNDERCUT / TRENCH RESTORATION			DRAINAGE PROFILES	ID9	185	INTERSECTION DETAIL FIFTH AVE & STEVENSON	1 ST 1040	216	INTERSECTION DETAILS FIFTH AVE & LOTHROP ST/MEYRAN AVE
CV5	5 13	130	SPECIAL DETAILS REMOVABLE CURB	CV82	157	DRAINAGE PROFILES DRAINAGE STRUCTURES A14 - A15	ID10	186	INTERSECTION DATA FIFTH AVE & STEVENSON	I ST	217	INTERSECTION DATA FIFTH AVE & LOTHROP ST/MEYRAN AVE
CV5	6 1	131	SPECIAL DETAILS PWSA - MANHOLE FRAME CASTINGS	CV83	158	DRAINAGE PROFILES DRAINAGE STRUCTURES A15 - A16	ID11	187	INTERSECTION DETAIL FIFTH AVE & PRIDE S	ST   1042	218	INTERSECTION DETAILS FIFTH AVE & ATWOOD ST
CV2	7 1:	132	SPECIAL DETAILS PWSA - MANHOLE FRAME & COVER CASTINGS	CV84	159	DRAINAGE PROFILES DRAINAGE STRUCTURES A16 - A17	ID12	188	INTERSECTION DATA FIFTH AVE & PRIDE S	ST   1043	219	INTERSECTION DATA FIFTH AVE & ATWOOD ST
CV5	8 13	133	SPECIAL DETAILS PWSA - TRENCH IN SIDEWALK & TRENCH REPAVING	CV85	160	DRAINAGE PROFILES DRAINAGE STRUCTURES A17 - A19	ID13	189	INTERSECTION DETAIL FIFTH AVE & MARION ST/V	INE ST	220	INTERSECTION DETAILS FIFTH AVE & OAKLAND AVE/DE SOTO ST
CV5	9 13	134	SPECIAL DETAILS PWSA - PIPE REINFORCEMENT & CIP MH INVERT	CV86	161	DRAINAGE PROFILES DRAINAGE STRUCTURES A19 - A20	ID14	190	INTERSECTION DATA FIFTH AVE & MARION ST/V	INE ST	221	INTERSECTION DATA FIFTH AVE & OAKLAND AVE/DE SOTO ST
CV6	0 13	135	SPECIAL DETAILS PWSA - MANHOLES	CV87	162	DRAINAGE PROFILES DRAINAGE STRUCTURES A20 - A23	ID15	191	INTERSECTION DETAIL FIFTH AVE & VAN BRAAM	1046	222	INTERSECTION DETAILS FIFTH AVE & BOUQUET ST
CV6	1 13	136	SPECIAL DETAILS PWSA - MANHOLE STEPS / INLET FRAME & GRATE	CV88	163	DRAINAGE PROFILES DRAINAGE STRUCTURES A20	ID16	192	INTERSECTION DATA FIFTH AVE & VAN BRAAM	1 ST 1047	223	INTERSECTION DATA FIFTH AVE & BOUQUET ST
CV6	2 1	137	SPECIAL DETAILS PWSA - CATCH BASIN TYPE 13	CV89	164	DRAINAGE PROFILES DRAINAGE STRUCTURES A24 - A25	ID17	193	INTERSECTION DETAIL FIFTH AVE & MILTENBERG	ER ST	224	INTERSECTION DETAILS FIFTH AVE & THACKERY AVE
CV6	3 1.	138	SPECIAL DETAILS PWSA - CATCH BASINS TYPE 13 MODIFIED	CV90	165	DRAINAGE PROFILES DRAINAGE STRUCTURES A25 - A26	ID18	194	INTERSECTION DATA FIFTH AVE & MILTENBERG	ER ST	225	INTERSECTION DATA FIFTH AVE & THACKERY AVE
eph.	4 13	139	SPECIAL DETAILS TRENCH DRAIN	CV91	166	DRAINAGE PROFILES DRAINAGE STRUCTURES A27 - A28	ID19	195	INTERSECTION DETAIL FIFTH AVE & DINNWIDDI	E ST	226	INTERSECTION DETAILS FIFTH AVE & BIGELOW BLVD
cve	5 14	140	SPECIAL DETAILS THROUGH CURB RAIN LEADER	CV92	167	DRAINAGE PROFILES DRAINAGE STRUCTURES A29 - A34	ID20	196	INTERSECTION DATA	E ST	227	INTERSECTION DATA FIFTH AVE & BIGELOW BLVD
S16_7	6 1	141	SPECIAL DETAILS PWSA - WYE CONTROL  SPECIAL DETAILS	CV93	168	DRAINAGE PROFILES DRAINAGE STRUCTURES A36 - A38		197	INTERSECTION DETAIL FIFTH AVE & GIST S'	T   1032	228	INTERSECTION DETAILS FIFTH AVE & LYTTON AVE
₽ CV6	7 1.	142	SPECIAL DETAILS RECESSED CATCH BASIN CONVERSION	CV94	169	DRAINAGE PROFILES DRAINAGE STRUCTURES GO1 - GO2		198	INTERSECTION DATA FIFTH AVE & GIST S'	T   1033	229	INTERSECTION DATA FIFTH AVE & LYTTON AVE
CV6	8 1	143	SPECIAL DETAILS PIPE FIELD COLLAR & PWSA - CONCRETE PLUG	CV95	170	DRAINAGE PROFILES DRAINAGE STRUCTURES GO4 - GO5	ID23	199	INTERSECTION DETAIL FIFTH AVE & JUMONVILLE ST/WY	YANDOTTE ST ID54	230	INTERSECTION DETAILS FIFTH AVE & TENNYSON AVE
ork ing												
ž d			NA.4			71	HE PREPARATION OF THIS			DESIGNED JMS		RT AUTHORITY OF ALLEGHENY COUNTY
,ö <u> </u>	4=		DM			D. D.	HE FREFARTION OF THIS OCUMENT HAS BEEN FINANCE ART THROUGH A GRANT FROM EDERAL TRANSIT ADMINISTRA	M THE	(NOT FOR	DRAWN JMS CHECKED MES		US RAPID TRANSIT UPTOWN TO OAKLAND
E PATH:		ulf Towe Grant St				U. Tr	EDERAL TRANSIT ADMINISTRA .S. DEPARTMENT OF RANSPORTATION, UNDER THE RBAN MASS TRANSPORTATIO		CONSTRUCTION)	IN CHARGE <u>LAR</u>		INDEX OF DRAWINGS
[ <del>[</del> ]	5t	th Floor		NO. DATE		DESCRIPTION P	F 1964, AS AMENDED, FOR THI ORT AUTHORITY OF ALLEGHE	E I		DATE	Port	Authority CONTRACT NO. BRT-001
	Pittsbur	igii, PA	10218			REVISIONS	OUNTY, PENNSYLVANIA.			AS SHOWN	1 011	connecting people to life DWG. NO. GN4 SHT. 4

TED: 4/2	DRAWING NUMBER	SHEET NUMBER	TITLE	DRAWING NUMBER	SHEET NUMBER	TITLE		SHEET NUMBER	TITLE	DRAWING NUMBER	SHEET NUMBER	TITLE
PL0T			INTERSECTION DETAILS (CONT'D)			INTERSECTION DETAILS (CO	NT' D)		CIVIL LAYOUT PLANS (	CONT' D)	REMOV	AL & ADJUSTMENTS PLANS (CONT'D)
	ID55	231	INTERSECTION DATA FIFTH AVE & TENNYSON AVE	ID86	262	INTERSECTION DETAILS FORBES AVE & HALKET ST	CL24	291	CIVIL LAYOUT PLANS FIFTH AVE - STA 555+50 TO S	TA 561+50 RA11	320	REMOVAL & ADJUSTMENTS PLANS FIFTH AVE - STA 443+50 TO STA 448+50
	ID56	232	INTERSECTION DETAILS FIFTH AVE & RUSKIN AVE	ID87	263	INTERSECTION DATA FORBES AVE & HALKET ST	CL25	292	CIVIL LAYOUT PLANS FIFTH AVE - STA 561+50 TO ST	A 566+50 RA12	321	REMOVAL & ADJUSTMENTS PLANS FIFTH AVE - STA 448+50 TO STA 454+50
	ID57	233	INTERSECTION DATA FIFTH AVE & RUSKIN AVE	ID88	264	INTERSECTION DETAILS FORBES AVE & BIGELOW BLVD	CL26	293	CIVIL LAYOUT PLANS FORBES AVE - STA 122+00 TO S	TA 128+00 RA13	322	REMOVAL & ADJUSTMENTS PLANS FIFTH AVE - STA 454+50 TO STA 458+50
	ID58	234	INTERSECTION DETAILS FIFTH AVE & BELLEFIELD AVE	ID89	265	INTERSECTION DATA FORBES AVE & BIGELOW BLVD	CL27	294	CIVIL LAYOUT PLANS FORBES AVE - STA 128+00 TO S	TA 133+50 RA14	323	REMOVAL & ADJUSTMENTS PLANS FIFTH AVE - STA 458+50 TO STA 464+50
	ID59	235	INTERSECTION DATA FIFTH AVE & BELLEFIELD AVE	ID90	266	INTERSECTION DETAILS FORBES AVE & SCHENLEY DR EXT	. CL28	295	CIVIL LAYOUT PLANS FORBES AVE - STA 138+50 TO S	TA 143+50 RA15	324	REMOVAL & ADJUSTMENTS PLANS FIFTH AVE - STA 464+50 TO STA 470+50
	ID60	236	INTERSECTION DETAILS FORBES AVE & BOYD ST	ID91	267	INTERSECTION DETAILS FORBES AVE & SCHENLEY DR EXT	. CL29	296	CIVIL LAYOUT PLANS FORBES AVE - STA 143+50 TO S	TA 149+50 RA16	325	REMOVAL & ADJUSTMENTS PLANS FIFTH AVE - STA 470+50 TO STA 475+50
	ID61	237	INTERSECTION DATA FORBES AVE & BOYD ST				CL30	297	CIVIL LAYOUT PLANS FORBES AVE - STA 149+50 TO S	TA 154+50 RA17	326	REMOVAL & ADJUSTMENTS PLANS FIFTH AVE - STA 475+50 TO STA 480+50
	ID62	238	INTERSECTION DETAILS FORBES AVE & ARMSTRONG TUNNEL			CIVIL LAYOUT PLANS	CL31	298	CIVIL LAYOUT PLANS FORBES AVE - STA 154+50 TO S	TA 159+50 RA18	327	REMOVAL & ADJUSTMENTS PLANS FIFTH AVE - STA 480+50 TO STA 485+50
	ID63	239	INTERSECTION DATA FORBES AVE & ARMSTRONG TUNNEL	CL1	268	CIVIL LAYOUT PLANS FIFTH AVE - STA 433+50 TO STA 43	8+50 CL32	299	CIVIL LAYOUT PLANS FORBES AVE - STA 159+50 TO S	TA 164+50 RA19	328	REMOVAL & ADJUSTMENTS PLANS FIFTH AVE - STA 485+50 TO STA 490+50
	ID64	240	INTERSECTION DETAILS FORBES AVE & CHATHAM SQ	CL2	269	CIVIL LAYOUT PLANS FIFTH AVE - STA 438+50 TO STA 44	3+50 CL33	300	CIVIL LAYOUT PLANS FORBES AVE - STA 164+50 TO S	TA 169+50 RA20	329	REMOVAL & ADJUSTMENTS PLANS FIFTH AVE - STA 490+50 TO STA 496+50
	ID65	241	INTERSECTION DATA FORBES AVE & CHATHAM SQ	CL3	270	CIVIL LAYOUT PLANS FIFTH AVE - STA 443+50 TO STA 44	8+50 CL34	301	CIVIL LAYOUT PLANS FORBES AVE - STA 169+50 TO S	TA 173+50 RA21	330	REMOVAL & ADJUSTMENTS PLANS FIFTH AVE - STA 496+50 TO STA 502+50
	ID66	242	INTERSECTION DETAILS FORBES AVE & STEVENSON ST	CL4	271	CIVIL LAYOUT PLANS FIFTH AVE - STA 448+50 TO STA 45	4+50 CL35	302	CIVIL LAYOUT PLANS FORBES AVE - STA 173+50 TO S	TA 177+50 RA22	331	REMOVAL & ADJUSTMENTS PLANS FIFTH AVE - STA 502+50 TO STA 507+50
	ID67	243	INTERSECTION DATA FORBES AVE & STEVENSON ST	CL5	272	CIVIL LAYOUT PLANS FIFTH AVE - STA 454+50 TO STA 45	8+50 CL36	303	CIVIL LAYOUT PLANS FORBES AVE - STA 177+50 TO S	TA 182+50 RA23	332	REMOVAL & ADJUSTMENTS PLANS FIFTH AVE - STA 507+50 TO STA 513+50
	ID68	244	INTERSECTION DETAILS FORBES AVE & PRIDE ST	CL6	273	CIVIL LAYOUT PLANS FIFTH AVE - STA 458+50 TO STA 46	4+50 CL37	304	CIVIL LAYOUT PLANS FORBES AVE - STA 207+50 TO S	TA 213+50 RA24	333	REMOVAL & ADJUSTMENTS PLANS FIFTH AVE - STA 513+50 TO STA 517+50
	ID69	245	INTERSECTION DATA FORBES AVE & PRIDE ST	CL7	274	CIVIL LAYOUT PLANS FIFTH AVE - STA 464+50 TO STA 47	0+50 CL38	305	CIVIL LAYOUT PLANS FORBES AVE - STA 213+50 TO S	ΓΑ 217+50 RA25	334	REMOVAL & ADJUSTMENTS PLANS FIFTH AVE - STA 517+50 TO STA 522+50
	ID70	246	INTERSECTION DETAILS FORBES AVE & MARION ST	CL8	275	CIVIL LAYOUT PLANS FIFTH AVE - STA 470+50 TO STA 47	5+50 CL39	306	CIVIL LAYOUT PLANS FORBES AVE - STA 221+50 TO S	TA 227+00 RA26	335	REMOVAL & ADJUSTMENTS PLANS FIFTH AVE - STA 522+50 TO STA 528+50
. dgn	ID71	247	INTERSECTION DATA FORBES AVE & MARION ST	CL9	276	CIVIL LAYOUT PLANS FIFTH AVE - STA 475+50 TO STA 48	0+50 CL40	307	CIVIL LAYOUT PLANS FORBES AVE - STA 232+00 TO S	TA 237+50 RA27	336	REMOVAL & ADJUSTMENTS PLANS FIFTH AVE - STA 528+50 TO STA 534+50
10003	ID72	248	INTERSECTION DETAILS FORBES AVE & VAN BRAAM ST	CL10	277	CIVIL LAYOUT PLANS FIFTH AVE - STA 480+50 TO STA 48	5+50 CL41	308	CIVIL LAYOUT PLANS FORBES AVE - STA 242+50 TO S	TA 247+50 RA28	337	REMOVAL & ADJUSTMENTS PLANS FIFTH AVE - STA 534+50 TO STA 540+50
_RD_	ID73	249	INTERSECTION DATA FORBES AVE & VAN BRAAM ST	CL 1 1	278	CIVIL LAYOUT PLANS FIFTH AVE - STA 485+50 TO STA 49	0+50 CL42	309	CIVIL LAYOUT PLANS FORBES AVE - STA 247+50 TO S	TA 251+50 RA29	338	REMOVAL & ADJUSTMENTS PLANS FIFTH AVE - STA 540+50 TO STA 545+50
RT_01	ID74	250	INTERSECTION DETAILS FORBES AVE & MILTENBERGER ST	CL12	279	CIVIL LAYOUT PLANS FIFTH AVE - STA 490+50 TO STA 49	6+50			RA30	339	REMOVAL & ADJUSTMENTS PLANS FIFTH AVE - STA 545+50 TO STA 551+50
.00\B	ID75	251	INTERSECTION DATA FORBES AVE & MILTENBERGER ST	CL13	280	CIVIL LAYOUT PLANS FIFTH AVE - STA 496+50 TO STA 50	2+50		REMOVAL & ADJUSTMENTS		340	REMOVAL & ADJUSTMENTS PLANS FIFTH AVE - STA 551+50 TO STA 555+50
02077	ID76	252	INTERSECTION DETAILS FORBES AVE & GIST ST	CL14	281	CIVIL LAYOUT PLANS FIFTH AVE - STA 502+50 TO STA 50	7+50 RA1	310	REMOVAL & ADJUSTMENTS P LEGEND	RAJZ	341	REMOVAL & ADJUSTMENTS PLANS FIFTH AVE - STA 555+50 TO STA 561+50
P\mo:	ID77	253	INTERSECTION DATA FORBES AVE & GIST ST	CL15	282	CIVIL LAYOUT PLANS FIFTH AVE - STA 507+50 TO STA 51	3+50	311	REMOVAL & ADJUSTMENTS P TABULATIONS	RASS	342	REMOVAL & ADJUSTMENTS PLANS FIFTH AVE - STA 561+50 TO STA 566+50
com.	ID78	254	INTERSECTION DETAILS FORBES AVE & JUMONVILLE ST	CL16	283	CIVIL LAYOUT PLANS FIFTH AVE - STA 513+50 TO STA 51	7+50 RA3	312	REMOVAL & ADJUSTMENTS P TABULATIONS	RAS4	343	REMOVAL & ADJUSTMENTS PLANS FORBES AVE - STA 122+00 TO STA 128+00
sh@de	ID79	255	INTERSECTION DATA FORBES AVE & JUMONVILLE ST	CL17	284	CIVIL LAYOUT PLANS FIFTH AVE - STA 517+50 TO STA 52	2+50 RA4	313	REMOVAL & ADJUSTMENTS P TABULATIONS	RAJS	344	REMOVAL & ADJUSTMENTS PLANS FORBES AVE - STA 128+00 TO STA 133+50
silic	ID80	256	INTERSECTION DETAILS FORBES AVE & SENECA ST	CL18	285	CIVIL LAYOUT PLANS FIFTH AVE - STA 522+50 TO STA 52	8+50 RA5	314	REMOVAL & ADJUSTMENTS P TABULATIONS	RASE	345	REMOVAL & ADJUSTMENTS PLANS FORBES AVE - STA 138+50 TO STA 143+50
seph.	ID81	257	INTERSECTION DATA FORBES AVE & SENECA ST	CL19	286	CIVIL LAYOUT PLANS FIFTH AVE - STA 528+50 TO STA 53	4+50 RA6	315	REMOVAL & ADJUSTMENTS P TABULATIONS	RAST	346	REMOVAL & ADJUSTMENTS PLANS FORBES AVE - STA 143+50 TO STA 149+50
a\j 08	ID82	258	INTERSECTION DETAILS FORBES AVE & MOULTRIE ST	CL20	287	CIVIL LAYOUT PLANS FIFTH AVE - STA 534+50 TO STA 54	0+50 RA7	316	REMOVAL & ADJUSTMENTS P TABULATIONS	RAJO	347	REMOVAL & ADJUSTMENTS PLANS FORBES AVE - STA 149+50 TO STA 154+50
s16_n	ID83	259	INTERSECTION DATA FORBES AVE & MOULTRIE ST	CL21	288	CIVIL LAYOUT PLANS FIFTH AVE - STA 540+50 TO STA 54	5+50 RA8	317	REMOVAL & ADJUSTMENTS P TABULATIONS	RASS	348	REMOVAL & ADJUSTMENTS PLANS FORBES AVE - STA 154+50 TO STA 159+50
om_ de	ID84	260	INTERSECTION DETAILS FORBES AVE & BIRMINGHAM BR	CL22	289	CIVIL LAYOUT PLANS FIFTH AVE - STA 545+50 TO STA 55	1+50 RA9	318	REMOVAL & ADJUSTMENTS PIFIFTH AVE - STA 433+50 TO ST	A 438+50	349	REMOVAL & ADJUSTMENTS PLANS FORBES AVE - STA 159+50 TO STA 164+50
"" g\dec	ID85	261	INTERSECTION DATA FORBES AVE & BIRMINGHAM BR	CL23	290	CIVIL LAYOUT PLANS FIFTH AVE - STA 551+50 TO STA 55	5+50 RA10	319	REMOVAL & ADJUSTMENTS PI FIFTH AVE - STA 438+50 TO ST		350	REMOVAL & ADJUSTMENTS PLANS FORBES AVE - STA 164+50 TO STA 169+50
silich" orking\												
å. §			200				THE DDEDARATION OF THE		·	DESIGNED JMS	POR	T AUTHORITY OF ALLEGHENY COUNTY
"jose	A	ECC	<i>)M</i>				THE PREPARATION OF THIS DOCUMENT HAS BEEN FINANCED II PART THROUGH A GRANT FROM TH	HE	(NOT FOR	DRAWN JMS CHECKED MES	PITTSBU	JRGH PENNSYLVANIA S RAPID TRANSIT UPTOWN TO OAKLAND
RATOR: E PATH:		Gulf Towe	er			UT	EDERAL TRANSIT ADMINISTRATIO  J.S. DEPARTMENT OF  RANSPORTATION, UNDER THE		CONSTRUCTION)	IN CHARGE <u>LAR</u>		INDEX OF DRAWINGS
OPER FILE		07 Grant St 5th Floor	·	NO. DATE		DESCRIPTION C	JRBAN MASS TRANSPORTATION AG DF 1964, AS AMENDED, FOR THE PORT AUTHORITY OF ALLEGHENY			DATE <u>05/01/24</u> SCALE  A.S. SLICOMAN	Port A	uthority CONTRACT NO. BRT-001
	Pitts	sburgh, PA	19218			REVISIONS	COUNTY, PENNSYLVANIA.			AS SHOWN	I UIL COI	necting people to life DWG. NO. GN5 SHT. 5

		SHEET NUMBER	TITLE	DRAWING NUMBER	SHEET NUMBER	TITLE	DRAWING NUMBER	SHEET NUMBER	TITLE	DRAW) NUMB		
		REMOVAI	L & ADJUSTMENTS PLANS (CONT'D)			ROADWAY PLANS (CONT'D	<u>)</u>		ROADWAY PROFILES (	CONT'D)		ROADWAY PROFILES (CONT'D)
	RA42	351	REMOVAL & ADJUSTMENTS PLANS FORBES AVE - STA 169+50 TO STA 173+50	PP24	380	ROADWAY PLANS FIFTH AVE - STA 555+50 TO STA 56	S1+50 PP53	409	ROADWAY PROFILE FIFTH AVE - STA 464+50 TO S	TA 470+50 PP8	440	ROADWAY PROFILE VAN BRAAM ST AND MILTENBERGER ST
	RA43	352	REMOVAL & ADJUSTMENTS PLANS FORBES AVE - STA 173+50 TO STA 177+50	PP25	381	ROADWAY PLANS FIFTH AVE - STA 561+50 TO STA 56	DDE4	410	ROADWAY PROFILE FIFTH AVE - STA 470+50 TO S	DDO	5 441	ROADWAY PROFILE GIST ST AND JUMONVILLE ST
	RA44	353	REMOVAL & ADJUSTMENTS PLANS FORBES AVE - STA 207+50 TO STA 213+50	PP26	382	ROADWAY PLANS FORBES AVE - STA 117+00 TO STA 12	DDEE	411	ROADWAY PROFILE FIFTH AVE - STA 475+50 TO S	DDO	5 442	ROADWAY PROFILE SENECA ST AND MOULTRIE ST
	RA45	354	REMOVAL & ADJUSTMENTS PLANS FORBES AVE - STA 213+50 TO STA 217+50	PP27	383	ROADWAY PLANS FORBES AVE - STA 122+00 TO STA 12	28+00 PP56	412	ROADWAY PROFILE FIFTH AVE - STA 480+50 TO S			
	RA46	355	REMOVAL & ADJUSTMENTS PLANS FORBES AVE - STA 221+50 TO STA 227+00	PP28	384	ROADWAY PLANS FORBES AVE - STA 128+00 TO STA 13	DDE 7	413	ROADWAY PROFILE FIFTH AVE - STA 485+50 TO S			KIRKPATRICK ST PARKING LOT
	RA47	356	REMOVAL & ADJUSTMENTS PLANS FORBES AVE - STA 242+50 TO STA 247+50	PP29	385	ROADWAY PLANS FORBES AVE - STA 133+50 TO STA 13	38+50 PP58	414	ROADWAY PROFILE FIFTH AVE - STA 490+50 TO S	TA 496+50 KP	443	KIRKPATRICK ST STORMWATER MANAGEMENT PLAN
				PP30	386	ROADWAY PLANS FORBES AVE - STA 138+50 TO STA 14	13+50 PP59	415	ROADWAY PROFILE FIFTH AVE - STA 496+50 TO S	TA 502+50 KP2	444	KIRKPATRICK ST SPECIAL DETAILS
			ROADWAY PLANS	PP31	387	ROADWAY PLANS FORBES AVE - STA 143+50 TO STA 14	19+50 PP60	416	ROADWAY PROFILE FIFTH AVE - STA 502+50 TO S	TA 507+50		
	PP1	357	ROADWAY PLANS FIFTH AVE - STA 433+50 TO STA 438+50	PP32	388	ROADWAY PLANS FORBES AVE - STA 149+50 TO STA 15	54+50 PP61	417	ROADWAY PROFILE FIFTH AVE - STA 507+50 TO S	TA 513+50		
	PP2	358	ROADWAY PLANS FIFTH AVE - STA 438+50 TO STA 443+50	PP33	389	ROADWAY PLANS FORBES AVE - STA 154+50 TO STA 15	59+50 PP62	418	ROADWAY PROFILE DIAMOND ST, CHATHAM SQ, WASHINGTO	ON PL, MAGEE ST		EROSION & SEDIMENTATION CONTROL PLANS
	PP3	359	ROADWAY PLANS FIFTH AVE - STA 443+50 TO STA 448+50	PP34	390	ROADWAY PLANS FORBES AVE - STA 159+50 TO STA 16	64+50 PP63	419	ROADWAY PROFILE LOGAN ST, STEVENSON ST, P	RIDE ST ES	445	EROSION & SEDIMENTATION CONTROL PLANS GENERAL NOTES
	PP4	360	ROADWAY PLANS FIFTH AVE - STA 448+50 TO STA 454+50	PP35	391	ROADWAY PLANS FORBES AVE - STA 164+50 TO STA 16	59+50 PP64	420	ROADWAY PROFILE PRIDE ST, MARION ST, VINE ST,	VAN BRAAM ST ES2	446	EROSION & SEDIMENTATION CONTROL PLANS GENERAL NOTES
	PP5	361	ROADWAY PLANS FIFTH AVE - STA 454+50 TO STA 458+50	PP36	392	ROADWAY PLANS FORBES AVE - STA 169+50 TO STA 17	'3+50 PP65	421	ROADWAY PROFILE MILTENBERGER ST, DINWIDDIE S	r, GIST ST, ESS	447	EROSION & SEDIMENTATION CONTROL PLANS SEQUENCE OF CONSTRUCTION
	PP6	362	ROADWAY PLANS FIFTH AVE - STA 458+50 TO STA 464+50	PP37	393	ROADWAY PLANS FORBES AVE - STA 173+50 TO STA 17	7+50 PP66	422	ROADWAY PROFILE WYANDOTTE ST, SENECA ST, MO	ULTRIE ST ES4	448	EROSION & SEDIMENTATION CONTROL PLANS DETAILS
	PP7	363	ROADWAY PLANS FIFTH AVE - STA 464+50 TO STA 470+50	PP38	394	ROADWAY PLANS FORBES AVE - STA 177+50 TO STA 18	32+50 PP67	423	ROADWAY PROFILE KIRKPATRICK ST, BIRMING	HAM BR ESS	449	EROSION & SEDIMENTATION CONTROL PLANS DETAILS
	PP8	364	ROADWAY PLANS FIFTH AVE - STA 470+50 TO STA 475+50	PP39	395	ROADWAY PLANS FORBES AVE - STA 207+50 TO STA 21	3+50 PP68	424	ROADWAY PROFILE FORBES AVE - STA 119+00 TO S	STA 122+00 ES6	450	EROSION & SEDIMENTATION CONTROL PLANS DETAILS
- dgn	PP9	365	ROADWAY PLANS FIFTH AVE - STA 475+50 TO STA 480+50	PP40	396	ROADWAY PLANS FORBES AVE - STA 213+50 TO STA 21	7+50 PP69	425	ROADWAY PROFILE FORBES AVE - STA 122+00 TO S	STA 128+00 EST	451	EROSION & SEDIMENTATION CONTROL PLANS DETAILS
0D04	PP10	366	ROADWAY PLANS FIFTH AVE - STA 480+50 TO STA 485+50	PP41	397	ROADWAY PLANS FORBES AVE - STA 221+50 TO STA 22	27+00 PP70	426	ROADWAY PROFILE FORBES AVE - STA 128+00 TO S	STA 133+50 ES8	452	EROSION & SEDIMENTATION CONTROL PLANS DETAILS
-RD- I	PP11	367	ROADWAY PLANS FIFTH AVE - STA 485+50 TO STA 490+50	PP42	398	ROADWAY PLANS FORBES AVE - STA 227+00 TO STA 23	32+00 PP71	427	ROADWAY PROFILE FORBES AVE - STA 133+50 TO	STA 138+50 ESS	453	EROSION & SEDIMENTATION CONTROL PLANS DETAILS
T_01	PP12	368	ROADWAY PLANS FIFTH AVE - STA 490+50 TO STA 496+50	PP43	399	ROADWAY PLANS FORBES AVE - STA 232+00 TO STA 23	37+50 PP72	428	ROADWAY PROFILE FORBES AVE - STA 138+50 TO	STA 143+50 ES1	454	EROSION & SEDIMENTATION CONTROL PLANS DETAILS
00\BF	PP13	369	ROADWAY PLANS FIFTH AVE - STA 496+50 TO STA 502+50	PP44	400	ROADWAY PLANS FORBES AVE - STA 237+50 TO STA 24	PP73	429	ROADWAY PROFILE FORBES AVE - STA 143+50 TO	STA 149+50 ES1	1 455	EROSION & SEDIMENTATION CONTROL PLANS DETAILS
02077	PP14	370	ROADWAY PLANS FIFTH AVE - STA 502+50 TO STA 507+50	PP45	401	ROADWAY PLANS FORBES AVE - STA 242+50 TO STA 24	17+50 PP74	430	ROADWAY PROFILE FORBES AVE - STA 149+50 TO	STA 154+50 ES1	2 456	EROSION & SEDIMENTATION CONTROL PLANS FIFTH AVE - STA 433+50 TO STA 438+50
)p\mo	PP15	371	ROADWAY PLANS FIFTH AVE - STA 507+50 TO STA 513+50	PP46	402	ROADWAY PLANS FORBES AVE - STA 247+50 TO STA 25	51+50 PP75	431	ROADWAY PROFILE FORBES AVE - STA 154+50 TO S	STA 159+50 ES1	3 457	EROSION & SEDIMENTATION CONTROL PLANS FIFTH AVE - STA 438+50 TO STA 443+50
o moc	PP16	372	ROADWAY PLANS FIFTH AVE - STA 513+50 TO STA 517+50				PP76	432	ROADWAY PROFILE FORBES AVE - STA 159+50 TO S	STA 164+50 ES1	458	EROSION & SEDIMENTATION CONTROL PLANS FIFTH AVE - STA 443+50 TO STA 448+50
h@de	PP17	373	ROADWAY PLANS FIFTH AVE - STA 517+50 TO STA 522+50			ROADWAY PROFILES	PP77	433	ROADWAY PROFILE FORBES AVE - STA 164+50 TO S	STA 169+50 ES1	459	EROSION & SEDIMENTATION CONTROL PLANS FIFTH AVE - STA 448+50 TO STA 454+50
silic	PP18	374	ROADWAY PLANS FIFTH AVE - STA 522+50 TO STA 528+50	PP47	403	ROADWAY PROFILE FIFTH AVE - STA 433+50 TO STA 43	8+50 PP78	434	ROADWAY PROFILE FORBES AVE - STA 169+50 TO	STA 173+50 ES1	460	EROSION & SEDIMENTATION CONTROL PLANS FIFTH AVE - STA 454+50 TO STA 458+50
eph.	PP19	375	ROADWAY PLANS FIFTH AVE - STA 528+50 TO STA 534+50	PP48	404	ROADWAY PROFILE FIFTH AVE - STA 438+50 TO STA 44	3+50 PP79	435	ROADWAY PROFILE FORBES AVE - STA 173+50 TO	STA 177+50 ES1	7 461	EROSION & SEDIMENTATION CONTROL PLANS FIFTH AVE - STA 458+50 TO STA 464+50
d\jos	PP20	376	ROADWAY PLANS FIFTH AVE - STA 534+50 TO STA 540+50	PP49	405	ROADWAY PROFILE FIFTH AVE - STA 443+50 TO STA 44	8+50 PP80	436	ROADWAY PROFILE FORBES AVE - STA 177+50 TO	STA 182+50 ES1	3 462	EROSION & SEDIMENTATION CONTROL PLANS FIFTH AVE - STA 464+50 TO STA 470+50
16_n	PP21	377	ROADWAY PLANS FIFTH AVE - STA 540+50 TO STA 545+50	PP50	406	ROADWAY PROFILE FIFTH AVE - STA 448+50 TO STA 45	4+50 PP81	437	ROADWAY PROFILE BOYD ST, MCNULTY ST, CHA	THAM SQ ES1	9 463	EROSION & SEDIMENTATION CONTROL PLANS FIFTH AVE - STA 470+50 TO STA 475+50
om_ ds	PP22	378	ROADWAY PLANS FIFTH AVE - STA 545+50 TO STA 551+50	PP51	407	ROADWAY PROFILE FIFTH AVE - STA 454+50 TO STA 45	8+50 PP82	438	ROADWAY PROFILE MAGEE ST AND STEVENSO		464	EROSION & SEDIMENTATION CONTROL PLANS FIFTH AVE - STA 475+50 TO STA 480+50
) dec	PP23	379	ROADWAY PLANS FIFTH AVE - STA 551+50 TO STA 555+50	PP52	408	ROADWAY PROFILE FIFTH AVE - STA 458+50 TO STA 46	4+50 PP83	439	ROADWAY PROFILE PRIDE ST AND MARION	ST ES2	1 465	EROSION & SEDIMENTATION CONTROL PLANS FIFTH AVE - STA 480+50 TO STA 485+50
rk ing g												
- wwo									<u> </u>	DESIGNED JMS		PORT AUTHORITY OF ALLEGHENY COUNTY
80	A	ECC	)M			D	HE PREPARATION OF THIS OCUMENT HAS BEEN FINANCEI ART THROUGH A GRANT FROM	1 THE	(NOT FOR	DRAWN JMS	P	ITTSBURGH PENNSYLVANIA
H A L		Gulf Tower				F	EDERAL TRANSIT ADMINISTRAT .S. DEPARTMENT OF RANSPORTATION, UNDER THE	TION,	\	CHECKED MES IN CHARGE LAR		BUS RAPID TRANSIT UPTOWN TO OAKLAND INDEX OF DRAWINGS
1 LE		7 Grant Stre 5th Floor		NO. DATE		U	RBAN MASS TRANSPORTATION F 1964, AS AMENDED, FOR THE ORT AUTHORITY OF ALLEGHEN	E	CONSTRUCTION)	DATE <u>05/01/24</u> SCALE	Dar	
	Pitts	burgh, PA 1	5219	INO.   DATE			OUNTY, PENNSYLVANIA.			AS SHOWN	rur	t Authority CONTRACT NO. BRT-001  DWG. NO. GN6 SHT. 6

		SHEET NUMBER		TITLE	DRAWING NUMBER	SHEET NUMBER	TITLE	DRAWING NUMBER	SHEET NUMBER	TITLE	Ţ	DRAWING NUMBER	SHEET NUMBER	TITLE
	EROSI	ON & SE	<u>EDIMENTATI</u>	ON CONTROL PLANS (CONT'D)	EROS	SION & S	EDIMENTATION CONTROL PLANS	( CONT' D)		UTILITY PLANS (CO	NT' D)			PWSA RELOCATION PLANS (CONT'D)
	ES22	466	EROSION & S	SEDIMENTATION CONTROL PLANS - STA 485+50 TO STA 490+50	ES53	497	EROSION & SEDIMENTATION CONTROL FORBES AVE - STA 232+00 TO STA 2		526	UTILITY PLANS FORBES AVE - STA 128+00 TO S	STA 133+50	PWSA5	555	PWSA WATERLINE RELOCATION PLAN FIFTH AVE - STA 444+50
	ES23	467	EROSION & S	SEDIMENTATION CONTROL PLANS - STA 490+50 TO STA 496+50	ES54	498	EROSION & SEDIMENTATION CONTROL FORBES AVE - STA 242+50 TO STA 2	PLANS 247+50 UT29	527	UTILITY PLANS FORBES AVE - STA 133+50 TO S		PWSA6	556	PWSA WATERLINE RELOCATION PLAN FIFTH AVE & MAGEE ST - STA 448+00
	ES24	468		SEDIMENTATION CONTROL PLANS - STA 496+50 TO STA 502+50				UT30	528	UTILITY PLANS FORBES AVE - STA 138+50 TO S		PWSA7	557	PWSA WATERLINE RELOCATION PLAN FIFTH AVE & WYANDOTTE ST - STA 478+00
	ES25	469	EROSION & S	SEDIMENTATION CONTROL PLANS - STA 502+50 TO STA 507+50			UTILITY PLANS	UT31	529	UTILITY PLANS FORBES AVE - STA 143+50 TO S	STA 149+50	PWSA8	558	PWSA WATERLINE RELOCATION PLAN FIFTH AVE - STA 471+00 TO STA 481+00
	ES26	470		SEDIMENTATION CONTROL PLANS - STA 507+50 TO STA 513+50	UT1	499	UTILITY PLANS GENERAL NOTES & UTILITY LEGEN	NDS UT32	530	UTILITY PLANS FORBES AVE - STA 149+50 TO S	STA 154+50	PWSA9	559	PWSA WATERLINE RELOCATION PLAN FIFTH AVE - STA 490+00
	ES27	471		SEDIMENTATION CONTROL PLANS - STA 513+50 TO STA 517+50	UT2	500	UTILITY PLANS FIFTH AVE - STA 433+50 TO STA 4	38+50 UT33	531	UTILITY PLANS FORBES AVE - STA 154+50 TO S	STA 159+50	PWSA10	560	PWSA WATERLINE RELOCATION PLAN FIFTH AVE - STA 495+00
	ES28	472		SEDIMENTATION CONTROL PLANS - STA 528+50 TO STA 534+50	<b>UT</b> 3	501	UTILITY PLANS FIFTH AVE - STA 438+50 TO STA 4	43+50 UT34	532	UTILITY PLANS FORBES AVE - STA 159+50 TO S	STA 164+50	PWSA11	561	PWSA WATERLINE RELOCATION PLAN FIFTH AVE - STA 503+00
	ES29	473		SEDIMENTATION CONTROL PLANS - STA 522+50 TO STA 528+50	UT4	502	UTILITY PLANS FIFTH AVE - STA 443+50 TO STA 4	48+50 UT35	533	UTILITY PLANS FORBES AVE - STA 164+50 TO S	STA 169+50	PWSA12	562	PWSA WATERLINE RELOCATION PLAN FIFTH AVE - STA 511+50
	ES30	474		SEDIMENTATION CONTROL PLANS - STA 528+50 TO STA 534+50	UT5	503	UTILITY PLANS FIFTH AVE - STA 448+50 TO STA 4	54+50 UT36	534	UTILITY PLANS FORBES AVE - STA 169+50 TO S	STA 173+50	PWSA13	563	PWSA WATERLINE RELOCATION PLAN FIFTH AVE - STA 517+00
	ES31	475	EROSION & S	SEDIMENTATION CONTROL PLANS - STA 534+50 TO STA 540+50	UT6	504	UTILITY PLANS FIFTH AVE - STA 454+50 TO STA 4	58+50 UT37	535	UTILITY PLANS FORBES AVE - STA 173+50 TO S	STA 177+50	PWSA14	564	PWSA WATERLINE RELOCATION PLAN FIFTH AVE - STA 539+00
	ES32	476		SEDIMENTATION CONTROL PLANS - STA 540+50 TO STA 545+50	UT7	505	UTILITY PLANS FIFTH AVE - STA 458+50 TO STA 4	64+50 UT38	536	UTILITY PLANS FORBES AVE - STA 177+50 TO S	STA 182+50	PWSA15	565	PWSA WATERLINE RELOCATION PLAN FIFTH AVE - STA 542+50
	ES33	477		SEDIMENTATION CONTROL PLANS - STA 545+50 TO STA 551+50	UT8	506	UTILITY PLANS FIFTH AVE - STA 464+50 TO STA 4	70+50 UT39	537	UTILITY PLANS FORBES AVE - STA 182+50 TO S	STA 187+50	PWSA16	566	PWSA WATERLINE RELOCATION PLAN FORBES AVE & PRIDE ST - STA 146+00
	ES34	478		SEDIMENTATION CONTROL PLANS - STA 551+50 TO STA 555+50	UT9	507	UTILITY PLANS FIFTH AVE - STA 470+50 TO STA 4	75+50 UT40	538	UTILITY PLANS FORBES AVE - STA 187+50 TO S	STA 193+50	PWSA17	567	PWSA WATERLINE RELOCATION PLAN FORBES AVE - STA 153+00 TO STA 171+00
	ES35	479		SEDIMENTATION CONTROL PLANS - STA 555+50 TO STA 561+50	UT10	508	UTILITY PLANS FIFTH AVE - STA 475+50 TO STA 4	80+50 UT41	539	UTILITY PLANS FORBES AVE - STA 193+50 TO S	STA 198+50	PWSA18	568	PWSA WATERLINE RELOCATION PLAN FORBES AVE - STA 161+00 & 166+50
	ES36	480		SEDIMENTATION CONTROL PLANS - STA 561+50 TO STA 566+50	UT11	509	UTILITY PLANS FIFTH AVE - STA 480+50 TO STA 4	85+50 UT42	540	UTILITY PLANS FORBES AVE - STA 198+50 TO S	STA 202+50	PWSA19	569	PWSA WATERLINE RELOCATION PLAN FORBES AVE - STA 175+00
	ES37	481		SEDIMENTATION CONTROL PLANS - STA 117+00 TO STA 122+00	UT12	510	UTILITY PLANS FIFTH AVE - STA 485+50 TO STA 4	90+50 UT43	541	UTILITY PLANS FORBES AVE - STA 202+50 TO S	STA 207+50	PWSA20	570	PWSA WATERLINE RELOCATION PLAN FORBES AVE & HALKET ST - STA 217+00
. dgn	ES38	482	EROSION & S FORBES AVE	SEDIMENTATION CONTROL PLANS - STA 128+00 TO STA 133+50	UT13	511	UTILITY PLANS FIFTH AVE - STA 490+50 TO STA 4	96+50 UT44	542	UTILITY PLANS FORBES AVE - STA 207+50 TO S	STA 213+50	PWSA21	571	PWSA WATERLINE RELOCATION PLAN FORBES AVE & MCKEE PLACE - STA 224+00
10D05	ES39	483	EROSION & S FORBES AVE	SEDIMENTATION CONTROL PLANS - STA 128+00 TO STA 133+50	UT14	512	UTILITY PLANS FIFTH AVE - STA 496+50 TO STA 5	02+50 UT45	543	UTILITY PLANS FORBES AVE - STA 213+50 TO S	STA 217+50			
-RD-	ES40	484	EROSION & S FORBES AVE	SEDIMENTATION CONTROL PLANS - STA 133+50 TO STA 138+50	UT15	513	UTILITY PLANS FIFTH AVE - STA 502+50 TO STA 5	07+50 UT46	544	UTILITY PLANS FORBES AVE - STA 217+50 TO S	STA 221+50			LANDSCAPING PLANS
1T_01	ES41	485	EROSION & S FORBES AVE	SEDIMENTATION CONTROL PLANS - STA 138+50 TO STA 143+50	UT16	514	UTILITY PLANS FIFTH AVE - STA 507+50 TO STA 5	13+50 UT47	545	UTILITY PLANS FORBES AVE - STA 221+50 TO S	STA 227+00	LS1	572	LANDSCAPING PLANS DETAILS
00\Bf	ES42	486	EROSION & S FORBES AVE	SEDIMENTATION CONTROL PLANS - STA 143+50 TO STA 149+50	UT17	515	UTILITY PLANS FIFTH AVE - STA 513+50 TO STA 5	17+50 UT48	546	UTILITY PLANS FORBES AVE - STA 227+00 TO S	STA 232+00	LS2	573	LANDSCAPING PLANS DETAILS
72077	ES43	487	FORBES AVE	SEDIMENTATION CONTROL PLANS - STA 149+50 TO STA 154+50	UT18	516	UTILITY PLANS FIFTH AVE - STA 517+50 TO STA 5	22+50 UT49	547	UTILITY PLANS FORBES AVE - STA 232+00 TO S	STA 237+50	LS3	574	LANDSCAPING PLANS FIFTH AVE - STA 433+50 TO STA 438+50
)p\mo:	ES44	488	FORBES AVE	SEDIMENTATION CONTROL PLANS - STA 154+50 TO STA 159+50	UT19	517	UTILITY PLANS FIFTH AVE - STA 522+50 TO STA 5	28+50 UT50	548	UTILITY PLANS FORBES AVE - STA 237+50 TO S	STA 242+50	LS4	575	LANDSCAPING PLANS FIFTH AVE - STA 438+50 TO STA 443+50
o • uoo	ES45	489	FORBES AVE	SEDIMENTATION CONTROL PLANS - STA 159+50 TO STA 164+50	UT20	518	UTILITY PLANS FIFTH AVE - STA 528+50 TO STA 5	34+50 UT51	549	UTILITY PLANS FORBES AVE - STA 242+50 TO S	STA 247+50	LS5	576	LANDSCAPING PLANS FIFTH AVE - STA 443+50 TO STA 448+50
h@de	ES46	490	FORBES AVE	SEDIMENTATION CONTROL PLANS - STA 164+50 TO STA 169+50	UT21	519	UTILITY PLANS FIFTH AVE - STA 534+50 TO STA 5	40+50 UT52	550	UTILITY PLANS FORBES AVE - STA 247+50 TO S	STA 251+50	LS6	577	LANDSCAPING PLANS FIFTH AVE - STA 448+50 TO STA 454+50
01110	ES47	491	FORBES AVE	SEDIMENTATION CONTROL PLANS - STA 169+50 TO STA 173+50	UT22	520	UTILITY PLANS FIFTH AVE - STA 540+50 TO STA 5	45+50				LS7	578	LANDSCAPING PLANS FIFTH AVE - STA 454+50 TO STA 458+50
eph.	ES48	492	FORBES AVE	SEDIMENTATION CONTROL PLANS - STA 173+50 TO STA 177+50	UT23	521	UTILITY PLANS FIFTH AVE - STA 545+50 TO STA 5	51+50		PWSA RELOCATION P		LS8	579	LANDSCAPING PLANS FIFTH AVE - STA 458+50 TO STA 464+50
a\jos	ES49	493	FORBES AVE	SEDIMENTATION CONTROL PLANS - STA 177+50 TO STA 182+50	UT24	522	UTILITY PLANS FIFTH AVE - STA 551+50 TO STA 5	55+50 PWSA1	551	PWSA WATERLINE RELOCATIO PWSA DETAILS		LS9	580	LANDSCAPING PLANS FIFTH AVE - STA 464+50 TO STA 470+50
16_n	ES50	494		SEDIMENTATION CONTROL PLANS - STA 207+50 TO STA 213+50	UT25	523	UTILITY PLANS FIFTH AVE - STA 555+50 TO STA 5		552	PWSA WATERLINE RELOCATIO PWSA DETAILS		LS10	581	LANDSCAPING PLANS FIFTH AVE - STA 470+50 TO STA 475+50
om_ds	ES51	495		SEDIMENTATION CONTROL PLANS - STA 213+50 TO STA 217+50	UT26	524	UTILITY PLANS FIFTH AVE - STA 561+50 TO STA 5	66+50 PWSA3	553	PWSA WATERLINE RELOCATIO PWSA DETAILS		LS11	582	LANDSCAPING PLANS FIFTH AVE - STA 475+50 TO STA 480+50
g\dec	ES52	496	FORBES AVE	SEDIMENTATION CONTROL PLANS - STA 221+50 TO STA 227+00	UT27	525	UTILITY PLANS FORBES AVE - STA 122+00 TO STA 1	28+00 PWSA4	554	PWSA WATERLINE RELOCATIO FIFTH AVE - STA 441+	N PLAN 00	LS12	583	LANDSCAPING PLANS FIFTH AVE - STA 480+50 TO STA 485+50
Ŧ.														
Dwwd								THE DREDADATION OF THE		·	DESIGNED JMS		POI	RT AUTHORITY OF ALLEGHENY COUNTY
, ö	A	ECC	M					THE PREPARATION OF THIS DOCUMENT HAS BEEN FINANCE PART THROUGH A GRANT FROM	M THE	(NOT FOR	DRAWN JMS CHECKED MES		PITTSE	BURGH PENNSYLVANIA  JS RAPID TRANSIT UPTOWN TO OAKLAND
E PAT		Gulf Tower	r					FEDERAL TRANSIT ADMINISTRA U.S. DEPARTMENT OF TRANSPORTATION, UNDER THE		CONSTRUCTION)	IN CHARGE <u>LAR</u>			INDEX OF DRAWINGS
FILI		7 Grant Str 5th Floor			NO. DATE		DESCRIPTION	URBAN MASS TRANSPORTATIO OF 1964, AS AMENDED, FOR TH PORT AUTHORITY OF ALLEGHE	느 ㅣ		DATE 05/01/24  SCALE		Port I	Authority CONTRACT NO. BRT-001
	PITTSD	ourgh, PA 1	15219				REVISIONS	COUNTY, PENNSYLVANIA.		·	AS SHOWI	IN	I UIL F	onnecting people to life DWG. NO. GN7 SHT. 7

	RAWING UMBER	SHEET NUMBER	TITLE	DRAWING NUMBER	SHEET NUMBER	TITLE	DRAWING NUMBER	SHEET NUMBE			DRAWING NUMBER	SHEET NUMBER	TITLE
- [			LANDSCAPING PLANS (CONT'D)		SIGNING 8	& PAVEMENT MARKING PLANS	(CONT'D)	SIGNI	NG & PAVEMENT MARKING PL	ANS (CONT'D)		SIGNING	& PAVEMENT MARKING PLANS (CONT'D)
	LS13	584	LANDSCAPING PLANS FIFTH AVE - STA 485+50 TO STA 490+50	SN8	611	SIGNING & PAVEMENT MARKING PL TABULATION SHEET	ANS SN39	642	SIGNING & PAVEMENT MARKIN SIXTH AVE - STA 624+50 TO S		SN70	673	SIGNING & PAVEMENT MARKING PLANS FORBES AVE - STA 138+50 TO STA 143+50
	LS14	585	LANDSCAPING PLANS FIFTH AVE - STA 490+50 TO STA 495+50	SN9	612	SIGNING & PAVEMENT MARKING PL TABULATION SHEET	ANS SN40	643	SIGNING & PAVEMENT MARKIN FIFTH AVE - STA 428+50 TO S		SN71	674	SIGNING & PAVEMENT MARKING PLANS FORBES AVE - STA 143+50 TO STA 149+50
	LS15	586	LANDSCAPING PLANS FIFTH AVE - STA 495+50 TO STA 502+50	SN10	613	SIGNING & PAVEMENT MARKING PL TABULATION SHEET	ANS SN41	644	SIGNING & PAVEMENT MARKIN SIXTH AVE - STA 631+50 TO S		SN72	675	SIGNING & PAVEMENT MARKING PLANS FORBES AVE - STA 149+50 TO STA 154+50
	LS16	587	LANDSCAPING PLANS FIFTH AVE - STA 502+50 TO STA 507+50	SN11	614	SIGNING & PAVEMENT MARKING PL TABULATION SHEET	ANS SN42	645	SIGNING & PAVEMENT MARKIN FIFTH AVE - STA 433+50 TO S		SN73	676	SIGNING & PAVEMENT MARKING PLANS FORBES AVE - STA 154+50 TO STA 159+50
	LS17	588	LANDSCAPING PLANS FIFTH AVE - STA 507+50 TO STA 513+50	SN12	615	SIGNING & PAVEMENT MARKING PL TABULATION SHEET	ANS SN43	646	SIGNING & PAVEMENT MARKIN FIFTH AVE - STA 438+50 TO S		SN74	677	SIGNING & PAVEMENT MARKING PLANS FORBES AVE - STA 159+50 TO STA 164+50
	LS18	589	LANDSCAPING PLANS FIFTH AVE - STA 513+50 TO STA 517+50	SN13	616	SIGNING & PAVEMENT MARKING PL TABULATION SHEET	ANS SN44	647	SIGNING & PAVEMENT MARKIN FIFTH AVE - STA 443+50 TO S		SN75	678	SIGNING & PAVEMENT MARKING PLANS FORBES AVE - STA 164+50 TO STA 169+50
	LS19	590	LANDSCAPING PLANS FIFTH AVE - STA 517+50 TO STA 522+50	SN14	617	SIGNING & PAVEMENT MARKING PL TABULATION SHEET	ANS SN45	648	SIGNING & PAVEMENT MARKIN FIFTH AVE - STA 448+50 TO S		SN76	679	SIGNING & PAVEMENT MARKING PLANS FORBES AVE - STA 169+50 TO STA 173+50
	LS20	591	LANDSCAPING PLANS FIFTH AVE - STA 551+50 TO STA 555+50	SN15	618	SIGNING & PAVEMENT MARKING PL SUMMARY OF ROADWAY SIGNS	ANS SN46	649	SIGNING & PAVEMENT MARKIN FIFTH AVE - STA 454+50 TO S		SN77	680	SIGNING & PAVEMENT MARKING PLANS FORBES AVE - STA 173+50 TO STA 177+50
	LS21	592	LANDSCAPING PLANS FIFTH AVE - STA 555+50 TO STA 561+50	SN16	619	SIGNING & PAVEMENT MARKING PL SUMMARY OF ROADWAY SIGNS	ANS SN47	650	SIGNING & PAVEMENT MARKIN FIFTH AVE - STA 458+50 TO S		SN78	681	SIGNING & PAVEMENT MARKING PLANS FORBES AVE - STA 177+50 TO STA 182+50
	LS22	593	LANDSCAPING PLANS FIFTH AVE - STA 561+50 TO STA 566+50	SN17	620	SIGNING & PAVEMENT MARKING PL SUMMARY OF ROADWAY SIGNS	ANS SN48	651	SIGNING & PAVEMENT MARKIN FIFTH AVE - STA 464+50 TO S		SN79	682	SIGNING & PAVEMENT MARKING PLANS FORBES AVE - STA 182+50 TO STA 187+50
	LS23	594	LANDSCAPING PLANS FORBES AVE - STA 138+50 TO STA 143+50	SN18	621	SIGNING & PAVEMENT MARKING PL SUMMARY OF ROADWAY SIGNS	ANS SN49	652	SIGNING & PAVEMENT MARKIN FIFTH AVE - STA 470+50 TO S		SN80	683	SIGNING & PAVEMENT MARKING PLANS FORBES AVE - STA 202+50 TO STA 207+50
	LS24	595	LANDSCAPING PLANS FORBES AVE - STA 143+50 TO STA 149+50	SN19	622	SIGNING & PAVEMENT MARKING PL SUMMARY OF ROADWAY SIGNS	ANS SN50	653	SIGNING & PAVEMENT MARKIN FIFTH AVE - STA 475+50 TO S		SN81	684	SIGNING & PAVEMENT MARKING PLANS FORBES AVE - STA 207+50 TO STA 213+50
	LS25	596	LANDSCAPING PLANS FORBES AVE - STA 149+50 TO STA 154+50	SN20	623	SIGNING & PAVEMENT MARKING PL SUMMARY OF ROADWAY SIGNS	ANS SN51	654	SIGNING & PAVEMENT MARKIN FIFTH AVE - STA 480+50 TO S		SN82	685	SIGNING & PAVEMENT MARKING PLANS FORBES AVE - STA 213+50 TO STA 217+50
	LS26	597	LANDSCAPING PLANS FORBES AVE - STA 154+50 TO STA 159+50	SN21	624	SIGNING & PAVEMENT MARKING PL SUMMARY OF ROADWAY SIGNS	ANS SN52	655	SIGNING & PAVEMENT MARKIN FIFTH AVE - STA 485+50 TO S		SN83	686	SIGNING & PAVEMENT MARKING PLANS FORBES AVE - STA 217+50 TO STA 221+50
	LS27	598	LANDSCAPING PLANS FORBES AVE - STA 159+50 TO STA 164+50	SN22	625	SIGNING & PAVEMENT MARKING PL SUMMARY OF ROADWAY SIGNS	ANS SN53	656	SIGNING & PAVEMENT MARKIN FIFTH AVE - STA 490+50 TO S		SN84	687	SIGNING & PAVEMENT MARKING PLANS FORBES AVE - STA 221+50 TO STA 227+00
	LS28	599	LANDSCAPING PLANS FORBES AVE - STA 164+50 TO STA 169+50	SN23	626	SIGNING & PAVEMENT MARKING PL SUMMARY OF ROADWAY SIGNS	ANS SN54	657	SIGNING & PAVEMENT MARKIN FIFTH AVE - STA 496+50 TO S		SN85	688	SIGNING & PAVEMENT MARKING PLANS FORBES AVE - STA 227+00 TO STA 232+00
· dgn	LS29	600	LANDSCAPING PLANS FORBES AVE - STA 169+50 TO STA 174+50	SN24	627	SIGNING & PAVEMENT MARKING PL SUMMARY OF ROADWAY SIGNS	ANS SN55	658	SIGNING & PAVEMENT MARKIN FIFTH AVE - STA 502+50 TO S		SN86	689	SIGNING & PAVEMENT MARKING PLANS FORBES AVE - STA 232+00 TO STA 237+50
90001	LS30	601	LANDSCAPING PLANS FORBES AVE - STA 174+50 TO STA 178+50	SN25	628	SIGNING & PAVEMENT MARKING PL SUMMARY OF ROADWAY SIGNS	ANS SN56	659	SIGNING & PAVEMENT MARKIN FIFTH AVE - STA 507+50 TO S		SN87	690	SIGNING & PAVEMENT MARKING PLANS FORBES AVE - STA 237+50 TO STA 242+50
_RD_ 1	LS31	602	LANDSCAPING PLANS FORBES AVE - STA 207+50 TO STA 213+50	SN26	629	SIGNING & PAVEMENT MARKING PL SUMMARY OF ROADWAY SIGNS	ANS SN57	660	SIGNING & PAVEMENT MARKIN FIFTH AVE - STA 513+50 TO S		SN88	691	SIGNING & PAVEMENT MARKING PLANS FORBES AVE - STA 242+50 TO STA 247+50
T_01	LS32	603	LANDSCAPING PLANS FORBES AVE - STA 213+50 TO STA 217+50	SN27	630	SIGNING & PAVEMENT MARKING PL SUMMARY OF ROADWAY SIGNS	ANS SN58	661	SIGNING & PAVEMENT MARKIN FIFTH AVE - STA 517+50 TO S	NG PLANS STA 522+50	SN89	692	SIGNING & PAVEMENT MARKING PLANS FORBES AVE - STA 247+50 TO STA 251+50
00\BF				SN28	631	SIGNING & PAVEMENT MARKING PL SUMMARY OF ROADWAY SIGNS	ANS SN59	662	SIGNING & PAVEMENT MARKIN FIFTH AVE - STA 522+50 TO S		SN90	693	SIGNING & PAVEMENT MARKING PLANS FORBES AVE - STA 251+50 TO STA 256+50
72077				SN29	632	SIGNING & PAVEMENT MARKING PL SUMMARY OF ROADWAY SIGNS	ANS SN60	663	SIGNING & PAVEMENT MARKIN FIFTH AVE - STA 528+50 TO S		SN91	694	SIGNING & PAVEMENT MARKING PLANS BELLEFIELD AVE
)P\mo				SN30	633	SIGNING & PAVEMENT MARKING PL SUMMARY OF ROADWAY SIGNS	ANS SN61	664	SIGNING & PAVEMENT MARKIN FIFTH AVE - STA 534+50 TO S				
o moo			SIGNING & PAVEMENT MARKING PLANS	SN31	634	SIGNING & PAVEMENT MARKING PL SUMMARY OF ROADWAY SIGNS	ANS SN62	665	SIGNING & PAVEMENT MARKIN FIFTH AVE - STA 540+50 TO S	NG PLANS STA 545+50			
høded	SN1	604	SIGNING & PAVEMENT MARKING PLANS GENERAL NOTES	SN32	635	SIGNING & PAVEMENT MARKING PL SUMMARY OF ROADWAY SIGNS	ANS SN63	666	SIGNING & PAVEMENT MARKIN FIFTH AVE - STA 545+50 TO S	NG PLANS STA 551+50			LIGHTING PLANS
i - i c	SN2	605	SIGNING & PAVEMENT MARKING PLANS SUMMARY OF QUANTITIES	SN33	636	SIGNING & PAVEMENT MARKING PL DETAILS	ANS SN64	667	SIGNING & PAVEMENT MARKIN FIFTH AVE - STA 551+50 TO S	STA 555+50	LP1	695	LIGHTING PLANS GENERAL NOTES
eph.	SN3	606	SIGNING & PAVEMENT MARKING PLANS SUMMARY OF QUANTITIES	SN34	637	SIGNING & PAVEMENT MARKING PL DETAILS	31100	668	SIGNING & PAVEMENT MARKIN FIFTH AVE - STA 555+50 TO	NG PLANS STA 561+50	LP2	696	LIGHTING PLANS TABULATION SHEET
d\jos	SN4	607	SIGNING & PAVEMENT MARKING PLANS SUMMARY OF QUANTITIES	SN35	638	SIGNING & PAVEMENT MARKING PL DETAILS	21100	669	SIGNING & PAVEMENT MARKIN FIFTH AVE - STA 561+50 TO S	STA 566+50	LP3	697	LIGHTING PLANS DETAIL SHEET
16_n	SN5	608	SIGNING & PAVEMENT MARKING PLANS TABULATION SHEET	SN36	639	SIGNING & PAVEMENT MARKING PL DETAILS	2001	670	SIGNING & PAVEMENT MARKIN FORBES AVE - STA 122+00 TO	STA 128+00	LP4	698	LIGHTING PLANS DETAIL SHEET
om_ds	SN6	609	SIGNING & PAVEMENT MARKING PLANS TABULATION SHEET	SN37	640	SIGNING & PAVEMENT MARKING PL DETAILS	2008	671	SIGNING & PAVEMENT MARKIN FORBES AVE - STA 128+00 TO	STA 133+50	LP5	699	LIGHTING PLANS DETAIL SHEET
)\dec	SN7	610	SIGNING & PAVEMENT MARKING PLANS TABULATION SHEET	SN38	641	SIGNING & PAVEMENT MARKING PL DETAILS	ANS SN69	672	SIGNING & PAVEMENT MARKIN FORBES AVE - STA 133+50 TO		LP6	700	LIGHTING PLANS DETAIL SHEET
7king√													
- wwo										DESIGNED JMS		POR	RT AUTHORITY OF ALLEGHENY COUNTY
် ဗု	A	EC				F	THE PREPARATION OF THIS DOCUMENT HAS BEEN FINANCE PART THROUGH A GRANT FRON	N THE	(NOT FOR	DRAWN JMS		PITTSB	
E PAIH:		Gulf Tow	rer				FEDERAL TRANSIT ADMINISTRA J.S. DEPARTMENT OF TRANSPORTATION, UNDER THE		CONSTRUCTION)	IN CHARGE LAR			INDEX OF DRAWINGS
1 LE		7 Grant S 5th Floo	or	NO. DATE		DESCRIPTION F	JRBAN MASS TRANSPORTATION OF 1964, AS AMENDED, FOR THE PORT AUTHORITY OF ALLEGHEN	E I	CONSTRUCTION)	DATE <u>05/01/24</u> SCALE		Dort A	
	Pitts	burgh, P	A 15219	DATE			COUNTY, PENNSYLVANIA.	-		AS SHOW	'N	FUIL A	Authority CONTRACT NO. BRT-001  DWG. NO. GN8 SHT. 8

	AWING JMBER	SHEET NUMBER	TITLE	DRAWING NUMBER	SHEET NUMBER	TITLE	DRAWING NUMBER	SHEET NUMBER	TITLE	DRAWING NUMBER	SHEET NUMBER	TITLE
PLOTT			LIGHTING PLANS (CONT'D)			LIGHTING PLANS (CONT'D)			ARCHITECTURAL PLANS (CONT'D)			STRUCTURAL PLANS (CONT'D)
	LP7	701	LIGHTING PLANS FIFTH AVE - STA 433+50 TO STA 438+50	LP38	732	LIGHTING PLANS FORBES AVE - STA 159+50 TO STA 164+50	AR032	761	ARCHITECTURAL PLANS 22 SOHO STATION-OVERALL SITE PLAN	ST6	790	STRUCTURAL PLANS BUS STATION 60' - PART 1
	LP8	702	LIGHTING PLANS FIFTH AVE - STA 438+50 TO STA 443+50	LP39	733	LIGHTING PLANS FORBES AVE - STA 164+50 TO STA 169+50	AR033	762	ARCHITECTURAL PLANS 23 WEST OAKLAND STATION-OVERALL SITE PLAN	ST7	791	STRUCTURAL PLANS BUS STATION 60' - PART 2
	LP9	703	LIGHTING PLANS FIFTH AVE - STA 443+50 TO STA 448+50	LP40	734	LIGHTING PLANS FORBES AVE - STA 169+50 TO STA 173+50	ARO34	763	ARCHITECTURAL PLANS 24 MCKEE PL STATION-OVERALL SITE PLAN	ST8	792	STRUCTURAL PLANS BUS STATION 60′ - PART 3
L	.P10	704	LIGHTING PLANS FIFTH AVE - STA 448+50 TO STA 454+50	LP41	735	LIGHTING PLANS FORBES AVE - STA 173+50 TO STA 177+50	AR035	764	ARCHITECTURAL PLANS 25 CENTRAL OAKLAND STATION-OVERALL SITE PLAN-PART	1 ST9	793	STRUCTURAL PLANS BUS STATION TABLES
L	_P11	705	LIGHTING PLANS FIFTH AVE - STA 454+50 TO STA 458+50	LP42	736	LIGHTING PLANS FORBES AVE - STA 177+50 TO STA 182+50	AR036	765	ARCHITECTURAL PLANS 25 CENTRAL OAKLAND STATION-OVERALL SITE PLAN-PART	2 ST10	794	STRUCTURAL PLANS DRAINAGE DETAILS - PART 1
L	.P12	706	LIGHTING PLANS FIFTH AVE - STA 458+50 TO STA 464+50	LP43	737	LIGHTING PLANS FORBES AVE - STA 207+50 TO STA 213+50	AR037	766	ARCHITECTURAL PLANS 26 BIGELOW BLVD STATION-OVERALL SITE PLAN-PART	1 ST11	795	STRUCTURAL PLANS DRAINAGE DETAILS - PART 2
L	.P13	707	LIGHTING PLANS FIFTH AVE - STA 464+50 TO STA 470+50	LP44	738	LIGHTING PLANS FORBES AVE - STA 213+50 TO STA 217+50	ARO38	767	ARCHITECTURAL PLANS 26 BIGELOW BLVD STATION-OVERALL SITE PLAN-PART	ST12	796	STRUCTURAL PLANS MISC DETAILS
L	.P14	708	LIGHTING PLANS FIFTH AVE - STA 470+50 TO STA 475+50	LP45	739	LIGHTING PLANS FORBES AVE - STA 221+50 TO STA 227+00	AR095	768	ARCHITECTURAL PLANS WINDSCREEN TYPES	ST13	797	STRUCTURAL PLANS VAULT HATCH CLOSURE SLAB
L	.P15	709	LIGHTING PLANS FIFTH AVE - STA 475+50 TO STA 480+50	LP46	740	LIGHTING PLANS FORBES AVE - STA 232+00 TO STA 237+50	AR096	769	ARCHITECTURAL PLANS WINDSCREEN SCHEDULES	ST14	798	STRUCTURAL PLANS VAULT SLAB PARTIAL REMOVAL
L	.P16	710	LIGHTING PLANS FIFTH AVE - STA 480+50 TO STA 485+50	LP47	741	LIGHTING PLANS FORBES AVE - STA 242+50 TO STA 247+50	AR102	770	ARCHITECTURAL PLANS 30' SHELTER ENLARGED PLAN, ROOF PLAN, AND RCP	ST15	799	STRUCTURAL PLANS SLAB MODIFICATIONS - OVERLAY
	P17	711	LIGHTING PLANS FIFTH AVE - STA 485+50 TO STA 490+50	LP48	742	LIGHTING PLANS FORBES AVE - STA 247+50 TO STA 251+50	AR103	771	ARCHITECTURAL PLANS 30' SHELTER ELEVATIONS	ST16	800	STRUCTURAL PLANS SLAB MODIFICATIONS - SIDEWALK SLAB
L	P18	712	LIGHTING PLANS FIFTH AVE - STA 490+50 TO STA 496+50	LP49	743	LIGHTING PLANS FORBES AVE - STA 251+50 TO STA 256+50	AR104	772	ARCHITECTURAL PLANS 60' SHELTER ENLARGED PLAN, ROOF PLAN, AND RCP	ST17	801	STRUCTURAL PLANS VAULT BACKFILL – PART 1
L	.P19	713	LIGHTING PLANS FIFTH AVE - STA 496+50 TO STA 502+50				AR105	773	ARCHITECTURAL PLANS 60' SHELTER ELEVATIONS	ST18	802	STRUCTURAL PLANS VAULT BACKFILL – PART 2
L	.P20	714	LIGHTING PLANS FIFTH AVE - STA 502+50 TO STA 507+50			ARCHITECTURAL PLANS	AR106	774	ARCHITECTURAL PLANS-30' GULLWING SHELTER ENLARGED PLAN, ROOF PLAN AND RCP	ST19	803	STRUCTURAL PLANS VAULT BACKFILL – PART 3
L	_P21	715	LIGHTING PLANS FIFTH AVE - STA 507+50 TO STA 513+50	AR001	744	ARCHITECTURAL PLANS ABBREVIATIONS AND SYMBOLS	AR107	775	ARCHITECTURAL PLANS 30' GULLWING SHELTER ELEVATIONS	ST20	804	STRUCTURAL PLANS VAULT HATCH REMOVAL
L	.P22	716	LIGHTING PLANS FIFTH AVE - STA 513+50 TO STA 517+50	AR002	745	ARCHITECTURAL PLANS-GENERAL NOTES, APPLICAL CODES AND STANDARDS, AND CODE SUMMARY	BLE AR200	776	ARCHITECTURAL PLANS TYPICAL SHELTER SECTIONS	ST21	805	STRUCTURAL PLANS VAULT HATCH REPLACEMENT - PART 1
ngb .7	.P23	717	LIGHTING PLANS FIFTH AVE - STA 517+50 TO STA 522+50	AR003	746	ARCHITECTURAL PLANS SHELTER SIZE AND AMENITIES SCHEDULE	AR201	777	ARCHITECTURAL PLANS TYPICAL SHELTER SECTIONS	ST22	806	STRUCTURAL PLANS VAULT HATCH REPLACEMENT - PART 2
1000 r	.P24	718	LIGHTING PLANS FIFTH AVE - STA 522+50 TO STA 528+50	ARO16	747	ARCHITECTURAL PLANS 6 UPTOWN WEST STATION-OVERALL SITE PLAN	AR300	778	ARCHITECTURAL PLANS SHELTER CANOPY DETAILS	ST23	807	STRUCTURAL PLANS VAULT SLAB REMOVAL - FORBES AVE STA 163+90.86
-RD	.P25	719	LIGHTING PLANS FIFTH AVE - STA 528+50 TO STA 534+50	ARO17	748	ARCHITECTURAL PLANS 7 PRIDE ST STATION-OVERALL SITE PLAN	AR310	779	ARCHITECTURAL PLANS SHELTER WINDSCREEN DETAILS	ST24	808	STRUCTURAL PLANS VAULT SLAB MODIFICATION - FORBES AVE STA 163+90.86
RT_0	.P26	720	LIGHTING PLANS FIFTH AVE - STA 534+50 TO STA 540+50	ARO18	749	ARCHITECTURAL PLANS 8 UPTOWN CENTRAL STATION-OVERALL SITE PLA	AN AR311	780	ARCHITECTURAL PLANS SHELTER WINDSCREEN DETAILS	ST25	809	STRUCTURAL PLANS VAULT DETAILS - FORBES AVE STA 163+90.86
8/00/B	.P27	721	FIFTH AVE - STA 540+50 TO STA 545+50	AR019	750	ARCHITECTURAL PLANS 9 JUMONVILLE ST STATION-OVERALL SITE PLAN	N AR320	781	ARCHITECTURAL PLANS SHELTER SERVICE CARRIER DETAILS	ST26	810	STRUCTURAL PLANS VAULT SLAB REMOVAL - FIFTH AVE STA 437+12.03
10207	.P28	722	LIGHTING PLANS FIFTH AVE - STA 545+50 TO STA 551+50	AR020	751	ARCHITECTURAL PLANS 10 SOHO STATION-OVERALL SITE PLAN	AR330	782	ARCHITECTURAL PLANS SIGNAGE & WAYFINDING	ST27	811	STRUCTURAL PLANS VAULT SLAB REPLACEMENT - FIFTH AVE STA 437+12.03
P/moc	.P29	723	LIGHTING PLANS FIFTH AVE - STA 551+50 TO STA 555+50	AR021	752	ARCHITECTURAL PLANS 11 WEST OAKLAND STATION-OVERALL SITE PLA	AN AR331	783	ARCHITECTURAL PLANS SHELTER SIGNAGE DETAILS	ST28	812	STRUCTURAL PLANS VAULT SLAB REMOVAL - FIFTH AVE STA 442+54.33
E L	.P30	724	LIGHTING PLANS FIFTH AVE - STA 555+50 TO STA 561+50	AR022	753	ARCHITECTURAL PLANS 12 CHESTERFIELD RD STATION-OVERALL SITE P	LAN AR340	784	ARCHITECTURAL PLANS MISC SHELTER & WINDSCREEN DETAILS	ST29	813	STRUCTURAL PLANS VAULT SLAB REPLACEMENT - FIFTH AVE STA 442+54.33
ch@de	_P31	725	FIFTH AVE - STA 561+50 TO STA 566+50	AR023	754	ARCHITECTURAL PLANS 13 ATWOOD STATION-OVERALL SITE PLAN				ST30	814	VAULT SLAB REMOVAL - FIFTH AVE STA 469+59.93
·- o	.P32	726	LIGHTING PLANS FORBES AVE - STA 128+00 TO STA 133+50	AR024	755	ARCHITECTURAL PLANS 14 BIGELOW BLVD STATION-OVERALL SITE PLAN ARCHITECTURAL PLANS	N		STRUCTURAL PLANS	ST31	815	VAULT SLAB REPLACEMENT - FIFTH AVE STA 469+59.93
Sep.	.P33	727	LIGHTING PLANS FORBES AVE - STA 133+50 TO STA 138+50	AR025	756	ARCHITECTURAL PLANS 15 TENNYSON AVE STATION-OVERALL SITE PLA		785	STRUCTURAL PLANS GENERAL NOTES STRUCTURAL PLANS	ST32	816	STRUCTURAL PLANS VAULT SLAB REPLACEMENT DETAILS
[ D	.P34	728	LIGHTING PLANS FORBES AVE - STA 138+50 TO STA 143+50	AR028	757	ARCHITECTURAL PLANS 18 UPTOWN WEST STATION-OVERALL SITE PLAN ARCHITECTURAL PLANS		786	SIRUCTURAL PLANS QUANTITIES STRUCTURAL PLANS	ST33	817	STRUCTURAL PLANS DLC VAULT SLAB REMOVAL - FIFTH AVE STA 438+14
s16	.P35	729	LIGHTING PLANS FORBES AVE - STA 143+50 TO STA 149+50 LIGHTING PLANS	AR029	758	ARCHITECTURAL PLANS 19 PRIDE ST STATION-OVERALL SITE PLAN ARCHITECTURAL PLANS	ST3	787	TYPICAL SLAB SECTIONS  STRUCTURAL PLANS	ST34	818	STRUCTURAL PLANS  DLC VAULT SLAB REPLACEMENT 1 - FIFTH AVE STA 438+14
Ü,	.P36	730	FORBES AVE - STA 149+50 TO STA 154+50  LIGHTING PLANS	AR030	759	20 UPTOWN CENTRAL STATION-OVERALL SITE PL		788	BUS STATION 30' - PART 1 STRUCTURAL PLANS	ST35	819	STRUCTURAL PLANS DLC VAULT SLAB REPLACEMENT 2 - FIFTH AVE STA 438+14
	.P37	731	FORBES AVE - STA 154+50 TO STA 159+50	AR031	760	21 JUMONVILLE ST STATION-OVERALL SITE PL	AN ST5	789	BUS STATION 30' - PART 2	ST36	820	STRUCTURAL PLANS DLC VAULT SLAB REMOVAL - FIFTH AVE STA 441+69
silich"												
			NA 4			THE DREE	PARATION OF THIS			<u> </u> <u>MS</u>		ORT AUTHORITY OF ALLEGHENY COUNTY
OPERATOR: "joseph. File Path: c:\pww	A	ECC	<i>)M</i> I			DOCUMEN PART THE	NT HAS BEEN FINANCE ROUGH A GRANT FROM TRANSIT ADMINISTRA	M THE		MS ES	_	TSBURGH PENNSYLVANIA BUS RAPID TRANSIT UPTOWN TO OAKLAND
E PA	7	Gulf Towe 07 Grant St				U.S. DEPA TRANSPO	ARTMENT OF DRTATION, UNDER THE ASS TRANSPORTATIO			<u>AR</u> 5/01/24	_	INDEX OF DRAWINGS
OPE F IL		5th Floor		NO. DATE		OF 1964, A DESCRIPTION PORT AUT	ASS TRANSPORTATIO AS AMENDED, FOR THI THORITY OF ALLEGHE PENNSYLVANIA.	E I	SCALE	6HOWN	Port	Authority CONTRACT NO. BRT-001
	riili	sburgh, PA	10218			REVISIONS	F LINING I LVAINIA.			A IOVVIV	010	connecting people to life DWG. NO. GN9 SHT. 9

	AWING JMBER	SHEET NUMBER	TITLE	DRAWING NUMBER	SHEET NUMBER	TITLE	DRAWING NUMBER	SHEET NUMBER	TITLE	DRAWING NUMBER		TITLE
PLOTI			STRUCTURAL PLANS (CONT'D)			STATION TAP IN PLANS (CO	NT′D)		CONTROL SYSTEMS PLANS (	CONT'D)		CONTROL SYSTEMS PLANS (CONT'D)
	ST37	821	STRUCTURAL PLANS DLC VAULT SLAB REPLACEMENT 1 - FIFTH AVE STA 441+69	TI4	847	STATION TAP IN PLANS JUMONVILLE STATION	CS24	876	CONTROL SYSTEMS PLANS GENERAL NOTES	CS55	907	CONTROL SYSTEMS PLANS FORBES AVE - STA 169+50 TO STA 173+50
	ST38	822	STRUCTURAL PLANS DLC VAULT SLAB REPLACEMENT 2 - FIFTH AVE STA 441+69	T15	848	STATION TAP IN PLANS SOHO STATION	CS25	877	CONTROL SYSTEMS PLANS SPECIAL DETAILS	CS56	908	CONTROL SYSTEMS PLANS FORBES AVE - STA 173+50 TO STA 177+50
	ST39	823	STRUCTURAL PLANS DLC VAULT SLAB REMOVAL - FIFTH AVE STA 443+11	T16	849	STATION TAP IN PLANS WEST OAKLAND STATION	CS26	878	CONTROL SYSTEMS PLANS TABULATION SHEET	CS57	909	CONTROL SYSTEMS PLANS FORBES AVE - STA 177+50 TO STA 182+50
	ST40	824	STRUCTURAL PLANS DLC VAULT SLAB REPLACEMENT 1 - FIFTH AVE STA 443+11	TI7	850	STATION TAP IN PLANS CHESTERFIELD STATION	CS27	879	CONTROL SYSTEMS PLANS TABULATION SHEET	CS58	910	CONTROL SYSTEMS PLANS FORBES AVE - STA 207+50 TO STA 213+50
	ST41	825	STRUCTURAL PLANS DLC VAULT SLAB REPLACEMENT 2 - FIFTH AVE STA 443+11	TI8	851	STATION TAP IN PLANS BIGELOW STATION	CS28	880	CONTROL SYSTEMS PLANS FIFTH AVE - STA 438+50 TO STA		911	CONTROL SYSTEMS PLANS FORBES AVE - STA 221+50 TO STA 227+00
	ST42	826	STRUCTURAL PLANS VAULT SLAB MODIFICATION - MISC DETAILS	T19	852	STATION TAP IN PLANS TENNYSON STATION	CS29	881	CONTROL SYSTEMS PLANS FIFTH AVE - STA 443+50 TO STA		912	CONTROL SYSTEMS PLANS FORBES AVE - STA 232+00 TO STA 237+50
	ST43	827	STRUCTURAL PLANS KIRKPATRICK WALL – GENERAL PLAN				CS30	882	CONTROL SYSTEMS PLANS FIFTH AVE - STA 448+50 TO STA		913	CONTROL SYSTEMS PLANS FORBES AVE - STA 242+50 TO STA 247+50
	ST44	828	STRUCTURAL PLANS KIRKPATRICK WALL - TYPICAL SECTION			CONTROL SYSTEMS PLANS	S CS31	883	CONTROL SYSTEMS PLANS FIFTH AVE - STA 454+50 TO STA			
	ST45	829	STRUCTURAL PLANS KIRKPATRICK WALL - ELEVATION 1	CS1	853	CONTROL SYSTEMS PLANS SYSTEMS GENERAL NOTES	CS32	884	CONTROL SYSTEMS PLANS FIFTH AVE - STA 458+50 TO STA		MAINTEN	NANCE & PROTECTION OF TRAFFIC PLANS
	ST46	830	STRUCTURAL PLANS KIRKPATRICK WALL - ELEVATION 2	CS2	854	CONTROL SYSTEMS PLANS SYSTEMS SHELTER COMUNICATIONS OVE	RVIEW CS33	885	CONTROL SYSTEMS PLANS FIFTH AVE - STA 464+50 TO STA		914	MAINTENANCE & PROTECTION OF TRAFFIC PLANS GENERAL NOTES
	ST47	831	STRUCTURAL PLANS KIRKPATRICK WALL - FOOTING PLAN	CS3	855	CONTROL SYSTEMS PLANS SYSTEMS BRT BLOCK DIAGRAM	CS34	886	CONTROL SYSTEMS PLANS FIFTH AVE - STA 470+50 TO STA		915	MAINTENANCE & PROTECTION OF TRAFFIC PLANS GENERAL NOTES
	ST48	832	STRUCTURAL PLANS KIRKPATRICK WALL - WALL DETAILS 1	CS4	856	CONTROL SYSTEMS PLANS PITT TOWER BLOCK DIAGRAM	CS35	887	CONTROL SYSTEMS PLANS FIFTH AVE - STA 475+50 TO STA		916	MAINTENANCE & PROTECTION OF TRAFFIC PLANS GENERAL NOTES
	ST49	833	STRUCTURAL PLANS OFFSET POLE FOUNDATIONS - PART 1	CS5	857	CONTROL SYSTEMS PLANS PITT TOWER PLAN	CS36	888	CONTROL SYSTEMS PLANS FIFTH AVE - STA 480+50 TO STA		917	MAINTENANCE & PROTECTION OF TRAFFIC PLANS INDEX SHEET
	ST50	834	STRUCTURAL PLANS OFFSET POLE FOUNDATIONS - PART 2	CS6	858	CONTROL SYSTEMS PLANS PITT TOWER EQUIPMENT RACK ELEVA	TION CS37	889	CONTROL SYSTEMS PLANS FIFTH AVE - STA 485+50 TO STA		918	MAINTENANCE & PROTECTION OF TRAFFIC PLANS INDEX SHEET
				CS7	859	CONTROL SYSTEMS PLANS TICKET VENDING MACHINE DETAILS SH	EET 01 CS38	890	CONTROL SYSTEMS PLANS FIFTH AVE - STA 490+50 TO STA		919	MAINTENANCE & PROTECTION OF TRAFFIC PLANS INDEX SHEET
			STATION ELECTRICAL PLANS	CS8	860	CONTROL SYSTEMS PLANS TICKET VENDING MACHINE DETAILS SH	EET 02 CS39	891	CONTROL SYSTEMS PLANS FIFTH AVE - STA 496+50 TO STA		920	MAINTENANCE & PROTECTION OF TRAFFIC PLANS INDEX SHEET
ngb.	EL1	835	STATION ELECTRICAL PLANS STATION TRACKER - CONSTRUCTION DATA	CS9	861	CONTROL SYSTEMS PLANS TICKET VALIDATOR DETAILS	CS40	892	CONTROL SYSTEMS PLANS FIFTH AVE - STA 502+50 TO STA		921	MAINTENANCE & PROTECTION OF TRAFFIC PLANS TABULATION SHEET
0008	EL2	836	STATION ELECTRICAL PLANS GENERAL ELECTRICAL NOTES	CS10	862	CONTROL SYSTEMS PLANS SYSTEM REAL TIME SIGN DETAILS SHE	EET 01 CS41	893	CONTROL SYSTEMS PLANS FIFTH AVE - STA 507+50 TO STA		922	MAINTENANCE & PROTECTION OF TRAFFIC PLANS TABULATION SHEET
-RD- I	EL3	837	STATION ELECTRICAL PLANS TYPICAL STATION PLAN & ELEVATION - 30 & 60 FT	CS11	863	CONTROL SYSTEMS PLANS SYSTEM REAL TIME SIGN DETAILS SHE	ET 02 CS42	894	CONTROL SYSTEMS PLANS FIFTH AVE - STA 513+50 TO STA		923	MAINTENANCE & PROTECTION OF TRAFFIC PLANS TABULATION SHEET
T01	EL4	838	STATION ELECTRICAL PLANS TYPICAL STATION PLAN & ELEVATION - 30 & 60 FT	CS12	864	CONTROL SYSTEMS PLANS SYSTEM REAL TIME SIGN DETAILS SHE	ET 03 CS43	895	CONTROL SYSTEMS PLANS FIFTH AVE - STA 522+50 TO STA		924	MAINTENANCE & PROTECTION OF TRAFFIC PLANS TABULATION SHEET
00\BF	EL5	839	STATION ELECTRICAL PLANS MISCELLANEOUS ELECTRICAL DETAILS	CS13	865	CONTROL SYSTEMS PLANS EMERGENCY CALL STATION DETAIL	.S CS44	896	CONTROL SYSTEMS PLANS FIFTH AVE - STA 528+50 TO STA		925	MAINTENANCE & PROTECTION OF TRAFFIC PLANS TABULATION SHEET
72077	EL6	840	STATION ELECTRICAL PLANS PANEL SCHEDULES - STATIONS 6 THRU 11	CS14	866	CONTROL SYSTEMS PLANS CCTV MOUNTING DETAILS	CS45	897	CONTROL SYSTEMS PLANS FIFTH AVE - STA 534+50 TO STA		926	MAINTENANCE & PROTECTION OF TRAFFIC PLANS TABULATION SHEET
)p\mo	EL7	841	STATION ELECTRICAL PLANS PANEL SCHEDULES - STATIONS 12 THRU 15	CS15	867	CONTROL SYSTEMS PLANS SYSTEM CABINET DETAILS	CS46	898	CONTROL SYSTEMS PLANS EXISTING ATWOOD STATION		927	MAINTENANCE & PROTECTION OF TRAFFIC PLANS TABULATION SHEET
o illo	EL8	842	STATION ELECTRICAL PLANS PANEL SCHEDULES - STATIONS 18 THRU 23	CS16	868	CONTROL SYSTEMS PLANS SYSTEMS 60' INBOUND EQUIPMENT P	PLAN CS47	899	CONTROL SYSTEMS PLANS FIFTH AVE - STA 545+50 TO STA	x 551+50 MT15	928	MAINTENANCE & PROTECTION OF TRAFFIC PLANS TABULATION SHEET
н@дес	EL9	843	STATION ELECTRICAL PLANS PANEL SCHEDULES - STATIONS 24 THRU 26	CS17	869	CONTROL SYSTEMS PLANS SYSTEMS 60' SPECIAL CASE EQUIPMEN	T PLAN CS48	900	CONTROL SYSTEMS PLANS FIFTH AVE - STA 555+50 TO STA	A 561+50 MT16	929	MAINTENANCE & PROTECTION OF TRAFFIC PLANS TABULATION SHEET
				CS18	870	CONTROL SYSTEMS PLANS SYSTEMS 30' INBOUND EQUIPMENT F	PLAN CS49	901	CONTROL SYSTEMS PLANS FORBES AVE - STA 128+00 TO STA		930	MAINTENANCE & PROTECTION OF TRAFFIC PLANS CONSTRUCTION SEQUENCE
eph.			STATION TAP IN PLANS	CS19	871	CONTROL SYSTEMS PLANS SYSTEMS 30' INBOUND CONDUIT PL	.AN CS50	902	CONTROL SYSTEMS PLANS FORBES AVE - STA 143+50 TO STA	A 149+50 MT18	931	MAINTENANCE & PROTECTION OF TRAFFIC PLANS CONSTRUCTION SEQUENCE
1/108	TI1	844	STATION TAP IN PLANS LOCATION MAP	CS20	872	CONTROL SYSTEMS PLANS SYSTEMS 30' OUTBOUND CONDUIT P	LAN CS51	903	CONTROL SYSTEMS PLANS FORBES AVE - STA 149+50 TO STA	A 154+50 MT19	932	MAINTENANCE & PROTECTION OF TRAFFIC PLANS CONSTRUCTION SEQUENCE
16_nc	TI2	845	STATION TAP IN PLANS TAP IN DETAILS	CS21	873	CONTROL SYSTEMS PLANS SYSTEMS 30' INBOUND CONDUIT PL	.AN CS52	904	CONTROL SYSTEMS PLANS FORBES AVE - STA 154+50 TO STA	A 159+50	933	MAINTENANCE & PROTECTION OF TRAFFIC PLANS CONSTRUCTION SEQUENCE
sp 'w	TI3	846	STATION TAP IN PLANS TAP IN DETAILS	CS22	874	CONTROL SYSTEMS PLANS SYSTEMS 30' OUTBOUND CONDUIT P	LAN CS53	905	CONTROL SYSTEMS PLANS FORBES AVE - STA 159+50 TO STA	A 164+50	934	MAINTENANCE & PROTECTION OF TRAFFIC PLANS CONSTRUCTION SEQUENCE
DO D				CS23	875	CONTROL SYSTEMS PLANS SYSTEMS EQUIPMENT CABINET LAYOUT (1	TYPICAL) CS54	906	CONTROL SYSTEMS PLANS FORBES AVE - STA 164+50 TO STA	A 169+50 MT22	935	MAINTENANCE & PROTECTION OF TRAFFIC PLANS CONSTRUCTION SEQUENCE
silich" orking\												
ċ ≹ —										DESIGNED <u>JMS</u>	DO.	RT AUTHORITY OF ALLEGHENY COUNTY
"josepl	$\Delta$	<b>EC</b>	OM			[	THE PREPARATION OF THIS DOCUMENT HAS BEEN FINANCE PART THROUGH A GRANT FROM			DRAWN JMS	PITTS	BURGH PENNSYLVANIA
RATOR: E PATH:		Gulf To	wer			F	EDERAL TRANSIT ADMINISTRA J.S. DEPARTMENT OF TRANSPORTATION, UNDER THE	TION,	(11011011	CHECKED <u>MES</u> IN CHARGE <u>LAR</u>		US RAPID TRANSIT UPTOWN TO OAKLAND INDEX OF DRAWINGS
OPER/ FILE		07 Grant 5th Flo	oor	NO. DATE		Į.	JRBAN MASS TRANSPORTATION DF 1964, AS AMENDED, FOR THE PORT AUTHORITY OF ALLEGHEN	=		DATE <u>05/01/24</u> SCALE	Dart	
	Pitts	sburgh, P		NO. DATE		REVISIONS	COUNTY, PENNSYLVANIA.			AS SHOWN	rutt	Authority CONTRACT NO. BRT-001  DWG. NO. GN10 SHT. 10

	AWING JMBER	SHEET NUMBER	TITLE	DRAW NUME		TITLE		NING SHE BER NUME	ET BER TITLE		DRAWING NUMBER	SHEET NUMBER	TITLE
PLOTT	MAINTE	ENANCE 8	& PROTECTION OF TRAFFIC PLANS (CON	<u>Γ΄ D)</u> ΜΑ	INTENANCE	& PROTECTION OF TRAFFIC PLANS	(CONT'D) MA	AINTENAN	CE & PROTECTION OF TRAFFIC PL	ANS (CONT'D)	MAINTE	NANCE &	PROTECTION OF TRAFFIC PLANS (CONT'D)
	MT23	936	MAINTENANCE & PROTECTION OF TRAFFIC PLAN CONSTRUCTION SEQUENCE	S MT5	967	MAINTENANCE & PROTECTION OF TRAFFIC F PHASE 1A / SIXTH AVE - STA 428+50 TO STA	PLANS A 433+50 MT	85 99	8 MAINTENANCE & PROTECTION OF TR PHASE 1D / FIFTH AVE - STA 555+50	AFFIC PLANS TO STA 561+50	MT116	1029	MAINTENANCE & PROTECTION OF TRAFFIC PLANS PHASE 1A / FORBES AVE - STA 169+50 TO STA 173+50
	MT24	937	MAINTENANCE & PROTECTION OF TRAFFIC PLAN CONSTRUCTION SEQUENCE	S MT5	55 968	MAINTENANCE & PROTECTION OF TRAFFIC F PHASE 2A / FIFTH AVE - STA 433+50 TO STA	PLANS A 438+50 MT	86 99	9 MAINTENANCE & PROTECTION OF TR PHASE 1D / FIFTH AVE - STA 561+50	AFFIC PLANS TO STA 566+50	MT117	1030	MAINTENANCE & PROTECTION OF TRAFFIC PLANS PHASE 1A / FORBES AVE - STA 173+50 TO STA 177+50
	MT25	938	MAINTENANCE & PROTECTION OF TRAFFIC PLAN CONSTRUCTION SEQUENCE	S MT5	66 969	MAINTENANCE & PROTECTION OF TRAFFIC F PHASE 2A / FIFTH AVE - STA 438+50 TO STA	PLANS A 443+50 MT	87 100	MAINTENANCE & PROTECTION OF TR PHASE 2A / FIFTH AVE - STA 490+50	AFFIC PLANS TO STA 496+50	MT118	1031	MAINTENANCE & PROTECTION OF TRAFFIC PLANS PHASE 1A / FORBES AVE - STA 177+50 TO STA 182+50
N	IT26	939	MAINTENANCE & PROTECTION OF TRAFFIC PLAN SIGN FABRICATION DETAILS	S MT5	970	MAINTENANCE & PROTECTION OF TRAFFIC F PHASE 2A / FIFTH AVE - STA 443+50 TO STA	PLANS A 448+50 MT	88 100	MAINTENANCE & PROTECTION OF TR PHASE 2A / FIFTH AVE - STA 496+50	AFFIC PLANS TO STA 502+50	MT119	1032	MAINTENANCE & PROTECTION OF TRAFFIC PLANS PHASE 1B / FORBES AVE - STA 138+50 TO STA 143+50
	MT27	940	MAINTENANCE & PROTECTION OF TRAFFIC PLAN DETAILS	S MT5	58 971	MAINTENANCE & PROTECTION OF TRAFFIC F PHASE 2A / FIFTH AVE - STA 448+50 TO STA	PLANS A 454+50 MT	89 100	MAINTENANCE & PROTECTION OF TR PHASE 2A / FIFTH AVE - STA 502+50		MT120	1033	MAINTENANCE & PROTECTION OF TRAFFIC PLANS PHASE 1B / FORBES AVE - STA 143+50 TO STA 149+50
	IT28	941	MAINTENANCE & PROTECTION OF TRAFFIC PLAN DETAILS	S MT5	972	MAINTENANCE & PROTECTION OF TRAFFIC F PHASE 2A / FIFTH AVE - STA 454+50 TO STA	PLANS A 458+50 MT	90 100	MAINTENANCE & PROTECTION OF TR PHASE 2A / FIFTH AVE - STA 507+50		MT121	1034	MAINTENANCE & PROTECTION OF TRAFFIC PLANS PHASE 1B / FORBES AVE - STA 149+50 TO STA 154+50
N	MT29	942	MAINTENANCE & PROTECTION OF TRAFFIC PLAN DETAILS	S МТ6	50 973	MAINTENANCE & PROTECTION OF TRAFFIC F PHASE 2B / FIFTH AVE - STA 454+50 TO STA	PLANS A 458+50 MT	91 100	MAINTENANCE & PROTECTION OF TR PHASE 2B / FIFTH AVE - STA 507+50		MT122	1035	MAINTENANCE & PROTECTION OF TRAFFIC PLANS PHASE 1B / FORBES AVE - STA 154+50 TO STA 159+50
N	1T30	943	MAINTENANCE & PROTECTION OF TRAFFIC PLAN DETAILS	S МТ6	51 974	MAINTENANCE & PROTECTION OF TRAFFIC F PHASE 2B / FIFTH AVE - STA 458+50 TO STA	PLANS A 464+50 MT	92 100	MAINTENANCE & PROTECTION OF TR PHASE 2B / FIFTH AVE - STA 513+50		MT123	1036	MAINTENANCE & PROTECTION OF TRAFFIC PLANS PHASE 1B / FORBES AVE - STA 159+50 TO STA 164+50
	AT31	944	MAINTENANCE & PROTECTION OF TRAFFIC PLAN DETAILS	S мте	52 975	MAINTENANCE & PROTECTION OF TRAFFIC F PHASE 2B / FIFTH AVE - STA 464+50 TO STA	PLANS A 470+50 MT	93 100	MAINTENANCE & PROTECTION OF TR PHASE 2B / FIFTH AVE - STA 517+50	AFFIC PLANS TO STA 522+50	MT124	1037	MAINTENANCE & PROTECTION OF TRAFFIC PLANS PHASE 1B / FORBES AVE - STA 164+50 TO STA 169+50
1	MT32	945	MAINTENANCE & PROTECTION OF TRAFFIC PLAN DETAILS	S мте	3 976	MAINTENANCE & PROTECTION OF TRAFFIC F PHASE 2B / FIFTH AVE - STA 470+50 TO STA	PLANS A 475+50 MT	94 100	MAINTENANCE & PROTECTION OF TR PHASE 2B / FIFTH AVE - STA 522+50	AFFIC PLANS TO STA 528+50	MT125	1038	MAINTENANCE & PROTECTION OF TRAFFIC PLANS PHASE 1C / FORBES AVE - STA 119+00 TO STA 122+00
1	MT33	946	MAINTENANCE & PROTECTION OF TRAFFIC PLAN DETAILS	S мте	977	MAINTENANCE & PROTECTION OF TRAFFIC F PHASE 2B / FIFTH AVE - STA 475+50 TO ST	PLANS A 481+50 MT	95 100	MAINTENANCE & PROTECTION OF TR PHASE 2C / FIFTH AVE - STA 522+50	AFFIC PLANS TO STA 528+50	MT126	1039	MAINTENANCE & PROTECTION OF TRAFFIC PLANS PHASE 1C / FORBES AVE - STA 122+00 TO STA 128+00
1	1T34	947	MAINTENANCE & PROTECTION OF TRAFFIC PLAN DETAILS	S мте	55 978	MAINTENANCE & PROTECTION OF TRAFFIC F PHASE 2C / FIFTH AVE - STA 470+50 TO ST		96 100	MAINTENANCE & PROTECTION OF TR PHASE 2C / FIFTH AVE - STA 528+50		MT127	1040	MAINTENANCE & PROTECTION OF TRAFFIC PLANS PHASE 1C / FORBES AVE - STA 128+00 TO STA 133+50
1	1T35	948	MAINTENANCE & PROTECTION OF TRAFFIC PLAN DETAILS	S МТ6	66 979	MAINTENANCE & PROTECTION OF TRAFFIC F PHASE 2C / FIFTH AVE - STA 475+50 TO STA	PLANS A 480+50 MT	97 101	O MAINTENANCE & PROTECTION OF TR PHASE 2C / FIFTH AVE - STA 534+50		MT128	1041	MAINTENANCE & PROTECTION OF TRAFFIC PLANS PHASE 1C / FORBES AVE - STA 133+50 TO STA 138+50
N	1T36	949	MAINTENANCE & PROTECTION OF TRAFFIC PLAN DETAILS	S МТ6	980	MAINTENANCE & PROTECTION OF TRAFFIC F PHASE 2C / FIFTH AVE - STA 480+50 TO STA		98 10	MAINTENANCE & PROTECTION OF TR PHASE 2C / FIFTH AVE - STA 540+50		MT129	1042	MAINTENANCE & PROTECTION OF TRAFFIC PLANS PHASE 1C / FORBES AVE - STA 138+50 TO STA 143+50
	1T37	950	MAINTENANCE & PROTECTION OF TRAFFIC PLAN TEMPORARY TRAFFIC SIGNAL TIMINGS	S МТ6	88 981	MAINTENANCE & PROTECTION OF TRAFFIC F PHASE 2C / FIFTH AVE - STA 485+50 TO ST		99 101	2 MAINTENANCE & PROTECTION OF TR PHASE 2D / FIFTH AVE - STA 540+50		MT130	1043	MAINTENANCE & PROTECTION OF TRAFFIC PLANS PHASE 1C / FORBES AVE - STA 143+50 TO STA 149+50
	MT38	951	MAINTENANCE & PROTECTION OF TRAFFIC PLANS PHASE 1A / SIXTH AVE - STA 428+50 TO STA 433+	50 MT6	982	MAINTENANCE & PROTECTION OF TRAFFIC F PHASE 2C / FIFTH AVE - STA 490+50 TO ST		100 101	3 MAINTENANCE & PROTECTION OF TR PHASE 2D / FIFTH AVE - STA 545+50		MT131	1044	MAINTENANCE & PROTECTION OF TRAFFIC PLANS PHASE 2A / FORBES AVE - STA 159+50 TO STA 164+50
ngb.	MT39	952	MAINTENANCE & PROTECTION OF TRAFFIC PLANS PHASE 1A FIFTH AVE - STA 433+50 TO STA 438+5	) МТ7	0 983	MAINTENANCE & PROTECTION OF TRAFFIC F PHASE 1A / FIFTH AVE - STA 490+50 TO ST		101 101	4 MAINTENANCE & PROTECTION OF TR PHASE 2D / FIFTH AVE - STA 551+50		MT132	1045	MAINTENANCE & PROTECTION OF TRAFFIC PLANS PHASE 2A / FORBES AVE - STA 164+50 TO STA 169+50
60001	1T40	953	MAINTENANCE & PROTECTION OF TRAFFIC PLANS PHASE 1A / FIFTH AVE - STA 438+50 TO STA 443+	50 MT	71 984	MAINTENANCE & PROTECTION OF TRAFFIC F PHASE 1A / FIFTH AVE - STA 496+50 TO STA	PLANS A 502+50 MT1	102 101	5 MAINTENANCE & PROTECTION OF TR PHASE 2D / FIFTH AVE - STA 555+50		MT133	1046	MAINTENANCE & PROTECTION OF TRAFFIC PLANS PHASE 2A / FORBES AVE - STA 169+50 TO STA 173+50
-RDI	AT41	954	MAINTENANCE & PROTECTION OF TRAFFIC PLANS PHASE 1A / FIFTH AVE - STA 443+50 TO STA 448+	50 MT7	'2 985	MAINTENANCE & PROTECTION OF TRAFFIC F PHASE 1A / FIFTH AVE - STA 502+50 TO ST	PLANS A 507+50 MT1	103 101	THASE 20 7 TIT IN AVE - STA SOTTSO	TO STA 566+50	MT134	1047	MAINTENANCE & PROTECTION OF TRAFFIC PLANS PHASE 2A / FORBES AVE - STA 173+50 TO STA 177+50
3T_01	MT42	955	MAINTENANCE & PROTECTION OF TRAFFIC PLANS PHASE 1A / FIFTH AVE - STA 448+50 TO STA 454+	50 MT7	'3 986	MAINTENANCE & PROTECTION OF TRAFFIC F PHASE 1A / FIFTH AVE - STA 507+50 TO ST	A 513+50	104 101	THASE TA / TORDES AVE - STA 251+30	) 10 STA 242+50	MT135		MAINTENANCE & PROTECTION OF TRAFFIC PLANS PHASE 2A / FORBES AVE - STA 177+50 TO STA 182+50
00\Bf	MT43	956	MAINTENANCE & PROTECTION OF TRAFFIC PLANS PHASE 1A / FIFTH AVE - STA 454+50 TO STA 458+	50 MT7	'4 987	MAINTENANCE & PROTECTION OF TRAFFIC F PHASE 1B / FIFTH AVE - STA 507+50 TO ST	PLANS A 513+50 MT1	105 101	8 MAINTENANCE & PROTECTION OF TR PHASE 1A / FORBES AVE - STA 242+50	AFFIC PLANS ) TO STA 247+50	MT136	1049	MAINTENANCE & PROTECTION OF TRAFFIC PLANS PHASE 2B / FORBES AVE - STA 138+50 TO STA 143+50
72077	1T44	957	MAINTENANCE & PROTECTION OF TRAFFIC PLANS PHASE 1B / FIFTH AVE - STA 454+50 TO STA 458+	50 MT7	'5 988	MAINTENANCE & PROTECTION OF TRAFFIC F PHASE 1B / FIFTH AVE - STA 513+50 TO ST		106 101	9 MAINTENANCE & PROTECTION OF TR PHASE 1A / FORBES AVE - STA 247+50	AFFIC PLANS ) TO STA 251+50	MT137	1050	MAINTENANCE & PROTECTION OF TRAFFIC PLANS PHASE 2B / FORBES AVE - STA 143+50 TO STA 149+50
.b√mo:	1T45	958	MAINTENANCE & PROTECTION OF TRAFFIC PLANS PHASE 1B / FIFTH AVE - STA 458+50 TO STA 464+	50 MT7	6 989	MAINTENANCE & PROTECTION OF TRAFFIC F PHASE 1B / FIFTH AVE - STA 517+50 TO STA		107 102	MAINTENANCE & PROTECTION OF TR PHASE 1B / FORBES AVE - STA 232+00	AFFIC PLANS ) TO STA 237+50	MT138	1051	MAINTENANCE & PROTECTION OF TRAFFIC PLANS PHASE 2B / FORBES AVE - STA 149+50 TO STA 154+50
N COM	1T46	959	MAINTENANCE & PROTECTION OF TRAFFIC PLANS PHASE 1B / FIFTH AVE - STA 464+50 TO STA 470+	50 MT7	7 990	MAINTENANCE & PROTECTION OF TRAFFIC F PHASE 1B / FIFTH AVE - STA 522+50 TO STA	PLANS A 528+50 MT1	108 102	THASE ID / TONDES AVE STA 251130	) TO STA 242+50	MT139	1052	MAINTENANCE & PROTECTION OF TRAFFIC PLANS PHASE 2B / FORBES AVE - STA 154+50 TO STA 159+50
th@de	1T47	960	MAINTENANCE & PROTECTION OF TRAFFIC PLANS PHASE 1B / FIFTH AVE - STA 470+50 TO STA 475+	50 MT7	78 991	MAINTENANCE & PROTECTION OF TRAFFIC F PHASE 1C / FIFTH AVE - STA 522+50 TO STA	A 528+50 MI	109 102	THASE TO FORDES AVE. STA ZITTSC	) TO STA 221+50	MT140	1053	MAINTENANCE & PROTECTION OF TRAFFIC PLANS PHASE 2B / FORBES AVE - STA 159+50 TO STA 164+50
۱ ا <u>۱</u>	1T48	961	MAINTENANCE & PROTECTION OF TRAFFIC PLANS PHASE 1B / FIFTH AVE - STA 475+50 TO STA 480+	50 MT7	'9 992	MAINTENANCE & PROTECTION OF TRAFFIC F PHASE 1C / FIFTH AVE - STA 528+50 TO STA	PLANS A 534+50 MT1	110 102	MAINTENANCE & PROTECTION OF TR PHASE 1C / FORBES AVE - STA 221+50	AFFIC PLANS ) TO STA 227+00	MT141	1054	MAINTENANCE & PROTECTION OF TRAFFIC PLANS PHASE 2B / FORBES AVE - STA 164+50 TO STA 169+50
, deph.	MT49	962	MAINTENANCE & PROTECTION OF TRAFFIC PLANS PHASE 1C / FIFTH AVE - STA 470+50 TO STA 475+	50 MT8	10 993	MAINTENANCE & PROTECTION OF TRAFFIC F PHASE 1C / FIFTH AVE - STA 534+50 TO ST	A 540+50 MI	111 102	THASE ID 7 TORBES AVE STA 202130	) TO STA 207+50	MT142	1055	MAINTENANCE & PROTECTION OF TRAFFIC PLANS PHASE 2C / FORBES AVE - STA 119+00 TO STA 122+00
a\jos	IT50	963	MAINTENANCE & PROTECTION OF TRAFFIC PLANS PHASE 1C / FIFTH AVE - STA 475+50 TO STA 480+	50 MT8	31 994	MAINTENANCE & PROTECTION OF TRAFFIC F PHASE 1C / FIFTH AVE - STA 540+50 TO ST	A 545+50 MI	112 102	THASE ID 7 TORBES AVE STA 201130	TO STA 213+50	MT143	1056	MAINTENANCE & PROTECTION OF TRAFFIC PLANS PHASE 2C / FORBES AVE - STA 122+00 TO STA 128+00
16-1	AT51	964	MAINTENANCE & PROTECTION OF TRAFFIC PLANS PHASE 1C / FIFTH AVE - STA 480+50 TO STA 485+	50 MT8	32 995	MAINTENANCE & PROTECTION OF TRAFFIC F PHASE 1C / FIFTH AVE - STA 545+50 TO ST	A 551+50	113 102	THASE ID / TORBES AVE STA 215130	) TO STA 217+50	MT144	1057	MAINTENANCE & PROTECTION OF TRAFFIC PLANS PHASE 2C / FORBES AVE - STA 128+00 TO STA 133+50
om. ds	MT52	965	MAINTENANCE & PROTECTION OF TRAFFIC PLANS PHASE 1C / FIFTH AVE - STA 485+50 TO STA 490+		996	MAINTENANCE & PROTECTION OF TRAFFIC F PHASE 1D / FIFTH AVE - STA 545+50 TO ST	A 551+50	114 102	THASE TA / TORBES AVE STA 155150		MT145	1058	MAINTENANCE & PROTECTION OF TRAFFIC PLANS PHASE 2C / FORBES AVE - STA 133+50 TO STA 138+50
기	MT53	966	MAINTENANCE & PROTECTION OF TRAFFIC PLANS PHASE 1C / FIFTH AVE - STA 490+50 TO STA 496+	50 MT8	34 997	MAINTENANCE & PROTECTION OF TRAFFIC F PHASE 1D / FIFTH AVE - STA 551+50 TO STA	PLANS A 555+50 MT1	115 102	28 MAINTENANCE & PROTECTION OF TR PHASE 1A / FORBES AVE - STA 164+50	AFFIC PLANS ) TO STA 169+50	MT146	1059	MAINTENANCE & PROTECTION OF TRAFFIC PLANS PHASE 2C / FORBES AVE - STA 138+50 TO STA 143+50
91 10 10 10 10 10 10 10 10 10 10 10 10 10													
<b>:</b> ≩							HE PREPARATION OF TH	110	·	DESIGNED JMS		POR	T AUTHORITY OF ALLEGHENY COUNTY
d\:0 #H	A	<b>=C(</b>				D P.	HE PREPARATION OF THE OCUMENT HAS BEEN FII ART THROUGH A GRANT EDERAL TRANSIT ADMIN	NANCED IN FROM THE	(NOT FOR	DRAWN JMS CHECKED MES		PITTSBUI	RGH PENNSYLVANIA  S RAPID TRANSIT UPTOWN TO OAKLAND
E PATH:	70	Gulf Tow				U	I.S. DEPARTMENT OF RANSPORTATION, UNDE	R THE	CONSTRUCTION)	IN CHARGE LAR		200	INDEX OF DRAWINGS
11.1		07 Grant S 5th Floo	or	NO. DA	TE	DESCRIPTION P	RBAN MASS TRANSPOR F 1964, AS AMENDED, FO ORT AUTHORITY OF ALL	OR THE EGHENY		DATE <u>05/01/24</u> SCALE		Port A	uthority CONTRACT NO. BRT-001
	PITTS	sburgh, PA	A 15219		'	REVISIONS	OUNTY, PENNSYLVANIA		·	AS SHOW	IN		DWG. NO. GN11 SHT. 11

	AWING IMBER		TITLE	DRAWING NUMBER	SHEET NUMBER	TITLE	DRAWING NUMBER	SHEET NUMBER	TITLE	DRAWI NUMBI		r R TITLE
0	MAINTE	NANCE	& PROTECTION OF TRAFFIC PLANS (CONT'D)			SIGNAL PLANS (CONT'D)			SIGNAL PLANS (CONT'	D)		SIGNAL PLANS (CONT'D)
мп	T147	1060	MAINTENANCE & PROTECTION OF TRAFFIC PLANS PHASE 2C / FORBES AVE - STA 143+50 TO STA 149+50	SG29	1089	SIGNAL PLANS TRAFFIC SIGNAL TABULATIONS	SG60	1120	SIGNAL PLANS WIRING, MOVEMENT, PHASING & SEQUENC	CE DIAGRAMS SG9	I 1151	SIGNAL PLANS FIFTH AVENUE & BELLFIELD AVENUE
				SG30	1090	SIGNAL PLANS TRAFFIC SIGNAL TABULATIONS	SG61	1121	SIGNAL PLANS TRAFFIC SIGNAL TABULATION	S SG9	1152	SIGNAL PLANS WIRING, MOVEMENT, PHASING & SEQUENCE DIAGRAMS
			SIGNAL PLANS	SG31	1091	SIGNAL PLANS FIFTH AVENUE & DINWIDDIE STREET	SG62	1122	SIGNAL PLANS TRAFFIC SIGNAL TABULATION	S SG9	1153	SIGNAL PLANS TRAFFIC SIGNAL TABULATIONS
	SG1	1061	SIGNAL PLANS SIXTH AVENUE & CENTRE AVENUE	SG32	1092	SIGNAL PLANS WIRING, MOVEMENT, PHASING & SEQUENCE DIAGRAMS	SG63	1123	SIGNAL PLANS FIFTH AVENUE & ATWOOD STRE	ET SG9	1154	SIGNAL PLANS TRAFFIC SIGNAL TABULATIONS
9	SG2	1062	SIGNAL PLANS Wiring, movement, phasing & sequence diagrams	SG33	1093	SIGNAL PLANS TRAFFIC SIGNAL TABULATIONS	SG64	1124	SIGNAL PLANS WIRING, MOVEMENT, PHASING & SEQUENC	CE DIAGRAMS SG9	1155	SIGNAL PLANS FORBES AVENUE & TENTH ST/ARMSTRONG TUNNEL
S	SG3	1063	SIGNAL PLANS TRAFFIC SIGNAL TABULATIONS	SG34	1094	SIGNAL PLANS TRAFFIC SIGNAL TABULATIONS	SG65	1125	SIGNAL PLANS TRAFFIC SIGNAL TABULATION	S SG9	1156	SIGNAL PLANS WIRING, MOVEMENT, PHASING & SEQUENCE DIAGRAMS
9	SG4	1064	SIGNAL PLANS FIFTH AVENUE & SIXTH STREET	SG35	1095	SIGNAL PLANS FIFTH AVENUE & JUMONVILLE STREET/WYANDOTTE ST	SG66	1126	SIGNAL PLANS TRAFFIC SIGNAL TABULATION	S SG9	1157	SIGNAL PLANS TRAFFIC SIGNAL TABULATIONS
9	SG5	1065	SIGNAL PLANS WIRING, MOVEMENT, PHASING & SEQUENCE DIAGRAMS	SG36	1096	SIGNAL PLANS WIRING, MOVEMENT, PHASING & SEQUENCE DIAGRAMS	SG67	1127	SIGNAL PLANS FIFTH AVENUE & OAKLAND AVENUE/DE S	OTO STREET SG9	1158	SIGNAL PLANS TRAFFIC SIGNAL TABULATIONS
S	SG6	1066	SIGNAL PLANS TRAFFIC SIGNAL TABULATIONS	SG37	1097	SIGNAL PLANS TRAFFIC SIGNAL TABULATIONS	SG68	1128	SIGNAL PLANS WIRING, MOVEMENT, PHASING & SEQUENCE	CE DIAGRAMS SG9	1159	SIGNAL PLANS FORBES AVENUE & CHATHAM SQUARE/MCANULTY DRIVE
S	SG7	1067	SIGNAL PLANS FORBES AVENUE/SIXTH AVENUE & DIAMOND STREET	SG38	1098	SIGNAL PLANS TRAFFIC SIGNAL TABULATIONS	SG69	1129	SIGNAL PLANS TRAFFIC SIGNAL TABULATION	s sg10	0 1160	SIGNAL PLANS WIRING, MOVEMENT, PHASING & SEQUENCE DIAGRAMS
9	SG8	1068	SIGNAL PLANS WIRING, MOVEMENT, PHASING & SEQUENCE DIAGRAMS	SG39	1099	SIGNAL PLANS FIFTH AVENUE & BIRMINGHAM BRIDGE/KIRKPATRICK ST	SG70	1130	SIGNAL PLANS TRAFFIC SIGNAL TABULATION	S SG10	1 1161	TRAFFIC SIGNAL TABULATIONS
S	SG9	1069	SIGNAL PLANS TRAFFIC SIGNAL TABULATIONS	SG40	1100	SIGNAL PLANS WIRING, MOVEMENT, PHASING & SEQUENCE DIAGRAMS	SG71	1131	SIGNAL PLANS FIFTH AVENUE & BOUQUET STRE	EET SG10	2 1162	SIGNAL PLANS TRAFFIC SIGNAL TABULATIONS
s	G10	1070	SIGNAL PLANS TRAFFIC SIGNAL TABULATIONS	SG41	1101	SIGNAL PLANS TRAFFIC SIGNAL TABULATIONS	SG72	1132	SIGNAL PLANS WIRING, MOVEMENT, PHASING & SEQUENC	CE DIAGRAMS SG10	3 1163	SIGNAL PLANS FORBES AVENUE & STEVENSON STREET
S	G11	1071	SIGNAL PLANS FIFTH AVENUE & WASHINGTON PLACE	SG42	1102	SIGNAL PLANS TRAFFIC SIGNAL TABULATIONS	SG73	1133	SIGNAL PLANS TRAFFIC SIGNAL TABULATION	S SG10	4 1164	WIRING, MOVEMENT, PHASING & SEQUENCE DIAGRAMS
S	G12	1072	SIGNAL PLANS WIRING, MOVEMENT, PHASING & SEQUENCE DIAGRAMS	SG43	1103	SIGNAL PLANS FIFTH AVENUE & RAMP TO BOULEVARD OF THE ALLIES	SG74	1134	SIGNAL PLANS TRAFFIC SIGNAL TABULATION	s SG10	5 1165	SIGNAL PLANS TRAFFIC SIGNAL TABULATIONS
S	G13	1073	SIGNAL PLANS TRAFFIC SIGNAL TABULATIONS	SG44	1104	SIGNAL PLANS WIRING, MOVEMENT, PHASING & SEQUENCE DIAGRAMS	SG75	1135	SIGNAL PLANS FIFTH AVENUE & THACKERY AVE	NUE SG10	6 1166	SIGNAL PLANS TRAFFIC SIGNAL TABULATIONS SIGNAL PLANS
o dgr	G14	1074	SIGNAL PLANS TRAFFIC SIGNAL TABULATIONS	SG45	1105	SIGNAL PLANS TRAFFIC SIGNAL TABULATIONS	SG76	1136	SIGNAL PLANS WIRING, MOVEMENT, PHASING & SEQUENC	CE DIAGRAMS SG10	7 1167	FORBES AVENUE & PRIDE STREET
1001 s	G15	1075	SIGNAL PLANS FIFTH AVENUE & MAGEE STREET SIGNAL PLANS	SG46	1106	SIGNAL PLANS TRAFFIC SIGNAL TABULATIONS SIGNAL PLANS	SG77	1137	SIGNAL PLANS TRAFFIC SIGNAL TABULATION SIGNAL PLANS	s SG10	8 1168	SIGNAL PLANS WIRING, MOVEMENT, PHASING & SEQUENCE DIAGRAMS SIGNAL PLANS
£	G16	1076	WIRING, MOVEMENT, PHASING & SEQUENCE DIAGRAMS SIGNAL PLANS	SG47	1107	FIFTH AVENUE & CRAFT AVENUE SIGNAL PLANS	SG78	1138	TRAFFIC SIGNAL TABULATION SIGNAL PLANS	S SG10		TRAFFIC SIGNAL TABULATIONS
3RT.	G17	1077	TRAFFIC SIGNAL TABULATIONS SIGNAL PLANS	SG48	1108	WIRING, MOVEMENT, PHASING & SEQUENCE DIAGRAMS SIGNAL PLANS	SG79	1139	FIFTH AVENUE & BIGELOW BOULE SIGNAL PLANS			TRAFFIC SIGNAL TABULATIONS
700	G18	1078	TRAFFIC SIGNAL TABULATIONS SIGNAL PLANS	SG49	1109	TRAFFIC SIGNAL TABULATIONS SIGNAL PLANS	SG80	1140	WIRING, MOVEMENT, PHASING & SEQUENCE SIGNAL PLANS			FORBES AVENUE & MARION STREET
102(	G19	1079	FIFTH AVENUE & STEVENSON STREET SIGNAL PLANS	SG50	1110	TRAFFIC SIGNAL TABULATIONS SIGNAL PLANS	SG81	1141	TRAFFIC SIGNAL TABULATION SIGNAL PLANS			WIRING, MOVEMENT, PHASING & SEQUENCE DIAGRAMS
000		1080	WIRING, MOVEMENT, PHASING & SEQUENCE DIAGRAMS SIGNAL PLANS	SG51		FIFTH AVENUE & HALKET STREET SIGNAL PLANS	SG82	1142	TRAFFIC SIGNAL TABULATION SIGNAL PLANS	3	3 1173	TRAFFIC SIGNAL TABULATIONS
900	G21	1081	TRAFFIC ŠĬĠŇĀL TABŪLATIONS SIGNAL PLANS	SG52	1112	WIRING, MOVEMENT, PHASING & SEQUENCE DIAGRAMS	SG83	1143	FIFTH AVENUE & LYTTON AVEN			TRAFFIC SIGNAL TABULATIONS
8	G22	1082	TRAFFIC SIGNAL TABULATIONS	SG53	1113	SIGNAL PLANS TRAFFIC SIGNAL TABULATIONS SIGNAL PLANS	SG84	1144	SIGNAL PLANS WIRING, MOVEMENT, PHASING & SEQUENT SIGNAL PLANS			FORBES AVENUE & VAN BRAAM STREET
·_ ο	G23	1083	SIGNAL PLANS FIFTH AVENUE & PRIDE STREET SIGNAL PLANS	SG54	1114	TRAFFIC SIGNAL TABULATIONS	SG85	1145	SIGNAL PLANS TRAFFIC SIGNAL TABULATION SIGNAL PLANS			WINTING, MOVEMENT, I HASTING & SEQUENCE DIAGNAMS
Sep Sep	G24 G25	1084	SIGNAL PLANS WIRING, MOVEMENT, PHASING & SEQUENCE DIAGRAMS SIGNAL PLANS	SG55	1115	SIGNAL PLANS FIFTH AVENUE & MCKEE PLACE/ DARRAGH STREET SIGNAL PLANS	SG86	1146 1147	SIGNAL PLANS TRAFFIC SIGNAL TABULATION SIGNAL PLANS	5011		SIGNAL PLANS TRAFFIC SIGNAL TABULATIONS SIGNAL PLANS
þ	G26	1086	TRAFFIC SIGNAL TABULATIONS SIGNAL PLANS	SG56 SG57	1116	WIRING, MOVEMENT, PHASING & SEQUENCE DIAGRAMS SIGNAL PLANS	SG87 SG88	1148	FIFTH AVENUE & TENNYSON AVE SIGNAL PLANS	6011		TRAFFIC SIGNAL TABULATIONS
s16	G27	1087	TRAFFIC SIGNAL TABULATIONS SIGNAL PLANS	SG58	1118	TRAFFIC SIGNAL TABULATIONS SIGNAL PLANS	SG89	1149	WIRING, MOVEMENT, PHASING & SEQUENCE SIGNAL PLANS	CO13		SIGNAL PLANS
Ü	G28	1088	FIFTH AVENUE & MARION STREET/VINE STREET  SIGNAL PLANS WIRING, MOVEMENT, PHASING & SEQUENCE DIAGRAMS	SG59	1119	TRAFFIC SIGNAL TABULATIONS SIGNAL PLANS	SG90	1150	TRAFFIC SIGNAL TABULATION SIGNAL PLANS	5		WINING, MOVEMENT, FRASING & SEQUENCE DIAGRAMS
	.020	1000	WIRING, MOVEMENT, PHASING & SEQUENCE DIAGRAMS	3033	1113	FIFTH AVENUE & MEYRAN AVENUE/ LOTHROP STREET	3030	1130	TRAFFIC SIGNAL TABULATION	S   3012	1 1101	TRAFFIC SIGNAL TABULATIONS
.silich" working\												
UPEKAIUK: "joseph. File Path: c: \pww	Λ:		<b>OA4</b>			THE PREPARAT		DIN		ESIGNED JMS RAWN JMS		PORT AUTHORITY OF ALLEGHENY COUNTY ITTSBURGH PENNSYLVANIA
ATH.			OM			PART THROUGH FEDERAL TRAN	S BEEN FINANCE I A GRANT FROM SIT ADMINISTRATION	THE TION,	(NOT FOR	HECKED <u>MES</u>		BUS RAPID TRANSIT UPTOWN TO OAKLAND
LE P.		Gulf To 7 Grant	Street			URBAN MASS TI	ION, UNDER THE RANSPORTATION	NACT C	$A \cap A \cap C \cap C \cap A \cap A \cap A \cap A \cap A \cap A \cap $	CHARGE         LAR           ATE         05/01/24		INDEX OF DRAWINGS
P.I.	Pittsl	5th Flo burgh, F	oor PA 15219	NO. DATE		DESCRIPTION PORT AUTHORI' COUNTY, PENN.	ENDED, FOR THE TY OF ALLEGHEN SYLVANIA.	: 1	,	AS SHOWN	Por	t Authority CONTRACT NO. BRT-001
						REVISIONS						connecting people to life DWG. NO. GN12 SHT. 12


## INDEX OF DRAWINGS

NUMBEF DRAWIN		T ER TITLE	DRAWIN NUMBE		TITLE	DRAWING NUMBER	SHEET NUMBER	TITLE	DRAW NUM		TITLE
7 0		SIGNAL PLANS (CO	NT' D)		CROSS SECTIONS (CONT	<u>′ D)</u>		CROSS SECTIONS (CO	DNT'D)		CROSS SECTIONS (CONT'D)
SG122	1182	SIGNAL PLANS TRAFFIC SIGNAL TABULA	TIONS XS5	1210	CROSS SECTIONS FIFTH AVE - STA 437+00.00	XS36	1241	CROSS SECTIONS FIFTH AVE - STA 460+00.00 TO S	TA 460+50.00 XS	57 1272	CROSS SECTIONS FIFTH AVE - STA 479+50.00 TO STA 480+00.00
SG123	1183	STONAL DIANS	VSC	1211	CROSS SECTIONS FIFTH AVE - STA 437+50.00	XS37	1242	CROSS SECTIONS FIFTH AVE - STA 461+00.00 TO S	VC.	S8 1273	CROSS SECTIONS FIFTH AVE - STA 480+50.00 TO STA 481+00.00
SG124	1184	SIGNAL PLANS WIRING, MOVEMENT, PHASING & SEG	UENCE DIAGRAMS XS7	1212	CROSS SECTIONS FIFTH AVE - STA 438+00.00 TO STA 4	438+50.00 XS38	1243	CROSS SECTIONS FIFTH AVE - STA 462+00	Ve	59 1274	CROSS SECTIONS FIFTH AVE - STA 481+50.00 TO STA 482+00.00
SG125	1185	SIGNAL PLANS TRAFFIC SIGNAL TABULA	TIONS XS8	1213	CROSS SECTIONS FIFTH AVE - STA 439+00.00 TO STA 4	439+50.00 XS39	1244	CROSS SECTIONS FIFTH AVE - STA 462+50	0. 00 XS	0 1275	CROSS SECTIONS FIFTH AVE - STA 482+39.00
SG126	1186	SIGNAL PLANS TRAFFIC SIGNAL TABULA	TIONS XS9	1214	CROSS SECTIONS FIFTH AVE - STA 440+00.00 TO STA 4	140+21.00 XS40	1245	CROSS SECTIONS FIFTH AVE - STA 463+00.00 TO S	TA 463+50.00 XS	71 1276	CROSS SECTIONS FIFTH AVE - STA 482+50.00
SG127	1187	SIGNAL PLANS FORBES AVENUE & JUMONVILL	E STREET XS10	1215	CROSS SECTIONS FIFTH AVE - STA 440+40.00 TO STA 4	140+50.00 XS41	1246	CROSS SECTIONS FIFTH AVE - STA 463+65.00 TO S	TA 464+00.00 XS	1277	CROSS SECTIONS FIFTH AVE - STA 483+00∙00
SG128	1188	SIGNAL PLANS WIRING, MOVEMENT, PHASING & SEG	UENCE DIAGRAMS XS11	1216	CROSS SECTIONS FIFTH AVE - STA 440+59.00 TO STA 4	141+00.00 XS42	1247	CROSS SECTIONS FIFTH AVE - STA 464+50.00 TO S	TA 465+00.00 XS	73 1278	CROSS SECTIONS FIFTH AVE - STA 483+50.00
SG129	1189	SIGNAL PLANS TRAFFIC SIGNAL TABULA	TIONS XS12	1217	CROSS SECTIONS FIFTH AVE - STA 441+50.00 TO STA 4	142+00.00 XS43	1248	CROSS SECTIONS FIFTH AVE - STA 465+50.00 TO S	TA 466+00.00 XS	74 1279	CROSS SECTIONS FIFTH AVE - STA 484+00.00 TO STA 484+50.00
SG130	1190	SIGNAL PLANS TRAFFIC SIGNAL TABULA	TIONS XS13	1218	CROSS SECTIONS FIFTH AVE - STA 442+11.00 TO STA 4	442+50 <b>.</b> 00 XS44	1249	CROSS SECTIONS FIFTH AVE - STA 466+50.00 TO S	TA 467+00.00 XS	75 1280	CROSS SECTIONS FIFTH AVE - STA 485+00.00
SG131	1191	SIGNAL PLANS FORBES AVENUE & MOULTRIE	STREET XS14	1219	CROSS SECTIONS FIFTH AVE - STA 443+00.00 TO STA 4	443+50•00 XS45	1250	CROSS SECTIONS FIFTH AVE - STA 467+08.00 TO	XS	76 1281	CROSS SECTIONS FIFTH AVE - STA 485+50.00
SG132	1192	SIGNAL PLANS WIRING, MOVEMENT, PHASING & SEG	UENCE DIAGRAMS XS15	1220	CROSS SECTIONS FIFTH AVE - STA 440+00.00 TO STA 4	444+50.00 XS46	1251	CROSS SECTIONS FIFTH AVE - STA 467+86.00 TO	XS	77 1282	CROSS SECTIONS FIFTH AVE - STA 486+00.00 TO STA 486+45.00
SG133	1193	SIGNAL PLANS TRAFFIC SIGNAL TABULA	TIONS XS16	1221	CROSS SECTIONS FIFTH AVE - STA 445+00.00 TO STA 4	445+50.00 XS47	1252	CROSS SECTIONS FIFTH AVE - STA 468+50.00 TO	XS 468+73.00	78 1283	CROSS SECTIONS FIFTH AVE - STA 486+50.00 TO STA 486+93.00
SG134	1194	SIGNAL PLANS TRAFFIC SIGNAL TABULA	TIONS XS17	1222	CROSS SECTIONS FIFTH AVE - STA 446+00.00	XS48	1253	CROSS SECTIONS FIFTH AVE - STA 469+00.00 TO S	TA 469+50.00 XS	79 1284	CROSS SECTIONS FIFTH AVE - STA 487+00.00 TO STA 487+50.00
SG135	1195	SIGNAL PLANS FORBES AVENUE & BIRMINGHAM BRID	GE ON-OFF RAMP XS18	1223	CROSS SECTIONS FIFTH AVE - STA 446+50.00	XS49	1254	CROSS SECTIONS FIFTH AVE - STA 470+0	0.00 XS	1285	CROSS SECTIONS FIFTH AVE - STA 488+00.00 TO STA 488+50.00
SG136	1196	SIGNAL PLANS WIRING, MOVEMENT, PHASING & SEG	UENCE DIAGRAMS XS19	1224	CROSS SECTIONS FIFTH AVE - STA 447+00.00 TO STA 4	447+50.00 XS50	1255	CROSS SECTIONS FIFTH AVE - STA 470+5	0.00 XS	1286	CROSS SECTIONS FIFTH AVE - STA 489+00.00 TO STA 489+50.00
SG137	1197	SIGNAL PLANS TRAFFIC SIGNAL TABULA	TIONS XS20	1225	CROSS SECTIONS FIFTH AVE - STA 447+86.00 TO STA 4	448+00.00 XS51	1256	CROSS SECTIONS FIFTH AVE - STA 471+00	). 00 XS	32 1287	CROSS SECTIONS FIFTH AVE - STA 490+00.00
등 SG138	1198	TRAFFIC SIGNAL TABULA	TIONS XS21	1226	CROSS SECTIONS FIFTH AVE - STA 448+50.00 TO STA 4	149+00.00 XS52	1257	CROSS SECTIONS FIFTH AVE - STA 471+50.00 TO S	TA 472+00.00 XS	1288	CROSS SECTIONS FIFTH AVE - STA 490+50∙00
SG139	1199	FURBES AVENUE & HALKET	STREET XS22	1227	CROSS SECTIONS FIFTH AVE - STA 449+50.00 TO STA 4	450+00 <b>.</b> 00 XS53	1258	CROSS SECTIONS FIFTH AVE - STA 472+46.00 TO S	TA 472+50.00 XS	1289	CROSS SECTIONS FIFTH AVE - STA 491+00∙00
g SG140	1200	WIRING, MOVEMENT, PHASING & SEG	UENCE DIAGRAMS XS23	1228	CROSS SECTIONS FIFTH AVE - STA 450+50.00	XS54	1259	CROSS SECTIONS FIFTH AVE - STA 473+00.00 TO S	TA 473+50.00 XS	1290	CROSS SECTIONS FIFTH AVE - STA 491+50.00 TO STA 492+00.00
SG141	1201	TRAFFIC SIGNAL TABULA	TIONS XS24	1229	CROSS SECTIONS FIFTH AVE - STA 451+00.00 TO STA 4	451+50 <b>.</b> 00 XS55	1260	CROSS SECTIONS FIFTH AVE - STA 474+00.00 TO S	TA 474+50.00 XS	36 1291	CROSS SECTIONS FIFTH AVE - STA 492+14.00 TO STA 492+50.00
SG142	1202	FORDES AVENUE & SCHENLET DRI	VE EXTENSION XS25	1230	CROSS SECTIONS FIFTH AVE - STA 452+00.00 TO STA 4	452+50.00 XS56	1261	CROSS SECTIONS FIFTH AVE - STA 475+0	0.00 XS	1292	CROSS SECTIONS FIFTH AVE - STA 493+00.00 TO STA 493+50.00
SG143	1203	WINING, MOVEMENT, PHASING & SEG	UENCE DIAGRAMS XS26	1231	CROSS SECTIONS FIFTH AVE - STA 452+92.00 TO STA 4	453+00.00 XS57	1262	CROSS SECTIONS FIFTH AVE - STA 475+5	0.00 XS	1293	CROSS SECTIONS FIFTH AVE - STA 494+00.00 TO STA 494+50.00
SG144	1204	TRAFFIC SIGNAL TABULA	TIONS XS27	1232	CROSS SECTIONS FIFTH AVE - STA 453+50.00 TO STA 4	454+00.00 XS58	1263	CROSS SECTIONS FIFTH AVE - STA 476+0	0.00 XS	39 1294	CROSS SECTIONS FIFTH AVE - STA 495+00.00
SG145	1205	SIGNAL PLANS TRAFFIC SIGNAL TABULA	TIONS XS28	1233	CROSS SECTIONS FIFTH AVE - STA 454+50.00	XS59	1264	CROSS SECTIONS FIFTH AVE - STA 476+1		1295	CROSS SECTIONS FIFTH AVE - STA 495+50.00
chade			XS29	1234	CROSS SECTIONS FIFTH AVE - STA 455+00.00 TO STA 4	455+50.00 XS60	1265	CROSS SECTIONS FIFTH AVE - STA 476+5	0.00 XS	1296	CROSS SECTIONS FIFTH AVE - STA 496+00.00
			XS30	1235	CROSS SECTIONS FIFTH AVE - STA 455+65.00 TO STA 4		1266	CROSS SECTIONS FIFTH AVE - STA 477+00		1297	CROSS SECTIONS FIFTH AVE - STA 496+50.00
seph.		CROSS SECTION	<u>S</u> xs31	1236	CROSS SECTIONS FIFTH AVE - STA 456+50.00 TO STA 4	456+80.00 XS62	1267	CROSS SECTIONS FIFTH AVE - STA 477+4	2.00 XS	1298	CROSS SECTIONS FIFTH AVE - STA 497+00.00  CROSS SECTIONS
Š XS1	1206	FIFTH AVE - 3TA 434+00.00 TO .	STA 434+50.00 XS32	1237	CROSS SECTIONS FIFTH AVE - STA 457+00.00 TO STA	457+50.00 XS63	1268	CROSS SECTIONS FIFTH AVE - STA 477+5	0.00 XS	1299	FIFTH AVE - STA 497+50.00
XS2	1207	FIFTH AVE - 31A 433+00 TO 31	A 435+16.00 XS33	1238	CROSS SECTIONS FIFTH AVE - STA 458+00.00 TO STA	458+50.00 XS64	1269	CROSS SECTIONS FIFTH AVE - STA 477+9	0.00 XS	95 1300	CROSS SECTIONS FIFTH AVE - STA 498+00.00
XS3	1208	CROSS SECTIONS FIFTH AVE - STA 435+50.00 TO S CROSS SECTIONS	STA 436+00.00 XS34	1239	CROSS SECTIONS FIFTH AVE - STA 459+00.00 TO STA 4 CROSS SECTIONS	459+44.00 XS65	1270	CROSS SECTIONS FIFTH AVE - STA 478+0 CROSS SECTIONS	0.00 XS	96 1301	CROSS SECTIONS FIFTH AVE - STA 498+50.00  CROSS SECTIONS
XS4	1209	FIFTH AVE - STA 436+5	0.00 XS35	1240	FIFTH AVE - STA 459+50.00 TO STA	459+75.00 XS66	1271	FIFTH AVE - STA 478+50.00 TO S	TA 479+00.00 XS	37 1302	FIFTH AVE - STA 499+00.00 TO STA 499+50.00
00 100 100 100 100 100 100 100 100 100											
• ≤		8014				THE PREPARATION OF THIS		·	DESIGNED JMS		ORT AUTHORITY OF ALLEGHENY COUNTY
FILE PATH CIND						DOCUMENT HAS BEEN FINANCE PART THROUGH A GRANT FROM	THE	(NOT FOR	DRAWN JMS CHECKED MES		TSBURGH PENNSYLVANIA BUS RAPID TRANSIT UPTOWN TO OAKLAND
E PAT	Gulf 7	Tower				FEDERAL TRANSIT ADMINISTRATUS. DEPARTMENT OF TRANSPORTATION, UNDER THE		CONSTRUCTION)	IN CHARGE <u>LAR</u>		INDEX OF DRAWINGS
	5th F	ant Street Floor	NO. DATE		DESCRIPTION	URBAN MASS TRANSPORTATION OF 1964, AS AMENDED, FOR THE PORT AUTHORITY OF ALLEGHEN			DATE <u>05/01/24</u> SCALE	Port	Authority CONTRACT NO. BRT-001
F	πτspurgh,	n, PA 15219		1	REVISIONS	COUNTY, PENNSYLVANIA.			AS SHOWN	1 UIL	connecting people to life DWG. NO. GN13 SHT. 13

ED: 4/23	DRAWING NUMBER	SHEET NUMBER	TITLE	DRAWING NUMBER	SHEET NUMBER	TITLE	DRAWING NUMBER			DRAWING NUMBER	SHEET NUMBER	TITLE
PLOTT			CROSS SECTIONS (CONT'D)			CROSS SECTIONS (CONT'	D)		CROSS SECTIONS (CONT	- <sub>'</sub> D)		CROSS SECTIONS (CONT'D)
	XS98	1303	CROSS SECTIONS FIFTH AVE - STA 500+00.00 TO STA 500+50.00	XS129	1334	CROSS SECTIONS FIFTH AVE - STA 533+00₊00 TO STA 53	33+50 00 0	0	0	XS191	1396	CROSS SECTIONS FORBES AVE - STA 138+00.00
	XS99	1304	CROSS SECTIONS FIFTH AVE - STA 500+50.00	XS130	1335	CROSS SECTIONS FIFTH AVE - STA 534+00.00 TO STA 53	VC1C1	1366	CROSS SECTIONS FORBES AVE - STA 121+50.0	xS192	1397	CROSS SECTIONS FORBES AVE - STA 138+50.00
	XS100	1305	CROSS SECTIONS FIFTH AVE - STA 501+50.00 TO STA 502+00.00	XS131	1336	CROSS SECTIONS FIFTH AVE - STA 535+00.00 TO STA 53	VC1C2	1367	CDOSS SECTIONS	VC103	1398	CROSS SECTIONS FORBES AVE - STA 139+00.00
	XS101	1306	CROSS SECTIONS FIFTH AVE - STA 502+50.00 TO STA 503+00.00	XS132	1337	CROSS SECTIONS FIFTH AVE - STA 536+00.00 TO STA 53	VC1C7	1368	CDOSS SECTIONS	VC104	1399	CROSS SECTIONS FORBES AVE - STA 139+50.00
	XS102	1307	CROSS SECTIONS FIFTH AVE - STA 503+50.00 TO STA 504+00.00	XS133	1338	CROSS SECTIONS FIFTH AVE - STA 537+00.00 TO STA 53	VC1C4	1369	CROSS SECTIONS	VC105	1400	CROSS SECTIONS FORBES AVE - STA 140+00.00
	XS103	1308	CROSS SECTIONS FIFTH AVE - STA 504+50.00 TO STA 505+00.00	XS134	1339	CROSS SECTIONS FIFTH AVE - STA 538+00.00 TO STA 53	VC1CE	1370	CDOSS SECTIONS	VC10C	1401	CROSS SECTIONS FORBES AVE - STA 140+50.00
	XS104	1309	CROSS SECTIONS FIFTH AVE - STA 505+50.00	XS135	1340	CROSS SECTIONS FIFTH AVE - STA 539+00.00 TO STA 53	VS1CC	1371	CROSS SECTIONS FORBES AVE - STA 123+50.00 TO STA	124+00.00 XS197	1402	CROSS SECTIONS FORBES AVE - STA 141+00.00
	XS105	1310	CROSS SECTIONS FIFTH AVE - STA 506+00.00	XS136	1341	CROSS SECTIONS FIFTH AVE - STA 540+00.00 TO STA 54	VC1C7	1372	CDACC CECTIONS	VC108	1403	CROSS SECTIONS FORBES AVE - STA 141+50.00
	XS106	1311	CROSS SECTIONS FIFTH AVE - STA 506+50.00 TO STA 507+00.00	XS137	1342	CROSS SECTIONS FIFTH AVE - STA 541+00.00 TO STA 54	11+50.00 XS168	1373	CROSS SECTIONS FORBES AVE - STA 125+00.0	0 XS199	1404	CROSS SECTIONS FORBES AVE - STA 141+78.00
	XS107	1312	CROSS SECTIONS FIFTH AVE - STA 507+50.00	XS138	1343	CROSS SECTIONS FIFTH AVE - STA 542+00.00 TO STA 54	2+50.00 XS169	1374	CROSS SECTIONS FORBES AVE - STA 125+50.0	xs200	1405	CROSS SECTIONS FORBES AVE - STA 142+00.00
	XS108	1313	CROSS SECTIONS FIFTH AVE - STA 508+00.00	XS139	1344	CROSS SECTIONS FIFTH AVE - STA 543+00.00 TO STA 54	3+50.00 XS170	1375	CROSS SECTIONS FORBES AVE - STA 126+00.00 TO STA	126+50.00 XS201	1406	CROSS SECTIONS FORBES AVE - STA 142+50.00
	XS109	1314	CROSS SECTIONS FIFTH AVE - STA 508+50.00	XS140	1345	CROSS SECTIONS FIFTH AVE - STA 544+00.00 TO STA 54	14+50.00 XS171	1376	CROSS SECTIONS FORBES AVE - STA 127+00.0	xs202	1407	CROSS SECTIONS FORBES AVE - STA 143+00.00 TO STA 143+50.00
	XS110	1315	CROSS SECTIONS FIFTH AVE - STA 509+00.00 TO STA 509+50.00	XS141	1346	CROSS SECTIONS FIFTH AVE - STA 550+94.00 TO STA 55	i1+00.00 XS172	1377	CROSS SECTIONS FORBES AVE - STA 127+50.0	xs203	1408	CROSS SECTIONS FORBES AVE - STA 144+00.00 TO STA 144+50.00
	XS111	1316	CROSS SECTIONS FIFTH AVE - STA 510+00.00 TO STA 510+50.00	XS142	1347	CROSS SECTIONS FIFTH AVE - STA 551+50.00 TO STA 55	32+00.00 XS173	1378	CROSS SECTIONS FORBES AVE - STA 128+00.0	00 XS204	1409	CROSS SECTIONS FORBES AVE - STA 145+00.00 TO STA 145+16.00
	XS112	1317	CROSS SECTIONS FIFTH AVE - STA 511+00.00 TO STA 511+50.00	XS143	1348	CROSS SECTIONS FIFTH AVE - STA 552+50.00 TO STA 55	3+00.00 XS174	1379	CROSS SECTIONS FORBES AVE - STA 128+50.0	xs205	1410	CROSS SECTIONS FORBES AVE - STA 145+50.00 TO STA 145+68.00
	XS113	1318	CROSS SECTIONS FIFTH AVE - STA 512+00.00 TO STA 512+50.00	XS144	1349	CROSS SECTIONS FIFTH AVE - STA 553+50.00 TO STA 55	34+00.00 XS175	1380	CROSS SECTIONS FORBES AVE - STA 129+00.0	xs206	1411	CROSS SECTIONS FORBES AVE - STA 146+00.00 TO STA 146+50.00
- dgn	XS114	1319	CROSS SECTIONS FIFTH AVE - STA 513+00.00 TO STA 513+50.00	XS145	1350	CROSS SECTIONS FIFTH AVE - STA 554+50.00 TO STA 55	55+00.00 XS176	1381	CROSS SECTIONS FORBES AVE - STA 129+24.0	0 XS207	1412	CROSS SECTIONS FORBES AVE - STA 147+00.00 TO STA 147+50.00
I 0D 12	XS115	1320	CROSS SECTIONS FIFTH AVE - STA 514+00.00 TO STA 514+50.00	XS146	1351	CROSS SECTIONS FIFTH AVE - STA 556+50.00 TO STA 55	57+00.00 XS177	1382	CROSS SECTIONS FORBES AVE - STA 129+50.0	0 XS208	1413	CROSS SECTIONS FORBES AVE - STA 148+00.00
-RD-	XS116	1321	CROSS SECTIONS FIFTH AVE - STA 515+00.00 TO STA 515+50.00	XS147	1352	CROSS SECTIONS FIFTH AVE - STA 557+50.00	XS178	1383	CROSS SECTIONS FORBES AVE - STA 130+00.0	00 XS209	1414	CROSS SECTIONS FORBES AVE - STA 148+25.00 TO STA 148+50.00
3T_01	XS117	1322	CROSS SECTIONS FIFTH AVE - STA 516+00.00 TO STA 516+50.00	XS148	1353	CROSS SECTIONS FIFTH AVE - STA 559+50.00 TO STA 56	xs179	1384	FUNDES AVE - STA 130+20.0	00 XS210	1415	CROSS SECTIONS FORBES AVE - STA 149+00.00 TO STA 149+50.00
,00\B	XS118	1323	CROSS SECTIONS FIFTH AVE - STA 516+97.00 TO STA 517+00.00	XS149	1354	CROSS SECTIONS FIFTH AVE - STA 560+50.00 TO STA 56	XS180	1385	FURDES AVE - STA 130+30.0	00 XS211	1416	CROSS SECTIONS FORBES AVE - STA 150+00.00 TO STA 150+50.00
02077	XS119	1324	CROSS SECTIONS FIFTH AVE - STA 517+50.00 TO STA 518+00.00	XS150	1355	CROSS SECTIONS FIFTH AVE - STA 561+50.00 TO STA 56	52+00.00 XS181	1386	FORDES AVE - STA 151+00.00 TO STA	131+50.00 XS212	1417	CROSS SECTIONS FORBES AVE - STA 151+00.00
P\moa	XS120	1325	CROSS SECTIONS FIFTH AVE - STA 518+50.00 TO STA 519+00.00	XS151	1356	CROSS SECTIONS FIFTH AVE - STA 562+50.00 TO STA 56	XS182	1387	CROSS SECTIONS FORBES AVE - STA 132+00.00 TO STA	132+50.00 XS213	1418	CROSS SECTIONS FORBES AVE - STA 151+50.00
com.	XS121	1326	CROSS SECTIONS FIFTH AVE - STA 520+50.00 TO STA 521+00.00	XS152	1357	CROSS SECTIONS FIFTH AVE - STA 563+50.00 TO STA 56	XS183	1388	FORBES AVE - STA 155+00.00 TO STA	133+50.00 XS214	1419	CROSS SECTIONS FORBES AVE - STA 152+00.00
sh@de	XS122	1327	CROSS SECTIONS FIFTH AVE - STA 521+50.00	XS153	1358	CROSS SECTIONS FIFTH AVE - STA 564+50.00 TO STA 57	73+95.00 XS184	1389	FUNDES AVE - STA 134+00.00 TO STA	134+50.00 XS215	1420	CROSS SECTIONS FORBES AVE - STA 152+50.00
 	XS123	1328	CROSS SECTIONS FIFTH AVE - STA 526+50.00  ORDER OF STA 526+50.00	XS155	1360	CROSS SECTIONS WASHINGTON PL - STA 25+50.00	XS185	1390	FORDES AVE - STA 135+00.00 TO STA	135+50.00 XS216	1421	CROSS SECTIONS FORBES AVE - STA 152+55.00
seph.	XS124	1329	CROSS SECTIONS FIFTH AVE - STA 527+00.00 TO STA 527+30.00	XS156	1361	CROSS SECTIONS PRIDE ST - STA 30+50.00	XS186	1391	FUNDES AVE - STA 136+00.0	0 XS217	1422	CROSS SECTIONS FORBES AVE - STA 153+50.00
10/108	XS125	1330	CROSS SECTIONS FIFTH AVE - STA 527+50.00 TO STA 528+00.00	XS157	1362	CROSS SECTIONS MARION ST - STA 22+75.00	XS187	1392	FUNDES AVE - STA 136+50.0	0 XS218	1423	CROSS SECTIONS FORBES AVE - STA 154+50.00 ODDOC STA 154+50.00
s16_n	XS126	1331	CROSS SECTIONS FIFTH AVE - STA 530+50.00 TO STA 531+00.00	XS158	1363	CROSS SECTIONS WYANDOTTE ST - STA 30+50.00	XS188	1393	FUNDES AVE - STA 136+10.0	0 XS219	1424	CROSS SECTIONS FORBES AVE - STA 155+00.00 TO STA 155+27.00
b Jmos	XS127	1332	CROSS SECTIONS FIFTH AVE - STA 531+50.00 TO STA 532+00.00	XS159	1364	CROSS SECTIONS KIRKPATRICK ST - STA 30+50.00 TO STA		1394	FUNDES AVE - STA 131+00.0			
g\dec	XS128	1333	CROSS SECTIONS FIFTH AVE - STA 532+50.00	XS160	1365	CROSS SECTIONS KIRKPATRICK ST - STA 31+50.00	0 XS190	1395	CROSS SECTIONS FORBES AVE - STA 137+50.0	00		
silich" orking\												
"joseph.			044			T T	THE PREPARATION OF THIS		DE	ESIGNED JMS		ORT AUTHORITY OF ALLEGHENY COUNTY
78 "jo	A						DOCUMENT HAS BEEN FINANG PART THROUGH A GRANT FRO EDERAL TRANSIT ADMINISTE	OM THE		RAWN         JMS           HECKED         MES		SBURGH PENNSYLVANIA BUS RAPID TRANSIT UPTOWN TO OAKLAND
RATOR: E PATH:	7	Gulf Tow 07 Grant S					J.S. DEPARTMENT OF FRANSPORTATION, UNDER TH JRBAN MASS TRANSPORTATI		$C \cap V$ $C \cap V$ $\cap C \cap V$ $\cap C \cap V$ $\cap C \cap V$ $\cap C \cap V$	CHARGE <u>LAR</u> ATE <u>05/01/24</u>		INDEX OF DRAWINGS
OPE FILI		5th Floosburgh, PA	or	NO. DATE		DESCRIPTION	DE 1964, AS AMENDED, FOR T PORT AUTHORITY OF ALLEGH COUNTY, PENNSYLVANIA.	HE	,	CALE AS SHOWN	Port	Authority CONTRACT NO. BRT-001
	riil	buurgii, P	7 10218			REVISIONS	JOONTI, FEMINOTEVANIA.			7.0 0110 1011		connecting people to life DWG. NO. GN14 SHT. 14

	DRAWING SHEET NUMBER NUMBER	TITLE	DRAWING SHE			
		CROSS SECTIONS (CONT'D)		CROSS SECTIONS ((	CONT'D)	
	XS220 1425	CROSS SECTIONS FORBES AVE - STA 155+50.00	XS251 145	CROSS SECTIONS		
	XS221 1426	CROSS SECTIONS FORBES AVE - STA 155+99.00	XS252 145	CROSS SECTIONS		
	XS222 1427	CROSS SECTIONS FORBES AVE - STA 156+00.00	XS253 145	CROSS SECTIONS		
	XS223 1428	CROSS SECTIONS FORBES AVE - STA 156+50.00 TO STA 157+00.00	XS254 145	CDOSS SECTIONS		
	XS224 1429	CROSS SECTIONS FORBES AVE - STA 157+50.00	XS255 146	CDOSS SECTIONS		
	XS225 1430	CROSS SECTIONS FORBES AVE - STA 158+00.00	XS256 146	CROSS SECTIONS FORBES AVE - STA 176-	-50.00	
	XS226 1431	CROSS SECTIONS FORBES AVE - STA 158+50.00	XS257 146	CROSS SECTIONS FORBES AVE - STA 176-	-58.00	
	XS227 1432	CROSS SECTIONS FORBES AVE - STA 159+00.00	XS258 146	CROSS SECTIONS FORBES AVE - STA 177	-00.00	
	XS228 1433	CROSS SECTIONS FORBES AVE - STA 159+50.00	XS259 146	CROSS SECTIONS FORBES AVE - STA 177+50.00 TO	STA 178+00.00	
	XS229 1434	CROSS SECTIONS FORBES AVE - STA 160+00.00	XS260 146	CROSS SECTIONS FORBES AVE - STA 178-	-50.00	
	XS230 1435	CROSS SECTIONS FORBES AVE - STA 160+50.00	XS261 146	CROSS SECTIONS FORBES AVE - STA 179	-00.00	
	XS231 1436	CROSS SECTIONS FORBES AVE - STA 161+00.00	XS262 146	CROSS SECTIONS FORBES AVE - STA 179	-50.00	
	XS232 1437	CROSS SECTIONS FORBES AVE - STA 161+36.00	XS263 146	CROSS SECTIONS FORBES AVE - STA 180-	-00.00	
	XS233 1438	CROSS SECTIONS FORBES AVE - STA 161+50.00	XS264 146	CROSS SECTIONS FORBES AVE - STA 180-	-50.00	
	XS234 1439	CROSS SECTIONS FORBES AVE - STA 162+00.00	XS265 147	O CROSS SECTIONS FORBES AVE - STA 180	-65.89	
	XS235 1440	CROSS SECTIONS FORBES AVE - STA 162+50.00	XS266 147	CROSS SECTIONS FORBES AVE - STA 211+50.00 TO	STA 212+00.00	
	XS236 1441	CROSS SECTIONS FORBES AVE - STA 163+00.00	XS267 147	CROSS SECTIONS FORBES AVE - STA 212+41.00 TO	STA 212+50.00	
	XS237 1442	CROSS SECTIONS FORBES AVE - STA 163+50.00 TO STA 164+00.00	XS268 147	CROSS SECTIONS FORBES AVE - STA 213+00.00 TO	STA 213+50.00	
	XS238 1443	CROSS SECTIONS FORBES AVE - STA 164+50.00 TO STA 165+00.00	XS269 147	CROSS SECTIONS FORBES AVE - STA 217	-15.00	
	XS239 1444	CROSS SECTIONS FORBES AVE - STA 165+50.00	XS270 147	CROSS SECTIONS FORBES AVE - STA 217	-21.50	
	XS240 1445	CROSS SECTIONS FORBES AVE - STA 165+88.00	XS271 147	CROSS SECTIONS FORBES AVE - STA 224+00.00 TO	STA 224+50.00	
	XS241 1446	CROSS SECTIONS FORBES AVE - STA 166+00.00	XS272 147	FUNDES AVE - STA 224+75.00 TO		
	XS242 1447	CROSS SECTIONS FORBES AVE - STA 166+32.00	XS273 147	FUNDES AVE - STA 223		
	XS243 1448	CROSS SECTIONS FORBES AVE - STA 166+50.00	XS274 147	FURDES AVE - STA 236+00.00 TO	STA 236+50.00	
	XS244 1449	CROSS SECTIONS FORBES AVE - STA 167+00.00 TO STA 167+50.00	XS275 148	FUNDES AVE - STA 236+36.00 TO	STA 237+00.00	
	XS245 1450	CROSS SECTIONS FORBES AVE - STA 168+00.00 TO STA 168+50.00	XS276 148	FUNDES AVE - STA 231		
	XS246 1451	CROSS SECTIONS FORBES AVE - STA 169+00.00 TO STA 169+50.00	XS277 148	FUNDES AVE - STA 245		
	XS247 1452	CROSS SECTIONS FORBES AVE - STA 170+00.00 TO STA 170+50.00	XS278 148	FORDES AVE - STA 243+30,00 TO	STA 245+76.00	
	XS248 1453	CROSS SECTIONS FORBES AVE - STA 171+00.00	XS279 148	FURDES AVE - STA 246+00,00 TO	STA 246+46.00	
	XS249 1454	CROSS SECTIONS FORBES AVE - STA 171+28.00 TOSTA 171+50.00	XS280 148	FUNDES AVE - STA 246+50,00 TO	STA 247+00.00	
	XS250 1455	CROSS SECTIONS FORBES AVE - STA 172+00.00 TO STA 172+50.00	XS281 148	CROSS SECTIONS FORBES AVE - STA 247+50.00 TO	STA 248+00.00	
A = 00 A 4		THE BREAK	ION OF THIS	·	DESIGNED JMS	PORT AUTHORITY OF ALLEGHENY COUNTY
AECOM		PART THROUGH	S BEEN FINANCED IN I A GRANT FROM THE	(NOT FOR	DRAWN JMS CHECKED MES	PITTSBURGH PENNSYLVANIA BUS RAPID TRANSIT UPTOWN TO OAKLAND
Gulf Tower		U.S. DEPARTME TRANSPORTATI	ON, UNDER THE	CONSTRUCTION)	IN CHARGE <u>LAR</u>	INDEX OF DRAWINGS
707 Grant Street 5th Floor	NO. DATE	OF 1964, AS AME PORT AUTHORI	RANSPORTATION ACT ENDED, FOR THE TY OF ALLEGHENY	JONOTINO HON	DATE 05/01/24  SCALE  A.S. S. H. O.M.N.I.	Port Authority CONTRACT NO. BRT-001
Pittsburgh, PA 15219		REVISIONS COUNTY, PENNS	SYLVANIA.	·	AS SHOWN	connecting people to life DWG. NO. GN15 SHT. 15

sнт. 16

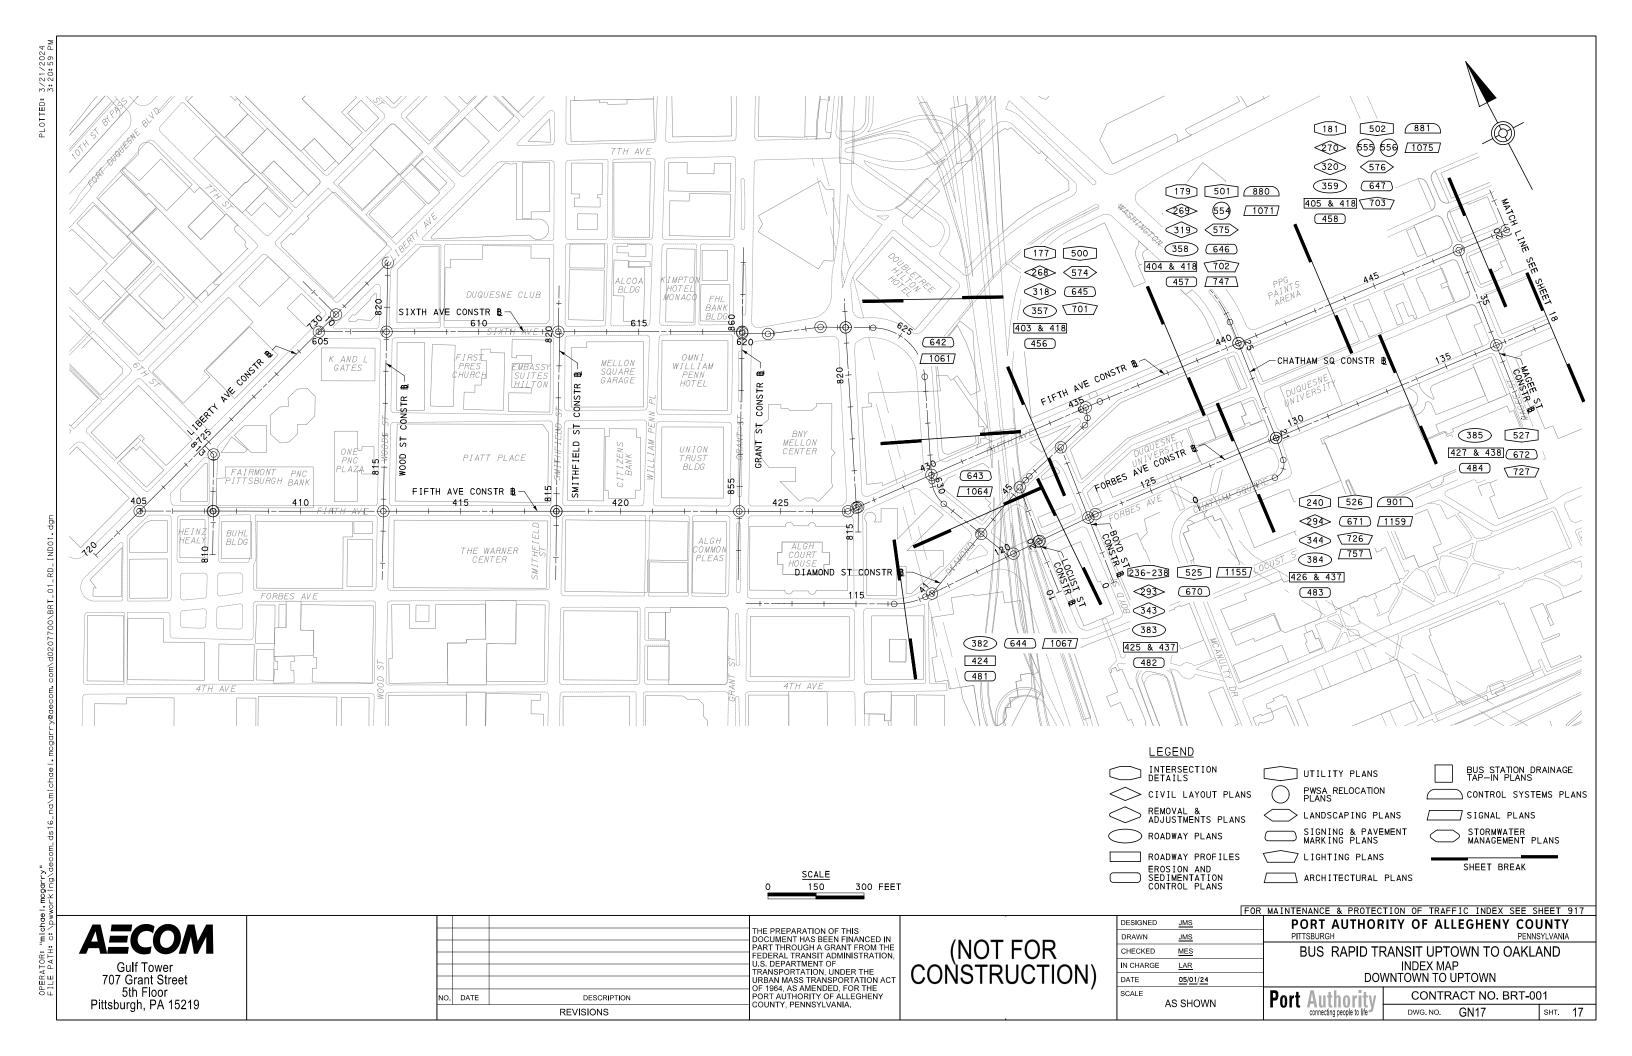

150

300 FEET

AECOM


**Gulf Tower** 707 Grant Street 5th Floor Pittsburgh, PA 15219


THE PREPARATION OF THIS DOCUMENT HAS BEEN FINANCED IN PART THROUGH A GRANT FROM THE FEDERAL TRANSIT ADMINISTRATION, U.S. DEPARTMENT OF TRANSPORTATION, UNDER THE URBAN MASS TRANSPORTATION ACT OF 1964, AS AMENDED, FOR THE PORT AUTHORITY OF ALLEGHENY COUNTY, PENNSYLVANIA. NO. DATE DESCRIPTION REVISIONS

(NOT FOR CONSTRUCTION

FOR MAINTENANCE & PROTECTION OF TRAFFIC INDEX SEE SHEET 918 DESIGNED PORT AUTHORITY OF ALLEGHENY COUNTY <u>JMS</u> DRAWN <u>JMS</u> BUS RAPID TRANSIT UPTOWN TO OAKLAND CHECKED MES N CHARGE INDEX MAP LAR UPTOWN DATE 05/01/24 SCALE CONTRACT NO. BRT-001 **Port Authority** AS SHOWN DWG.NO. GN18 sнт. 18

ARCHITECTURAL PLANS

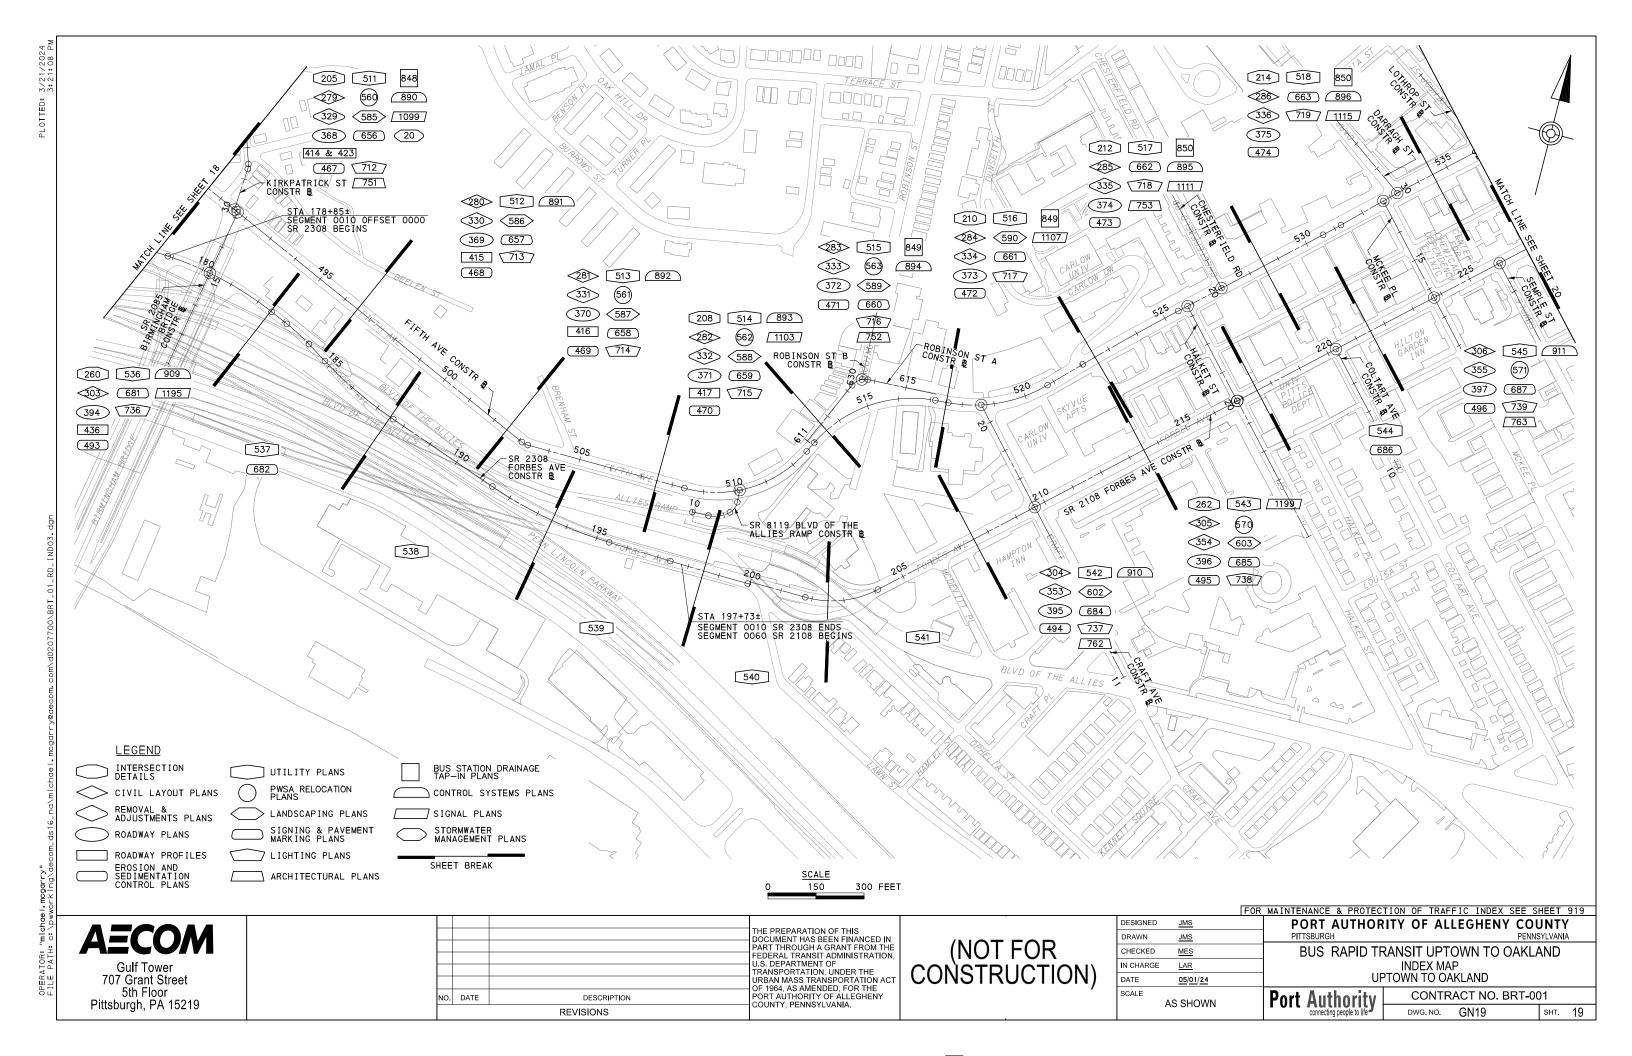

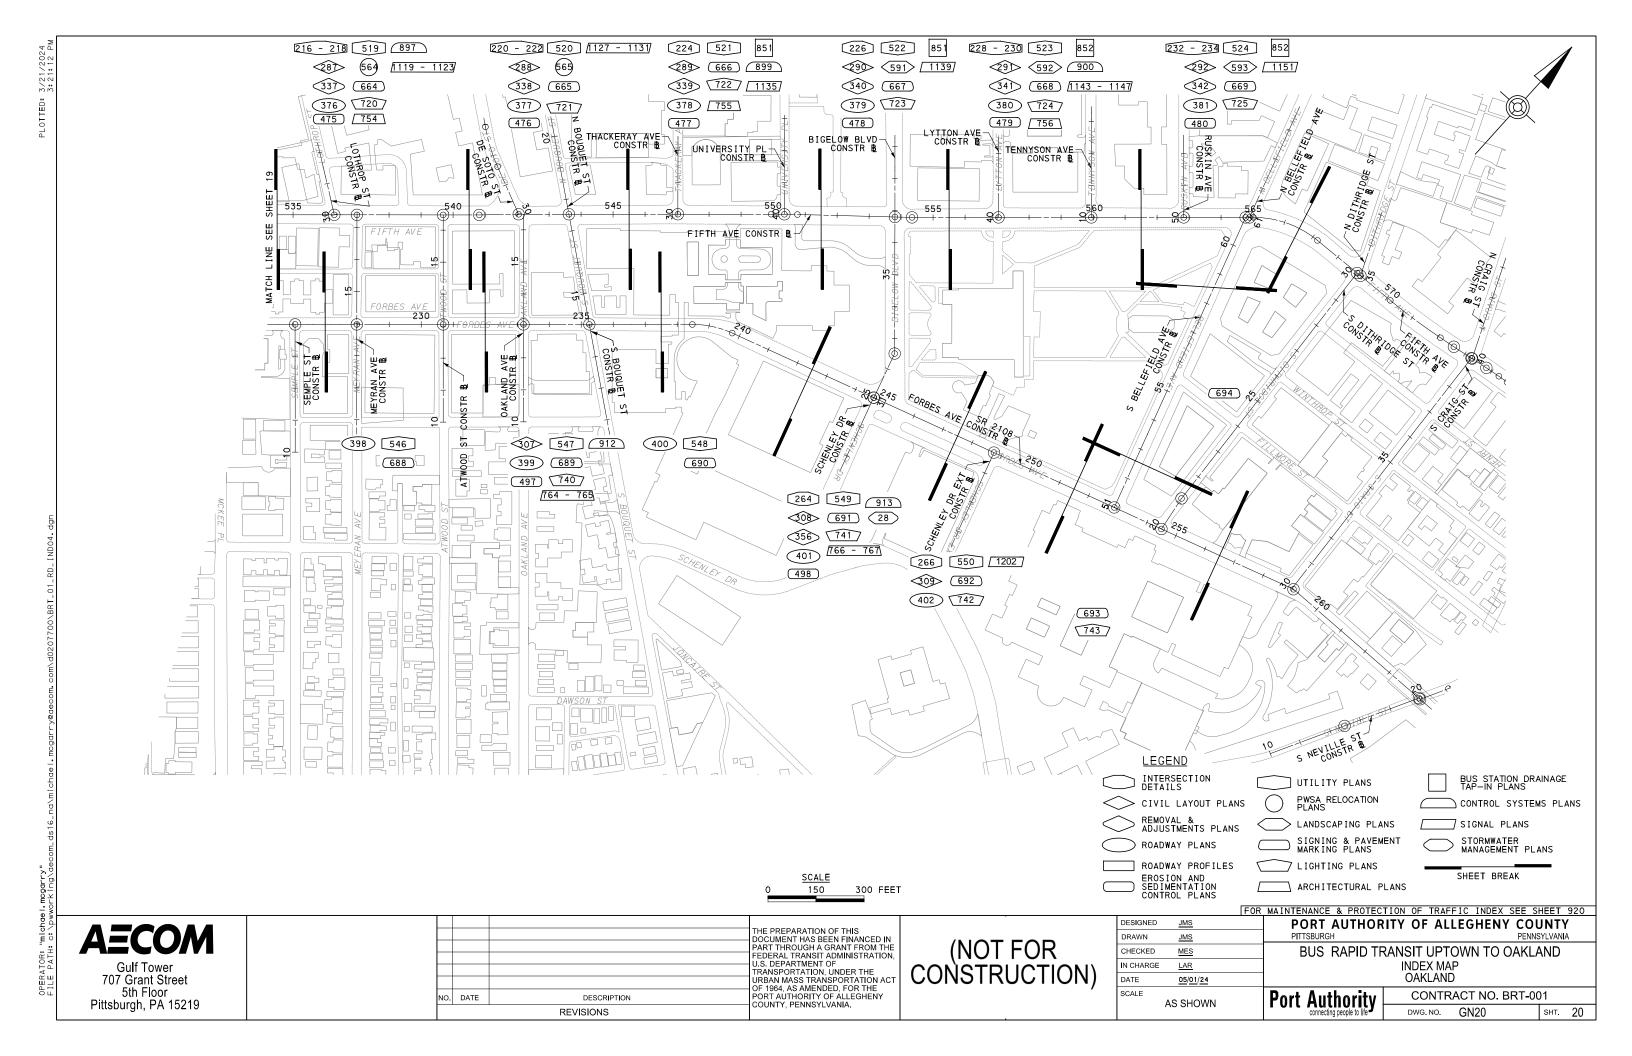

### GENERAL NOTES

- NOTIFY THE CITY OF PITTSBURGH DEPARTMENT OF MOBILITY AND INFRASTRUCTURE SURVEY PARTY CHIEF AT 412-255-2517 AT LEAST FOURTY-EIGHT (48) HOURS IN ADVANCE OF ANY CONSTRUCTION WHICH MAY INVOLVE STREET MONUMENTS OR BENCHMARKS.
- THE PROJECT BASE MAPPING WAS PREPARED WITH THE USE OF LIDAR AND ON THE GROUND SURVEY MAPPING LOCATING CURB LINES, UTILITIES AND EXISTING CITY MONUMENTS.
- THE PROJECT BASE MAPPING HAS BEEN UPDATED TO ACCOUNT FOR ONGOING MODIFICATIONS TO THE SITE, TO THE EXTENT PRACTICAL. THE BASE MAPPING MAY NOT ACCURATELY DEPICT THE PROJECT SITE, CONTRACTOR IS RESPONSIBLE TO FIELD VERIFY PRIOR TO BEGINNING WORK.
- THE HORIZONTAL CONTROL IS BASED ON THE PENNSYLVANIA STATE PLANE COORDINATE SYSTEM (SPCS 83) (SOUTH SIDE) GEOID 12B. VERTICAL CONTROL IS BASED ON THE NORTH AMERICAN VERTICAL DATUM 1988 (NAVD 88).
- COMBINED SCALE FACTOR IS 0.999916411 FORBES AVE COMBINED SCALE FACTOR IS 0.999919875 FIFTH AVE
- . CURVE DATA IS BASED ON THE ARC DEFINITION UNLESS
- 7. ALL FIELD SURVEYING THAT WAS PERFORMED WITH GPS WAS ON THE
- ALL FIELD SURVEYING THAT WAS PERFORMED DOWNTOWN WAS DONE WITH ROBOTIC TOTAL STATION.
- DO NOT INTERFERE WITH THE OPERATION OF ANY FIRE HYDRANT, FIRE CALL BOX OR POLICE CALL BOX, UNLESS DIRECTED BY THE CONTRACT DRAWINGS OR THE ENGINEER.
- 10. ALL DIMENSIONS ON CONTRACT DRAWINGS ARE MEASURED HORIZONTALLY, UNLESS OTHERWISE NOTED.
- 11. ALL SIDEWALK AND ROADWAY SURFACE REPLACEMENTS SHALL BE CONSTRUCTED TO THE NEAREST EXISTING CONSTRUCTION JOINT AT OR BEYOND THE END OF CONSTRUCTION WITHIN LEGAL RIGHT-OF-WAY OR TEMPORARY CONSTRUCTION EASEMENT, EXCEPT AS NOTED ON THE CONTRACT DRAWINGS. CONCRETE PAVEMENT RECONSTRUCTION LIMITS HAVE BEEN ESTABLISHED TO THE NEAREST EXISTING PAVEMENT JOINT. SAW CUT CONCRETE PAVEMENT AS DIRECTED. PAVEMENT RECONSTRUCTION LIMITS TYING INTO EXISTING BITUMINOUS SURFACES WILL BE SAW CUT AND SEALED AS PER THE CONTRACT DRAWINGS.
- 12. SLOPES DENOTED ON THESE DRAWINGS ARE SHOWN IN ENGLISH PROTOCOL AS 2:1. (TWO HORIZONTAL TO ONE VERTICAL).
- 13. CONSTRUCT CURB TO MATCH EXISTING SIDE STREET CURB. CONSTRUCT SIDEWALKS FLUSH WITH TOP OF CURB UNLESS OTHERWISE DIRECTED BY THE ENGINEER.
- 14. ALWAYS ASSUME THE EXISTING UTILITY CONDUITS ARE ACTIVE. UTILITIES IDENTIFIED AS ABANDONED SHALL BE CONFIRMED WITH FACILITY OWNER BEFORE ANY WORK IS PERFORMED.
- 15. UTILITIES SHOWN ON THE DRAWINGS REPRESENT THE EXTENT OF UTILITIES WHICH MAY BE IMPACTED BY CONSTRUCTION, NOT THE TOTAL EXTENT OF THE RESPECTIVE UTILITIES.
- 16. THE CONTRACTOR SHALL BE AWARE THAT PORTIONS OF THE WORK ARE IN CLOSE PROXIMITY TO EXISTING BASEMENT WALLS AND UTILITY STRUCTURES. PERFORM EXPLORATORY INVESTIGATIONS AS DETAILED IN THE TECHNICAL PROVISIONS. IN THE EVENT THE LOCATION OF THE EXISTING STRUCTURES IS WITHIN THE PROPOSED CONSTRUCTION OR THE PROPOSED CONSTRUCTION ADVERSELY AFFECTS THE BASEMENT WALL OR VAULT OR UTILITY, CONTACT THE ENGINEER IMMEDIATELY.
- 17. THE LIMITS OF WORK ARE INDICATED ON THE SHEET INDEX PLANS.
  PLAN SHEETS FOR EACH DISCIPLINE ARE MEANT TO COVER THE
  WORK NECESSARY FOR THAT DISCIPLINE. THEREFORE, IF THERE IS
  NO WORK FOR A PARTICULAR DISCIPLINE ON A PLAN SHEETS, THEN THAT PLAN SHEET MAY HAVE BEEN OMITTED.

- 18. CONTROL POINTS FOR THE CONSTRUCTION OF EACH PAAC STATION HAVE BEEN ESTABLISHED AND A BENCHMARK HAS BEEN SET. USE STATION CONTROL POINTS DRAWINGS THAT SHOW THE REFERENCE TIES FOR EACH CONTROL POINT IN THE EVENT THE BENCHMARKS ARE DISTURBED OR REMOVED PRIOR TO CONSTRUCTION OF THE PAAC
- 19. CONTRACTOR IS RESPONSIBLE FOR SETTING THE BRT STATION ACCURATELY TO WITHIN 0.01' HORIZONTALLY AND WITHIN 0.01' VERTICALLY.
- 20. STATE ROUTES INCLUDE:

  SR 2108 (FORBES AVE)
  SR 2308 (FORBES AVE)
  SR 2085 (BIRMINGHAM BRIDGE)
  SR 8119 (BLVD OF THE ALLIES RAMP)
  ALL OTHER STREETS IN THE PROJECT ARE CITY STREETS.
- 21. MANHOLE & VAULT COVERS SHOULD NOT BE LOCATED ON PAVEMENT JOINT. COORDINATE JOINT LAYOUT WITH THE CONSTRUCTION & UTILITY PLANS.
- 22. TEMPORARY CONSTRUCTION EASEMENT. AN EASEMENT TO USE THE LAND DURING CONSTRUCTION OF THE PROJECT. THE EASEMENT IS REQUIRED ONLY UNTIL THE CONSTRUCTION OR WORK INDICATED BY THE PLAN IS COMPLETED, UNLESS SOONER RELINQUISHED IN WRITING BY THE AUTHORITY. SEE APPENDIX B FOR ADDITIONAL PROJUBLEMENTS
- 23. TEMPORARY CONSTRUCTION EASEMENT LINES SHOWN ON THE PLANS HAVE BEEN OFFSET A SET DISTANCE FROM THE LIMIT OF PHYSICAL WORK. THIS DOES NOT GIVE THE RIGHT TO ENTER A BUILDING, MODIFY A BUILDING, STEPS, PLANTER WALL OR RETAINING WALL, NOR ENTER OR MODIFY A LANDSCAPE AREA, UNLESS APPROVED BY THE ENGINEER IN WEITING. THE ENGINEER, IN WRITING.
- 24. PRIVATE PROPERTY LINES WERE NOT SURVEYED BY THE PROFESSIONAL LAND SURVEYOR RESPONSIBLE FOR THE PROJECT AND ARE FOR INFORMATION ONLY. THEIR ACCURACY IS NOT
- 25. SEE CONTRACT APPENDIX B "RIGHT-OF-WAY TRACKER" FOR RIGHT-OF-WAY AND TEMPORARY CONSTRUCTION EASEMENT PLATS.
- 26. CONFINE OPERATIONS WITHIN CITY OF PITTSBURGH RIGHT-OF-WAY INCLUDING TEMPORARY CONSTRUCTION EASEMENTS. THE CONTRACTOR'S WORK WILL ENCROACH WITHIN PENNSYLVANIA DEPARTMENT OF TRANSPORTATION EXISTING LEGAL RIGHT-OF-WAY.
- 27. THIS IS A FEDERAL AID PROJECT AND AS SUCH IS SUBJECT TO INSPECTION BY REPRESENTATIVES OF THE FEDERAL GOVERNMENT.
- 28. ALL WORK DONE UNDER THIS CONTRACT SHALL BE IN ACCORDANCE WITH THE CONTRACT DOCUMENTS.
- 29. ALL UTILITIES SHOWN ARE QUALITY LEVEL "D" (QL-D) UNLESS
- 30. THREE WORKING DAYS PRIOR TO EXCAVATION, CALL THE PA ONE CALL SYSTEM, INC. 1-800-242-1776
- 31. UTILITY SIZE SHOWN HEREON IS TAKEN FROM UTILITY RECORDS.
- 32. UTILITY DEPTHS NOTED OR SHOWN ON CROSS SECTIONS ARE BASED UPON UTILITY OWNER ESTIMATED DEPTHS. ACTUAL FIELD CONDITIONS MAY VARY. THE CONTRACTOR SHALL VERIFY ACTUAL FIELD CONDITIONS PRIOR TO CONSTRUCTION.
- 33. PRIOR TO EXCAVATION ON ADJACENT PROPERTIES, CONTACT PROPERTY OWNERS TO DETERMINE UTILITY LOCATIONS.
- 34. THE ORIGINAL SURVEYING INFORMATION WAS COMPLETED IN 2017
  AS A MOBILE LIDAR. AWK ENGINEERS COMPLETED TRADITIONAL
  SUPPLEMENTAL SURVEY IN OCTOBER 2019, MARCH 2020, JUNE 202
  AND OCTOBER 2022. CONTACT THE ENGINEER FOR ADDITIONAL JUNE 2020
- 35. WORK PERFORMED ON STATE ROADS 2108, 2308, 2085 AND 8119 ARE PERMITTED UNDER PENNSYLVANIA DEPARTMENT OF TRANSPORTATION HIGHWAY OCCUPANCY PERMIT #11059300.

RNA (ROADWAY NOTIFICATION AND APPROVAL) - 21 DAYS PRIOR TO START OF WORK: 1) RNA FORM MUST BE SUBMITTED VIA EMAIL TO PERMIT SUPERVISOR AND THOSE LISTED ON THE RNA FORM. THE RNA FORM AND IT'S INSTRUCTIONS ARE IN THE ATTACHMENTS SECTION OF THE HOP.

DETAILS OTHER THAN THOSE INDICATED ARE ON THE FOLLOWING STANDARD DRAWINGS

PENNSYLVANIA DEPT OF TRANSPORTATION STANDARD DRA	WINGS
RC-10M JUNE 1, 2010 CLAS	SIFICATION OF
RC-13M JUNE 1, 2010 PAY   RC-20M NOV 1, 2022 CONC RC-21M JUNE 1, 2010 REIN	HWORK LIMIT OF SUBBASE RETE PAVEMENT JOINTS FORCED CONCRETE
RC-26M NOV 30, 2021 CONC	MENI RETE PAVEMENT BILITATION
RC-27M NOV 30, 2021 PLAI RC-28M SEPT 1, 2023 OVER	N CONCRETE PAVEMENT LAY TRANSITIONS AND NG NOTCHES
RC-30M FEB 27, 2023 SUBS RC-32M JUNE 1, 2010 SLOP CONN	URFACE DRAINS E PIPE FITTINGS, PIPE ECTORS AND CONCRETE
RC-38M SEPT 15, 2016 SANI	AR FOR PIPE EXTENSION TARY SEWER MANHOLES M WATER MANHOLES T TOPS, GRATES AND E
RC-46M FEB 19, 2021 INLE RC-57M SEPT 1, 2023 CONC RC-64M FEB 19, 2021 CURB RC-65M DEC 17, 2019 CONC RC-67M FEB 19, 2021 CURB RC-70M FEB 8, 2019 PERI	T BOXES RETE MEDIAN BARRIER S AND GUTTERS RETE MOUNTABLE CURBS RAMPS AND SIDEWALKS METER CONTROL DEVICES MENT BASIN AND
RC-72M FEB 8, 2019 INLE	T AND OUTLET ECTION
RC-77M DEC 17, 2019 ROCK ENTR	CONSTRUCTION
RC-80M NOV 1, 2022 HIGH	WAY LIGHTING - ENTIONAL LIGHTING
RC-82M JUNE 1, 2010 HIGH	WAY LIGHTING - TION BOXES - HEAVY
DUTY RC-83M NOV 1, 2022 HIGH MAST	WAY LIGHTING - HIGH LIGHTING
L I GH' DETA	WAY LIGHTING - TING AND ELECTRICAL ILS
DETA	
RC-92M JUNE 1, 2010 REMO TRIM	VAL LIMITS OF TREE MING
	FORCEMENT BAR ICATION DETAILS
( E C0	VEMENT MARKINGS XPRESSWAY/FREEWAY, NVENTIONAL, LEGENDS
TC-8604 AUG 17, 2021 DE TC-8700C JUNE 13, 2013 SP AP	SYMBOLS) LINIATION ACING CHARTS/DIRECT PLIED LETTERS,
TC-8701S JUNE 13, 2013 FL	MERALS & ARROWS AT SHEET ALUMINIUM
TC-8702B JUNE 13, 2013 PO	GNS ST-MOUNTED SIGNS,
TC-8715 JUNE 13, 2013 SI	PE B GN LIGHTING BE III BARRICADE
TC-8717 JUNE 13, 2013 TE SI	PE III BARRICADE MPORARY PORTABLE GN POST, "H" BASE D "X" BASE
TC-8802 DEC 12, 2011 CO TC-8803 DEC 12, 2011 MI TC-8804 DEC 12, 2011 EL	AFFIC SIGNAL SUPPORT NTROLLER ASSEMBLY SCELLANEOUS ECTRICAL STRIBUTION
TC-8805 DEC 12, 2011 SI	GNAL HEADS TECTORS

CITY	0F	PI.	TTSE	BURGH	-	DE	PAR	<b>IMENT</b>	0F	PUBL I C	WORKS	
DEDVE	2 T ME	=NT	7	MORTI	Т.	ΓY	VIID	INER	V C T	SHCTHRE		

CTY SERIES (2008)

RIGHT-DE-WAY PROCEDURES MANUAL (MAY 1, 2022)

RIGHT-OF-WAY PE	ROCEDURES MANUAL (MAY 1, 2022)
PL-200 SC-500 SC-501A	ROCEDURES POLICY (JUNE 1, 2017) STREET TREE ROOT ZONE REQUIREMENTS REINFORCED CONCRETE SIDEWALK BITUMINOUS PAVEMENT FOR PRIMARY AND SECONDARY STREETS GRANITE CURB
SC-501B SC-502A SC-502B SC-502C SC-502D SC-502E SC-502F SC-502G SC-502I	GRANITE CURB TYPE 1 CURB RAMP, 6' SIDEWALK TYPE 1 CURB RAMP, 5' SIDEWALK TYPE 2 CURB RAMP, 4' LANDING TYPE 2 CURB RAMP, 3' LANDING TYPE 3 CURB RAMP, 4' LANDING TYPE 3 CURB RAMP, 3' LANDING TYPE 4 CURB RAMP TYPE 100 CURB RAMP, 4' LANDING TYPE 100 CURB RAMP, 3' LANDING
(JULY 1, 1993) SA-200 SA-202 SC-300 SC-501	JRGH STANDARDS OF CONSTRUCTION  STREET PAVEMENTS - TREATMENT AT CURB TRENCH REPAVING DETAILS GRANITE CURB DETAILS BRICK AND RUSTIC TERRAZZO SIDEWALK INSTALLATION OF SURVEY MONUMENT
CITY OF PITTSBL	JRGH STANDARD DETAILS OF

CONSTRUCTION (NOV 2008)
SA-100
SA-101
JOINT DE JOINT PATTERNS
JOINT DETAILS

REINFORCING DETAILS

### DUQUESNE LIGHT COMPANY STANDARD DRAWINGS

60912 - VAULT LADDER DETAILS (OHSA) - REV 10 62142 - STRUCTURAL DESIGN & SECTIONS OF 5' X 9' STRUCTURAL DESIGN & DETAILS (SET - A) -62144 - STRUCTURAL DESIGN & SECTIONS OF 6' X 12' HATCH - REV 3
62181 - STRUCTURAL DESIGN & SECTIONS OF 2'-111/8" X 3'-3 \( \frac{1}{4} \)" HATCH - REV 2

sнт. 21


GN21

DWG NO

PITTSBURGH WATER & SEWER AUTHORITY PWSA STANDARD DETAILS FOR WATER TAP-INS

# AECOM

707 Grant Street 5th Floor Pittsburgh, PA 15219

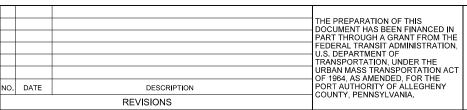

(NOT FOR CONSTRUCTION)

DESIGNED	<u>SDS</u>	PORT AUTHOR	RITY OF ALLEGHENY	COUNTY			
DRAWN	<u>JMS</u>	PITTSBURGH	F	ENNSYLVANIA			
CHECKED	<u>MES</u>	BUS RAPID TE	RANSIT UPTOWN TO OA	KLAND			
IN CHARGE	LAR	GENERAL NOTES					
DATE	<u>05/01/24</u>	AND	STANDARD DRAWINGS				
SCALE	AS SHOWN	Port Authority	CONTRACT NO. BR	Γ-001			
	AS SHOWN	I of that indire	ONO4				

### LIST OF PUBLIC UTILITIES

PITTSBURGH WATER AND SEWER AUTHORITY (PWSA)

PITTSBURGH REGIONAL TRANSIT

UNIVERSITY OF PITTSBURGH

PA. ONE CALL SERIAL NO.

VERIZON

PITTSBURGH UNIVERSITY

MEDICAL CENTER (PUH)

OWNER	LINESTYLE	ADDRESS	REPRESENTATIVE	TELEPHONE	EMAIL ADDRESS
ALLEGHENY CITY ELECTRIC		3080 BABCOCK BLVD. PITTSBURGH, PA 15237	TOM ULIZZI	412-931-0777	412-931-0777
ALLEGHENY COUNTY SANITARY AUTHORITY		3300 PREBLE AVENUE PITTSBURGH, PA 15233	JEFFREY CZOCHERA	412-766-4810	JEFFREY.CZOCHARA@ ALLEGHENYCOUNTY.COM
AT&T ATLANTA LONG DISTANCE (COMMUNICATION)		2500 ALLEGHENY CENTER PITTSBURGH, PA 15212	JAMES SCHRENK	412-316-9930	JS9723@ATT.COM
AT&T LOCAL SERVICES (COMMUNICATION)		2500 ALLEGHENY CENTER PITTSBURGH, PA 15212	MIKE HUDDLESTON PAT SUTTON	724-622-7196 814-321-6470	MHUDDLESTON@MBAKERINTL.COM PS4364@ATT.COM
CARLOW UNIVERSITY		3333 FIFTH AVENUE PITTSBURGH, PA 15213	DANIEL HALL	412-578-6591	DJHALL@CARLOW. EDU
CARNEGIE MELLON UNIVERSITY (COMMUNICATION/STEAM)		5000 FORBES AVENUE PITTSBURGH, PA 15213	ANDREW REILLY	412-268-8904	AREILLY@ANDREW.CMU.EDU
LUMEN (FORMERLY CENTURYLINK) (FORMERLY QWEST COMMUNICATION)		6230 OLD DOBIN LANE SUITE 140 COLUMBIA, MD 21045	DAVID BINGER	301-361-3517 240-216-8325	DAVID.BINGER@LUMEN.COM
		DEPARTMENT OF MOBILITY	BRIAN RALSTON	412-389-4505	BRIAN.RALSTON@PITTSBURGHPA.GOV
	— EU1 —	AND INFRASTRUCTURE (DOMI) 414 GRANT ST	STEVEN AUTERMAN	412-523-7516	STEVEN. AUTERMAN@PITTSBURGHPA. GOV
		PITTSBURGH, PA 15219	DENNY ROBINSON (LIGHTING)		DENNY.ROBINSON@PITTSBURGHPA.GOV
CITY OF PITTSBURGH		PITTSBURGH BUREAU OF FIRE 200 ROSS STREET, 5TH FLOOR PITTSBURGH, PA 15219	CHRISTOPHER SKERTICH	412-255-2863	CHRISTOPHER.SKERTICH@PITTSBURGH PA.GOV
		DEPARTMENT OF PUBLIC SAFETY ADMINISTRATION 414 GRANT STREET, SUITE 400 PITTSBURGH, PA 15219	DANIEL R. SHAK	412-255-8977	DANIEL.SHAK@PITTSBURGHPA.GOV
CLEARWAY ENGERY	— CEU — — CW1 —	900 WALNUT STREET HARRISBURG, PA 17101	BARD RUPP	717-920-8273	BARD. RUPP@CLEARWAYENERGY. COM
CLEARWAT ENGERT	— ST1 —	1339 OUR WAY PITTSBURG, PA 15219	BRIAN SARTI	412-231-0409	BRIAN. SARTI@CLEARWAYENERGY. COM
COMCAST CABLEVISION	— c —	1530 CHARTIES AVENUE	ROBERT PIRAINO	412-875-1104	ROBERT_PIRAINO@COMCAST.COM
(COMMUNICATION)		PITTSBURGH, PA 15204	MATT WEST	928-899-8655	MATTHEW_WEST2@CABLECOMCAST.COM
CROWN CASTLE (COMMUNICATION)	— F0U2 —	2000 CORPORATE DRIVE CANONSBURG, PA 15317	ROBERT PACHOLARZ	732-718-9078	ROBERT. PACHOLARZ@CROWNCASTLE. COM
DUQUESNE LIGHT COMPANY (ELECTRIC)	EXISTING — EU —	2825 NEW BEAVER AVENUE PITTSBURGH, PA 15233	PATTY NAGLE	412-414-2818	PNAGLE@DUQLIGHT.COM
	— EU — PROPOSED	411 7th AVENUE MAIL DROP 6-1 PITTSBURGH, PA 15219	JIM RUNATZ	412-393-7813	JRUNATZ@DUQLIGHT.COM
DQE COMMUNICATIONS, LLC		424 S 27TH STREET PITTSBURGH, PA 15203	ADAM NULPH	724-919-7258	ACNULPH@DQE.COM
PEOPLE'S NATURAL GAS	EXISTING — G —	SUITE 400 375 N SHORE DRIVE PITTSBURGH, PA 15212	TODD COEN	412-258-4415	TODD. COEN@PEOPLES-GAS. COM
TEOLE 3 NATURAL GAS	— G — PROPOSED	4536 ROUTE 136, SUITE 1 GREENSBURG, PA 15601	GARY M. BAIRD	724-837-1057	GBAIRD@LSSE.COM
EXTENET SYSTEMS		5844 JOHN HICKMAN PKWY SUITE 600 FRISCO, TX 75034	JOSHUA BZOREK	412-639-1677	JDBZOREK@PIKE.COM

### RECORD OF EXISTING ROAD TYPES

NOTE: THE DEPTHS OF MATERIAL SHOWN ARE FOR DESIGN PURPOSES ONLY. RECENT CONSTRUCTION IN THE PROJECT AREA MAY HAVE MODIFIED THE EXISTING PAVEMENT STRUCTURE FROM WHAT IS SHOWN IN THIS TABLE, INCLUDING TYPE AND DEPTH OF PAVEMENT LAYERS. ANY RISK OF UNANTICIPATED COSTS ASSOCIATED WITH DIFFERENCES BETWEEN THE LISTED DEPTHS AND THE ACTUAL DEPTHS SHALL BE ACCEPTED BY THE CONTRACTOR.

FIFTH AVE STA 434+00 TO STA 491+16 (DIAMOND ST TO SR 2085 BIRMINGHAM BRIDGE)	5" ASPHALT ON 5" BLOCKSTONE ON 6" CONCRETE
FIFTH AVE STA 491+16 TO STA 509+83 (SR 2085 BIRMINGHAM BRIDGE TO SR 8119 BLVD OF THE ALLIES RAMP)	13" ASPHALT ON 5" CONCRETE
FIFTH AVE STA 551+70 TO STA 553+10 (UNIVERSITY PL TO BIGELOW BLVD)	16" ASPHALT
FIFTH AVE STA 553+50 TO STA 564+89 (BIGELOW BLVD TO BELLEFIELD AVE)	17" ASPHALT
FORBES AVE STA 121+29 TO STA 180+64 (DIAMOND ST TO SR 2085 BIRMINGHAM BRIDGE)	5" ASPHALT ON 5" BLOCKSTONE ON 6" CONCRETE
FORBES AVE STA 214+00 TO STA 216+65 (CRAFT AVE TO HALKET ST)	9" ASPHALT ON 9" CONCRETE

FIFTH AVE STA 434+00 TO STA 491+16 (DIAMOND ST TO SR 2085 BIRMINGHAM BRIDGE)	5" ASPHALT ON 5" BLOCKSTONE ON 6" CONCRETE
FIFTH AVE STA 491+16 TO STA 509+83 (SR 2085 BIRMINGHAM BRIDGE TO SR 8119 BLVD OF THE ALLIES RAMP)	13" ASPHALT ON 5" CONCRETE
FIFTH AVE STA 551+70 TO STA 553+10 (UNIVERSITY PL TO BIGELOW BLVD)	16" ASPHALT
FIFTH AVE STA 553+50 TO STA 564+89 (BIGELOW BLVD TO BELLEFIELD AVE)	17" ASPHALT
FORBES AVE STA 121+29 TO STA 180+64 (DIAMOND ST TO SR 2085 BIRMINGHAM BRIDGE)	5" ASPHALT ON 5" BLOCKSTONE ON 6" CONCRETE
FORBES AVE STA 214+00 TO STA 216+65 (CRAFT AVE TO HALKET ST)	9" ASPHALT ON 9" CONCRETE

THE PERMITTEE MUST CONTACT THE PENNSYLVANIA ONE-CALL SYSTEM AT 1-800-242-1776 AT LEAST THREE WORKING DAYS PRIOR TO THE START OF EXCAVATION OR DEMOLITION WORK TO HAVE ALL UNDERGROUND UTILITIES MARKED IN THE WORK AREA.

# AECOM 707 Grant Street

5th Floor

Pittsburgh, PA 15219

THE PREPARATION OF THIS DOCUMENT HAS BEEN FINANCED IN PART THROUGH A GRANT FROM THE FEDERAL TRANSIT ADMINISTRATION U.S. DEPARTMENT OF TRANSPORTATION, UNDER THE URBAN MASS TRANSPORTATION ACT OF 1964 AS AMENDED FOR THE PORT AUTHORITY OF ALLEGHENY COUNTY, PENNSYLVANIA. NO. DATE DESCRIPTION REVISIONS

(NOT FOR CONSTRUCTION)

LINESTYLE

FXISTINO

PROPOSED

— CW2 -

— ST2 —

20172921587 20172921588 20172921589 20172921590 20172921650 20172921694 20172921695 20172921696

ADDRESS

1200 PENN AVENUE PITTSBURGH, PA 15222

200 LOTHROP STREET PITTSBURGH, PA 15213

PITTSBURGH, FACILITIES
MANAGEMENT, 3400 FORBES

AERIAL/UNDERGROUND 508 OLD FRANKSTOWN ROAD MONROEVILLE, PA 15146

WIRELESS 7575 COMMERCE COURT LEWIS CENTER, OH 43035

AVE, PITTSBURGH, PA

501 HOLIDAY DRIVE PITTSBURG, PA 15220

UNIVERSITY OF

**AERIAL** 

HEINZ 57 BUILDING 345 SIXTH AVE, 6TH FLOOR DENISE OTT PITTSBURGH, PA 15222

REPRESENTATIVE

WILLIAM MCFADDIN

MARGARET BELL

PAT BIGLEY

ASHELY DONALDSON

CHRISTOPHER HAWK

DANIEL BARRON

MICHAEL BONDY

ANA BENNETT

DARBY NEIDIG

TELEPHONE

412-255-8800

(EXT. 5548)

412-688-7126

412-237-2291

412-529-9266

412-255-8800 AFLORES@PGH20.COM (EXT.8035)

412-255-8800 WMCFADDIN@PGH20.COM

412-566-5379 DOTT@RIDEPRT. ORG

412-383-4287 PRB11@PITT.EDU

412-383-4287 AID140@PITT. EDU

ONEIDIG@PGH20.COM

BELLMD@UPMC. EDU

CHAWK@PIKE.COM

ANIEL.BARRON@VERIZON.COM

614-359-8773 MICHAEL. BONDY@VERIZONWIRELESS. COM

EMAIL ADDRESS

DESIGNED	SS	
DRAWN	<u>JMS</u>	
CHECKED	<u>TKF</u>	
IN CHARGE	LAR	
DATE	05/01/24	
SCALE		
	AS SHOWN	

# PORT AUTHORITY OF ALLEGHENY COUNTY

BUS RAPID TRANSIT UPTOWN TO OAKLAND GENERAL NOTES. LIST OF PUBLIC UTILITIES AND PA ONE CALLS

**Port Authority** 

CONTRACT NO. BRT-001 GN22 DWG NO sнт. 22

	A
ABD.	ABANDONED
A. F. F.	ABOVE FINISHED FLOOR
ABUT. A.DR.	ABUTMENT ACCESS DOOR
A. P.	ACCESS PANEL
ACCEL.	ACCELERATION
ACOUST. ADD.	ACOUSTICAL ADDITION
ADD' L	ADDITIONAL
ADJ.	ADJUSTING OR ADJUSTABLE
P.M. AGGR.	AFTERNOON AGGREGATE
AHD.	AHEAD
AC ACU	AIR CONDITIONING AIR CONDITIONING UNIT
A. V.	AIR VALVE
ALIGN.	AL I GNMENT
AB ALLOW.	ALIGNMENT BEARING ALLOWANCE
ALUM.	ALUMINUM
ALT. A.C.	ALTERNATE ALTERNATING CURRENT
AMP	AMPERE
<i>X</i>	ANGLE
ANT. AMT.	ANTENNA AMOUNT
APPL.	APPLICATION
APPR.	APPROACH
APP'D. APPROX.	APPROVED APPROXIMATE
ARCH.	ARCHITECTURAL
A A. D.	AREA AREA DRAIN
A. C. D.	ASBESTOS CEMENT DUCT
A C D	( CONDUIT)
A.C.P. ASPH.	ASBESTOS CEMENT PIPE ASPHALT
ASSY.	ASSEMBLY
ASST. ASSOC.	ASSISTANT ASSOCIATE
ASSN.	ASSOCIATE
<b>©</b>	AT
AUTO. A. A. V.	AUTOMATIC AUTOMATIC AIR VALVE
A. T. C.	AUTOMATIC AIR VALVE AUTOMATIC TEMPERATURE
ALIV	CONTROL
AUX. AVE.	AUXILIARY AVENUE
AVG.	AVERAGE
A. W. G.	AMERICAN WIRE GAUGE
	B
BK.	BACK
B' FILL	BACKFILL
B.S. B.TO B.	BACKSIGHT BACK TO BACK
BBL.	BARREL
<u>⊌</u> BSM′Т <b>.</b>	BASE LINE BASEMENT
BRG.	BEARING
B&X B <b>.</b> T <b>.</b> C <b>.</b>	BELL AND SPIGOT BELL TELEPHONE COMPANY
BM I.C.	BENCH MARK
BTWN.	BETWEEN
BEV. BIT.	BEVELED BITUMINOUS
ВССМР	BITUMINOUS COATED CORRU-
	GATED GALVANIZED STEEL PIPE
всвс	BITUMINOUS CONCRETE
	BASE COURSE
B. S. C.	BITUMINOUS SURFACE COURSE
BLK.	BLOCK
BLKG. B.O.V.	BLOCKING BLOW OFF VALVE
BD.	BOARD
BORO.	BOROUGH
B.F. B.W.	BOTH FACES BOTH WAYS
BOT.	BOTTOM
B/B B/C	BOTTOM OF BANK
B. C.	BOTTOM OF CURB BOTTOM CUT
B. F.	BOTTOM FILL
B. W.	BOTTOM WALL

B/D B/P B/S B. H. BL VD. BBY. BRK. BRKR. BRKR. BRKR. BRKR. BR. B. M. U. BRN. BL DC. B. L. B. L. B. L.	B CONT'D.  BOTTOM OF DUCT BOTTOM OF PANEL BOTTOM OF STAKE BORE HOLE BOULEVARD BOUNDARY BREAK IN GRADE BRICK BREAKER BRACKET BRICK MASONRY UNIT BROWN BUILDING BUILT-UP BULKHEAD  C	
CC CC C. G. C.	CANDELA CAULKING CAPACITY CAST IRON CAST IRON PIPE CAST-IN-PLACE CATALOG CATENARY CATCH BASIN CEILING CEILING DIFFUSER CELSIUS CEMENT CEMENT TREATED BASE CEMETERY CENTER CENTERS CENTER LINE CENTER TO CENTER CENTER OF GRAVITY CHAIN CHAMFER CHAMFER CHAMFER CHAMFER CHAMFER CITY OF PITTSBURGH CLASS CLEAN OUT CLEAN OUT CLEAN OUT CLEAN OUT COUMBIA GAS COMPANY COLUMN COMBINATION COMBINATION COMBINATION COMBINATION COMBINATION COMCRETE CONCRETE GUTTER CONCRETE FIPE CONCRETE GUTTER CONCRETE GUTTER CONCRETE GUTTER CONCRETE GUTTER CONCRETE HASONRY UNIT CONDUCTOR CONCRETE GUTTER CONCRETE CONCRETE GUTTER CONCRETE CONCRETE CONCRETE CONCRETE CONCRETE CONTINUOUS OR CONTRACTION CONTRACTION CONTRACTION CONTRACTOR CONTRAC	

C. M. C. M. P. CTR. CSK. CO. CPLG. CRSE. C. C. J. X-RD. X-SECT. CR. CU. C. F. OR	C CONT'D.  CORRUGATED METAL CORRUGATED METAL PIPE COUNTER COUNTERSUNK COUNTY OR COMPANY COUPLING COURSE CRACK CONTROL JOINT CROSS ROAD CROSS SECTION CRUSHED CUBIC CUBIC
CU.FT. CFS CFM C.I. OR CU.IN. C.Y. OR CU.YD. C&G CUR. C.L.F. C	CUBIC FEET PER SECOND CUBIC FEET PER MINUTE CUBIC INCH  CUBIC YARD  CURB & GUTTER CURRENT CURRENT CURRENT LIMITING FUSE CUT
DPR. D.L. DEFL. DEG. OR O  DEPT. DPW  DET. DWS DSGN. DIAG. DIAG. OR	DAMPER DEAD LOAD DEFLECTION DEGREE DELTA DEPARTMENT DEPT. OF PUBLIC WORKS (C/P) DETAIL DETECTABLE WARNING SURFACE DESIGN DIAGONAL DIAMETER
DIAG. DIAG. DIAM. DIR. DISC. DIST. DP DR. DBL. DWLS. DR. DN. DWNSTRE. D.I. DWG. DRWG. DRWY. DP. I. D.I.P. D.L.C. DWLG.	DIAGRAM DIAPHRAGM DIMENSION DIRECTIONAL OR DIRECT DISCONNECT DISTANCE DISTRIBUTION PANEL DOOR DOUBLE DOWELS DRAIN DOWN DOWNSTREAM DRAIN INLET DRAWING DRAWINGS DRIVE DRIVE DRIVE WAY DROP INLET DUCTILE IRON PIPE DUQUESNE LIGHT COMPANY DWELLING
EA. E.F. E.SMT. E E.B. E/C E/R E/P E/S ELL. ELEC. E.P.B. ELW. ELEV. EMB EMB. EMB. ENCL	EACH EACH FACE EACH WAY EASEMENT EAST EAST BOUND EDGE OF CONCRETE EDGE OF ROAD EDGE OF PAVEMENT EDGE OF SHOULDER ELBOW ELECTRIC OR ELECTRICAL ELECTRIC PANEL BOARD ELECTRIC MANHOLE ELEVATION EMBANKMENT EMBED OR EMBEDMENT EMERGENCY ENCLOSURE

E.O.L. E TO E ENGR. ENTR. EQ. OR( =) EQ. OR( =) EQ. C. EQUIP. EST. EXC. EXH. EXIST. EXP. EXP. BT. EXP. BT. EXP. BT. EXT. EXT. EXT. EXT. EXT. EXT. EXT. EX	E CONT' D.  END LINE RESISTOR END TO END ENGINEER ENTRANCE EQUAL EQUALITY EQUATION EQUIPMENT EQUITABLE GAS COMPANY EQUIVALENT ESTIMATE EXCAVATION EXHAUST EXISTING EXPANSION EXPANSION BOLT EXPANSION JOINT EXPOSED BLOCK EXTENSION EXTERNAL
F TO F F/C F.F. FED. FED. A. FEMA	FACE TO FACE FACE OF CURB FAR FACE FEDERAL FEDERAL AID FED. EMERGENCY MANAGEMENT
FTA  FT. OR / FPS FPM FP D. F. B. F. IG. F. IN. F. H. F. H. F. H. F. P. FIXT. F. P. FLASH FLLOR FLLOR FLLOR FLUOR FTG. FTG. FTG. FTG. FTG. FTG. FTG. FTG.	ADMINISTRATION FED. TRANSIT ADMINISTRATION FEET FEET PER SECOND FEET PER MINUTE FENCE POST FIBER DUCT, CONDUIT FIELD BOOK FIGURE FILL FINISH FINISH GRADE FINISHED FLOOR FIRE ALARM FIRE HOSE VALVE FIRE HYDRANT FIRE PROTECTION FIXED FIXTURES FLAG POLE FLANGE OR FLANGED FLASHING FLEXIBLE FLOOR FLOOR DRAIN FLOOR LINE FLOUR LINE FLOUR LINE FLOUR SECENT FOOT FOOTING FORESIGHT FORWARD FOUNDATION FRAME FREWAY FULL SCALE
F. FUT.	FULL SCALE FUSE FUTUREG
GA. GAL. GPM GPS GALV. G. I. G. S.	GAGE, GAUGE GALLON GALLONS PER MINUTE GALLONS PER SECOND GALVANIZED GALVANIZED IRON GALVANIZED STEEL
•	DECICNED IMC

	0 00111 0:
G.S.P. GAR.	GALVANIZED STEEL PIPE GARAGE
GSKT. G.M. G.V.	GASKET GAS METER GAS VALVE
GEN. G. A. E. C.	GENERAL GENERAL ARCHITECTURAL/
G. C. G	ENGINEERING CONSULTANT GENERAL CONTRACTOR GIGA
GL. G.R.C.	GLASS GLASS REINFORCED CONC.
GOVT. GR G.P.	GOVERNMENT GRADE GRADE POINT
GRAD. GRTG.	GRADUATION GRATING
GI GR. GRD.	GREEN INFRASTRUCTURE GRILLE GRIND
GRD. G.F.	GROUND GROUND FAULT GROUND FAULT
G.F.I. GP	GROUND FAULT INTERRUPTER GUARD POST
OI .	<u>H</u>
HCP. H. R.	HANDICAPPED HANDRAIL
HDW. HDWD. HD.	HARDWARE HARDWOOD HEAD
HDR. HTR.	HEADER HEATER
HVY. ha	HEATING AND VENTILATING HEAVY HECTARE
HGT. Hz	HEIGHT HERTZ
HEX. H. I. H. P.	HEXAGON, HEXAGONAL HEIGHT OF INSTRUMENT HIGH POINT
HP HWY. H.M.	HIGH PRESSURE HIGHWAY HOLLOW METAL
HOR.	HORIZONTAL HORSEPOWER
HR. HSE. HYD.	HOUR HOUSE HYDRANT
1110+	I
IB. IN. OR "	INBOUND INCH
INCL. INC. INFO.	INCLUDING OR INCLUDING INCORPORATED INFORMATION
I.D. I.F.	INSIDE DIAMETER INSIDE FACE
INST. INSUL. INTEG.	INSTRUMENT INSULATION INTEGRAL
INT. INTER. INV.	INTERIOR INTERMEDIATE INVERT
I. E. I. PIN	INVERT INVERT ELEVATION IRON PIN
I.P.	IRON PIPE J
JT• J	JOINT JOULE
JСТ. J.В.	JUNCTION JUNCTION BOX
W) / 6	K A NO. T. ANDUEDE
KVA KW K	KILO-VOLT-AMPHERE KILOWATT KIP OR KIPS
KSF KSI	KIPS PER SQUARE FOOT KIPS PER SQUARE INCH
KLF K.O.	KIPS PER LINEAR FOOT KNOCK OUT
DODT AUTHOR	ITY OF ALLEGHENY COLL

G CONT' D.

**AECOM** 

Gulf Tower 707 Grant Street 5th Floor Pittsburgh, PA 15219

			THE PREPARATION OF THIS DOCUMENT HAS BEEN FINANCED IN
			PART THROUGH A GRANT FROM TH
			FEDERAL TRANSIT ADMINISTRATION U.S. DEPARTMENT OF
			TRANSPORTATION, UNDER THE
			URBAN MASS TRANSPORTATION AC OF 1964, AS AMENDED, FOR THE
ю.	DATE		PORT AUTHORITY OF ALLEGHENY COUNTY, PENNSYLVANIA.
		REVISIONS	COONTT, FEMINISTEVANIA.

(NOT FOR CONSTRUCTION)

DESIGNED	<u>JMS</u>	
DRAWN	JMS	
CHECKED	MES	
N CHARGE	LAR	
DATE	05/01/24	
SCALE		
	AS SHOWN	

# PORT AUTHORITY OF ALLEGHENY COUNTY PENNSYLVANIA

BUS RAPID TRANSIT UPTOWN TO OAKLAND STANDARD ABBREVIATIONS A-K

Port Authority connecting people to life

CONTRACT NO. BRT-001 sнт. 23

DWG. NO. GN23

	L
LAM. LAT.	LAMINATE LATITUDE
LT. L.H.	LEFT HAND
L/T LGTH.	LEFT TRACK LENGTH LENGTH OF DEVELOPMENT
ld. Lt	LENGTH OF DEVELOPMENT LENGTH (ESTIMATED TOTAL) LIGHT
LGT. LTG LED	LIGHTING LIGHT EMITTING DIODE
LS LIN.	LIGHT STANDARD LINEAR OR LINEAL
L.A. L.F. OR	LIMITED ACCESS LINEAR FOOT
LIN.FT. L.L.	LIVE LOAD
LOCA. LG.	LOCATION LONG
LONG.	LONGITUDE OR LONGITUDINAL
LV. L.P. LP	LOUVER LOW POINT
LUB. LBR.	LOW PRESSURE LUBRICATE LUMBER
Im LS	LUMEN LUMP SUM
İx	LUX
MACH.	MACHINE
MAG. MAINT.	MAGNETIC MAINTENANCE
MH. MAN.	MANHOLE MANUAL
MFR. MK.	MANUFACTURER MARK
MAS. M.O. MAT'L.	MASONRY MASONRY OPENING
MAX. MECH.	MATERIAL MAXIMUM MECHANICAL
MSE	MECHANICALLY STABILIZED EARTH
MET. MI	METAL MILE
M.P.H. MIN.	MILE PER HOUR MINIMUM
MIN. MISC.	MINUTE MISCELLANEOUS
M.D. MTN. MON.	MOTOR DAMPER MOUNTAIN MONUMENT
MTD. M. H.	MOUNTED MOUNTED HEIGHT
MTG. MTBLE.	MOUNTING MOUNTABLE
M. J. M. C. D.	MOVEMENT JOINT MULTIPLE CONCRETE DUCT MULTIPLE TILE DUCT
M. T. D.	
NAT' L.	NATIONAL
N. G. V. D.	NATIONAL GEODETIC VERTICAL DATUM
N. G. S. NAT.	NATIONAL GEODETIC SURVEY NATIVE OR NATURAL
N. F. N. S. NEG.	NEAR FACE NEAR SIDE NEGATIVE
NEUT. NOM.	NEUTRAL NOMINAL
NOR. N. C.	NORMAL NORMALLY CLOSED
N. O. N	NORMALLY OPEN NORTH
N. B. N. E.	NORTH BOUND NORTHEAST
N. W. N. A. N. I. C.	NORTHWEST NOT APPLICABLE NOT IN CONTRACT
NTS NO. OR #	NOT TO SCALE NUMBER
NOS.	NUMBERS

	0
0. C.	ON CENTER
/	0F
OFF. OPNG.	OFFSET OPENING
OGS OPP.	OPEN GRADAGE SUBBASE OPPOSITE
OPP.HD.	OPPOSITE HAND
OPT. ORN.	OPTIONAL ORANGE
ORIG. O.G.	ORIGINAL ORIGINAL GRADE
OB.	OUTBOUND
0.D. 0.F.	OUTSIDE DIAMETER OUTSIDE FENCE
0 TO 0	OUTSIDE FENCE OUTSIDE TO OUTSIDE OR OUT TO OUT
OA.	OVERALL
O. H.	OVERHEAD
	<u>P</u>
P.	PAGE
PP. PR.	PAGES PAIR
PNL. PAR	PANEL PARALLEL
PKG.	PARKING
PKG.M. PKWY.	PARKING METER PARKWAY
PARTN.	PARTITION
PAV'T. PBD	PAVEMENT PAVEMENT BASE DRAIN
PAV' G. P. D. A.	PAVING PREDETERMINED AMOUNT
PED. PA	PEDESTRIAN
P. A. W. C.	PENNSYLVANIA PENNSYLVANIA AMERICAN
PADER	WATER COMPANY PENNSYLVANIA DEPT. OF
	ENVIRONMENTAL RESOURCES
PENNDOT	PENNSYLVANIA DEPARTMENT OF TRANSPORTATION
PNGCO.	PEOPLES NATURAL GAS
%	COMPANY PERCENT
P. C. M. P.	PERFORATED CORRUGATED METAL PIPE
PERF.	PERFORATED
PERM. PERP.	PERMANENT PERPENDICULAR
PGH PWSA	PITTSBURGH PGH. WATER & SEWER
	AUTHORITY
PL PCC OR	PLANE OR PLAIN PLAIN CEMENT CONCRETE
PLCC P.D.	PLASTIC CONDUIT DUCT
PL.	PLATE
PLATF. PLWD.	PLATFORM PLYWOOD
PT.	POINT POINT OF CURVE
P. C. P. O. E.	POINT OF END
<b>PT</b> P.C.B.	POINT OF TANGENT POLICE CALL BOX
PVC PAT OR	POLYVINYL CHORIDE PORT AUTHORITY OF
PAAC	ALLEGHENY COUNTY
P.C.C. POS.	PORTLAND CEMENT CONCRETE POSITION
LB.,LBS.	POUND OR POUNDS
PCF PSF	POUNDS PER CUBIC FOOT POUNDS PER SQUARE FOOT
PSI PWR.	POUNDS PER SQUARE INCH POWER
PP	POWER PANEL
PPB P.P.	POWER PANEL BOARD POWER POLE
PRI. PCST.	PRIMARY PRECAST
PREFAB.	PREFABRICATED
PRELIM. PMLD.	PRELIMINARY PREMOLDED
PRESS. P/S	PRESSURE
P. C. P.	PRESTRESSED PRESTRESSED CONCRETE
	PIPE
1 1	

		P CONT'D.
	PROD. PG PGL PROJ. PL PROP.	PRODUCTION PROFILE GRADE PROFILE GRADE LINE PROJECTION PROPERTY LINE PROPOSED
	PUB. P.B.	PUBLICATION PUSH-BUTTON
	QUAD. QUAL. QTR.	Q QUADRANT QUALITY QUARTER
	RAD. rad R. C. P. R. RECONSTR. RECON	RADIAL RADIAN RADIUS REINFORCED CONCRETE PIPE, RUBBER GASKET RECESSED RECONSTRUCT RECTANGLE REPRESSED REFERENCE REFERENCE REFERENCE REFERENCE REFLECTION OR REFLECTOR REGULAR REGISTER REINFORCED, REINFORCEMENT OR REINFORCED COMCRETE PIPE REINFORCED CONCRETE PIPE REINFORCED CONCRETE PIPE REINFORCED CONCRETE PIPE REMOVAL OR REMOVE REQUIRED RETAINING RETURN REVERSE REVISION RIGHT RIGHT HAND RIGHT-OF-WAY RIGHT TRACK ROAD ROADWAY ROOM ROOF ROOF DRAIN ROUND ROUTE  SANITARY SEWER SANITARY SEWER SANITARY SEWER SANITARY SEWER SANITARY SEWER SCOND SEGMENT SELECT SEPARATE
	SERV. S.S. SHT. SHLD. SH/TR SWLK SIG. S.P. S&PM	SERVICE SERVICE SINK SHEET SHOULDER SHORE/TRENCH BOX SIDEWALK SIGNAL SINGLE POLE SIGNING AND PAVEMENT MARKING
	S. T. SIM. SK SLV. SL. S. S. E. S. W. S. B.	SINGLE THROW SIMILAR SKETCH SLEEVE SLOPE SOUTH SOUTHEAST SOUTHWEST SOUTH BOUND
	1	
_		THE PREPARATION OF THIS

	S CONT' D.
SPA	SPACE OR SPACING
SPCS	SPACES
SP. SPEC.	SPARE SPECIFICATION
SQ. SQ.FT.OR	SQUARE SQUARE FOOT
S.F. SQ. IN. OR	
SQ.IN.OR S.I.	SQUARE INCH
S. Y.	SQUARE YARD
STAG S.S.	STAGGERED STAINLESS STEEL
STWY. S.P.	STAIRWAY STAND PIPE
STD.	STANDARD
SR STA.	STATE ROUTE STATION
STM. STL.	STEAM
STG.	STEEL PIPE, DUCT, CONDUIT STORAGE
S.A. STR.RM.	STORAGE AREA STORAGE ROOM
SS	STORM SEWER
SWM STY.	STORMWATER MANAGEMENT STORY
ST. S.L.	STREET STREET LIGHTING
STRUCT.	STRUCTURAL
STR SUBG.OR	STRUCTURE SUBGRADE
SUBSTR. S.E.	SUBSTRUCTURE SUPER ELEVATION
SUP.	SUPPORT
SOE SURF.	SUPPORT OF EXCAVATION SURFACE
S. M.	SURFACE MOUNTED
SURV. SUSP.	SURVEY SUSPENDED
SW. SYM.	SWITCH SYMMETRICAL
311110	_
TAN.	TANCENT
TRP.	TANGENT TAPER
TECH. TEL.	TECHNICAL TELEPHONE
T.B.	TELEPHONE BOOTH
T.P. TEMP.	TELEPHONE POLE TEMPERATURE
TEMP.C. TEMP	TEMPERATURE CONTROL TEMPORARY
TENS.	TENSION
TERM. T.C.	TERMINAL TERRA COTTA
TCMD	TERRA COTTA MULTIPLE DUCTS
TCP	TERRA COTTA PIPE
TCSD	TERRA COTTA SINGLE DUCT
T.B. THK.	TEST BORING
М	THICK THOUSAND
THD. THRESH.	THREAD THRESHOLD
THRU	THROUGH
TOL. T&G	TOLERANCE TONGUE AND GROOVE
T T&B	TOP TOP AND BOTTOM
TOP0	TOPOGRAPHY
T/B T/CONC.	TOP OF BANK TOP OF CONCRETE
T/C T/G	TOP OF CURB TOP OF GRATE
T/GRTG.	TOP OF GRATING
T/F T/ST.	TOP OF FILL TOP OF STEEL
T/R T/W	TOP OF RAIL
TF	TOP OF WALL TOTAL FILL
TWP. TRK.	TOWNSHIP TRACK
TR.	TRAFFIC
T. C. B. T. S.	TRAFFIC CALL BOX TRAFFIC SIGNAL
TRANS.	TRANSFORMER
_ <del>.</del>	
	DESIGNED JMS

	T CONT' D.
T. A.	TRANSFER AIR
TRANV. T	TRANSVERSE TREAD
ˈtκ•	TRIP
Ť. P.	TURNING POINT
TYP.	TYPICAL
	U
UD OR	UNDERDRAIN
U-DRAIN	
U. P. V.	UNDER PLATFORM
LINE IN	VENTILATION
UNFIN. U.P.S.	UNFINISHED UNINTERRUPTED POWER
0.1.3.	SUPPLY
U.S,G.S.	U.S. GEOLOGICAL SURVEY
UNIV.	UNIVERSAL
U. N.	UNLESS NOTED
U. O. N.	UNLESS OTHERWISE NOTED
UPL	UTILITY POLE WITH LUMINARIES
	LUMINARIES
	V
VAC.	VACANT
VAC. VAL.	VALVE
VAL. VAR.	VARIABLE
VE.	VENT
VENT.	VENTILATION
VIF	VERIFY IN FIELD
VERT.	VERTICAL
V. C. L.	VERTICAL CONTROL LINE
V. C. V. F.	VERTICAL CURVE VERTICAL FEET
V.F. VCP	VITRIFIED CLAY PIPE
VCPX	VITRIFIED CLAY PIPE
	EXTRA STRENGTH
VCPXR	VITRIFIED CLAY PIPE
	EXTRA STRENGTH RUBBER
1/14	GASKET
VM VTP	VITRIFIED MATERIAL VITRIFIED TILE PIPE
V	VOLT
•	VOL 1
·	W
·	W
WK.	W WALK
·	W
WK. WHSE. W.B. W.C.	WALK WAREHOUSE WATER BOX WATER CLOSET
WK. WHSE. W. B. W. C. W. M.	WALK WAREHOUSE WATER BOX WATER CLOSET WATER METER
WK. WHSE. W.B. W.C. W.M.	WALK WAREHOUSE WATER BOX WATER CLOSET WATER METER WATERPROOFING
WK. WHSE. W. B. W. C. W. M. WP. W. S.	WALK WAREHOUSE WATER BOX WATER CLOSET WATER METER WATERPROOFING WATER SPIGOT
WK. WHSE. W.B. W.C. W.M.	WALK WAREHOUSE WATER BOX WATER CLOSET WATER METER WATERPROOFING
WK. WHSE. W.B. W.C. W.M. WP. W.S.	WALK WAREHOUSE WATER BOX WATER CLOSET WATER METER WATERPROFING WATER SPIGOT WATER VALVE
WK. WHSE. W.B. W.C. W.M. WP.S. WV W	WALK WAREHOUSE WATER BOX WATER CLOSET WATER METER WATERPROOFING WATER SPICOT WATER VALVE WATT WEARING SURFACE WEATHERPROOF
WK. WHSE. W. B. W. C. W. M. WP. W. S. WV W. S. W. P. W. P.	WALK WAREHOUSE WATER BOX WATER CLOSET WATER METER WATERROOFING WATER SPIGOT WATER VALVE WATT WEARING SURFACE WEATHERPROOF WEEP HOLES
WK. WHSE. W. B. W. C. W. M. WP. W. S. WV W. S. W. P. W. H. W. H.	W WALK WAREHOUSE WATER BOX WATER CLOSET WATER METER WATERPROOFING WATER SPICOT WATER VALVE WATT WEARING SURFACE WEATHERPROOF WEEP HOLES WEIGHT
WK. WHSE. W.B. W.C. W.M. WP. W.S. WV W.S. W.P. W.H.	WALK WAREHOUSE WATER BOX WATER CLOSET WATER METER WATERPROOFING WATER SPIGOT WATER VALVE WATT WEATING SURFACE WEATHERPROOF WEEP HOLES WEIGHT WELDED WIRE FABRIC
WK. WHSE. W. B. W. C. W. M. WP. W. S. WV W. S. W. P. W. H. WT. WWF	W WALK WAREHOUSE WATER BOX WATER CLOSET WATER METER WATERPROOFING WATER SPICOT WATER VALVE WATT WEARING SURFACE WEATHERPROOF WEEP HOLES WEIGHT
WK. WHSE. W.B. W.C. W.M. WP. W.S. WV W.S. W.P. W.H.	WALK WAREHOUSE WATER BOX WATER BOX WATER CLOSET WATER METER WATER SPIGOT WATER VALVE WATT WEARING SURFACE WEATHERPROOF WEEP HOLES WEIGHT WELDED WIRE FABRIC WELDED STEEL PIPE WELDED STEEL PIPE COATED
WK. WHSE. W. B. W. C. W. M. WP. W. S. WV W. S. W. P. W. H. WT. WWF	WALK WAREHOUSE WATER BOX WATER CLOSET WATER METER WATERPROOFING WATER SPIGOT WATER VALVE WATT WEARING SURFACE WEATHERPROOF WEEP HOLES WEIGHT WELDED WIRE FABRIC WELDED STEEL PIPE WELDED STEEL PIPE, COATED WELDED STEEL PIPE,
WK. WHSE. W. B. W. C. W. M. WP. W. S. WV W. S. WY W. S. W	WALK WAREHOUSE WATER BOX WATER CLOSET WATER METER WATERPROOFING WATER SPIGOT WATER VALVE WATT WEARING SURFACE WEATHERPROOF WEEP HOLES WEIGHT WELDED WIRE FABRIC WELDED STEEL PIPE WELDED STEEL PIPE, COATED WELDED STEEL PIPE, COATED, CEMENT LINED
WK. WHSE. W.B. W.C. W.M. WP. W.S. WV W.S. WV W.S. W.P. W.H. WT. WWF WSP WSPC	WALK WAREHOUSE WATER BOX WATER BOX WATER CLOSET WATER METER WATERPROOF ING WATER SPIGOT WATER VALVE WATT WEARING SURFACE WEATHERPROOF WEEP HOLES WEIGHT WELDED STEEL PIPE WELDED STEEL PIPE, COATED WEST
WK. WHSE. W.B. W.C. W.M. WP. W.S. WV W.S. W.P. W.F. WT. WT. WSP WSPC WSPCC W.B.	WALK WAREHOUSE WATER BOX WATER BOX WATER CLOSET WATER METER WATERPROOF ING WATER SPIGOT WATER VALVE WATT WEARING SURFACE WEATHERPROOF WEEP HOLES WEIGHT WELDED STEEL PIPE WELDED STEEL PIPE, COATED WEST
WK. WHSE. W.B. W.C. W.M. WP. W.S. WV W.S. WV W.S. W.P. W.H. WT. WWF WSP WSPC	WALK WAREHOUSE WATER BOX WATER CLOSET WATER METER WATERPROOFING WATER SPIGOT WATER VALVE WATT WEARING SURFACE WEATHERPROOF WEEP HOLES WEIGHT WELDED WIRE FABRIC WELDED STEEL PIPE WELDED STEEL PIPE, COATED WELDED STEEL PIPE, COATED WELDED STEEL PIPE, COATED, CEMENT LINED WEST WEST BOUND WEST BOUND
WK. WHSE. W.B. W.C. W.M. WP. W.S. WV W.S. WV W.S. WV W.S. WV W.S. WV W.S. W.P. W.H. WT. WSP WSPC WSPC WSPC	WALK WAREHOUSE WATER BOX WATER BOX WATER CLOSET WATER METER WATERPROOF ING WATER SPIGOT WATER VALVE WATT WEARING SURFACE WEATHERPROOF WEEP HOLES WEIGHT WELDED STEEL PIPE WELDED STEEL PIPE, COATED WEST
WK. WHSE. W.B. W.C. W.M. WP. S. WV W.S. W.P. W.H. WT. WWF WSP WSPC WSPC WSPC W.B. W.P.P.C. W.U.	WALK WAREHOUSE WATER BOX WATER BOX WATER CLOSET WATER METER WATERPROOFING WATER SPIGOT WATER VALVE WATT WEARING SURFACE WEATHERPROOF WEEP HOLES WEIGHT WELDED WIRE FABRIC WELDED STEEL PIPE WELDED STEEL PIPE, COATED COATED WELDED STEEL PIPE, COATED COMPANY WEST BOUND WEST PENN POWER COMPANY WESTERN UNION TELEGRAPH COMPANY WINDOW
WK. WHSE. W.B. W.C. W.M. WP. W.S. WV W.S. WV W.S. W.P. W.H. WT. WWF WSPC WSPC WSPCC WSPCC WSP.P.C. W.B. W.P.P.C. W.U. WDW.	WALK WAREHOUSE WATER BOX WATER CLOSET WATER METER WATERPROOFING WATER VALVE WATT WEARING SURFACE WEATHERPROOF WEEP HOLES WEIGHT WELDED STEEL PIPE, COATED WELDED STEEL PIPE, COATED WEST DOUND WEST WEST BOUND WEST BOUND WESTERN UNION TELEGRAPH COMPANY WINDOW WING WALL
WK. WHSE. W.B. W.C. W.M. WP. W.S. WV W.S. W.Y. W.H. WT. WWF WSP WSPC WSPCC WSPCC WSPCC WSPCC W.B. W.P.P.C. W.U. WD.W. W.W.	WALK WAREHOUSE WATER BOX WATER CLOSET WATER METER WATERPROOF ING WATER VALVE WATT WEARING SURFACE WEATHERPROOF WEEP HOLES WEIGHT WELDED STEEL PIPE WELDED STEEL PIPE, COATED WELDED STEEL PIPE, COATED WEST PENN POWER COMPANY WEST PENN POWER COMPANY WINDOW WINDOW WING WALL WIRE GLASS
WK. WHSE. W.B. W.C. W.M. WP. W.S. WV W.S. W.P. W.H. WT. WSP WSPC WSPC WSPC WSPC WS.P.C. W.P.P.C. W.U. WDW. W.GL. W.GL. W/	WALK WAREHOUSE WATER BOX WATER BOX WATER CLOSET WATER METER WATERPROOFING WATER SPIGOT WATER VALVE WATT WEARING SURFACE WEATHERPROOF WEEP HOLES WEIGHT WELDED STEEL PIPE WELDED STEEL PIPE, COATED WELDED STEEL PIPE, COATED WELDED STEEL PIPE, COATED WEST BOUND WEST BOUND WEST PENN POWER COMPANY WESTERN UNION TELEGRAPH COMPANY WINDOW WING WALL WIRE GLASS WITH
WK. WHSE. W.B. W.C. W.M. WP. W.S. WV W.S. WV W.S. W.P. W.H. WT. WWF WSPC WSPC WSPC WSPC WSPC WSPC WSPC WSPC	WALK WAREHOUSE WATER BOX WATER BOX WATER CLOSET WATER METER WATERPROOFING WATER SPIGOT WATER VALVE WATT WEARING SURFACE WEATHERPROOF WEEP HOLES WEIGHT WELDED WIRE FABRIC WELDED STEEL PIPE WELDED STEEL PIPE, COATED WELDED STEEL PIPE, COATED WELDED STEEL PIPE, COATED WEST WEST BOUND WEST WEST BOUND WEST PENN POWER COMPANY WESTERN UNION TELEGRAPH COMPANY WINDOW WING WALL WIRE GLASS WITH
WK. WHSE. W.B. W.C. W.M. WP. W.S. WV W.S. W.P. W.H. WT. WSP WSPC WSPC WSPC WSPC WS.P.C. W.P.P.C. W.U. WDW. W.GL. W.GL. W/	WALK WAREHOUSE WATER BOX WATER BOX WATER CLOSET WATER METER WATERPROOFING WATER SPIGOT WATER VALVE WATT WEARING SURFACE WEATHERPROOF WEEP HOLES WEIGHT WELDED STEEL PIPE WELDED STEEL PIPE, COATED WELDED STEEL PIPE, COATED WELDED STEEL PIPE, COATED WEST BOUND WEST BOUND WEST PENN POWER COMPANY WESTERN UNION TELEGRAPH COMPANY WINDOW WING WALL WIRE GLASS WITH
WK. WHSE. W.B. W.C. W.M. WP. W.S. WV W.S. WV W.S. W.P. W.H. WT. WWF WSPC WSPC WSPC WSPC WSPC WSP.P.C. W.B. W.P.C. W.B. W.O. W.W. W.GL. W/O W.D. W.P.	WALK WAREHOUSE WATER BOX WATER CLOSET WATER METER WATERPROOFING WATER SPIGOT WATER VALVE WATT WEARING SURFACE WEATHERPROOF WEEP HOLES WEIGHT WELDED WIRE FABRIC WELDED STEEL PIPE WELDED STEEL PIPE, COATED WELDED STEEL PIPE, COATED WELDED STEEL PIPE, COATED WEST WEST BOUND WEST WEST BOUND WEST PENN POWER COMPANY WESTERN UNION TELEGRAPH COMPANY WINDOW WING WALL WIRE GLASS WITH WITHOUT WIODT WOOD WORK POINT
WK. WHSE. W.B. W.C. W.M. WP. W.S. WV W.S. WV W.S. W.P. W.H. WT. WWF WSP WSPC WSPCC WSPCC WSPCC WSPCC WSPCC WSPCC WSPCC WSPCC WSPC WSP	WALK WAREHOUSE WATER BOX WATER CLOSET WATER METER WATERPROOF ING WATER VALVE WATT WEARING SURFACE WEATHERPROOF WEEP HOLES WEIGHT WELDED STEEL PIPE, COATED WELDED STEEL PIPE, COATED WEST DOUND WEST PENN POWER COMPANY WEST BOUND WEST PENN POWER COMPANY WINDOW WING WALL WIRE GLASS WITH WITHOUT WIDTH WOOD WORK POINT WROUGHT IRON
WK. WHSE. W.B. W.C. W.M. WP. W.S. WV W.S. WV W.S. W.P. W.H. WT. WWF WSPC WSPC WSPC WSPC WSPC WSP.P.C. W.B. W.P.C. W.B. W.O. W.W. W.GL. W/O W.D. W.P.	WALK WAREHOUSE WATER BOX WATER CLOSET WATER METER WATERPROOFING WATER SPIGOT WATER VALVE WATT WEARING SURFACE WEATHERPROOF WEEP HOLES WEIGHT WELDED WIRE FABRIC WELDED STEEL PIPE WELDED STEEL PIPE, COATED WELDED STEEL PIPE, COATED WELDED STEEL PIPE, COATED WEST WEST BOUND WEST WEST BOUND WEST PENN POWER COMPANY WESTERN UNION TELEGRAPH COMPANY WINDOW WING WALL WIRE GLASS WITH WITHOUT WIODT WOOD WORK POINT
WK. WHSE. W.B. W.C. W.M. WP. W.S. WV W.S. WV W.S. W.P. W.H. WT. WWF WSP WSPC WSPCC WSPCC WSPCC WSPCC WSPCC WSPCC WSPCC WSPCC WSPC WSP	WALK WAREHOUSE WATER BOX WATER CLOSET WATER METER WATERPROOFING WATER SPIGOT WATER VALVE WATT WEARING SURFACE WEATHERPROOF WEEP HOLES WEIGHT WELDED WIRE FABRIC WELDED STEEL PIPE WELDED STEEL PIPE, COATED WELDED STEEL PIPE, COATED WELDED STEEL PIPE, COATED WEST BOUND WEST WEST BOUND WEST PENN POWER COMPANY WESTERN UNION TELEGRAPH COMPANY WINDOW WING WALL WIRE GLASS WITH WITHOUT WIDTH WOOD WORK POINT WROUGHT IRON WROUGHT IRON WROUGHT IRON
WK. WHSE. W. B. W. C. W. M. WP. W. S. WV W. S. W. S. W. S. W. S. WV W. S. W	WALK WAREHOUSE WATER BOX WATER BOX WATER CLOSET WATER METER WATERPROOFING WATER SPIGOT WATER VALVE WATT WEARING SURFACE WEATHERPROOF WEEP HOLES WEIGHT WELDED WIRE FABRIC WELDED STEEL PIPE WELDED STEEL PIPE, COATED WELDED STEEL PIPE, COATED WELDED STEEL PIPE, COATED WEST WEST BOUND WEST BOUND WEST PENN POWER COMPANY WESTERN UNION TELEGRAPH COMPANY WINDOW WING WALL WIRE GLASS WITH WITHOUT WIODTH WOOD WORK POINT WROUGHT IRON WROUGHT IRON PIPE
WK. WHSE. W.B. W.C. W.M. W.S. W.Y. W.S. W.Y. W.S. W.P. W.H. WT. WSPC WSPCC WSPCC WSPCC WSPCC WSPCC WSPCC WSPCC WSPCC WSP.P.C. W.J. W.P.P.C. W.J. W.W. W.GL. W.Y.O W.D. W.P. W.J. W.J. W.J. W.J. W.J. W.J. W.J	WALK WAREHOUSE WATER BOX WATER BOX WATER CLOSET WATER METER WATERPROOFING WATER SPIGOT WATER VALVE WATT WEARING SURFACE WEATHERPROOF WEEP HOLES WEIGHT WELDED STEEL PIPE COATED WELDED STEEL PIPE, COATED WELDED STEEL PIPE, COATED WEST BOUND WEST WEST BOUND WEST PENN POWER COMPANY WESTERN UNION TELEGRAPH COMPANY WINDOW WING WALL WIRE GLASS WITH WITHOUT WIDTH WOOD WORK POINT WROUGHT IRON WROUGHT IRON WROUGHT IRON PIPE
WK. WHSE. W. B. W. C. W. M. WP. W. S. WV W. S. W. S. W. S. W. S. WV W. S. W	WALK WAREHOUSE WATER BOX WATER BOX WATER CLOSET WATER METER WATERPROOFING WATER SPIGOT WATER VALVE WATT WEARING SURFACE WEATHERPROOF WEEP HOLES WEIGHT WELDED WIRE FABRIC WELDED STEEL PIPE WELDED STEEL PIPE, COATED WELDED STEEL PIPE, COATED WELDED STEEL PIPE, COATED WEST WEST BOUND WEST BOUND WEST PENN POWER COMPANY WESTERN UNION TELEGRAPH COMPANY WINDOW WING WALL WIRE GLASS WITH WITHOUT WIODTH WOOD WORK POINT WROUGHT IRON WROUGHT IRON PIPE
WK. WHSE. W.B. W.C. W.M. WP. W.S. WV W.S. WV W.S. W.P. W.H. WT. WWF WSP WSPC WSPCC WSPCC WSPCC WSPCC W.B. W.P. C. W.U. WD. W.GL. W/O W.O. W.P. W.I. W.I.P. YD. YR.	WALK WAREHOUSE WATER BOX WATER CLOSET WATER METER WATERPROOF ING WATER SPIGOT WATER VALVE WATT WEARING SURFACE WEATHERPROOF WEEP HOLES WEIGHT WELDED STEEL PIPE, COATED WELDED STEEL PIPE, COATED, CEMENT LINED WEST WEST BOUND WEST PENN POWER COMPANY WESTERN UNION TELEGRAPH COMPANY WINDOW WING WALL WIRE GLASS WITH WITHOUT WIDTH WOOD WORK POINT WROUGHT IRON WROUGHT IRON WROUGHT IRON YEAR
WK. WHSE. W.B. W.C. W.M. WP. W.S. WV W.S. WV W.S. W.P. W.H. WT. WWF WSP WSPC WSPCC WSPCC WSPCC WSPCC W.B. W.P. C. W.U. WD. W.GL. W/O W.O. W.P. W.I. W.I.P. YD. YR.	WALK WAREHOUSE WATER BOX WATER CLOSET WATER METER WATERPROOF ING WATER SPIGOT WATER VALVE WATT WEARING SURFACE WEATHERPROOF WEEP HOLES WEIGHT WELDED STEEL PIPE, COATED WELDED STEEL PIPE, COATED, CEMENT LINED WEST WEST BOUND WEST PENN POWER COMPANY WESTERN UNION TELEGRAPH COMPANY WINDOW WING WALL WIRE GLASS WITH WITHOUT WIDTH WOOD WORK POINT WROUGHT IRON WROUGHT IRON WROUGHT IRON WROUGHT IRON YEAR

sнт. 24


# **AECOM**

Gulf Tower 707 Grant Street 5th Floor Pittsburgh, PA 15219

			THE PREPARATION OF THIS DOCUMENT HAS BEEN FINANCED IN
			PART THROUGH A GRANT FROM TH
			FEDERAL TRANSIT ADMINISTRATION U.S. DEPARTMENT OF
			TRANSPORTATION, UNDER THE
			URBAN MASS TRANSPORTATION AC OF 1964. AS AMENDED, FOR THE
NO.	DATE	DESCRIPTION	PORT AUTHORITY OF ALLEGHENY COUNTY, PENNSYLVANIA.
		REVISIONS	COUNTY, PENINSTEVANIA.

(NOT FOR CONSTRUCTION)

DESIGNED	<u>JMS</u>	PORT	AUTHOR	ITY OF AL	LEGHENY CO	UNTY	,
DRAWN	<u>JMS</u>	PITTSBURG	GH		PENN	SYLVANIA	1
CHECKED	MES	BUS	RAPID TE	RANSIT UP1	OWN TO OAKL	AND	
IN CHARGE	LAR	STANDARD ABBREVIATIONS					
DATE	<u>05/01/24</u>			L-Z			
SCALE /	AS SHOWN	Port Authority		CONTRACT NO. BRT-001			
·	connecting people to life		ting people to life	DWG. NO.	GN24	SHT.	2

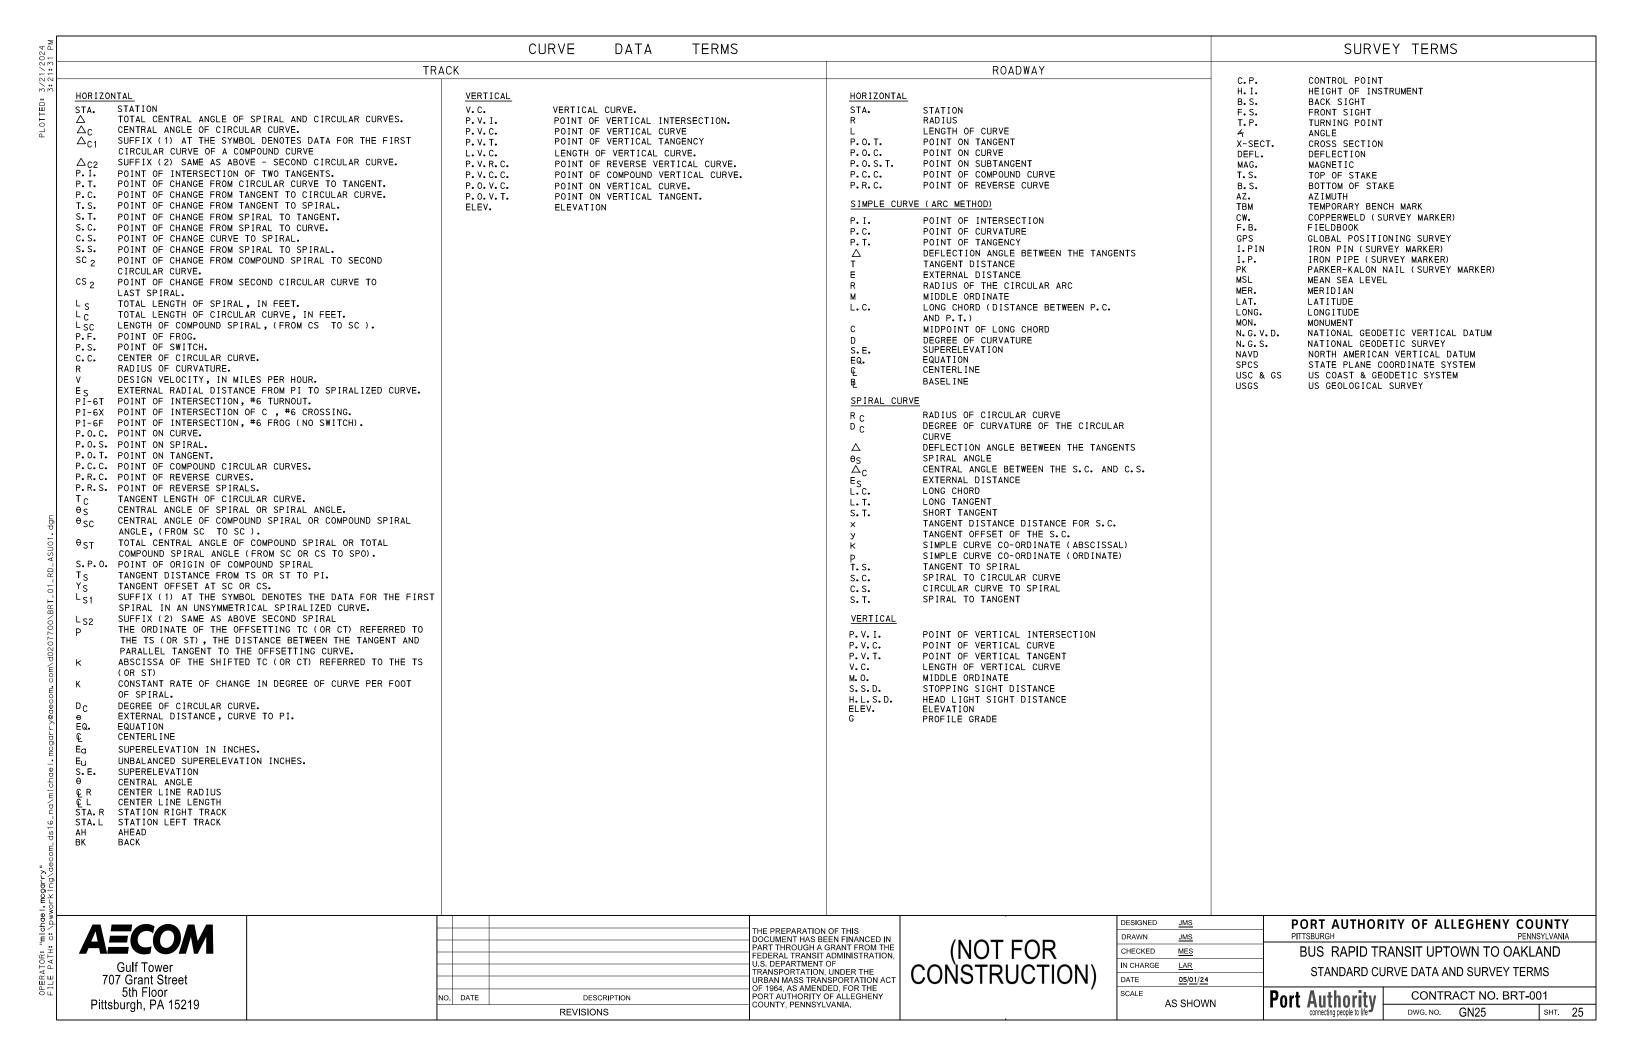

OF 1964, AS AMENDED, FOR THE PORT AUTHORITY OF ALLEGHENY COUNTY, PENNSYLVANIA.

SCALE

AS SHOWN

CONTRACT NO. BRT-001

DWG NO

**Port Authority** 

5th Floor

Pittsburgh, PA 15219

NO. DATE

DESCRIPTION

⊕<sub>TB OR B \_\_\_</sub>

MATCH LINE SEE SHEET \_\_\_\_



THE PREPARATION OF THIS DOCUMENT HAS BEEN FINANCED IN PART THROUGH A GRANT FROM THE FEDERAL TRANSIT ADMINISTRATION, U.S. DEPARTMENT OF TRANSPORTATION, UNDER THE URBAN MASS TRANSPORTATION ACT OF 1964, AS AMENDED, FOR THE PORT AUTHORITY OF ALLEGHENY COUNTY, PENNSYLVANIA. NO. DATE DESCRIPTION REVISIONS

EXISTING TO REMAIN

FLASHING ARROW PANEL

DETOUR ROUTE

DETOUR ROUTE

DIRECTION OF VECHICULAR TRAVEL

(NOT FOR CONSTRUCTION)

ETR

WHERE A CONFLICT ARISES BETWEEN THE DRAWING SHEETS AND THE SYMBOL SHEETS, THE DRAWING SHEETS SHALL GOVERN.						ΗE		
DESIGNED	<u>JMS</u>		PORT AUTHORITY OF ALLEGHENY COUNTY					
DRAWN	<u>JMS</u>		PITTSBURGH			PENNSYL	VANIA	4
CHECKED	<u>MES</u>		BUS RAPID TRANSIT UPTOWN TO OAKLAND					
IN CHARGE	LAR		STANDARD SYMBOLOGY					
DATE	05/01/24		3 TANDARD STMBOLOGT					
SCALE AS SHOWN		Port Authority	CONTR	RACT NO. B	RT-001			
AO ONOWN			connecting people to life	DWG. NO.	GN27	s	HT.	27

THE SIZE OF SEWER, WATER AND GAS LINES SHOWN ON DRAWING SHEETS ARE FOR REFERENCE ONLY. NUMBERS SHOWN FOR MANHOLES, PULL BOXES AND JUNCTION BOXES ARE FOR REFERENCE ONLY.

CONDUIT/SIZE

EXISTING POWER CONDUIT

EXISTING INTERCONNECT CONDUIT

SOLID WHITE LINE/WIDTH

BROKEN WHITE LINE/WIDTH

DOUBLE SOLID YELLOW LINE/WIDTH

NOTES:

<u>NEW</u>

➾

TW/4"

TY/4"

TDY/4"

TBW/4"

TDW/4"

**-**■ (2)

**→** (2)

• 🛕

⊥,**\_** A

**→**) ②

 $\boxtimes$ 

□ 2

1 2

C/2"

C/P

C/I


W/6"

BW/6"

DY/4"

707 Grant Street 5th Floor

Pittsburgh, PA 15219

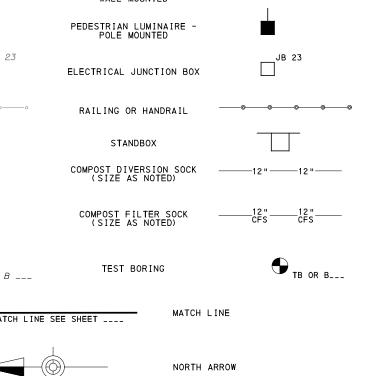

# TYPE B FLASHING LIGHT (YELLOW) 承 TYPE B FLASHING LIGHT (RED) COVER EXISTING SIGN

### SUMMARY OF PROJECT COORDINATES

BASED ON PENNSYLVANIA STATE PLANE COORDINATE SYSTEM (SPCS 83) (SOUTH SIDE) GEOID 12B

CONSTR BASELINE	STATION	POINT	NORTHING	EASTING	BEARING
	404+97.44	POB	411744.6678	1341513.6276	S 62°26′15"E
	427+11.08	ΡI	410720.3833	1343476.0312	
	435+05.56	PC	410665.5800	1344268.6203	S 86° 02′ 41 " E
	435+37.69	ΡI	410663.3634	1344300.6776	S 86° 02′ 41 " E
	435+69.82	PT	410660.7349	1344332.7037	S 85° 18′ 29 " E
	481+82.53	PC	410283.4309	1348929.9497	S 85° 18′ 29 " E
	482+23.55	ΡI	410280.0751	1348970.8381	S 85° 18′ 29 " E
	482+64.56	PT	410274.4894	1349011.4819	S 82° 10′ 29 " E
	489+21.12	PC	410185.0979	1349661.9267	S 82°10′29"E
	489+41.79	ΡΙ	410182.2829	1349682.4101	S 82°10′29"E
	489+62.17	PT	410173.6670	1349701.2052	S 65°22′22"E
	503+10.76	PC	409611.6921	1350927.1277	S 65°22′22"E
	503+21.22	ΡI	409607.3366	1350936.6290	S 65°22′22"E
	503+31.37	PT	409607.1518	1350947.0795	S 88°59′14"E
	508+38.94	PC	409598.1799	1351454.5668	S 88°59′14"E
	510+74.57	ΡI	409594.0147	1351690.1653	S 88°59′14"E
	512+59.81	PT	409804.3500	1351796.3871	N 26° 47′ 40" E
	512+96.11	PC	409836.7519	1351812.7504	N 26° 47′ 40" E
	515+26.47	PI	410042.3840	1351916.5970	N 26° 47′ 40" E
	517+15.01	PT	410058.2239	1352146.4182	N 86° 03′ 26 " E
	517+56.29	PC	410061.0621	1352187.5970	N 86° 03′ 26 " E
	519+24.37	PI	410072.6190	1352355.2769	N 86°03′26"E
	520+78.00	PT	410191.2700	1352474.3234	N 45°05′43"E
	522+05.48	PC	410281.2626	1352564.6161	N 45°05′43"E
	523+76.67	PI	410402.1104	1352685.8667	N 45°05′43"E
FIFTH AVE	525+47.80	PT	410516.8868	1352812.8797	N 47°53′50"E
	530+58.92	PC	410859.5784	1353192.1067	N 47°53′50"E
	530+90.79	PI	410880.9447	1353215.7509	N 47°53′50"E
	531+22.65	PT	410903.0534	1353238.7023	N 46°04′17"E
	533+25.05	PI	411043.4718	1353384.4732	N 46°04′17"E
	540+81.75	PI	411549.8504	1353946.7660	N 47°59′42"E
	542+04.83	PI	411633.7936	1354036.7793	N 46°59′55"E
	549+93.88	PC	412162.3022	1354622.6736	N 47°56′52"E
	550+34.92	PI	412189.7890	1354653.1450	N 47°56′52"E
	550+75.95	PT	412216.5049	1354684.2945	N 49°22′53"E
	554+34.24	PI	412449.7566	1354956. 2555	N 49°22′53"E
		PC		1355748.6761	N 47°58′04"E
	565+01.08 566+14.09	PI	413164.0630	1355832.6136	N 47°58′04"E
	567+18.09			1355945.5069	N 87°26′19"E
		PT	413244.7763		N 87°26′19"E
	570+13.02	PC		1356240.1498	N 87°26′19"E
	571+10.77	PI	413262.3251	1356337.8010	N 81°50′33 " E
	572+08.37	PT	413276. 1951	1356434.5608	N 81°50′33"E
	572+58.87	PI	413283.3616	1356484.5556	N 80°53′56"E
	573+79.83	PI	413302.4953	1356603.9957	N 81°55′19"E
	574+27.04	PC	413309.1291	1356650, 7346	N 81°55′19"E
	574+42.81	PI	413311.3452	1356666.3484	N 85°56′10" E
	574+58.57	PT	413312.4628	1356682.0791	N 85°56′10" E
	577+97.86	POE	413336.5081	1357020.5160	14 02 26 10 E
	580+00.00	POB	413326.4324	1357023.6105	N 85°56′10"E
	582+99.50	POE	413347.6577	1357322.3558	

111+30.60	CONSTR BASELINE	STATION	POINT	NORTHING	EASTING	BEARING
16+19-01		111+30.60	POB	410624.5622	1343037.8469	S 62°13′58" E
116+0-4.0		116+19.01	PC	410397.0211	1343470.0145	
117+19, 99		116+70.40	ΡI	410373.0752	1343515.4949	
120+26. 44		117+19.99	PT	410371.7595	1343566.8772	
123+10.71		120+26.44	ΡI	410363.9153	1343873.2254	
Table		123+10.71	ΡI	410355.0498	1344157.3572	
FORBES AVE    145+68.18		141+78.10				
FORBES AVE			ΡI	410165.6525	1346406.8515	
FORBES AVE  FORBES						
FORBES AVE					1349550, 3673	
FORBES AVE    180+70.01   PI						
FORBES AVE    182+53.01   PT						
FORBES AVE    183+13.56   PC						S 66°02′16" E
183+60.59	FORBES AVE					S 66°02′16" E
184+07.46						S 66°02′16" E
184+80.12						S 57°45′39" E
186+21.16						S 57°45′39" E
FORBES AVE    187+61.10   PT						S 57°45′39" E
FORBES AVE  FORBES AVE  FORBES AVE  ATWOOD ST  S BELLEFIELD AVE  N BELLEFIELD AVE  BIGELOW BLVD  SR 2085  (BIRMINGHAM BRIDGE)  TRIP 3,39, 91  PI 409356, 1885 1350871, 9006  193+39, 91  PI 409365, 1189 1351064, 2618  S 70° 08' 42" E 409366, 5799 1351468, 5567  197+41, 48 PC 409366, 5799 1351468, 5016  S 81° 22' 27" E 5 88° 48' 58" E						S 70°08′42" E
193+39.91   PI   409385.1189   1351064.2618   S   70°08' 42"   E   S   87°22' 27"   E   S						S 70°08′42" E
FORBES AVE    195+41.34   PT   409375.7493   1351268.5657   5 87°22′27"   E   5 88°48′58"   E   5 88°4						S 70°08′42" E
197+41.48						S 87°22′27" E
198+67.33						S 87°22′27" E
199+93.16						S 87°22′27" E
## PORBES AVE   Continue						S 88°48′58" E
## PORBES AVE   COUNTY   COUNT						S 88°48′58" F
FORBES AVE    201+78.08   PC   409361.3926   1351905.0536   S 88° 48' 58' E   203+00.89   PI   409358.8552   1352027.8404   N 47° 57' 35'' E   238+47.37   PC   411741.6389   1354670.4547   N 47° 57' 35'' E   239+12.60   PI   411785.3193   1354718.8982   N 72° 29' 36'' E   239+75.83   PT   411804.9411   1354781.1053   PT   259+03.72   PI   412384.8851   1356619.7066   N 72° 29' 36'' E   410993.2500   1354296.6229   N 42° 02' 34'' W   410993.2500   1354296.6229   N 42° 02' 34'' W   410993.2500   1354296.6229   N 42° 02' 34'' W   410993.2500   13556032.6211   N 17° 40' 02'' W   412199.7027   1356032.6211   N 17° 40' 02'' W   413147.8064   1355730.6417   N 17° 40' 02'' W   413517.7955   1355624.3432   N 17° 38' 08'' W   410993.2500   1354296.6229   N 42° 02' 34'' W   410993.2500   13556032.6211   N 17° 40' 02'' W   410993.2500   135500.9591   N 10° 53' 04'' W   410993.2500   135500.9591   N 10° 53' 04'' W   410993.2500   135500.9591   N 10° 53' 04'' W   410993.2500   135500.9591   N 10° 17' 11'' E   410993.2500   135500.9591   N 10° 17' 11'' E   410993.2500   135500.2503   N 10° 17' 11'' E   410953.2500   135500.2503   N						0 00 10 00 2
FORBES AVE    203+00.89   PI						S 88°48′58" E
FORBES AVE    204+11.94   PT						S 88°48′58" E
## A 17 57 73 5						N 47°57′35" E
239+12.60 PI 411785.3193 1354718.8982	FORBES AVE					N 47°57′35" E
ATWOOD ST  ATWOOD POB						N 47°57′35" E
ATWOOD ST    10+00.00   POB						N 72°29′36" E
ATWOOD ST    10+00.00						N 72°29/36    E
S   BELLEFIELD AVE   51+00.00   POB   411474.2805   1353862.8516   N   42°02′34" W		259+03.72			1356619.7066	N 12 29 36" E
S BELLEFIELD AVE    S BELLEFIELD AVE	ATWOOD ST	10+00.00				N 42°02′34" W
N BELLEFIELD AVE   60+95.03   POE   413147.8064   1355730.6417   N 17°40′02" W   M   M   M   M   M   M   M   M   M		16+47.73			1353862.8516	
N BELLEFIELD AVE  60+95.03 POE 413147.8064 1355730.6417  61+00.00 POB 413155.7392 1355739.4420  64+79.91 POE 413517.7955 1355624.3432  31+00.00 POB 411951.3554 1355245.2838  32+52.61 PI 412097.3875 1355200.9591  36+79.50 PI 412414.9390 1354915.6597  40+04.16 POE 412656.1585 1354698.3663  N 16°53′04" W  N 41°56′15" W  N 42°00′46" W  R 40+04.16 POE 410087.7727 1349888.5796    10+00.00 POB 409379.5025 1349760.0378     10+51.34 POE 410087.7727 1349888.5796     10+00.00 POB 409531.9871 1351497.0834     10+87.91 PI 409534.8067 1351584.9454     10+87.91 PI 409534.8067 1351584.9454     11+21.16 PCC 409560.1858 1351611.2756     11+42.61 PI 409575.0726 1351626.7201     11+61.40 PT 409596.4940 1351625.5934     N 10°37′03°00′39" W	S BELLEFIELD AVE					N 17°40′02" W
N BELLEFIELD AVE						
BIGELOW BLVD  31+00.00  POB 411951.3554  3155245.2838  32+52.61  PI 412097.3875  1355200.9591  36+79.50  PI 412414.9390  1354915.6597  40+04.16  POE 412656.1585  1354698.3663  N 42°00′46" W  N 42°00′46" W  ROM 100.00  ROM 10087.7727  ROM	N BELLEFTELD AVE	61+00.00		413155.7392	1355739.4420	N 17°38′08" W
BIGELOW BLVD  32+52.61 PI 412097.3875 1355200.9591  36+79.50 PI 412414.9390 1354915.6597  40+04.16 POE 412656.1585 1354698.3663  N 42°00′46" W  SR 2085 (BIRMINGHAM BRIDGE) 17+19.84 POE 410087.7727 1349888.5796  10+00.00 POB 409379.5025 1349760.0378 10+51.34 POE 410087.7727 1349888.5796  10+00.00 POB 409531.9871 1351497.0834 10+51.34 PC 409533.6337 1351548.3941 N 88°09′43" E  SR 8119 (BLVD OF THE ALLIES RAMP)  11+21.16 PCC 409560.1858 1351611.2756 11+42.61 PI 409575.0726 1351626.7201 11+61.40 PT 409596.4940 1351625.5934 N 03°00′39" W			POE		1355624.3432	
BIGELOW BLVD  36+79.50 PI 412414.9390 1354915.6597  40+04.16 POE 412656.1585 1354698.3663  SR 2085 (BIRMINGHAM BRIDGE) 17+19.84 POE 410087.7727 1349888.5796  10+00.00 POB 409531.9871 1351497.0834 10+51.34 PC 409533.6337 1351548.3941  SR 8119 (BLVD OF THE ALLIES RAMP)  ALLIES RAMP)  11+21.16 PCC 409560.1858 1351611.2756 11+42.61 PI 409575.0726 1351626.7201 11+61.40 PT 409596.4940 1351625.5934  N 41°56′15" W N 42°00′46" W N 42°00′40°40°40°40°40°40°40°40°40°40°40°40°40°4		31+00.00	POB	411951.3554	1355245.2838	N 16°53′04" W
36+79.50 PI 412414.9390 1354915.6597  40+04.16 POE 412656.1585 1354698.3663 N 42°00′46" W  SR 2085 10+00.00 POB 409379.5025 1349760.0378 N 10°17′11" E  17+19.84 POE 410087.7727 1349888.5796  10+00.00 POB 409531.9871 1351497.0834 10+51.34 PC 409533.6337 13515483.941 N 88°09′43" E  SR 8119 (BLVD OF THE ALLIES RAMP) PI 409534.8067 1351584.9454 11+21.16 PCC 409560.1858 1351611.2756 11+42.61 PI 409575.0726 1351626.7201 11+61.40 PT 409596.4940 1351625.5934 N 03°00′39" W	BIGELOW BLVD	32+52.61	PI	412097.3875	1355200.9591	N 41°56′15" W
SR 2085 (BIRMINGHAM BRIDGE) 10+00.00 POB 409379.5025 1349760.0378 N 10°17′11" E  10+00.00 POB 409379.5025 13497808.5796  10+00.00 POB 409531.9871 1351497.0834 N 88°09′43" E  SR 8119 (BLVD OF THE ALLIES RAMP) PI 409534.8067 1351584.9454  11+21.16 PCC 409560.1858 1351611.2756 N 46°03′13" E  11+42.61 PI 409575.0726 1351626.7201 11+61.40 PT 409596.4940 1351625.5934 N 03°00′39" W	51022511 52 45	36+79.50	ΡI	412414.9390	1354915.6597	
(BIRMINGHAM BRIDGE) 17+19.84 POE 410087.7727 1349888.5796 N 10*17*11" E 10*10*10*10*10*10*10*10*10*10*10*10*10*1						N 42°00′46" W
10+00.00   POB   409531.9871   1351497.0834   N 88°09′43"   E						N 10°17′11" E
SR 8119 (BLVD OF THE ALLIES RAMP)  10+87.91 PI 409534.8067 1351548.3941 N 88°09′43" E 409534.8067 1351548.3941 N 46°03′13" E 409560.1858 1351611.2756 11+42.61 PI 409575.0726 1351626.7201 11+61.40 PT 409596.4940 1351625.5934 N 03°00′39" W	COLKMINGHAM BRIDGE)					
SR 8119 (BLVD OF THE ALLIES RAMP)  (BLVD OF THE 11+21.16 PCC 409534.8067 1351584.9454  11+22.61 PI 409575.0726 1351626.7201  11+61.40 PT 409596.4940 1351625.5934  N 03°00′39" W						N 88°09′43" E
(BLVD OF THE ALLIES RAMP) 11+21.16 PCC 409560.1858 1351611.2756 N 46°03′13" E 11+42.61 PI 409575.0726 1351626.7201 N 03°00′39" W						
ALLIES RAMP) 11+42.61 PI 409575.0726 1351626.7201 11+61.40 PT 409596.4940 1351625.5934 N 03°00′39" W						N 46907/17"
11+61.40 PT 4095/6.4940 1351625.5934 N 03°00′39" W						N 40°U3'13" E
1 03 00 33 11						
12+00.00   POE   409635.0376   1351623.5661						N 03°00′39" W
		12+00.00	POE	409635.0376	1351623.5661	

CONSTD DASEL THE	CTATION	DOINT	NODTHING	EASTING	DEADINO
CONSTR BASELINE	0+00.00	POINT POB	NORTH ING 410139.3189	EASTING 1344109.8839	BEARING
BOYD ST		POE		1344158.2621	N 06°07′32
	4+53.38		410590.1062		
CHATHAM SQ	21+00.00	POB	410304.8034	1344767.7630	N 05°56′59
CHATHAM SQ	24+19.23	POE	410622.3131	1344800.8536	
	25+00.00	POB	410622.2771	1344801.2914	N 05°24′03
WASHIANOTON DI	25+70.63	PC	410692.5960	1344807.9396	N 05°24′03
WASHINGTON PL	26+50.40	PI	410772.0067	1344815.4474	N 19°35′07
	27+27.63	PT	410847.1565	1344788.7094	N 40075/07
	28+82.83	P0E	410993.3819	1344736.6831	N 19°35′07
CHESTERFIELD RD	20+00.00	P0B	410619.1982	1352926.0988	N 42°08′53
	23+28.42	P0E	410862.6948	1352705.7116	
COLTART AVE	10+00.00	POB	410211.0181	1353601.7852	N 42°06′45
	14+21.12	P0E	410523.4151	1353319.3896	
CRAFT AVE	11+00.00	POB	409365.3306	1352931.0250	N 41°56′24
	20+60.63	POE	410079.8927	1352288.9816	
	30+00.00	POB	411633.7936	1354036.7793	N 65°56′04
	31+62.58	PC	411700.0923	1353888.3278	N 65°56′04
DE SOTO ST	32+27.98	ΡI	411726.7604	1353828.6145	N 52°07′26
	32+92.74	PT	411766.9117	1353776.9936	
	33+20.67	P0E	411784.0579	1353754.9495	N 52°07′26
	41+00.00	POB	410371.1697	1343589.9123	N 67°06′17
	45+59.49	PC	410549.9317	1344013.1982	
	45+68.08	ΡI	410553.2738	1344021.1120	N 67°06′17
DIAMOND CT	45+76.64	PT	410555.5019	1344029.4086	N 74°58′03
DIAMOND ST	48+12.68	PC	410616.7233	1344257.3744	N 74°58′03
	48+26.23	PI	410620.2360	1344270.4550	N 74°58′03
	48+37.51	PT	410633.1114	1344274.6566	N 18°04′29
	48+70.45	P0E	410664.4292	1344284.8775	N 18°04′29
	20+00.00	POB	410390.5399	1347624.8837	
DINWIDDIE ST	22+48.48	POE	410638.1642	1347645.4692	N 04°45′08
	20+00.00	POB	412248.4667	1356187.2181	
S DITHRIDGE ST	21+14.13	ΡI	412361.2748	1356169.9276	N 08°42′51
	30+07.10	POE	413251.9491	1356105.8508	N 04°06′54
	30+00.00	POB	411043.4718	1353384.4732	
DARRAGH ST	32+98.80	POE	411218.6338	1353142.4006	N 54°06′39
	10+00.00	POB	409766.0726	1347946.9671	
GIST ST	12+71.89	POE	410036.9844	1347969.9937	N 04°51′30
	20+00.00	POB	410037.0500	1347969, 1966	
GIST ST	23+24.14	POE	410360.0310	1347996.6186	N 04°51′11
	10+00.00	POB		1353381.9410	
HALKET ST					N 42°00′06
	14+79.14	POE	410290.7192	1353061.3194	
HALKET ST	20+00.00	POB	410289.8565	1353060.3626	N 41°52′29
	23+34.37	P0E	410538.8334	1352837.1661	
JUMONVILLE ST	10+00.00	POB	409758.5131	1348444.5077	⊣ N 04°39′00"
OUMOINATEE 21		POE	409996.3332	1348463.8507	
OUMONAILLE 21	12+38.61	_	409996.3162	1348464.0567	N 04°42′57
JUMONVILLE ST	20+00.00	POB			
	20+00.00	POB POE	410319.4796	1348490.7154	17 01 12 01
	20+00.00			1348490.7154 1349876.4936	
	20+00.00	POE	410319.4796		
	20+00.00 23+24.26 30+00.00	POE POB	410319.4796 410093.3131	1349876.4936	
JUMONVILLE ST	20+00.00 23+24.26 30+00.00 31+33.87	POE POB PC	410319.4796 410093.3131 410226.8833	1349876.4936 1349885.4804	N 03°50′57

# AECOM Gulf Tower 707 Grant Street

Gulf Tower 707 Grant Street 5th Floor Pittsburgh, PA 15219

			THE PREI
			PART THI
			FEDERAL U.S. DEP
			TRANSPO
			URBAN M OF 1964,
ο.	DATE	DESCRIPTION	PORT AU
		REVISIONS	COUNTY,

THE PREPARATION OF THIS
DOCUMENT HAS BEEN FINANCED IN
PART THROUGH A GRANT FROM THE
FEDERAL TRANSIT ADMINISTRATION,
J.S. DEPARTMENT OF
FRANSPORTATION, UNDER THE
JRBAN MASS TRANSPORTATION ACT
DF 1964, AS AMENDED, FOR THE
PORT AUTHORITY OF ALLEGHENY
COUNTY, PENNSYLVANIA.

(NOT FOR CONSTRUCTION)

DESIGNED	SDS	
DRAWN	<u>JMS</u>	
CHECKED	MES	
IN CHARGE	LAR	
DATE	05/01/24	
SCALE		
	AS SHOWN	

# PORT AUTHORITY OF ALLEGHENY COUNTY PITTSBURGH PENNSYLVANIA

BUS RAPID TRANSIT UPTOWN TO OAKLAND PROJECT COORDINATES FIFTH AVE, FORBES AVE AND SIDE STREETS

Port Authority connecting people to life

CONTRACT NO. BRT-001

DWG. NO. GN28 SHT. 28

## SUMMARY OF PROJECT COORDINATES

BASED ON PENNSYLVANIA STATE PLANE COORDINATE SYSTEM (SPCS 83) (SOUTH SIDE) GEOID 12B

CONSTR BASELINE	STATION	POINT	NORTHING	EASTING	BEARING
	20+00.00	POB	410547.9092	1345707.4244	
LOGAN ST	21+35.97	POE	410683, 4395	1345718.3883	N 04°37′30" E
	30+00.00	РОВ	411246.7092	1353610.1520	
LOTHROP ST	33+05.91	POE	411421.8402	1353359.3388	N 55°04′31" W
	40+00.00	POB	412630.6768	1355156.9606	
LYTTON AVE	43+37.23	POE	412881,2798	1354931.3047	N 42°00′05" W
	31+00.00	POB	409989.5742	1345485.8169	
MAGEE ST	36+74.74	POE	410561.1770	1345545.7631	N 05°59′13" E
	10+00.00	POB	409861.5195	1346634.3679	
MARION ST	12+84.50	POE	410144.5453	1346663, 2745	N 05°49′54" E
	19+91.52	POB	410144.5690	1346662.9872	
MARION ST	23+15.41	POE	410466, 7818	1346695.9183	N 05°50′08" E
	0+03.83	POB	410222.7874	1344452,2793	6 04000/ 5411 5
	2+60.35	PC	410196.6346	1344707.4645	S 84°08′54" E
MCANULTY DR	3+02.18	PI	410192.3695	1344749.0801	S 84°08′54" E
MOANGETT BIX	3+27.75	PT	410233.5640	1344756.3648	N 10°01′42" E
	4+00,00	POE	410304.7061	1344768.9453	N 10°01′42" E
	10+00.00	POB	410481.5683	1353824.0625	
MCKEE PL	17+10.03	POE	411008.6593	1353348.3337	N 42°04′05" W
	10+00.00	POB	410743.8664	1354157.6500	
MERYAN ST	17+40.04	POE	411293, 9525	1353662.6119	N 41°59′06" W
	10+00.00	POB	409813.6826	1347411.7768	
MILTENBERGER ST	15+92.36	POE	410403.9885	1347461.0198	N 04°46′07" E
	51+00.00	POB	409754.2802	1349348.8909	
MOULTRIE ST	52+68.65	POE	409922, 4101	1349362.0715	N 04°28′57" E
	53+00.00	POB	409922.4436	1349361.5079	
MOULTRIE ST	56+01.54	POE	410222.9280	1349386.6611	N 04°47′06" E
	30+00.00	POB	410216.3541	1349434.4954	
MOULTRIE ST	31+60.70	POE	410374.6495	1349462.2114	N 09°55′53" E
	10+00.00	POB	411281.1166	1354751.0429	
N/S BOUQUET ST	20+62.61	POE	411927, 2394	1353907.4455	N 52°33′04" W
	10+00.00	POB	411954.9949	1356910, 1542	
S NEVILLE ST	12+47.68	PI	412174.7854	1357024.3454	N 27°27′14" E
3 NEVILLE 31	14+95.37	POE	412394.5758	1357138.5366	1 21 21 14 6
	20+00.00	POB	412394.6778	1357138.3388	
		PC	412478.2053	1357187.2108	N 27°21′16" E
S NEVILLE ST	20+94.04	PI	412581.3788	1357240.5869	N 27°21′16" E
3 NEVILLE 31					N 11°58′54" W
	23+17.17	PT POE	412695.0107	1357216.4717	N 11°58′54" W
		POB	412708.1233	1357213.6889	
N/S NEVILLE ST	11+00.00		412924.6380	1357147.0088	N 17°04′22" W
	36+38.96	POE	415351.7107	1356401.6110	
OAKLAND AVE	10+00.00	POB	411162.1394	1354482.3649	N 42°01′48" W
	16+48.68	POE	411643.9726	1354048.0634	
PRIDE ST	10+00.00	POB	409919.3371	1346381.5531	N 05°42′37" E
	12+47.61	POE	410165.7142	1346406.1893	
PRIDE ST	26+76.30	POB	410165.6525	1346406.8515	N 05°35′23" E
	30+00.11	POE	410487.9174	1346438.3922	
PRIDE ST	30+00.00	POB	410488.4869	1346431.4527	N 05°51′04" E
	32+77.47	POE	410764.5135	1346459.7394	

CONSTR BASELINE	STATION	POINT	NORTHING	EASTING	BEARING
	611+00.00	POB	409836.3557	1351790.3036	N 24°30′07'
	613+23.33	PC	410039.5740	1351882.9240	
ROBINSON ST A	613+54.08	PI	410067.5566	1351895.6775	N 24°30′07'
11051110011 01 71	613+78.47	PT	410068.7971	1351926.4043	N 87°41′17'
	615+95.50	POE	410077.5524	1352143.2589	N 87°41′17
	630+00.00	POB	410064.3984	1351907.8245	
ROBINSON ST B	633+35.57	POE	410399.8275	1351898.0848	N 01°39′48
	50+00.00	POB	413018.3052	1355586.9787	
RUSKIN AVE	53+55.32	POE	413282.2630	1355349.1145	N 42°01′24'
	22+46.91	POB	411709.5244	1355319.9456	
SCHENLEY DR	25+00.00	POE	411951.0076	1355244. 1812	N 17°25′09
	60+00.00	POB	411722.5355		
SCHENLEY DR EXTENSION				1355750.3455	N 17°33′48
LATENSTON	63+70.15	POE	412075.4330	1355638.6479	
SEMPLE ST	10+00.00	POB	410614.1481	1354015.8365	N 42°04′09
	13+98.99	POE	410910.3345	1353748.5006	
SENECA ST	10+00.00	POB	409703.3444	1348937.2716	N 04°44′51
	12+53.16	P0E	409955.6394	1348958.2245	
SENECA ST	15+00.00	РОВ	409955.6641	1348957.9247	N 04°44′43
	18+23.37	POE	410277.9277	1348984.6753	
SHINGISS ST	20+00.00	POB	410361.0709	1343964.3846	N 07°09′01
311110133 31	21+79.05	POE	410538.7291	1343986.6718	14 01 03 01
	620+00.00	POB	411366.9673	1343440.4489	S 60°36′44
	620+80.50	ΡI	411327.4664	1343510.5866	C C08 F0/ 00
	622+46.33	ΡI	411270.6799	1343666.3906	S 69°58′28
	624+10.73	PC	411192.3950	1343810.9620	S 61°33′53
	625+61.53	PI	411120.5911	1343943.5646	S 61°33′53
SIXTH AVE	626+54.59	PŤ	410982.4411	1343883.1180	S 23°37′53
	629+81.50	PC	410682.9430	1343752.0748	S 23°37′53
	630+25.38	ΡΙ	410642.7490	1343734.4882	S 23°37′53
	630+64.19	PT	410602.5902	1343752.1548	S 23°44′44
	633+24.49	POE	410364.3315	1343856.9694	S 23°44′44
	10+00.00	POB	409940.9731	1345992.6513	
STEVENSON ST	12+62.16	POE	410201.8246	1346018.7755	N 05°43′09
	15+00.00	POB	410201.8510	1346018.4548	
STEVENSON ST	18+19.52	POE	410519.7090	1346051.0288	N 05°51′04
	20+00.00	POB	410520.3720	1346048.7508	
STEVENSON ST	21+34.96	POE	410654.8585	1346060.0453	N 04°48′02
			412824.9047	1355372.4286	
TENNYSON AVE	10+00.00	POB			N 42°01′02
	13+46.52	POE	413082.3486	1355140. 4843	
THACKERAY AVE	30+00.00	POB	411967.0884	1354406.2634	N 41°58′26
	33+05.12	POE	412193.9286	1354202.2020	
UNIVERSITY PL	40+00.00	POB	412189.8603	1354653.6147	N 41°59′06
	43+09.76	POE	412420.1097	1354446.4066	
SIVIVENOITT TE					
	10+00.00	POB	409839.1685	1347069.5956	N 04° 45′ 26
VAN BRAMM ST		POB POE	409839.1685	1347069.5956 1347092.0722	N 04°45′26
VAN BRAMM ST	10+00.00				
	10+00.00 12+71.01	POE	410109.2494	1347092.0722	
VAN BRAMM ST	10+00.00 12+71.01 20+00.00	POE POB	410109.2494 410109.2839	1347092.0722 1347091.6533	N 04°52′05
VAN BRAMM ST	10+00.00 12+71.01 20+00.00 23+23.93	POE POB POE	410109.2494 410109.2839 410432.0470	1347092.0722 1347091.6533 1347119.1425	N 04°52′05
VAN BRAMM ST	10+00.00 12+71.01 20+00.00 23+23.93 30+00.00	POE POB POE POB	410109.2494 410109.2839 410432.0470 410463.9340	1347092.0722 1347091.6533 1347119.1425 1346730.6170	N 04°52′05 N 03°35′05
VAN BRAMM ST	10+00.00 12+71.01 20+00.00 23+23.93 30+00.00 32+44.27	P0E P0B P0E P0B P0E	410109.2494 410109.2839 410432.0470 410463.9340 410707.7282	1347092.0722 1347091.6533 1347119.1425 1346730.6170 1346745.8901	N 04°52′05 N 03°35′05 N 04°41′31
VAN BRAMM ST	10+00.00 12+71.01 20+00.00 23+23.93 30+00.00 32+44.27 30+00.00	POE POB POE POB POE	410109.2494 410109.2839 410432.0470 410463.9340 410707.7282 410315.6460	1347092.0722 1347091.6533 1347119.1425 1346730.6170 1346745.8901 1348537.4254	N 04° 52′ 05 N 03° 35′ 05 N 04° 41′ 31 N 04° 41′ 31
VAN BRAMM ST  VAN BRAMM ST  VINE ST	10+00.00 12+71.01 20+00.00 23+23.93 30+00.00 32+44.27 30+00.00 30+23.50	POE POB POE POB POE POB POE POB	410109.2494 410109.2839 410432.0470 410463.9340 410707.7282 410315.6460 410339.0710	1347092.0722 1347091.6533 1347119.1425 1346730.6170 1346745.8901 1348537.4254 1348539.3479	N 04° 45′ 26′ N 04° 52′ 05′ N 03° 35′ 05′ N 04° 41′ 31′ N 04° 41′ 31′ N 60° 52′ 13′

**AECOM** 

Gulf Tower 707 Grant Street 5th Floor Pittsburgh, PA 15219

		THE PREPARATION OF THIS DOCUMENT HAS BEEN FINANCED IN PART THROUGH A GRANT FROM THE FEDERAL TRANSIT ADMINISTRATION, U.S. DEPARTMENT OF TRANSPORTATION, UNDER THE URBAN MASS TRANSPORTATION ACT
DATE	DESCRIPTION	OF 1964, AS AMENDED, FOR THE PORT AUTHORITY OF ALLEGHENY
Ditte	REVISIONS	COUNTY, PENNSYLVANIA.

# (NOT FOR CONSTRUCTION)


DESIGNED	SDS	
DRAWN	<u>JMS</u>	
CHECKED	MES	
N CHARGE	LAR	
DATE	05/01/24	
SCALE	4.0.011014/41	I
	AS SHOWN	

# PORT AUTHORITY OF ALLEGHENY COUNTY

BUS RAPID TRANSIT UPTOWN TO OAKLAND PROJECT COORDINATES SIDE STREETS

Port Authority connecting people to life

CONTRACT NO. BRT-001 DWG. NO. GN29 sнт. 29

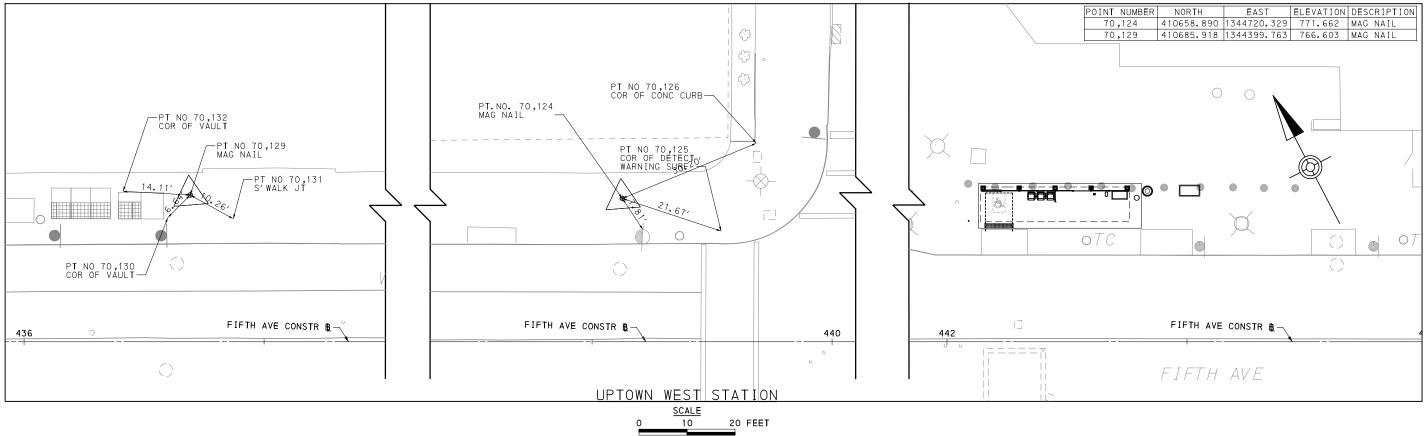

AECOM

Gulf Tower 707 Grant Street 5th Floor Pittsburgh, PA 15219 CONSULTING ENGINEERS, INC.
1225 RODI ROAD
TURTLE CREEK, PA 15145
NO. DATE

THE PREPARATION OF THIS
DOCUMENT HAS BEEN FINANCED IN
PART THROUGH A GRANT FROM THE
FEDERAL TRANSIT ADMINISTRATION,
U.S. DEPARTMENT OF
TRANSPORTATION, UNDER THE
URBAN MASS TRANSPORTATION ACT
OF 1964, AS AMENDED, FOR THE
PORT AUTHORITY OF ALLEGHENY
COUNTY, PENNSYLVANIA.

(NOT FOR CONSTRUCTION)

DESIGNED	DCL	
DRAWN	<u>MEL</u>	
CHECKED	MJM	
N CHARGE	<u>MJM</u>	
DATE	05/01/24	
SCALE		
	AS SHOWN	


PORT AUTHORITY OF ALLEGHENY COUNTY PENNSYLVANIA
BUS RAPID TRANSIT UPTOWN TO OAKLAND


BUS RAPID TRANSIT UPTOWN TO OAKLAND STATION CONTROL POINTS UPTOWN WEST STATION


Port Authority CONTRACT NO. BRT-001


DWG. NO. GN30 SHT. 30


OPERATOR: "linvillem"

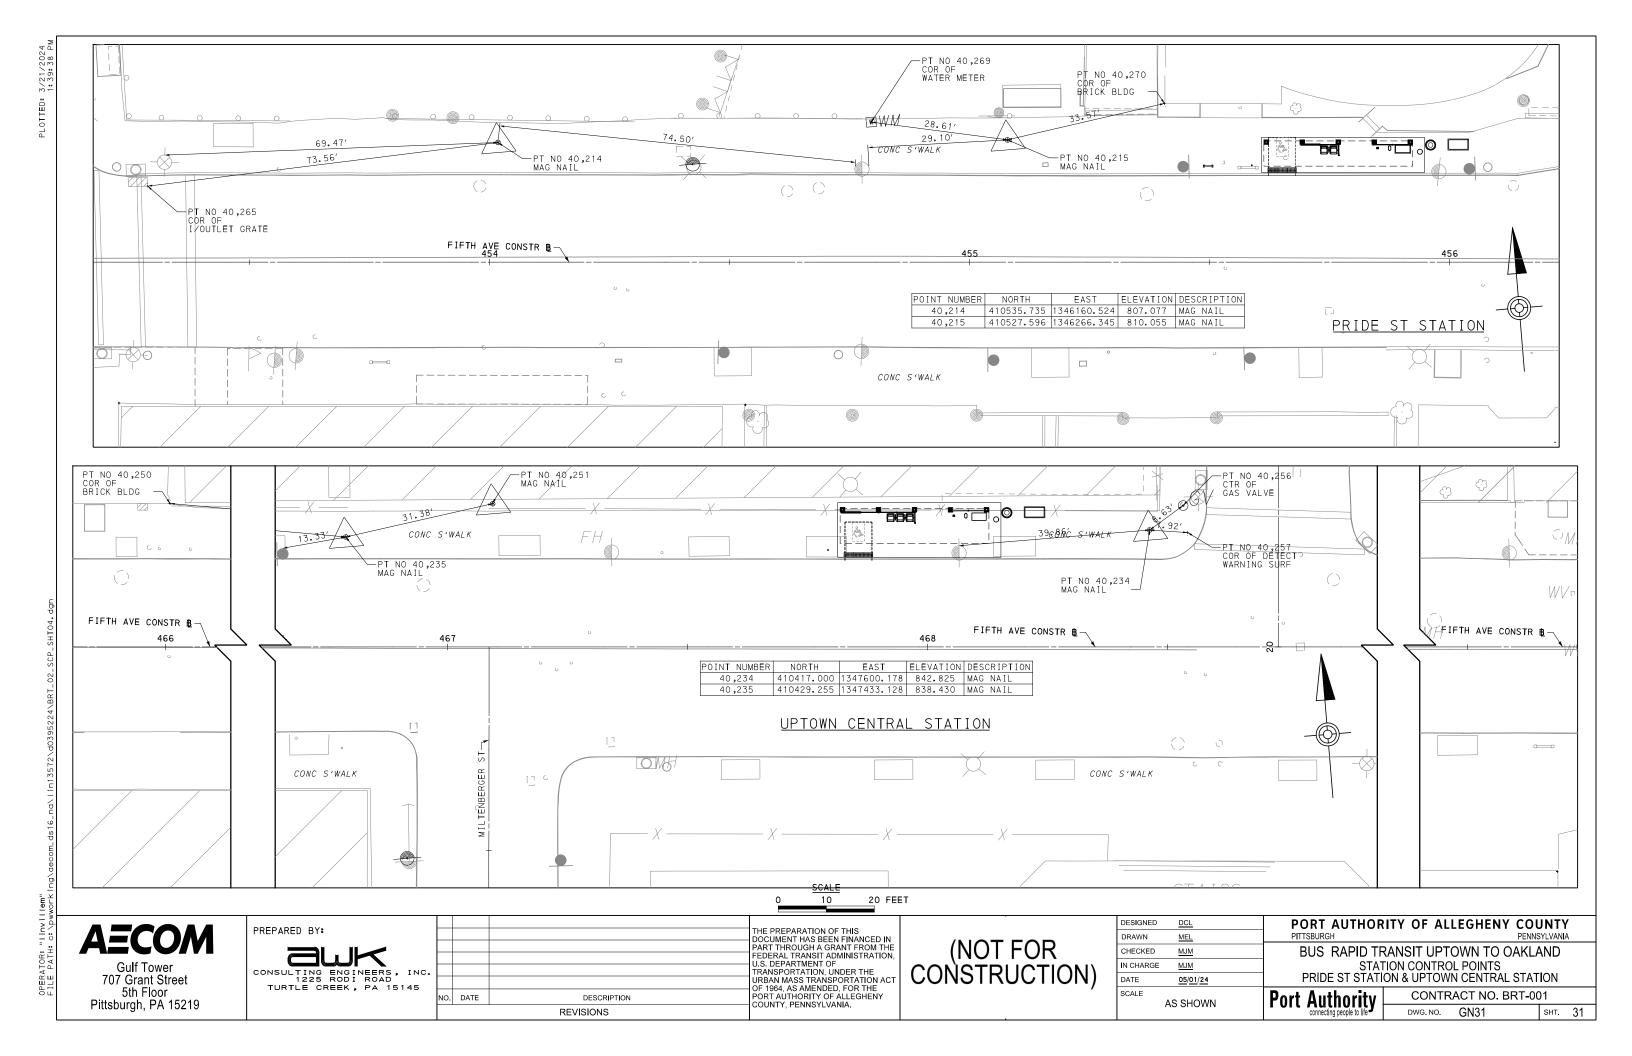

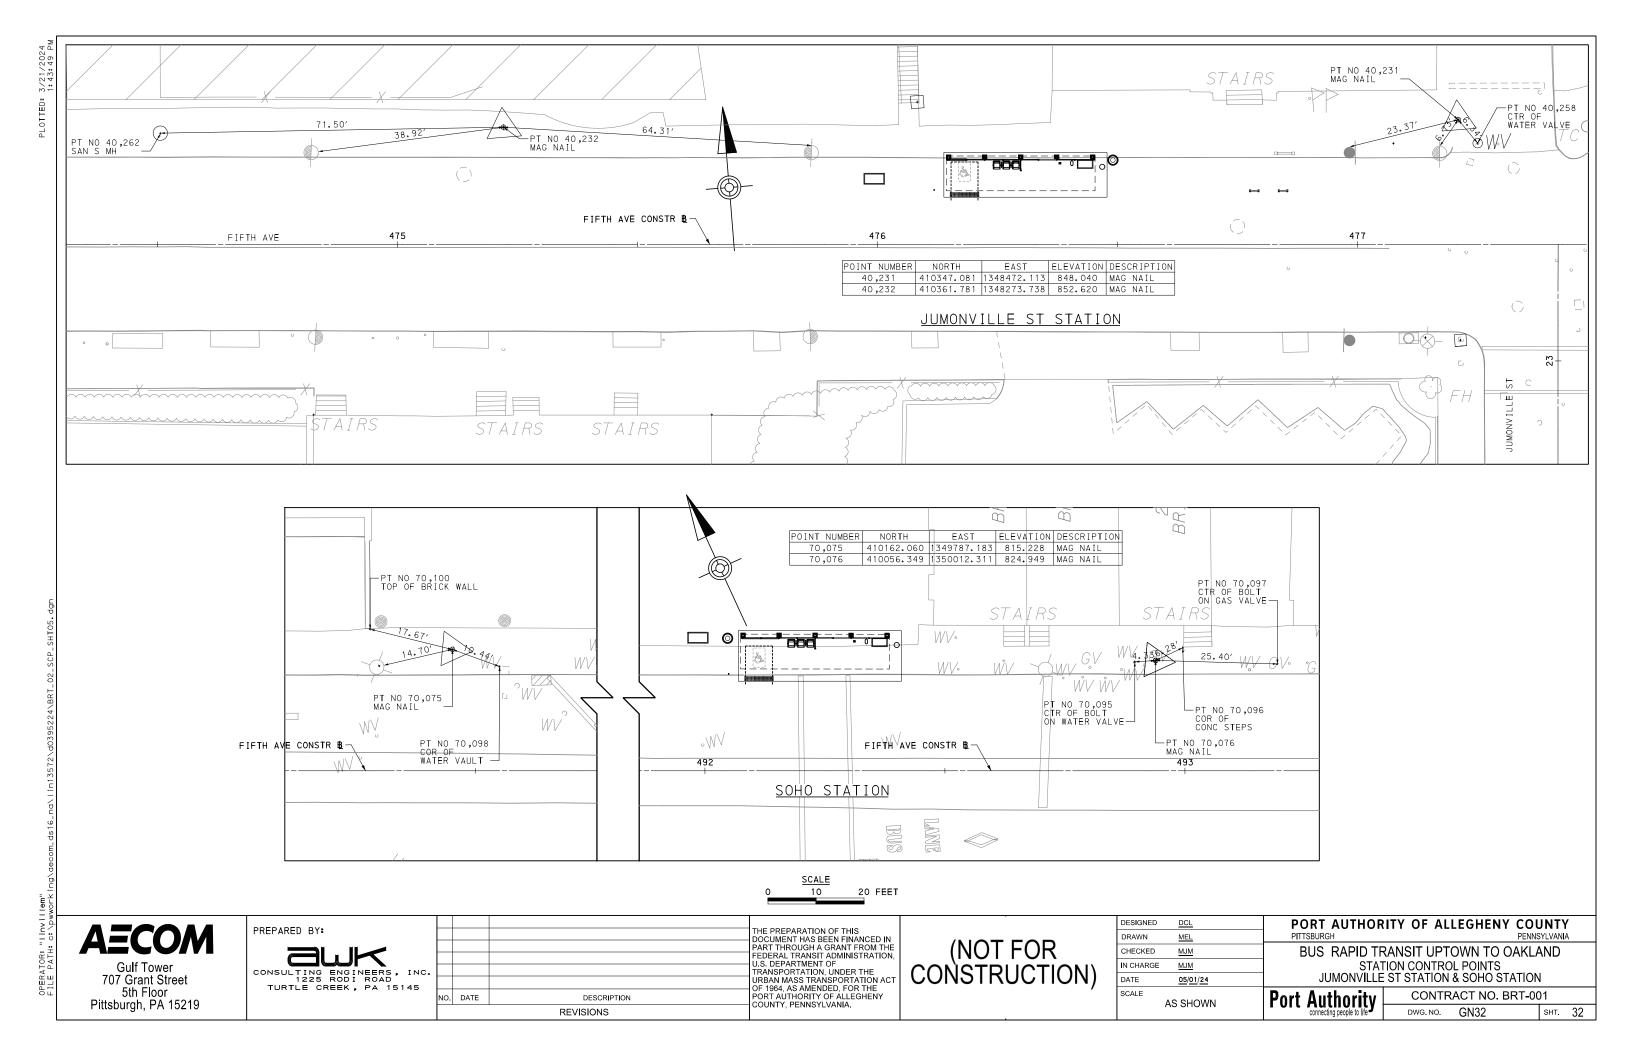

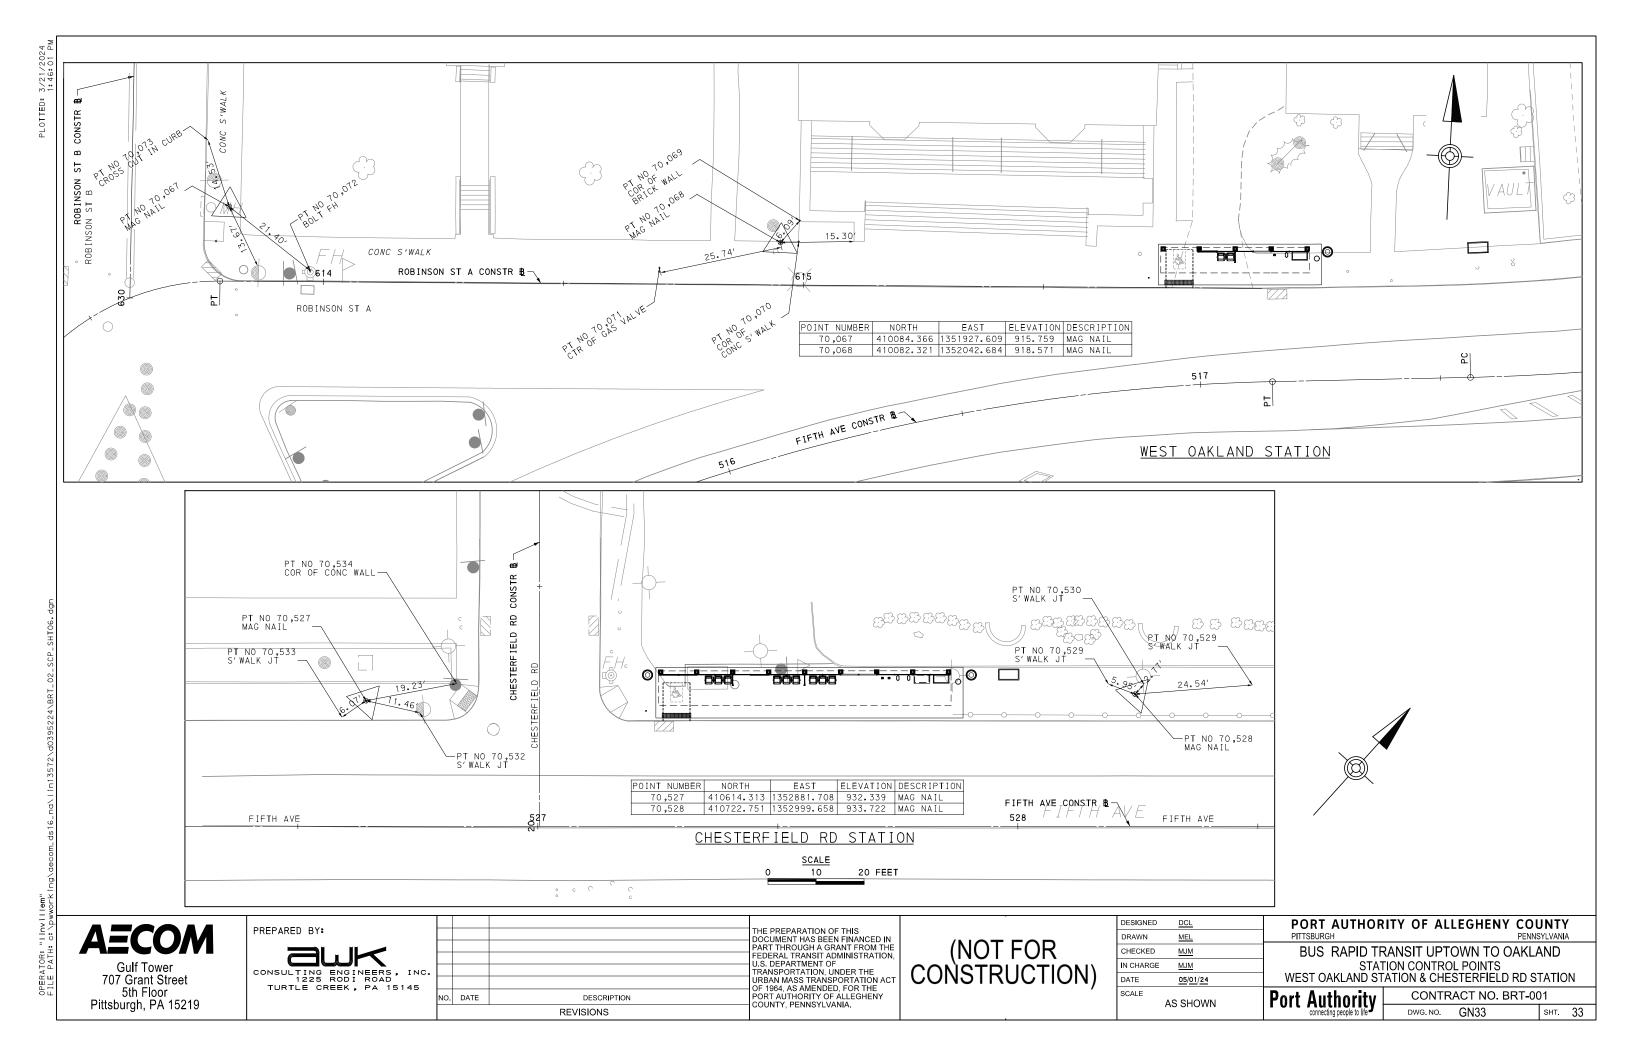

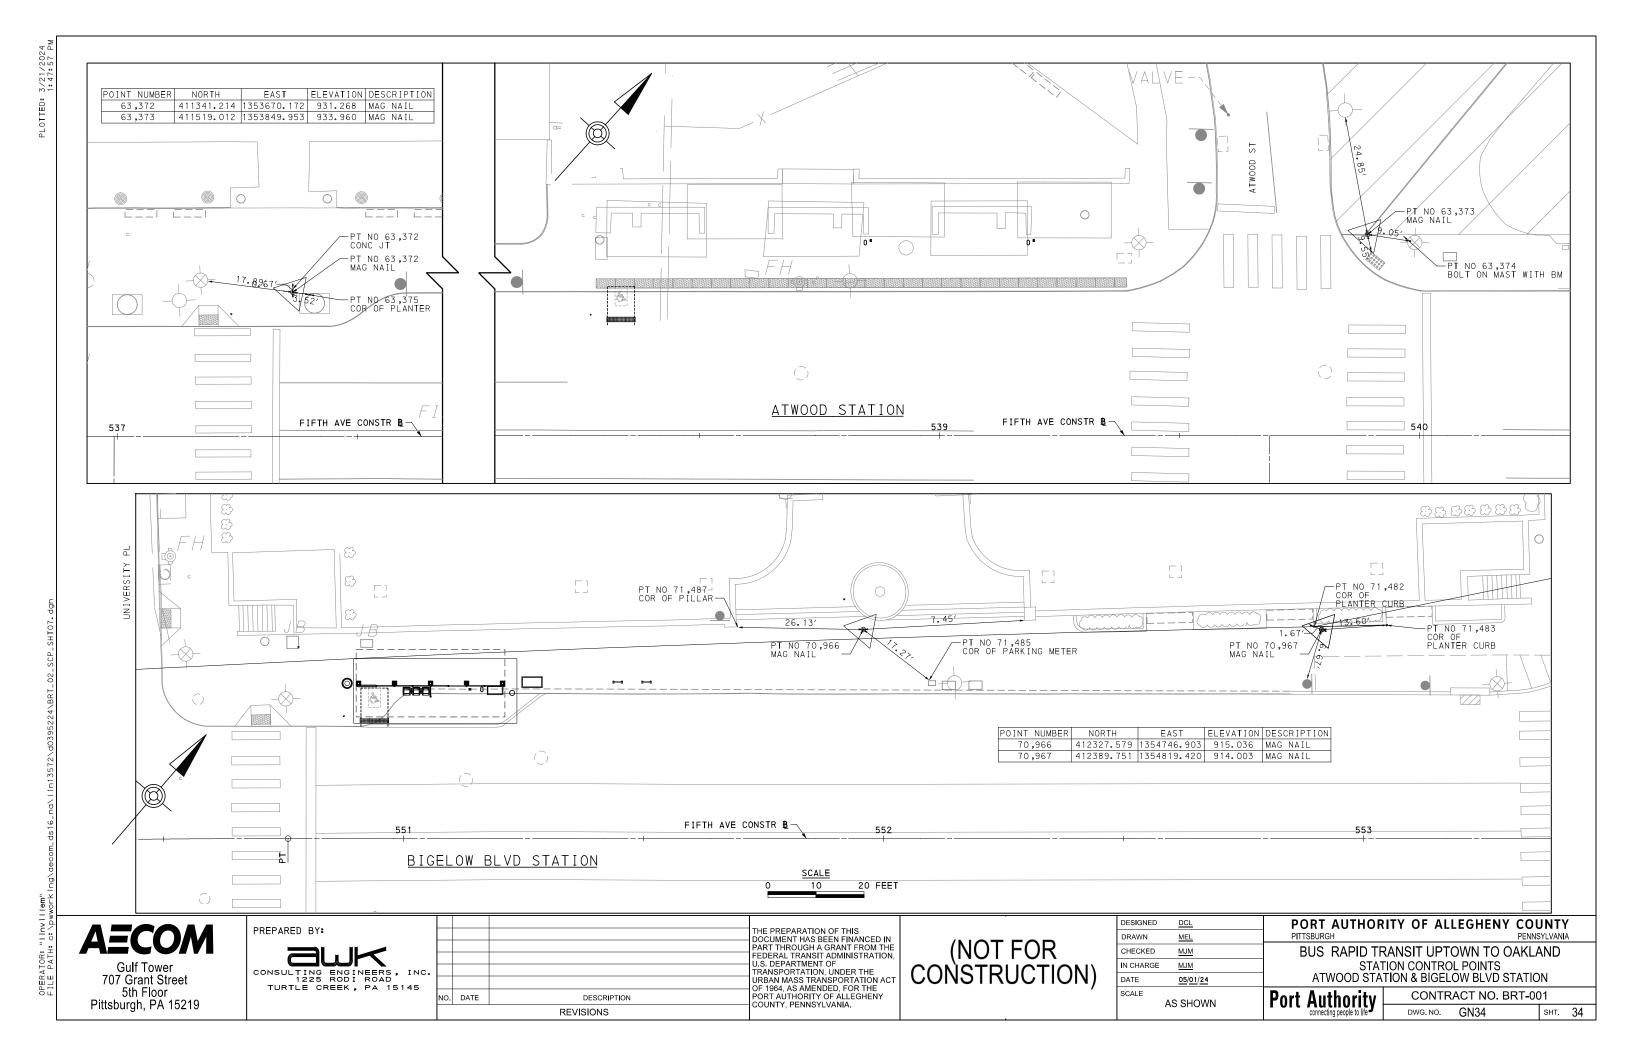

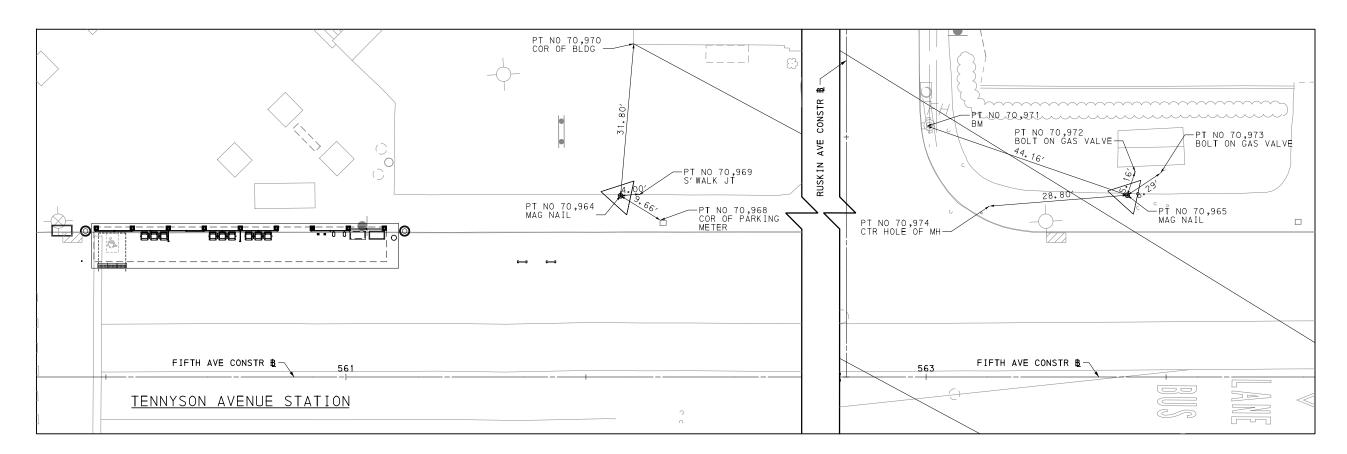



POINT	NUMBER	NORTH	EAST	ELEVATION	DESCRIPTION
70	,964	412961.859	1355468.010	918.745	MAG NAIL
70,	,965	413085.624	1355605.111	920.652	MAG NAIL

SCALE 0 10 20 FEET

**AECOM**Gulf Tower

Gulf Tower 707 Grant Street 5th Floor Pittsburgh, PA 15219 PREPARED BY:

CONSULTING ENGINEERS, INC.
1225 RODI ROAD
TURTLE CREEK, PA 15145

NO. DA

		THE PREPARATION OF THIS DOCUMENT HAS BEEN FINANCED IN
		PART THROUGH A GRANT FROM THE
		FEDERAL TRANSIT ADMINISTRATION, U.S. DEPARTMENT OF
		TRANSPORTATION, UNDER THE
		URBAN MASS TRANSPORTATION ACT OF 1964, AS AMENDED, FOR THE
ATE	DESCRIPTION	PORT AUTHORITY OF ALLEGHENY COUNTY, PENNSYLVANIA.
	REVISIONS	COUNTY, PENNSTEVANIA.

(NOT FOR CONSTRUCTION)

	DESIGNED	DCL	
	DRAWN	<u>MEL</u>	
	CHECKED	MJM	
	IN CHARGE	<u>MJM</u>	
	DATE	05/01/24	
	SCALE		
		AS SHOWN	


# PORT AUTHORITY OF ALLEGHENY COUNTY PITTSBURGH BUS RAPID TRANSIT UPTOWN TO OAKLAND STATION CONTROL POINTS

STATION CONTROL POINTS
TENNYSON AVE STATION


Down Authority CONTRACT NO. BRT-001


Port Authority CONTRACT NO. BRT-001

DWG. NO. GN35 SHT. 35

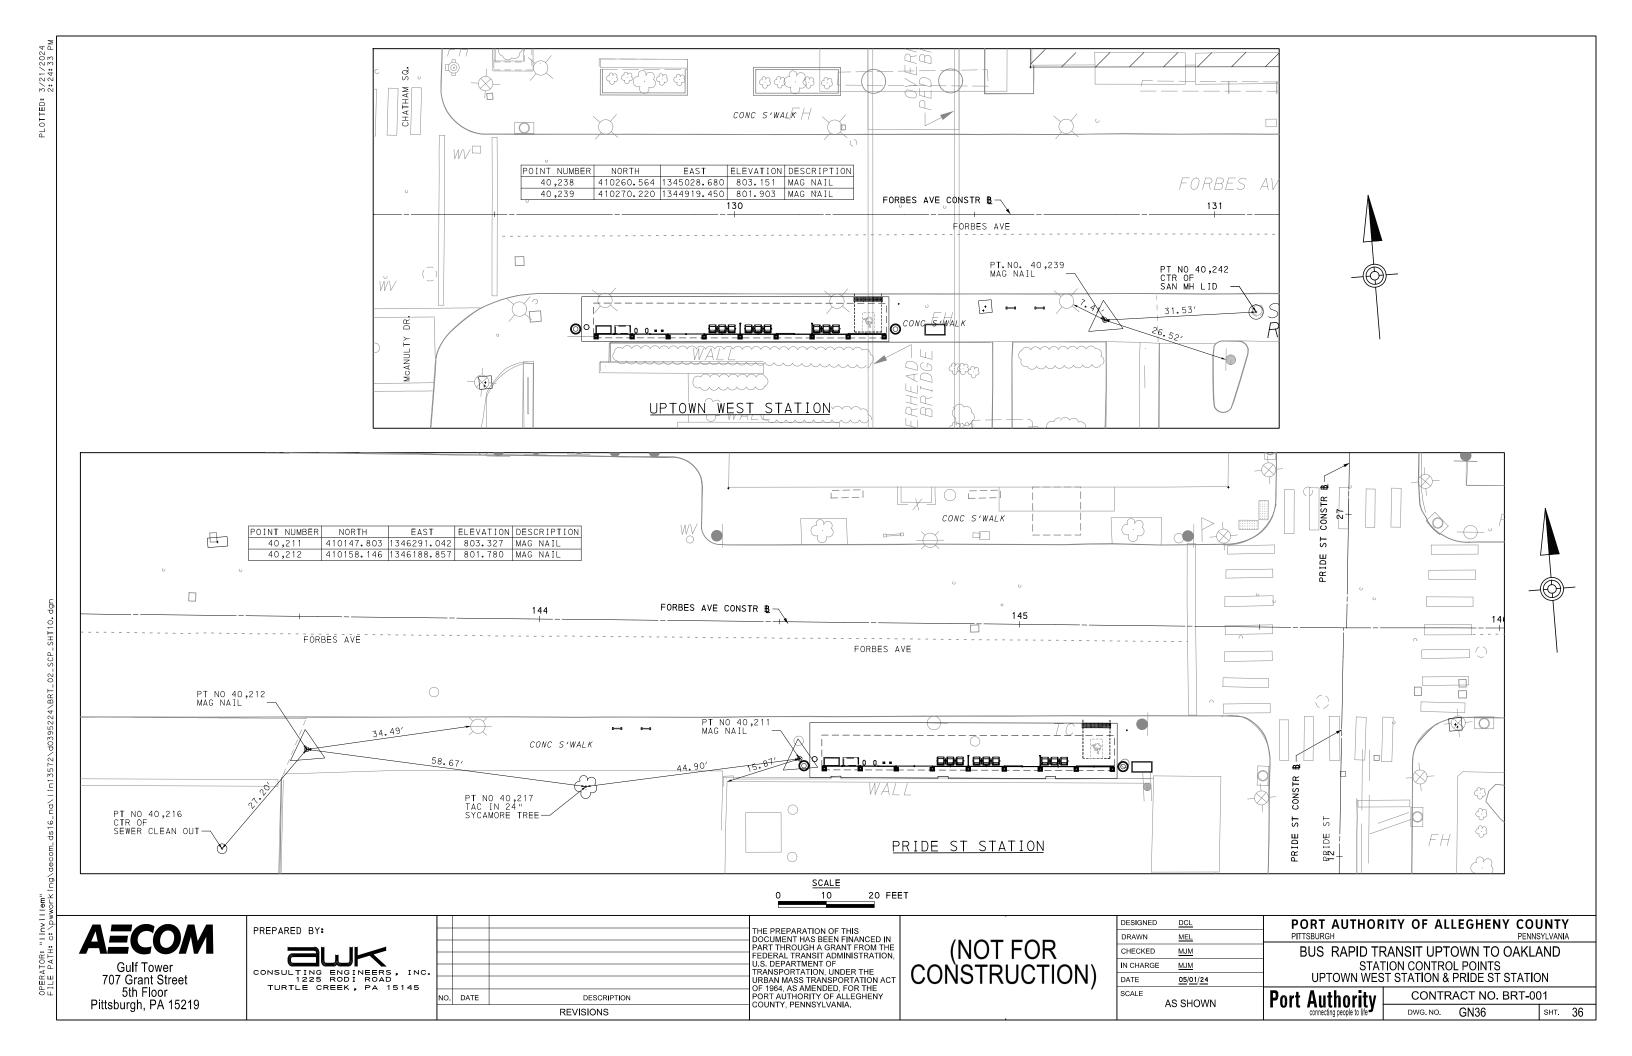



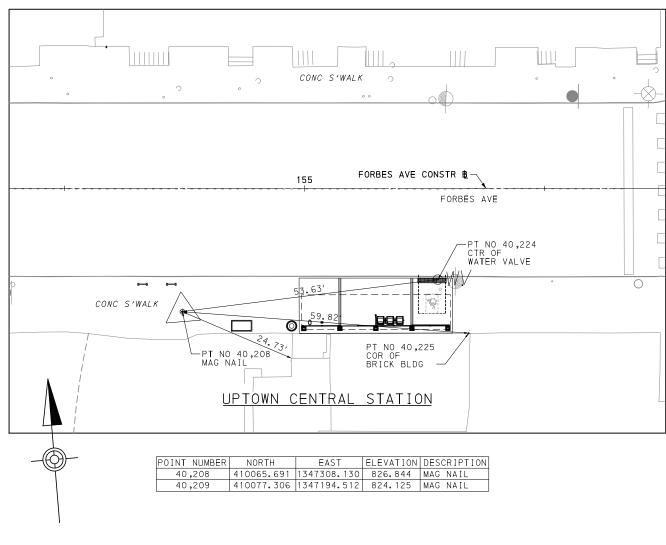

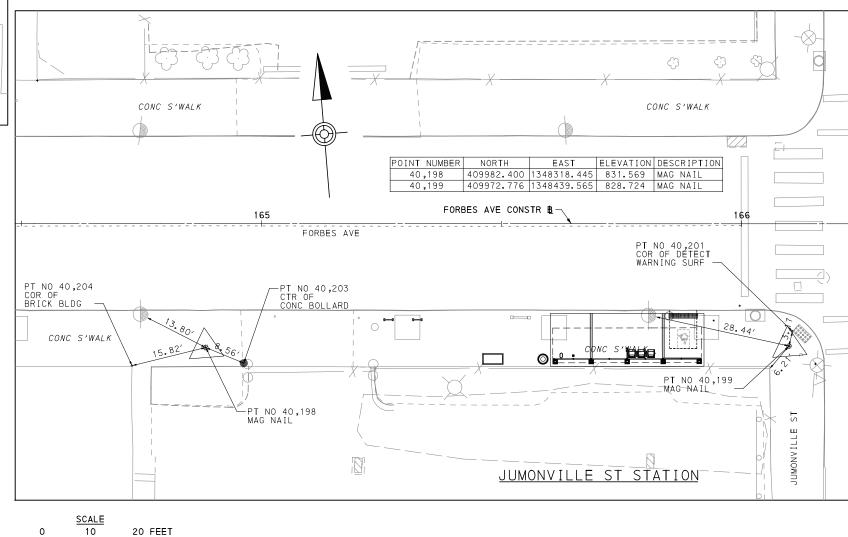

**AECOM** 

Gulf Tower 707 Grant Street 5th Floor Pittsburgh, PA 15219 CONSULTING ENGINEERS, INC.
1225 RODI ROAD
TURTLE CREEK, PA 15145

THE PREPARATION OF THIS
DOCUMENT HAS BEEN FINANCED IN
PART THROUGH A GRANT FROM THE
FEDERAL TRANSIT ADMINISTRATION,
U.S. DEPARTMENT OF
TRANSPORTATION, UNDER THE
URBAN MASS TRANSPORTATION ACT
OF 1964, AS AMENDED, FOR THE
PORT AUTHORITY OF ALLEGHENY
COUNTY, PENNSYLVANIA.

BEEN FINANCED IN
A GRANT FROM THE
IT ADMINISTRATION,
IT OF
IN, UNDER THE
ANSPORTATION ACT
NOED, FOR THE
OF ALL FEGIENY

DESIGNED	DCL	
DRAWN	<u>MEL</u>	
CHECKED	<u>MJM</u>	
IN CHARGE	MJM	
DATE	05/01/24	
SCALE	AS SHOWN	

PORT AUTHORITY OF ALLEGHENY COUNTY PENNSYLVANIA
BUS RAPID TRANSIT UPTOWN TO OAKLAND


BUS RAPID TRANSIT UPTOWN TO OAKLAND STATION CONTROL POINTS UPTOWN CENTRAL STATION & JUMONVILLE ST STATION


Port Authority


CONTRACT NO. BRT-001

DWG. NO. GN37 SHT. 37

OPERATOR: "Linvillem" File Dath: 0:\pww.ork.co\u000m 1016 00\

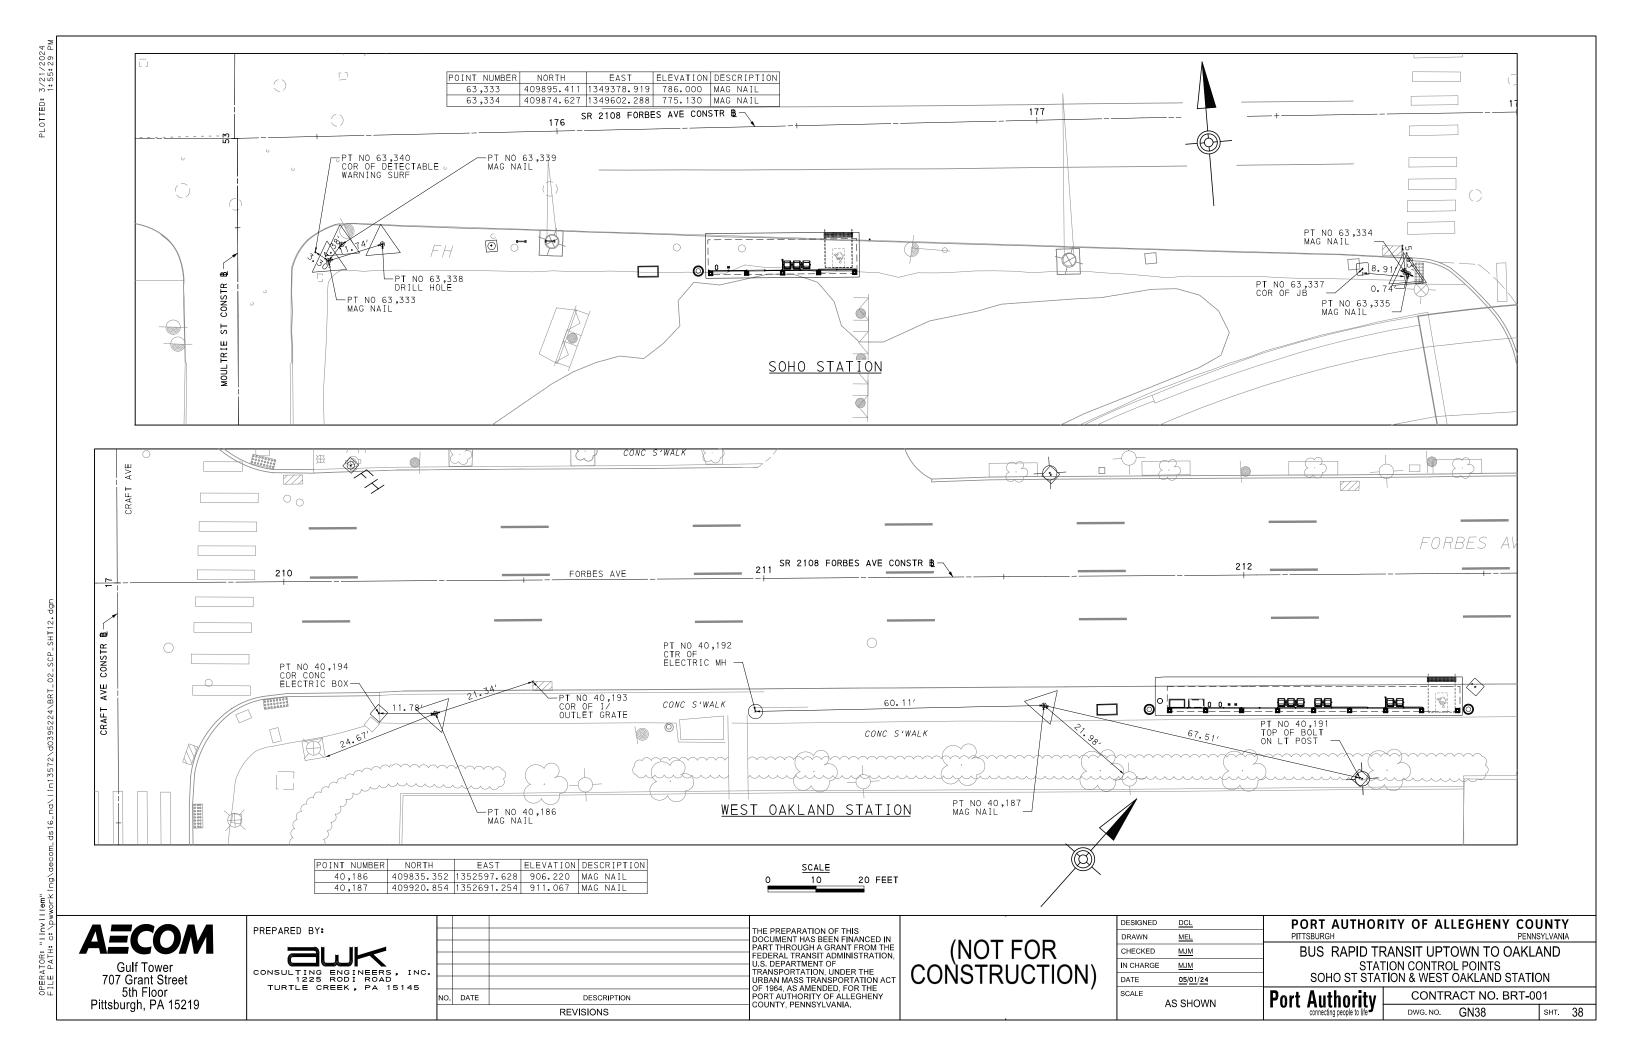

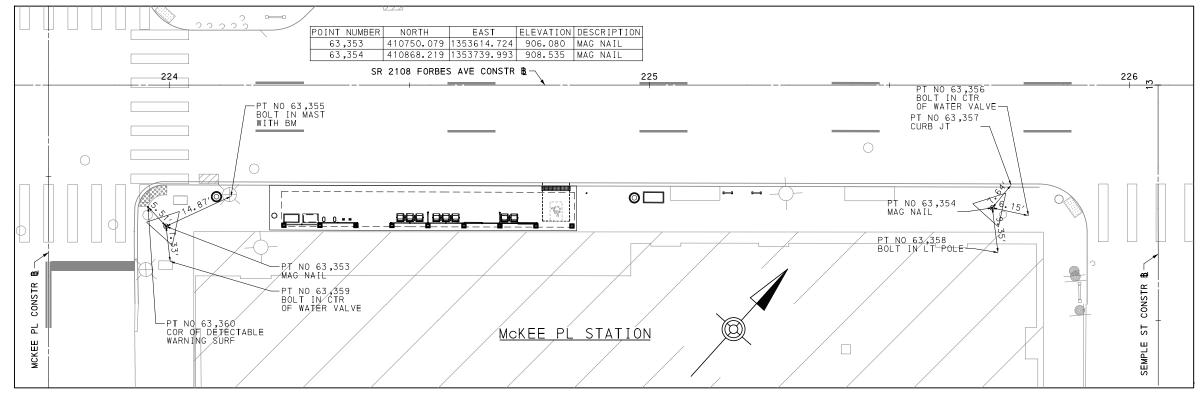

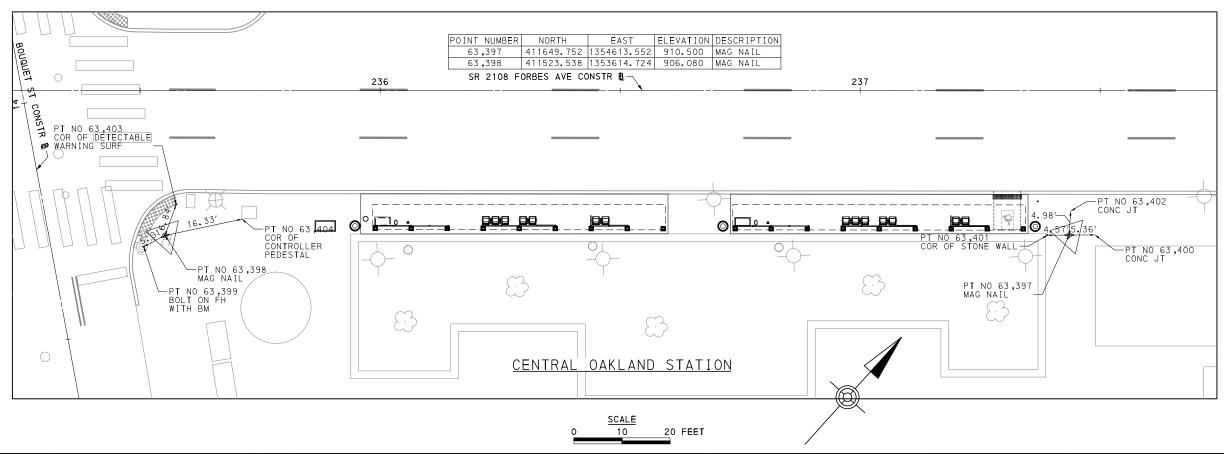

**AECOM** 

Gulf Tower 707 Grant Street 5th Floor Pittsburgh, PA 15219 CONSULTING ENGINEERS, INC.
1225 RODI ROAD
TURTLE CREEK, PA 15145
NO. DATE

THE PREPARATION OF THIS
DOCUMENT HAS BEEN FINANCED IN
PART THROUGH A GRANT FROM THE
FEDERAL TRANSIT ADMINISTRATION,
U.S. DEPARTMENT OF
TRANSPORTATION, UNDER THE
URBAN MASS TRANSPORTATION ACT
OF 1964, AS AMENDED, FOR THE
PORT AUTHORITY OF ALLEGHENY
COUNTY, PENNSYLVANIA.

(NOT FOR CONSTRUCTION)

DESIGNED	DCL	
DRAWN	MEL	
CHECKED	MJM	
IN CHARGE	МЈМ	
DATE	<u>05/01/24</u>	
SCALE		
	AS SHOWN	

PORT AUTHORITY OF ALLEGHENY COUNTY PITTSBURGH PENNSYLVANIA

BUS RAPID TRANSIT UPTOWN TO OAKLAND STATION CONTROL POINTS MCKEE PLACE STATION & CENTRAL OAKLAND STATION

Port Authority CONTRACT NO. BRT-001

DWG. NO. GN39 SHT. 39

SCALE

POINT NUMBER NORTH EAST ELEVATION DESCRIPTION 40,177 411963.786 1355407.411 898.124 MAG NAIL PLOTTED: 411994.232 1355509.608 896.707 MAG NAIL CONC S'WALK CONC S'WALK 6666666 48 BI GEL SR 2108 FORBES AVE CONSTR B -245 246 FORBES AVE 82. 34 -PT NO 40,181 MAG NAIL 0 BIGELOW PT NO 40,178 MAG NAIL -PT NO 40,177 MAG NAIL PT NO 40,180 MAG NAIL CONC S'WALK / P CONC S'WALK --PT NO 40,182 MAG NAIL PT NO 40,183 MAG NAIL PT NO 40,179 CTR OF ELECTRIC MH — ☆ ☆ ☆ ● 승유한 승유승 BIGELOW BLVD STATION 유유유 20 FEET DESIGNED PORT AUTHORITY OF ALLEGHENY COUNTY DCL THE PREPARATION OF THIS
DOCUMENT HAS BEEN FINANCED IN
PART THROUGH A GRANT FROM THE
FEDERAL TRANSIT ADMINISTRATION, **AECOM** PREPARED BY: DRAWN MEL (NOT FOR CONSTRUCTION) CHECKED BUS RAPID TRANSIT UPTOWN TO OAKLAND MJM PEDERAL TRANSIT ADMINISTRATION,
U.S. DEPARTMENT OF
TRANSPORTATION, UNDER THE
URBAN MASS TRANSPORTATION ACT
OF 1964, AS AMENDED, FOR THE
PORT AUTHORITY OF ALLEGHENY
COUNTY, PENNSYLVANIA. STATION CONTROL POINTS N CHARGE MJM Gulf Tower CONSULTING ENGINEERS, INC. 1225 RODI ROAD TURTLE CREEK, PA 15145 BIGELOW BLVD STATION 707 Grant Street DATE 05/01/24 5th Floor SCALE CONTRACT NO. BRT-001 **Port Authority** NO. DATE DESCRIPTION Pittsburgh, PA 15219 AS SHOWN

REVISIONS

GN40

sнт. 40

DWG. NO.

# PLOTTED: 3/26/2024

# OPERATOR: "joseph.silich" FILE PATH: c:/pwworking/decom\_ds16\_nd/joseph.silich@aecom.com/d0207700/BRT\_01\_RD\_SUM01.dgn

# SUMMARY OF QUANTITIES

QUANTITY ITEM NO UNIT	DESCRIPTION	QUANTITY ITEM NO UNIT	DESCRIPTION	QUANTITY	ITEM NO UNIT	DESCRIPTION	QUANTITY	ITEM NO UNIT	DESCRIPTION	
\$15,000 01313 .001 PDA	PROJECT SIGNS, AS DIRECTED	\$150,000 01802 .001 PDA	UNFORESEEN WATER POLLUTION CONTROL	4	01883 .002	TEMPORARY MODIFICATION OF EXISTING TRAFFIC SIGNAL	1,211	02212 .009	POLE FOUNDATION DRILLING, LESS THAN 30" DIAMETER	
1 01321 001 LS	PROJECT SCHEDULING	1 01805 .001 LS	MOBILIZATION	237	01900 .001	DESIGN OF CURB RAMPS	798	02212 010 LF	POLE FOUNDATION DRILLING, 30" DIAMETER OR GREATER	
\$240,000 01322 .001 PDA	EARLY COMPLETION INCENTIVE	1 01806 .001	FIELD OFFICE	500	02020 .001	HANDLING AND DISPOSAL OF RESIDUAL WASTE MATERIALS	\$65,000	02216 001 PDA	UNFORESEEN WALL RESTORATION, AS DIRECTED	
\$1,000,000 01706 PDA	MISCELLANEOUS UNFORESEEN CONSTRUCTION	\$1,411,000 01811 •001 PDA	CITY OF PITTSBURGH OFF-DUTY UNIFORMED POLICE OFFICER	\$200,000	02020 .002 PDA	UNFORESEEN HANDLING AND DISPOSAL OF RESIDUAL WASTE MATERIALS	6,109	02218 .001	FOREIGN BORROW EXCAVATION	
\$200,000 01706 .002 PDA	MISCELLANEOUS UNFORESEEN REPAIRS	1 01860 .001 LS	CONSTRUCTION NOISE AND VIBRATION CONTROL	1	02030 .001 LS	HAZARDOUS MATERIAL INVESTIGATION, SAMPLING AND REPORTING	\$160,000	.02220 .001 PDA	MISCELLANEOUS UNFORESEEN DEMOLITION	
\$50,000 01706 .003 PDA	MISCELLANEOUS UNFORESEEN SPARE PARTS	\$40,000 01870 .001 PDA	UNFORESEEN ARCHAEOLOGIC DISCOVERY HANDLING	278	02030 .002 EA	ASBESTOS BULK SAMPLE ANALYSIS	4,998	02220 .002 LFR	REMOVAL OF TROLLEY TRACKS	
\$500,000 01720 .001 PDA	UNFORESEEN PRIVATE SERVICE LINE CONSTRUCTION - WATER, AS DIRECTED	1 01881 .001 LS	MAINTENANCE AND PROTECTION OF TRAFFIC DURING CONSTRUCTION	93	02030 .003 EA	LEAD PAINT CHIP ANALYSIS	\$150,000	02220 .003 PDA	UNFORESEEN REMOVAL OF TROLLEY TRACKS	
\$500,000 01720 .002 PDA	UNFORESEEN PRIVATE SERVICE LINE CONSTRUCTION - SANITARY, AS DIRECTED	1,796 01881 .002 LF	4" STANDARD PAVEMENT MARKINGS, PAINT & BEADS, YELLOW	\$25,000	02030 .004 PDA	MISCELLANEOUS UNFORESEEN HAZARDOUS MATERIAL SURVEY, SAMPLING AND ANALYSIS	1	02220 .004 LS	REMOVAL AND BACKFILL OF EXISTING CANTILEVER SIGN STRUCTURE	
\$500,000 01720 .003 PDA	UNFORESEEN PRIVATE SERVICE LINE CONSTRUCTION - GAS, AS DIRECTED	39,555 01881 .003 LF	4" STANDARD PAVEMENT MARKINGS, PAINT & BEADS, WHITE	\$100,000	02030 005 PDA	MISCELLANEOUS UNFORESEEN HAZARDOUS MATERIAL ABATEMENT	1	02231 001 LS	CLEARING AND GRUBBING	
\$500,000 01720 .004 PDA	UNFORESEEN PRIVATE SERVICE LINE CONSTRUCTION - ELECTRIC, AS DIRECTED	1,207 01881 .004 LF	6" STANDARD PAVEMENT MARKINGS, PAINT & BEADS, WHITE	8	02085 .001 EA	PWSA 6" GATE VALVE	\$400,000	02317 .001 PDA	REMOVE OR BACKFILL OF UNFORESEEN UTILITY FACILIITIES	
\$200,000 01721 .001 PDA	MISCELLANEOUS UNFORESEEN PWSA LEAD WATERLINE CONSTRUCTION	944 01881 • 005 LF	8" STANDARD PAVEMENT MARKINGS, PAINT & BEADS, WHITE	1	02085 •002 EA	PWSA 4" GATE VALVE	738	02317 .002 LF	PWSA REMOVE AND SEAL ABANDONED UTILITY PIPES (12"-24")	
1 01784 .001 LS	MAINTENANCE AND PROTECTION OF PEDESTRIAN AND BICYCLE TRAFFIC	744 01881 .006 LF	24" STANDARD PAVEMENT MARKINGS, PAINT & BEADS, WHITE	7	02085 .003 EA	PWSA RELOCATE EXISTING VALVE	343	02317 .003 LF	PWSA REMOVE ABANDONED UTILITY DUCTS	
7,208 0178 <sup>4</sup> .002 LF	CONSTRUCTION FENCE, CHAIN LINK MESH ON PORTABLE SUPPORT	11 01881 .007 EA	WHITE WATERBORNE LEGEND, "LEFT ARROW" 12-0" X 3'-0"	6	02085 .004 EA	PWSA REPLACE EXISTING VALVE	831	02317 .04 LF	PWSA GI REMOVE AND SEAL ABANDONED UTILITY PIPES (12"-24")	
30,832 0178 <sup>2</sup> .003	RESET CONSTRUCTION FENCE	10 01881 .008 EA	WHITE WATERBORNE LEGEND, "RIGHT ARROW" 12-0" X 3'-0"	5	02086 .001 EA	PWSA FIRE HYDRANT	543	02317 .05 LF	PWSA GI REMOVE ABANDONED CONCRETE UTILITY DUCTS	
15 01786 .001	CITY OF PITTSBURGH SURVEY MONUMENT	5 01881 • 009 EA	WHITE WATERBORNE LEGEND, *ONLY", 8'-0*	11	02086 .002 EA	PWSA RESET FIRE HYDRANT	353	02320 .001 CY	AASHTO NO. 57 COARSE AGGREGATE	
1 01791 .001 LS	REMOVE, STORE, AND RESET EXISTING COMPONENTS	12 01881 •010 EA	WHITE WATERBORNE LEGEND, *THRU AND RIGHT ARROW", 20'-0" X 3'-7*	5	02086 .003 EA	PWSA FIRE HYDRANT REMOVAL	168	02320 .002 CY	PENNDOT NO. 2A AGGREGATE	
01795 .001 LF	TEMPORARY CONCRETE BARRIER	9 01881 .011 EA	WHITE WATERBORNE LEGEND, *THRU AND LEFT ARROW", 20'-0" X 3'-7*	\$200,000	02212 .001 PDA	UNFORESEEN EXPLORATORY INVESTIGATIONS, AS-DIRECTED	67	02320 .006 CY	PENNDOT TYPE D FLOWABLE BACKFILL	
27 01795 .002 EA	TEMPORARY END TRANSITION	4,205 01881 .012 DAY	ADDITIONAL TYPE B LIGHTS	1	02212 .02 EA	PWSA GI EXPLORATORY EXCAVATION AND BACKFILL (POTHOLING)	187	02341 .001 CY	SUBGRADE UNDERCUT, AS SPECIFIED	
20 01795 .003	TEMPORARY IMPACT ATTENUATING DEVICE	20,640 01881 .013 DAY	ADDITIONAL TYPE C LIGHTS	3	02212 .003 EA	VAULT EXPLORATION	122	02341 .002 CY	SUBGRADE UNDERCUT, AS DIRECTED	
23,101 01795 .004 LF		1,000 01881 .014 SF	ADDITIONAL TRAFFIC CONTROL SIGNS	38	02212 •004 CY	PWSA EXPLORATORY INVESTIGATIONS, WATER LINE LOCATION	30,019	02353 .001 LF	GEOTEXTILE, CLASS I	
69 01795 .005		\$100,000 01881 .015 PDA	MISCELLANEOUS UNFORESEEN MAINTENANCE AND PROTECTION OF TRAFFIC	1	02212 •005 EA	EXPLORATORY INVESTIGATIONS, CUT-IN-WYE A24-1A	9,358	02353 .002 SY	GEOTEXTILE, CLASS 4, TYPE A	
26 01795 .006 EA		8 01882 .001 EA	TEMPORARY TRAFFIC SIGNAL TIMING MODIFICATIONS	20	02212 .006 EA	EXPLORATORY INVESTIGATIONS, OFFSET POLE FOUNDATION	2,009	02353 .003 SY	GEOTEXTILE, CLASS 4, TYPE C	
\$330,000 01796 .001 PDA		71 01882 •002 EA	TRAFFIC SIGNAL TIMING MODIFICATIONS	1	02212 .007 LS	EXPLORATORY INVESTIGATIONS, KIRKPATRICK PARKING LOT	292	02513 .001 LF	PWSA 6" DUCTILE IRON PIPE	
1 01800 .001 LS	EROSION AND SEDIMENTATION CONTROL	3 01883 .001 EA	TEMPORARY TRAFFIC SIGNAL	10	02212 .008 EA	VAULT SLAB THICKNESS EXPLORATORY DRILLING	103	02513 .002 LF	PWSA 8" DUCTILE IRON PIPE	
. ∀ r o	1 OF 5									

Gulf Tower
707 Grant Street
5th Floor
Pittsburgh, PA 15219

		THE PREPARATION OF THIS DOCUMENT HAS BEEN FINANCED
		PART THROUGH A GRANT FROM
		FEDERAL TRANSIT ADMINISTRATI
		TRANSPORTATION, UNDER THE
		URBAN MASS TRANSPORTATION . OF 1964. AS AMENDED, FOR THE
DATE	DESCRIPTION	PORT AUTHORITY OF ALLEGHENY COUNTY, PENNSYLVANIA.
	REVISIONS	COUNTY, FEMINSTEVANIA.

ESIGNED	<u>SDS</u>	PORT AUTHOR	RITY OF ALLEGHENY COUNTY									
RAWN	<u>JMS</u>	PITTSBURGH	PENNSYLVANIA									
HECKED	MES	BUS RAPID TE	RANSIT UPTOWN TO OAKLAND									
CHARGE	LAR	SUMMARY OF QUANTITIES										
ATE	05/01/24	3010	MINIART OF QUANTITIES									
CALE	AS SHOWN	Port Authority	CONTRACT NO. BRT-001									
	AS SHOWN	connecting people to life	DWG. NO. GN41 SHT. 4	11								

# PLOTTED: 3/26/2024

# DPERATOR: "joseph.silich" FILE PATH: c:\pwworking\decom\_ds16\_na\joseph.silich@aecom.com\d0207700\BRT\_01\_RD\_SUMO2.dg

# SUMMARY OF QUANTITIES

	QUANTITY	ITEM NO UNIT	DESCRIPTION	QUANTITY	ITEM NO UNIT	DESCRIPTION	QUANTITY	ITEM NO UNIT	DESCRIPTION	QUANTIT	Y ITEM NO UNIT	DESCRIPTION
	51	02513 .004 LF	PWSA 15" DUCTILE IRON PIPE	\$400,000	02532 .009 PDA	MISCELLANEOUS UNFORESEEN ASPHALT BASE PAVEMENT	135	02630 0.01 LF	PWSA GI 8" DIAMETER SDR-35 PVC PIPE	6	02633 .007 EA	PWSA DOGHOUSE MANHOLE, WITH MANHOLE FRAME AND COVER
	45	02513 .005	PWSA 20" DUCTILE IRON PIPE		02550 .001 SY	MILLING OF ASPHALT PAVEMENT SURFACE, 1 1/2" DEPTH	404	02630 .02 LF	PWSA GI 8" DIAMETER HDPE PERFORATED PIPE	13	02633 .008 EA	PWSA 4' DIAMETER PWSA MANHOLE, WITH MANHOLE FRAME AND COVER
	11,700	02513 .006 LB	PWSA DUCTILE IRON WATER MAIN FITTINGS		02550 •002 SY	MILLING OF ASPHALT PAVEMENT SURFACE, 2" DEPTH	103	02630 0.03 LF	PWSA GI 10" DIAMETER HDPE SOLID PIPE	2	02633 .009	PWSA MANHOLE SA-10C, WITH MANHOLE FRAME AND COVER
	10	02513 .007	PWSA TEE AND VALVE INSTALLATION		02550 •003 SY	MILLING OF ASPHALT PAVEMENT SURFACE, 3 1/2" DEPTH	263	02630 0.04 LF	PWSA GI 12" DIAMETER HDPE SOLID PIPE	12	02633 .010	PWSA CORE HOLE IN EXISTING DRAINAGE STRUCTURE
	2	02513 .011 EA	PWSA 8" CAP		02550 •004 SY	MILLING OF ASPHALT PAVEMENT SURFACE, VARIABLE DEPTH	19	02630 .05 EA	PWSA GI PVC CLEANOUTS	63	02633 .011 EA	PWSA CONCRETE COLLAR FOR PIPE CONNECTION
	1	02513 .012 EA	PWSA 12" CAP	\$120,000 _	02550 .005 PDA	MISCELLANEOUS UNFORESEEN MILLING OF ASPHALT PAVEMENT SURFACE	27	02630 .06 LF	PWSA GI 8" DIAMETER DUCTILE IRON PIPE	45	02633 .012 EA	PWSA CLEANING DRAINAGE STRUCTURES
	2	02513 .013 EA	PWSA 20" CAP	3,410	02555 .001 SY	MILLING OF CEMENT CONCRETE PAVEMENT SURFACE, 2"	12	02630 .07 EA	PWSA GI GEOMEMBRANE PIPE PENETRATION (BOOT SEAL)	1,885	02633 .013 LF	PWSA CLEANING DRAINAGE PIPE
	40	02513 .016 CY	PWSA CONCRETE ANCHOR AND THRUST BLOCK	\$200,000	02555 .002 PDA	MISCELLANEOUS UNFORESEEN MILLING OF CEMENT CONCRETE PAVEMENT SURFACE	20	02630 .08 EA	PWSA GI HDPE ANTI-SEEP COLLAR	87	02633 .014 EA	PWSA DRAINAGE STRUCTURE REMOVAL
	58	02513 .025 LF	PWSA 8" WATERLINE ABANDONMENT		02610 .001 LF	6" PVC PIPE, SDR 26	3	02630 .09 EA	PWSA GI CATCH BASIN, TYPE 13, WITH 3-FLANGE CAST IRON FRAME AND BICYCLE SAFE GRATE	\$200,00	02633 .017 PDA	PWSA UNFORESEEN SEWER REPAIRS
	15	02513 .026 LF	PWSA 20" WATERLINE ABANDONMENT		02610 •002 LF	3" PVC PIPE, SDR 26	1	02630 .10 EA	PWSA GI CATCH BASIN, TYPE 13 MODIFIED	1	02633 •018 EA	PWSA CATCH BASIN, PWSA, TYPE 13, WITH 4-FLANGE CAST IRON FRAME AND BICYCLE SAFE GRATE
	\$150,000	02513 .027 PDA	PWSA MISCELLANEOUS UNFORESEEN WATERLINE PIPING		02610 .003 LF	4" PVC PIPE, SDR 26	1	02630 • 12 EA	PWSA GI GREEN INFRASTRUCTURE (GI) CONTROL STRUCTURE, PWSA TYPE 5 CATCH BASIN WITH WEIR	6	02633 •019 EA	PWSA RECESSED CATCH BASIN CONVERSION
	7	02515 .002 EA	PWSA 1.25" TO 2" WATER SERVICE CONNECTION		02610 .004 EA	SEWER TAP TO EXISTING SEWER WYE	2	02630 .13 EA	PWSA GI 24" DIAMETER PVC CATCH BASIN WITH SOLID LID	2	02633 .020 EA	PWSA CATCH BASIN, PWSA, TYPE 13 REVERSE MODIFIED, WITH 3-FLANGE CAST IRON FRAME AND BICYCLE SAFE GRATE
	578	02521 .001 SY	SUBBASE 8" DEPTH (NO. 2A)		02610 .005 EA	CUT-IN WYE PIPE TRANSITION	18	02630 • 14 EA	PWSA GI PIPE TRASH GUARD	7	02633 .21	PWSA GI CATCH BASIN / INLET TIE-IN
DIMUZ.	33,566	02521 .002 SY	SUBBASE 6" DEPTH (NO. 2A)		02610 .006 LF	PWSA 15" PVC PIPE, SDR 26	13	02630 • 15 EA	PWSA GI INLET DEFLECTION PAN (24" X 26")	3	02633 •22 EA	PWSA GI TIE-IN / CONNECTION TO EXISTING MANHOLE
 	5,152	02521 .003 SY	SUBBASE 4" DEPTH (NO. 2A)		02610 .007 LF	PWSA 15" DUCTILE IRON PIPE	6	02630 .16 EA	PWSA GI 2' X 2' PRECAST CONCRETE INLET	3,802	02635 .001 LF	PWSA SIDEWALK TRENCH DRAIN WITH ADA COMPLIANT BICYCLE SAFE GRATE
7,8K1_0	2,805	02521 .004 CY	SUBBASE (NO. 2A)		02610 .008 LF	PWSA 6" PVC PIPE, SDR 26	12	02630 • 17 EA	PWSA GI GREEN INFRASTRUCTURE (GI) CONTROL STRUCTURE, TYPE 13 CATCH BASIN WITH WEIR	7	02635 • 02 LF	PWSA GI 18" CONCRETE TRENCH DRAIN WITH ADA COMPLIANT BICYCLE SAFE GRATE
1011020	\$150,000	02521 .005 PDA	MISCELLANEOUS UNFORESEEN SUBBASE		02610 .009 LF	PWSA DRAINAGE PIPE REMOVAL	19	02630 .18 EA	PWSA GI CHAMBER SYSTEM INSPECTION PORT	93	02637 .001 EA	PWSA GRADE ADJUSTMENT OF EXISTING PWSA MANHOLE
Compa	58,058	02532 .001 SY	SUPERPAVE ASPHALT MIXTURE DESIGN, WEARING COURSE, PG 64E-22, 10 TO <30 MILLION ESALS, 9.5 MM MIX, 1 1/2" DEPTH, SRL-H	\$300,000	02610 .013 PDA	MISCELLANEOUS UNFORESEEN PIPE CONSTRUCTION	3	02630 .20 EA	PWSA GI JUNCTION BOX WITH WEIR	19	02637 .002 EA	PWSA GRADE ADJUSTMENT OF EXISTING PWSA INLET
T decom	10,307	02532 .003 SY	SUPERPAVE ASPHALT MIXTURE DESIGN, WEARING COURSE, PG 64S-22, < 0.3 MILLION ESALS, 9.5 MM MIX, 2" DEPTH, SRL-H		02610 .014 EA	PWSA CORED WYE OR TEE CONNECTION TO EXISTING SEWER	51	02630 •21 LF	PWSA GI 8" DIAMETER SDR-26 PVC PIPE	526	02637 .003 EA	PWSA GRADE ADJUSTMENT OF EXISTING PWSA VALVE
	501	02532 .004 SY	SUPERPAVE ASPHALT MIXTURE DESIGN, BINDER COURSE, PG 64E-22, 10 TO <30 MILLION ESALS, 19.0 MM MIX, 2" DEPTH		02610 .015 EA	PWSA CUT-IN WYE OR TEE PIPE TRANSITION	425	02630 • 22 LF	PWSA GI 8" DIAMETER HDPE SOLID PIPE	175	02639 .001 VF	PWSA REBUILT MANHOLE
ides.	392	02532 .005 SY	SUPERPAVE ASPHALT MIXTURE DESIGN, BASE COURSE, PG 64S-22, < 0.3 MILLION ESALS, 25.0 MM MIX, 4 1/2" DEPTH		02615 .001 LF	PWSA TRENCH RESTORATION (PIPE INSTALLATION)	14	02630 .23 LF	PWSA GI 15" DIAMETER PVC SOLID PIPE	125	02639 • 002 VF	PWSA REBUILT INLET BOX
	5,152	02532 .006 SY	SUPERPAVE ASPHALT MIXTURE DESIGN, BASE COURSE, PG 64S-22, < 0.3 MILLION ESALS, 25.0 MM MIX, 4" DEPTH	1 20	02615 .002 LF	TRENCH RESTORATION (PIPE INSTALLATION)	19	02633 001 EA	PWSA CATCH BASIN, PWSA TYPE 13 MODIFIED, WITH 3-FLANGE CAST IRON FRAME AND BICYCLE SAFE GRATE	1	02639 .003 EA	PWSA REBUILT INLET BOX WITH MANHOLE TOP
	10,275	02532 .007 TON	SUPERPAVE ASPHALT MIXTURE DESIGN, BINDER COURSE (LEVELING), PG 64E-22, 10 TO < 30 MILLION ESALS, 19.0 MM MIX		02620 .001 LF	THROUGH CURB RAIN LEADER	74	02633 002 EA	PWSA CATCH BASIN, PWSA, TYPE 13, WITH 3-FLANGE CAST IRON FRAME AND BICYCLE SAFE GRATE	1	02640 .001	STORMWATER MANAGEMENT SYSTEM FOR KIRKPATRICK PARKING LOT
) g v decc	\$450,000	02532 .008 PDA	MISCELLANEOUS UNFORESEEN ASPHALT WEARING PAVEMENT		02627 .001 LF	4" PAVEMENT BASE DRAIN	2	02633 005 EA	PWSA STORM INLET, PWSA, TYPE 13, WITH 3-FLANGE CAST IRON FRAME AND BICYCLE SAFE GRATE	116,696	02741	ASPHALT TACK COAT
						2 (	)F 5					

# Gulf Tower 707 Grant Street 5th Floor Pittsburgh, PA 15219

			THE PREPARATION OF THIS DOCUMENT HAS BEEN FINANCED I
			PART THROUGH A GRANT FROM T
			FEDERAL TRANSIT ADMINISTRATION OF
			TRANSPORTATION, UNDER THE
			URBAN MASS TRANSPORTATION A OF 1964. AS AMENDED. FOR THE
٥.	DATE	DESCRIPTION	PORT AUTHORITY OF ALLEGHENY COUNTY, PENNSYLVANIA.
		REVISIONS	COUNTY, PENNSTEVANIA.

DESIGNED	<u>SDS</u>	PORT AUTHOR	ITY OF AL	LEGHENY CO	TAUC	1				
DRAWN	<u>JMS</u>	PITTSBURGH		PEN	NNSYLVANI	A				
CHECKED	MES	BUS RAPID TRANSIT UPTOWN TO OAKLAND SUMMARY OF QUANTITIES								
IN CHARGE	LAR									
DATE	05/01/24	SUIV	IIVIAN OI QU	JANTITIES						
SCALE	S SHOWN	Port Authority	CONTR	RACT NO. BRT-	001					
,	S SHOWN	connecting people to life	DWG. NO.	GN42	SHT.	42				

# SUMMARY OF QUANTITIES

\ I												
32.	QUANTITY	ITEM NO UNIT	DESCRIPTION	QUANTITY	ITEM NO UNIT	DESCRIPTION	QUANTITY	ITEM NO UNIT	DESCRIPTION	QUANTITY	ITEM NO UNIT	DESCRIPTION
	7,824	02750 .001 SY	REINFORCED CEMENT CONCRETE BASE COURSE, 10" DEPTH	1	02761 .019 EA	WHITE HOT THERMOPLASTIC LEGEND, *BIKE LANE REDUCTION TRANSITION ARROW * RIGHT LANE *, 9*-0* X 2*-9*	59	02763 .006 LF	24" WHITE EPOXY PAVEMENT MARKINGS	\$180,000	02785 .002 PDA	MISCELLANEOUS UNFORESEEN CONCRETE SIDEWALK
	2,498	02750 .002 SY	REINFORCED ACCELERATED CONCRETE PAVEMENT, 8" DEPTH	37	02761 .020 EA	WHITE HOT THERMOPLASTIC LEGEND "CHEVRON"	2	02763 .008 EA	WHITE EPOXY LEGEND "BUS", 8'-0"	1,347	02786 .002 SY	EXPOSED AGGREGATE CONCRETE SIDEWALK, BROWN
	228	02750 .003 SY	PLAIN CEMENT CONCRETE PAVEMENT, 4" DEPTH	1	02761 .021 EA	WHITE HOT THERMOPLASTIC LEGEND "BICYCLE DETECTOR SYMBOL"	2	02763 .009 EA	WHITE EPOXY LEGEND "ONLY" 8'-0"	113	02786 .004 CY	EXPOSED AGGREGATE CONCRETE, BROWN
	216	02750 .06 CY	PWSA GI CONCRETE PAVING BASE (ALL CLASSES)	2	02761 .022 EA	WHITE HOT THERMOPLASTIC LEGEND, "YIELD TO PEDS"	1	02763 •012 EA	WHITE EPOXY LEGEND "STRAIGHT ARROW" 12'-0" X 1'-8"	27	02786 .005 SY	ACCELERATED EXPOSED AGGREGATE CONCRETE, BROWN, 8" DEPTH
	\$175,000	02750 .007 PDA	MISCELLANEOUS UNFORESEEN CONCRETE PAVEMENT	115	02761 .023 LF	WHITE HOT THERMOPLASTIC LEGEND, "BIKE LANE YIELD LINE", 12" X 18" TRIANGLE, (MIN 3 TRIANGLES PER LINE)	13	02763 •015 EA	WHITE EPOXY LEGEND "BICYCLE WITH RIDER", 6'-0" X 3'-4"	\$100,000	02786 .006 PDA	MISCELLANEOUS UNFORESEEN EXPOSED AGGREGATE CONCRETE SIDEWALK
	6,041	02755 .001 SY	ACCELERATED CONCRETE PAVEMENT PATCHING, AS DIRECTED	17	02761 .024 LF	WHITE HOT THERMOPLASTIC LEGEND, "YIELD LINE", 24" X 36" TRIANGLE, (MIN 4 TRIANGLES PER LINE)	14	02763 .016 EA	WHITE EPOXY LEGEND "STRAIGHT ARROW", 6'-0" X 1'-4"	76	02788 .001 SY	BRICK SURFACING
	1,931	02757 .001 LF	TRANSVERSE JOINT CLEANING	2	02761 .026 EA	WHITE HOT THERMOPLASTIC LEGNED, "LANE REDUCTION TRANSITION ARROW - RIGHT LANE", 18'-0" x 5'-6"	10	02763 .017 EA	WHITE EPOXY LEGEND "PED SYMBOL", 6'-0" X 3'-4"	53	02788 .002 SY	REMOVE AND RESET BRICK SIDEWALK
	21,158	02761 .001 LF	4" WHITE HOT THERMOPLASTIC PAVEMENT MARKINGS	1,380	02761 .027 LF	6" YELLOW HOT THERMOPLASTIC PAVEMENT MARKINGS	43	02763 .020 EA	WHITE EPOXY LEGEND "CHEVRON"	81	02790 .001 SY	REMOVE, STORE AND RESET INTERLOCKING PAVERS
	11,462	02761 .002 LF	4" YELLOW HOT THERMOPLASTIC PAVEMENT MARKINGS	1,203	02761 .028 LF	12" YELLOW HOT THERMOPLASTIC PAVEMENT MARKINGS	2	02763 .021 EA	WHITE EPOXY LEGEND "BICYCLE DETECTOR SYMBOL"	946	02840 .001 LF	ORNAMENTAL RAILING
	18,041	02761 .003 LF	6" WHITE HOT THERMOPLASTIC PAVEMENT MARKINGS	159,509	02762 .001 SF	RED BUS LANE	\$100,000	02763 .027 PDA	MISCELLANEOUS UNFORESEEN PAVEMENT MARKINGS	1	02889 .001 EA	LED LUMINAIRE CITY STANDARD, GRAY
	14,157	02761 .004 LF	8" WHITE HOT THERMOPLASTIC PAVEMENT MARKINGS	2,149	02762 .002 LF	24" GREEN MMA PAVEMENT MARKINGS	57,470	02764 .001 SF	PAVEMENT MARKING REMOVAL	49	02889 .002 EA	LED LUMINAIRE CITY STANDARD, BLACK
	2,027	02761 .005 LF	12" WHITE HOT THERMOPLASTIC PAVEMENT MARKINGS	3,937	02762 .003 SF	GREEN MMA PAVEMENT MARKING	129	02764 .002 EA	PAVEMENT MARKING LEGEND REMOVAL	21	02890 .001 EA	TRAFFIC SIGNAL CONTROLLER ASSEMBLY, TYPE 2070 LC WITH TYPE 332 BASE MOUNTED CABINET
rgu	13,279	02761 .006 LF	24" WHITE HOT THERMOPLASTIC PAVEMENT MARKINGS	1	02762 .004 EA	4' X 12' BIKE BOX	74	02765 001 EA	FLEXIBLE DELINEATOR POST, SURFACE MOUNT TYPE SM-1, WHITE POST WITH WHITE SHEETING	2	02890 .002 EA	TRAFFIC SIGNAL CONTROLLER ASSEMBLY, TYPE 2070 LC IN EXISTING CABINET
SUMO3.	323	02761 .007 LF	24" YELLOW HOT THERMOPLASTIC PAVEMENT MARKINGS	1	02762 .005 EA	5' X 10' BIKE BOX	65	02765 .002 EA	FLEXIBLE DELINEATOR POST, SURFACE MOUNT TYPE SM-1, YELLOW POST WITH YELLOW SHEETING	26	02890 .003 EA	ETHERNET SWITCH
1-RD_S	60	02761 .008 EA	WHITE HOT THERMOPLASTIC LEGEND "BUS", 8'-0"	1	02762 .006 EA	5' x 12' BIKE BOX	28,147	02781 .001 LF	REINFORCED CEMENT CONCRETE CURB	3	02890 .004 EA	TEMPORARY TRAFFIC SIGNAL CONTROLLER
)\BRT_(	60	02761 .009 EA	WHITE HOT THERMOPLASTIC LEGEND "ONLY", 8'-0"	2	02762 .007 EA	9' X 8' BIKE BOX	1,954	02781 .002 LF	REINFORCED ACCELERATED CONCRETE CURB	28	02890 .005 EA	GPS TIME CLOCK
0207700	49	02761 .010 EA	WHITE HOT THERMOPLASTIC LEGEND "LEFT ARROW", 12'-0" X 3'-0"	1	02762 .008 EA	10' X 16' BIKE BOX	1,604	02781 .003 LF	PLAIN CONCRETE MOUNTABLE CURB, TYPE A	6	02890 .006 EA	TRAFFIC SIGNAL CONTROLLER ASSEMBLY FOUNDATION, FUTURE INSTALLATION OF TYPE 332 BASE MOUNTED CABINET AND 8" RISER
, com\d	93	02761 .011 EA	WHITE HOT THERMOPLASTIC LEGEND "RIGHT ARROW", 12'-0" X 3'-0"	1	02762 .009 EA	10' X 17' BIKE BOX	1,353	02781 .004 LF	CURB CHEEK WALL	1	02890 .007 EA	TUNNEL PREEMPTION CONNECTION
Modecom	7	02761 .012 EA	WHITE HOT THERMOPLASTIC LEGEND "STRAIGHT ARROW", 12'-0" X 1'-8"	1	02762 .010 EA	10' X 12'-6" BIKE BOX	410	02781 •005 LF	REINFORCED CEMENT CONCRETE CURB, 36"	1,610	02891 .001 SF	POST MOUNTED SIGNS, TYPE B
Silicht	4	02761 .013 EA	WHITE HOT THERMOPLASTIC LEGEND "THRU AND RIGHT ARROW", 20'-0" X 3'-7"	1	02762 .011 EA	40' X 5' BIKE BOX	8	02781 .006 EA	CONCRETE CURB STOP	1,364	02891 .003 SF	POST MOUNTED SIGNS, TYPE F
seph.	3	02761 .014 EA	WHITE HOT THERMOPLASTIC LEGEND "THRU AND LEFT ARROW", 20'-0" X 3'-7"	3	02762 .012 EA	8' X 10' BIKE BOX	528	02781 1.07 LF	PWSA GI REINFORCED CONCRETE CURB, 36"	1,824	02891 .007 SF	STRUCTURE MOUNTED FLAT SHEET ALUMINUM SIGNS WITH STIFFENERS
6_na\j.	126	02761 .015 EA	WHITE HOT THERMOPLASTIC LEGEND "BICYCLE WITH RIDER", 6'-0" X 3'-4"	3,674	02763 .001 LF	4" WHITE EPOXY PAVEMENT MARKINGS	\$200,000	02781 .008 PDA	MISCELLANEOUS UNFORESEEN CONCRETE CURB	91	02891 .011 EA	RESET POST MOUNTED SIGNS, TYPE B
om_ds1(	122	02761 .016 EA	WHITE HOT THERMOPLASTIC LEGEND "STRAIGHT ARROW", 6'-0" X 1'-4"	1,183	02763 .002 LF	4" YELLOW EPOXY PAVEMENT MARKINGS	551	02783 .001 SY	CONCRETE BUFFER	93	02891 .013 EA	RESET POST MOUNTED SIGNS, TYPE F
on " ng\aecc	3	02761 .018 EA	WHITE HOT THERMOPLASTIC LEGEND "LANE REDUCTION TRANSITION ARROW - LEFT LANE", 18'-0" X 5'-6"	296	02763 .004 LF	8" WHITE EPOXY PAVEMENT MARKINGS	27,985	02785 .001 SY	REINFORCED CEMENT CONCRETE SIDEWALK, 4" DEPTH	17	02891 .021 EA	RESET STRUCTURE MOUNTED FLAT SHEET ALUMINUM SIGN WITH STIFFENERS
vork ir						3	0F 5					

**AECOM** Gulf Tower 707 Grant Street 5th Floor Pittsburgh, PA 15219

		THE PREPARATION OF THIS  OCUMENT HAS BEEN FINANCED IN	
		PART THROUGH A GRANT FROM THE	
		FEDERAL TRANSIT ADMINISTRATION, U.S. DEPARTMENT OF	
		TRANSPORTATION, UNDER THE	
		URBAN MASS TRANSPORTATION ACT OF 1964. AS AMENDED, FOR THE	
DATE	DESCRIPTION	PORT AUTHORITY OF ALLEGHENY COUNTY, PENNSYLVANIA.	
	REVISIONS	COUNTY, PENNSTEVANIA.	

DESIGNED	SDS	PORT AUTHOR	ITY OF ALLEGHE	NY COUNTY						
DRAWN	<u>JMS</u>	PITTSBURGH		PENNSYLVANIA						
CHECKED	<u>MES</u>	BUS RAPID TRANSIT UPTOWN TO OAKLAND SUMMARY OF QUANTITIES								
IN CHARGE	LAR									
DATE	05/01/24	3010	WANT OF QUANTITIE	.5						
SCALE	AS SHOWN	Port Authority	CONTRACT NO	O. BRT-001						
	ASSIOWN	connecting people to life	DWG. NO. GN43	sнт. <b>43</b>						

# PLOTTED: 3/26/2024

# AATOR: "joseph.silich" E PATH: c:\pwworking\aecom\_ds16\_na\joseph.silich@aecom.com\d0207700\BRT\_01\_RD\_SUM04.dg

# SUMMARY OF QUANTITIES

QUANTITY	ITEM NO UNIT	DESCRIPTION	QUANTITY	ITEM NO UNIT	DESCRIPTION	QUANTITY	ITEM NO UNIT	DESCRIPTION	QUANTITY	ITEM NO UNIT	DESCRIPTION
173	02891 .031 EA	REMOVE POST MOUNTED SIGNS TYPE B	5	02892 .209 EA	TRAFFIC SIGNAL SUPPORT, 34' MAST ARM WITH LUMINAIRE ARM (30' MOUNTING HEIGHT), PAINTED BLACK	3	02893 .003 EA	REMOVE EXISTING MAST ARM	158	02897 .001	CITY OF PITTSBURGH STANDARD CONCRETE JUNCTION BOX, TYPE 1
286	02891 •032 EA	REMOVE POST MOUNTED SIGNS TYPE F	2	02892 .210 EA	TRAFFIC SIGNAL SUPPORT, 36' MAST ARM WITH LUMINAIRE ARM (30' MOUNTING HEIGHT), PAINTED BLACK	23	02893 .004 EA	REMOVE AND REPLACE EXISTING LUMINAIRE	3	02897 .010 EA	REPLACE EXISTING JUNCTION BOX LID
13	02891 •033 EA	REMOVE STRUCTURE MOUNTED FLAT SHEET ALUMINUM SIGN	2	02892 .213 EA	TRAFFIC SIGNAL SUPPORT, 40' MAST ARM WITH LUMINAIRE ARM (30' MOUNTING HEIGHT), PAINTED BLACK	29	02893 .005 EA	REMOVE LUMINAIRE AND ARM	24	02897 .011 EA	CONNECT TO EXISTING JUNCTION BOX
\$25,000	02891 .035 PDA	MISCELLANEOUS UNFORESEEN SIGNAGE	2	02892 .214 EA	TRAFFIC SIGNAL SUPPORT, 46' MAST ARM WITH LUMINAIRE ARM (30' MOUNTING HEIGHT), PAINTED BLACK	1	02893 .006 EA	REMOVE EXISTING POLE AND ENTIRE FOUNDATION	7	02897 .012 EA	REMOVE EXISTING JUNCTION BOX
2	02892 .002 EA	TRAFFIC SIGNAL SUPPORT, 19' TYPE X, PAINTED GRAY	1	02892 .301 EA	TRAFFIC SIGNAL SUPPORT, 20' MAST ARM AND 30' MAST ARM WITH LUMINAIRÉ ARM (30' MOUNTING HEIGHT), PAINTED BLACK	142	02894 • 001 EA	VEHICULAR SIGNAL HEAD, THREE 12" SECTIONS	26,486	02898 .001 LF	TRENCH AND BACKFILL TYPE I
23	02892 .003 EA	TRAFFIC SIGNAL SUPPORT, 15' TYPE X, PAINTED BLACK	1	02892 .302 EA	TRAFFIC SIGNAL SUPPORT, 20' MAST ARM AND 32' MAST ARM WITH LUMINAIRE ARM (30' MOUNTING HEIGHT), PAINTED BLACK	3	02894 .002 EA	VEHICULAR SIGNAL HEAD, FOUR 12" SECTIONS	2,924	02898 .002 LF	TRENCH AND BACKFILL TYPE II
13	02892 .004 EA	TRAFFIC SIGNAL SUPPORT, 19' TYPE X, PAINTED BLACK	1	02892 .400 EA	TRAFFIC SIGNAL SUPPORT, 15' MAST ARM WITH LUMINAIRE ARM (30' MOUNTING HEIGHT), (FOUNDATION ONLY)	1	02894 .003 EA	VEHICULAR SIGNAL HEAD, FIVE 12" SECTIONS	4,831	02898 .005 LF	TRENCH AND BACKFILL TYPE IV
11	02892 .005 EA	TRAFFIC SIGNAL SUPPORT, 30' TYPE X-L WITH LUMINAIRE ARM, PAINTED BLACK	1	02892 .401 EA	TRAFFIC SIGNAL SUPPORT, 44' MAST ARM WITH LUMINAIRE ARM (30' MOUNTING HEIGHT), PAINTED BLACK (POLE ONLY)	23	02894 .004 EA	BICYCLE SIGNAL HEAD, THREE 8" SECTIONS	20,368	02899 .002 LF	2 INCH CONDUIT
1	02892 .006 EA	TRAFFIC SIGNAL SUPPORT, 15' TYPE X, PAINTED BLACK (POLE ONLY)	1	02892 •403 EA	TRAFFIC SIGNAL SUPPORT, 30' MAST ARM, (FOUNDATION ONLY)	186	02894 .005 EA	LED COUNTDOWN PEDESTRIAN SIGNAL HEAD, TYPE A	46,139	02899 003 LF	3 INCH CONDUIT
3	02892 •008 EA	TRAFFIC SIGNAL SUPPORT FOUNDATION, 15' TYPE X, (FOUNDATION ONLY)	15	02892 .501 EA	EXISTING TRAFFIC SIGNAL SUPPORT, PAINTED BLACK	40	02894 .006 EA	VEHICULAR SIGNAL HEAD, THREE 8" SECTIONS	60	02899 004 LF	2 INCH EXPOSED CONDUIT
1	02892 .009 EA	TRAFFIC SIGNAL SUPPORT, 19' TYPE X, PAINTED BLACK (POLE ONLY)	1	02892 .602 EA	TRAFFIC SIGNAL SUPPORT, 20' MAST ARM, PAINTED BLACK	10	02894 .021 EA	RESET VEHICULAR SIGNAL HEAD	30	02899 005 LF	3 INCH EXPOSED CONDUIT
2	02892 .011 EA	TRAFFIC SIGNAL SUPPORT, STRAIN POLE, 2,000 POUNDS DESIGN TENSION, PAINTED BLACK	3	02892 .603 EA	TRAFFIC SIGNAL SUPPORT, 24' MAST ARM, PAINTED BLACK	2	02894 .022 EA	RESET PEDESTRIAN SIGNAL HEAD	12,220	02899 .006 LF	FIBER-OPTIC MICRODUCT
3	02892 .012 EA	TRAFFIC SIGNAL SUPPORT, STRAIN POLE WITH LUMINAIRE ARM (30' MOUNTING HEIGHT), 4,000 POUNDS DESIGN TENSION, PAINTED BLACK	5	02892 .604 EA	TRAFFIC SIGNAL SUPPORT, 28' MAST ARM, PAINTED BLACK	16	02894 .031 EA	REMOVE VEHICULAR SIGNAL HEAD	6	02899 .007 EA	INSTALL CONDUIT TO EXISTING TRAFFIC SIGNAL SUPPORT
1	02892 .020 EA	PEDESTRIAN STUB POLE, TYPE B, PAINTED BLACK	4	02892 .605 EA	TRAFFIC SIGNAL SUPPORT, 34' MAST ARM, PAINTED BLACK	4	02894 .032 EA	REMOVE PEDESTRIAN SIGNAL HEAD	13,973	02900 .001 LF	AWG 8, UNDERGROUND CABLE, COPPER,1 CONDUCTOR
2	02892 .021 EA	PEDESTRIAN STUB POLE, TYPE E, PAINTED BLACK	3	02892 .606 EA	TRAFFIC SIGNAL SUPPORT, 36' MAST ARM, PAINTED BLACK	88	02895 •001 EA	VIDEO DETECTION	22,323	02900 .002 LF	SIGNAL CABLE, 14 AWG, 5 CONDUCTOR
1	02892 .100 EA	TRAFFIC SIGNAL SUPPORT, 40' MAST ARM WITH LUMINAIRE ARM (30' MOUNTING HEIGHT), PAINTED GRAY	2	02892 .607 EA	TRAFFIC SIGNAL SUPPORT, 46' MAST ARM, PAINTED BLACK	180	02895 .002 EA	ACCESSIBLE PEDESTRIAN SIGNALS	23,483	02900 .003	SIGNAL CABLE, 14 AWG, 7 CONDUCTOR
1	02892 .101 EA	TRAFFIC SIGNAL SUPPORT, 15' MAST ARM WITH LUMINAIRE ARM (30' MOUNTING HEIGHT), PAINTED GRAY	1	02892 .608 EA	TRAFFIC SIGNAL SUPPORT, 42' MAST ARM, PAINTED BLACK	2	02895 .003 EA	REMOVE PEDESTRIAN PUSH BUTTON/SIGN	225	02900 .004 LF	AWG 8, ABOVE GROUND CABLE, COPPER, 1 CONDUCTOR
1	02892 .202 EA	TRAFFIC SIGNAL SUPPORT, 20' MAST ARM WITH LUMINAIRE ARM (30' MOUNTING HEIGHT), PAINTED BLACK	1	02892 .609 EA	TRAFFIC SIGNAL SUPPORT, 15' MAST ARM, PAINTED BLACK	1	02895 .004 EA	RESET ACCESSIBLE PEDESTRIAN SIGNALS	\$100,000	02903 .001 PDA	UNFORSEEN CONDUIT CLEANING AND REPAIRS
2	02892 •203 EA	TRAFFIC SIGNAL SUPPORT, 22' MAST ARM WITH LUMINAIRE ARM (30' MOUNTING HEIGHT), PAINTED BLACK	1	02892 .610 EA	TRAFFIC SIGNAL SUPPORT, 26' MAST ARM, PAINTED BLACK	23	02895 .005 EA	DIGITAL WAVE RADAR DETECTION	7	02923 .001 LB	SEEDING
5	02892 •204 EA	TRAFFIC SIGNAL SUPPORT, 24' MAST ARM WITH LUMINAIRE ARM (30' MOUNTING HEIGHT), PAINTED BLACK	2	02892 .611 EA	TRAFFIC SIGNAL SUPPORT, 30' MAST ARM, PAINTED BLACK	7	02896 .002 EA	ELECTRICAL SERVICE, TYPE B	50	02923 .002 CY	PLANTING MIX (FOR LAWN)
3	02892 .205 EA	TRAFFIC SIGNAL SUPPORT, 26' MAST ARM WITH LUMINAIRE ARM (30' MOUNTING HEIGHT), PAINTED BLACK	1	02892 .613 EA	TRAFFIC SIGNAL SUPPORT, 38' MAST ARM, PAINTED BLACK	2	02896 .003 EA	ELECTRICAL SERVICE, TYPE C (EXISTING)	50	02923 .003 CY	TOPSOIL (FOR LAWN)
1	02892 .206 EA	TRAFFIC SIGNAL SUPPORT, 28' MAST ARM WITH LUMINAIRE ARM (30' MOUNTING HEIGHT), PAINTED BLACK	\$200,000	02892 .635 PDA	MISCELLANEOUS UNFORESEEN TRAFFIC SIGNALS, AS DIRECTED	13	02896 .004 EA	ELECTRICAL SERVICE, TYPE C (NEW)	60	02925 .001 CY	FLEXIBLE POROUS PAVEMENT
5	02892 .207 EA	TRAFFIC SIGNAL SUPPORT, 30' MAST ARM WITH LUMINAIRE ARM (30' MOUNTING HEIGHT), PAINTED BLACK	128	02893 .001 EA	REMOVE EXISTING POLE	1	02896 .005 EA	LUMINAIRE SERVICE DISCONNECT	5,069	02925 .002 SF	GEOTEXTILE FILTER FABRIC
4	02892 .208 EA	TRAFFIC SIGNAL SUPPORT, 32' MAST ARM WITH LUMINAIRE ARM (30' MOUNTING HEIGHT), PAINTED BLACK	20	02893 .002 EA	REMOVE AND RELOCATE EXISTING LIGHT POLE	5	02896 .006 EA	UNMETERED ELECTRIC SERVICE FOR STREET LIGHTING	47	02925 .003 CY	#57 (2B) STONE
2					4 (	0F 5					

4 OF 5

# Gulf Tower 707 Grant Street 5th Floor Pittsburgh, PA 15219

			THE PREPARATION OF THIS
			DOCUMENT HAS BEEN FINANCED II
			PART THROUGH A GRANT FROM TH
			FEDERAL TRANSIT ADMINISTRATIO
			TRANSPORTATION, UNDER THE
			URBAN MASS TRANSPORTATION AG OF 1964, AS AMENDED, FOR THE
э.	DATE	DESCRIPTION	PORT AUTHORITY OF ALLEGHENY COUNTY, PENNSYLVANIA.
		REVISIONS	COUNTY, PENNSTEVANIA.

DESIGNED	<u>SDS</u>	PORT AUTHOR	RITY OF ALLEGHENY COUNTY
DRAWN	<u>JMS</u>	PITTSBURGH	PENNSYLVANIA
CHECKED	MES	BUS RAPID TF	RANSIT UPTOWN TO OAKLAND
IN CHARGE	LAR	SIIN	MARY OF QUANTITIES
DATE	<u>05/01/24</u>	JOIN	IMART OF QUARTITIES
SCALE	AS SHOWN	<b>Port Authority</b>	CONTRACT NO. BRT-001
Ļ	O OHOWN	connecting people to life	DWG. NO. GN44 SHT. 44

# SUMMARY OF QUANTITIES

QUANTITY	ITEM NO UNIT	DESCRIPTION	QUANTITY ITEM NO UNIT	DESCRIPTION	QUANTITY	ITEM NO UNIT	DESCRIPTION	QUANTITY	ITEM NO UNIT	DESCRIPTION
298	02930 .001	TREES	263 03305 .001 CY	CLASS A CONCRETE, STATION SLABS	1	16010 .010	BRT STATION - SOHO INBOUND, ELECTRICAL/COMMUNICATIONS INFRASTRUCTURE	10	16536 .003	LED TEARDROP LUMINAIRE TYPE A ON A 25-FOOT FLUTED POLE
6,185	02930 .002 EA	ORNAMENTAL GRASS	52 03305 •002 CY	CLASS AA CONCRETE MODIFIED, VAULT ROOF AND WALL	1	16010 .011 LS	BRT STATION - WEST OAKLAND INBOUND, ELECTRICAL/COMMUNICATIONS INFRASTRUCTURE	33	16536 •004 EA	LED TEARDROP LUMINAIRE TYPE B ON A 30-FOOT FLUTED POLE
308	02930 .003 EA	SHRUBS	100,000 03305 .003 PDA	MISCELLANEOUS UNFORESEEN VAULT MODIFICATIONS, CLASS AA CONCRETE LIGHTWEIGHT, AS DIRECTED	1	16010 •012 LS	BRT STATION - CHESTERFIELD RD INBOUND, ELECTRICAL/COMMUNICATIONS INFRASTRUCTURE	12	16536 •005 EA	LED ACORN LUMINAIRE
1,518	02930 •004 CY	PLANTING MIX	74 03305 •004 SY	CLASS AA CONCRETE LIGHTWEIGHT, VAULT HYDRODEMOLITION AND OVERLAY	1	16010 .013 LS	BRT STATION - ATWOOD INBOUND, COMMUNICATIONS INFRASTRUCTURE	12	16536 •006 EA	12-F00T ORNAMENTAL POLE
849	02930 .005 CY	TOPSOIL	52 03305 .005 CY	CLASS AA CONCRETE LIGHTWEIGHT, VAULT SIDEWALK	1	16010 .014 LS	BRT STATION - BIGELOW BLVD INBOUND, ELECTRICAL/COMMUNICATIONS INFRASTRUCTURE	21	16536 .007 EA	FOUNDATION TYPE A
212	02930 .006 CY	DOUBLE SHREDDED HARDWOOD MULCH	97 03305 • 006 CY	CLASS A CONCRETE, RETAINING WALL	1	16010 .015 LS	BRT STATION - TENNYSON AVE INBOUND, ELECTRICAL/COMMUNICATIONS INFRASTRUCTURE	61	16536 .008 EA	FOUNDATION TYPE B
29	02930 •07 CY	PWSA GI DOUBLE SHREDDED HARDWOOD MULCH	296 04413 001 LF	GRANITE CURB	1	16010 •018 LS	BRT STATION - UPTOWN WEST OUTBOUND, ELECTRICAL/COMMUNICATIONS INFRASTRUCTURE	55,576	16536 • 009 EA	#6 AWG UNDERGROUND CABLE
1,266	02930 .08 EA	PWSA GI ORNAMENTAL GRASSES (3 GAL)	32 04413 .002 LF	RADIUS GRANITE CURB	1	16010 .019 LS	BRT STATION - PRIDE ST OUTBOUND, ELECTRICAL/COMMUNICATIONS INFRASTRUCTURE	\$200,000	16536 .010 EA	MISCELLANEOUS UNFORESEEN STREET LIGHTING CONSTRUCTION
40	02930 .09 CY	PWSA GI TREE PIT PLANTING SOIL	9 05100 .001 EA	REMOVABLE CURB	1	16010 .020 LS	BRT STATION - UPTOWN CENTRAL OUTBOUND, ELECTRICAL/COMMUNICATIONS INFRASTRUCTURE	6	16536 .011 EA	OFFSET POLE FOUNDATION, TYPE A
\$15,000	02930 .010 PDA	MISCELLANEOUS UNFORESEEN LANDSCAPING	05511 1 .001 EA	DLC LADDER	1	16010 .021 LS	BRT STATION - JUMONVILLE ST OUTBOUND, ELECTRICAL/COMMUNICATIONS INFRASTRUCTURE	15	16536 .012 EA	OFFSET POLE FOUNDATION, TYPE B
10	02975 .01 EA	PWSA GI CONCRETE SPLASH PAD	15 08305 .001 EA	SIDEWALK HATCH	1	16010 .022 LS	BRT STATION - SOHO OUTBOUND, ELECTRICAL/COMMUNICATIONS INFRASTRUCTURE	5	16536 .013 EA	POLE FOUNDATION TYPE B, MODIFIED
2	02975 .02 EA	PWSA GI INTEGRATED INLET (FOXHOLE)	2 08305 •002 EA	5 x 9 DLC HATCH	1	16010 .023 LS	BRT STATION - WEST OAKLAND OUTBOUND, ELECTRICAL/COMMUNICATIONS INFRASTRUCTURE	1	16536 •014 EA	TESTING OF ENTIRE STREET LIGHTING SYSTEM
L 1	02975 •03 EA	PWSA GI INTEGRATED INLET (BUNKER)	1 08305 • 003 EA	6 x 12 DLC HATCH	1	16010 .024 LS	BRT STATION - MCKEE PLACE OUTBOUND, ELECTRICAL/COMMUNICATIONS INFRASTRUCTURE	19	17080 .002 EA	LAYER 2 SWITCH
13	02975 •04 EA	PWSA GI CURB CUTS	1 08305 • 004 EA	2'-11" x 3'-4" DLC HATCH	1	16010 •025 LS	BRT STATION - CENTRAL OAKLAND OUTBOUND, ELECTRICAL/COMMUNICATIONS INFRASTRUCTURE	38	17080 .003 EA	SMALL FORM FACTOR PLUGGABLE (SFP) OPTICAL TRANSCEIVER
361	02975 •05 LF	PWSA GI 8" DIAMETER UNDERDRAIN INCLUDING BEDDING AND GEOTEXTILE	1 08305 • 005 EA	3x3 VAULT GRATE	1	16010 •026 LS	BRT STATION - BIGELOW BLVD OUTBOUND, ELECTRICAL/COMMUNICATIONS INFRASTRUCTURE	1	17125 .001 EA	BRT SYSTEMS TESTING, INSPECTION, AND TRAINING
115,000	02975 .06 PDA	PWSA GI MISCELLANEOUS UNFORESEEN PWSA CONSTRUCTION	2 10734 .001 EA	SHELTER SIZE 30' X 5'	1	16010 .102 LS	PITT TOWER COMMUNICATIONS INFRASTRUCTURE	25	17200 .001 EA	PTZ CAMERA
886	02976 .01 SY	PWSA GI IMPERMEABLE GEOMEMBRANE BARRIER	7 10734 • 002 EA	SHELTER SIZE 30' X 7'	150,000	16010 .103 PDA	MISCELLANEOUS UNFORESEEN STATION CONSTRUCTION	10	17300 .001 EA	13" DIGITAL BUS DISPLAY
2,153	02976 •02 SY	PWSA GI NON-WOVEN GEOTEXTILE	3 10734 .003 EA	SHELTER SIZE 60' X 5'	5	16124 .001 EA	BRT STATION - ELECTRICAL/COMMUNICATIONS CABINET, 60 AMP, TYPE 1, LEFT METER	8	17300 •002 EA	32" DIGITAL BUS DISPLAY
1,345	02976 •03 CY	PWSA GI FURNISH AND PLACE AASHTO #57 STONE FOR GI SYSTEMS	6 10734 • 004 EA	SHELTER SIZE 60' X 7'	10	16124 •002 EA	BRT STATION - ELECTRICAL/COMMUNICATIONS CABINET, 60 AMP, TYPE 1, RIGHT METER	15	17400 .001 EA	EMERGENCY BLUE LIGHT PHONE
년 - 484	02976 •04 CY	PWSA GI AGGREGATE TRENCH BACKFILL ABOVE STORMWATER TRENCHES (PENNDOT 2A)	1 10734 .005 EA	SHELTER SIZE 30' X 14' GULLWING SHELTER	2	16124 .003 EA	BRT STATION - ELECTRICAL/COMMUNICATIONS CABINET, 100 AMP, TYPE 2, LEFT METER	1	17400 •004 EA	BLUE LIGHT PHONE SYSTEM INTEGRATION
27	02976 .05 EA	PWSA GI 12" HEAVY DUTY CHAMBER UNIT	1 16010 .006 LS	BRT STATION - UPTOWN WEST INBOUND, ELECTRICAL/COMMUNICATIONS INFRASTRUCTURE	1	16124 .004 EA	BRT STATION - ELECTRICAL/COMMUNICATIONS CABINET, 100 AMP, TYPE 2, RIGHT METER	10	32330 .001 EA	SEATING BENCH WITH TWO (2) SEATS
59	02976 .06 EA	PWSA GI 18" HEAVY DUTY CHAMBER UNIT	1 16010 .007 LS	BRT STATION - PRIDE ST INBOUND, ELECTRICAL/COMMUNICATIONS INFRASTRUCTURE	200,000	16124 .006 PDA	MISCELLANEOUS UNFORESEEN ELECTRICAL CONSTRUCTION	29	32330 .002 EA	SEATING BENCH WITH THREE (3) SEATS
17	02976 .07 EA	PWSA GI 30" HEAVY DUTY CHAMBER UNIT	1 16010 .008 LS	BRT STATION - UPTOWN CENTRAL INBOUND, ELECTRICAL/COMMUNICATIONS INFRASTRUCTURE	8	16536 .001 EA	LED ROADWAY LUMINAIRE TYPE A ON 25-FOOT STEEL POLE	28	32330 .003 EA	TRASH RECEPTACLE
173	02979 .01 CY	PWSA GI ENGINEERED BIORETENTION / BIOSWALE SOIL	1 16010 .009 LS	BRT STATION - JUMONVILLE ST INBOUND, ELECTRICAL/COMMUNICATIONS INFRASTRUCTURE	29	16536 .002 EA	LED ROADWAY LUMINAIRE TYPE B ON A 30-F00T STEEL POLE	23	32330 .004 EA	BIKE RACK
- X				5 (	0F 5					

**AECOM** Gulf Tower 707 Grant Street 5th Floor Pittsburgh, PA 15219

		THE PREPARATION OF THIS DOCUMENT HAS BEEN FINANCED IN PART THROUGH A GRANT FROM THE FEDERAL TRANSIT ADMINISTRATION, U.S. DEPARTMENT OF TRANSPORTATION, UNDER THE URBAN MASS TRANSPORTATION ACT 10F 1964 AS AMENDED, FOR THE
DATE	DESCRIPTION	OF 1964, AS AMENDED, FOR THE PORT AUTHORITY OF ALLEGHENY
•	REVISIONS	COUNTY, PENNSYLVANIA.

SIGNED	SDS	PORT AUTHOR	ITY OF ALLEGHENY	COUNT	/
AWN	<u>JMS</u>	PITTSBURGH	1	PENNSYLVANI	A
ECKED	<u>MES</u>	BUS RAPID TF	RANSIT UPTOWN TO OA	KLAND	
CHARGE	LAR	CLIN	MARY OF QUANTITIES		
TE	<u>05/01/24</u>	SUIV	IMART OF QUANTITIES		
ALE	AS SHOWN	<b>Port Authority</b>	CONTRACT NO. BR	T-001	
	AS SHOWN	connecting people to life	DWG. NO. GN45	SHT.	45

			1		1				1		0		1		1	1						
DESIGN OF CURB RAMPS	FOREIGN BORROW EXCAVATION		GEOTEXTILE CLASS 1	GEOTEXTILE CLASS 4, TYPE A	SUBBASE 8" DEPTH (NO. 2A)	SUBBASE 6" DEPTH (NO. 2A)	SUBBASE 4" DEPTH (NO. 2A)	SUBBASE (NO. 2A) (MATCH ADJACENT SUBBASE DEPTH)			SUPERPAVE ASPHALT MIXTURE DESIGN, MERRING COURSE, PG 64E-22, 10 TO <3 MILLION ESALS, 9.5MM MIX, 1 1/2" DEPTH, SRL-H	SUPERPAVE ASPHALT MIXTURE DESIGN, WEARING COURSE, PG 64S-22, <0.3 MILLION ESALS, 9.5MM MIX, 2"DEPTH. CRI-H	SUPERRAVE ASPHALT MIXTURE DESIGN, BINDER COURSE, PG 64E-22, 10 TO 230 MILLION ESALS, 19.0 MM MIX, 210 DEPTH	SUPERPAVE ASPHALT MIXTURE DESIGN, BASE COURSE, PG 64S-22, <0.3 MILLION ESALS, 25.0MM MIX, 4 1/2" DEPTH	2 SUPERPAVE ASPHALT MIXTURE DESIGN, 5 BASE COURSE, PG 645-22, CO.3 MILLION ESALS, 25.0MM MIX, 4"	SUPERRAVE ASPHALT MIXTURE DESIGN, BINDER COURSE (LEVELING), PG 64E-22, 10 TO <30 MILLION ESALS, 19.0 MM MIX	MILLING OF ASPHALT PAVEMENT SURFACE, 1 1/2" DEPTH	MILLING OF ASPHALT PAVEMENT SURFACE, 2" DEPTH	MILLING OF ASPHALT PAVEMENT SURFACE, 3 1/2" DEPTH	MILLING OF ASPHALT PAVEMENT SURFACE, VARIABLE DEPTH	MILLING OF CEMENT CONCRETE PAVEMENT SURFACE, 2" DEPTH	REMARKS STATION SIDE
01900 .001	02218 .001 CY		02353 .001 LF	02353 .002 SY	02521 .001 SY	02521 .002 SY	02521 .003 SY	02521 .004 CY			02532 .001 SY	02532 .003 SY	02532 .004 SY	02532 .005 SY	02532 .006 SY	02532 .007 TON	02550 .001 SY	02550 .002 SY	02550 .003 SY	02550 .004 SY	02555 .001 SY	NUMBEN UNITED
																						FIFTH AVE - ENTIRE LENGTH
																						AS DIRECTED - ENTIRE LENGTH LT / RT 434+00.00 TO 565+00.00
																						FIFTH AVE - UPTOWN
10	230		1536	149		1826	336	81			3061	336			336	754				3061		DIAMOND ST TO CHATHAM SQ/WASHINGTON PL LT / RT 434+00.00 TO 440+95.00
9	227		1872	958	76	1579	597	196			3282	597			597	906				2735		CHATHAM SQ/WASHINGTON PL TO MAGEE ST/LOGAN ST LT / RT 440+95.00 TO 449+60.00
4	54		706	149		729	161	34			1374	161			161	372				1374		MAGEE ST/LOGAN ST TO STEVENSON ST LT / RT 449+60.00 TO 453+15.00
7	65		810	183		930	174	41			1772	174			174	405				1759		STEVENSON ST TO PRIDE ST LT / RT 453+15.00 TO 457+00.00
7	75		635	123		721	126	28			1108	126			126	273				1108		PRIDE ST TO MARION ST/VINE ST LT / RT 457+00.00 TO 459+95.00
5	115		867	158		1116	204	35			1296	204			204	342				1296		MARION ST/VINE ST TO VAN BRAAM ST LT / RT 459+95.00 TO 463+80.00
4	88		707	141		876	185	32			1175	185			185	301				1175		VAN BRAAM ST TO MILTENBERGER ST LT /RT 463+80.00 TO 467+25.00
6	58		344	62		376	95	14			615	95			95	157				615		MILTENBERGER ST TO DINWIDDIE ST LT / RT 467+25.00 TO 468+90.00
6	91		761	184		904	194	41			1275	194			194	340				1275		DINWIDDIE ST TO GIST ST LT / RT 468+90.00 TO 472+65.00
5	159		1071	255		1479	255	57			1767	255			255	453				1767		GIST ST TO JUMONVILLE ST/WYANDOTTE ST LT / RT 472+65.00 TO 478+05.00
5	185		1045	209		1307	228	47			1388	228			228	333				1388		JUMONVILLE ST/WYANDOTTE ST TO SENECA ST LT / RT 478+05.00 TO 482+55.00
6	142		893	269		1066	224	60			1558	224			224	387				1559		SENECA ST TO MOULTRIE ST LT / RT 482+55.00 TO 487+05.00
5	294		1106	739	502	1393	492	53			2588	492	501		492	415			795	1292		MOULTRIE TO KIRKPATRICK ST/BIRMINGHAM BR LT / RT 487+05.00 TO 492+00.00
4	732		3652	749		4791		167			6316			392		345	1113			4812		KIRKPATRICK ST/BIRMINGHAM BR TO BLVD OF THE LT / RT 492+00.00 TO 510+50.00
5 4																						
83	2515		16005	4328	 578	19093	3271	886			28575	3271	501	392	3271	5783	1113	0	795	25216	0	SUBTOTALS - FIFTH AVE - UPTOWN

1A OF 4C

**AECOM** Gulf Tower 707 Grant Street 5th Floor Pittsburgh, PA 15219

		THE PREPARATION OF THIS DOCUMENT HAS BEEN FINANCED IN PART THROUGH A GRANT FROM THE FEDERAL TRANSIT ADMINISTRATION, U.S. DEPARTMENT OF TRANSPORTATION, UNDER THE URBAN MASS TRANSPORTATION ACT OF 1964, AS AMENDED, FOR THE
DATE	DESCRIPTION	OF 1964, AS AMENDED, FOR THE PORT AUTHORITY OF ALLEGHENY COUNTY, PENNSYLVANIA.
	REVISIONS	COUNTY, FERNOTEVANIA.

(NOT FOR CONSTRUCTION)

ESIGNED	<u>FAS</u>	
DRAWN	<u>JMS</u>	
CHECKED	SDS	
N CHARGE	LAR	
DATE	05/01/24	
CALE		ı
	AS SHOWN	ı

# PORT AUTHORITY OF ALLEGHENY COUNTY BUS RAPID TRANSIT UPTOWN TO OAKLAND

ROADWAY TABULATION SHEET

Port Authority connecting people to life

CONTRACT NO. BRT-001 DWG. NO. GN46 sнт. 46

02627 .001 4" PAVEMENT BASE DRAIN LF	02741 .001 ASPHALT TACK COAT	00750	. 001 REINFORCED CEMENT CONCRETE BASE SY COURSE, 10" DEPTH	02750 -002 -002 -002 -003 -003 -003 -003 -00	.001 ACCELERATED CONCRETE PAVEMENT SY PATCHING, AS DIRECTED	02757 .001 TRANSVERSE JOINT CLEANING LF	.001 REINFORCED CEMENT CONCRETE CURB	02781 REINFORCED ACCELERATED CONCRETE CURB	02781 PLAIN CONCRETE MOUNTABLE CURB,  TYPE A LF	02781 • 004 CURB CHEEK WALL LF	02781 REINFORCED CEMENT CONCRETE CURB, 36"	02781 .006 CONCRETE CURB STOP EA	02783 .001 CONCRETE BUFFER SY	02785 .001 REINFORCED CEMENT CONCRETE SY SIDEWALK, 4" DEPTH	LITEM NUMBER IN LINIT	SIDE	STATION
									·						FIFTH AVE - ENTIRE LENGTH		
					2919										AS DIRECTED - ENTIRE LENGTH	_T / RT	434+00.00 T0 565+00.00
															FIFTH AVE - UPTOWN		
1506	6458		362	413			1512	261						1216	DIAMOND ST TO CHATHAM SQ/WASHINGTON PL	T / RT	434+00.00 TO 440+95.00
1872	7161		858	183			1737	142	1045	110				1158	CHATHAM SQ/WASHINGTON PL TO MAGEE ST/LOGAN ST L	T / RT	440+95.00 TO 449+60.00
706	2909		149	80			631	70						597	MAGEE ST/LOGAN ST TO STEVENSON ST	T / RT	449+60.00 TO 453+15.00
810	3718		183	131			707	104		97				720	STEVENSON ST TO PRIDE ST	T / RT	453+15.00 TO 457+00.00
627	2342		123	56			537	53		91	38			609	PRIDE ST TO MARION ST/VINE ST	T / RT	457+00.00 TO 459+95.00
867	2796		158	173			736	127		197				862	MARION ST/VINE ST TO VAN BRAAM ST	_T / RT	459+95.00 TO 463+80.00
707	2535		141	44			664	44		189				770	VAN BRAAM ST TO MILTENBERGER ST	LT /RT	463+80.00 TO 467+25.00
361	1325		62				319				25			349	MILTENBERGER ST TO DINWIDDIE ST	T / RT	467+25.00 TO 468+90.00
757	2744		184	40			686	26		68	47			795	DINWIDDIE ST TO GIST ST	T / RT	468+90.00 TO 472+65.00
1071	3789		255	118			868	86		135	118			1264	GIST ST TO JUMONVILLE ST/WYANDOTTE ST	T / RT	472+65.00 TO 478+05.00
1045	3004		209				1021	25						606	JUMONVILLE ST/WYANDOTTE ST TO SENECA ST	T / RT	478+05.00 TO 482+55.00
893	3340		269	65			779	74		126	40			923		_T / RT	482+55.00 TO 487+05.00
1106	5668		718	207 21			1087	128		22				1081			487+05.00 TO 492+00.00
3652	7065		749	169			3691	132		162		8		3943	KIRKPATRICK ST/BIRMINGHAM BR TO BLVD OF THE ALLIES	_T / RT	492+00.00 TO 510+50.00
15980	54854		4420	1679 21	2919	0	14975	1272	1045	1197	268	8	0	14893	SUBTOTALS - FIFTH AVE - UPTOWN		

1B OF 4C

**AECOM** Gulf Tower 707 Grant Street 5th Floor Pittsburgh, PA 15219

		THE PREPARATION OF THIS DOCUMENT HAS BEEN FINANCED IN
		PART THROUGH A GRANT FROM THE
		FEDERAL TRANSIT ADMINISTRATION, U.S. DEPARTMENT OF
		TRANSPORTATION, UNDER THE
		URBAN MASS TRANSPORTATION ACT OF 1964, AS AMENDED, FOR THE
DATE	DESCRIPTION	PORT AUTHORITY OF ALLEGHENY COUNTY, PENNSYLVANIA.
	REVISIONS	COUNTY, PENNSTEVANIA.

(NOT FOR CONSTRUCTION)

DESIGNED	<u>FAS</u>	
DRAWN	<u>JMS</u>	
CHECKED	SDS	
N CHARGE	LAR	
DATE	05/01/24	
SCALE		
	AS SHOWN	

# PORT AUTHORITY OF ALLEGHENY COUNTY PENNSYLVANIA

BUS RAPID TRANSIT UPTOWN TO OAKLAND ROADWAY TABULATION SHEET

Port Authority connecting people to life

CONTRACT NO. BRT-001

DWG. NO. GN47 sнт. 47

	OCTRE ACCELERATED EXPOSED AGGREGATE  OOS CONCRETE, BROWN, 8" DEPTH  SY	02788 • 001 BRICK SURFACING SY	02788 REMOVE AND RESET BRICK SY SIDEWALK		02790 SEMOVE, STORE AND RESET SY INTERLÖCKING PAVERS		CF ORNAMENTAL RAILING						.001 GRANITE CURB	. 002 RADIUS GRANITE CURB		05100 • 001 REMOVABLE CURB	UNIT REMARKS  WEMARKS	SIDE	STATION
	- 1			ı					- 1						- '		FIFTH AVE - ENTIRE LENGTH		
																	AS DIRECTED - ENTIRE LENGTH	LT / RT	434+00.00 TO 565+00.00
																	FIFTH AVE - UPTOWN		
					81											3	DIAMOND ST TO CHATHAM SQ/WASHINGTON PL	LT / RT	434+00.00 TO 440+95.00
86		76															CHATHAM SQ/WASHINGTON PL TO MAGEE ST/LOGAN S	T LT / RT	440+95.00 TO 449+60.00
																	MAGEE ST/LOGAN ST TO STEVENSON ST	LT / RT	449+60.00 TO 453+15.00
																	STEVENSON ST TO PRIDE ST	LT / RT	453+15.00 TO 457+00.00
																	PRIDE ST TO MARION ST/VINE ST	LT / RT	457+00.00 TO 459+95.00
																1	MARION ST/VINE ST TO VAN BRAAM ST	LT / RT	459+95.00 TO 463+80.00
																	VAN BRAAM ST TO MILTENBERGER ST	LT /RT	463+80.00 TO 467+25.00
																	MILTENBERGER ST TO DINWIDDIE ST	LT / RT	467+25.00 TO 468+90.00
																	DINWIDDIE ST TO GIST ST	LT / RT	468+90.00 TO 472+65.00
																	GIST ST TO JUMONVILLE ST/WYANDOTTE ST	LT / RT	472+65.00 TO 478+05.00
628	27																JUMONVILLE ST/WYANDOTTE ST TO SENECA ST	LT / RT	478+05.00 TO 482+55.00
																	SENECA ST TO MOULTRIE ST	LT / RT	482+55.00 TO 487+05.00
																1	MOULTRIE TO KIRKPATRICK ST/BIRMINGHAM BR	LT / RT	487+05.00 TO 492+00.00
							946									1	KIRKPATRICK ST/BIRMINGHAM BR TO BLVD OF THE ALLIES	LT / RT	492+00.00 TO 510+50.00
714	27	76	0		81		946						0	0		6	SUBTOTALS - FIFTH AVE - UPTOWN		

1C OF 4C

Gulf Tower
707 Grant Street
5th Floor
Pittsburgh, PA 15219

			THE PREPARATION OF THIS DOCUMENT HAS BEEN FINANCED IN
			PART THROUGH A GRANT FROM THE
			FEDERAL TRANSIT ADMINISTRATION, U.S. DEPARTMENT OF
			TRANSPORTATION, UNDER THE
			URBAN MASS TRANSPORTATION ACT OF 1964, AS AMENDED, FOR THE
ο.	DATE	DESCRIPTION	PORT AUTHORITY OF ALLEGHENY COUNTY, PENNSYLVANIA.
		REVISIONS	COUNTY, PENNOTEVANIA.

(NOT FOR CONSTRUCTION)

DESIGNED	FAS	
DRAWN	<u>JMS</u>	
CHECKED	SDS	
N CHARGE	LAR	
DATE	05/01/24	
SCALE	AS SHOWN	

# PORT AUTHORITY OF ALLEGHENY COUNTY PENNSYLVANIA BUS RAPID TRANSIT UPTOWN TO OAKLAND

US RAPID TRANSIT UPTOWN TO OAKLAND ROADWAY TABULATION SHEET

Port Authority connecting people to life

CONTRACT NO. BRT-001

DWG. NO. GN48 SHT. 48

2 366   1016 23		O19900 EA EA EAMPS	2218 -001 FOREIGN BORROW EXCAVATION CY	02353 • 001 GEOTEXTILE CLASS 1	02353 • 002 SY GEOTEXTILE CLASS 4, TYPE A	02521 • 001 SUBBASE 8" DEPTH (NO. 2A) SY	02521 • 002 SY SY	02521 • 003 SUBBASE 4" DEPTH (NO. 2A) SY	.004 SUBBASE (NO. 2A) (MATCH ADJACENT SUBBASE DEPTH)	02532 SUPERPAVE ASPHALT MIXTURE DESIGN, 30	SY DEPTH, SRL-H 2532 SUPERPAVE ASPHALT MIXTURE DESIGN,	*** OO3 WEATING COURSE, PG 64S-22, <0.3 MILLION ESALS, 9.5MM MIX, 2"  SY DEPTH, SRL-H O2532 SUPERPAVE ASPHALT MIXTURE DESIGN,	SY 2" DEPTH  02532 SUPERPAVE ASPHALT MIXTURE DESIGN,  00633 SUPERPAVE ASPHALT MIXTURE DESIGN,  006 BASE COURSE, PC 645-22, CO. 3 1100 ESALS, 25.0MM MIX, 4 1/2"	SY DEPTH 02532 SUPERPAVE ASPHALT MIXTURE DESIGN, 0006 BASE COURSE, PG 645-22, <0.3 SY DEPTH	2532 SUPERPAVE ASPHALT MIXTURE DESIGN, 007 BINDER COURSE (LEVELING), PG 64E-22, 10, TO <30 MILLION ESALS,	19.0 MM MIX  MILLING OF ASPHALT PAVEMEN  SURFACE, 1 1/2" DEPTH	.002 MILLING OF ASPHALT PAVEMENT	MILLING OF SURFACE, 3	.004 MILLING OF ASPHALT PAVEMENT SY SURFACE, VARIABLE DEPTH	2555 MILLING OF CEMENT CONCRETE 501 PAVEMENT SURFACE, 2" DEPTH	UNIT UNIT UNIT	SIDE	STATION
2 366	$\parallel \parallel$	, ,	o '	0 .	0 .	0 '	0 •	0 .	0 1		0	• 0	. 0 .	0 .	0,	0 '	0 •	0 .	0 .	0 '			
3   10   167   158   121   35   3   866   5   1   177   ORAFT AVE TO INAMEST STORESTED NO RET FLOWER FLOWER FLOWER STORESTED NO RET FLOWER F	╁	2	366	1016	231		1308		52	17:	45				103	1732						_T / RT	510+50.00 TO 518+59.63
3   1   314   250   319   56   100   801   111   147   741   344   345   344   17   17   527100, 33   10   10   10   10   10   10   10	╁										_	806								767			518+59.63 TO 527+00.39
T 73	╽┝	3	1							<del>                                     </del>													527+00.39 TO 533+25.05
4 1	$\ \cdot\ $	7	73	740			628		52			500			24	317				408		T / RT	533+25.05 TO 536+99.36
3 26	$\parallel$	5	61	327	114		372		26	27	5	318			13	218				301	LOTHROP ST/MEYRAN AVE TO ATWOOD ST	T / RT	536+99.36 TO 539+68.83
4 6 93 71 88 16 16 14 367 4 1 37 359 BOUNDETST TO THACKERAY AVE LT / RT 543+61.78 TO 5 1 1 1 1 1 1 1 1 1 1 1 1 1 1 1 1 1 1		4	1	85	58		70		13			307			3					287	ATWOOD ST TO DE SOTO ST/OAKLAND AVE	T / RT	539+68.83 TO 542+20.03
5 1		3	26	159	55		167		13	13	5	181			7	108				173	DE SOTO ST/OAKLAND AVE TO BOUQUET ST	T / RT	542+20.03 TO 543+61.78
2 31	ااء	4	6	93	71		88		16	1.	4 :	367			4					359	BOUQUET ST TO THACKERAY AVE	T / RT	543+61.78 TO 547+02.43
7 29 251 170 341 38 377 341 14 318 317 BEGLOW BLVD TO LYTTON AVE LT / RT 553+80.75 TO 10 26 250 199 293 45 544 322 18 476 283 LYTTON AVE TO TENNYSON AVE LT / RT 557+04.45 TO 6 84 3335 162 434 36 591 321 19 503 303 TENNYSON AVE LT / RT 589+94.54 TO 5 38 419 164 511 37 501 171 27 344 128 153 RUSKIN AVE TO BELLEFIELD AVE LT / RT 562+83.69 TO 17 AVE TO 18 AVE TO BELLEFIELD AVE LT / RT 562+83.69 TO 18 AVE TO BELLEFIELD AVE LT / RT 562+83		5	1	135	74		137		17	2	1 ;	356			5					346	THACKERAY AVE TO UNIVERSITY PL	T / RT	547+02.43 TO 550+35.31
10 26	TABC	2	31	469	224		474		50	54	3	364			34	365	337	7		28	UNIVERSITY PL TO BIGELOW BLVD	_T / RT	550+35.31 TO 553+80.75
6 84 335 162 434 36 591 321 19 503 303 TENNYSON AVE TO RUSKIN AVE LT / RT 559494.54 TO 5 38 419 164 511 37 501 171 27 344 128 153 RUSKIN AVE TO BELLEFIELD AVE LT / RT 562483.69 TO 5 38 501 171 501 1	- RD	7	29	251	170		341		38	37	7	341			14	318	317	7			BIGELOW BLVD TO LYTTON AVE	_T / RT	553+80.75 TO 557+04.45
5 38 419 164 511 37 501 171 27 344 128 153 RUSKIN AVE TO BELLEFIELD AVE LT / RT 562+83, 69 TO	۲ - -	10	26	250	199		293		45	54	4 :	322			18	476	283	3			LYTTON AVE TO TENNYSON AVE	_T / RT	557+04.45 TO 559+94.54
		6	84	335	162		434		36	59	11	321			19	503	303	3			TENNYSON AVE TO RUSKIN AVE	T / RT	559+94.54 TO 562+83.39
	020	5	38	419	164		511		37	50	)1	171			27	344	128	3	153		RUSKIN AVE TO BELLEFIELD AVE	T / RT	562+83.69 TO 564+88.65
	E0																						
	yøde(														<del> </del>								
	garr														<u> </u>								
	<u> </u>														-								
															-								
															-								
	-														-								
6   66   753     4840   2155   0   5263   0   486     5182   5155   0   0   0   287   4528   1368   0   153   3410   SUBTOTALS - FIFTH AVE - OAKLAND	)   		753	1910	2155		5263		186		22	155	0 0		207	4500	130	<u> </u>	157	3/10	SURTOTALS - ETETH AVE - DAVI AND		
66 753   4840 2155   0 5263 0 486   5182 5155 0 0 0 287   4528 1368 0 153 3410 SUBTOTALS - FIFTH AVE - OAKLAND	ğ L	00	133	4840	2155	U	5263		486	511	52 5	1133	0 0	0		4528	136	0 0	153	3410	SUBTUTALS - FIFTH AVE - VARLAND		

2A OF 4C

**AECOM** Gulf Tower 707 Grant Street 5th Floor Pittsburgh, PA 15219

			THE PREPARATION OF THIS  DOCUMENT HAS BEEN FINANCED I
			PART THROUGH A GRANT FROM TI
			FEDERAL TRANSIT ADMINISTRATION OF
			TRANSPORTATION, UNDER THE
			URBAN MASS TRANSPORTATION A OF 1964, AS AMENDED, FOR THE
٥.	DATE	DESCRIPTION	PORT AUTHORITY OF ALLEGHENY COUNTY, PENNSYLVANIA.
		REVISIONS	COONTT, FENNSTEVANIA.

(NOT FOR CONSTRUCTION)

ESIGNED	FAS	Р
RAWN	<u>JMS</u>	PI
HECKED	SDS	
CHARGE	LAR	
ATE	05/01/24	
CALE	AS SHOWN	Port

# PORT AUTHORITY OF ALLEGHENY COUNTY PENNSYLVANIA BUS RAPID TRANSIT UPTOWN TO OAKLAND

ROADWAY TABULATION SHEET

Port Authority connecting people to life

CONTRACT NO. BRT-001 DWG. NO. GN49 sнт. **49** 

# michdei.mcgarry" c:/pwworking/aecom\_ds16\_na/michaei.mcgarry@aecom.com/d0207700\B

# ROADWAY TABULATION SHEET

02627 • 001 LF	02741 • 001 ASPHALT TACK COAT SY	02750 • 001 REINFORCED CEMENT CONCRETE BASE SY COURSE, 10" DEPTH	O2750 REINFORCED ACCELERATED CONCRETE SY O2750 PLAIN CEMENT CONCRETE PAVEMENT, SY 4" DEPTH	02755 ACCELERATED CONCRETE PAVEMENT SY PATCHING, AS DIRECTED	02757 . 001 TRANSVERSE JOINT CLEANING LF	02781 • 001 REINFORCED CEMENT CONCRETE CURB	02781 REINFORCED ACCELERATED CONCRETE CURB	02781 PLAIN CONCRETE MOUNTABLE CURB,	02781 • 004 CURB CHEEK WALL LF	.005 REINFORCED CEMENT CONCRETE CURB	02781  .006 CONCRETE CURB STOP  EA	02783 • 001 CONCRETE BUFFER SY	.001 SIDEWALK, 4" DEPTH	REMARKS UNIT	SIDE	STATION
														FIFTH AVE - OAKLAND		
1016	1976	231				1026		50	92				1220	BLVD OF THE ALLIES TO CRAFT AVE	LT / RT	510+50.00 TO 518+59.63
187	851	42			369	187						116	118	CRAFT AVE TO HALKET ST/CHESTERFIELD RD	RT	518+59.63 TO 527+00.39
374	994	84	41		503	374		381	40			90	317	HALKET ST/CHESTERFIELD RD TO MCKEE PL/DARRAGH	LT / RT	527+00.39 TO 533+25.05
740	990	166			316	414						68	637	MCKEE PL/DARRAGH ST TO LOTHROP ST/MEYRAN AVE		533+25.05 TO 536+99.36
327	667	74			174	323						40	383	LOTHROP ST/MEYRAN AVE TO ATWOOD ST	LT / RT	536+99.36 TO 539+68.83
85	327	20			123	85						38	70	ATWOOD ST TO DE SOTO ST/OAKLAND AVE	LT / RT	539+68.83 TO 542+20.03
159	352	36			104	159						19	171	DE SOTO ST/OAKLAND AVE TO BOUQUET ST	LT / RT	542+20.03 TO 543+61.78
93	403	22			200	89						50	89	BOUQUET ST TO THACKERAY AVE	LT / RT	543+61.78 TO 547+02.43
135	408	31			122	135						43	140	THACKERAY AVE TO UNIVERSITY PL	LT / RT	547+02.43 TO 550+35.31
469	1085	178			20	315						47	496	UNIVERSITY PL TO BIGELOW BLVD	LT / RT	550+35.31 TO 553+80.75
251	802	84	21 27			346	18					40	348	BIGELOW BLVD TO LYTTON AVE	LT / RT	553+80.75 TO 557+04.45
250	974	108	11 49			457	11		24				319	LYTTON AVE TO TENNYSON AVE	LT / RT	557+04.45 TO 559+94.54
335	1018	106	34			464							466	TENNYSON AVE TO RUSKIN AVE	LT / RT	559+94.54 TO 562+83.39
419	767	95	56			419		128					528	RUSKIN AVE TO BELLEFIELD AVE	LT / RT	562+83.69 TO 564+88.65
4840	11614	1277	32 207	0	1931	4793	29	559	156	0	0	551	5302	SUBTOTALS - FIFTH AVE - OAKLAND		

2B OF 4C

Gulf Tower
707 Grant Street
5th Floor
Pittsburgh, PA 15219

			THE PREPARATION OF THIS DOCUMENT HAS BEEN FINANCED I
			PART THROUGH A GRANT FROM T
			FEDERAL TRANSIT ADMINISTRATION OF
			TRANSPORTATION, UNDER THE
			URBAN MASS TRANSPORTATION A OF 1964. AS AMENDED. FOR THE
٥.	DATE	DESCRIPTION	PORT AUTHORITY OF ALLEGHENY COUNTY, PENNSYLVANIA.
		REVISIONS	COONTY, PENNSTEVANIA.

(NOT FOR CONSTRUCTION)

DESIGNED	FAS	
DRAWN	<u>JMS</u>	
CHECKED	SDS	
N CHARGE	LAR	
DATE	05/01/24	
SCALE	AS SHOWN	

# PORT AUTHORITY OF ALLEGHENY COUNTY PENNSYLVANIA BUS RAPID TRANSIT UPTOWN TO OAKLAND

US RAPID TRANSIT UPTOWN TO OAKLAND ROADWAY TABULATION SHEET

ort	Authority	L
	connecting people to life	

CONTRACT NO. BRT-001

DWG. NO. GN50 SHT. 50

FIFTS ANY - OWALAND  BUSINESS FOR MALESTS TO COMPAND AND  BUSINESS FOR MALESTS TO COMPAND AND  COMPAND AND THE DIRECTION STATE PROJECTION TO THE STREET PLANESS AND TO SERVICE AND  SERVICE PLANESS AND TO SERVICE PLANESS AND THE SERVICE PLANES	02786 EXPOSED AGGREGATE CONCRETE SY SIDEWALK, BROWN	2786 ACCELERATED EXPOSED AGGREGATE 005 CONCRETE, BROWN, 8" DEPTH	2788 .001 BRICK SURFACING SY	.002 SY SIDEWALK	02790 .001 REMOVE, STORE AND RESET SY INTERLOCKING PAVERS	02840 .001 ORNAMENTAL RAILING LF			CURB	002 RADIUS GRANITE CURB	5100 .001 REMOVABLE CURB	UNIT REMARKS  REMARKS	SIDE	STATION
SUND OF THE ALLES TO CREAT AVE		0 ,	0.	0 1	0 •	0 '				•				
CONSTANT IS MALEST STANDARD   No.   STREET, RES. 0.5 17-00-39													LT / PT	510+50 00 TO 518+59 63
### AMARET STYCHESTERPIELD 80 TO MISSER PL/CHARMAN LET / RT \$27-00.38 TO \$33425.05    1														
298 32 MACKER PLANEARMAN BY TO LOTHRINGS TAKETROM AVE LI / RI SASS-20-30 TO SSERE, AS 1 LOTHRINGS TAKETROM AVE LI / RI SASS-20-30 TO SSERE, AS 1 LOTHRING STATEMENT AND LI / RI SASS-20-30 TO SSERE, AS 1 LOTHRING STATEMENT AND LI / RI SASS-20-30 TO SSERE, AS 1 LOTHRING STATEMENT AND LI / RI SASS-20-30 TO SSERE, AS 1 LOTHRING STATEMENT AND LI / RI SASS-20-30 TO SSERE, AS 1 LOTHRING STATEMENT AND LI / RI SASS-20-30 TO SSERE, AS 1 LOTHRING STATEMENT AND LI / RI SASS-20-30 TO SSERE, AS 1 LOTHRING STATEMENT AND LI / RI SASS-20-30 TO SSERE, AS 1 LOTHRING STATEMENT AND LI / RI SASS-20-30 TO SSERE, AS 1 LOTHRING STATEMENT AND LI / RI SASS-20-30 TO SSERE, AS 1 LOTHRING STATEMENT AND LI / RI SASS-20-30 TO SSERE, AS 1 LOTHRING STATEMENT AND LI / RI SASS-20-30 TO SSERE, AS 1 LOTHRING STATEMENT AND LI / RI SASS-20-30 TO SSERE, AS 1 LOTHRING STATEMENT AND LI / RI SASS-20-30 TO SSERE, AS 1 LOTHRING STATEMENT AND LI / RI SASS-20-30 TO SSERE, AS 1 LOTHRING STATEMENT AND LI / RI SASS-20-30 TO SSERE, AS 1 LOTHRING STATEMENT AND LI / RI SASS-20-30 TO SSERE, AS 1 LOTHRING STATEMENT AND LIT / RI SASS-20-30 TO SSERE, AS 1 LOTHRING STATEMENT AND LIT / RI SASS-20-30 TO SSERE, AS 1 LOTHRING STATEMENT AND LIT / RI SASS-20-30 TO SSERE, AS 1 LOTHRING STATEMENT AND LIT / RI SASS-20-30 TO SSERE, AS 20-30 TO SSERE, AS												HALKET ST/CHESTERFIELD RD TO MCKEE PL/DARRAGH	LT / PT	
1   LOTIRIOP STAVENTIAN AVE TO ATBOOD ST									296	32				
ATWOOD ST TO DE SOTO ST/CAMLAND AVE									230	32	1			
DE SOTO ST/DAKLAND AVE TO BUDGUET ST LT / RT \$42*20.03 TO 545*61.78  1 800QUET ST TO THACKERAY AVE LT / RT \$42*20.03 TO 545*61.78  1 1 800QUET ST TO THACKERAY AVE LT / RT \$47*402.43 TO \$505*402.43  THACKERAY AVE TO UNIVERSITY PL D. T. / RT \$47*402.43 TO \$505*40.75  UNIVERSITY PL TO THACKERAY AVE LT / RT \$505*40.75 TO \$57*404.45  BIGGLOW BLVO TO LYTTON AVE LT / RT \$555*40.45 TO \$59*494.56  1 LYTTON AVE TO TENNYSON AVE LT / RT \$559*40.45 TO \$509*49.56  TENNYSON AVE TO RUSKIN AVE LT / RT \$559*40.45 TO \$62*83.39  RUSKIN AVE TO BELLEPIELD AVE LT / RT \$62*83.69 TO \$64*88.65											'			
1 BOUGUET ST TO THACKERAY AVE LT / RT 543+61.78 TO 547+02.43  THACKERAY AVE TO UNIVERSITY PL LT / RT 543+61.78 TO 547+02.43  UNIVERSITY PL TO BIELLOW BLVO LT / RT 553+04.75 TO 557+04.75  BISCOLON BLVO TO LYTTON AVE LT / RT 553+04.75 TO 557+04.75  1 LYTTON AVE TO TENNYSON AVE LT / RT 553+04.45 TO 559+04.55  TENNYSON AVE TO RUSKIN AVE LT / RT 553+04.64 TO 562+83.39  RUSKIN AVE TO BELLEFIELD AVE LT / RT 552+34.64 TO 562+83.69  RUSKIN AVE TO BELLEFIELD AVE LT / RT 552+34.64 TO 562+83.69  LT / RT 552+34.64 TO 562+83.69  RUSKIN AVE TO BELLEFIELD AVE LT / RT 552+34.64 TO 562+83.69  LT / RT 552+34.64 TO 562+83.69  RUSKIN AVE TO BELLEFIELD AVE LT / RT 552+34.64 TO 562+83.69  LT / RT 552+34.64 TO 562+83.69  RUSKIN AVE TO BELLEFIELD AVE LT / RT 552+34.64 TO 562+83.69  RUSKIN AVE TO BELLEFIELD AVE LT / RT 552+34.64 TO 562+83.69  RUSKIN AVE TO BELLEFIELD AVE LT / RT 552+34.64 TO 562+83.69  RUSKIN AVE TO BELLEFIELD AVE LT / RT 552+34.64 TO 562+83.69  RUSKIN AVE TO BELLEFIELD AVE LT / RT 552+34.64 TO 562+83.69  RUSKIN AVE TO BELLEFIELD AVE LT / RT 552+34.64 TO 562+83.69  RUSKIN AVE TO BELLEFIELD AVE LT / RT 552+34.64 TO 562+83.69  RUSKIN AVE TO BELLEFIELD AVE LT / RT 552+34.64 TO 562+83.69  RUSKIN AVE TO BELLEFIELD AVE LT / RT 552+34.64 TO 562+83.69  RUSKIN AVE TO BELLEFIELD AVE LT / RT 552+34.64 TO 562+83.69  RUSKIN AVE TO BELLEFIELD AVE LT / RT 552+34.64 TO 562+83.69  RUSKIN AVE TO BELLEFIELD AVE LT / RT 552+34.64 TO 562+83.69  RUSKIN AVE TO BELLEFIELD AVE LT / RT 552+64.75  RUSKIN AVE TO BELLEFIELD AVE LT / RT 552+64.75  RUSKIN AVE TO BELLEFIELD AVE LT / RT 552+64.75  RUSKIN AVE TO BELLEFIELD AVE LT / RT 552+64.75  RUSKIN AVE TO BELLEFIELD AVE LT / RT 552+64.75  RUSKIN AVE TO BELLEFIELD AVE LT / RT 552+64.75  RUSKIN AVE TO BELLEFIELD AVE LT / RT 552+64.75  RUSKIN AVE TO BELLEFIELD AVE LT / RT 552+64.75  RUSKIN AVE TO BELLEFIELD AVE LT / RT 552+64.75  RUSKIN AVE TO BELLEFIELD AVE LT / RT 552+64.75  RUSKIN AVE TO BELLEFIELD AVE LT / RT 552+64.75  RUSKIN AVE TO BELLEFIELD AVE LT / RT 552+64.75  RUSKIN AVE TO BELLEFIELD AVE LT														
THACKERAY AVE TO UNIVERSITY PL LT / RT 547+02, 43 TO 550+35, 31 TO 550+35, 31 TO 550+35, 31 TO 550+36, 31 TO 550+3											1			
UNIVERSITY PL TO BIGELOW BLVD TO LYTON AVE  LT / RT 550-35.31 TO 553+80.75  BIGELOW BLVD TO LYTTON AVE  LT / RT 553+80.75 TO 557+04.45  1 LYTTON AVE TO TENNYSON AVE  LT / RT 557+04.45 TO 559-94.54  TENNYSON AVE TO RUSKIN AVE  LT / RT 559-94.54 TO 562-83.39  RUSKIN AVE TO BELLEFIELD AVE  LT / RT 556-83.69 TO 564-88.65										-	'			
BIGELOW BLVD TO LYTTON AVE LT / RT 553+80. T5 T0 557+04. 45  1 LYTTON AVE TO TENNYSON AVE LT / RT 557+04. 45 T0 559+94. 54  TENNYSON AVE TO RUSKIN AVE LT / RT 559+94. 54 T0 562+83. 39  RUSKIN AVE TO BELLEFIELD AVE LT / RT 562+83. 69 TO 564+88. 65										-				
1 LYTTON AVE TO TENNYSON AVE LT / RT 557+04.45 TO 559+94.54  TENNYSON AVE TO RUSKIN AVE CT / RT 559+94.54 TO 562+83.39  RUSKIN AVE TO BELLEFIELD AVE LT / RT 562+83.69 TO 564+88.65										-				
TENNYSON AVE TO RUSKIN AVE LT / RT 559+94.54 TO 562+83.39 RUSKIN AVE TO BELLEFIELD AVE LT / RT 562+83.69 TO 564+88.65 RUSKIN AVE TO BELLEFIELD AVE LT / RT 562+83.69 TO 564+88.65 RUSKIN AVE TO BELLEFIELD AVE AVE TO BELLEFIE											1			
RUSKIN AVE TO BELLEFIELD AVE LT / RT 562+83.69 TO 564+88.65										-	1			
										-				
0 0 0 0 0 0 0 0 296 32 3 SUBTOTALS - FIFTH AVE - OAKLAND												NOSKIN AVE ID BELLEFIELD AVE	LI / KI	302703.03 10 304+88.65
0 0 0 0 0 0 0 0 0 0 0 0 0 0 0 0 0 0 0														
0 0 0 0 0 0 0 0 0 0 0 0 0 0 0 0 0 0 0														
0 0 0 0 0 0 0 0 0 0 0 0 0 0 0 0 0 0 0														
0 0 0 0 0 0 0 0 0 0 0 0 0 0 0 0 0 0 0														
0 0 0 0 0 0 0 0 0 0 0 0 0 0 0 0 0 0 0														
0 0 0 0 0 0 0 0 0 0 0 0 0 0 0 0 0 0 0														
0 0 0 0 0 0 0 0 0 0 0 0 0 0 0 0 0 0 0														
0 0 0 0 0 0 0 0 0 0 0 0 0 0 0 0 0 0 0														
0 0 0 0 0 0 0 0 0 0 0 0 0 0 0 0 0 0 0			.											
	0	0	0	0	0	0			296	32	3	SUBTOTALS - FIFTH AVE - OAKLAND		

2C OF 4C

**AECOM** Gulf Tower 707 Grant Street 5th Floor Pittsburgh, PA 15219

			THE PREPARATION OF THIS DOCUMENT HAS BEEN FINANCED II
			PART THROUGH A GRANT FROM TH
			FEDERAL TRANSIT ADMINISTRATIO
			TRANSPORTATION, UNDER THE
			URBAN MASS TRANSPORTATION AG OF 1964, AS AMENDED, FOR THE
Э.	DATE	DESCRIPTION	PORT AUTHORITY OF ALLEGHENY COUNTY, PENNSYLVANIA.
		REVISIONS	COUNTY, PENNSTEVANIA.

(NOT FOR CONSTRUCTION)

DESIGNED	FAS	
DRAWN	<u>JMS</u>	
CHECKED	<u>SDS</u>	
N CHARGE	<u>LAR</u>	
DATE	05/01/24	
SCALE	AS SHOWN	Po

# PORT AUTHORITY OF ALLEGHENY COUNTY PENNSYLVANIA BUS RAPID TRANSIT UPTOWN TO OAKLAND

ROADWAY TABULATION SHEET

nrt	Authority	CONTRACT NO. BRT-00	)1	
,,,	connecting people to life	dwg. no. GN51	SHT.	51

01900 . 001 EA O2218 . 001 FOREIGN BORROW EXCAVATION CY	02353		SY S	ON DEGEN	SUBB	.002 SUBBASE 6" DEPTH (NO. 2A) SY 005521	. 003 SUBBASE 4" DEPTH (NO. 2A) SY 02521 SUBBASE (NO. 2A) (MATCH .004 ADJACENT SUBBASE DEPTH)	02532 SUPERPAVE ASPHALT MIXTURE 0001 DESIGN, WEARING COURSE, PG 001 G46-22, 10 TO C30 MILLIA SALS, SY 9.5MM MIX, 1 1/2" DEPTH, SRL-H	O2532 SUPERPAVE ASPHALT MIXTURE .003 DESIGN, WEARING COURSE, PG 64S-25, (O.3 MILLION ESALS, SY 9.5MM MIX. 2.0 DEPTH. SRI-H.	02532 SUPERPORT ASPHALT MIXTURE .004 DESIGN, BINDER COURSE, PG 64E-22, 10 TO 30 MILLION SY ESALS, 19,0 MM MIX, 2" DEPTH	02532 SUPERPAVE ASPHALT MIXTURE .005 DESIGN, BASE COURSE, PG 645-22, (0.3 MILLION ESALS, SY 25,00M MIX. 4 1/2" DEPTH	02532 SUPERPAVE ASPHALT MIXTURE .006 64S-22, (0.3 MILLION ESALS, SY 25,0MM MIX. 4" DEPTH	02532 SUPERRAVE ASPHALT MIXTURE 007 (LEVELING), PG 64E-22, 10 TO TON <30 MILLION ESALS, 19.0 MM MIX	02550 .001 SY SY SURFACE, 1 1/2" DEPTH	02550 . 002 MILLING OF ASPHALT PAVEMENT . SURFACE, 2" DEPTH	MILL ING SURFACE,	MILLING OF ASPHAL SURFACE, VARIABLE	SY PAVEMENT SURFACE, 2" DEPTH LIMBER NUMBER NUMIT SYANDEM SYNDER SYNDEM	SIDE	STATION
																		FORBES AVENUE - ENTIRE LENGTH		
																		AS DIRECTED - ENTIRE LENGTH	LT / RT	121+20.00 TO 259+50.00
																		FORDES AVE. LIDTOWN		
			4				3	873					119				869	FORBES AVE - UPTOWN	LT / RT	121+20 34 TO 123+03 OO
6	8		23			147	16	2483					444				2460	SHINGISS ST TO BOYD ST  BOYD ST TO CHATHAM SQ/MCANULTY DR	LT / RT	121+29.34 TO 123+03.00 123+03.00 TO 129+42.00
4			32			358	55	2786					528				2704	CHATHAM SQ/MCANULTY DR TO MAGEE ST	LT / RT	129+42.00 TO 136+89.00
2			12			235	76	2361					320				2249	MAGEE ST TO STEVENSON ST	LT / RT	136+89.00 TO 142+00.00
7 45			80			458	121	2221					325				2041	STEVENSON ST TO PRIDE ST	LT / RT	142+00.00 TO 145+83.00
8 265			42				109 96	1019	109			109	172				877	PRIDE ST TO MARION ST	LT / RT	145+83.00 TO 148+45.00
8 304			60				246 175	1589	246			246	341				1329	MARION ST TO VAN BRAAM ST	LT /RT	148+45.00 TO 152+75.00
8 251			44				165 97	1306	165			165	188				1162	VAN BRAAM ST TO MILTENBERGER ST	LT / RT	152+75.00 TO 156+18.00
8 375			19				322 214	1937	322			322	365				1618	MILTENBERGER ST TO GIST ST	LT / RT	156+18.00 TO 161+56.00
8 357			66				258 179	1793	258			258	409				1527	GIST ST TO JUMONVILLE ST	LT / RT	161+56.00 TO 166+47.50
8 387			90				264 195	1854	264			264	427				1564	JUMONVILLE ST TO SENECA ST	LT / RT	166+47.50 TO 171+47.00
8 304	84	10 1	76			928	227 118	1440	227			227	305				1264	SENECA ST TO MOULTRIE ST	LT / RT	171+47.00 TO 175+47.00
6 226	58	35 1	27			580	142 86	1131	142			142	299				1004	MOULTRIE ST TO BRADY ST	LT / RT	175+47.00 TO 178+45.00
2 1	6	0	2			33	2	859					283				857	BRADY ST TO BIRMINGHAM BR	LT / RT	178+45.00 TO 180+66.00
																		FORBES AVE - OAKLAND		
3 60	30	04				274		292						292				CRAFT AVE TO HALKET ST	LT/RT	209+65.29 TO 217+30.40
	1.	'3				113		274						274				MCKEE PL TO SEMPLE ST	RT	224+04.59 TO 225+77.25
	15	56				28		83						83				S BOUQUET ST TO BIGELOW BLVD/SCHENLEY DR	RT	235+93.00 TO 237+60.69
2 266	52	20				100	148		148			148						BIGELOW BLVD/SCHENLEY DR TO SCHENLEY DR EXT	RT	244+85.95 TO 248+25.99
												3A OF	4C							

**AECOM** 

Gulf Tower 707 Grant Street 5th Floor Pittsburgh, PA 15219

GANNETT FLEMING
GANNETT FLEMING, INC.
Foster Plaza 8
Suite 400
730 Holiday Drive
Pittsburgh, PA. 15220

THE PREPARATION OF THIS

DOCUMENT HAS BEEN FINANCED IN
PART THROUGH A GRANT FROM THE
FEDERAL TRANSIT ADMINISTRATION,
U.S. DEPARTMENT OF
TRANSPORTATION, UNDER THE
URBAN MASS TRANSPORTATION ACT
OF 1964, AS AMENDED, FOR THE
PORT AUTHORITY OF ALLEGHENY
COUNTY, PENNSYLVANIA. NO. DATE DESCRIPTION REVISIONS

(NOT FOR CONSTRUCTION)

DESIGNED	KCF	
DRAWN	KCF	
CHECKED	<u>TCG</u>	
IN CHARGE	GEC	
DATE	05/01/24	
SCALE		
	AS SHOWN	

## PORT AUTHORITY OF ALLEGHENY COUNTY PENNSYLVANIA BUS RAPID TRANSIT UPTOWN TO OAKLAND

**ROADWAY TABULATION SHEET** 

Port Authority connecting people to life

CONTRACT NO. BRT-001 DWG. NO. GN52 sнт. 52

	02627 -001 4" PAVEMENT BASE DRAIN LF	02741 .001 ASPHALT TACK COAT	02750 .001 REINFORCED CEMENT CONCRETE SY BASE COURSE, 10" DEPTH	.002 REINFORCED ACCELERATED CONCRETE PAVEMENT, 8" DEPTH	02750 .003 PLAIN CEMENT CONCRETE SY PAVEMENT, 4" DEPTH	02755 ACCELERATED CONCRETE PAVEMENT SY PATCHING, AS DIRECTED	02757 .001 LF TRANSVERSE JOINT CLEANING	02781 REINFORCED CEMENT CONCRETE CLRB	02781 REINFORCED ACCELERATED CONCRETE CURB	02781 PLAIN CONCRETE MOUNTABLE CURB,	02781 • 004 CURB CHEEK WALL	02781 .005 REINFORCED CEMENT CONCRETE LIF	02781 • 006 CONCRETE CURB STOP EA	02783 .001 CONCRETE BUFFER SY	02785 .001 REINFORCED CEMENT CONCRETE SY SIDEWALK, 4" DEPTH	REMARKS STATION SIDE	
																FORBES AVENUE - ENTIRE LENGTH	_
						3122										AS DIRECTED - ENTIRE LENGTH LT / RT 121+20.00 TO 259+50.00	_
																FORBES AVE - UPTOWN	
		1750	4													SHINGISS ST TO BOYD ST LT / RT 121+29.34 TO 123+03.00	
	82	4989	23					82								BOYD ST TO CHATHAM SQ/MCANULTY DR LT / RT 123+03.00 TO 129+42.00	
	404	5654	82					404								CHATHAM SQ/MCANULTY DR TO MAGEE ST LT / RT 129+42.00 TO 136+89.00	
	305	4834	112	58				216	89						177	MAGEE ST TO STEVENSON ST LT / RT 136+89.00 TO 142+00.00	
	410	4622	180					410							458	STEVENSON ST TO PRIDE ST LT / RT 142+00.00 TO 145+83.00	
5	590	2180	142	133				537	53						575	PRIDE ST TO MARION ST LT / RT 145+83.00 TO 148+45.00	
	880	3438	260	68				813	67						1009	MARION ST TO VAN BRAAM ST LT /RT 148+45.00 TO 152+75.00	
	700	2756	144	19				681	19						667	VAN BRAAM ST TO MILTENBERGER ST LT / RT 152+75.00 TO 156+18.00	
	1098	4193	319	123				987	111						1164	MILTENBERGER ST TO GIST ST LT / RT 156+18.00 TO 161+56.00	
	1007	3852	266	213				846	161						912	GIST ST TO JUMONVILLE ST LT / RT 161+56.00 TO 166+47.50	
	1060	3998	290	43				1017	43						1030	JUMONVILLE ST TO SENECA ST LT / RT 166+47.50 TO 171+47.00	
	840	3056	176	130				730	110						798	SENECA ST TO MOULTRIE ST LT / RT 171+47.00 TO 175+47.00	
	585	2389	127					585							580	MOULTRIE ST TO BRADY ST LT / RT 175+47.00 TO 178+45.00	
	60	1720	2					60							33	BRADY ST TO BIRMINGHAM BR LT / RT 178+45.00 TO 180+66.00	
																FORBES AVE - OAKLAND	
	304	292						304							274	CRAFT AVE TO HALKET ST LT/RT 209+65.29 TO 217+40	
	173	274						173							113	MCKEE PL TO SEMPLE ST RT 224+04.59 TO 225+77.25	
	156	83						156								S BOUQUET ST TO BIGELOW BLVD/SCHENLEY DR RT 235+93.00 TO 237+60.69	
	520	148						378				142				BIGELOW BLVD/SCHENLEY DR TO SCHENLEY DR EXT RT 244+85.95 TO 248+25.99	
3																	
<u></u>																	
			 			 				3B 0F	4C						

**AECOM** 

Gulf Tower 707 Grant Street 5th Floor Pittsburgh, PA 15219

GANNETT FLEMING
GANNETT FLEMING, INC.
Foster Plaza 8
Suite 400
730 Holiday Drive
Pittsburgh, PA. 15220

THE PREPARATION OF THIS

DOCUMENT HAS BEEN FINANCED IN
PART THROUGH A GRANT FROM THE
FEDERAL TRANSIT ADMINISTRATION,
U.S. DEPARTMENT OF
TRANSPORTATION, UNDER THE
URBAN MASS TRANSPORTATION ACT
OF 1964, AS AMENDED, FOR THE
PORT AUTHORITY OF ALLEGHENY
COUNTY, PENNSYLVANIA. NO. DATE DESCRIPTION REVISIONS

(NOT FOR CONSTRUCTION)

DESIGNED	KCF	
DRAWN	KCF	
CHECKED	TCG	
N CHARGE	GEC	
DATE	05/01/24	
SCALE		
	AS SHOWN	

# PORT AUTHORITY OF ALLEGHENY COUNTY

BUS RAPID TRANSIT UPTOWN TO OAKLAND **ROADWAY TABULATION SHEET** 

Port Authority connecting people to life

CONTRACT NO. BRT-001 DWG. NO. GN53 sнт. **53** 

02786 • 002 EXPOSED AGGREGATE CONCRETE		02788 BRICK SURFACING SY 02788 REMOVE AND RESET BRICK SIDEWALK	SY	.001 REMOVE, STORE AND RESET SY INTERLOCKING PAVERS		CRAMENIAL RAILING								04413 -001 GRANITE CHRR	RADIUS G			5100 001 REMOVABLE CURB EA	UNIT REMARKS UNIT	SIDE	STATION
8 .	0 .	8. 8.		8.	8	•								o.	o ·			<u>8.</u>	FORBES AVENUE - ENTIRE LENGTH		
																			AS DIRECTED - ENTIRE LENGTH	LT / RT	121+20.00 TO 259+50.00
																					250 55 15 255 556 55
																			FORBES AVE - UPTOWN		
																			SHINGISS ST TO BOYD ST	LT / RT	121+29.34 TO 123+03.00
14	7	8																	BOYD ST TO CHATHAM SQ/MCANULTY DR	LT / RT	123+03.00 TO 129+42.00
35		45																	CHATHAM SQ/MCANULTY DR TO MAGEE ST	LT / RT	129+42.00 TO 136+89.00
																			MAGEE ST TO STEVENSON ST	LT / RT	136+89.00 TO 142+00.00
																			STEVENSON ST TO PRIDE ST	LT / RT	142+00.00 T0 145+83.00
																			PRIDE ST TO MARION ST	LT / RT	145+83.00 TO 148+45.00
																			MARION ST TO VAN BRAAM ST	LT /RT	148+45.00 TO 152+75.00
																			VAN BRAAM ST TO MILTENBERGER ST	LT / RT	152+75.00 TO 156+18.00
																			MILTENBERGER ST TO GIST ST	LT / RT	156+18.00 TO 161+56.00
																			GIST ST TO JUMONVILLE ST	LT / RT	161+56.00 TO 166+47.50
																			JUMONVILLE ST TO SENECA ST	LT / RT	166+47.50 TO 171+47.00
																			SENECA ST TO MOULTRIE ST	LT / RT	171+47.00 TO 175+47.00
																			MOULTRIE ST TO BRADY ST	LT / RT	175+47.00 TO 178+45.00
																			BRADY ST TO BIRMINGHAM BR	LT / RT	178+45.00 TO 180+66.00
																			FORBES AVE - OAKLAND		
																			CRAFT AVE TO HALKET ST	LT/RT	209+65.29 TO 217+40
																			MCKEE PL TO SEMPLE ST	RT	224+04.59 TO 225+77.25
28																			S BOUQUET ST TO BIGELOW BLVD/SCHENLEY DR	RT	235+93.00 TO 237+60.69
100	0																		BIGELOW BLVD/SCHENLEY DR TO SCHENLEY DR EXT	RT	244+85.95 TO 248+25.99
'	<u> </u>					'	·	•		'		:	3C OF 4	С	'		'			<u>'</u>	

**AECOM** 

Gulf Tower 707 Grant Street 5th Floor Pittsburgh, PA 15219

GANNETT FLEMING
GANNETT FLEMING, INC.
Foster Plaza 8
Suite 400
730 Holiday Drive
Pittsburgh, PA. 15220

THE PREPARATION OF THIS

DOCUMENT HAS BEEN FINANCED IN
PART THROUGH A GRANT FROM THE
FEDERAL TRANSIT ADMINISTRATION,
U.S. DEPARTMENT OF
TRANSPORTATION, UNDER THE
URBAN MASS TRANSPORTATION ACT
OF 1964, AS AMENDED, FOR THE
PORT AUTHORITY OF ALLEGHENY
COUNTY, PENNSYLVANIA. NO. DATE DESCRIPTION REVISIONS

(NOT FOR CONSTRUCTION)

DESIGNED	KCF	
DRAWN	KCF	
CHECKED	TCG	
N CHARGE	GEC	
DATE	05/01/24	
SCALE		
	AS SHOWN	

# PORT AUTHORITY OF ALLEGHENY COUNTY

BUS RAPID TRANSIT UPTOWN TO OAKLAND **ROADWAY TABULATION SHEET** 

Port Authority connecting people to life

sнт. **54** 

CONTRACT NO. BRT-001 DWG. NO. GN54

# ROADWAY TABULATION SHEET - TOTALS

JF CURB RAMPS	CY FOREIGN BORROW EXCAVATION		02353 • 001 GEOTEXTILE CLASS 1 LF	02353 • 002 SY GEOTEXTILE CLASS 4, TYPE A	02521 .001 SUBBASE 8" DEPTH (NO. 2A) SY	02521 • 002 SUBBASE 6" DEPTH (NO. 2A) SY	02521 .003 SUBBASE 4" DEPTH (NO. 2A) SY	02521 SUBBASE (NO. 2A) (MATCH .004 ADJACENT SUBBASE DEPTH)	02532 SUPERPAVE ASPHALT MIXTURE .001 DESIGN WEARING COURSE. PG 467-22, 10 TO CASO MILLION ESALS, SY 9.5MM MIX, 1 1/2" DEPH4, SRL-H	O2532 SUPERPAVE ASPHALT MIXTURE .003 BESIGN, WEARING COURSE, PG .004 645-22, AG.3 MILLION ESALS, SY 9.5MM MIX, 2" DEPTH, SRL-H	02532 SUPERPAVE ASPHALT MIXTURE .004 DESIGN, BINDER COURSE, PG 64E-22, 10.0 TO <30 MILLION SY ESALS, 19.0 MM MIX, 2" DEPTH	O2532 SUPERPAVE ASPHALT MIXTURE .008 DESIGN, BASE COURSE, PG 645-22, C 0.3 MILLION ESALS, SY 25.0 MM MIX, 4 1/2" DEPTH	O2532 SUPERPAVE ASPHALT MIXTURE .006 DESIGN, BASE COURSE, PG .006 G4S-22, A0.3 MILLION ESALS,	02532 SUPERRAVE ASPHALT MIXTURE .007 DESIGN, BINDER COURSE TON (CLEVELING), PG 64E-22, 10 TO TON (330 MILLION ESALS, 19.0 MM MIX	.001 SURFACE, 1 1/2" DEPTH	.002 MILLING OF ASPHALT PAVEMENT	MILLING OF SURFACE, 3	02550 .0054 MILLING OF ASPHALT PAVEMENT	02555 MILLING OF CEMENT CONCRETE .001 PAVEMENT SURFACE, 2" DEPTH	REMARKS  UNIT  TIND	SIDE	STATION
83 2	2515		16005	4328	578	19093	3271	886	28575	3271	501	392	3271	5783	1113		795	25216	;	SUBTOTAL - FIFTH AVE - ENTIRE LENGTH SUBTOTAL - FIFTH AVE - UPTOWN		
66	753		4840	2155		5263		486	5182	5155				287	4528	1368	3	153	3410	SUBTOTAL - FIFTH AVE - OAKLAND		
03 2	DE 1 E		9021	2127		9695	1733	1/133	23652	1733			1733	420E				21525		SUBTOTAL - FORBES AVENUE - ENTIRE LENGTH SUBTOTAL - FORBES AVE - UPTOWN		
	326		1153	2127		8695 515	1733	1433	23652 649	1733			148	4205	649			21525	'	SUBTOTAL - FORBES AVE - OAKLAND		
									+													
237 6	5109		30019	8610	578	33566	5152	2805	58058	10307	501	392	5152	10275	6290	1368	795	46894	3410	TOTALS		
										1	I	L	4A OF						1	1.025		

**AECOM** 

Gulf Tower 707 Grant Street 5th Floor Pittsburgh, PA 15219

		THE DREPARATION OF THE
		THE PREPARATION OF THIS DOCUMENT HAS BEEN FINANCED IN
		PART THROUGH A GRANT FROM THE
		FEDERAL TRANSIT ADMINISTRATION,
		U.S. DEPARTMENT OF TRANSPORTATION. UNDER THE
		URBAN MASS TRANSPORTATION ACT
		OF 1964, AS AMENDED, FOR THE
DATE	DESCRIPTION	PORT AUTHORITY OF ALLEGHENY COUNTY, PENNSYLVANIA.
	REVISIONS	COUNTY, FEMINSTEVANIA.

(NOT FOR CONSTRUCTION)

DESIGNED	<u>FAS</u>	
DRAWN	<u>JMS</u>	
CHECKED	SDS	
N CHARGE	LAR	
DATE	05/01/24	
SCALE		
	AS SHOWN	

# PORT AUTHORITY OF ALLEGHENY COUNTY PENNSYLVANIA

BUS RAPID TRANSIT UPTOWN TO OAKLAND ROADWAY TABULATION SHEET - TOTALS

Port Authority -

CONTRACT NO. BRT-001

DWG NO. GN55 SHT. 55

## ROADWAY TABULATION SHEET - TOTALS

.001 4" PAVEMENT BASE DRAIN	02741 .001 ASPHALT TACK COAT SY	SY BASE COURSE, 10" DEPTH	02750 .002 REINFORCED ACCELERATED CONCRETE PAVEMENT, 8" DEPTH	202750 PLAIN CEMENT CONCRETE SY PAVEMENT, 4" DEPTH		02755 .001 ACCELERATED CONCRETE PAVEMENT SY PATCHING, AS DIRECTED	O2757 -001 TRANSVERSE JOINT CLEANING LF		.002 CONCRETE CURB	02781 .003 PLAIN CONCRETE MOUNTABLE CURB, LF	O2781 •004 CURB CHEEK WALL	02781 .005 REINFORCED CEMENT CONCRETE LF CURB, 36"	02781 • 006 CONCRETE CURB STOP		O2785 .001 REINFORCED CEMENT CONCRETE SY SIDEWALK, 4" DEPTH		NUMBER UNIT TINIT	SIDE	STATION
						2919											SUBTOTAL - FIFTH AVE - ENTIRE LENGTH		
15980	54854	4420	1679	21			1071		1272	1045		268	8		14893		SUBTOTAL - FIFTH AVE - UPTOWN  SUBTOTAL - FIFTH AVE - OAKLAND		
4840	11614	1277	32	207		3122	1931	4793	29	559	156			551	5302		SUBTOTAL - FIFTH AVE - GARLAND  SUBTOTAL - FORBES AVENUE - ENTIRE LENGTH		
8021	49431	2127	787			3122		7368	653						7403		SUBTOTAL - FORBES AVE - UPTOWN		
1153	797	 						1011				142			387		SUBTOTAL - FORBES AVE - OAKLAND		
29994	116696	7824	2498	228		6041	1931	28147	1954	1604	1353	410	8	551	27985		TOTALS		
					1			1		4B OF		I	1						

**AECOM** 

Gulf Tower 707 Grant Street 5th Floor Pittsburgh, PA 15219 THE PREPARATION OF THIS
DOCUMENT HAS BEEN FINANCED IN
PART THROUGH A GRANT FROM THE
FEDERAL TRANSIT ADMINISTRATION,
U.S. DEPARTMENT OF
TRANSPORTATION, UNDER THE
URBAN MASS TRANSPORTATION ACT
OF 1964, AS AMENDED, FOR THE
PORT AUTHORITY OF ALLEGHENY
COUNTY, PENNSYLVANIA.

(NOT FOR CONSTRUCTION)

ESIGNED	FAS	
DRAWN	<u>JMS</u>	
CHECKED	SDS	
N CHARGE	LAR	
ATE	05/01/24	
CALE		
	AS SHOWN	

# PORT AUTHORITY OF ALLEGHENY COUNTY PENNSYLVANIA

BUS RAPID TRANSIT UPTOWN TO OAKLAND ROADWAY TABULATION SHEET - TOTALS

Port Authority connecting people to life

CONTRACT NO. BRT-001

DWG. NO. GN56 SHT. 56

# ROADWAY TABULATION SHEET - TOTALS

86 EXPOSED AGGREGATE CONCRETE	86 ACCELERATED EXPOSED AGGREGATE CONCRETE, BROWN, 8" DEPTH	88 31 BRICK SURFACING	88 REMOVE AND RESET BRICK SIDEWALK		90 REMOVE, STORE AND RESET	40 11 ORNAMENTAL RAILING					13 GRANITE CURB 13 RADIUS GRANITE CURB			00 01 REMOVABLE CURB	REMARKS	SIDE	STATION
0278 .00	0278 .00 SY	0278 .00. SY	02788 .002 SY		02790 .001 SY	02840 .001 LF					.001 LF 04413	۲		0510 .00	NUMBER N N I I		
	'							'			'						
															SUBTOTAL - FIFTH AVE - ENTIRE LENGTH		
714	27	76			81	946								6	SUBTOTAL - FIFTH AVE - UPTOWN		
											296 32			3	SUBTOTAL - FIFTH AVE - OAKLAND		
															SUBTOTAL - FORBES AVENUE - ENTIRE LENGTH		
505			53												SUBTOTAL - FORBES AVE - UPTOWN		
128															SUBTOTAL - FORBES AVE - OAKLAND		
43.5	0-						<u> </u>				000	1	<u> </u>		TOTALC		
1347	27	76	53		81	946				4C OF	296 32			9	TOTALS		

**AECOM** 

Gulf Tower 707 Grant Street 5th Floor Pittsburgh, PA 15219

		THE PREPARATION OF THIS DOCUMENT HAS BEEN FINANCED IN PART THROUGH A GRANT FROM THE
		FEDERAL TRANSIT ADMINISTRATION, U.S. DEPARTMENT OF TRANSPORTATION, UNDER THE
		URBAN MASS TRANSPORTATION ACT OF 1964, AS AMENDED, FOR THE
DATE	DESCRIPTION	PORT AUTHORITY OF ALLEGHENY COUNTY, PENNSYLVANIA.
	REVISIONS	COUNTY, FENNSTEVANIA.

(NOT FOR CONSTRUCTION)

DESIGNED	FAS	
DRAWN	<u>JMS</u>	
CHECKED	SDS	
N CHARGE	LAR	
DATE	05/01/24	
SCALE		
	AS SHOWN	

# PORT AUTHORITY OF ALLEGHENY COUNTY PENNSYLVANIA

BUS RAPID TRANSIT UPTOWN TO OAKLAND ROADWAY TABULATION SHEET - TOTALS

Port Authority Connecting people to life

CONTRACT NO. BRT-001

DWG. NO. GN57 SHT. 57

26/202	5: 18: 51 AM
PLOTTED:	

6 PVC PIPE 3 PVC PIPE 4 PVC PIPE	SEWER TAP TO EXIST	02610 OVE CUT-IN WYE PIPE TRANSITION EA	02610 .006 PWSA 15" PVC PIPE, SDR 26	to Mod a littorid mat A swid	FRSA 19 " DUCITLE IRON	PWSA 6" PVC PIPE.	PWSA DRAINAGE PIPE KEMO	EA CONNECTION TO EXISTING SEWER O2610 PWSA CUT-IN WYE PIPE	TRANSITION	02615 PWSA TRENCH RESTORATION .001 (PIPE INSTALLATION)	02620 .001 THROUGH CURB RAIN LEADER LF	02633 PWSA CATCH BASIN, PWSA TYPE 13 .001 MODIFIED, WITH 3-FLANGE CAST IRON FRAME AND BICYCLE SAFE EA GRATE	02633 PWSA CATCH BASIN, PWSA TYPE 13, .002 WITH 3-FLANGE CAST IRON EA FRAME AND BICYCLE SAFE GRATE	02633 PWSA STORM INLET, PWSA TYPE 13, .005 WITH 3-FLANGE CAST IRON EA FRAME AND BICYCLE SAFE GRATE	02633 PWSA DOGHOUSE MANHOLE, WITH 0.007 MANHOLE FRAME AND COVER	02633 PWSA 4' DIAMETER PWSA MANHOLE, OOB WITH MANHOLE FRAME AND COVER EA	02633 .009 MANHOLE SA-10C, WITH EA MANHOLE FRAME AND COVER	02633 010 DWSA CORE HOLE IN EXISTING EA DRAINAGE STRUCTURE	02633 PWSA CONCRETE COLLAR FOR PIPE CONNECTION	REMARKS	SIDE	STATION
																						-
																				FIFTH AVE - UPTOWN	L T (DT	CT-10T TO 545-00
				-	7					11								1		GRADE ADJSUTMENT NOT CALLED OUT	LT/RT	START TO 515+00 434+30 TO
			3		3					11		ı	1					1	1	A14-5, A14-3	RT LT	434+30 T0 435+10/48+25 435+45
			10						1				1						'	A14-8	LT	435+00
			25	_	6	55 1	17		'				1		1				1	A14-2, A14-2A, A14-9, A14-10	RT	437+00/48+35 TO 435+25
																				A15-8	LT	435+25 438+50 T0 439+50
																				A15-9, A15-10, A15-11	RT	483+80 TO 439+45
			6			2	21						1						1	A15-1	LT	441+05
			23	3	3	36				18						1			1	A15-3, A15-7, A15-12, A15-13	RT	440+60 TO 441+40
3											41									UPTOWN WEST STATION	LT	442+00 TO 443+25
			6				9			7			1					1		A16-8, A16-9	RT	443+90 TO 444+00
				1	2					6			1						1	A16-2	LT	444+70
																				A16-10, A16-11, A16-12	RT	444+40 TO 446+55
			5										1						1	A16-7	LT	448+35
																				A16-13, A16-14, A17-9, A17-10	RT	448+35 TO 452+45
			5							8			1						1	A17-2	LT	449+60
			16	5						3		1				1			1	A17-3, A17-3A	LT	453+30 TO 453+35
			20	o									1			1			1	A17-6, A17-8	RT	453+25 T0 453+30
																				A18-5, A18-6, A18-7	RT	454+60 TO 455+80
15																				PRIDE STREET STATION	LT	455+50 TO 456+00
			18	3												1			1	A18-1, A18-1A	RT	457+10 TO 457+25
			8							10			1						1	A18-2	LŤ	457+10

**AECOM** Gulf Tower 707 Grant Street 5th Floor Pittsburgh, PA 15219

		THE PREPARATION OF THIS DOCUMENT HAS BEEN FINANCED IN PART THROUGH A GRANT FROM THE FEDERAL TRANSIT ADMINISTRATION.
		U.S. DEPARTMENT OF
		TRANSPORTATION, UNDER THE
		URBAN MASS TRANSPORTATION ACT
DATE	DESCRIPTION	OF 1964, AS AMENDED, FOR THE PORT AUTHORITY OF ALLEGHENY COUNTY, PENNSYLVANIA.
	REVISIONS	COUNTY, PENNOTEVANIA.

(NOT FOR CONSTRUCTION)

ESIGNED	<u>MRM</u>	
DRAWN	<u>JMS</u>	
CHECKED	DJC	
N CHARGE	LAR	
ATE	05/01/24	
CALE		
	AS SHOWN	

# PORT AUTHORITY OF ALLEGHENY COUNTY PENNSYLVANIA

BUS RAPID TRANSIT UPTOWN TO OAKLAND DRAINAGE TABULATION SHEET

Por

rt	Authority	CONTRACT NO. BRT-00	)1	
	connecting people to life	dwg. no. GN58	SHT.	58

02633 PWSA CLEANING DRAINAGE • 012 STRUCTURES	02633 •013 PWSA CLEANING DRAINAGE PIPE LF	02633 PWSA DRAINAGE STRUCTURE EA REMOVAL			02633 PWSA CATCH BASIN, PWSA TYPE •018	O2633 PWSA RECESSED CATCH BASIN EA CONVERSION	O2633 PWSA CATCH BASIN, PWSA TYPE 13 .020 REVERSE MODIFIED, WITH 3-FLANGE CAST IRON FRAME AND BICYCLE EA SAFE GRATE	02635 PWSA SIDEWALK TRENCH DRAIN .001 WITH ADA COMPLIANT AND BICYCLE LF SAFE GRATE		02637 PWSA CRADE AD.HISTMENT OF	EXISTING PWSA MANHOLE	02637 PWSA GRADE ADJUSTMENT OF .002 EXISTING SET PWSA INLET	02639 PWSA REBUILT INLET BOX WITH .003 MANHOLE TOP	02640 .001 STORWWATER MANAGEMENT SYSTEM	REMARKS	SIDE	STATION
									$\perp$								
																-	-
																-	
															FIFTH AVE - UPTOWN		
											51				GRADE ADJSUTMENT NOT CALLED OUT	LT/RT	START TO 515+00
1															A14-5, A14-3	RT	434+30 T0 435+10/48+25
	18														A14-7	LT	435+45
	8	1													A14-8	LŤ	435+00
1								73							A14-2, A14-2A, A14-9, A14-10	RT	437+00/48+35 T0 435+25
								67							A15-8	LT	438+50 TO 439+50
	15	1													A15-9, A15-10, A15-11	RT	483+80 TO 439+45
	18	1													A15-1	LT	441+05
		1					1	49							A15-3, A15-7, A15-12, A15-13	RT	440+60 TO 441+40
															UPTOWN WEST STATION	LT	442+00 TO 443+25
1		1									1				A16-8, A16-9	RT	443+90 TO 444+00
	17	1													A16-2	LT	444+70
								217							A16-10, A16-11, A16-12	RT	444+40 TO 446+55
	28														A16-7	LT	448+35
								413							A16-13, A16-14, A17-9, A17-10	RT	448+35 TO 452+45
	23	1													A17-2	LT	449+60
	35	1													A17-3, A17-3A	LT	453+30 TO 453+35
	7	1													A17-6, A17-8	RT	453+25 TO 453+30
								125							A18-5, A18-6, A18-7	RT	454+60 TO 455+80
															PRIDE STREET STATION	LT	455+50 TO 456+00
	13														A18-1, A18-1A	RT	457+10 TO 457+25
	22	1													A18-2	LŤ	457+10

**AECOM** Gulf Tower 707 Grant Street 5th Floor Pittsburgh, PA 15219

			THE PREPARATION OF THIS DOCUMENT HAS BEEN FINANCED I
			PART THROUGH A GRANT FROM TI
			FEDERAL TRANSIT ADMINISTRATION OF
			TRANSPORTATION, UNDER THE
			URBAN MASS TRANSPORTATION A OF 1964. AS AMENDED, FOR THE
٥.	DATE	DESCRIPTION	PORT AUTHORITY OF ALLEGHENY COUNTY, PENNSYLVANIA.
		REVISIONS	COUNTY, PENNSTEVANIA.

(NOT FOR CONSTRUCTION)

ESIGNED	MRM	
DRAWN	<u>JMS</u>	
CHECKED	DJC	
N CHARGE	LAR	
ATE	05/01/24	
CALE		
	AS SHOWN	

# PORT AUTHORITY OF ALLEGHENY COUNTY PITTSBURGH PENNSYLVANIA

BUS RAPID TRANSIT UPTOWN TO OAKLAND DRAINAGE TABULATION SHEET

Port Authority connecting people to life

CONTRACT NO. BRT-001 DWG. NO. GN59 sнт. 59

0 1 6" PVC PIPE, SDR 26	2 3" PVC PIPE, SDR 26	3 4" PVC PIPE, SDR 26 4 SEWER TAP TO EXISTING SEWER	no	6 PWSA 15" PVC PIPE, SDR 26	7 PWSA 15" DUCTILE IRON PIPE	0 8 PWSA 6" PVC PIPE, SDR 26	PWSA DRAINAGE PIPE REMOVAL	O PWSA CORED WYE OR TEE CONNECTION TO EXISTING SEWER	D PWSA CUT-IN WYE PIPE TRANSITION	1 PWSA TRENCH RESTORATION (PIPE INSTALLATION)	O THROUGH CURB RAIN LEADER	33 PWSA CATCH BASIN, PWSA TYPE 13 1 MODIFIED, WITH 3-FLANGE CAST 1 IRON FRAME AND BICYCLE SAFE GRATE		5 WITH 3-FLANGE CAST IRON FRAME AND BICYCLE SAFE GRATE	7 PWSA DOGHOUSE MANHOLE, WITH MANHOLE FRAME AND COVER	8 PWSA 4' DIAMETER PWSA MANHOLE, WITH MANHOLE FRAME AND COVER	9 PWSA MANHOLE SA-10C, WITH MANHOLE FRAME AND COVER	MSA CORE HOLE IN EXISTING DRAINAGE STRUCTURE	1 CONNECTION	REMARKS	SIDE	STATION
02610 .001 LF	02610 .002 LF	02610 .003 EA 02610	0261 .00	02610 .006 LF	02610 .007 LF	02610 .008 LF	02610 .009	02610 .014 EA	02610 .015 EA	02615 .001 LF	02620 .001 LF	02633 .001 EA	0263 .00 .EA	02633 .005 EA	02633 .007 EA	0263 .00 EA	0263	0263 .01	02633 .011 EA			
																				FIFTH AVE - UPTOWN		
																				A18-11, A18-12, A19-9	RT	457+45 TO 458+65
				33			3			7			2		1					A19-2, A19-3, A19-4	LT	459+90 TO 460+15
				30		70		1					1				1			A19-10, A19-11, A19-12, A19-13, A19-14, A19-6, A19-5	RT	459+85 TO 460+65
				4						7			1						1	A19-8	LT	463+30
																				A19-15, A19-16, A20-9	RT	464+35 TO 465+05
				19									1			1			1	A20-1, A20-2	RT	466+20 TO 466+30
				337		50	17					1	1	1				1		A20-3, A20-4, A20-7, A20-10, A20-11, A21-1, A21-2, A21-3, A21-4	RT	467+45 TO 472+05
	22						_			_										UPTOWN CENTRAL STATION	LT	467+80 TO 468+15
				6			8			7			1					1		A20-6, A20-6A	RT	468+90 TO 467+00
																				A21-6, A21-7, A21-8, A21-9	RT	472+60 TO 473+92
																				A21-10, A21-11, A21-12	RT	474+40 TO 474+90
		100		14		40	4						1		1					A21-13, A22-10, A22-1, A22-1A	LT . +	475+35 TO 477+50
80		106 1																		JUMONVILLE ST STATION, A22-24, -25, -26, -27, -28, -29, -30		476+20 TO 476+60
				7		26	8			11									1	A22-5, A22-6, A22-2	RT	476+39 TO 477+20
						4.7	1.0			10						4				A22-9, A22-8, A22-7	LT	478+25 TO 479+75
				52		13	16			12			1			1			1	A22-11, A23-4, A23-2, A23-1A	RT LT	
				12			40		1				'						1	A23-5 A24-9 A24-5 9 A24-2 A24-1A	RT	482+55 483+00 TO 486+05
				12			40		'											A23-5, A24-9, A24-5 & A24-2, A24-1A  A24-1 & A24-3	LT	485+00 TO 486+05 486+35 TO 486+80
																				A24-1 & A24-3 A24-4	LT	487+30
				10			24						1		1					A24-4 A24-6 & A24-7, A24-8	LT	489+00 TO 489+45
				10			8						'		'					A25-1	LT	490+65
				43			10						1						1	A25-2, A25-2A	RT	497+95 TO 491+35
				12			12		1				1						'	A25-5, A25-5A	LT	491+50 TO 491+65
							'-						<u>'</u>							A25-6	LT	492+15 TO 492+45
														2A OF	13B	<u> </u>				1		

**AECOM** Gulf Tower 707 Grant Street 5th Floor Pittsburgh, PA 15219

			THE PREPARATION OF THIS
			DOCUMENT HAS BEEN FINANCED II
			PART THROUGH A GRANT FROM TH
			FEDERAL TRANSIT ADMINISTRATIO
			TRANSPORTATION, UNDER THE
			URBAN MASS TRANSPORTATION AG OF 1964, AS AMENDED, FOR THE
э.	DATE	DESCRIPTION	PORT AUTHORITY OF ALLEGHENY COUNTY, PENNSYLVANIA.
		REVISIONS	COUNTY, PENNSTEVANIA.

(NOT FOR CONSTRUCTION)

DESIGNED	<u>MRM</u>	
DRAWN	<u>JMS</u>	
CHECKED	DJC	
IN CHARGE	<u>LAR</u>	
DATE	05/01/24	
SCALE		
	AS SHOWN	

# PORT AUTHORITY OF ALLEGHENY COUNTY PITTSBURGH PENNSYLVANIA

BUS RAPID TRANSIT UPTOWN TO OAKLAND DRAINAGE TABULATION SHEET

Port Authority connecting people to life

CONTRACT NO. BRT-001 DWG. NO. GN60 sнт. 60

000	707/97	5: 19: 03 AM
+	FLUI EU:	

# oseph.silich" o:^pwworking/aecom\_ds16\_na/joseph.silich@aecom.com\d0207700\BRT\_01\_RD\_TAB28.dgn

# DRAINAGE TABULATION SHEET

	PWSA CLEANING DRAINAGE STRUCTURES	PWSA CLEANING DRAINAGE PIPE	3 PWSA DRAINAGE STRUCTURE REMOVAL				CONVERSION PWSA CATCH BASIN, PY REVERSE MODIFIED, WII CASI IRON FRAME AND		5 PWSA SIDEWALK TRENCH DRAIN WITH ADA COMPLIANT AND BICYCLE SAFE GRATE	7 PWSA GRADE ADJUSTMENT OF EXISTING PWSA MANHOLE	7 PWSA GRADE ADJUSTMENT OF EXISTING PWSA INLET			MANHOLE TOP	STORMWATER MANAGEMENT SYSTEM FOR KIRKPATRICK PARKING LOT		REMARKS	SIDE	STATION
55900	.012 EA	. 013 LF	0263 014 EA			02633 . 018 EA	EA 02633 . 020	п 4	.001 LF	02637 • 001	02637 .002 SET			02639 .003 EA	02640 .001 EA				
													'			'			
																	FIFTH AVE - UPTOWN		
									123								A18-11, A18-12, A19-9	RT	457+45 TO 458+65
		31	1														A19-2, A19-3, A19-4	LT	459+90 TO 460+15
									26								A19-10, A19-11, A19-12, A19-13, A19-14, A19-6, A19-5	RŤ	459+85 TO 460+65
		30															A19-8	LT	463+30
									77								A19-15, A19-16, A20-9	RT	464+35 TO 465+05
		4	1														A20-1, A20-2	RT	466+20 TO 466+30
	1		1						332	1							A20-3, A20-4, A20-7, A20-10, A20-11, A21-1, A21-2, A21-3, A21-4	RT	467+45 TO 472+05
_    _																	UPTOWN CENTRAL STATION	LT	467+80 TO 468+15
%	1	20	1							1							A20-6, A20-6A	RT	468+90 TO 467+00
TAB28.									135								A21-6, A21-7, A21-8, A21-9	RT	472+60 TO 473+92
-ga-									53								A21-10, A21-11, A21-12	RT	474+40 TO 474+90
T_ 01			1						181								A21-13, A22-10, A22-1, A22-1A	LT	475+35 TO 477+50
900\BR																	JUMONVILLE ST STATION, A22-24, -25, -26, -27, -28, -29, -30	LT	476+20 TO 476+60
4020770		38	1						61								A22-5, A22-6, A22-2	RT	476+39 TO 477+20
70p/u									157								A22-9, A22-8, A22-7	LT	478+25 TO 479+75
- Co		31	1						339								A22-11, A23-4, A23-2, A23-1A	RT	479+75 TO 482+20
i deco		8	1														A23-3	LT	482+55
ich@			1						 303								A23-5, A24-9, A24-5 & A24-2, A24-1A	RT	483+00 TO 486+05
-   L	2	30									2						A24-1 & A24-3	LT	486+35 TO 486+80
seph	1	20									1						A24-4	LŤ	487+30
	1	8	3								1						A24-6 & A24-7, A24-8	LT	489+00 TO 489+45
16_r.	1		1								1						A25-1	LŤ	490+65
Jm. ds		24	1											1			A25-2, A25-2A	RT	497+95 TO 491+35
) decc			2														A25-5, A25-5A	LT	491+50 TO 491+65
(sing)	1	50					1										A25-6	LT	492+15 TO 492+45
wor						<u> </u>				21	B OF 13E	3					DODT AUTHORIT		

**AECOM** 

Gulf Tower 707 Grant Street 5th Floor Pittsburgh, PA 15219

		THE PREPARATION OF THIS DOCUMENT HAS BEEN FINANCED IN PART THROUGH A GRANT FROM THE FEDERAL TRANSIT ADMINISTRATION, U.S. DEPARTMENT OF TRANSPORTATION, UNDER THE URBAN MASS TRANSPORTATION ACT OF 1964. AS AMENDED, FOR THE
DATE	DESCRIPTION	PORT AUTHORITY OF ALLEGHENY
	REVISIONS	COUNTY, PENNSYLVANIA.

(NOT FOR CONSTRUCTION)

ESIGNED	MRM	
DRAWN	<u>JMS</u>	
CHECKED	DJC	
N CHARGE	LAR	
ATE	05/01/24	
CALE		
	AS SHOWN	

# PORT AUTHORITY OF ALLEGHENY COUNTY PENNSYLVANIA

BUS RAPID TRANSIT UPTOWN TO OAKLAND

DRAINAGE TABULATION SHEET

ort	Authority	
VIL	connecting people to life	

CONTRACT NO. BRT-001

DWG. NO. GN61 SHT. 61

70000	3/26/2024	5:19:07 AM
	FLU I EU	

ppn.siilan" pwworking\aecom_ds16_na\joseph.siilch@aecom.com\d0207700\BRT_01_RD_TAB29.dgn 			
ph.silian" wworking\aecom_ds16_na\joseph.silich@aecom.com\d0207700\BRT_01_RD_		.TAB29. dgn	
on.silion" wworking/aecom_ds16_na\joseph.silich@aecom.com\d0207		700\BRT_01_RD.	
on.silion" wworking\aecom_ds16_na\joseph.silich@a		ecom.com\d0207	
on.silich" vwworking\decom_ds16_na\jc T		seph.silich@a	
on.silich" wworking\dec		om_ds16_na∖jo	
	.uo!!!s	wworking\aec	

DRAINAGE	TARIII A	NOITA	SHEET
DNAINAGE		<b>1</b>	$\cup$

6" PVC PIPE, SDR 26	3" PVC PIPE, SDR 26	4" PVC PIPE, SDR 26	SEWER TAP TO EXISTING SEWER WYE	CUT-IN WYE PIPE TRANSITION	PWSA 15" PVC PIPE, SDR 26		PWSA 15" DUCTILE IRON PIPE	PWSA 6" PVC PIPE. SDR 26	PWSA DRAINAGE PIPE REMOVAL	PWSA CORED WYE OR TEE CONNECTION TO EXISTING SEWER	PWSA CUT-IN WYE PIPE TRANSITION	PWSA TRENCH RESTORATION (PIPE INSTALLATION)	THROUGH CURB RAIN LEADER	; PWSA CATCH BASIN, PWSA TYPE 13 MODIFIED, WITH 3-FLANGE CAST IRON FRAME AND BICYCLE SAFE GRATE	PWSA CATCH BASIN, PWSA TYPE 13, WITH 3-FLANGE CAST IRON FRAME AND BICYCLE SAFE GRATE	PWSA STORM INLET, PWSA TYPE 13, WITH 3-FLANGE CAST IRON FRAME AND BICYCLE SAFE GRATE	PWSA DOGHOUSE MANHOLE, WITH MANHOLE FRAME AND COVER	PWSA 4' DIAWETER PWSA MANHOLE, WITH MANHOLE FRAME AND COVER	PWSA MANHOLE SA-10C, WITH MANHOLE FRAME AND COVER	PWSA CORE HOLE IN EXISTING DRAINAGE STRUCTURE	PWSA CONCRETE COLLAR FOR PIPE CONNECTION		REMARKS S	SIDE	STATION
02610 .001 LF	02610 .002 LF	02610 .003 EA	2610 004 EA	02610 .005 EA	2610 006	LF 02610	007 LF	02610 .008 LF	02610 .009 LF	2610 014	02610 .015 EA	02615 .001 LF	02620 .001 LF	2633 001 EA	02633 .002 EA	2633 005 EA	2633 007 EA	02633 .008 EA	02633 .009 EA	2633 010 FA	02633 .011 EA				
8.	9.	ö ·	8.	8 •	8 •	Ö	1	ö •	8.	9 .	8 1	9.		8.	ö ·	8.	8 1	S •	8.	8.	9 .				
																							FIFTH AVE - UPTOWN		
108		144	1																				SOHO STATION- A25-8,-9,-10,-11,-12,-13,-14	RT	491+80 TO 492+30
					7									1							1		A25-7	LT	494+50
					16									2							2		A26-1 & A26-2	LT	496+90 TO 497+35
																							A26-3	RT	497+45
					7									1							1		A26-4	LT	500+50
																							A26-5	RT	501+90
																							A27-1	RT	503+45
					22										2						2		A27-3 & A27-4	LT	504+40 TO 504+85
						1	110								1		1						A28-5, A28-6	RT	511+80 TO 512+95
																							FIFTH AVE - OAKLAND		
					25				32	1		25			1				1				·	RT	515+05 T0 515+30
81		108		1																			WEST OAKLAND STATION, A29-4, -5, -6, -7, -8, -9, -10	LT	516+90 TO 517+15
																							A29-11	LT	517+15
					6										1						1			LT	527+20
94		124	1																				CHESTERFIELD ROAD STATION, A31-1, -2, -3, -4, -5, -6, -7	LT	527+40 TO 527+80
								14															A32-3, A33-4, A33-1, A33-5, A33-6	LT	533+80 TO 535+55
																							A33-11, A33-12, A33-13	LT	538+15 TO 538+30
					11				5			6			1						1			LT	543+00
70		104	1																				BIGELOW BOULEVARD STAION, A35-1, -2, -3, -4, -5, -6, -7	LT	550+95 TO 551+70
					9				15			8					1						A36-2, A36-3	LT	553+00 T0 553+15
					7				15		1				1								A36-6, A36-7	LT	554+70
					6				3			8			1						1		A37-8	LT	557+50
					14				5					1						1			A37-12, A37-13	LT	560+35 TO 560+25
																							GRADE ADJSUTMENT NOT CALLED OUT	T/RT	515+00 TO END

**AECOM** Gulf Tower 707 Grant Street 5th Floor Pittsburgh, PA 15219

			THE DREDADATION OF THE
			THE PREPARATION OF THIS DOCUMENT HAS BEEN FINANCED IN
			PART THROUGH A GRANT FROM THE
			FEDERAL TRANSIT ADMINISTRATION, U.S. DEPARTMENT OF
			TRANSPORTATION, UNDER THE
			URBAN MASS TRANSPORTATION ACT OF 1964, AS AMENDED, FOR THE
ο.	DATE	DESCRIPTION	PORT AUTHORITY OF ALLEGHENY COUNTY, PENNSYLVANIA.
		REVISIONS	COUNTY, FEMNOTEVANIA.

(NOT FOR CONSTRUCTION)

ESIGNED	MRM	P(
RAWN	<u>JMS</u>	PIT
HECKED	DJC	
CHARGE	LAR	
ATE	<u>05/01/24</u>	
CALE	AS SHOWN	Port

# PORT AUTHORITY OF ALLEGHENY COUNTY PENNSYLVANIA BUS RAPID TRANSIT UPTOWN TO OAKLAND

DRAINAGE TABULATION SHEET

sнт. 62

D. BRT-001

ł	Authority	CONTR	RACT NO.
•	connecting people to life	DWG, NO.	GN62

3/26/2024	c
PLOTTED:	

oh. s i i i ch "	.pwwork ing\aecom_ds16_na\joseph.silich@aecom.com\d0207700\BRT_01_RD_TAB30.dgn	
ᇦ	φ	١

PWSA CLEANING DRAINAGE STRUCTURES	PWSA CLEANING DRAINAGE PIPE	PWSA DRAINAGE STRUCTURE REMOVAL		PWSA CATCH BASIN, PWSA TYPE	FRAME AND BICYCLE SAFE GRATE PWSA RECESSED CATCH BASIN CONVERSION	PWSA CATCH BASIN, PWSA TYPE 13 REVERSE MODIFIED, WITH 3-FLANGE CAST IRON FRAME AND BICYCLE SAFE GRATE	PWSA SIDEWALK TRENCH DRAIN WITH ADA COMPLIANT AND BICYCLE SAFE GRATE	PWSA GRADE ADJUSTMENT OF EXISTING PWSA MANHOLE	PWSA GRADE ADJUSTMENT OF EXISTING PWSA INLET	PWSA REBUILT INLET BOX WITH MANHOLE TOP	STORWWATER MANAGEMENT SYSTEM FOR KIRKPATRICK PARKING LOT	REMARKS	SIDE	STATION
02633 012 EA	.013 LF	02633 .014 EA		02633	EA .019	02633 P	02635 .001 LF	)2637 .001	02637 .002 SET	02639 .003 EA	02640 .001 EA			
												FIFTH AVE - UPTOWN		
												SOHO STATION- A25-8,-9,-10,-11,-12,-13,-14	RT	491+80 TO 492+30
	6	1										A25-7	LT	494+50
	12	2										A26-1 & A26-2	LT	496+90 TO 497+35
1	65				1							A26-3	RT	497+45
	6	1										A26-4	LT	500+50
1	65				1							A26-5	RT	501+90
1	50				1							A27-1	RT	503+45
	12	2										A27-3 & A27-4	LT	504+40 TO 504+85
	31	1										A28-5, A28-6	RT	
												FIFTH AVE - OAKLAND		
		1										A29-2, A29-3	RT	515+05 TO 515+30
												WEST OAKLAND STATION, A29-4, -5, -6, -7, -8, -9, -10	LT	516+90 TO 517+15
1	6								1			A29-11	LT	517+15
	6	1										A31-8	LŤ	527+20
												CHESTERFIELD ROAD STATION, A31-1, -2, -3, -4, -5, -6, -7	LT	527+40 TO 527+80
1	16				1		162					A32-3, A33-4, A33-1, A33-5, A33-6	LT	533+80 TO 535+55
							101					A33-11, A33-12, A33-13	LT	538+15 TO 538+30
	6	1										A34-1	LT	543+00
												BIGELOW BOULEVARD STAION, A35-1, -2, -3, -4, -5, -6, -7	LT	550+95 TO 551+70
		1		1								A36-2, A36-3	LT	553+00 T0 553+15
		1										A36-6, A36-7	LT	554+70
	15	1										A37-8	LT	557+50
1		1						1				A37-12, A37-13	LT	560+35 TO 560+25
								13				 GRADE ADJSUTMENT NOT CALLED OUT	LT/RT	515+00 TO END
									3B OF 13B					

Gulf Tower 707 Grant Street 5th Floor Pittsburgh, PA 15219

			THE PREPARATION OF THIS DOCUMENT HAS BEEN FINANCED IN
			PART THROUGH A GRANT FROM THE
			FEDERAL TRANSIT ADMINISTRATION, U.S. DEPARTMENT OF
			TRANSPORTATION, UNDER THE
			URBAN MASS TRANSPORTATION ACT OF 1964, AS AMENDED, FOR THE
ο.	DATE	DESCRIPTION	PORT AUTHORITY OF ALLEGHENY COUNTY, PENNSYLVANIA.
		REVISIONS	COUNTY, FERNISTEVANIA.

(NOT FOR CONSTRUCTION)

DESIGNED	MRM	PORT
DRAWN	<u>JMS</u>	PITTSBURG
CHECKED	DJC	BUS
IN CHARGE	LAR	
DATE	05/01/24	
SCALE	AS SHOWN	Port Au

# ORT AUTHORITY OF ALLEGHENY COUNTY TITSBURGH PENNSYLVANIA PLIS PADID TRANSIT LIDTOWN TO CAKLAND

US RAPID TRANSIT UPTOWN TO OAKLAND
DRAINAGE TABULATION SHEET

Port	Autho	rity	
016	connecting peo	ple to life	

CONTRACT NO. BRT-001

DWG. NO. GN63 SHT. 63

6" PVC PIPE, SDR 26	3" PVC PIPE, SDR 26	4" PVC PIPE, SDR 26	SEWER TAP TO EXISTING SEWER	CUT-IN WYE PIPE TRANSITION	PWSA 15" PVC PIPE, SDR 26	PWSA 15" DUCTILE IRON PIPE	PWSA 6" PVC PIPE. SDR 26	PWSA DRAINAGE PIPE REMOVAL	PWSA CORED WYE OR TEE CONNECTION TO EXISTING SEWER	PWSA CUT-IN WYE PIPE TRANSITION	PWSA TRENCH RESTORATION (PIPE INSTALLATION)	THROUGH CURB RAIN LEADER	PWSA CATCH BASIN, PWSA TYPE 13 MODIFIED, WITH 3-FLANGE CAST IRON FRAME AND BICYCLE SAFE GRATE	PWSA CATCH BASIN, PWSA TYPE 13, WITH 3-FLANGE CAST IRON FRAME AND BICYCLE SAFE GRATE	PWSA STORM INLET, PWSA TYPE 13, WITH 3-FLANGE CAST IRON FRAME AND BICYCLE SAFE GRATE	PWSA DOGHOUSE MANHOLE, WITH MANHOLE FRAME AND COVER	PWSA 4' DIAMETER PWSA MANHOLE, WITH MANHOLE FRAME AND COVER	PWSA MANHOLE SA-10C, WITH MANHOLE FRAME AND COVER	PWSA CORE HOLE IN EXISTING DRAINAGE STRUCTURE	PWSA CONCRETE COLLAR FOR PIPE CONNECTION	REMARKS	SIDE	STATION
02610	02610 .002	02610 .003 EA	02610 .004 EA	02610 .005 EA	02610 .006 LF	02610 .007 LF	02610 .008 LF	02610 .009	02610 .014 EA	02610 .015 EA	.02615 .001 LF	02620 .001 LF	02633 .001 EA	02633 .002 EA	02633 .005 EA	02633 .007 EA	02633 .008 EA	02633 .009 EA	02633 .010 EA	02633 .011 EA			
																					FIFTH AVE - OAKLAND		
96		128	1																		TENNYSON AVENUE STATION, A37-14, -15, -16, -17, -18, -19, -20	LT	560+50 TO 560+95
					7									1						1	A38-2	LT	563+30
																					SIDE STREETS		
																					DIAMOND STREET		
																					A14-1	RT	48+05
																					WASHINGTON PLACE		
					17			8			20			1	1					2	A15-5 TO A15-4	LT/RT	25+55 TO 25+40
					10															<u> </u>	CHATHAM SQUARE		07:05
					12									1						1	A15-6	LT	23+85
																					MAGEE STREET		
					27			5			10			2						2	A16-3 & A16-4	LT/RT	36+40
					21							+ +							1		ALO WATO T	C17101	30.10
																					LOGAN STREET		
					5								1							1	A17-1	LT	20+35
																					PRIDE STREET		
					6						7			1						1		LT / RT	30+30 TO 30+55
																					VINE STREET		
					12								1							1	A19-1	LT	30+35

**AECOM** Gulf Tower 707 Grant Street 5th Floor Pittsburgh, PA 15219

			THE PREPARATION OF THIS DOCUMENT HAS BEEN FINANCED I
			PART THROUGH A GRANT FROM TI
			FEDERAL TRANSIT ADMINISTRATION OF
			TRANSPORTATION, UNDER THE
			URBAN MASS TRANSPORTATION A OF 1964, AS AMENDED, FOR THE
٥.	DATE	DESCRIPTION	PORT AUTHORITY OF ALLEGHENY COUNTY, PENNSYLVANIA.
		REVISIONS	COUNTY, FEMINISTEVANIA.

(NOT FOR CONSTRUCTION)

DESIGNED	<u>MRM</u>	
DRAWN	<u>JMS</u>	
CHECKED	DJC	
IN CHARGE	LAR	
DATE	05/01/24	
SCALE		
	AS SHOWN	

# PORT AUTHORITY OF ALLEGHENY COUNTY PENNSYLVANIA BUS RAPID TRANSIT UPTOWN TO OAKLAND

DRAINAGE TABULATION SHEET

Port Authority connecting people to life

CONTRACT NO. BRT-001 DWG. NO. GN64 sнт. 64

PWSA	MSA CLEANING DRAINAGE	PWSA DRAINAGE STRUCTURE		3 PWSA CATCH BASIN, PWSA TYPE 3 13, 13 WITH 4-FLANGE CAST IRON FRAME AND BICYCLE SAFE GRATE	3 PWSA RECESSED CATCH BASIN CONVERSION PWSA CATCH BASIN PWSA TVE	SAFE GRATE AND BICYCLE SAFE GRATE	5 PWSA SIDEWALK TRENCH DRAIN WITH ADA COMPLIANT AND BICYCLE SAFE GRATE	7 PWSA GRADE ADJUSTMENT OF EXISTING PWSA MANHOLE	7 PWSA GRADE ADJUSTMENT OF EXISTING PWSA INLET	MANHOLE TOP INLET BOX WI	STORMWATER MANAGEMENT SYSTEM FOR KIRKPATRICK PARKING LOT		REMARKS	SIDE	STATION
02633 .012 EA	. 013 LF	0263 . 014 EA		0263 . 018 EA	02633 .019 EA	. 020 . 020 EA	02635 .001 LF	0263 .00	02637 .002 SET	02639 .003 EA	02640 .001 EA				
												'			
													FIFTH AVE - OAKLAND		
													TENNYSON AVENUE STATION, A37-14, -15, -16, -17, -18, -19, -20	LT	560+50 T0 560+95
	6	1											A38-2	LT	563+30
													SIDE STREETS		
													DIAMOND STREET		
1									1				A14-1	RT	48+05
													WASHINGTON PLACE		
	80	1											A15-5 TO A15-4	LT/RT	25+55 TO 25+40
													CHATHAM SQUARE		
	9	1											A15-6	LT	23+85
													MAGEE STREET		
	34	2											A16-3 & A16-4	LT/RT	36+40
													LOGAN STREET		
	41												A17-1	LT	20+35
													PRIDE STREET		
	32	1							1				A18-3 & A18-4	LT / RT	30+30 TO 30+55
													VINE STREET		
	35												A19-1	LT	30+35

Gulf Tower
707 Grant Street
5th Floor
Pittsburgh, PA 15219

			THE PREPARATION OF THIS DOCUMENT HAS BEEN FINANCED IN
			PART THROUGH A GRANT FROM THE
			FEDERAL TRANSIT ADMINISTRATION, U.S. DEPARTMENT OF
			TRANSPORTATION, UNDER THE
			URBAN MASS TRANSPORTATION ACT OF 1964, AS AMENDED, FOR THE
ο.	DATE	DESCRIPTION	PORT AUTHORITY OF ALLEGHENY COUNTY, PENNSYLVANIA.
		REVISIONS	COUNTY, PENNOTEVANIA.

(NOT FOR CONSTRUCTION)

DESIGNED	MRM	
DRAWN	<u>JMS</u>	
CHECKED	DJC	
N CHARGE	LAR	
DATE	05/01/24	
SCALE		
	AS SHOWN	

# PORT AUTHORITY OF ALLEGHENY COUNTY PENNSYLVANIA BUS RAPID TRANSIT UPTOWN TO OAKLAND

US RAPID TRANSIT UPTOWN TO OAKLAND
DRAINAGE TABULATION SHEET

Port Authority Connecting people to life

CONTRACT NO. BRT-001

DWG. NO. GN65 SHT. 65

3/26/2024	19:25
PLOTTED:	

# silich" vorking\aecom\_ds16\_na\joseph.silich@aecom.com\d0207700\BRT\_01\_RD\_TAB33.dgn

# DRAINAGE TABULATION SHEET

6" PVC PIPE, SDR 26	4" PVC PIPE, SDR	SEWER TAP TO EXISTING SEWER	10 5 CUT-IN WYE PIPE TRANSITION		6 PWSA 15" PVC PIPE, SDR 26	10 PWSA 15" DUCTILE IRON PIPE	10 8 PWSA 6" PVC PIPE. SDR 26	10 19 PWSA DRAINAGE PIPE REMOVAL	PWSA CORED WYE OR TEE CONNECTION TO EXISTING SEWER	10 5 PWSA CUT-IN WYE PIPE TRANSITION		PWSA TRENCH RESTORATION (PIPE INSTALLATION)	20 11 THROUGH CURB RAIN LEADER	33 PWSA CATCH BASIN, PWSA TYPE 13 MODIFIED, WITH 3-FLANGE CAST IRON FRAME AND BICYCLE SAFE GRATE	2 PWSA CATCH BASIN, PWSA TYPE 13, WITH 3-FLANGE CAST IRON FRAME AND BICYCLE SAFE GRATE	PWSA STORM INLET, PWSA TYPE 13, WITH 3-FLANGE CAST IRON FRAME AND BICYCLE SAFE GRATE	PWSA DOGHOUSE MANHOLE, WITH MANHOLE FRAME AND COVER	PWSA 4' DIAMETER PWSA MANHOLE, WITH MANHOLE FRAME AND COVER	PWSA MANHOLE SA-10C, WITH MANHOLE FRAME AND COVER	33 PWSA CORE HOLE IN EXISTING O DRAINAGE STRUCTURE	33 PWSA CONCRETE COLLAR FOR PIPE CONNECTION		REMARKS	SIDE	STATION
02610 .001 LF 02610	0261 .00	0267 • 00 EA	02610 .005 EA	02610		02610 .007 LF	02610 .008 LF	02610 .009	02610 .014	02610 .015 EA		02615 .001 LF	02620 .001 LF	02633 .001	0263 .00	02633 .005 EA	0267 • 00 EA	0267 .00	0263 .00	0267	EA .011 EA				
																							SIDE STREETS		
																							DINWIDDIE STREET		
					6							8			1						1		A20-5	LT	20+35
																							WYANDOTTE STREET		
																							A22-4	RT	30+50
																							KIRKPATRICK STREET		
					8				1						1								A25-4, A25-4A & A25-3A & A25-3	LT	30+95 TO 30+75
																							KIRKPATRICK STREET PARKING LOT	RT	30+90 T0 39+25
																							WAKEE BLAGE		
					17							14											MCKEE PLACE	1.7	10.05
					13							14			1						<u>'</u>		A32-1	LT	16+65
																							LYTTON AVENEUE		
					7										1						1		A37-5	RT	40+55
					•										<u>'</u>						'		701.0	111	.5.00
					$\dashv$																		NORTH BELLFIELD AVENUE		
																							A38-3	LT	61+55
					+																				
					$\dashv$																				
		+																							
			1				1				1	1			1	5A OF	13B		1	1		ı	1	I	

**AECOM** 

Gulf Tower 707 Grant Street 5th Floor Pittsburgh, PA 15219

DATE	DESCRIPTION	THE PREPARATION OF THIS DOCUMENT HAS BEEN FINANCED IN PART THROUGH A GRANT FROM THE FEDERAL TRANSIT ADMINISTRATION, U.S. DEPARTMENT OF TRANSPORTATION, UNDER THE URBAN MASS TRANSPORTATION ACT OF 1964, AS AMENDED, FOR THE PORT AUTHORITY OF ALLEGHENY
DATE	DESCRIPTION	PORT AUTHORITY OF ALLEGHENY COUNTY, PENNSYLVANIA.
	REVISIONS	COUNTY, PENINSTEVANIA.

(NOT FOR CONSTRUCTION)

DESIGNED	MRM	
DRAWN	JMS	
CHECKED	DJC	
N CHARGE	LAR	
DATE	05/01/24	
SCALE		
	AS SHOWN	

# PORT AUTHORITY OF ALLEGHENY COUNTY PENNSYLVANIA

BUS RAPID TRANSIT UPTOWN TO OAKLAND

DRAINAGE TABULATION SHEET

Port Authority connecting people to life

CONTRACT NO. BRT-001

DWG. NO. GN66 SHT. 66

CLEANING	PWSA DRAINAGE STRUCTURE	REMOVAL				02633 PWSA CATCH BASIN, PWSA TYPE .018 WITH 4-FLANGE CAST IRON EA FRAME AND BICYCLE SAFE GRATE	19 PWSA RECESSED CATCH BASIN CONVERSION A	PWSA CATCH BASIN, PWSA TYPE 13 20 REVERSE MODIFIED, WITH 3-FLANGE CAST IRON FRAME AND BICYCLE A SAFE GRATE	02635 PWSA SIDEWALK TRENCH DRAIN .001 WITH ADA COMPLIANT AND BICYCLE LF SAFE GRATE	537 PWSA GRADE ADJUSTMENT OF EXISTING	02637 PWSA GRADE ADJUSTMENT OF .002 EXISTING SET PWSA INLET	02639 PWSA REBUILT INLET BOX WITH EA MANHOLE TOP	02640 STORMWATER MANACEMENT SYSTEM .001 FOR KIRKPATRICK PARKING LOT	REMARKS	SIDE	STATION
026	026	.   "				026	026	0.0	026 . 0	026 .0	026 .0	0.0	026			
		_												SIDE STREETS		
														DINWIDDIE STREET		
1	5 1	1												A20-5	LT	20+35
														WYANDOTTE STREET		
1 1	0										1			A22-4	RT	30+50
														KIRKPATRICK STREET		
1 1	0							1			1			A25-4, A25-4A & A25-3A & A25-3	LT	30+95 TO 30+75
													1	KIRKPATRICK STREET PARKING LOT	RT	30+90 TO 39+25
	_													MCKEE PLACE		16.65
1	0													A32-1	LT	16+65
														LYTTON AVENEUE		
	5 1	1												A37-5	RT	40+55
		$\top$														
														NORTH BELLFIELD AVENUE		
1 3	0						1							A38-3	LT	61+55
		$\perp$														
		_														
											5B OF 1					

Gulf Tower
707 Grant Street
5th Floor
Pittsburgh, PA 15219

		THE PREPARATION OF THIS DOCUMENT HAS BEEN FINANCED IN
		PART THROUGH A GRANT FROM THE
		FEDERAL TRANSIT ADMINISTRATION, U.S. DEPARTMENT OF
		TRANSPORTATION, UNDER THE
		URBAN MASS TRANSPORTATION ACT OF 1964. AS AMENDED, FOR THE
DATE	DESCRIPTION	PORT AUTHORITY OF ALLEGHENY COUNTY, PENNSYLVANIA.
	REVISIONS	COUNTY, FEMINOTEVANIA.

(NOT FOR CONSTRUCTION)

ESIGNED	<u>MRM</u>	
DRAWN	<u>JMS</u>	
CHECKED	DJC	
N CHARGE	LAR	
ATE	05/01/24	
CALE		
	AS SHOWN	

# PORT AUTHORITY OF ALLEGHENY COUNTY PITTSBURGH PENNSYLVANIA RUS RAPID TRANSIT LIPTOWN TO OAKLAND

BUS RAPID TRANSIT UPTOWN TO OAKLAND

DRAINAGE TABULATION SHEET

Port Authority -

CONTRACT NO. BRT-001

DWG. NO. GN67 SHT. 67

# "josepn.s.i.icn" : c:\pwworking\aecom\_ds16\_na\joseph.s!lich@aecom.com\d0207700\BRT\_01

## DRAINAGE TABULATION SHEET

02610 LF 02610 02610 02630 3" PVC PIPE, SDR 26	02610 • 003 4" PVC PIPE, SDR 26 EA	02610 SEWER TAP TO EXISTING SEWE EA	02610 • 005 EA CUT-IN WYE PIPE TRANSITION	02610 PWSA 15" PVC PIPE, SDR 26,5HORE/TRENCH BOX LF	02610 • 007 PWSA 15" DUCTILE IRON PIPE LF	02610 • 008 LF	.00610 .009 PWSA DRAINAGE PIPE REMOVAL	02610 PWSA CORED WYE OR TEE CONNECTION TO EXISTING SEWER	.015 PWSA CUT-IN WYE PIPE  EA TRANSITION	02615 PWSA TRENCH RESTORATION (PIPE INSTALLATION)	.001 THROUGH CURB RAIN LEADER LF		02633 PWSA CATCH BASIN, PWSA TYPE .002 WITH 3-FLANGE CAST IRON EA FRAME AND BICYCLE SAFE GRATE	02633 PWSA STORM INLET, PWSATYPE 13 .005 WITH 3-FLANGE CAST IRON EA FRAME AND BICYCLE SAFE GRATE	. 007 PWSA DOGHOUSE MANHOLE, WITH EA MANHOLE FRAME AND COVER	02633 PWSA 4' DIAMETER PWSA MANHOL .008 WITH MANHOLE FRAME AND COVER	02633 PWSA MANHOLE SA-10C, WITH - 009 MANHOLE FRAME AND COVER EA	.010 PWSA CORE HOLE IN EXISTING BRAINAGE STRUCTURE	ю-	NUMBER UNIT	SIDE	STATION
																				FORBES AVE - UPTOWN		
				20			25			20		1	2						4	MISCELLANEOUS DRAINAGE	LT / RT	121+30 TO 127+38
				20			30			20	18	3							4	MISCELLANEOUS DRAINAGE	LT / RT	129+00 TO 132+43
																				MISCELLANEOUS DRAINAGE	LT / RT	136+65 TO 137+02
																				MISCELLANEOUS DRAINAGE	LT / RT	139+18 TO 140+61
				10			10			10		1							1	MISCELLANEOUS DRAINAGE	LT / RT	141+56 TO 142+16
				10			10			10			1						1	G04-12	RT	141+57 TO 141+67
				42						42			1					1		GO4-4 TO GO4-5	LT	142+47 TO 142+64
				28						28			1					1		G05-1 T0 G05-2	LT / RT	143+60 TO 143+79
22																				PRIDE ST STATION	RT	144+75 TO 145+05
				20			22		1	20			1							G05-3 TO G05-4	RT	145+52.50 TO 145+72
				6			6			6			1						1	G05-10	RT	145+72 TO 145+82
																				MISCELLANEOUS DRAINAGE	LT / RT	145+53 TO 145+72.50
				16			27		1	16			1							G05-8 TO G05-9	LT	145+80 TO 145+83
				10					1	10			1							G05-7 TO G05-6	LT	145+80 TO 146+40
				10			6			10			1						1	G05-5	RT	145+92 TO 146+00
																				MISCELLANEOUS DRAINAGE	LT / RT	148+10 TO 148+21
				8			31			4			1						1	G05-12	RT	148+38 TO 148+60
				10		20			1	10			1					1		G06-10 T0 G05-11	LT	148+91 TO 149+62
				10			20		1	10			1							G06-1 TO G06-3	LT	149+85 TO 150+00
				20			27		1	20			1							G06-2 T0 G06-12	RT	149+90 TO 150+05

**AECOM** 

Gulf Tower 707 Grant Street 5th Floor Pittsburgh, PA 15219 GANNETT FLEMING
GANNETT FLEMING, INC.
Foster Plaza 8
Suite 400
730 Holiday Drive
Pittsburgh, PA. 15220

		THE PREPARATION OF THIS DOCUMENT HAS BEEN FINANCED IN
		PART THROUGH A GRANT FROM THE
		FEDERAL TRANSIT ADMINISTRATION, U.S. DEPARTMENT OF
		TRANSPORTATION, UNDER THE
		URBAN MASS TRANSPORTATION ACT
DATE	DESCRIPTION	OF 1964, AS AMENDED, FOR THE PORT AUTHORITY OF ALLEGHENY COUNTY, PENNSYLVANIA.
	DEVISIONS	COUNTY, FEMINSTEVANIA.

(NOT FOR CONSTRUCTION)

DESIGNED	<u>TCG</u>	
DRAWN	<u>TCG</u>	
CHECKED	TRZ	
IN CHARGE	<u>GEC</u>	
DATE	05/01/24	
SCALE	AS SHOWN	

# PORT AUTHORITY OF ALLEGHENY COUNTY PENNSYLVANIA

BUS RAPID TRANSIT UPTOWN TO OAKLAND

DRAINAGE TABULATION SHEET

	Auth connecting p	
--	-------------------	--

CONTRACT NO. BRT-001

DWG. NO. GN68 SHT. 68

22633 PWSA CLEANING DRAINAGE	TURES	PWSA CLEANING	.014 PWSA DRAINAGE STRUCTURE EA REMOVAL				02633 PWSA CATCH BASIN, PWSA TYPE 9, 016 WITH 4-FLANGE CAST IRON EA FRAME AND BICYCLE SAFE GRATE 02633 PWSA CATCH BASIN, PWSA TYPE 018 13, 019 WITH 4-FLANGE CAST IRON EA FRAME AND BICYCLE SAFE GRATE 02633 PWSA RECESSED CATCH BASIN 019 CONVERSION	<b>⋖</b>	02635 PWSA SIDEWALK TRENCH DRAIN .001 WITH ADA COMPLIANT AND BICYCLE LF SAFE GRATE	22637 PWSA GRADE ADJUSTMENT OF .001 EXISTING SET PWSA MANHOLE	02637 PWSA GRADE ADJUSTMENT OF .002 EXISTING SET PWSA INLET		 PWSA KEBUILI MANHUL	OZESS PWSA REBUILT INLET BOX WITH  EA MANHOLE TOP  EA MANHOLE TOP	02640 STORMWATER MANAGEMENT SYSTEM .001 FOR KIRKPATRICK PARKING LOT	NUMBER UNIT	SIDE	STATION
	1															FORBES AVE - UPTOWN		
	3 4	13	3							3	2					MISCELLANEOUS DRAINAGE	LT / RT	121+30 TO 127+38
	1 9	90	3							1						MISCELLANEOUS DRAINAGE	LT / RT	129+00 TO 132+43
	1									3						MISCELLANEOUS DRAINAGE	LT / RT	136+65 TO 137+02
	2									2						MISCELLANEOUS DRAINAGE	LT / RT	139+18 TO 140+61
	2 1	14	2													MISCELLANEOUS DRAINAGE	LT / RT	141+56 TO 142+16
	2	29	1							1						G04-12	RT	141+57 TO 141+67
										1						GO4-4 TO GO4-5	LT	142+47 TO 142+64
										1						G05-1 TO G05-2	LT / RT	143+60 TO 143+79
																PRIDE ST STATION	RT	144+75 TO 145+05
3			1													G05-3 TO G05-4	RT	145+52.50 TO 145+72
, gen			1													G05-10	RT	145+72 TO 145+82
	1									2						MISCELLANEOUS DRAINAGE	LT / RT	145+53 TO 145+72.50
			1													G05-8 TO G05-9	LT	145+80 TO 145+83
, ng																G05-7 TO G05-6	LT	145+80 TO 146+40
	1	8	1													G05-5	RT	145+92 TO 146+00
202	1									1	1					MISCELLANEOUS DRAINAGE	LT / RT	148+10 TO 148+21
	2	21	2													G05-12	RT	148+38 TO 148+60
									55							G06-10 TO G05-11	LT	148+91 TO 149+62
			1													G06-1 TO G06-3	LT	149+85 TO 150+00
- - -			1													G06-2 TO G06-12	RT	149+90 TO 150+05
-																		
SOF																		
9																		
											7B 0	F 13B						

**AECOM** 

Gulf Tower 707 Grant Street 5th Floor Pittsburgh, PA 15219

GANNETT FLEMING
GANNETT FLEMING, INC.
Foster Plaza 8
Suite 400
730 Holiday Drive
Pittsburgh, PA. 15220

		THE PREPARATION OF THIS DOCUMENT HAS BEEN FINANCED IN
		PART THROUGH A GRANT FROM THE
		FEDERAL TRANSIT ADMINISTRATION, U.S. DEPARTMENT OF
		TRANSPORTATION, UNDER THE
		URBAN MASS TRANSPORTATION ACT OF 1964, AS AMENDED, FOR THE
DATE	DESCRIPTION	PORT AUTHORITY OF ALLEGHENY COUNTY, PENNSYLVANIA.
	REVISIONS	COUNTY, PENNSTEVANIA.

(NOT FOR CONSTRUCTION)

DESIGNED	<u>TCG</u>	
DRAWN	<u>TCG</u>	
CHECKED	TRZ	
IN CHARGE	GEC	
DATE	05/01/24	
SCALE		
	AS SHOWN	

# PORT AUTHORITY OF ALLEGHENY COUNTY PITTSBURGH PENNSYLVANIA

BUS RAPID TRANSIT UPTOWN TO OAKLAND DRAINAGE TABULATION SHEET

Port Authority connecting people to life

CONTRACT NO. BRT-001 DWG. NO. GN69 sнт. 69

02610 .001 6" PVC PIPE, SDR 26	.002 3" PVC PIPE, SDR 26 LF	02610 .003 EA	02610 .004 SEWER TAP TO EXISTING SEWER EA	02610 • 005 EA CUT-IN WYE PIPE TRANSITION	02610 PWSA 15" PVC PIPE, SDR . 006 26,SHORE/TRENCH BOX	02610 • 007 PWSA 15" DUCTILE IRON PIPE LF	02610 • 008 PWSA 6" PVC PIPE. SDR 26	02610 • 009 • PWSA DRAINAGE PIPE REMOVAL	02610 PWSA CORED WYE OR TEE CONNECTION TO EXISTING SEWER EA	.015 PWSA CUT-IN WYE PIPE  EA TRANSITION	.001 PWSA TRENCH RESTORATION LF (PIPE INSTALLATION)	02620 • 001 THROUGH CURB RAIN LEADER LF	02633 PWSA CATCH BASIN, PWSA TYPE 13 .001 MODIFIED, WITH 3-FLANGE CAST EA GRATE	02633 PWSA CATCH BASIN, PWSA TYPE 13, • 002 WITH 3-FLANGE CAST IRON EA FRAME AND BICYCLE SAFE GRATE	.00533 PWSA STORM INLET, PWSATYPE 13, .005 WITH 3-FLANGE CAST IRON EA FRAME AND BICYCLE SAFE GRATE	02633 PWSA DOGHOUSE MANHOLE, WITH EA MANHOLE FRAME AND COVER	.008 PWSA 4' DIAMETER PWSA MANHOLE, EAM WITH MANHOLE FRAME AND COVER	02633 PWSA MANHOLE SA-10C, WITH 6009 MANHOLE FRAME AND COVER	.010 PWSA CORE HOLE IN EXISTING BRAINAGE STRUCTURE	.011 PWSA CONCRETE COLLAR FOR PIPE  EA CONNECTION	UNIT REMARKS	SIDE	STATION
			·																		FORBES AVE- UPTOWN		
					59			10			59			1			1		1		G06-5 TO G06-8	LT	152+32 TO 152+71
					5			8			5			1						1	G06-9	LT	152+40.50
					10			5			10			1						1	MISCELLANEOUS DRAINAGE	RT	152+94
					23		14				23		1						1		GO7-8 TO GO6-7	LT	152+68 TO 155+14
												22									UPTOWN CENTRAL STATION	RT	155+07 TO 155+23
					19			5			19			1						1	MISCELLANEOUS DRAINAGE	LT / RT	155+84 TO 156+46
					65			8			65			1	1		1				G07-1 TO G07-3	LT / RT	156+08 TO 156+66
																					MISCELLANEOUS DRAINAGE	LT	161+21.50 TO 163+88
																					G08-1 TO G08-3	LT	163+50 TO 164+03
ug L					10		40	8		1	10			1					1		G08-4 TO G09-6	LT	164+26 TO 165+34
ABB S					10			33		1	10			1							G09-2 TO G09-3	LT	165+97
2												20									JUMONVILLE STATION	RT	165+58 TO 165+92
					10			5			10			1						1	G09-4	RT	165+96.50
784					10			5			10			1						2	MISCELLANEOUS DRAINAGE	LT / RT	166+17.25 TO 168+83
					10		10	18		1	10			1					1		G09-12 TO G10-2	LT	166+80 TO 170+71
708					18			20			18			3						3	MISCELLANEOUS DRAINAGE	LT / RT	170+95 TO 171+43
					10			17		1	5			1							G11-1	LT	174+65 TO 175+15
ECO					10			7			10			1						1	G11-3	RT	174+98 TO 175+24
Da Co					5			5			5		1							1	MISCELLANEOUS DRAINAGE	LT	175+22 TO 176+54
ω	20																				SOHO STATION	RT	176+31 TO 176+63
ebu-					12					1	6		1								G12-1 TO G12-2	LT	177+47.50
30/108					12			5			0		1							1	G12-3	RT	177+65 TO 177+83
9 0					5						0			1			1				G12-4 TO G12-6	RT	178+46.50 TO 178+47
SD																					MISCELLANEOUS DRAINAGE	LT / RT	178+10.75 TO 180+17
gu-																							
ž															8A OF	13B							

**AECOM** 

Gulf Tower 707 Grant Street 5th Floor Pittsburgh, PA 15219

GANNETT FLEMING
GANNETT FLEMING, INC.
Foster Plaza 8
Suite 400
730 Holiday Drive
Pittsburgh, PA. 15220

		THE PREPARATION OF THIS
		DOCUMENT HAS BEEN FINANCED IN PART THROUGH A GRANT FROM THE
		FEDERAL TRANSIT ADMINISTRATION, U.S. DEPARTMENT OF
		TRANSPORTATION, UNDER THE
		URBAN MASS TRANSPORTATION ACT OF 1964, AS AMENDED, FOR THE
DATE		PORT AUTHORITY OF ALLEGHENY COUNTY, PENNSYLVANIA.
	REVISIONS	COUNTY, PENNOTEVANIA.

(NOT FOR CONSTRUCTION)

DESIGNED	<u>TCG</u>	
DRAWN	<u>TCG</u>	
CHECKED	<u>TRZ</u>	
IN CHARGE	GEC	
DATE	05/01/24	
SCALE		
	AS SHOWN	

# PORT AUTHORITY OF ALLEGHENY COUNTY PITTSBURGH PENNSYLVANIA

BUS RAPID TRANSIT UPTOWN TO OAKLAND DRAINAGE TABULATION SHEET

Port Authority connecting people to life

CONTRACT NO. BRT-001 DWG. NO. GN70 sнт. 70

02633 PWSA CLEANING DRAINAGE • 012 STRUCTURES	02633 •013 PWSA CLEANING DRAINAGE PIPE LF	02633 PWSA DRAINAGE STRUCTURE .014 REMOVAL EA				02633 PWSA CATCH BASIN, PWSA TYPE 9, •016 WITH 4-FLANGE CAST IRON EA FRAME AND BICYCLE SAFE GRATE	02633 PWSA CATCH BASIN, PWSA TYPE  • 018 13  EA WITH 4-FLANGE CAST IRON  EA FRAME AND BICYCLE SAFE GRATE	02633 PWSA RECESSED CATCH BASIN EA CONVERSION	.001 WITH ADA COMPLIANT AND BICYCLE LF SAFE GRATE	02637 PWSA GRADE ADJUSTMENT OF • 001 EXISTING SET PWSA MANHOLE	02637 PWSA GRADE ADJUSTMENT OF .002 EXISTING SET PWSA INLET		02639 .001 PWSA REBUILT MANHOLE VF	.003 PWSA REBUILT INLET BOX WITH EA MANHOLE TOP	02640 .001 FOR KIRKPATRICK PARKING LOT	REMARKS  NUMBER  NUMBE	SIDE	STATION
	·			Ċ		·										FORBES AVE- UPTOWN		
		1								1						G06-5 TO G06-8	LT	152+32 TO 152+71
		1														G06-9	LT	152+40.50
		1														MISCELLANEOUS DRAINAGE	RT	152+94
									220							G07-8 TO G06-7	LT	152+68 TO 155+14
																UPTOWN CENTRAL STATION	RT	155+07 TO 155+23
1		1														MISCELLANEOUS DRAINAGE	LT / RT	155+84 TO 156+46
		1														G07-1 TO G07-3	LT / RT	156+08 TO 156+66
2										2						MISCELLANEOUS DRAINAGE	LT	161+21.50 TO 163+88
									52							G08-1 TO G08-3	LT	163+50 TO 164+03
7)									106							G08-4 TO G09-6	LT	164+26 TO 165+34
		1														G09-2 T0 G09-3	LT	165+97
																JUMONVILLE STATION	RT	165+58 TO 165+92
	35	1														G09-4	RT	165+96.50
	70	2								2						MISCELLANEOUS DRAINAGE	LT / RT	166+17.25 TO 168+83
									375							G09-12 T0 G10-2	LT	166+80 TO 170+71
2	80	4								1						MISCELLANEOUS DRAINAGE	LT / RT	170+95 TO 171+43
		1														G11-1	LT	174+65 TO 175+15
	19	11														G11-3	RT	174+98 TO 175+24
1	27	1														MISCELLANEOUS DRAINAGE	LT	175+22 TO 176+54
																SOHO STATION	RT	176+31 TO 176+63
										1						G12-1 TO G12-2	LT	177+47.50
	48	1														G12-3	RT	177+65 TO 177+83
	23	1								1						G12-4 TO G12-6	RT	178+46.50 TO 178+47
4										2	4					MISCELLANEOUS DRAINAGE	LT / RT	178+10.75 TO 180+17
									 		8B OF	13B						

**AECOM** 

Gulf Tower 707 Grant Street 5th Floor Pittsburgh, PA 15219

GANNETT FLEMING
GANNETT FLEMING, INC.
Foster Plaza 8
Suite 400
730 Holiday Drive
Pittsburgh, PA. 15220

		THE PREPARATION OF THIS DOCUMENT HAS BEEN FINANC
		PART THROUGH A GRANT FRO
		FEDERAL TRANSIT ADMINISTRA U.S. DEPARTMENT OF
		TRANSPORTATION, UNDER TH
		URBAN MASS TRANSPORTATION OF 1964. AS AMENDED, FOR TH
DATE	DESCRIPTION	PORT AUTHORITY OF ALLEGHE COUNTY, PENNSYLVANIA.
	REVISIONS	COUNTY, PENNSTEVANIA.

NCED IN ROM THE TRATION, (NOT FOR CONSTRUCTION) THE TION ACT THE SHENY

DESIGNED	TCG	
DRAWN	<u>TCG</u>	
CHECKED	<u>TRZ</u>	
IN CHARGE	GEC	
DATE	05/01/24	
SCALE		
	AS SHOWN	

# PORT AUTHORITY OF ALLEGHENY COUNTY PITTSBURGH PENNSYLVANIA

BUS RAPID TRANSIT UPTOWN TO OAKLAND DRAINAGE TABULATION SHEET

Port Authority connecting people to life

CONTRACT NO. BRT-001 DWG. NO. GN71 sнт. **71** 

# septies in tent. \pwworking\decom\_ds16\_na\joseph.silich@aecom.com\d0207700\BRT\_01\_RD\_TAI

## DRAINAGE TABULATION SHEET

02610 .001 6" PVC PIPE, SDR 26	02610 • 002 LF	02610 .003 EA 4" PVC PIPE, SDR 26	02610 SEWER TAP TO EXISTING SEWER EA WYE	02610 • 005 CUT-IN WYE PIPE TRANSITION EA	02610 PWSA 15" PVC PIPE, SDR	02610 - 007 PWSA 15" DICTH FIRON PIPE	LF PWSA 6" PVC PIPE. SDR 26 02610 000 PWSA DRAINAGE PIPE REMOVAL	02610 PWSA CORED WYE OR TEE	PWSA CUT-IN WYE PIPE TRANSITION	02615 • 001 PWSA TRENCH RESTORATION (PIPE INSTALLATION)	02620 .001 THROUGH CURB RAIN LEADER LF	02633 PWSA CATCH BASIN, PWSA TYPE 13	MODIFIED, WITH 3-FLANGE CAST IRON FRAME AND BICYCLE SAFE GRATE	02633 PWSA CATCH BASIN, PWSA TYPE 13, • 002 WITH 3-FLANGE CAST IRON FRAME AND BICYCLE SAFE GRATE	02633 pwsa storm inlet, pwsatype 13, 005 WITH 3-FLANGE CAST IRON EA FRAME AND BICYCLE SAFE GRATE	02633 0007 PWSA DOGHOUSE MANHOLE, WITH AMANHOLE FRAME AND COVER	02633 PWSA 4' DIAMETER PWSA MANHOLE, .008 WITH MANHOLE FRAME AND COVER	. 009 PWSA MANHOLE SA-10C, WITH EA MANHOLE FRAME AND COVER	.010 PWSA CORE HOLE IN EXISTING DRAINAGE STRUCTURE FA	02633 PWSA CONCRETE COLLAR FOR PIPE EA CONNECTION		NIMBER NIMBER UNIT	SIDE	STATION
																						FORBES AVE - OAKLAND		
	16																					MISCELLANEOUS DRAINAGE	RT	212+00 TO 213+90.50
	18																					MISCELLANEOUS DRAINAGE	RT	224+08 TO 224+73
	32																					CENTRAL OAKLAND STATION	RT	236+14 TO 237+19
104	48																					BIGELOW BLVD STATION	RT	245+34 TO 246+56
																						MISCELLANEOUS DRAINAGE	LT	255+01 TO 255+50
																						MARION ST		
					17		5		1	17				1								G05-15 TO G05-14	RT	20+25 TO 20+33
					9		13		1	9				1								G05-16 TO G05-17	LT	20+36 TO 20+44
in l																								
																						JUMONVILLE ST		
					22					22				1			4					G09-7 TO G09-8	RT	20+36.50 TO 20+61.50
															9A OF	13B								

**AECOM** 

Gulf Tower 707 Grant Street 5th Floor Pittsburgh, PA 15219 GANNETT FLEMING
GANNETT FLEMING, INC.
Foster Plaza 8
Suite 400
730 Holiday Drive
Pittsburgh, PA. 15220

		THE PREPARATION OF THIS
		DOCUMENT HAS BEEN FINANCED IN PART THROUGH A GRANT FROM THE
		FEDERAL TRANSIT ADMINISTRATION, U.S. DEPARTMENT OF
		TRANSPORTATION, UNDER THE
		URBAN MASS TRANSPORTATION ACT OF 1964, AS AMENDED, FOR THE
DATE	DESCRIPTION	PORT AUTHORITY OF ALLEGHENY COUNTY, PENNSYLVANIA.
	REVISIONS	COUNTY, PENNSTEVANIA.

(NOT FOR CONSTRUCTION)

DESIGNED	<u>TCG</u>	
DRAWN	<u>TCG</u>	
CHECKED	TRZ	
IN CHARGE	<u>GEC</u>	
DATE	05/01/24	
SCALE		
	AS SHOWN	

# PORT AUTHORITY OF ALLEGHENY COUNTY PITTSBURGH PENNSYLVANIA

BUS RAPID TRANSIT UPTOWN TO OAKLAND
DRAINAGE TABULATION SHEET

Port Authority connecting people to life

CONTRACT NO. BRT-001

DWG. NO. GN72 SHT. 72

# PATH: c:/pwworking/aecom\_ds16\_na\joseph.silich@aecom.com\d0207700\BRT\_

# DRAINAGE TABULATION SHEET

02633 PWSA CLEANING DRAINAGE -012 STRUCTURES	22633 •013 PWSA CLEANING DRAINAGE PIPE LF	22633 PWSA DRAINAGE STRUCTURE  EA REMOVAL		22633 PWSA CATCH BASIN, PWSA TYPE 9,	EAME AND BICYCLE SAFE GRATE 02633 PWSA CATCH BASIN, PWSA TYPE 018 13 WITH 4-FLANGE CATE CATE EAME AND BICYCLE SAFE COATE	22633 PWSA RECESSED CATCH BASIN EA CONVERSION	O2635 PWSA SIDEWALK TRENCH DRAIN O01 WITH ADA COMPLIANT AND BICYCLE LF SAFE GRATE	12637 PWSA GRADE ADJUSTMENT OF • 001 EXISTING SET PWSA MANHOLE	O2637 PWSA GRADE ADJUSTMENT OF O02 EXISTING SET PWSA INLET	)2639 - 001 PWSA REBUILT MANHOLE	02639 PWSA REBUILT INLET BOX WITH EA MANHOLE TOP	02640 .001 FOR KIRKPATRICK PARKING LOT	UNIT UNIT TT	SIDE	STATION
	J												FORBES AVE - OAKLAND		
1	5								1				MISCELLANEOUS DRAINAGE	RT	212+00 TO 213+90.50
1	5								1				MISCELLANEOUS DRAINAGE	RT	224+08 TO 224+73
													CENTRAL OAKLAND STATION	RT	236+14 TO 237+19
													BIGELOW BLVD STATION	RT	245+34 TO 246+56
													MISCELLANEOUS DRAINAGE	LT	255+01 TO 255+50
													MARION ST		
		1											G05-15 TO G05-14	RT	20+25 TO 20+33
		1											G05-16 TO G05-17	LT	20+36 TO 20+44
													JUMONVILLE ST		
	46	1											G09-7 TO G09-8	RT	20+36.50 TO 20+61.50
									9B 0F						

**AECOM** 

Gulf Tower 707 Grant Street 5th Floor Pittsburgh, PA 15219 GANNETT FLEMING
GANNETT FLEMING, INC.
Foster Plaza 8
Suite 400
730 Holiday Drive
Pittsburgh, PA. 15220

THE PREPARATION OF THIS
DOCUMENT HAS BEEN FINANCED IN
PART THROUGH A GRANT FROM THE
FEDERAL TRANSIT ADMINISTRATION,
U.S. DEPARTMENT OF
TRANSPORTATION, UNDER THE
URBAN MASS TRANSPORTATION ACT
OF 1964, AS AMENDED, FOR THE
PORT AUTHORITY OF ALLEGHENY
COUNTY, PENNSYLVANIA.

(NOT FOR CONSTRUCTION)

DESIGNED	<u>TCG</u>	
DRAWN	<u>TCG</u>	
CHECKED	TRZ	
IN CHARGE	<u>GEC</u>	
DATE	05/01/24	
SCALE		
	AS SHOWN	

# PORT AUTHORITY OF ALLEGHENY COUNTY PENNSYLVANIA

BUS RAPID TRANSIT UPTOWN TO OAKLAND DRAINAGE TABULATION SHEET

Port Authority connecting people to life

CONTRACT NO. BRT-001

DWG. NO. GN73 SHT. 73

# cs towworking aecom\_ds16\_na\joseph.silich@aecom.com\d0207700\BRT\_01\_

# DRAINAGE TABULATION SHEET - TOTALS

6" PVC PIPE,	3" PVC PIPE, SDR 26	4" PVC PIPE, SDR 26	SEWER TAP TO EXISTING SE	CUT-IN WYE PIPE TRANSITION	PWSA 15" PVC PIPE, SDR 26	PWSA 15" DUCTILE IRON PIPE	PWSA 6" PVC PIPE. SDR 26	PWSA DRAINAGE PIPE REMOVAL	PWSA CORED WYE OR TEE CONNECTION TO EXISTING SEWER	PWSA CUT-IN WYE OR TEE PIPE TRANSITION	PWSA TRENCH RESTORATION (PIPE INSTALLATION)	THROUGH CURB RAIN LEADER	PWSA CATCH BASIN, PWSA TYPE MODIFIED, WITH 3-FLANGE CAST IRON FRAME AND BICYCLE SAFE	PWSA CATCH BASIN, PWSA TYPE	FRAME AND BICYCLE SAFE GRATE PWSA STORM INLET, PWSATYPE 13 WITH 3-FLANGE CAST IRON FRAME AND BICYCLE SAFE GRATE	PWSA DOGHOUSE MANHOLE, WITH	MANHOLE FRAME AND COVER PWSA 4' DIAMETER PWSA MANHOLE,	± Ei *	PWSA MANHOLE SA-10C, WITH MANHOLE FRAME AND COVER	PWSA CORE HOLE IN EXISTING - DRAINAGE STRUCTURE	PWSA CONCRETE COLLAR FOR PIPE CONNECTION	REMARKS SIDE STATION
02610 .001 LF	02610 .002 LF	02610 .003 EA	02610 .004 EA	02610 .005 EA	02610	02610	02610	02610 .009	02610 .014	02610 .015 EA	02615 .001 LF	02620 .001	02633	02633 .002	EA 02633 .005	02633 .007	EA 02633	EA 02633	. 009 EA	02633 .010 EA	02633 .011 EA	N U N I T E M BEA
			_						_					<u> </u>					_			
529	40	714	5	1	869	195			2	3	154	41	7	26		6			1	5 4	27	SUBTOTAL - FIFTH AVE - ENTIRE LENGTH  SUBTOTAL - FIFTH AVE - UPTOWN
341	40	250 464	3	1	784 85	195	300	75	1	1	107	41	1	6		5	6	<u>'</u>	1	1	23	SUBTOTAL - FIFTH AVE - OKLAND
		.5,		'			''	15	<u> </u>		.,		,			+ '		+	•			
104	156				543		84	373		11	511	60	9	30	1		3			7	25	SUBTOTAL - FORBES AVE - ENTIRE LENGTH
	42				543		84	373		11	511	60	9	30	1		3			7	25	SUBTOTAL - FORBES AVE - UPTOWN
104	114																					SUBTOTAL - FORBES AVE - OAKLAND
																						SUBTOTAL - DIAMOND STREET
, —					17			8			20			1				$\perp$			2	SUBTOTAL - WASHINGTON PLACE
					12			5			10			1							1	SUBTOTAL - CHATHAM SQUARE
					27 5			5			10		1	2				+			1	SUBTOTAL - MAGEE STREET  SUBTOTAL - LOGAN STREET
					6						7		+ '	1		+		+			1	SUBTOTAL - PRIDE STREET
					12								1	+							1	SUBTOTAL - VINE STREET
					6						8			1							1	SUBTOTAL - DINWIDDIE STREET
																						SUBTOTAL - WYANDOTTE STREET
					8				1					1								SUBTOTAL - KIRKPATRICK STREET
,					13						14			1							1	SUBTOTAL - MCKEE PLACE
,					7									1							1	SUBTOTAL - LYTTON STREET
								<u> </u>	-				_			-		$\perp$				SUBTOTAL - NORTH BELLFIELD AVENUE
					26			18		2	26			1								SUBTOTAL - MARION STREET
					22						22			+ '								SUBTOTAL - JUMONVILLE STREET
														+								
633	196	714	5	1	1573	195	398	676	3	17	772	101	19	74	2	6	1	3	2	12	63	TOTALS

**AECOM** 

Gulf Tower 707 Grant Street 5th Floor Pittsburgh, PA 15219 THE PREPARATION OF THIS
DOCUMENT HAS BEEN FINANCED IN
PART THROUGH A GRANT FROM THE
FEDERAL TRANSIT ADMINISTRATION,
U.S. DEPARTMENT OF
TRANSPORTATION, UNDER THE
URBAN MASS TRANSPORTATION ACT
OF 1964, AS AMENDED, FOR THE
PORT AUTHORITY OF ALLEGHENY
COUNTY, PENNSYLVANIA.

(NOT FOR CONSTRUCTION)

ESIGNED	<u>MRM</u>	
DRAWN	<u>JMS</u>	
CHECKED	DJC	
N CHARGE	LAR	
ATE	05/01/24	
CALE		
	AS SHOWN	

# PORT AUTHORITY OF ALLEGHENY COUNTY PENNSYLVANIA

BUS RAPID TRANSIT UPTOWN TO OAKLAND
DRAINAGE TABULATION SHEET - TOTALS

Port Authority connecting people to life

CONTRACT NO. BRT-001

DWG. NO. GN74 SHT. 74

# DRAINAGE TABULATION SHEET - TOTALS

PWSA CLEANING DRAINAGE	PWSA CLEANING DRAINAGE PIPE	PWSA DRAINAGE STRUCTURE	EMOVAL				PWSA CATCH BASIN, PWSA TYPE 13 13 13 14 15 16 17 18 18 18 18 18 18 18 18 18 18 18 18 18	PWSA CATCH BASIN, PWSA TYPE 13 REVERSE MODIFIED, WITH 3-FLANGE CAST IRON FRAME AND BICYCLE	PWSA SIDEWALK TRENCH DRAIN WITH ADA COMPLIANT AND BICYCLE SAFE GRATE	PWSA GRADE ADJUSTMENT OF EXISTING PWSA MANHOLE EXISTING EXISTING EXISTING PWSA INLET		PWSA REBUILT INLET BOX WITH MANHOLE TOP	STORMWATER MANACEMENT SYSTEM FOR KIRKPATRICK PARKING LOT	REMARKS	SIDE	STATION
02633 .012 S	02633 .013 P	12633 P	A A				02633 P . 018 1 EA EA EA CO2633 P	EA 02633 P C C C C C C C C C C C C C C C C C C	02635 P	02637 P SET P 02637 P 02637 P SET P		02639 . 003 P EA M	02640 .001 EA	NUMBER UNIT		
17	800	4	11				1 5	1	2994	68 6		1		SUBTOTAL - FIFTH AVE - ENTIRE LENGTH		
14	745	3	3				4	1	2731	54 5		1		SUBTOTAL - FIFTH AVE - UPTOWN		
3	55	8	8				1 1		263	14 1				SUBTOTAL - FIFTH AVE - OAKLAND		
23	527	3	55						808	25 9				SUBTOTAL - FORBES AVE - ENTIRE LENGTH		
21	517	3	55						808	25 7				SUBTOTAL - FORBES AVE - UPTOWN		
2	10									2				SUBTOTAL - FORBES AVE - OAKLAND		
_										1				SUBTOTAL - DIAMOND STREET		
	80		1											SUBTOTAL - WASHINGTON PLACE		
	9		1											SUBTOTAL - CATHAM SQUARE		
	34		2											SUBTOTAL - MAGEE STREET		
	41													SUBTOTAL - LOGAN STREET		
1	32		1							1				SUBTOTAL - PRIDE STREET		
	35													SUBTOTAL - VINE STREET		
<u> </u>	15		1											SUBTOTAL - DINWIDDIE STREET		
1										1	-			SUBTOTAL - WYANDOTTE STREET		
1	10							1		1			1	SUBTOTAL - KIRKPATRICK STREET		
<u> </u>	10		1								-			SUBTOTAL - MCKEE PLACE		
	6		1											SUBTOTAL - LYTTON STREET		
<u> </u>	30						1				-			SUBTOTAL - NORTH BELLFIELD AVENUE		
			2											SUBTOTAL - MARION STREET		
	46		1											SUBTOTAL - JUMONVILLE STREET		
				_							-					
		_				<u> </u>					<u> </u>			TOTALO		
[ 45	168	8	1				1 6	2	3802	93   19 13B 0F		1	1	TOTALS		

**AECOM** 

Gulf Tower 707 Grant Street 5th Floor Pittsburgh, PA 15219 THE PREPARATION OF THIS
DOCUMENT HAS BEEN FINANCED IN
PART THROUGH A GRANT FROM THE
FEDERAL TRANSIT ADMINISTRATION,
U.S. DEPARTMENT OF
TRANSPORTATION, UNDER THE
URBAN MASS TRANSPORTATION ACT
OF 1964, AS AMENDED, FOR THE
PORT AUTHORITY OF ALLEGHENY
COUNTY, PENNSYLVANIA.

(NOT FOR CONSTRUCTION)

DESIGNED	MRM	
DRAWN	<u>JMS</u>	
CHECKED	DJC	
N CHARGE	LAR	
DATE	05/01/24	
SCALE		
	AS SHOWN	

# PORT AUTHORITY OF ALLEGHENY COUNTY PENNSYLVANIA


BUS RAPID TRANSIT UPTOWN TO OAKLAND
DRAINAGE TABULATION SHEET - TOTALS

Port Authority connecting people to life

 CONTRACT NO. BRT-001


 DWG. NO.
 GN75
 SHT.
 75



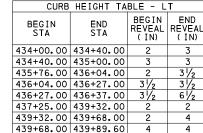

61/2

BUILDING

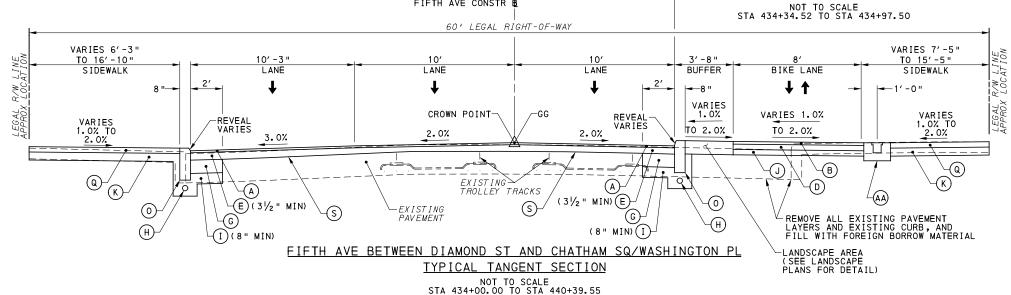

FIFTH AVE CONSTR B

**LEGEND** 

- SUPERPAVE ASPHALT MIXTURE DESIGN, WEARING COURSE, PG 64E-22, 10 TO <30 MILLION ESALS, 9.5 MM MIX, 1/2" DEPTH, SRL-H
- SUPERPAVE ASPHALT MIXTURE DESIGN, WEARING COURSE, PG 645-22, <0.3 MILLION ESALS, 9.5 MM MIX, 2" DEPTH, SRL-H
- SUPERPAVE ASPHALT MIXTURE DESIGN, BINDER COURSE, PG 64E-22, 10 TO <30 MILLION ESALS, 19.0 MM MIX, 2" DEPTH
- SUPERPAVE ASPHALT MIXTURE DESIGN, BASE COURSE, PG 64S-22, CO.3 MILLION ESALS, 25.0 MM MIX, 4" DEPTH
- SUPERPAVE ASPHALT MIXTURE DESIGN, BINDER COURSE (LEVELING), PG 64E-22, 10 TO <30 MILLION ESALS, 19.0 MM MIX
- $\stackrel{\textstyle \leftarrow}{\mathsf{F}}$  PLAIN CEMENT CONCRETE PAVEMENT, 4" DEPTH
- G REINFORCED CEMENT CONCRETE BASE COURSE, 10" DEPTH
- 4" PAVEMENT BASE DRAIN
- SUBBASE (NO. 2A) (MATCH ADJACENT SUBBASE DEPTH) OVER GEOTEXTILE CLASS 4, TYPE A
- J SUBBASE 4" DEPTH (NO. 2A)
- (K) SUBBASE 6" DEPTH (NO. 2A)
- SUBBASE 8" DEPTH (NO. 2A)
  OVER GEOTEXTILE CLASS 4, TYPE A
- M PLAIN CONCRETE MOUNTABLE CURB,
- N CONCRETE BUFFER
- O REINFORCED CEMENT CONCRETE CURB
- (P) GRANITE CURB

- Q REINFORCED CEMENT CONCRETE SIDEWALK, 4" DEPTH
- MILLING OF CEMENT CONCRETE PAVEMENT SURFACE, 2" DEPTH
- MILLING OF ASPHALT PAVEMENT SURFACE, VARIABLE DEPTH (MILL TO SANDSTONE BLOCK LAYER)
- MILLING OF ASPHALT PAVEMENT SURFACE, 1 1/2 " DEPTH
- MILLING OF ASPHALT PAVEMENT SURFACE, 2" DEPTH
- MILLING OF ASPHALT PAVEMENT SURFACE, 3 1/2 " DEPTH

- W REINFORCED CEMENT CONCRETE CURB, 36"
- X CURB CHEEK WALL

PARKING LANE

(8" MIN)(I)

VARIES 0'-0"

TO 7'-6"

LANDSCAPE AREA

VARIES 1.7% TO 2.2%

LANDSCAPE AREA (SEE LANDSCAPE

PLANS FOR DETAIL)

3.0%

(31/2" MIN) (E)

(s)

REVEAL

REVEAL

- REMOVE AND RESET INTERLOCKING PAVERS
- Z EXPOSED AGGREGATE CONCRETE SIDEWALK, BROWN
- AA PWSA SIDEWALK TRENCH DRAIN WITH ADA COMPLIANT AND BICYCLE SAFE GRATE
- TT DIRECTIONAL ARROWS

NOTE: ASPHALT TACK COAT IS REQUIRED BETWEEN ALL ASPHALT PAVING COURSES AND ON MILLED SURFACES PRIOR TO PLACING OVERLAY

NOTE: EXISTING TROLLEY TRACKS SHOWN FOR INFORMATION ONLY. THE EXACT LOCATION, LIMITS, AND TYPE OF TRACK IS UNKNOWN. TROLLEY TRACKS MAY HAVE BEEN REMOVED.

707 Grant Street 5th Floor Pittsburgh, PA 15219

THE PREPARATION OF THIS DOCUMENT HAS BEEN FINANCED IN PART THROUGH A GRANT FROM THE FEDERAL TRANSIT ADMINISTRATION U.S. DEPARTMENT OF TRANSPORTATION, UNDER THE URBAN MASS TRANSPORTATION ACT OF 1964, AS AMENDED, FOR THE PORT AUTHORITY OF ALLEGHENY NO. DATE DESCRIPTION COUNTY, PENNSYLVANIA. **REVISIONS** 

(NOT FOR CONSTRUCTION)

DESIGNED	SDS	
DRAWN	SDS	
CHECKED	<u>BFS</u>	
N CHARGE	LAR	
DATE	05/01/24	
SCALE		
	AS SHOWN	

PORT AUTHORITY OF ALLEGHENY COUNTY

BUS RAPID TRANSIT UPTOWN TO OAKLAND TYPICAL SECTIONS FIFTH AVE / DIAMAND ST TO CHATAM SQ

Port Authority

LEGAL R/W LINE APPROX LOCATION

RUITIDING

-BEDDING SAND (INCIDENTAL TO  $(Y)^{\circ}$ 

OVER GEOTEXTILE CLASS 4, TYPE A

LEGAL R/W INE APPROX LOCATION

BEDDING SAND (INCIDENTAL TO (Y))

OVER GEOTEXTILE CLASS 4, TYPE A

BUILDING

 $^ackslash$  asphalt tack coat (incidental to (Y)).

LANDSCAPING/

-ASPHALT TACK COAT (INCIDENTAL TO (Y))

434+00.00 | 434+95.92

435+40.34 439+60.00

439+60.00 439+80.00

439+80.00 439+87.54

CURB HEIGHT TABLE - RT

BEGIN END REVEAL (IN) (IN)

4

4

SIDEWALK

10'-8" SIDEWALK

MATCH EXISTING

VARIES 7'-10" TO 11'-10"

SIDEWALK

REMOVE ALL EXISTING PAVEMENT LAYERS AND EXISTING CURB, AND FILL WITH FOREIGN BORROW MATERIAL

VARIES


1.0% TO 2.0%

FIFTH AVE PARTIAL TYPICAL TANGENT SECTION NOT TO SCALE STA 434+00.00 TO STA 434+34.52

FIFTH AVE

PARTIAL TYPICAL TANGENT SECTION

CONTRACT NO. BRT-001 DWG. NO. CV1 sнт. 76

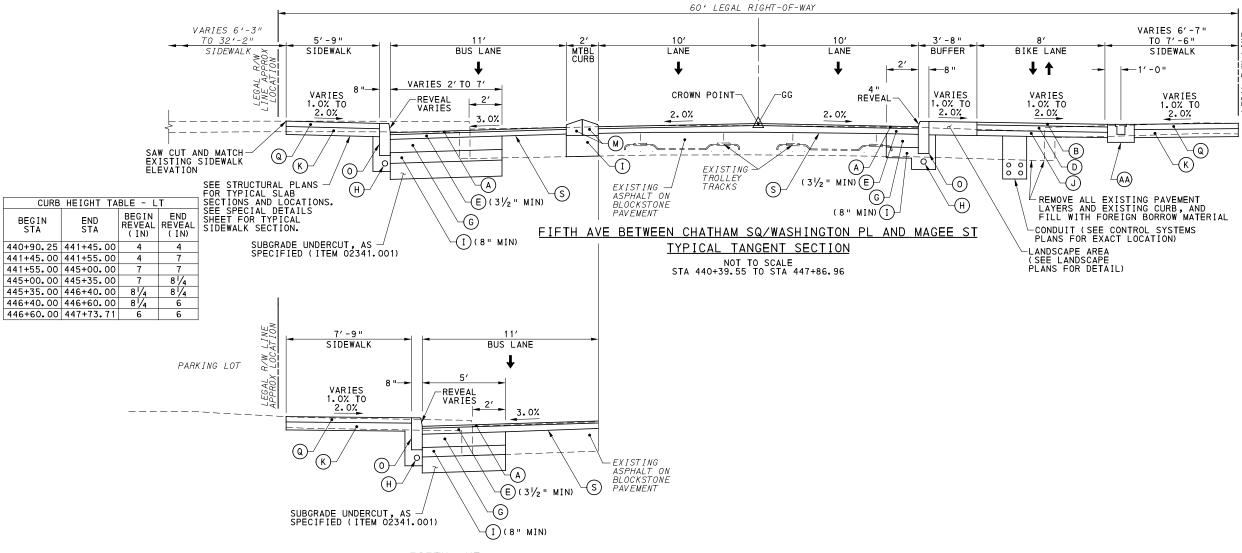

FIFTH AVE PARTIAL TYPICAL TANGENT SECTION NOT TO SCALE STA 446+39.50 TO STA 447+86.96

**LEGEND** 

- SUPERPAVE ASPHALT MIXTURE DESIGN, WEARING COURSE, PG 64E-22, 10 TO <30 MILLION ESALS, 9.5 MM MIX, 11/2" DEPTH, SRL-H
- SUPERPAVE ASPHALT MIXTURE DESIGN, WEARING COURSE, PG 64S-22, <0.3, MILLION ESALS, 9.5 MM MIX, 2" DEPTH, SRL-H
- SUPERPAVE ASPHALT MIXTURE DESIGN, BINDER COURSE, PG 64E-22, 10 TO <30 MILLION ESALS, 19.0 MM MIX, 2" DEPTH
- SUPERPAVE ASPHALT MIXTURE DESIGN, BASE COURSE, PG 64S-22, <0.3 MILLION ESALS, 25.0 MM MIX, 4" DEPTH
- SUPERPAVE ASPHALT MIXTURE DESIGN, BINDER COURSE (LEVELING), PG 64E-22, 10 TO <30 MILLION ESALS, 19.0 MM MIX
- F PLAIN CEMENT CONCRETE PAVEMENT, 4" DEPTH
- G REINFORCED CEMENT CONCRETE BASE COURSE, 10" DEPTH
- 4" PAVEMENT BASE DRAIN
- SUBBASE (NO. 2A) (MATCH ADJACENT SUBBASE DEPTH) OVER GEOTEXTILE CLASS 4, TYPE A
- J SUBBASE 4" DEPTH (NO. 2A)
- (K) SUBBASE 6" DEPTH (NO. 2A)
- SUBBASE 8" DEPTH (NO. 2A)
  OVER GEOTEXTILE CLASS 4. TYPE A
- M PLAIN CONCRETE MOUNTABLE CURB,
- (N) CONCRETE BUFFER
- O REINFORCED CEMENT CONCRETE CURB
- (P) GRANITE CURB

- REINFORCED CEMENT CONCRETE SIDEWALK, 4" DEPTH
- MILLING OF CEMENT CONCRETE PAVEMENT SURFACE, 2" DEPTH
- MILLING OF ASPHALT PAVEMENT SURFACE, VARIABLE DEPTH (MILL TO SANDSTONE BLOCK LAYER)
- MILLING OF ASPHALT PAVEMENT SURFACE, 1 1/2 " DEPTH
- MILLING OF ASPHALT PAVEMENT SURFACE, 2" DEPTH MILLING OF ASPHALT PAVEMENT SURFACE, 3 1/2 " DEPTH
- (W) REINFORCED CEMENT CONCRETE CURB, 36"
- X CURB CHEEK WALL
- REMOVE AND RESET INTERLOCKING PAVERS
- Z) EXPOSED AGGREGATE CONCRETE SIDEWALK, BROWN
- PWSA SIDEWALK TRENCH DRAIN WITH ADA COMPLIANT AND BICYCLE SAFE GRATE
- TT DIRECTIONAL ARROWS

NOTE: ASPHALT TACK COAT IS REQUIRED BETWEEN ALL ASPHALT PAVING COURSES AND ON MILLED SURFACES PRIOR TO PLACING OVERLAY

NOTE: EXISTING TROLLEY TRACKS SHOWN FOR INFORMATION ONLY. THE EXACT LOCATION, LIMITS, AND TYPE OF TRACK IS UNKNOWN. TROLLEY TRACKS MAY HAVE BEEN REMOVED.

707 Grant Street 5th Floor Pittsburgh, PA 15219

THE PREPARATION OF THIS DOCUMENT HAS BEEN FINANCED IN PART THROUGH A GRANT FROM THE FEDERAL TRANSIT ADMINISTRATION U.S. DEPARTMENT OF TRANSPORTATION, UNDER THE URBAN MASS TRANSPORTATION ACT OF 1964 AS AMENDED FOR THE PORT AUTHORITY OF ALLEGHENY COUNTY, PENNSYLVANIA. NO. DATE DESCRIPTION REVISIONS


(NOT FOR CONSTRUCTION)


DESIGNED	<u>SDS</u>	
DRAWN	SDS	
CHECKED	BFS	
IN CHARGE	<u>LAR</u>	
DATE	05/01/24	
SCALE		
	AS SHOWN	

PORT AUTHORITY OF ALLEGHENY COUNTY

BUS RAPID TRANSIT UPTOWN TO OAKLAND TYPICAL SECTIONS FIFTH AVE / CHATHAM SQ TO MAGEE ST CONTRACT NO. BRT-001 Port Authority DWG. NO. CV2 sнт. **77** 

BUILDING

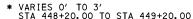

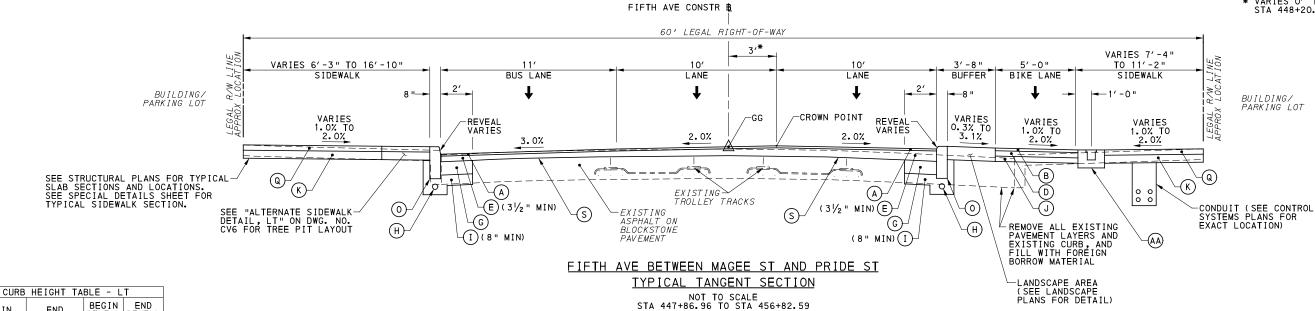

LUKD	HEIGHT IA	DLE - L	
BEGIN STA	END STA	BEGIN REVEAL (IN)	END REVEAL ( IN)
447+98.38	448+19.00	2	6
448+19.00	449+32.86	6	6
449+64.62	450+35.00	6	6
450+35.00	450+48.00	6	21/2
450+48.00	450+75.00	21/2	6
450+75.00	452+52.98	6	6
453+26.77	453+30.00	7	7
453+30.00	453+40.00	7	3
453+40.00	455+25.00	3	3
455+40.00	455+44.00	2	7
455+44.00	456+40.70	7	7

CURB	HEIGHT TA	BLE - R	Ť
BEGIN STA	END STA	BEGIN REVEAL (IN)	END REVEAL (IN)
448+21.01	449+05.00	7	7
449+05.00	449+40.00	7	2
449+40.00	452+58.89	2	2
453+27.75	453+45.00	7	7
453+45.00	453+60.00	7	9
453+60.00	454+10.00	თ	91
454+10.00	454+35.00	9	4
454+35.00	455+32.00	4	4
455+54.00	456+41.48	2	2

NOTE: EXISTING TROLLEY TRACKS SHOWN FOR INFORMATION ONLY, THE EXACT LOCATION, LIMITS, AND TYPE OF TRACK IS UNKNOWN. TROLLEY TRACKS MAY HAVE BEEN REMOVED.

### **LEGEND**

- SUPERPAVE ASPHALT MIXTURE DESIGN, WEARING COURSE, PG 64E-22, 10 TO <30 MILLION ESALS, 9.5 MM MIX, 1/2" DEPTH, SRL-H
- SUPERPAVE ASPHALT MIXTURE DESIGN, WEARING COURSE, PG 64S-22, <0.3, MILLION ESALS, 9.5 MM MIX, 2" DEPTH, SRL-H
- SUPERPAVE ASPHALT MIXTURE DESIGN, BINDER COURSE, PG 64E-22, 10 TO <30 MILLION ESALS, 19.0 MM MIX, 2" DEPTH
- SUPERPAVE ASPHALT MIXTURE DESIGN, BASE COURSE, PG 64S-22, <0.3 MILLION ESALS, 25.0 MM MIX, 4" DEPTH (D)
- SUPERPAVE ASPHALT MIXTURE DESIGN, BINDER COURSE (LEVELING), PG 64E-22, 10 TO <30 MILLION ESALS, 19.0 MM MIX
- F PLAIN CEMENT CONCRETE PAVEMENT, 4" DEPTH
- G REINFORCED CEMENT CONCRETE BASE COURSE, 10" DEPTH
- 4" PAVEMENT BASE DRAIN
- SUBBASE (NO. 2A) (MATCH ADJACENT SUBBASE DEPTH) OVER GEOTEXTILE CLASS 4, TYPE A
- J SUBBASE 4" DEPTH (NO. 2A)
- (K) SUBBASE 6" DEPTH (NO. 2A)
- SUBBASE 8" DEPTH (NO. 2A)
  OVER GEOTEXTILE CLASS 4, TYPE A
- M PLAIN CONCRETE MOUNTABLE CURB,
- (N) CONCRETE BUFFER
- O REINFORCED CEMENT CONCRETE CURB
- (P) GRANITE CURB

- REINFORCED CEMENT CONCRETE SIDEWALK, 4" DEPTH
- MILLING OF CEMENT CONCRETE PAVEMENT SURFACE, 2" DEPTH
- MILLING OF ASPHALT PAVEMENT SURFACE, VARIABLE DEPTH (MILL TO SANDSTONE BLOCK LAYER)
- MILLING OF ASPHALT PAVEMENT SURFACE, 1 1/2 " DEPTH
- MILLING OF ASPHALT PAVEMENT SURFACE, 2" DEPTH

MILLING OF ASPHALT PAVEMENT SURFACE, 3 1/2 " DEPTH

- W REINFORCED CEMENT CONCRETE CURB, 36"
- X CURB CHEEK WALL
- REMOVE AND RESET INTERLOCKING PAVERS
- Z) EXPOSED AGGREGATE CONCRETE SIDEWALK, BROWN
- PWSA SIDEWALK TRENCH DRAIN WITH ADA COMPLIANT AND BICYCLE SAFE GRATE
- TT DIRECTIONAL ARROWS

NOTE: ASPHALT TACK COAT IS REQUIRED BETWEEN ALL ASPHALT PAVING COURSES AND ON MILLED SURFACES PRIOR TO PLACING OVERLAY

sнт. 78

**Gulf Tower** 707 Grant Street 5th Floor Pittsburgh, PA 15219

THE PREPARATION OF THIS DOCUMENT HAS BEEN FINANCED IN PART THROUGH A GRANT FROM THE FEDERAL TRANSIT ADMINISTRATION U.S. DEPARTMENT OF TRANSPORTATION, UNDER THE URBAN MASS TRANSPORTATION ACT OF 1964, AS AMENDED, FOR THE PORT AUTHORITY OF ALLEGHENY COUNTY, PENNSYLVANIA. NO. DATE DESCRIPTION REVISIONS

(NOT FOR CONSTRUCTION)


DESIGNED	<u>SDS</u>	
DRAWN	SDS	
CHECKED	BFS	
IN CHARGE	<u>LAR</u>	
DATE	05/01/24	
SCALE		
	AS SHOWN	


PORT AUTHORITY OF ALLEGHENY COUNTY

BUS RAPID TRANSIT UPTOWN TO OAKLAND

TYPICAL SECTIONS FIFTH AVE / MAGEE ST TO PRIDE ST

CONTRACT NO. BRT-001 **Port Authority** DWG. NO. CV3

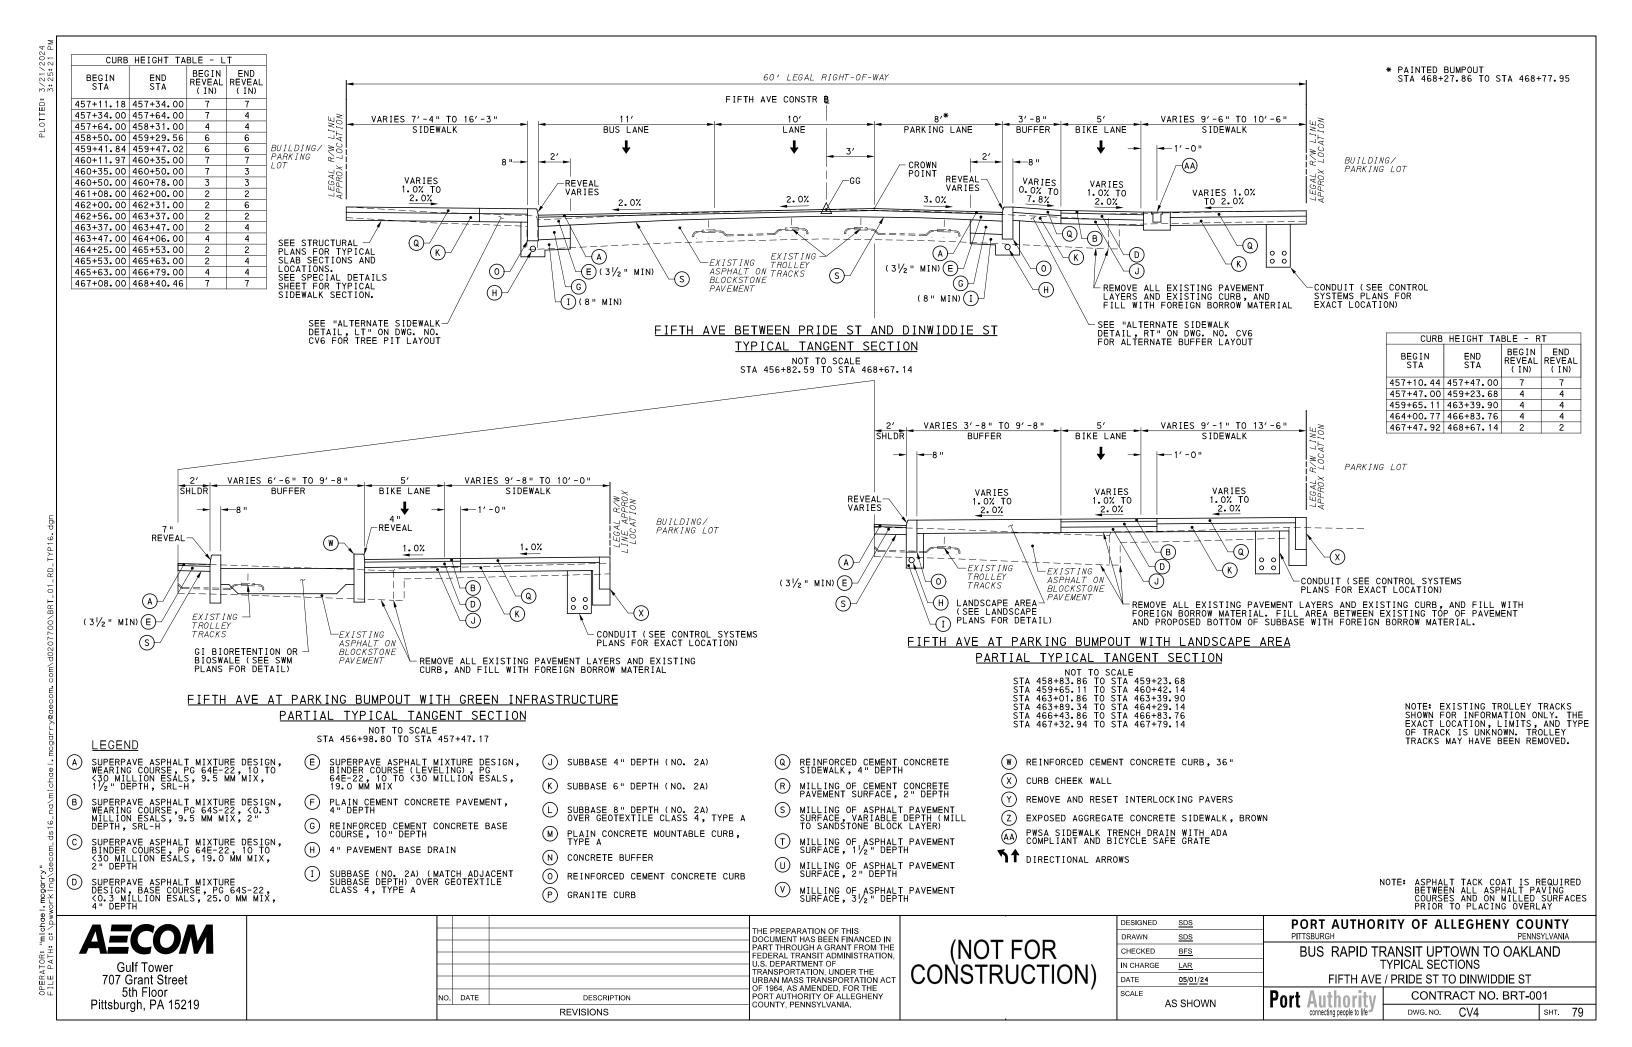

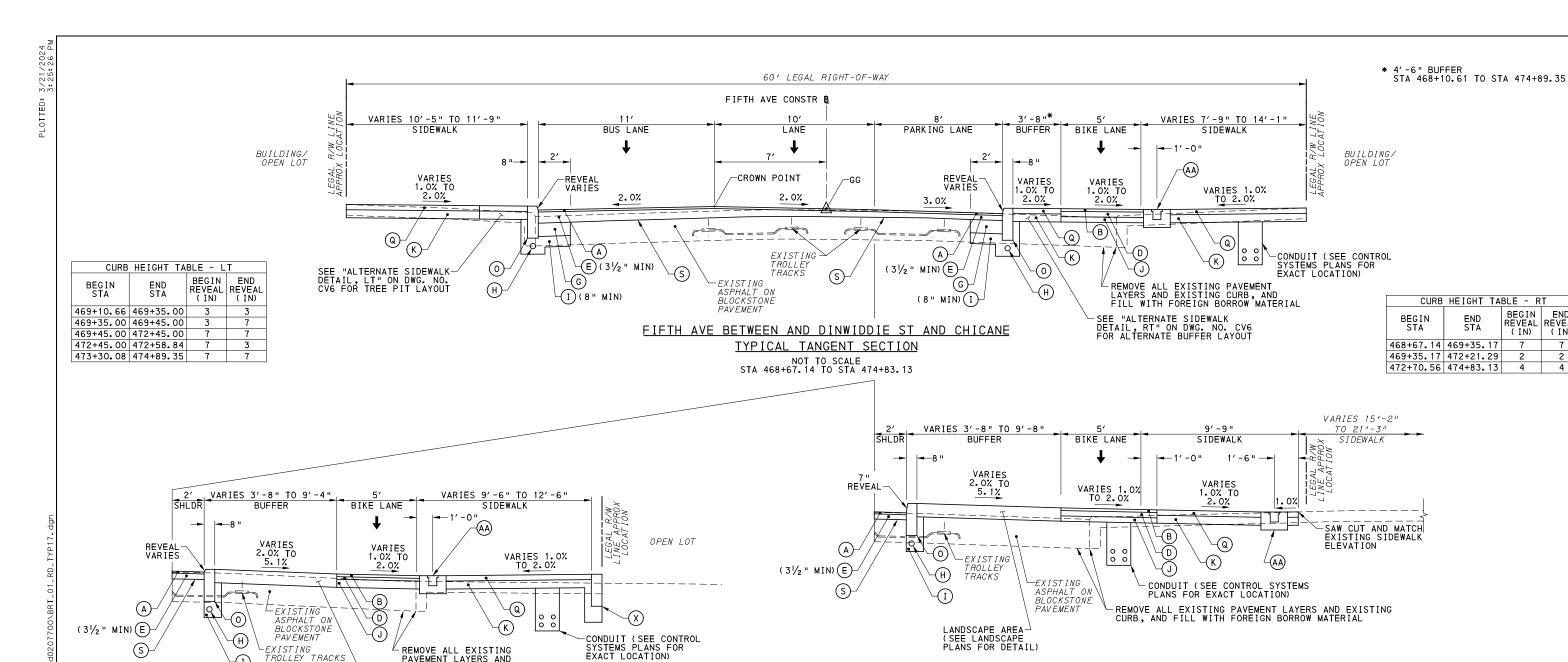

FIFTH AVE AT PARKING BUMPOUT WITH LANDSCAPE AREA PARTIAL TYPICAL TANGENT SECTION

NOT TO SCALE STA 468+67.14 TO STA 469+35.17

NOTE: EXISTING TROLLEY TRACKS SHOWN FOR INFORMATION ONLY, THE EXACT LOCATION, LIMITS, AND TYPE OF TRACK IS UNKNOWN. TROLLEY TRACKS MAY HAVE BEEN REMOVED.

BEGIN END REVEAL (IN) (IN)

### **LEGEND**

SUPERPAVE ASPHALT MIXTURE DESIGN, WEARING COURSE, PG 64E-22, 10 TO <30 MILLION ESALS, 9.5 MM MIX, 1/2" DEPTH, SRL-H

FXISTING

TROLLEY TRACKS LANDSCAPE AREA

(SEE LANDSCAPE PLANS FOR DETAIL)

- SUPERPAVE ASPHALT MIXTURE DESIGN, WEARING COURSE, PG 64S-22, <0.3 MILLION ESALS, 9.5 MM MIX, 2" DEPTH, SRL-H
- SUPERPAVE ASPHALT MIXTURE DESIGN, BINDER COURSE, PG 64E-22, 10 TO <30 MILLION ESALS, 19.0 MM MIX, 2" DEPTH
- SUPERPAVE ASPHALT MIXTURE DESIGN, BASE COURSE, PG 64S-22, <0.3 MILLION ESALS, 25.0 MM MIX, 4" DEPTH
- SUPERPAVE ASPHALT MIXTURE DESIGN, BINDER COURSE (LEVELING), PG 64E-22, 10 TO <30 MILLION ESALS, 19.0 MM MIX

∠ REMOVE ALL EXISTING
PAVEMENT LAYERS AND
EXISTING CURB, AND FILL WITH
FOREIGN BORROW MATERIAL

FIFTH AVE AT PARKING BUMPOUT WITH LANDSCAPE AREA

PARTIAL TYPICAL TANGENT SECTION NOT TO SCALE STA 471+79.86 TO STA 472+21.29 STA 472+70.56 TO STA 473+10.70

- SUBBASE (NO. 2A) (MATCH ADJACENT SUBBASE DEPTH) OVER GEOTEXTILE CLASS 4, TYPE A

- (N) CONCRETE BUFFER
- (P) GRANITE CURB

- REINFORCED CEMENT CONCRETE SIDEWALK, 4" DEPTH
- MILLING OF CEMENT CONCRETE PAVEMENT SURFACE, 2" DEPTH
- MILLING OF ASPHALT PAVEMENT SURFACE, VARIABLE DEPTH (MILL TO SANDSTONE BLOCK LAYER)
- MILLING OF ASPHALT PAVEMENT SURFACE, 1 1/2 " DEPTH
- MILLING OF ASPHALT PAVEMENT SURFACE, 2" DEPTH

MILLING OF ASPHALT PAVEMENT SURFACE, 3 1/2 " DEPTH

- (W) REINFORCED CEMENT CONCRETE CURB, 36"
- X CURB CHEEK WALL
- REMOVE AND RESET INTERLOCKING PAVERS
- Z) EXPOSED AGGREGATE CONCRETE SIDEWALK, BROWN
- PWSA SIDEWALK TRENCH DRAIN WITH ADA COMPLIANT AND BICYCLE SAFE GRATE
- TT DIRECTIONAL ARROWS

ASPHALT TACK COAT IS REQUIRED BETWEEN ALL ASPHALT PAVING COURSES AND ON MILLED SURFACES PRIOR TO PLACING OVERLAY

sнт. 80

707 Grant Street 5th Floor Pittsburgh, PA 15219

THE PREPARATION OF THIS DOCUMENT HAS BEEN FINANCED IN PART THROUGH A GRANT FROM THE FEDERAL TRANSIT ADMINISTRATION U.S. DEPARTMENT OF TRANSPORTATION, UNDER THE URBAN MASS TRANSPORTATION ACT OF 1964 AS AMENDED FOR THE NO. DATE DESCRIPTION COUNTY, PENNSYLVANIA. REVISIONS

(NOT FOR CONSTRUCTION)

PLANS FOR DETAIL)

SDS		
SDS		
BFS		
<u>LAR</u>		
05/01/24		
AS SHOWN		
	SDS BFS LAR 05/01/24	SDS BFS LAR 05/01/24

PORT AUTHORITY OF ALLEGHENY COUNTY

BUS RAPID TRANSIT UPTOWN TO OAKLAND TYPICAL SECTIONS FIFTH AVE / DINWIDDIE ST TO CHICANE

PITTSBURGH

CONTRACT NO. BRT-001 **Port Authorit** CV5 DWG NO

 $\stackrel{\textstyle \leftarrow}{\mathsf{F}}$  PLAIN CEMENT CONCRETE PAVEMENT, 4" DEPTH

REINFORCED CEMENT CONCRETE BASE COURSE, 10" DEPTH

4" PAVEMENT BASE DRAIN


J SUBBASE 4" DEPTH (NO. 2A)

(K) SUBBASE 6" DEPTH (NO. 2A)

SUBBASE 8" DEPTH (NO. 2A)
OVER GEOTEXTILE CLASS 4. TYPE A

M PLAIN CONCRETE MOUNTABLE CURB,

O REINFORCED CEMENT CONCRETE CURB

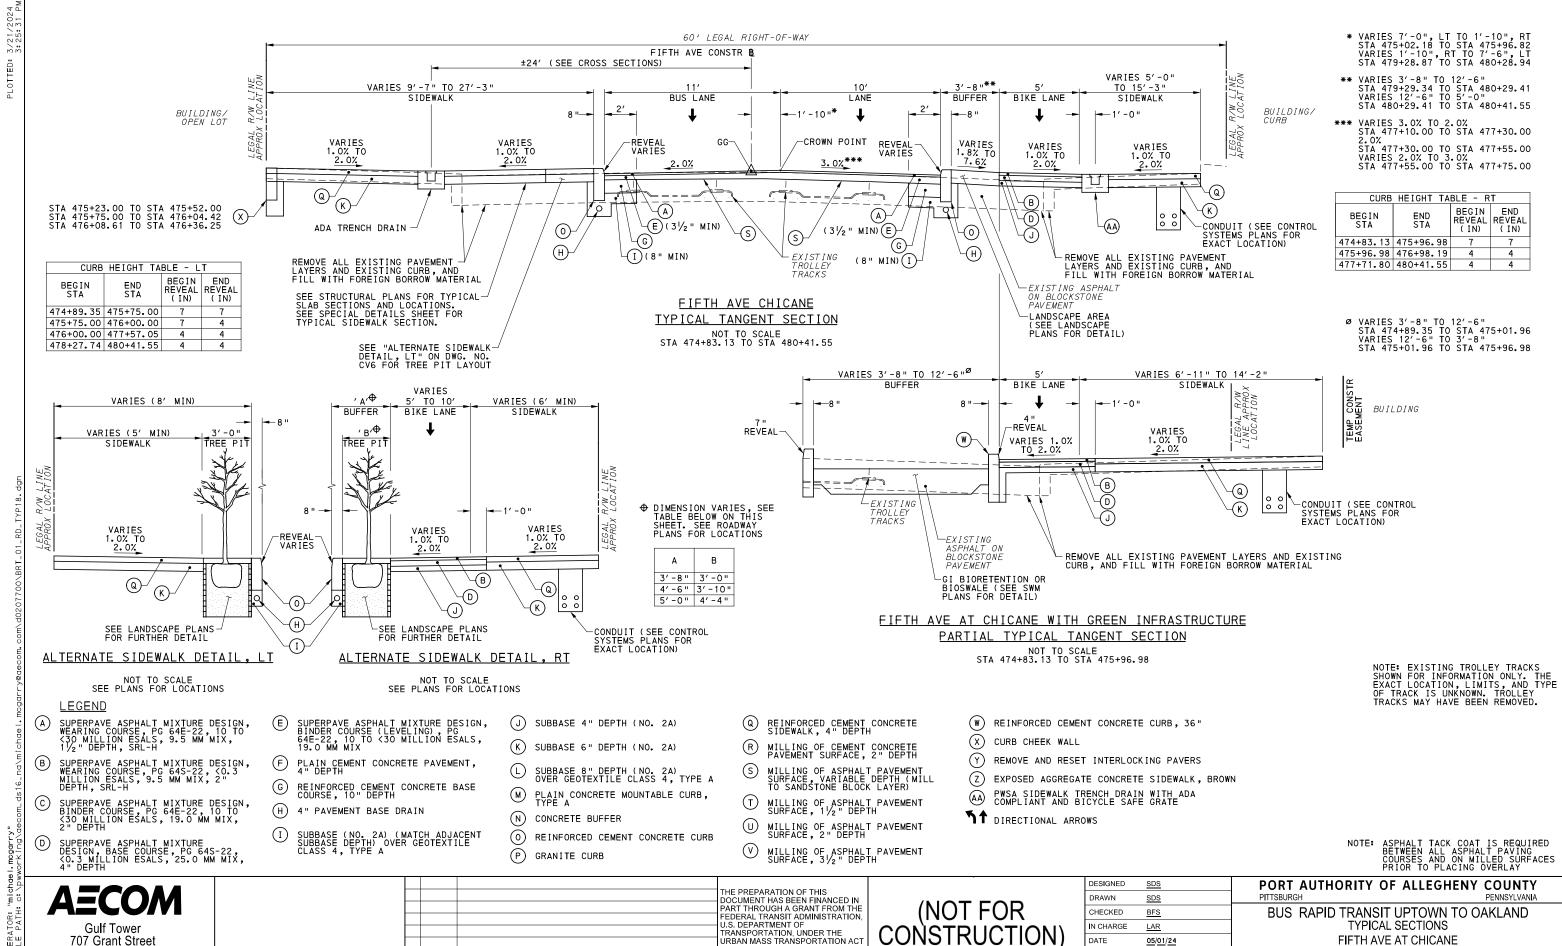

OF 1964, AS AMENDED, FOR THE PORT AUTHORITY OF ALLEGHENY COUNTY, PENNSYLVANIA.

FIFTH AVE AT CHICANE

DWG NO

**Port Authority** 

CONTRACT NO. BRT-001

sнт. 81

CV6

DATE

SCALE

05/01/24

AS SHOWN

707 Grant Street

5th Floor


Pittsburgh, PA 15219

NO. DATE

DESCRIPTION

REVISIONS



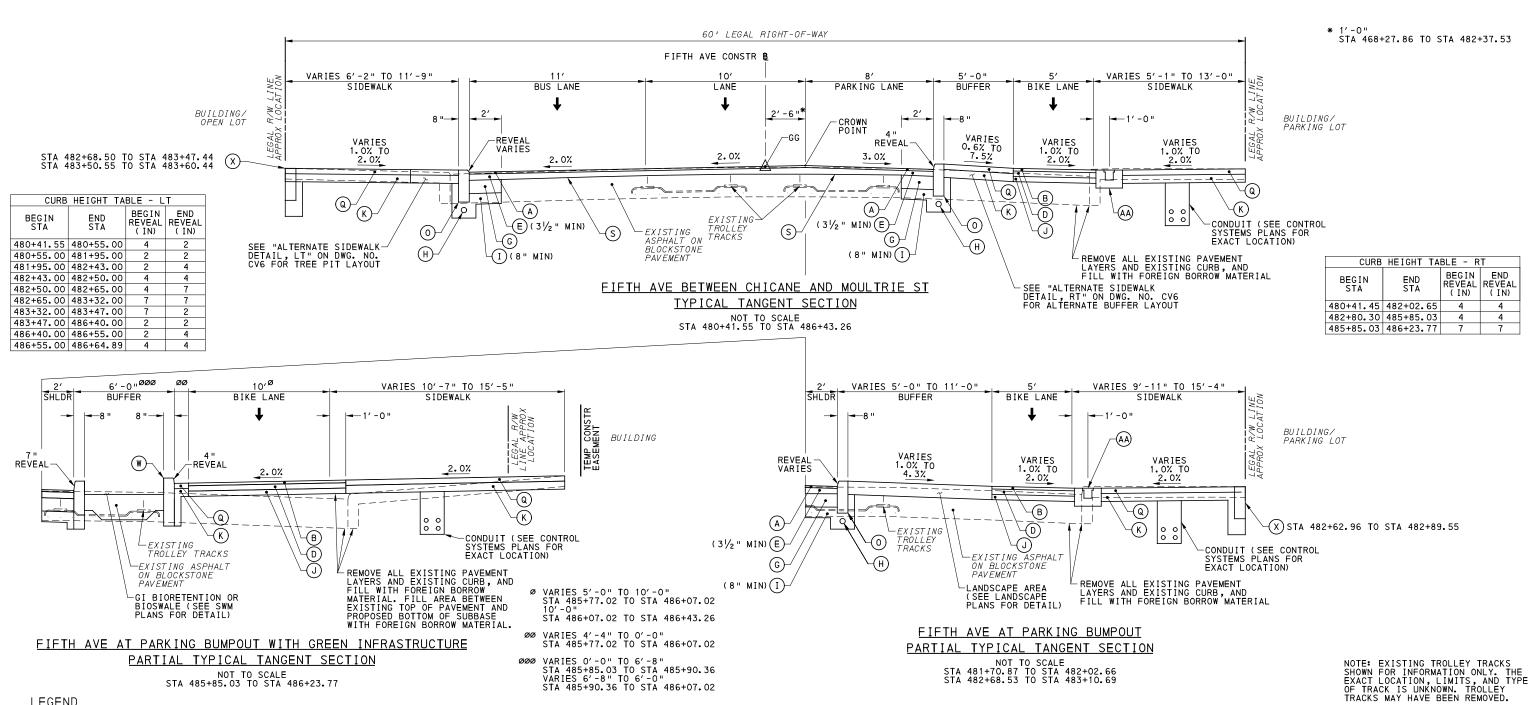

### LEGEND

- SUPERPAVE ASPHALT MIXTURE DESIGN, WEARING COURSE, PG 64E-22, 10 TO <30 MILLION ESALS, 9.5 MM MIX, 11/2" DEPTH, SRL-H
- SUPERPAVE ASPHALT MIXTURE DESIGN, WEARING COURSE, PG 64S-22, <0.3 MILLION ESALS, 9.5 MM MIX, 2" DEPTH, SRL-H
- SUPERPAVE ASPHALT MIXTURE DESIGN, BINDER COURSE, PG 64E-22, 10 TO <30 MILLION ESALS, 19.0 MM MIX, 2" DEPTH
- SUPERPAVE ASPHALT MIXTURE DESIGN, BASE COURSE, PG 64S-22, <0.3 MILLION ESALS, 25.0 MM MIX, 4" DEPTH
- SUPERPAVE ASPHALT MIXTURE DESIGN, BINDER COURSE (LEVELING), PG 64E-22, 10 TO <30 MILLION ESALS, 19.0 MM MIX
- PLAIN CEMENT CONCRETE PAVEMENT, 4" DEPTH
- REINFORCED CEMENT CONCRETE BASE COURSE, 10" DEPTH
- 4" PAVEMENT BASE DRAIN
- SUBBASE (NO. 2A) (MATCH ADJACENT SUBBASE DEPTH) OVER GEOTEXTILE CLASS 4, TYPE A
- J SUBBASE 4" DEPTH (NO. 2A)
- SUBBASE 6" DEPTH (NO. 2A)
- SUBBASE 8" DEPTH (NO. 2A)
  OVER GEOTEXTILE CLASS 4. TYPE A
- M PLAIN CONCRETE MOUNTABLE CURB,
- (N) CONCRETE BUFFER
- O REINFORCED CEMENT CONCRETE CURB
- (P) GRANITE CURB

- REINFORCED CEMENT CONCRETE SIDEWALK, 4" DEPTH
- MILLING OF CEMENT CONCRETE PAVEMENT SURFACE, 2" DEPTH
- MILLING OF ASPHALT PAVEMENT SURFACE, VARIABLE DEPTH (MILL TO SANDSTONE BLOCK LAYER)
- MILLING OF ASPHALT PAVEMENT SURFACE, 1 1/2 " DEPTH

MILLING OF ASPHALT PAVEMENT SURFACE, 3 1/2 " DEPTH

- MILLING OF ASPHALT PAVEMENT SURFACE, 2" DEPTH
- (W) REINFORCED CEMENT CONCRETE CURB, 36"
- (X) CURB CHEEK WALL
- REMOVE AND RESET INTERLOCKING PAVERS
- EXPOSED AGGREGATE CONCRETE SIDEWALK, BROWN
- PWSA SIDEWALK TRENCH DRAIN WITH ADA COMPLIANT AND BICYCLE SAFE GRATE
- TT DIRECTIONAL ARROWS

707 Grant Street 5th Floor Pittsburgh, PA 15219

THE PREPARATION OF THIS DOCUMENT HAS BEEN FINANCED IN PART THROUGH A GRANT FROM THE FEDERAL TRANSIT ADMINISTRATION U.S. DEPARTMENT OF TRANSPORTATION, UNDER THE URBAN MASS TRANSPORTATION ACT OF 1964, AS AMENDED, FOR THE PORT AUTHORITY OF ALLEGHENY NO. DATE DESCRIPTION COUNTY, PENNSYLVANIA. REVISIONS

(NOT FOR CONSTRUCTION)

DESIGNED	SDS	
DRAWN	SDS	
CHECKED	BFS	
IN CHARGE	LAR	
DATE	05/01/24	
SCALE		
	AS SHOWN	

# ASPHALT TACK COAT IS REQUIRED BETWEEN ALL ASPHALT PAYING COURSES AND ON MILLED SURFACES PRIOR TO PLACING OVERLAY PORT AUTHORITY OF ALLEGHENY COUNTY


BUS RAPID TRANSIT UPTOWN TO OAKLAND TYPICAL SECTIONS

FIFTH AVE / CHICANE AND MOULTRIE ST

Port Authorit

CONTRACT NO. BRT-001 CV7 DWG NO

sнт. 82

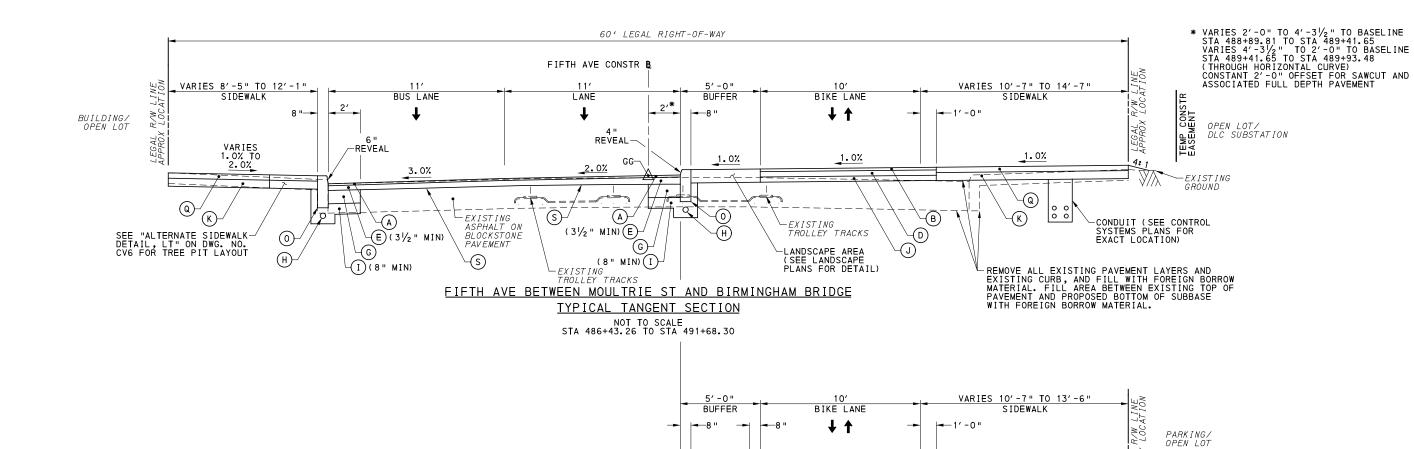

REVEAL-

## FIFTH AVE WITH GREEN INFRASTRUCTURE PARTIAL TYPICAL TANGENT SECTION

VARIES 1.0% TO 2.0%

-EXISTING

ASPHALT ON BLOCKSTONE

PAVEMENT

REVEAL

 $\overline{(W)}$ 

-GI BIORETENTION OR BIOSWALE (SEE SWM PLANS FOR DETAIL)

NOT TO SCALE STA 488+25.33 TO STA 490+89.87

NOTE: EXISTING TROLLEY TRACKS SHOWN FOR INFORMATION ONLY, THE EXACT LOCATION, LIMITS, AND TYPE OF TRACK IS UNKNOWN. TROLLEY TRACKS MAY HAVE BEEN REMOVED.

### **LEGEND**

- SUPERPAVE ASPHALT MIXTURE DESIGN, WEARING COURSE, PG 64E-22, 10 TO <30 MILLION ESALS, 9.5 MM MIX, 11/2" DEPTH, SRL-H
- SUPERPAVE ASPHALT MIXTURE DESIGN, WEARING COURSE, PG 64S-22, <0.3, MILLION ESALS, 9.5 MM MIX, 2" DEPTH, SRL-H
- SUPERPAVE ASPHALT MIXTURE DESIGN, BINDER COURSE, PG 64E-22, 10 TO <30 MILLION ESALS, 19.0 MM MIX, 2" DEPTH
- SUPERPAVE ASPHALT MIXTURE DESIGN, BASE COURSE, PG 64S-22, <0.3 MILLION ESALS, 25.0 MM MIX, 4" DEPTH
- SUPERPAVE ASPHALT MIXTURE DESIGN, BINDER COURSE (LEVELING), PG 64E-22, 10 TO <30 MILLION ESALS, 19.0 MM MIX
- F PLAIN CEMENT CONCRETE PAVEMENT, 4" DEPTH
- G REINFORCED CEMENT CONCRETE BASE COURSE, 10" DEPTH
- 4" PAVEMENT BASE DRAIN
- SUBBASE (NO. 2A) (MATCH ADJACENT SUBBASE DEPTH) OVER GEOTEXTILE CLASS 4, TYPE A
- J SUBBASE 4" DEPTH (NO. 2A)
- (K) SUBBASE 6" DEPTH (NO. 2A)
- SUBBASE 8" DEPTH (NO. 2A)
  OVER GEOTEXTILE CLASS 4. TYPE A
- M PLAIN CONCRETE MOUNTABLE CURB,
- (N) CONCRETE BUFFER
- O REINFORCED CEMENT CONCRETE CURB
- (P) GRANITE CURB

- REINFORCED CEMENT CONCRETE SIDEWALK, 4" DEPTH
- MILLING OF CEMENT CONCRETE PAVEMENT SURFACE, 2" DEPTH
- MILLING OF ASPHALT PAVEMENT SURFACE, VARIABLE DEPTH (MILL TO SANDSTONE BLOCK LAYER)
- MILLING OF ASPHALT PAVEMENT SURFACE, 1 1/2 " DEPTH
- MILLING OF ASPHALT PAVEMENT SURFACE, 2" DEPTH
- MILLING OF ASPHALT PAVEMENT SURFACE, 3 1/2 " DEPTH

(W) REINFORCED CEMENT CONCRETE CURB, 36"

√(B)

(D)

- X CURB CHEEK WALL
- REMOVE AND RESET INTERLOCKING PAVERS
- Z) EXPOSED AGGREGATE CONCRETE SIDEWALK, BROWN
- (AA) PWSA SIDEWALK TRENCH DRAIN WITH ADA COMPLIANT AND BICYCLE SAFE GRATE
- TT DIRECTIONAL ARROWS

NOTE: ASPHALT TACK COAT IS REQUIRED BETWEEN ALL ASPHALT PAVING COURSES AND ON MILLED SURFACES PRIOR TO PLACING OVERLAY

**Gulf Tower** 707 Grant Street 5th Floor Pittsburgh, PA 15219

THE PREPARATION OF THIS DOCUMENT HAS BEEN FINANCED IN PART THROUGH A GRANT FROM THE FEDERAL TRANSIT ADMINISTRATION U.S. DEPARTMENT OF TRANSPORTATION, UNDER THE URBAN MASS TRANSPORTATION ACT OF 1964, AS AMENDED, FOR THE PORT AUTHORITY OF ALLEGHENY NO. DATE DESCRIPTION COUNTY, PENNSYLVANIA. REVISIONS

(NOT FOR CONSTRUCTION)

DESIGNED	SDS	
DRAWN	SDS	
CHECKED	BFS	
IN CHARGE	LAR	
DATE	05/01/24	
SCALE	-	
	AS SHOWN	

VARIES 1.0% TO 2.0%

<u>\_Q</u>

-REMOVE ALL EXISTING PAVEMENT LAYERS AND EXISTING CURB, AND FILL WITH FOREIGN BORROW MATERIAL

(K)

# PORT AUTHORITY OF ALLEGHENY COUNTY


PITTSBURGH BUS RAPID TRANSIT UPTOWN TO OAKLAND TYPICAL SECTIONS FIFTH AVE / MOULTRIE ST TO BIRMINGHAM BRIDGE

DWG NO

**Port Authority** 

-CONDUIT (SEE CONTROL SYSTEMS PLANS FOR EXACT LOCATION)

CONTRACT NO. BRT-001 CV8 sнт. 83

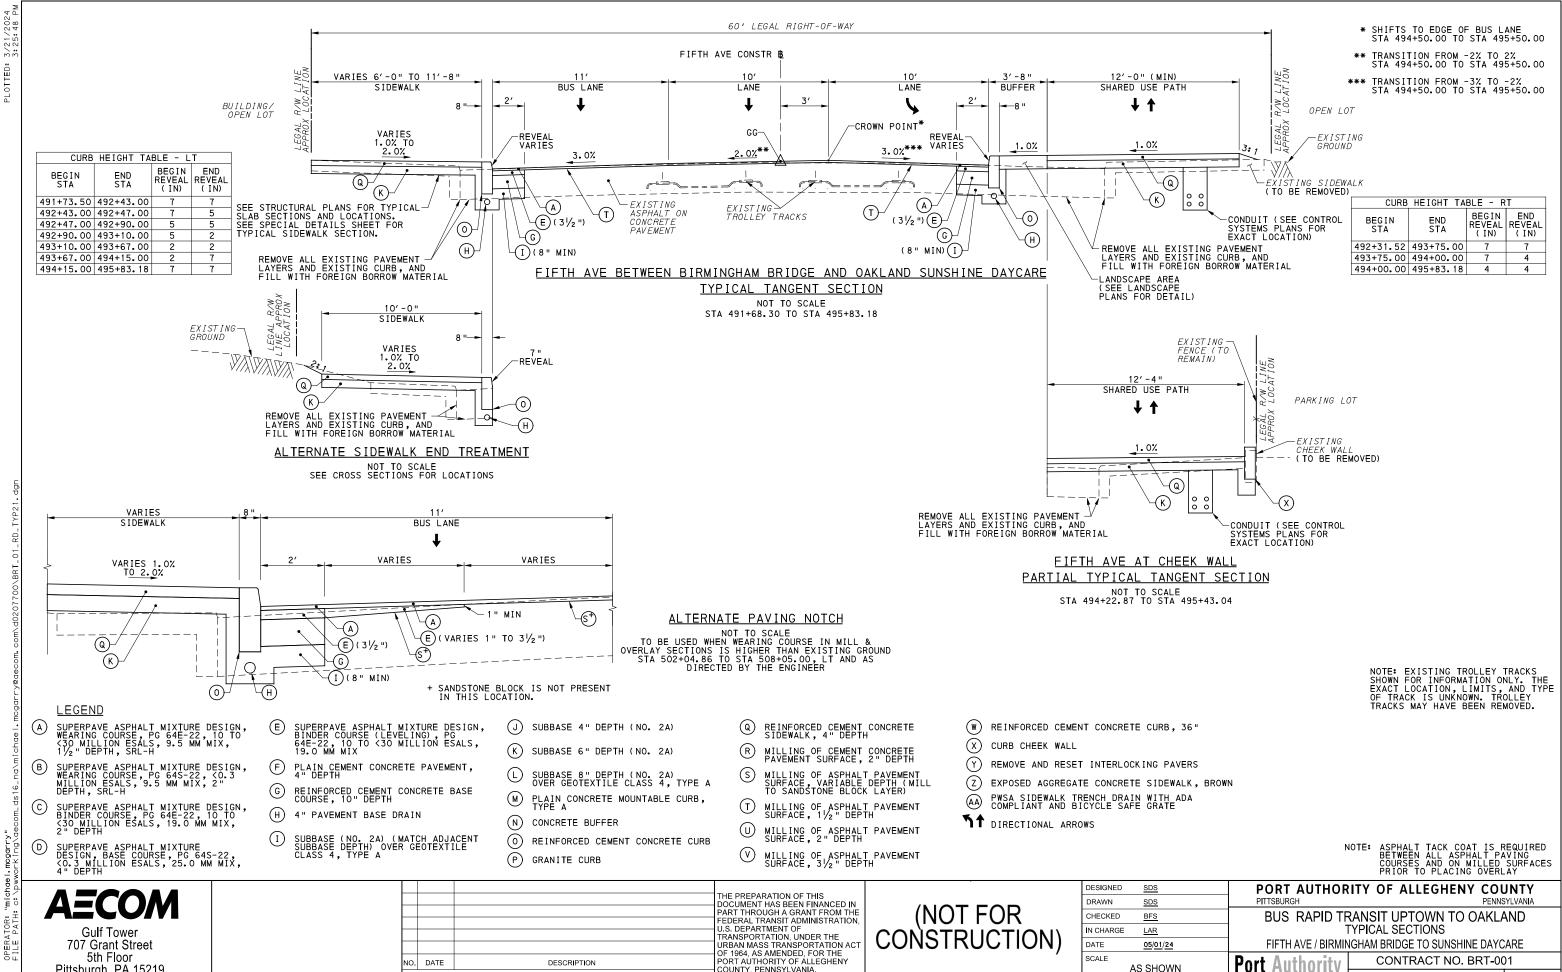

COUNTY, PENNSYLVANIA.

REVISIONS


AS SHOWN


CV9


sнт. **84** 

DWG NO


Pittsburgh, PA 15219

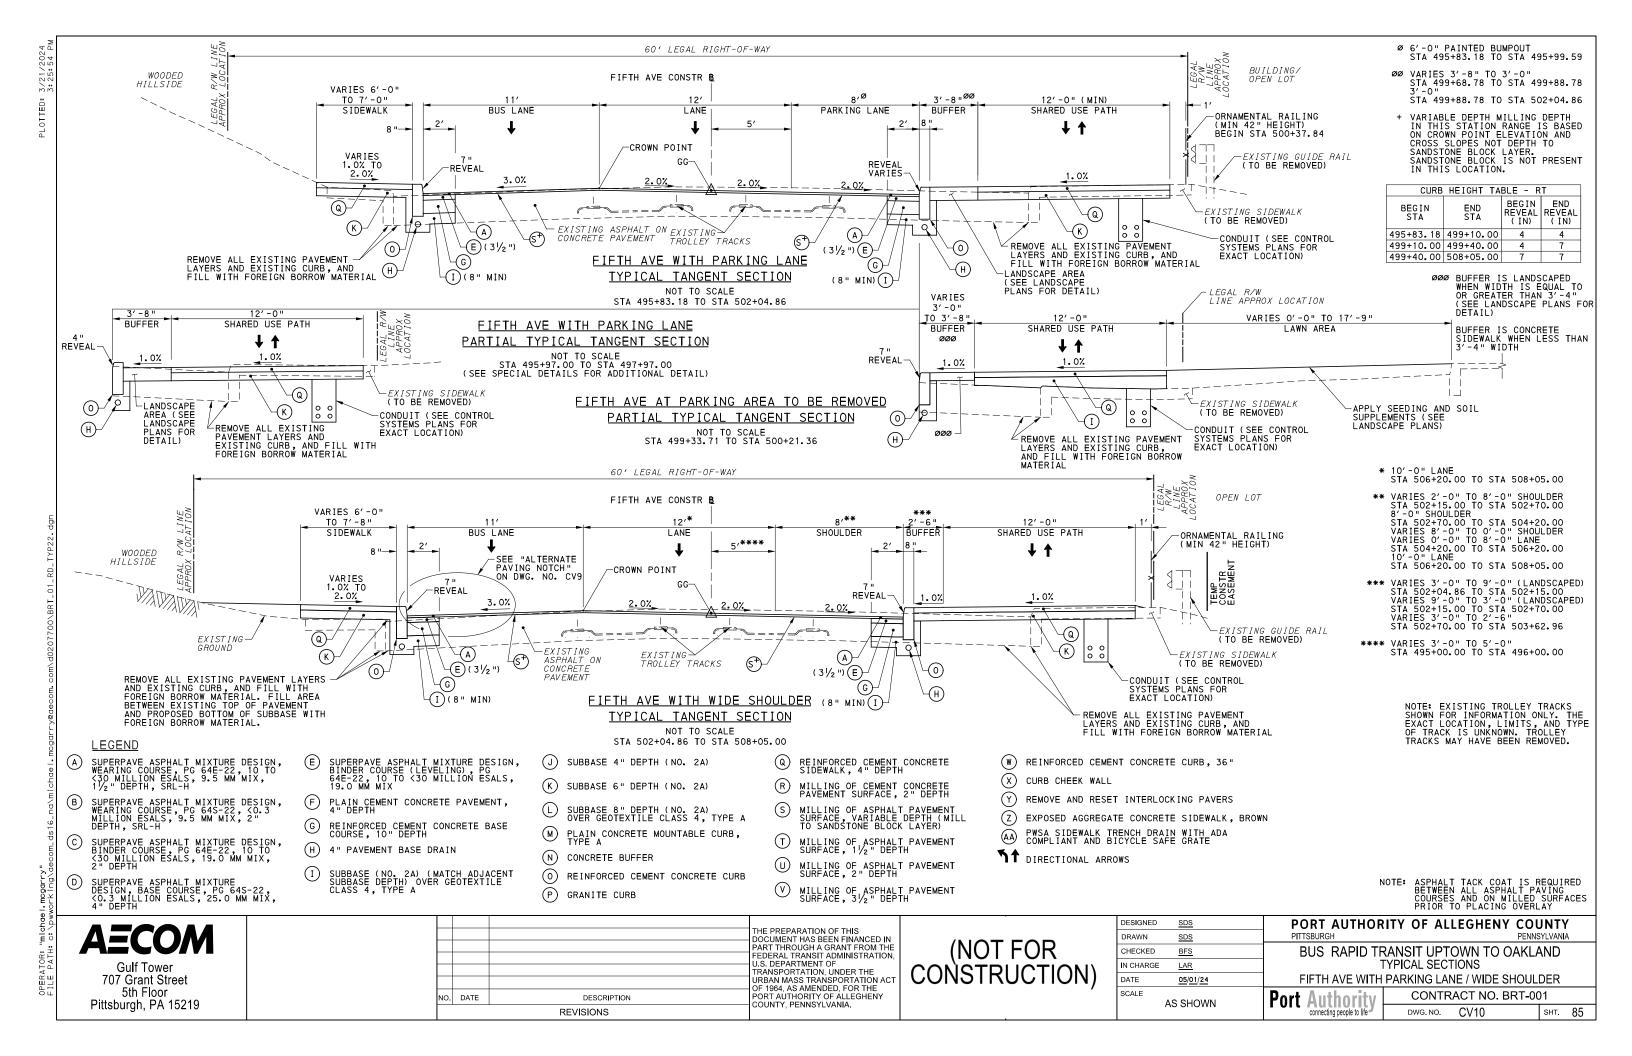

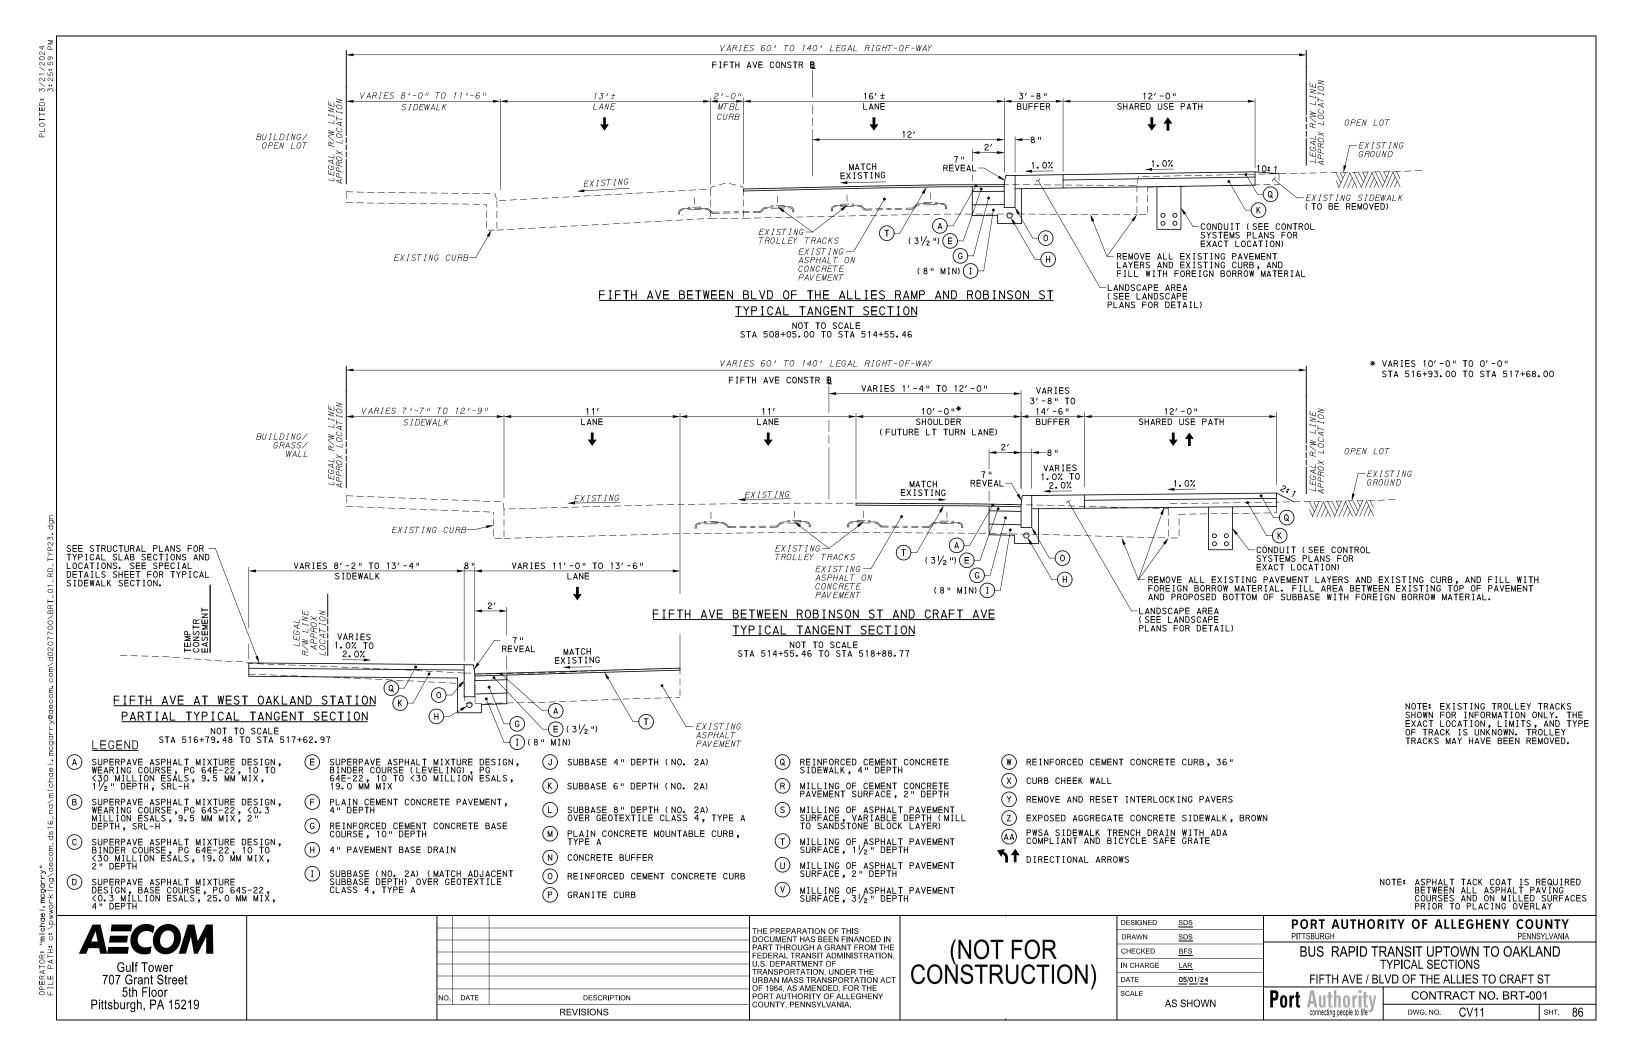

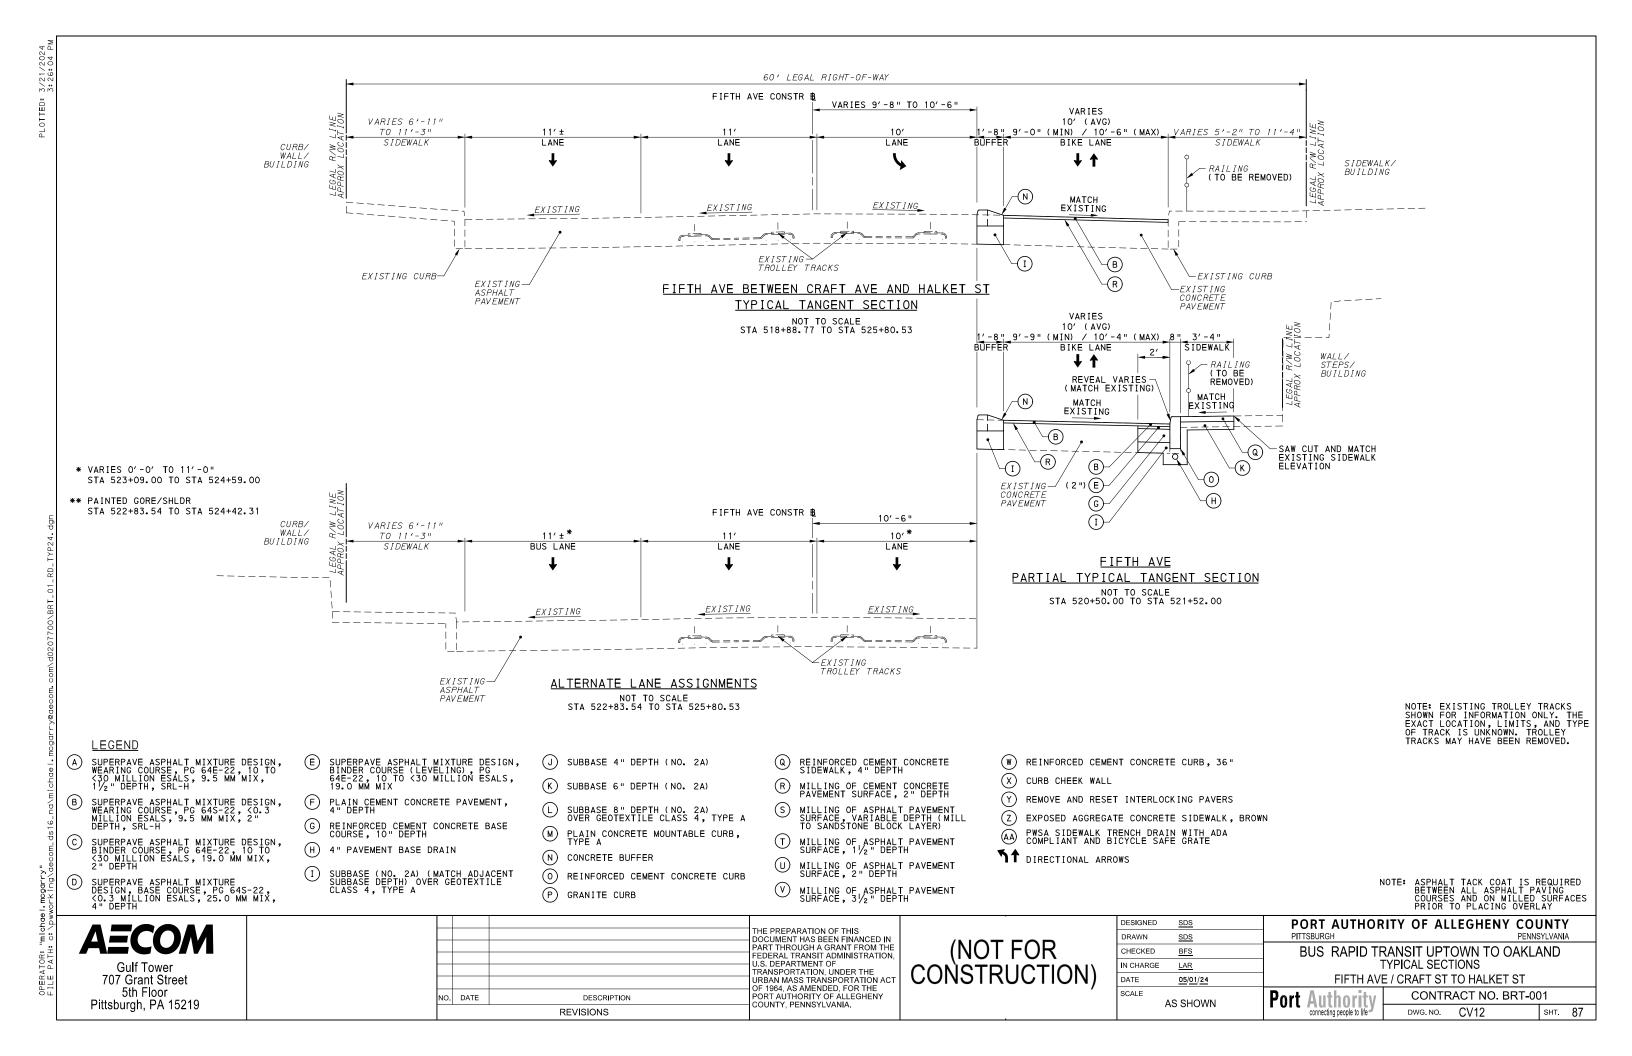



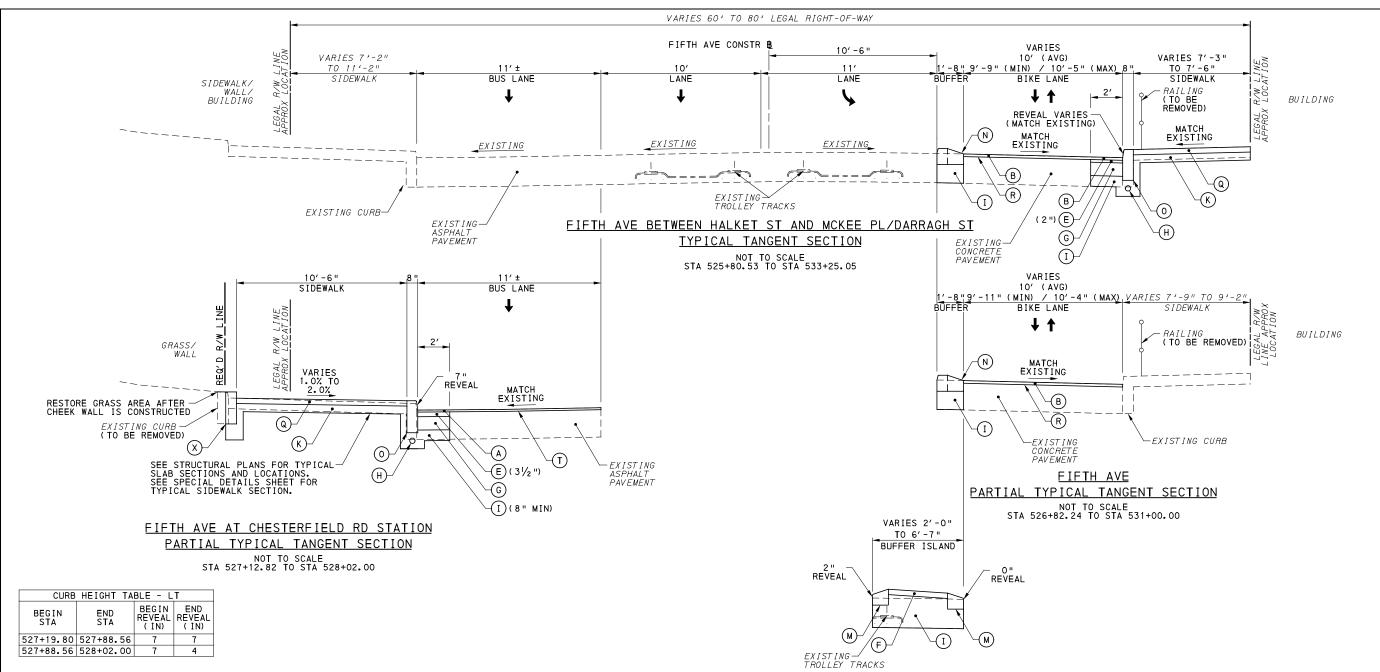

**LEGEND** 

SUPERPAVE ASPHALT MIXTURE DESIGN, WEARING COURSE, PG 64E-22, 10 TO <30 MILLION ESALS, 9.5 MM MIX, 11/2" DEPTH, SRL-H

SUPERPAVE ASPHALT MIXTURE DESIGN, WEARING COURSE, PG 64S-22, <0.3 MILLION ESALS, 9.5 MM MIX, 2" DEPTH, SRL-H

SUPERPAVE ASPHALT MIXTURE DESIGN, BINDER COURSE, PG 64E-22, 10 TO <30 MILLION ESALS, 19.0 MM MIX, 2" DEPTH

SUPERPAVE ASPHALT MIXTURE DESIGN, BASE COURSE, PG 64S-22, <0.3 MILLION ESALS, 25.0 MM MIX, 4" DEPTH

- SUPERPAVE ASPHALT MIXTURE DESIGN, BINDER COURSE (LEVELING), PG 64E-22, 10 TO <30 MILLION ESALS, 19.0 MM MIX
- F PLAIN CEMENT CONCRETE PAVEMENT, 4" DEPTH
- REINFORCED CEMENT CONCRETE BASE COURSE, 10" DEPTH
- 4" PAVEMENT BASE DRAIN
- SUBBASE (NO. 2A) (MATCH ADJACENT SUBBASE DEPTH) OVER GEOTEXTILE CLASS 4, TYPE A
- J SUBBASE 4" DEPTH (NO. 2A)
- (K) SUBBASE 6" DEPTH (NO. 2A)
- SUBBASE 8" DEPTH (NO. 2A)
  OVER GEOTEXTILE CLASS 4. TYPE A
- M PLAIN CONCRETE MOUNTABLE CURB,
- (N) CONCRETE BUFFER
- O REINFORCED CEMENT CONCRETE CURB
- (P) GRANITE CURB

- REINFORCED CEMENT CONCRETE SIDEWALK, 4" DEPTH
- MILLING OF CEMENT CONCRETE PAVEMENT SURFACE, 2" DEPTH
- MILLING OF ASPHALT PAVEMENT SURFACE, VARIABLE DEPTH (MILL TO SANDSTONE BLOCK LAYER)
- MILLING OF ASPHALT PAVEMENT SURFACE, 1 1/2 " DEPTH
- MILLING OF ASPHALT PAVEMENT SURFACE, 2" DEPTH
- (W) REINFORCED CEMENT CONCRETE CURB, 36"
- X CURB CHEEK WALL
- REMOVE AND RESET INTERLOCKING PAVERS
- Z EXPOSED AGGREGATE CONCRETE SIDEWALK, BROWN
- PWSA SIDEWALK TRENCH DRAIN WITH ADA COMPLIANT AND BICYCLE SAFE GRATE

TT DIRECTIONAL ARROWS

NOTE: EXISTING TROLLEY TRACKS SHOWN FOR INFORMATION ONLY. THE EXACT LOCATION, LIMITS, AND TYPE OF TRACK IS UNKNOWN. TROLLEY TRACKS MAY HAVE BEEN REMOVED.

NOTE: ASPHALT TACK COAT IS REQUIRED BETWEEN ALL ASPHALT PAVING COURSES AND ON MILLED SURFACES PRIOR TO PLACING OVERLAY

707 Grant Street 5th Floor Pittsburgh, PA 15219

THE PREPARATION OF THIS DOCUMENT HAS BEEN FINANCED IN PART THROUGH A GRANT FROM THE FEDERAL TRANSIT ADMINISTRATION, U.S. DEPARTMENT OF TRANSPORTATION, UNDER THE URBAN MASS TRANSPORTATION ACT OF 1964, AS AMENDED, FOR THE PORT AUTHORITY OF ALLEGHENY COUNTY, PENNSYLVANIA. NO. DATE DESCRIPTION REVISIONS

(NOT FOR CONSTRUCTION)

ALTERNATE BUFFER DETAIL NOT TO SCALE STA 530+95.32 TO STA 532+53.22

DESIGNED	SDS	
DRAWN	SDS	
CHECKED	<u>BFS</u>	
IN CHARGE	LAR	
DATE	05/01/24	
SCALE		Ī

AS SHOWN


PORT AUTHORITY OF ALLEGHENY COUNTY


BUS RAPID TRANSIT UPTOWN TO OAKLAND


TYPICAL SECTIONS FIFTH AVE / HALKET ST TO MCKEE PL

**Port Authority** 

CONTRACT NO. BRT-001 CV13 sнт. 88 DWG NO

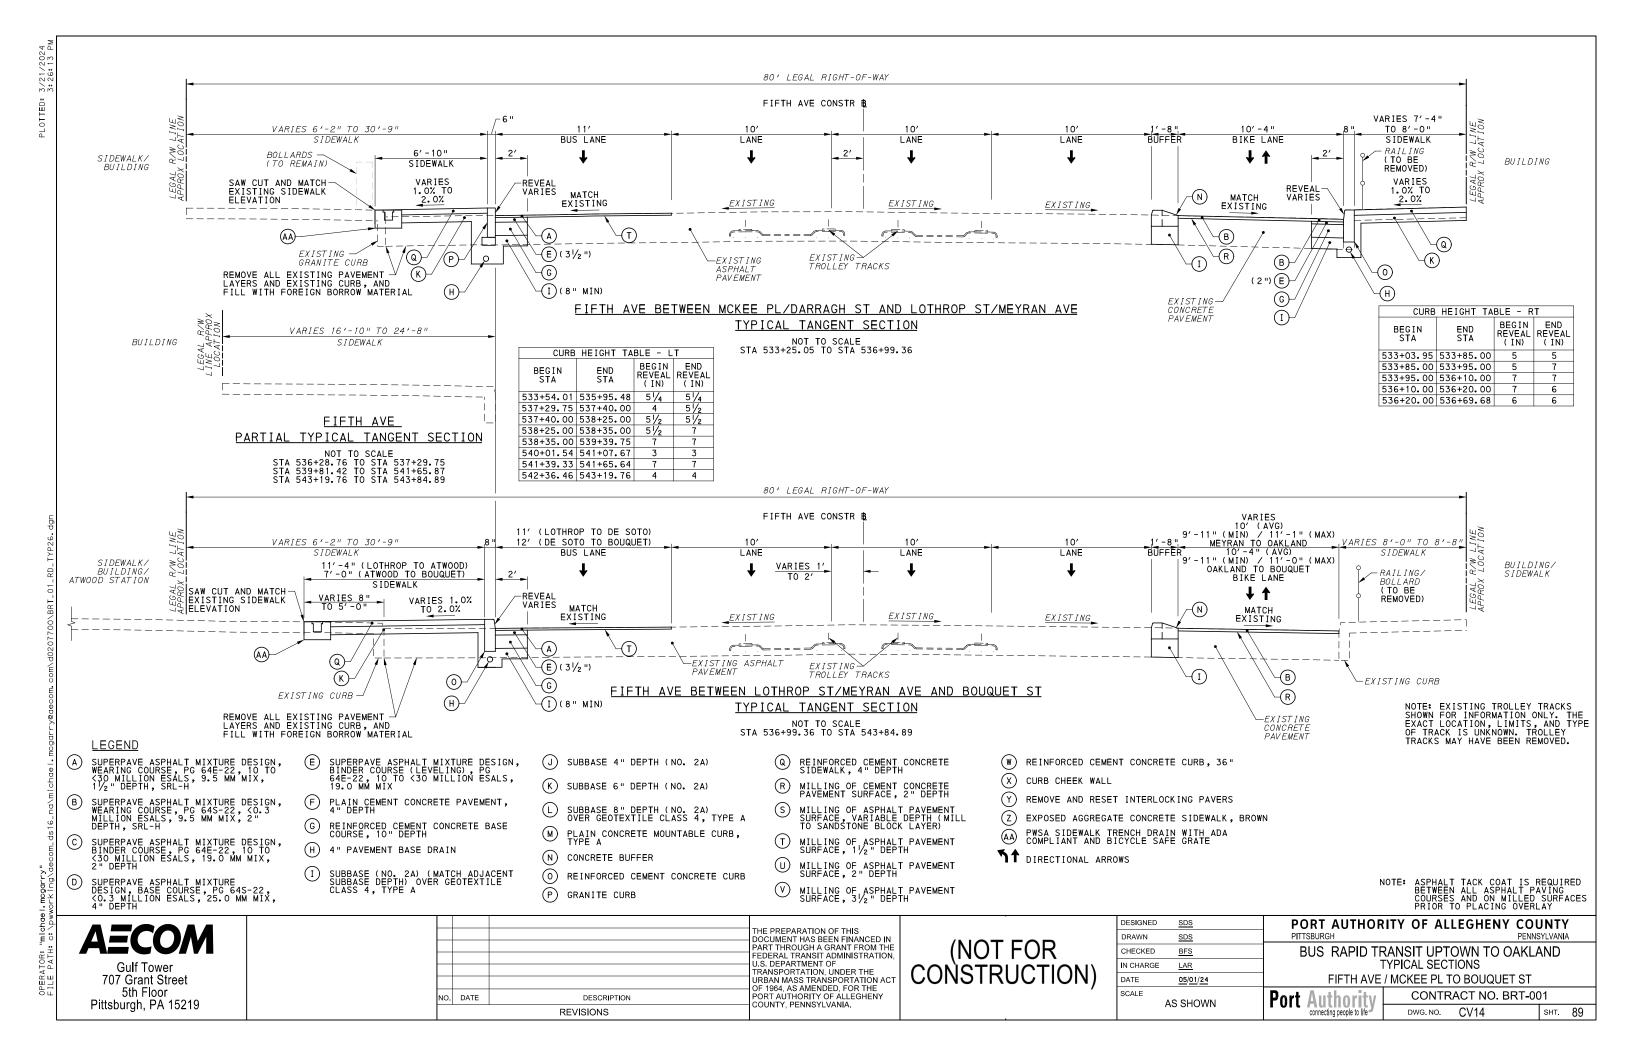

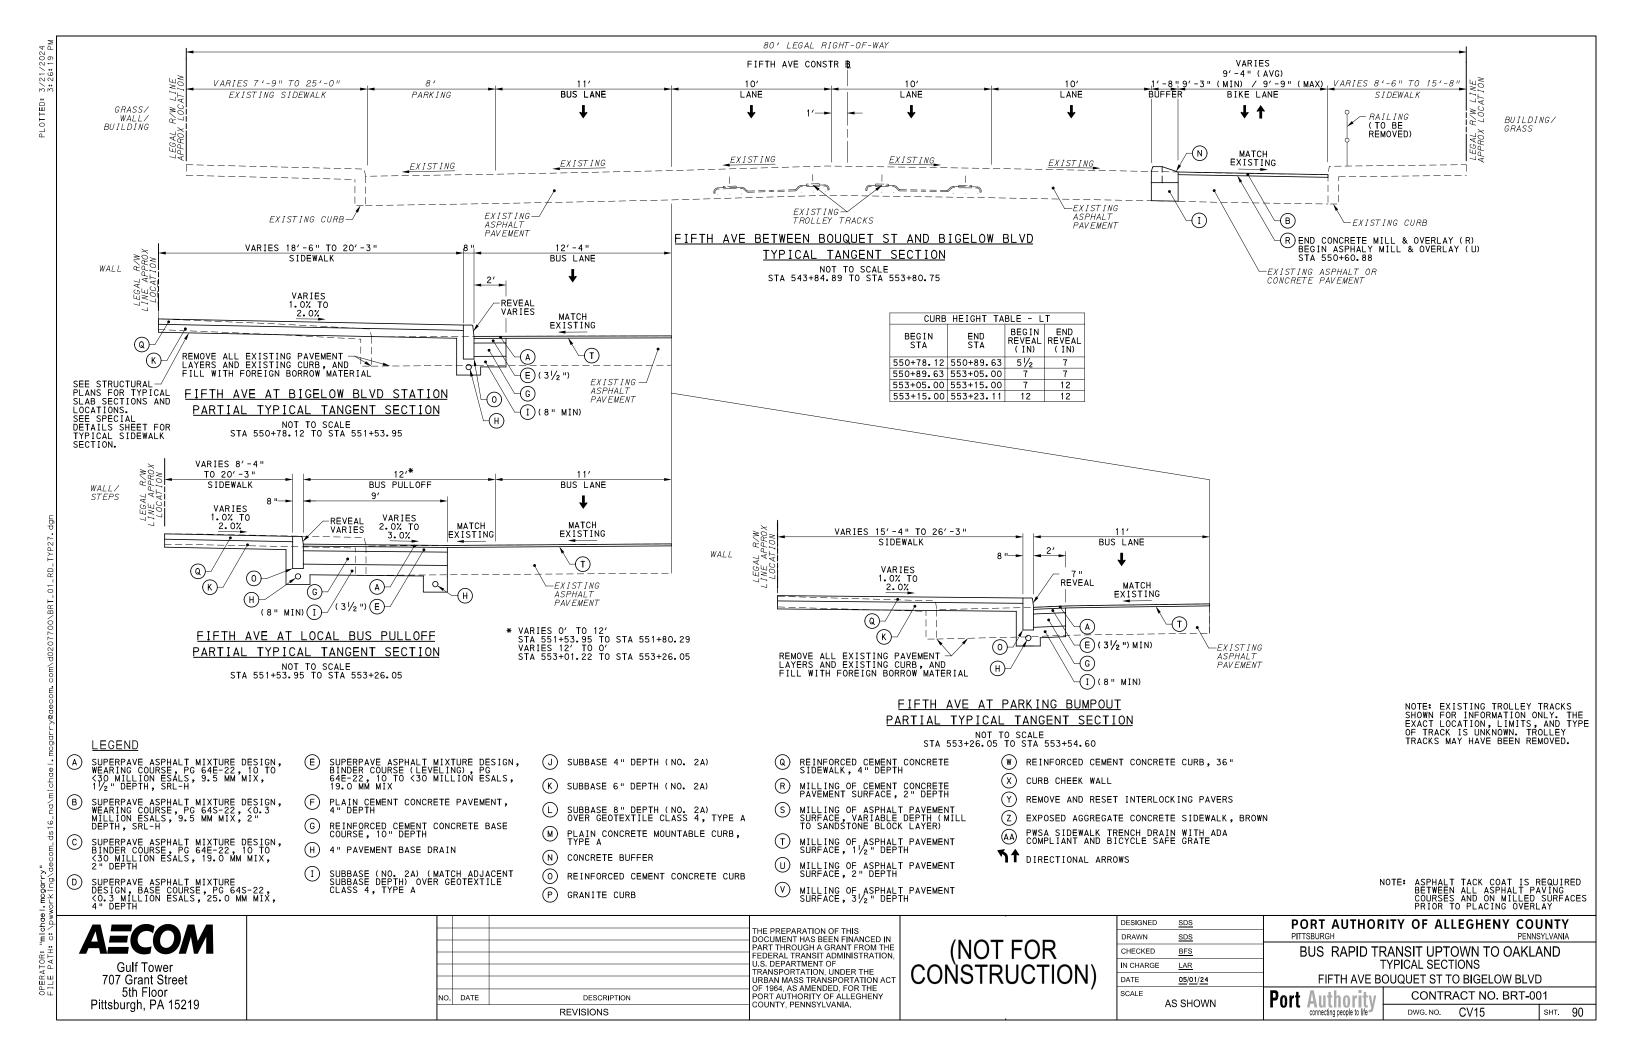

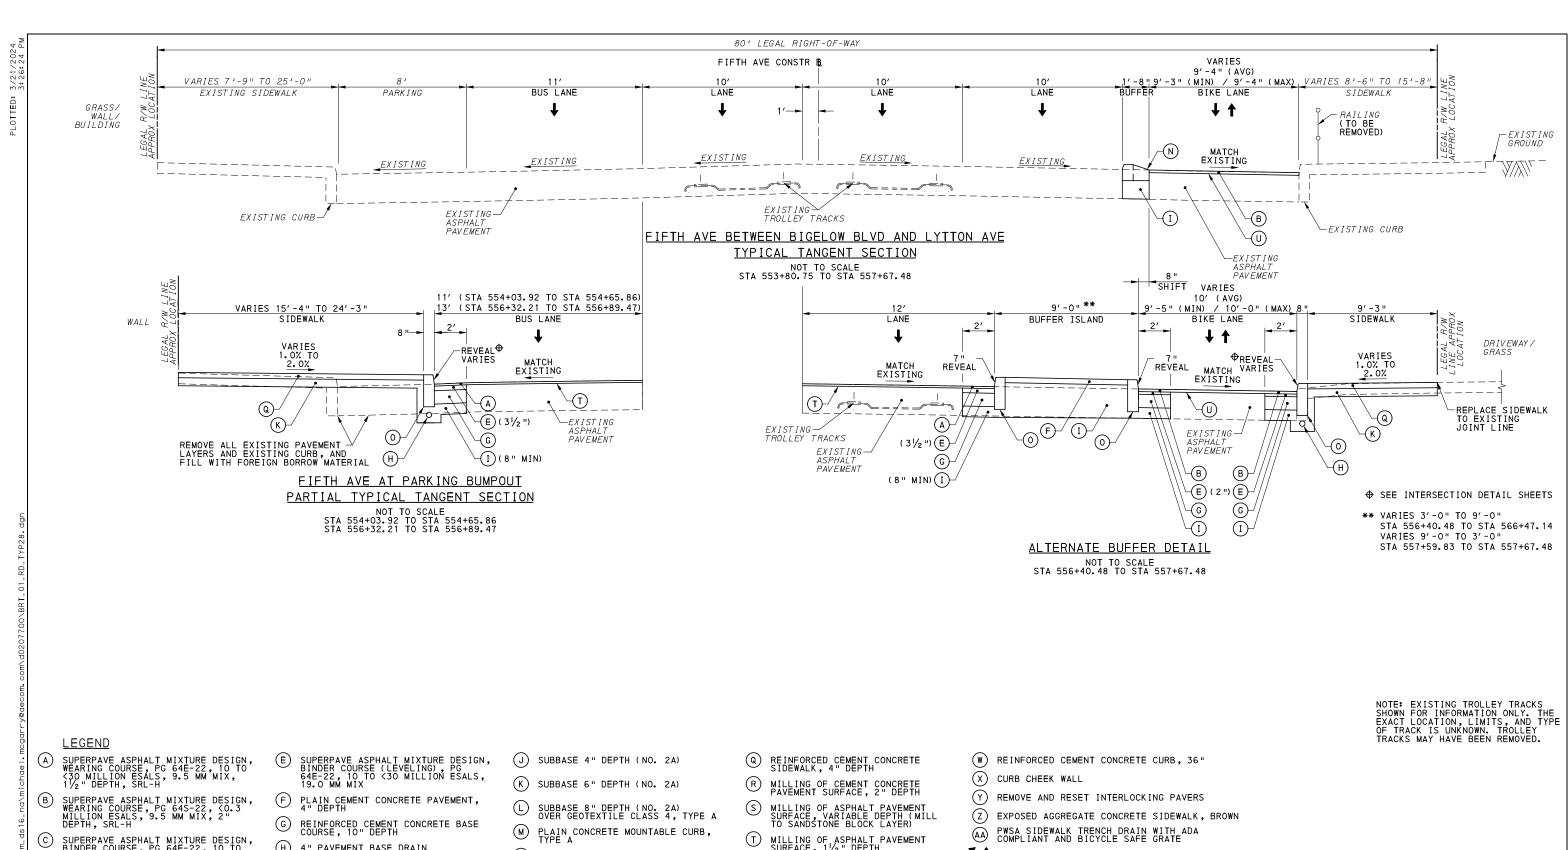

- SUPERPAVE ASPHALT MIXTURE DESIGN, BINDER COURSE, PG 64E-22, 10 TO <30 MILLION ESALS, 19.0 MM MIX, 2" DEPTH
- SUPERPAVE ASPHALT MIXTURE DESIGN, BASE COURSE, PG 64S-22, <0.3 MILLION ESALS, 25.0 MM MIX, 4" DEPTH
- 4" PAVEMENT BASE DRAIN
- SUBBASE (NO. 2A) (MATCH ADJACENT SUBBASE DEPTH) OVER GEOTEXTILE CLASS 4, TYPE A
- (N) CONCRETE BUFFER
- O REINFORCED CEMENT CONCRETE CURB
- (P) GRANITE CURB

MILLING OF ASPHALT PAVEMENT SURFACE, 1 1/2 " DEPTH

MILLING OF ASPHALT PAVEMENT SURFACE, 3 1/2 " DEPTH

MILLING OF ASPHALT PAVEMENT SURFACE, 2" DEPTH

TT DIRECTIONAL ARROWS

NOTE: ASPHALT TACK COAT IS REQUIRED BETWEEN ALL ASPHALT PAVING COURSES AND ON MILLED SURFACES PRIOR TO PLACING OVERLAY

707 Grant Street 5th Floor Pittsburgh, PA 15219

THE PREPARATION OF THIS NO. DATE DESCRIPTION COUNTY, PENNSYLVANIA. REVISIONS

DOCUMENT HAS BEEN FINANCED IN PART THROUGH A GRANT FROM THE FEDERAL TRANSIT ADMINISTRATION U.S. DEPARTMENT OF TRANSPORTATION, UNDER THE URBAN MASS TRANSPORTATION ACT OF 1964, AS AMENDED, FOR THE PORT AUTHORITY OF ALLEGHENY

(NOT FOR CONSTRUCTION)


ESIGNED	SDS	
DRAWN	SDS	
CHECKED	BFS	
N CHARGE	LAR	
ATE	05/01/24	
CALE		
	AS SHOWN	


PORT AUTHORITY OF ALLEGHENY COUNTY

BUS RAPID TRANSIT UPTOWN TO OAKLAND TYPICAL SECTIONS FIFTH AVE / BIGELOW BLVD TO LYTTON AVE

**Port Authorit** 

CONTRACT NO. BRT-001 CV16 DWG NO sнт. 91

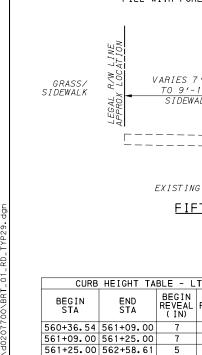

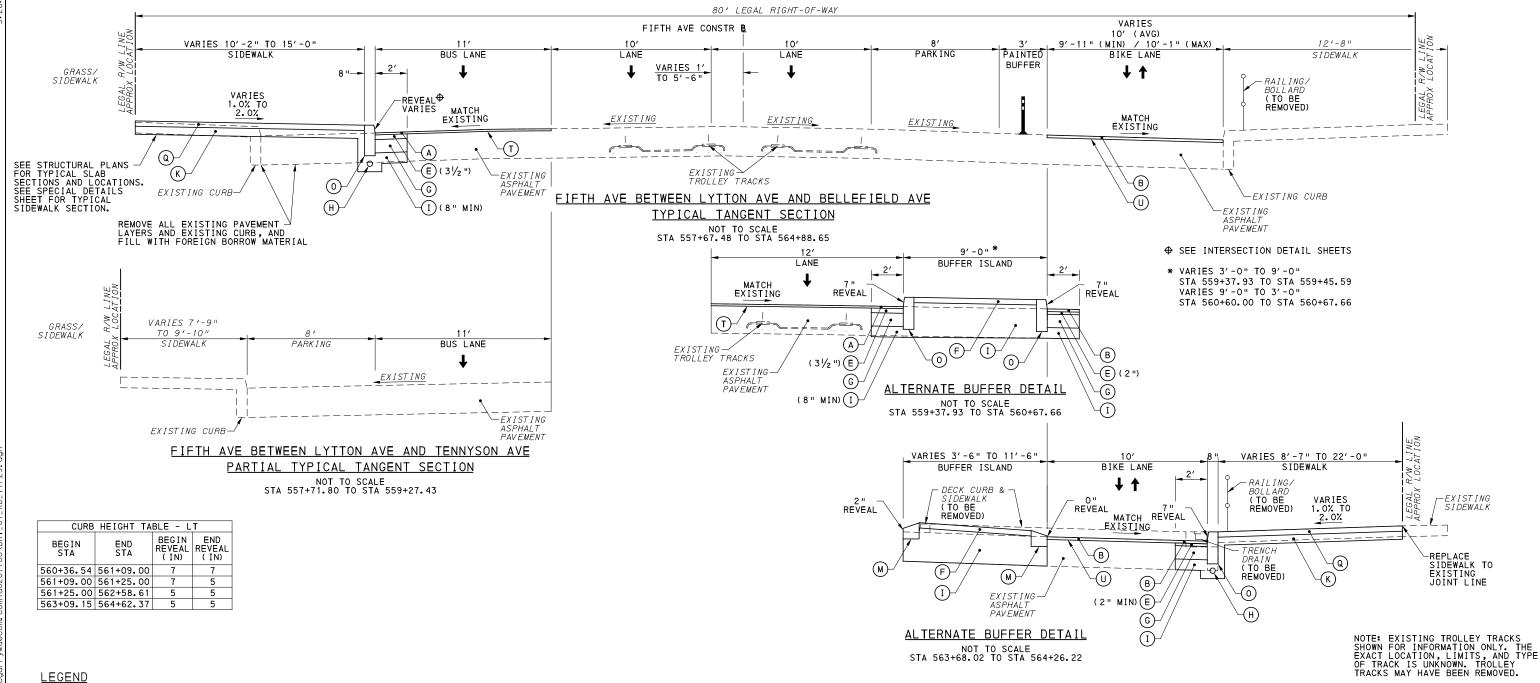

- SUPERPAVE ASPHALT MIXTURE DESIGN, WEARING COURSE, PG 64E-22, 10 TO <30 MILLION ESALS, 9.5 MM MIX, 11/2" DEPTH, SRL-H
- SUPERPAVE ASPHALT MIXTURE DESIGN, WEARING COURSE, PG 64S-22, <0.3, MILLION ESALS, 9.5 MM MIX, 2" DEPTH, SRL-H
- SUPERPAVE ASPHALT MIXTURE DESIGN, BINDER COURSE, PG 64E-22, 10 TO <30 MILLION ESALS, 19.0 MM MIX, 2" DEPTH
- SUPERPAVE ASPHALT MIXTURE DESIGN, BASE COURSE, PG 64S-22, <0.3 MILLION ESALS, 25.0 MM MIX, 4" DEPTH
- SUPERPAVE ASPHALT MIXTURE DESIGN, BINDER COURSE (LEVELING), PG 64E-22, 10 TO <30 MILLION ESALS, 19.0 MM MIX
- F PLAIN CEMENT CONCRETE PAVEMENT, 4" DEPTH
- REINFORCED CEMENT CONCRETE BASE COURSE, 10" DEPTH
- 4" PAVEMENT BASE DRAIN
- SUBBASE (NO. 2A) (MATCH ADJACENT SUBBASE DEPTH) OVER GEOTEXTILE CLASS 4, TYPE A
- J SUBBASE 4" DEPTH (NO. 2A)
- (K) SUBBASE 6" DEPTH (NO. 2A)
- SUBBASE 8" DEPTH (NO. 2A)
  OVER GEOTEXTILE CLASS 4. TYPE A
- M PLAIN CONCRETE MOUNTABLE CURB,
- (N) CONCRETE BUFFER
- O REINFORCED CEMENT CONCRETE CURB
- (P) GRANITE CURB

- REINFORCED CEMENT CONCRETE SIDEWALK, 4" DEPTH
- MILLING OF CEMENT CONCRETE PAVEMENT SURFACE, 2" DEPTH
- MILLING OF ASPHALT PAVEMENT SURFACE, VARIABLE DEPTH (MILL TO SANDSTONE BLOCK LAYER)
- MILLING OF ASPHALT PAVEMENT SURFACE, 1 1/2 " DEPTH
- MILLING OF ASPHALT PAVEMENT SURFACE, 2" DEPTH

MILLING OF ASPHALT PAVEMENT SURFACE, 3 1/2 " DEPTH

- (W) REINFORCED CEMENT CONCRETE CURB, 36"
- X CURB CHEEK WALL
- REMOVE AND RESET INTERLOCKING PAVERS
- Z EXPOSED AGGREGATE CONCRETE SIDEWALK, BROWN
- PWSA SIDEWALK TRENCH DRAIN WITH ADA COMPLIANT AND BICYCLE SAFE GRATE
- ↑↑ DIRECTIONAL ARROWS

NOTE: ASPHALT TACK COAT IS REQUIRED BETWEEN ALL ASPHALT PAVING COURSES AND ON MILLED SURFACES PRIOR TO PLACING OVERLAY

707 Grant Street 5th Floor Pittsburgh, PA 15219

THE PREPARATION OF THIS DOCUMENT HAS BEEN FINANCED IN PART THROUGH A GRANT FROM THE FEDERAL TRANSIT ADMINISTRATION U.S. DEPARTMENT OF TRANSPORTATION, UNDER THE URBAN MASS TRANSPORTATION ACT OF 1964, AS AMENDED, FOR THE PORT AUTHORITY OF ALLEGHENY COUNTY, PENNSYLVANIA. NO. DATE DESCRIPTION REVISIONS

(NOT FOR CONSTRUCTION)


DESIGNED	<u>SDS</u>	
DRAWN	<u>SDS</u>	
CHECKED	BFS	
IN CHARGE	LAR	
DATE	05/01/24	
SCALE		
	AS SHOWN	


# PORT AUTHORITY OF ALLEGHENY COUNTY


BUS RAPID TRANSIT UPTOWN TO OAKLAND TYPICAL SECTIONS FIFTH AVE LYTTON AVE TO BELLEFIELD AVE

**Port Authority** 

CONTRACT NO. BRT-001 CV17 DWG NO sнт. 92

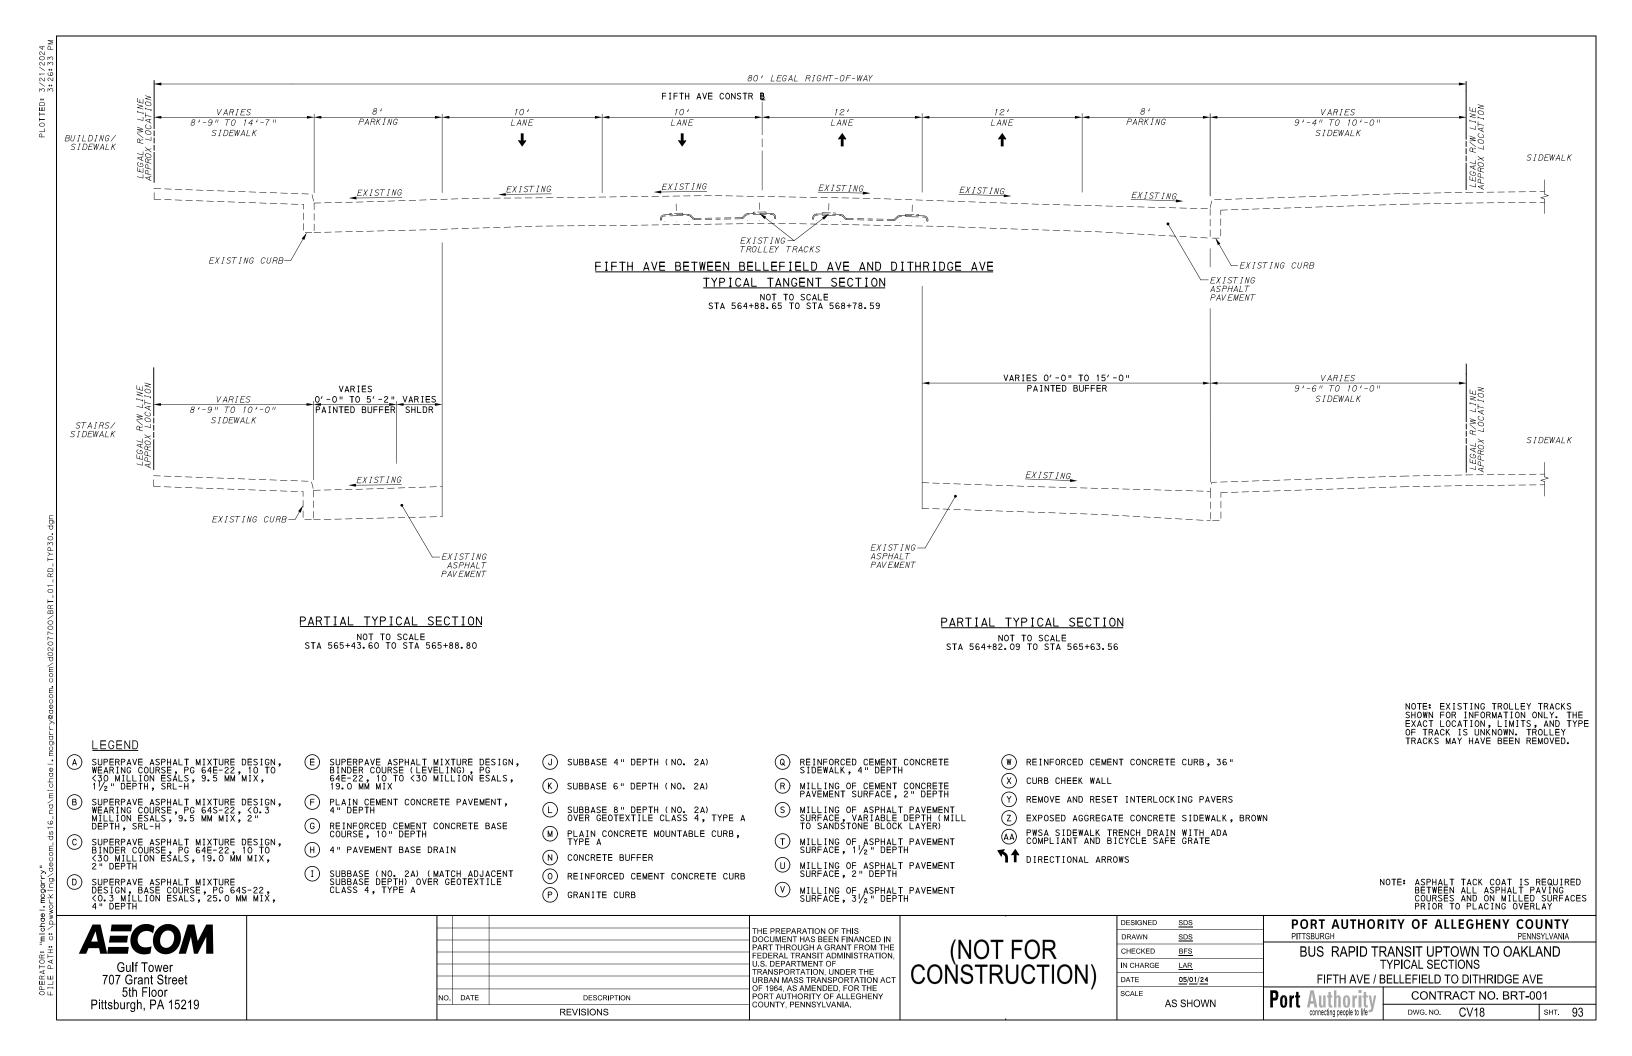

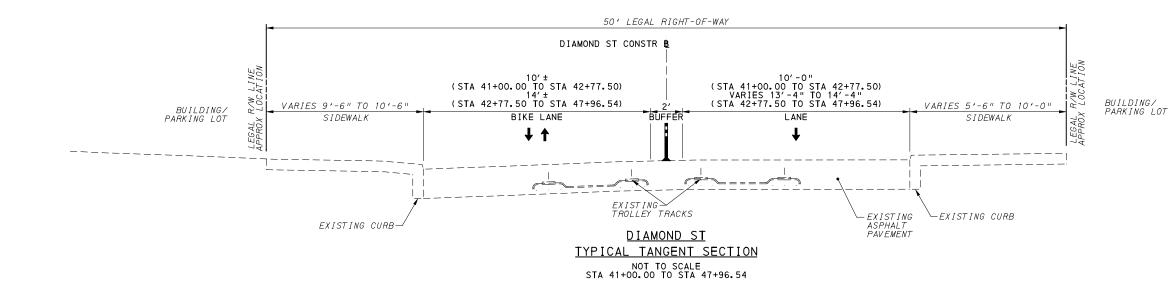

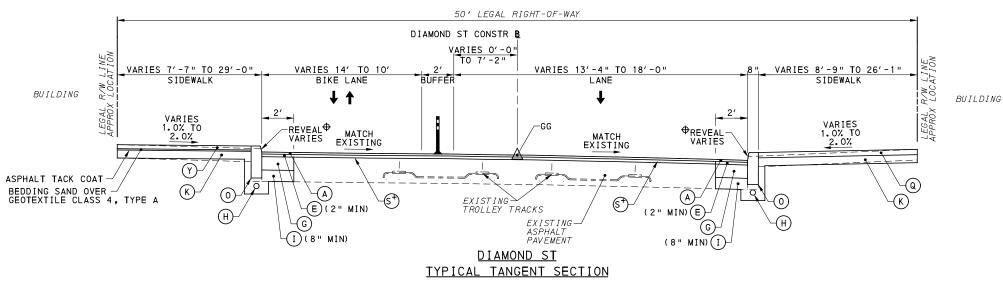

+ DEPTH OF MILLING BASED ON PROPOSED PAVEMENT DEPTHS

NOT DEPTH TO SANDSTONE BLOCK LAYER. SANDSTONE BLOCK MAY NOT BE PRESENT IN THIS LOCATION.

◆ SEE INTERSECTION DETAIL SHEETS

NOTE: EXISTING TROLLEY TRACKS SHOWN FOR INFORMATION ONLY. THE EXACT LOCATION, LIMITS, AND TYPE OF TRACK IS UNKNOWN. TROLLEY TRACKS MAY HAVE BEEN REMOVED.

### **LEGEND**

- SUPERPAVE ASPHALT MIXTURE DESIGN, WEARING COURSE, PG 64E-22, 10 TO <30 MILLION ESALS, 9.5 MM MIX, 11/2" DEPTH, SRL-H
- SUPERPAVE ASPHALT MIXTURE DESIGN, WEARING COURSE, PG 64S-22, <0.3, MILLION ESALS, 9.5 MM MIX, 2" DEPTH, SRL-H
- SUPERPAVE ASPHALT MIXTURE DESIGN, BINDER COURSE, PG 64E-22, 10 TO <30 MILLION ESALS, 19.0 MM MIX, 2" DEPTH
- SUPERPAVE ASPHALT MIXTURE DESIGN, BASE COURSE, PG 64S-22, <0.3 MILLION ESALS, 25.0 MM MIX, 4" DEPTH
- SUPERPAVE ASPHALT MIXTURE DESIGN, BINDER COURSE (LEVELING), PG 64E-22, 10 TO <30 MILLION ESALS, 19.0 MM MIX
- F PLAIN CEMENT CONCRETE PAVEMENT, 4" DEPTH
- G REINFORCED CEMENT CONCRETE BASE COURSE, 10" DEPTH
- 4" PAVEMENT BASE DRAIN
- SUBBASE (NO. 2A) (MATCH ADJACENT SUBBASE DEPTH) OVER GEOTEXTILE CLASS 4, TYPE A
- J SUBBASE 4" DEPTH (NO. 2A)
- (K) SUBBASE 6" DEPTH (NO. 2A)
- SUBBASE 8" DEPTH (NO. 2A)
  OVER GEOTEXTILE CLASS 4. TYPE A
- M PLAIN CONCRETE MOUNTABLE CURB,
- (N) CONCRETE BUFFER
- O REINFORCED CEMENT CONCRETE CURB
- (P) GRANITE CURB

- REINFORCED CEMENT CONCRETE SIDEWALK, 4" DEPTH
- MILLING OF CEMENT CONCRETE PAVEMENT SURFACE, 2" DEPTH
- MILLING OF ASPHALT PAVEMENT SURFACE, VARIABLE DEPTH (MILL TO SANDSTONE BLOCK LAYER)
- MILLING OF ASPHALT PAVEMENT SURFACE, 1 1/2 " DEPTH
- MILLING OF ASPHALT PAVEMENT SURFACE, 2" DEPTH
- MILLING OF ASPHALT PAVEMENT SURFACE, 3 1/2 " DEPTH

- (W) REINFORCED CEMENT CONCRETE CURB, 36"
- X CURB CHEEK WALL
- REMOVE AND RESET INTERLOCKING PAVERS
- Z) EXPOSED AGGREGATE CONCRETE SIDEWALK, BROWN
- PWSA SIDEWALK TRENCH DRAIN WITH ADA COMPLIANT AND BICYCLE SAFE GRATE
- TT DIRECTIONAL ARROWS

NOTE: ASPHALT TACK COAT IS REQUIRED BETWEEN ALL ASPHALT PAVING COURSES AND ON MILLED SURFACES PRIOR TO PLACING OVERLAY

707 Grant Street 5th Floor Pittsburgh, PA 15219

THE PREPARATION OF THIS DOCUMENT HAS BEEN FINANCED IN PART THROUGH A GRANT FROM THE FEDERAL TRANSIT ADMINISTRATION U.S. DEPARTMENT OF TRANSPORTATION, UNDER THE URBAN MASS TRANSPORTATION ACT OF 1964, AS AMENDED, FOR THE PORT AUTHORITY OF ALLEGHENY COUNTY, PENNSYLVANIA. NO. DATE DESCRIPTION REVISIONS

(NOT FOR CONSTRUCTION)

DESIGNED	SDS	P
DRAWN	SDS	PIT
CHECKED	<u>BFS</u>	l l
IN CHARGE	LAR	
DATE	<u>05/01/24</u>	
SCALE	AS SHOWN	Port

# ORT AUTHORITY OF ALLEGHENY COUNTY


BUS RAPID TRANSIT UPTOWN TO OAKLAND TYPICAL SECTIONS DIAMOND ST


Port Authority

CONTRACT NO. BRT-001

DWG. NO. CV19 sнт. **94** 

NOT TO SCALE STA 47+96.54 TO STA 48+59.17

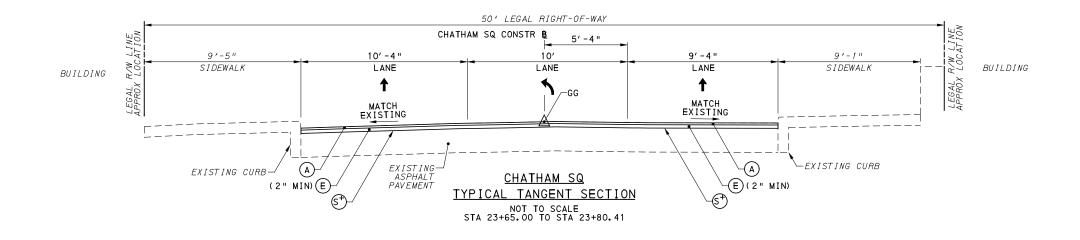

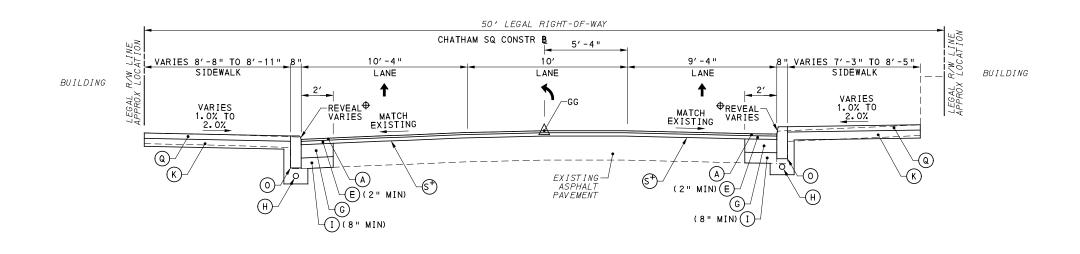

CHATHAM SQ TYPICAL TANGENT SECTION

NOT TO SCALE STA 23+80.41 TO STA 24+09.23

+ DEPTH OF MILLING BASED ON PROPOSED PAVEMENT DEPTHS ROPUSED FAVEMENT DEFINS NOT DEPTH TO SANDSTONE BLOCK LAYER. SANDSTONE BLOCK MAY NOT BE PRESENT IN THIS LOCATION.

◆ SEE INTERSECTION DETAIL SHEETS

### **LEGEND**

- SUPERPAVE ASPHALT MIXTURE DESIGN, WEARING COURSE, PG 64E-22, 10 TO <30 MILLION ESALS, 9.5 MM MIX, 1/2" DEPTH, SRL-H
- SUPERPAVE ASPHALT MIXTURE DESIGN, WEARING COURSE, PG 645-22, <0.3 MILLION ESALS, 9.5 MM MIX, 2" DEPTH, SRL-H
- SUPERPAVE ASPHALT MIXTURE DESIGN, BINDER COURSE, PG 64E-22, 10 TO 430 MILLION ESALS, 19.0 MM MIX, 2" DEPTH
- SUPERPAVE ASPHALT MIXTURE DESIGN, BASE COURSE, PG 64S-22, CO. 3 MILLION ESALS, 25.0 MM MIX, 4" DEPTH
- SUPERPAVE ASPHALT MIXTURE DESIGN, BINDER COURSE (LEVELING), PG 64E-22, 10 TO <30 MILLION ESALS, 19.0 MM MIX
- F PLAIN CEMENT CONCRETE PAVEMENT, 4" DEPTH
- G REINFORCED CEMENT CONCRETE BASE COURSE, 10" DEPTH
- H 4" PAVEMENT BASE DRAIN
- SUBBASE (NO. 2A) (MATCH ADJACENT SUBBASE DEPTH) OVER GEOTEXTILE CLASS 4, TYPE A
- J SUBBASE 4" DEPTH (NO. 2A)
- (K) SUBBASE 6" DEPTH (NO. 2A)
- SUBBASE 8" DEPTH (NO. 2A)
  OVER GEOTEXTILE CLASS 4, TYPE A
- M PLAIN CONCRETE MOUNTABLE CURB,
- (N) CONCRETE BUFFER
- O REINFORCED CEMENT CONCRETE CURB
- P GRANITE CURB

- Q REINFORCED CEMENT CONCRETE SIDEWALK, 4" DEPTH
- MILLING OF CEMENT CONCRETE PAVEMENT SURFACE, 2" DEPTH
- MILLING OF ASPHALT PAVEMENT SURFACE, VARIABLE DEPTH (MILL TO SANDSTONE BLOCK LAYER)
- MILLING OF ASPHALT PAVEMENT SURFACE, 1 1/2 " DEPTH
- MILLING OF ASPHALT PAVEMENT SURFACE, 2" DEPTH
- MILLING OF ASPHALT PAVEMENT SURFACE, 31/2 " DEPTH

- (W) REINFORCED CEMENT CONCRETE CURB, 36"
- X CURB CHEEK WALL
- Y) REMOVE AND RESET INTERLOCKING PAVERS
- Z) EXPOSED AGGREGATE CONCRETE SIDEWALK, BROWN
- PWSA SIDEWALK TRENCH DRAIN WITH ADA COMPLIANT AND BICYCLE SAFE GRATE
- TT DIRECTIONAL ARROWS

NOTE: ASPHALT TACK COAT IS REQUIRED BETWEEN ALL ASPHALT PAVING COURSES AND ON MILLED SURFACES PRIOR TO PLACING OVERLAY

sнт. 95

**Gulf Tower** 707 Grant Street 5th Floor Pittsburgh, PA 15219

THE PREPARATION OF THIS DOCUMENT HAS BEEN FINANCED IN PART THROUGH A GRANT FROM THE FEDERAL TRANSIT ADMINISTRATION U.S. DEPARTMENT OF TRANSPORTATION, UNDER THE URBAN MASS TRANSPORTATION ACT OF 1964, AS AMENDED, FOR THE PORT AUTHORITY OF ALLEGHENY NO. DATE DESCRIPTION COUNTY, PENNSYLVANIA. **REVISIONS** 

(NOT FOR CONSTRUCTION)

ESIGNED	<u>SDS</u>	PORT AUTHOR	ITY OF AL	LEGHENY C	OUNTY
RAWN	SDS	PITTSBURGH		PI	ENNSYLVANIA
HECKED	<u>BFS</u>	BUS RAPID TF	RANSIT UPT	OWN TO OAK	KLAND
N CHARGE	LAR	]	"YPICAL SEC"	TIONS	
ATE	05/01/24		CHATHAM	SQ	
CALE AS SHOWN		Port Authority	CONTR	ACT NO. BRT	-001
	AOOHOWN	connecting people to life	DWG. NO.	CV20	SHT.

FEDERAL TRANSIT ADMINISTRATION U.S. DEPARTMENT OF TRANSPORTATION, UNDER THE URBAN MASS TRANSPORTATION ACT

OF 1964, AS AMENDED, FOR THE PORT AUTHORITY OF ALLEGHENY

COUNTY, PENNSYLVANIA.

BUS RAPID TRANSIT UPTOWN TO OAKLAND

TYPICAL SECTIONS

WASHINGTON PL

DWG NO

Port Authority

CONTRACT NO. BRT-001

sнт. 96

CV21

CHECKED

N CHARGE

DATE

SCALE

CONSTRUCTION

BFS

LAR

05/01/24

AS SHOWN

707 Grant Street


5th Floor


Pittsburgh, PA 15219


NO. DATE

DESCRIPTION

REVISIONS

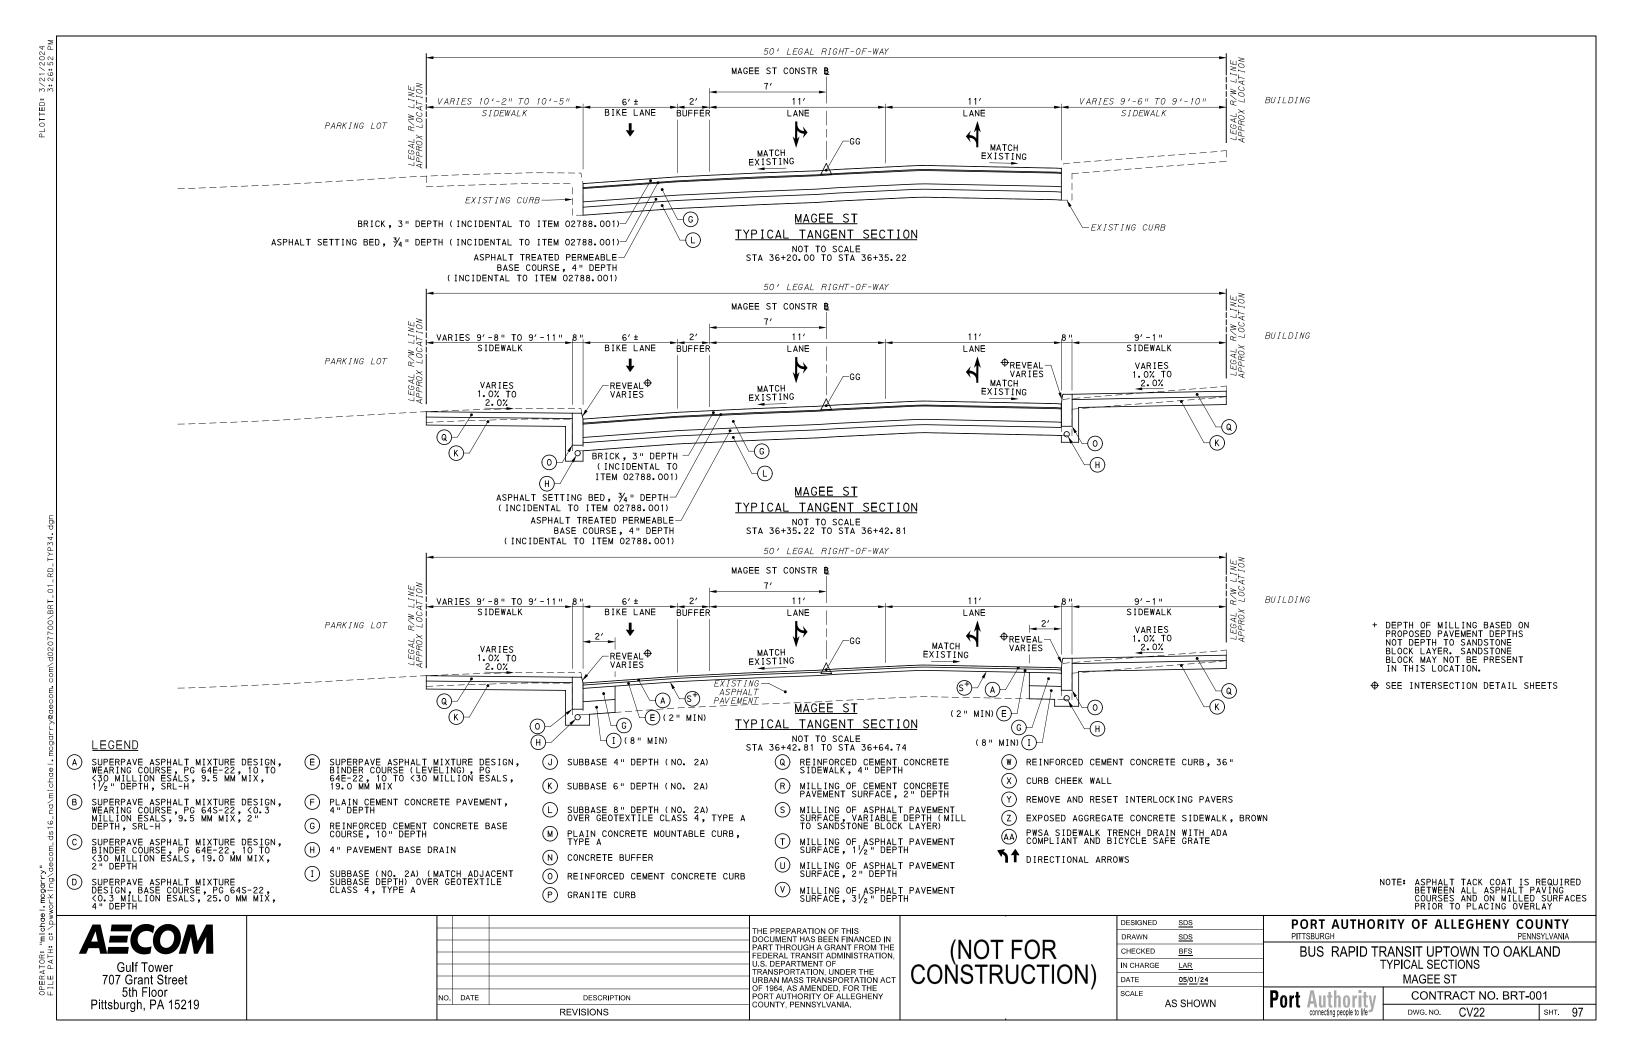

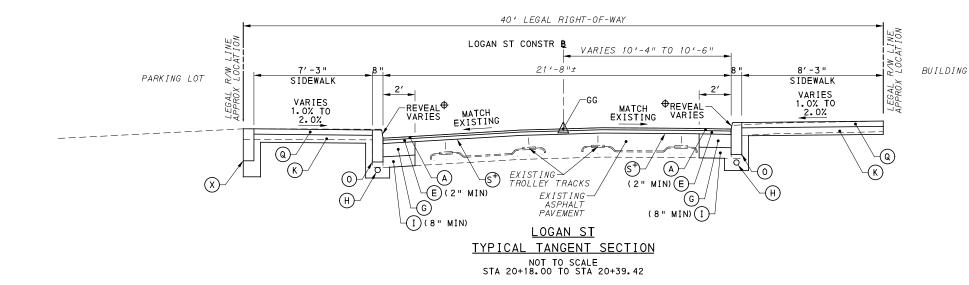

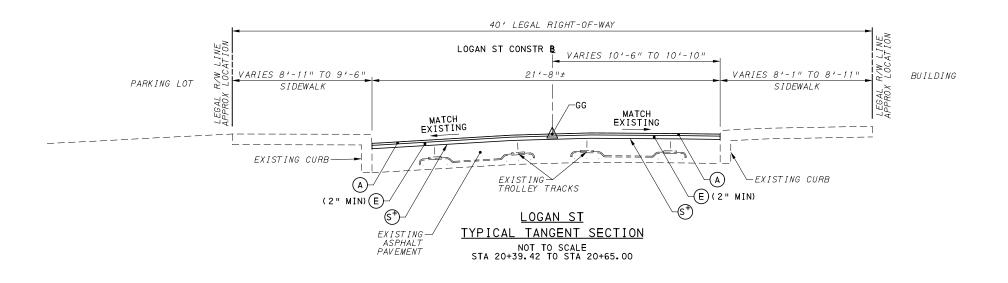

◆ SEE INTERSECTION DETAIL SHEETS

DEPTH OF MILLING BASED ON PROPOSED PAVEMENT DEPTHS

NOT DEPTH TO SANDSTONE BLOCK LAYER. SANDSTONE BLOCK MAY NOT BE PRESENT IN THIS LOCATION.

NOTE: EXISTING TROLLEY TRACKS SHOWN FOR INFORMATION ONLY. THE EXACT LOCATION, LIMITS, AND TYPE OF TRACK IS UNKNOWN. TROLLEY TRACKS MAY HAVE BEEN REMOVED.

- SUPERPAVE ASPHALT MIXTURE DESIGN, WEARING COURSE, PG 64E-22, 10 TO <30 MILLION ESALS, 9.5 MM MIX, 11/2" DEPTH, SRL-H
- SUPERPAVE ASPHALT MIXTURE DESIGN, WEARING COURSE, PG 645-22, <0.3 MILLION ESALS, 9.5 MM MIX, 2" DEPTH, SRL-H
- SUPERPAVE ASPHALT MIXTURE DESIGN, BINDER COURSE, PG 64E-22, 10 TO <30 MILLION ESALS, 19.0 MM MIX, 2" DEPTH
- SUPERPAVE ASPHALT MIXTURE DESIGN, BASE COURSE, PG 64S-22, <0.3 MILLION ESALS, 25.0 MM MIX, 4" DEPTH
- SUPERPAVE ASPHALT MIXTURE DESIGN, BINDER COURSE (LEVELING), PG 64E-22, 10 TO <30 MILLION ESALS, 19.0 MM MIX
- F PLAIN CEMENT CONCRETE PAVEMENT, 4" DEPTH
- G REINFORCED CEMENT CONCRETE BASE COURSE, 10" DEPTH
- 4" PAVEMENT BASE DRAIN
- SUBBASE (NO. 2A) (MATCH ADJACENT SUBBASE DEPTH) OVER GEOTEXTILE CLASS 4, TYPE A
- J SUBBASE 4" DEPTH (NO. 2A)
- (K) SUBBASE 6" DEPTH (NO. 2A)
- SUBBASE 8" DEPTH (NO. 2A)
  OVER GEOTEXTILE CLASS 4, TYPE A
- M PLAIN CONCRETE MOUNTABLE CURB,
- (N) CONCRETE BUFFER
- O REINFORCED CEMENT CONCRETE CURB
- (P) GRANITE CURB

- REINFORCED CEMENT CONCRETE SIDEWALK, 4" DEPTH
- MILLING OF CEMENT CONCRETE PAVEMENT SURFACE, 2" DEPTH
- MILLING OF ASPHALT PAVEMENT SURFACE, VARIABLE DEPTH (MILL TO SANDSTONE BLOCK LAYER)
- MILLING OF ASPHALT PAVEMENT SURFACE, 1 /2 " DEPTH
- MILLING OF ASPHALT PAVEMENT SURFACE, 2" DEPTH
- MILLING OF ASPHALT PAVEMENT SURFACE, 3 1/2 " DEPTH

- W REINFORCED CEMENT CONCRETE CURB, 36"
- X CURB CHEEK WALL
- REMOVE AND RESET INTERLOCKING PAVERS
- Z EXPOSED AGGREGATE CONCRETE SIDEWALK, BROWN

DATE

SCALE

05/01/24

AS SHOWN

- PWSA SIDEWALK TRENCH DRAIN WITH ADA COMPLIANT AND BICYCLE SAFE GRATE
- TT DIRECTIONAL ARROWS

**Gulf Tower** 707 Grant Street 5th Floor Pittsburgh, PA 15219

THE PREPARATION OF THIS DOCUMENT HAS BEEN FINANCED IN PART THROUGH A GRANT FROM THE FEDERAL TRANSIT ADMINISTRATION U.S. DEPARTMENT OF TRANSPORTATION, UNDER THE URBAN MASS TRANSPORTATION ACT OF 1964, AS AMENDED, FOR THE PORT AUTHORITY OF ALLEGHENY DESCRIPTION COUNTY, PENNSYLVANIA. REVISIONS

(NOT FOR CONSTRUCTION

		ASPHALT TACK COAT IS REQUIRED BETWEEN ALL ASPHALT PAVING COURSES AND ON MILLED SURFACES PRIOR TO PLACING OVERLAY
DESIGNED SDS	PORT AUTHORITY (	OF ALLEGHENY COUNTY
DRAWN <u>SDS</u>	PITTSBURGH	PENNSYLVANIA
CHECKED BFS	BUS RAPID TRANSI	T UPTOWN TO OAKLAND
IN CHARGE LAR	TYPICA	AL SECTIONS


LOGAN ST

CONTRACT NO. BRT-001 **Port Authorit** 

CV23 sнт. 98 DWG NO

**LEGEND** 

NO. DATE

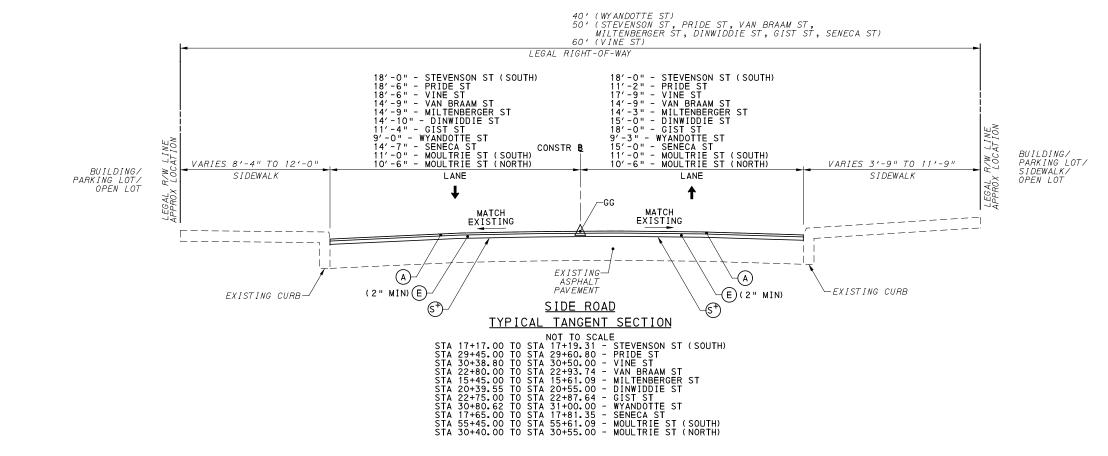

+ DEPTH OF MILLING BASED ON PROPOSED PAVEMENT DEPTHS NOT DEPTH TO SANDSTONE BLOCK LAYER. SANDSTONE BLOCK MAY NOT BE PRESENT IN THIS LOCATION.

◆ SEE INTERSECTION DETAIL SHEETS

### **LEGEND**

- SUPERPAVE ASPHALT MIXTURE DESIGN, WEARING COURSE, PG 64E-22, 10 TO <30 MILLION ESALS, 9.5 MM MIX, 1/2" DEPTH, SRL-H
- SUPERPAVE ASPHALT MIXTURE DESIGN, WEARING COURSE, PG 645-22, <0.3 MILLION ESALS, 9.5 MM MIX, 2" DEPTH, SRL-H
- SUPERPAVE ASPHALT MIXTURE DESIGN, BINDER COURSE, PG 64E-22, 10 TO 430 MILLION ESALS, 19.0 MM MIX, 2" DEPTH
- SUPERPAVE ASPHALT MIXTURE DESIGN, BASE COURSE, PG 64S-22, <0.3 MILLION ESALS, 25.0 MM MIX, 4" DEPTH (D)
- SUPERPAVE ASPHALT MIXTURE DESIGN, BINDER COURSE (LEVELING), PG 64E-22, 10 TO <30 MILLION ESALS, 19.0 MM MIX
- F PLAIN CEMENT CONCRETE PAVEMENT, 4" DEPTH

- J SUBBASE 4" DEPTH (NO. 2A)
- (K) SUBBASE 6" DEPTH (NO. 2A)
- SUBBASE 8" DEPTH (NO. 2A)
  OVER GEOTEXTILE CLASS 4, TYPE A
- M PLAIN CONCRETE MOUNTABLE CURB,
- (N) CONCRETE BUFFER
- O REINFORCED CEMENT CONCRETE CURB
- P GRANITE CURB

- MILLING OF ASPHALT PAVEMENT SURFACE, 2" DEPTH
- WILLING OF ASPHALT PAVEMENT SURFACE, 3 1/2 " DEPTH

- (W) REINFORCED CEMENT CONCRETE CURB, 36"
- X CURB CHEEK WALL
- Y) REMOVE AND RESET INTERLOCKING PAVERS
- Z) EXPOSED AGGREGATE CONCRETE SIDEWALK, BROWN
- AA PWSA SIDEWALK TRENCH DRAIN WITH ADA COMPLIANT AND BICYCLE SAFE GRATE
- TT DIRECTIONAL ARROWS

ASPHALT TACK COAT IS REQUIRED BETWEEN ALL ASPHALT PAVING COURSES AND ON MILLED SURFACES PRIOR TO PLACING OVERLAY

sнт. 99

# AECOM

**Gulf Tower** 707 Grant Street 5th Floor Pittsburgh, PA 15219

THE PREPARATION OF THIS OF 1964, AS AMENDED, FOR THE PORT AUTHORITY OF ALLEGHENY NO. DATE DESCRIPTION COUNTY, PENNSYLVANIA. REVISIONS

(NOT FOR CONSTRUCTION)

DESIGNED	<u>SDS</u>	PORT	AUTHOR	ITY OF A	LLEGHENY	COL	JNTY
DRAWN	SDS	PITTSBURGH	1			PENNS	SYLVANIA
CHECKED	<u>BFS</u>	BUS I	RAPID TF	RANSIT UP	TOWN TO O	AKL/	AND
IN CHARGE	LAR		Ţ	YPICAL SEC	CTIONS		
DATE	05/01/24			SIDE RO	AD		
SCALE	AS SHOWN	Port Aut	hority	CONT	RACT NO. B	RT-00	)1
	AS SHOWN		g people to life	DWG. NO.	CV24		SHT.

DOCUMENT HAS BEEN FINANCED IN PART THROUGH A GRANT FROM THE FEDERAL TRANSIT ADMINISTRATION U.S. DEPARTMENT OF TRANSPORTATION, UNDER THE URBAN MASS TRANSPORTATION ACT

G REINFORCED CEMENT CONCRETE BASE COURSE, 10" DEPTH

H 4" PAVEMENT BASE DRAIN


SUBBASE (NO. 2A) (MATCH ADJACENT SUBBASE DEPTH) OVER GEOTEXTILE CLASS 4, TYPE A

Q REINFORCED CEMENT CONCRETE SIDEWALK, 4" DEPTH

MILLING OF CEMENT CONCRETE PAVEMENT SURFACE, 2" DEPTH

MILLING OF ASPHALT PAVEMENT SURFACE, VARIABLE DEPTH (MILL TO SANDSTONE BLOCK LAYER)

MILLING OF ASPHALT PAVEMENT SURFACE, 1 1/2 " DEPTH

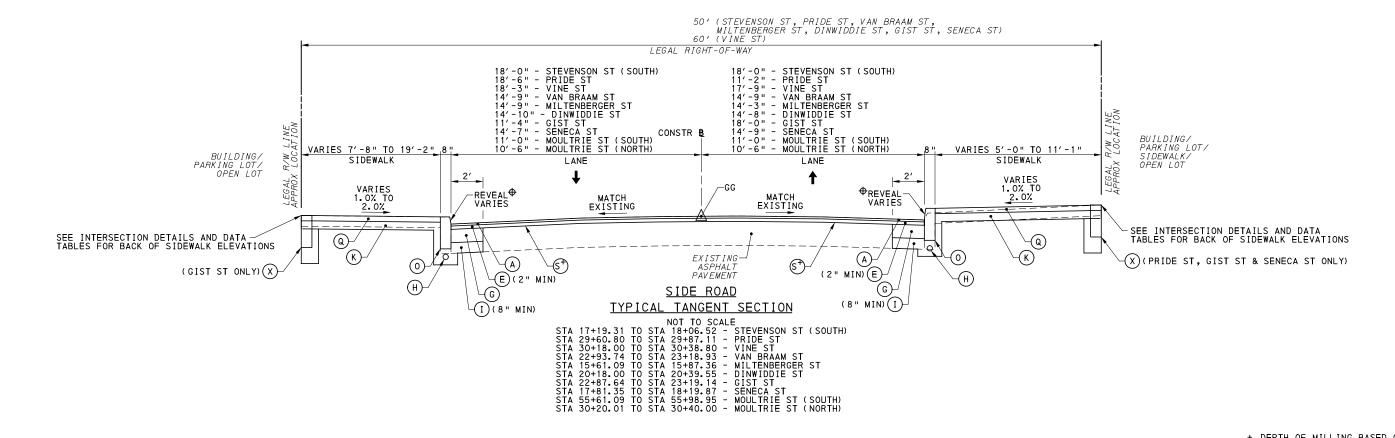

+ DEPTH OF MILLING BASED ON PROPOSED PAVEMENT DEPTHS NOT DEPTH TO SANDSTONE BLOCK LAYER. SANDSTONE BLOCK MAY NOT BE PRESENT IN THIS LOCATION.

◆ SEE INTERSECTION DETAIL SHEETS

### **LEGEND**

- SUPERPAVE ASPHALT MIXTURE DESIGN, WEARING COURSE, PG 64E-22, 10 TO <30 MILLION ESALS, 9.5 MM MIX, 1/2" DEPTH, SRL-H
- SUPERPAVE ASPHALT MIXTURE DESIGN, WEARING COURSE, PG 645-22, <0.3 MILLION ESALS, 9.5 MM MIX, 2" DEPTH, SRL-H
- SUPERPAVE ASPHALT MIXTURE DESIGN, BINDER COURSE, PG 64E-22, 10 TO 430 MILLION ESALS, 19.0 MM MIX, 2" DEPTH
- SUPERPAVE ASPHALT MIXTURE DESIGN, BASE COURSE, PG 64S-22, <0.3 MILLION ESALS, 25.0 MM MIX, 4" DEPTH
- SUPERPAVE ASPHALT MIXTURE DESIGN, BINDER COURSE (LEVELING), PG 64E-22, 10 TO <30 MILLION ESALS, 19.0 MM MIX
- F PLAIN CEMENT CONCRETE PAVEMENT, 4" DEPTH
- G REINFORCED CEMENT CONCRETE BASE COURSE, 10" DEPTH
- H 4" PAVEMENT BASE DRAIN
- SUBBASE (NO. 2A) (MATCH ADJACENT SUBBASE DEPTH) OVER GEOTEXTILE CLASS 4, TYPE A
- J SUBBASE 4" DEPTH (NO. 2A)
- (K) SUBBASE 6" DEPTH (NO. 2A)
- SUBBASE 8" DEPTH (NO. 2A)
  OVER GEOTEXTILE CLASS 4, TYPE A
- M PLAIN CONCRETE MOUNTABLE CURB,
- (N) CONCRETE BUFFER
- O REINFORCED CEMENT CONCRETE CURB
- P GRANITE CURB

- Q REINFORCED CEMENT CONCRETE SIDEWALK, 4" DEPTH
- MILLING OF CEMENT CONCRETE PAVEMENT SURFACE, 2" DEPTH
- MILLING OF ASPHALT PAVEMENT SURFACE, VARIABLE DEPTH (MILL TO SANDSTONE BLOCK LAYER)
- MILLING OF ASPHALT PAVEMENT SURFACE, 1 1/2 " DEPTH
- MILLING OF ASPHALT PAVEMENT SURFACE, 2" DEPTH WILLING OF ASPHALT PAVEMENT SURFACE, 3 1/2 " DEPTH
- (W) REINFORCED CEMENT CONCRETE CURB, 36"
- X CURB CHEEK WALL
- Y) REMOVE AND RESET INTERLOCKING PAVERS
- Z) EXPOSED AGGREGATE CONCRETE SIDEWALK, BROWN
- AA PWSA SIDEWALK TRENCH DRAIN WITH ADA COMPLIANT AND BICYCLE SAFE GRATE
- TT DIRECTIONAL ARROWS

ASPHALT TACK COAT IS REQUIRED BETWEEN ALL ASPHALT PAYING COURSES AND ON MILLED SURFACES PRIOR TO PLACING OVERLAY

AECOM


**Gulf Tower** 707 Grant Street 5th Floor Pittsburgh, PA 15219


THE PREPARATION OF THIS DOCUMENT HAS BEEN FINANCED IN PART THROUGH A GRANT FROM THE FEDERAL TRANSIT ADMINISTRATION U.S. DEPARTMENT OF TRANSPORTATION, UNDER THE URBAN MASS TRANSPORTATION ACT OF 1964, AS AMENDED, FOR THE PORT AUTHORITY OF ALLEGHENY NO. DATE DESCRIPTION COUNTY, PENNSYLVANIA. REVISIONS

(NOT FOR CONSTRUCTION)

			11(10)(	TO TEACTIVE OVER	-71	
DESIGNED	SDS	PORT AUTHORITY OF ALLEGHENY COUNTY				<del>/</del>
DRAWN	SDS	PITTSBURGH		PENN	SYLVAN	Α
CHECKED	BFS	BUS RAPID TRANSIT UPTOWN TO OAKLAND				
IN CHARGE	LAR	TYPICAL SECTIONS				
DATE	<u>05/01/24</u>	SIDE ROAD				
SCALE A	AS SHOWN Port Authority CONTRACT NO. BRT-001		01			
^	IO OI IOVVIV	connecting people to life	DWG. NO.	CV25	SHT.	100

(D)

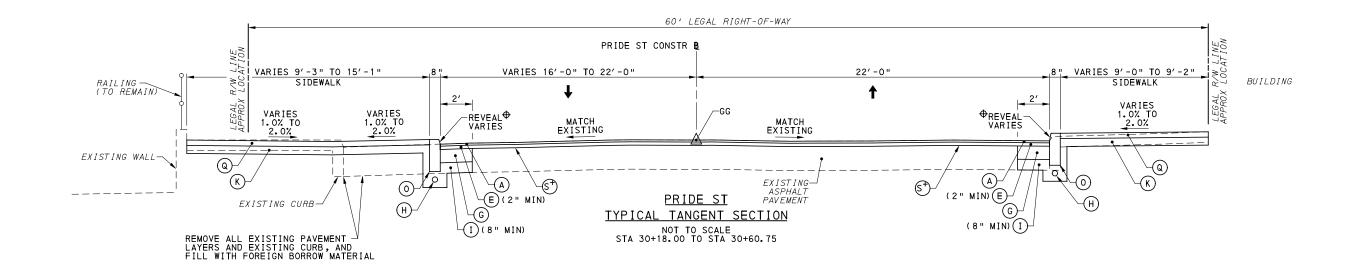

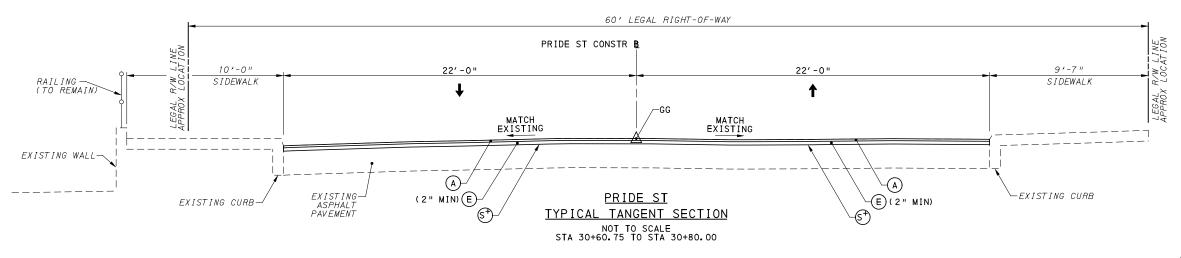

DEPTH OF MILLING BASED ON PROPOSED PAVEMENT DEPTHS NOT DEPTH TO SANDSTONE BLOCK LAYER. SANDSTONE BLOCK MAY NOT BE PRESENT IN THIS LOCATION.

BUILDING

◆ SEE INTERSECTION DETAIL SHEETS

### **LEGEND**

- SUPERPAVE ASPHALT MIXTURE DESIGN, WEARING COURSE, PG 64E-22, 10 TO <30 MILLION ESALS, 9.5 MM MIX, 1/2" DEPTH, SRL-H
- SUPERPAVE ASPHALT MIXTURE DESIGN, WEARING COURSE, PG 645-22, <0.3 MILLION ESALS, 9.5 MM MIX, 2" DEPTH, SRL-H
- SUPERPAVE ASPHALT MIXTURE DESIGN, BINDER COURSE, PG 64E-22, 10 TO <30 MILLION ESALS, 19.0 MM MIX, 2" DEPTH
- SUPERPAVE ASPHALT MIXTURE DESIGN, BASE COURSE, PG 64S-22, CO. 3 MILLION ESALS, 25.0 MM MIX, 4" DEPTH
- SUPERPAVE ASPHALT MIXTURE DESIGN, BINDER COURSE (LEVELING), PG 64E-22, 10 TO <30 MILLION ESALS, 19.0 MM MIX
- F PLAIN CEMENT CONCRETE PAVEMENT, 4" DEPTH
- G REINFORCED CEMENT CONCRETE BASE COURSE, 10" DEPTH
- 4" PAVEMENT BASE DRAIN
- SUBBASE (NO. 2A) (MATCH ADJACENT SUBBASE DEPTH) OVER GEOTEXTILE CLASS 4, TYPE A
- J SUBBASE 4" DEPTH (NO. 2A)
- (K) SUBBASE 6" DEPTH (NO. 2A)
- SUBBASE 8" DEPTH (NO. 2A)
  OVER GEOTEXTILE CLASS 4, TYPE A
- M PLAIN CONCRETE MOUNTABLE CURB,
- (N) CONCRETE BUFFER
- O REINFORCED CEMENT CONCRETE CURB
- (P) GRANITE CURB

- REINFORCED CEMENT CONCRETE SIDEWALK, 4" DEPTH
- MILLING OF CEMENT CONCRETE PAVEMENT SURFACE, 2" DEPTH
- MILLING OF ASPHALT PAVEMENT SURFACE, VARIABLE DEPTH (MILL TO SANDSTONE BLOCK LAYER)
- MILLING OF ASPHALT PAVEMENT SURFACE, 1 1/2 " DEPTH
- MILLING OF ASPHALT PAVEMENT SURFACE, 2" DEPTH
- MILLING OF ASPHALT PAVEMENT SURFACE, 3 1/2 " DEPTH

- (W) REINFORCED CEMENT CONCRETE CURB, 36"
- X CURB CHEEK WALL
- REMOVE AND RESET INTERLOCKING PAVERS
- Z) EXPOSED AGGREGATE CONCRETE SIDEWALK, BROWN
- PWSA SIDEWALK TRENCH DRAIN WITH ADA COMPLIANT AND BICYCLE SAFE GRATE
- TT DIRECTIONAL ARROWS

NOTE: ASPHALT TACK COAT IS REQUIRED BETWEEN ALL ASPHALT PAVING COURSES AND ON MILLED SURFACES PRIOR TO PLACING OVERLAY

**Gulf Tower** 707 Grant Street 5th Floor Pittsburgh, PA 15219

THE PREPARATION OF THIS DOCUMENT HAS BEEN FINANCED IN PART THROUGH A GRANT FROM THE FEDERAL TRANSIT ADMINISTRATION U.S. DEPARTMENT OF TRANSPORTATION, UNDER THE URBAN MASS TRANSPORTATION ACT OF 1964, AS AMENDED, FOR THE PORT AUTHORITY OF ALLEGHENY NO. DATE DESCRIPTION COUNTY, PENNSYLVANIA. REVISIONS

(NOT FOR CONSTRUCTION)


DESIGNED	SDS	PORT AUTHO
DRAWN	SDS	PITTSBURGH
CHECKED	<u>BFS</u>	BUS RAPID
IN CHARGE	LAR	
DATE	05/01/24	
SCALE	AS SHOWN	Port Authority


PORT AUTHORITY OF ALLEGHENY COUNTY BUS RAPID TRANSIT UPTOWN TO OAKLAND TYPICAL SECTIONS

PRIDE ST

CONTRACT NO. BRT-001 DWG NO

CV26 sнт. 101

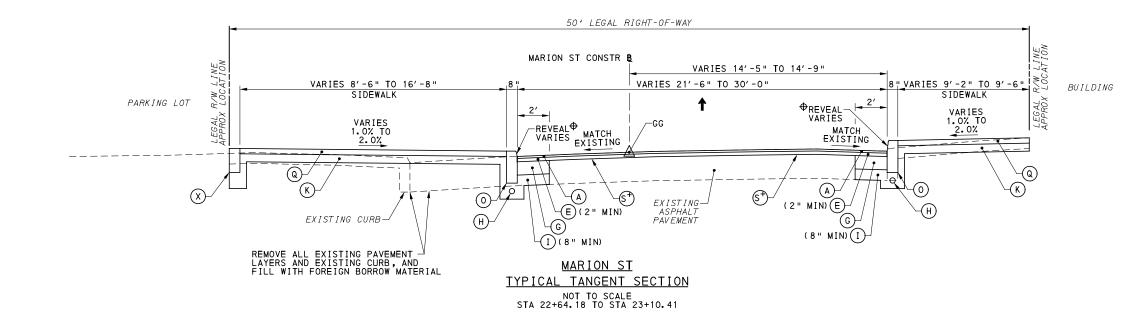

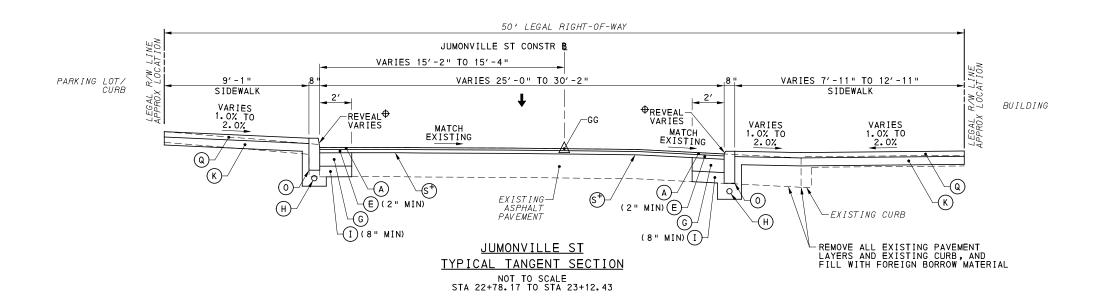

- + DEPTH OF MILLING BASED ON PROPOSED PAVEMENT DEPTHS NOT DEPTH TO SANDSTONE BLOCK LAYER. SANDSTONE BLOCK MAY NOT BE PRESENT IN THIS LOCATION.
- ◆ SEE INTERSECTION DETAIL SHEETS

### **LEGEND**

- SUPERPAVE ASPHALT MIXTURE DESIGN, WEARING COURSE, PG 64E-22, 10 TO <30 MILLION ESALS, 9.5 MM MIX, 1/2" DEPTH, SRL-H
- SUPERPAVE ASPHALT MIXTURE DESIGN, WEARING COURSE, PG 645-22, <0.3 MILLION ESALS, 9.5 MM MIX, 2" DEPTH, SRL-H
- SUPERPAVE ASPHALT MIXTURE DESIGN, BINDER COURSE, PG 64E-22, 10 TO <30 MILLION ESALS, 19.0 MM MIX, 2" DEPTH
- SUPERPAVE ASPHALT MIXTURE DESIGN, BASE COURSE, PG 64S-22, CO. 3 MILLION ESALS, 25.0 MM MIX, 4" DEPTH
- SUPERPAVE ASPHALT MIXTURE DESIGN, BINDER COURSE (LEVELING), PG 64E-22, 10 TO <30 MILLION ESALS, 19.0 MM MIX
- F PLAIN CEMENT CONCRETE PAVEMENT, 4" DEPTH
- G REINFORCED CEMENT CONCRETE BASE COURSE, 10" DEPTH
- H 4" PAVEMENT BASE DRAIN
- SUBBASE (NO. 2A) (MATCH ADJACENT SUBBASE DEPTH) OVER GEOTEXTILE CLASS 4, TYPE A
- J SUBBASE 4" DEPTH (NO. 2A)
- (K) SUBBASE 6" DEPTH (NO. 2A)
- SUBBASE 8" DEPTH (NO. 2A)
  OVER GEOTEXTILE CLASS 4, TYPE A
- M PLAIN CONCRETE MOUNTABLE CURB,
- (N) CONCRETE BUFFER
- O REINFORCED CEMENT CONCRETE CURB
- (P) GRANITE CURB

- Q REINFORCED CEMENT CONCRETE SIDEWALK, 4" DEPTH
- MILLING OF CEMENT CONCRETE PAVEMENT SURFACE, 2" DEPTH
- MILLING OF ASPHALT PAVEMENT SURFACE, VARIABLE DEPTH (MILL TO SANDSTONE BLOCK LAYER)
- MILLING OF ASPHALT PAVEMENT SURFACE, 1 1/2 " DEPTH
- MILLING OF ASPHALT PAVEMENT SURFACE, 2" DEPTH
- MILLING OF ASPHALT PAVEMENT SURFACE, 3 1/2 " DEPTH

- (W) REINFORCED CEMENT CONCRETE CURB, 36"
- X CURB CHEEK WALL
- REMOVE AND RESET INTERLOCKING PAVERS
- Z) EXPOSED AGGREGATE CONCRETE SIDEWALK, BROWN
- AA PWSA SIDEWALK TRENCH DRAIN WITH ADA COMPLIANT AND BICYCLE SAFE GRATE
- TT DIRECTIONAL ARROWS

NOTE: ASPHALT TACK COAT IS REQUIRED BETWEEN ALL ASPHALT PAVING COURSES AND ON MILLED SURFACES PRIOR TO PLACING OVERLAY

**Gulf Tower** 707 Grant Street 5th Floor Pittsburgh, PA 15219

THE PREPARATION OF THIS DOCUMENT HAS BEEN FINANCED IN PART THROUGH A GRANT FROM THE FEDERAL TRANSIT ADMINISTRATION U.S. DEPARTMENT OF TRANSPORTATION, UNDER THE URBAN MASS TRANSPORTATION ACT OF 1964, AS AMENDED, FOR THE PORT AUTHORITY OF ALLEGHENY NO. DATE DESCRIPTION COUNTY, PENNSYLVANIA. **REVISIONS** 

(NOT FOR CONSTRUCTION)

DESIGNED	<u>SDS</u>	
DRAWN	SDS	
CHECKED	BFS	
IN CHARGE	<u>LAR</u>	
DATE	05/01/24	
SCALE		
	AS SHOWN	

# PORT AUTHORITY OF ALLEGHENY COUNTY

BUS RAPID TRANSIT UPTOWN TO OAKLAND TYPICAL SECTIONS

MARION ST AND JUMONVILLE ST

CONTRACT NO. BRT-001 **Port Authority** CV27 sнт. 102 DWG. NO.

◆ SEE INTERSECTION DETAIL SHEETS

\* VARIES 14'-0" TO 15'-4" LANE STA 31+33.87 TO STA 31+55.00, RT

\*\* 0'-0" STA 30+20.03 TO STA 30+60.00 VARIES 0'-0" TO 8'-0" STA 30+60.00 TO STA 30+71.41 VARIES 8'-0" TO 0'-0" STA 31+18.14 TO STA 31+33.14 0'-0" STA 31+33.14 TO STA 31+55.00

WYANDOTTE ST TYPICAL TANGENT SECTION NOT TO SCALE STA 30+09.17 TO STA 30+80.62

LEGAL R/W LINE APPROX LOCATION (DISTANCE FROM PROPOSED —CONSTR & VARIES) 50' LEGAL RIGHT-OF-WAY (ALONG EXISTING ALIGNMENT) SEE INTERSECTION DETAILS, ROADWAY PLANS, AND KIRKPATRICK STREET KIRKPATRICK ST CONSTR B VARIES 6'-0" TO 19'-4" VARIES 6'-0' STORMWATER MANAGEMENT PLAN 8'-0" \*\* 14'-0"\* 14'-0"\* TO 11'-5" FOR PARKING LOT DESIGN SIDEWALK PARK ING LANE SIDEWALK LANE EXISTING -VARIES 11.0% TO 2.0% REVEAL. CROWN POINT VARIES 1.0% TO 4.8% PG-VARIES 1.0% TO REVEAL VARIES 2.0% \_\_T0\_6.0%\_ VARIES 2.0% \_\_T0\_6.0%\_ -2.0% -(Q) -(A) EXISTING CURB Q A(C) (K) (C)-0 <u>(G</u> <u>G</u> FXISTING: KIRKPATRICK ST ASPHALT PAVEMENT (TO BE -(L) (L) TYPICAL TANGENT SECTION REMOVED) NOT TO SCALE STA 30+20.03 TO STA 31+55.00

### **LEGEND**

SUPERPAVE ASPHALT MIXTURE DESIGN, WEARING COURSE, PG 64E-22, 10 TO <30 MILLION ESALS, 9.5 MM MIX, 11/2" DEPTH, SRL-H

SUPERPAVE ASPHALT MIXTURE DESIGN, WEARING COURSE, PG 64S-22, <0.3, MILLION ESALS, 9.5 MM MIX, 2" DEPTH, SRL-H

- SUPERPAVE ASPHALT MIXTURE DESIGN, BINDER COURSE, PG 64E-22, 10 TO <30 MILLION ESALS, 19.0 MM MIX, 2" DEPTH
- SUPERPAVE ASPHALT MIXTURE DESIGN, BASE COURSE, PG 64S-22, <0.3 MILLION ESALS, 25.0 MM MIX, 4" DEPTH
- SUPERPAVE ASPHALT MIXTURE DESIGN, BINDER COURSE (LEVELING), PG 64E-22, 10 TO <30 MILLION ESALS, 19.0 MM MIX
- F PLAIN CEMENT CONCRETE PAVEMENT, 4" DEPTH
- G REINFORCED CEMENT CONCRETE BASE COURSE, 10" DEPTH
- 4" PAVEMENT BASE DRAIN
- SUBBASE (NO. 2A) (MATCH ADJACENT SUBBASE DEPTH) OVER GEOTEXTILE CLASS 4, TYPE A
- J SUBBASE 4" DEPTH (NO. 2A)
- (K) SUBBASE 6" DEPTH (NO. 2A)
- SUBBASE 8" DEPTH (NO. 2A)
  OVER GEOTEXTILE CLASS 4. TYPE A
- M PLAIN CONCRETE MOUNTABLE CURB,
- (N) CONCRETE BUFFER
- O REINFORCED CEMENT CONCRETE CURB
- (P) GRANITE CURB

- Q REINFORCED CEMENT CONCRETE SIDEWALK, 4" DEPTH
- MILLING OF CEMENT CONCRETE PAVEMENT SURFACE, 2" DEPTH
- MILLING OF ASPHALT PAVEMENT SURFACE, VARIABLE DEPTH (MILL TO SANDSTONE BLOCK LAYER)
- MILLING OF ASPHALT PAVEMENT SURFACE, 1 1/2 " DEPTH
- MILLING OF ASPHALT PAVEMENT SURFACE, 2" DEPTH

- (W) REINFORCED CEMENT CONCRETE CURB, 36"
- X CURB CHEEK WALL
- REMOVE AND RESET INTERLOCKING PAVERS
- Z) EXPOSED AGGREGATE CONCRETE SIDEWALK, BROWN
- PWSA SIDEWALK TRENCH DRAIN WITH ADA COMPLIANT AND BICYCLE SAFE GRATE
- TT DIRECTIONAL ARROWS

NOTE: ASPHALT TACK COAT IS REQUIRED BETWEEN ALL ASPHALT PAVING COURSES AND ON MILLED SURFACES PRIOR TO PLACING OVERLAY

+ DEPTH OF MILLING BASED ON PROPOSED PAVEMENT DEPTHS NOT DEPTH TO SANDSTONE BLOCK LAYER. SANDSTONE BLOCK MAY NOT BE PRESENT IN THIS LOCATION.

707 Grant Street 5th Floor Pittsburgh, PA 15219

THE PREPARATION OF THIS DOCUMENT HAS BEEN FINANCED IN PART THROUGH A GRANT FROM THE FEDERAL TRANSIT ADMINISTRATION U.S. DEPARTMENT OF TRANSPORTATION, UNDER THE URBAN MASS TRANSPORTATION ACT OF 1964, AS AMENDED, FOR THE PORT AUTHORITY OF ALLEGHENY NO. DATE DESCRIPTION COUNTY, PENNSYLVANIA. REVISIONS

(NOT FOR CONSTRUCTION)

DESIGNED	SDS	
DRAWN	SDS	
CHECKED	BFS	
IN CHARGE	LAR	
DATE	05/01/24	
SCALE		
	AS SHOWN	


PORT AUTHORITY OF ALLEGHENY COUNTY


BUS RAPID TRANSIT UPTOWN TO OAKLAND TYPICAL SECTIONS WYANDOTTE ST AND KIRKPATRICK ST

**Port Authority** 

CONTRACT NO. BRT-001

CV28 sнт. 103 DWG NO

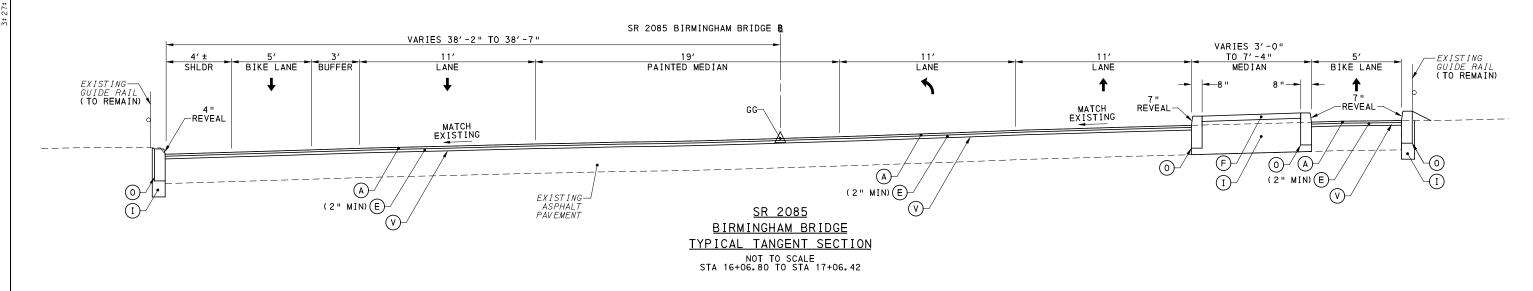

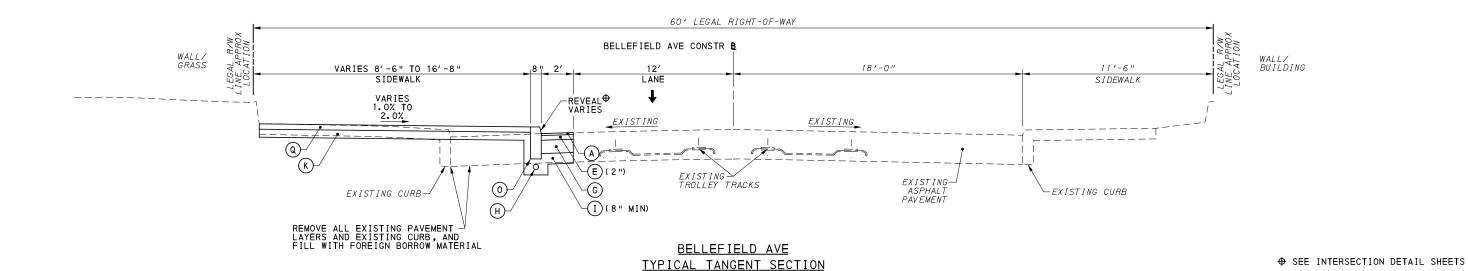

**LEGEND** 

SUPERPAVE ASPHALT MIXTURE DESIGN, WEARING COURSE, PG 64E-22, 10 TO <30 MILLION ESALS, 9.5 MM MIX, 1/2" DEPTH, SRL-H

SUPERPAVE ASPHALT MIXTURE DESIGN, WEARING COURSE, PG 645-22, <0.3 MILLION ESALS, 9.5 MM MIX, 2" DEPTH, SRL-H

- SUPERPAVE ASPHALT MIXTURE DESIGN, BINDER COURSE, PG 64E-22, 10 TO <30 MILLION ESALS, 19.0 MM MIX, 2" DEPTH
- SUPERPAVE ASPHALT MIXTURE DESIGN, BASE COURSE, PG 64S-22, <0.3 MILLION ESALS, 25.0 MM MIX, 4" DEPTH
- SUPERPAVE ASPHALT MIXTURE DESIGN, BINDER COURSE (LEVELING), PG 64E-22, 10 TO <30 MILLION ESALS, 19.0 MM MIX
- F PLAIN CEMENT CONCRETE PAVEMENT, 4" DEPTH
- G REINFORCED CEMENT CONCRETE BASE COURSE, 10" DEPTH
- 4" PAVEMENT BASE DRAIN
- SUBBASE (NO. 2A) (MATCH ADJACENT SUBBASE DEPTH) OVER GEOTEXTILE CLASS 4, TYPE A
- J SUBBASE 4" DEPTH (NO. 2A)
- (K) SUBBASE 6" DEPTH (NO. 2A)
- SUBBASE 8" DEPTH (NO. 2A)
  OVER GEOTEXTILE CLASS 4, TYPE A
- M PLAIN CONCRETE MOUNTABLE CURB,
- (N) CONCRETE BUFFER
- O REINFORCED CEMENT CONCRETE CURB
- (P) GRANITE CURB

- Q REINFORCED CEMENT CONCRETE SIDEWALK, 4" DEPTH
- MILLING OF CEMENT CONCRETE PAVEMENT SURFACE, 2" DEPTH

NOT TO SCALE STA 61+30.20 TO STA 61+89.89

- MILLING OF ASPHALT PAVEMENT SURFACE, VARIABLE DEPTH (MILL TO SANDSTONE BLOCK LAYER)
- MILLING OF ASPHALT PAVEMENT SURFACE, 1 1/2 " DEPTH
- MILLING OF ASPHALT PAVEMENT SURFACE, 2" DEPTH

- (W) REINFORCED CEMENT CONCRETE CURB, 36"
- X CURB CHEEK WALL
- REMOVE AND RESET INTERLOCKING PAVERS
- Z EXPOSED AGGREGATE CONCRETE SIDEWALK, BROWN
- PWSA SIDEWALK TRENCH DRAIN WITH ADA COMPLIANT AND BICYCLE SAFE GRATE
- TT DIRECTIONAL ARROWS

NOTE: ASPHALT TACK COAT IS REQUIRED BETWEEN ALL ASPHALT PAVING COURSES AND ON MILLED SURFACES PRIOR TO PLACING OVERLAY

sнт. 104

707 Grant Street 5th Floor Pittsburgh, PA 15219

THE PREPARATION OF THIS DOCUMENT HAS BEEN FINANCED IN PART THROUGH A GRANT FROM THE FEDERAL TRANSIT ADMINISTRATION, U.S. DEPARTMENT OF TRANSPORTATION, UNDER THE URBAN MASS TRANSPORTATION ACT OF 1964, AS AMENDED, FOR THE PORT AUTHORITY OF ALLEGHENY COUNTY, PENNSYLVANIA. NO. DATE DESCRIPTION REVISIONS


(NOT FOR CONSTRUCTION)

DESIGNED	SDS	
DRAWN	SDS	
CHECKED	BFS	
IN CHARGE	LAR	
DATE	05/01/24	
SCALE		
	AS SHOWN	

PORT AUTHORITY OF ALLEGHENY COUNTY


BUS RAPID TRANSIT UPTOWN TO OAKLAND TYPICAL SECTIONS SR 2085 BIRMINGHAM BRIDGE AND BELLEFIELD AVE

CONTRACT NO. BRT-001 **Port Authorit** DWG. NO. CV29

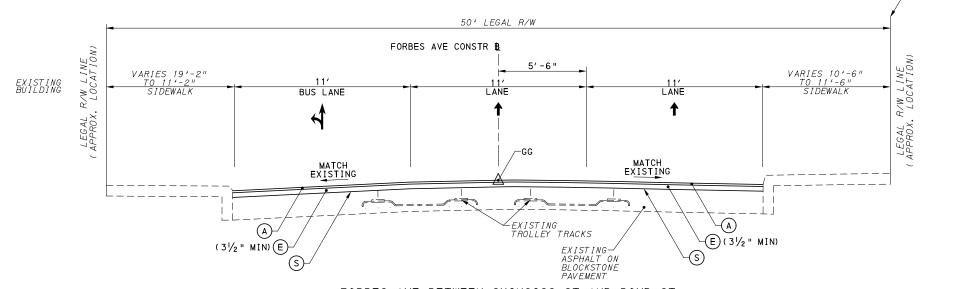

### FORBES AVE BETWEEN SHINGISS ST AND BOYD ST TYPICAL SECTION

NOT TO SCALE STA 121+29.49 TO STA 122+86.46

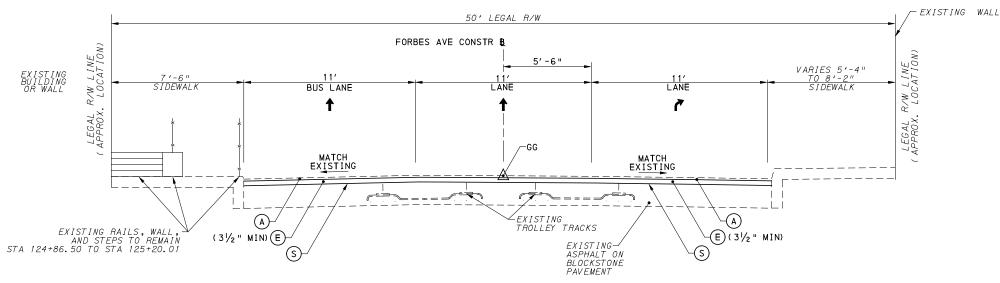

### FORBES AVE BETWEEN BOYD ST AND ARMSTRONG TUNNEL

# TYPICAL SECTION

NOT TO SCALE STA 122+86.46 TO STA 126+25.00

### **LEGEND**

- SUPERPAVE ASPHALT MIXTURE DESIGN, WEARING COURSE, PG 64E-22, 10 TO <30 MILLION ESALS, 9.5 MM MIX, 11/2" DEPTH, SRL-H
- SUPERPAVE ASPHALT MIXTURE DESIGN, WEARING COURSE, PG 64S-22, <0.3, MILLION ESALS, 9.5 MM MIX, 2" DEPTH, SRL-H
- SUPERPAVE ASPHALT MIXTURE DESIGN, BINDER COURSE, PG 64E-22, 10 TO <30 MILLION ESALS, 19.0 MM MIX, 2" DEPTH
- SUPERPAVE ASPHALT MIXTURE DESIGN, BASE COURSE, PG 64S-22, <0.3 MILLION ESALS, 25.0 MM MIX, 4" DEPTH
- SUPERPAVE ASPHALT MIXTURE DESIGN, BINDER COURSE (LEVELING), PG 64E-22, 10 TO <30 MILLION ESALS, 19.0 MM MIX
- F PLAIN CEMENT CONCRETE PAVEMENT, 4" DEPTH
- G REINFORCED CEMENT CONCRETE BASE COURSE, 10" DEPTH
- 4" PAVEMENT BASE DRAIN
- SUBBASE (NO. 2A) (MATCH ADJACENT SUBBASE DEPTH) OVER GEOTEXTILE CLASS 4, TYPE A
- J SUBBASE 4" DEPTH (NO. 2A)
- (K) SUBBASE 6" DEPTH (NO. 2A)
- SUBBASE 8" DEPTH (NO. 2A)
  OVER GEOTEXTILE CLASS 4, TYPE A
- M PLAIN CONCRETE MOUNTABLE CURB,
- (N) CONCRETE BUFFER
- O REINFORCED CEMENT CONCRETE CURB
- (P) GRANITE CURB

- Q REINFORCED CEMENT CONCRETE SIDEWALK, 4" DEPTH
- MILLING OF CEMENT CONCRETE PAVEMENT SURFACE, 2" DEPTH
- MILLING OF ASPHALT PAVEMENT SURFACE, VARIABLE DEPTH (MILL TO SANDSTONE BLOCK LAYER)
- MILLING OF ASPHALT PAVEMENT SURFACE, 1 1/2 " DEPTH
- MILLING OF ASPHALT PAVEMENT SURFACE, 2" DEPTH
- MILLING OF ASPHALT PAVEMENT SURFACE, 31/2 " DEPTH

- (W) REINFORCED CEMENT CONCRETE CURB, 36"
- X CURB CHEEK WALL
- REMOVE AND RESET INTERLOCKING PAVERS
- Z) EXPOSED AGGREGATE CONCRETE SIDEWALK, BROWN
- PWSA SIDEWALK TRENCH DRAIN WITH ADA COMPLIANT AND BICYCLE SAFE GRATE
- TT DIRECTIONAL ARROWS

NOTE: ASPHALT TACK COAT IS REQUIRED BETWEEN ALL ASPHALT PAVING COURSES AND ON MILLED SURFACES PRIOR TO PLACING OVERLAY

NOTE: EXISTING TROLLEY TRACKS SHOWN FOR INFORMATION ONLY. THE EXACT LOCATION, LIMITS, AND TYPE OF TRACK IS UNKNOWN. TROLLEY TRACKS MAY HAVE BEEN REMOVED.

**Gulf Tower** 707 Grant Street 5th Floor Pittsburgh, PA 15219 **ANNETT FLEMING** GANNETT FLEMING, INC. Foster Plaza 8 Suite 400 730 Holiday Drive Pittsburgh, PA. 15220

		THE PREPARATION OF THIS DOCUMENT HAS BEEN FINANCED IN
		PART THROUGH A GRANT FROM THE
		FEDERAL TRANSIT ADMINISTRATION,
		U.S. DEPARTMENT OF TRANSPORTATION, UNDER THE
		URBAN MASS TRANSPORTATION ACT
DATE	DESCRIPTION	OF 1964, AS AMENDED, FOR THE PORT AUTHORITY OF ALLEGHENY COUNTY, PENNSYLVANIA.
	REVISIONS	COUNTY, PENINSTEVANIA.

(NOT FOR CONSTRUCTION)

DESIGNED	RRH	
DRAWN	RRH	
CHECKED	KCF	
IN CHARGE	GEC	
DATE	05/01/24	
SCALE		
	AS SHOWN	

# PORT AUTHORITY OF ALLEGHENY COUNTY

BUS RAPID TRANSIT UPTOWN TO OAKLAND **TYPICAL SECTIONS** FORBES AVE

Port	Authority	
	connecting people to life	Γ

EXISTING WALL

CONTRACT NO. BRT-001 DWG. NO. CV30 sнт. 105 LANE

NOTE: EXISTING TROLLEY TRACKS SHOWN FOR INFORMATION ONLY. THE EXACT LOCATION, LIMITS, AND TYPE OF TRACK IS UNKNOWN, TROLLEY TRACKS MAY HAVE BEEN REMOVED.

-EXISTING ISLAND

### **LEGEND**

R/W LINE LOCATION

-EGAL PPROX

SUPERPAVE ASPHALT MIXTURE DESIGN, WEARING COURSE, PG 64E-22, 10 TO <30 MILLION ESALS, 9.5 MM MIX, 11/2" DEPTH, SRL-H

SIDEWALK

1.0%

(K)

. @

0 0

- SUPERPAVE ASPHALT MIXTURE DESIGN, WEARING COURSE, PG 645-22, <0.3 MILLION ESALS, 9.5 MM MIX, 2" DEPTH, SRL-H
- SUPERPAVE ASPHALT MIXTURE DESIGN, BINDER COURSE, PG 64E-22, 10 TO <30 MILLION ESALS, 19.0 MM MIX, 2" DEPTH
- SUPERPAVE ASPHALT MIXTURE DESIGN, BASE COURSE, PG 64S-22, <0.3 MILLION ESALS, 25.0 MM MIX, 4" DEPTH
- SUPERPAVE ASPHALT MIXTURE DESIGN, BINDER COURSE (LEVELING), PG 64E-22, 10 TO <30 MILLION ESALS, 19.0 MM MIX

VARIES 7'-6"

TO 7'-10' SIDEWALK

- $\stackrel{\hbox{\scriptsize F}}{\mbox{\scriptsize F}}$  PLAIN CEMENT CONCRETE PAVEMENT, 4" DEPTH
- G REINFORCED CEMENT CONCRETE BASE COURSE, 10" DEPTH
- 4" PAVEMENT BASE DRAIN
- SUBBASE (NO. 2A) (MATCH ADJACENT SUBBASE DEPTH) OVER GEOTEXTILE CLASS 4, TYPE A
- J SUBBASE 4" DEPTH (NO. 2A)
- (K) SUBBASE 6" DEPTH (NO. 2A)
- SUBBASE 8" DEPTH (NO. 2A)
  OVER GEOTEXTILE CLASS 4. TYPE A
- M PLAIN CONCRETE MOUNTABLE CURB,
- (N) CONCRETE BUFFER
- O REINFORCED CEMENT CONCRETE CURB
- (P) GRANITE CURB

REINFORCED CEMENT CONCRETE SIDEWALK, 4" DEPTH

50' LEGAL R/W

LANE

5'-6"

11' BUS LANE

FORBES AVE CONSTR B

- MILLING OF CEMENT CONCRETE PAVEMENT SURFACE, 2" DEPTH
- MILLING OF ASPHALT PAVEMENT SURFACE, VARIABLE DEPTH (MILL TO SANDSTONE BLOCK LAYER)
- MILLING OF ASPHALT PAVEMENT SURFACE, 1 1/2 " DEPTH
- - MILLING OF ASPHALT PAVEMENT SURFACE, 3 1/2 " DEPTH

# W REINFORCED CEMENT CONCRETE CURB, 36"

- X CURB CHEEK WALL
- REMOVE AND RESET INTERLOCKING PAVERS
- EXPOSED AGGREGATE CONCRETE SIDEWALK, BROWN

VARIES 7'-6"

TO 7'-8'

SIDEWALK

- EXISTING GROUND

ISLAND

PROPOSED ADA RAMPS, CURB, AND SIDEWALK TO BE CONSTRUCTED BY ARMSTRONG TUNNEL

CONTRACTOR

- PWSA SIDEWALK TRENCH DRAIN WITH ADA COMPLIANT AND BICYCLE SAFE GRATE
- TT DIRECTIONAL ARROWS

NOTE: ASPHALT TACK COAT IS REQUIRED BETWEEN ALL ASPHALT PAVING COURSES AND ON MILLED SURFACES PRIOR TO PLACING OVERLAY

**Gulf Tower** 707 Grant Street 5th Floor Pittsburgh, PA 15219 **ANNETT FLEMING** GANNETT FLEMING, INC. Foster Plaza 8 Suite 400 730 Holiday Drive Pittsburgh, PA. 15220

THE PREPARATION OF THIS DOCUMENT HAS BEEN FINANCED IN PART THROUGH A GRANT FROM THE FEDERAL TRANSIT ADMINISTRATION U.S. DEPARTMENT OF TRANSPORTATION, UNDER THE URBAN MASS TRANSPORTATION ACT OF 1964 AS AMENDED FOR THE NO. DATE DESCRIPTION COUNTY, PENNSYLVANIA. **REVISIONS** 


(NOT FOR CONSTRUCTION)

DESIGNED	RRH	
DRAWN	RRH	
CHECKED	KCF	
IN CHARGE	<u>GEC</u>	
DATE	05/01/24	
SCALE		
	AS SHOWN	

PORT AUTHORITY OF ALLEGHENY COUNTY BUS RAPID TRANSIT UPTOWN TO OAKLAND

**TYPICAL SECTIONS** FORBES AVE **Port Authority** 


CONTRACT NO. BRT-001 CV31 sнт. 106 DWG. NO.

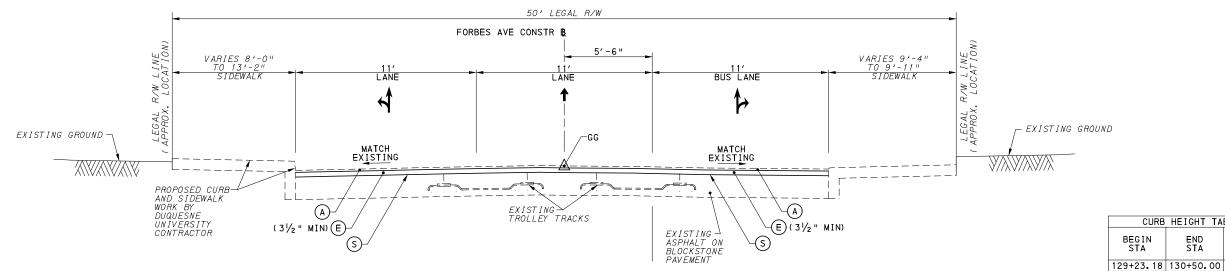

FORBES AVE BETWEEN CHATHAM SQ/McANULTY DR AND MAGEE ST

TYPICAL SECTION

NOT TO SCALE STA 129+23.18 TO STA 136+70.38

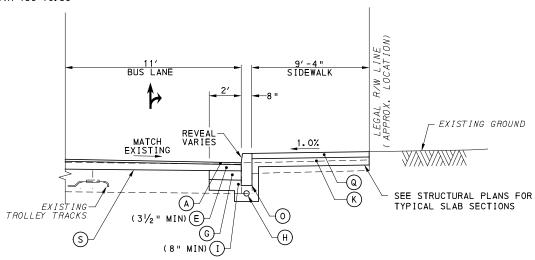

## FORBES AVE BETWEEN CHATHAM SQ/McANULTY DR AND MAGEE ST

## PARTIAL TYPICAL TANGENT SECTION

NOTE: EXISTING TROLLEY TRACKS SHOWN FOR INFORMATION ONLY. THE EXACT LOCATION, LIMITS, AND TYPE OF TRACK IS UNKNOWN. TROLLEY TRACKS MAY HAVE BEEN REMOVED.

CURB HEIGHT TABLE - RT

131+25.57 133+63.48

BEGIN END REVEAL (IN) (IN)

4

4

# **LEGEND**

- SUPERPAVE ASPHALT MIXTURE DESIGN, WEARING COURSE, PG 64E-22, 10 TO <30 MILLION ESALS, 9.5 MM MIX, 11/2" DEPTH, SRL-H
- SUPERPAVE ASPHALT MIXTURE DESIGN, WEARING COURSE, PG 64S-22, <0.3, MILLION ESALS, 9.5 MM MIX, 2" DEPTH, SRL-H
- SUPERPAVE ASPHALT MIXTURE DESIGN, BINDER COURSE, PG 64E-22, 10 TO <30 MILLION ESALS, 19.0 MM MIX, 2" DEPTH
- SUPERPAVE ASPHALT MIXTURE DESIGN, BASE COURSE, PG 64S-22, <0.3 MILLION ESALS, 25.0 MM MIX, 4" DEPTH
- SUPERPAVE ASPHALT MIXTURE DESIGN, BINDER COURSE (LEVELING), PG 64E-22, 10 TO <30 MILLION ESALS, 19.0 MM MIX
- F PLAIN CEMENT CONCRETE PAVEMENT, 4" DEPTH
- G REINFORCED CEMENT CONCRETE BASE COURSE, 10" DEPTH
- 4" PAVEMENT BASE DRAIN
- SUBBASE (NO. 2A) (MATCH ADJACENT SUBBASE DEPTH) OVER GEOTEXTILE CLASS 4, TYPE A
- (K) SUBBASE 6" DEPTH (NO. 2A)
- SUBBASE 8" DEPTH (NO. 2A)
  OVER GEOTEXTILE CLASS 4. TYPE A
- $\stackrel{\textstyle (M)}{\textstyle \mbox{ M}}$  plain concrete mountable curb, TYPE A
- (N) CONCRETE BUFFER
- O REINFORCED CEMENT CONCRETE CURB
- P GRANITE CURB

- REINFORCED CEMENT CONCRETE SIDEWALK, 4" DEPTH
- MILLING OF CEMENT CONCRETE PAVEMENT SURFACE, 2" DEPTH
- MILLING OF ASPHALT PAVEMENT SURFACE, VARIABLE DEPTH (MILL TO SANDSTONE BLOCK LAYER)
- MILLING OF ASPHALT PAVEMENT SURFACE, 1 1/2 " DEPTH
- MILLING OF ASPHALT PAVEMENT SURFACE, 2" DEPTH
- X CURB CHEEK WALL
- REMOVE AND RESET INTERLOCKING PAVERS
- Z) EXPOSED AGGREGATE CONCRETE SIDEWALK, BROWN
- AA PWSA SIDEWALK TRENCH DRAIN WITH ADA
- TT DIRECTIONAL ARROWS

NOTE: ASPHALT TACK COAT IS REQUIRED BETWEEN ALL ASPHALT PAVING COURSES AND ON MILLED SURFACES PRIOR TO PLACING OVERLAY

**Gulf Tower** 707 Grant Street 5th Floor Pittsburgh, PA 15219 (ANNETT FLEMING GANNETT FLEMING, INC. Foster Plaza 8 Suite 400 730 Holiday Drive Pittsburgh, PA. 15220

THE PREPARATION OF THIS DOCUMENT HAS BEEN FINANCED IN PART THROUGH A GRANT FROM THE FEDERAL TRANSIT ADMINISTRATION U.S. DEPARTMENT OF TRANSPORTATION, UNDER THE URBAN MASS TRANSPORTATION ACT OF 1964, AS AMENDED, FOR THE PORT AUTHORITY OF ALLEGHENY COUNTY, PENNSYLVANIA. NO. DATE DESCRIPTION REVISIONS

(NOT FOR CONSTRUCTION)

DESIGNED	RRH	
DRAWN	<u>RRH</u>	
CHECKED	KCF	
IN CHARGE	GEC	
DATE	05/01/24	
SCALE		
	AS SHOWN	

# PORT AUTHORITY OF ALLEGHENY COUNTY


BUS RAPID TRANSIT UPTOWN TO OAKLAND TYPICAL SECTIONS **FORBES AVE** 

**Port Authority** 

CONTRACT NO. BRT-001


DWG.NO. CV32 sнт. 107

NOT TO SCALE STA 129+23.18 TO STA 130+50.00 STA 131+25.57 TO STA 133+63.48 J SUBBASE 4" DEPTH (NO. 2A) (W) REINFORCED CEMENT CONCRETE CURB, 36"

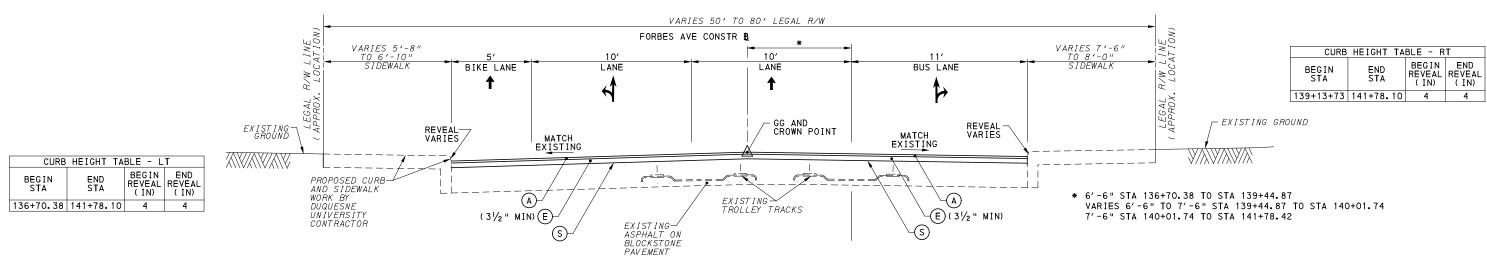

# FORBES AVE BETWEEN MAGEE ST AND STEVENSON ST TYPICAL SECTION

NOT TO SCALE STA 136+70.38 TO STA 141+78.10

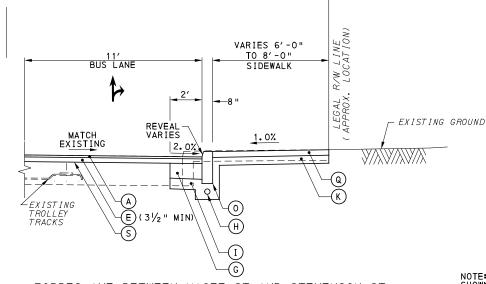

FORBES AVE BETWEEN MAGEE ST AND STEVENSON ST PARTIAL TYPICAL TANGENT SECTION

NOT TO SCALE STA 139+13.72 TO STA 141+78.10

NOTE: EXISTING TROLLEY TRACKS SHOWN FOR INFORMATION ONLY. THE EXACT LOCATION, LIMITS, AND TYPE OF TRACK IS UNKNOWN. TROLLEY TRACKS MAY HAVE BEEN REMOVED.

### **LEGEND**

- SUPERPAVE ASPHALT MIXTURE DESIGN, WEARING COURSE, PG 64E-22, 10 TO <30 MILLION ESALS, 9.5 MM MIX, 11/2" DEPTH, SRL-H
- SUPERPAVE ASPHALT MIXTURE DESIGN, WEARING COURSE, PG 64S-22, <0.3, MILLION ESALS, 9.5 MM MIX, 2" DEPTH, SRL-H
- SUPERPAVE ASPHALT MIXTURE DESIGN, BINDER COURSE, PG 64E-22, 10 TO <30 MILLION ESALS, 19.0 MM MIX, 2" DEPTH
- SUPERPAVE ASPHALT MIXTURE DESIGN, BASE COURSE, PG 64S-22, <0.3 MILLION ESALS, 25.0 MM MIX, 4" DEPTH
- SUPERPAVE ASPHALT MIXTURE DESIGN, BINDER COURSE (LEVELING), PG 64E-22, 10 TO <30 MILLION ESALS, 19.0 MM MIX
- F PLAIN CEMENT CONCRETE PAVEMENT, 4" DEPTH
- G REINFORCED CEMENT CONCRETE BASE COURSE, 10" DEPTH
- 4" PAVEMENT BASE DRAIN
- SUBBASE (NO. 2A) (MATCH ADJACENT SUBBASE DEPTH) OVER GEOTEXTILE CLASS 4, TYPE A
- J SUBBASE 4" DEPTH (NO. 2A)
- (K) SUBBASE 6" DEPTH (NO. 2A)
- SUBBASE 8" DEPTH (NO. 2A)
  OVER GEOTEXTILE CLASS 4. TYPE A
- M PLAIN CONCRETE MOUNTABLE CURB,
- (N) CONCRETE BUFFER
- O REINFORCED CEMENT CONCRETE CURB
- P GRANITE CURB

- REINFORCED CEMENT CONCRETE SIDEWALK, 4" DEPTH
- MILLING OF CEMENT CONCRETE PAVEMENT SURFACE, 2" DEPTH
- MILLING OF ASPHALT PAVEMENT SURFACE, VARIABLE DEPTH (MILL TO SANDSTONE BLOCK LAYER)
- MILLING OF ASPHALT PAVEMENT SURFACE, 1 1/2 " DEPTH
- MILLING OF ASPHALT PAVEMENT SURFACE, 2" DEPTH
- MILLING OF ASPHALT PAVEMENT SURFACE, 31/2" DEPTH

- W REINFORCED CEMENT CONCRETE CURB, 36"
- X CURB CHEEK WALL
- REMOVE AND RESET INTERLOCKING PAVERS
- Z) EXPOSED AGGREGATE CONCRETE SIDEWALK, BROWN
- AA PWSA SIDEWALK TRENCH DRAIN WITH ADA
- TT DIRECTIONAL ARROWS

NOTE: ASPHALT TACK COAT IS REQUIRED BETWEEN ALL ASPHALT PAVING COURSES AND ON MILLED SURFACES PRIOR TO PLACING OVERLAY

**Gulf Tower** 707 Grant Street 5th Floor Pittsburgh, PA 15219 **ANNETT FLEMING** GANNETT FLEMING, INC. Foster Plaza 8 Suite 400 730 Holiday Drive Pittsburgh, PA. 15220

THE PREPARATION OF THIS DOCUMENT HAS BEEN FINANCED IN PART THROUGH A GRANT FROM THE FEDERAL TRANSIT ADMINISTRATION U.S. DEPARTMENT OF TRANSPORTATION, UNDER THE URBAN MASS TRANSPORTATION ACT OF 1964 AS AMENDED FOR THE PORT AUTHORITY OF ALLEGHENY COUNTY, PENNSYLVANIA. NO. DATE DESCRIPTION REVISIONS

(NOT FOR CONSTRUCTION)


DESIGNED	RRH	
DRAWN	RRH	
CHECKED	KCF	
IN CHARGE	<u>GEC</u>	
DATE	05/01/24	
SCALE		
	AS SHOWN	


# PORT AUTHORITY OF ALLEGHENY COUNTY

BUS RAPID TRANSIT UPTOWN TO OAKLAND TYPICAL SECTIONS **FORBES AVE** 

**Port Authority** 

CONTRACT NO. BRT-001 DWG. NO. CV33 sнт. 108

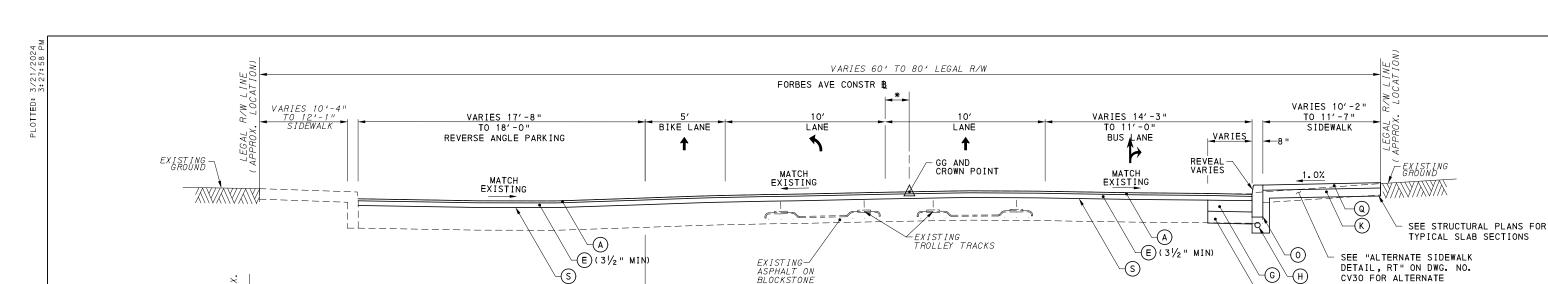

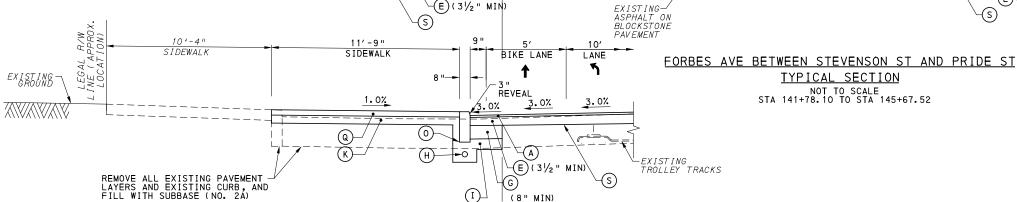

\* VARIES 2.17'LT TO 0.54' LT STA 142+18.27 TO STA 144+38.12 VARIES 0.54'LT TO 1.44' LT STA 144+38.12 TO STA 145+36.00

CV30 FOR ALTERNATE


BUFFER LAYOUT

(8" MIN)

CURB	HEIGHT TA	BLE - R	T
BEGIN STA	END STA	BEGIN REVEAL (IN)	END REVEA ( IN)
142+11.00	142+99.58	7	7
143+51.76	145+67.52	7	7

### FORBES AVE BETWEEN STEVENSON ST AND PRIDE ST PARTIAL TYPICAL TANGENT SECTION

CURB	HEIGHT TA	BLE - L	T
BEGIN STA	END STA	BEGIN REVEAL (IN)	END REVEAL ( IN)
142+26.07	142+75.13	4	4

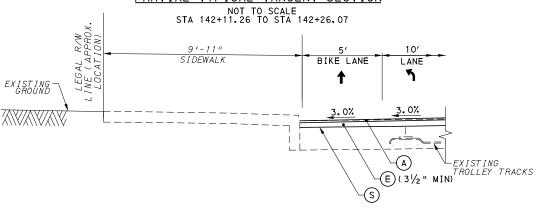

FORBES AVE BETWEEN STEVENSON ST AND PRIDE ST PARTIAL TYPICAL TANGENT SECTION

NOT TO SCALE STA 144+33.52 TO STA 145+42.88

### **LEGEND**

- SUPERPAVE ASPHALT MIXTURE DESIGN, WEARING COURSE, PG 64E-22, 10 TO <30 MILLION ESALS, 9.5 MM MIX, 11/2" DEPTH, SRL-H
- SUPERPAVE ASPHALT MIXTURE DESIGN, WEARING COURSE, PG 64S-22, <0.3 MILLION ESALS, 9.5 MM MIX, 2" DEPTH, SRL-H
- SUPERPAVE ASPHALT MIXTURE DESIGN, BINDER COURSE, PG 64E-22, 10 TO <30 MILLION ESALS, 19.0 MM MIX, 2" DEPTH
- SUPERPAVE ASPHALT MIXTURE DESIGN, BASE COURSE, PG 64S-22, <0.3 MILLION ESALS, 25.0 MM MIX, 4" DEPTH
- SUPERPAVE ASPHALT MIXTURE DESIGN, BINDER COURSE (LEVELING), PG 64E-22, 10 TO <30 MILLION ESALS, 19.0 MM MIX
- F PLAIN CEMENT CONCRETE PAVEMENT, 4" DEPTH
- G REINFORCED CEMENT CONCRETE BASE COURSE, 10" DEPTH
- 4" PAVEMENT BASE DRAIN
- SUBBASE (NO. 2A) (MATCH ADJACENT SUBBASE DEPTH) OVER GEOTEXTILE CLASS 4, TYPE A
- J SUBBASE 4" DEPTH (NO. 2A)
- SUBBASE 6" DEPTH (NO. 2A)
- SUBBASE 8" DEPTH (NO. 2A)
  OVER GEOTEXTILE CLASS 4. TYPE A
- M PLAIN CONCRETE MOUNTABLE CURB,
- (N) CONCRETE BUFFER
- O REINFORCED CEMENT CONCRETE CURB
- (P) GRANITE CURB

- REINFORCED CEMENT CONCRETE SIDEWALK, 4" DEPTH
- MILLING OF CEMENT CONCRETE PAVEMENT SURFACE, 2" DEPTH
- MILLING OF ASPHALT PAVEMENT SURFACE, VARIABLE DEPTH (MILL TO SANDSTONE BLOCK LAYER)
- MILLING OF ASPHALT PAVEMENT SURFACE, 1 1/2 " DEPTH
- MILLING OF ASPHALT PAVEMENT SURFACE, 2" DEPTH

- (W) REINFORCED CEMENT CONCRETE CURB, 36"
- X CURB CHEEK WALL
- REMOVE AND RESET INTERLOCKING PAVERS
- Z) EXPOSED AGGREGATE CONCRETE SIDEWALK, BROWN
- AA PWSA SIDEWALK TRENCH DRAIN WITH ADA
- TT DIRECTIONAL ARROWS

NOTE: ASPHALT TACK COAT IS REQUIRED BETWEEN ALL ASPHALT PAVING COURSES AND ON MILLED SURFACES PRIOR TO PLACING OVERLAY

NOTE: EXISTING TROLLEY TRACKS SHOWN FOR INFORMATION ONLY. THE EXACT LOCATION, LIMITS, AND TYPE OF TRACK IS UNKNOWN. TROLLEY

TRACKS MAY HAVE BEEN REMOVED.

**Gulf Tower** 707 Grant Street 5th Floor Pittsburgh, PA 15219 **ANNETT FLEMING** GANNETT FLEMING, INC. Foster Plaza 8 Suite 400 730 Holiday Drive Pittsburgh, PA. 15220

THE PREPARATION OF THIS DOCUMENT HAS BEEN FINANCED IN PART THROUGH A GRANT FROM THE FEDERAL TRANSIT ADMINISTRATION U.S. DEPARTMENT OF TRANSPORTATION, UNDER THE URBAN MASS TRANSPORTATION ACT OF 1964 AS AMENDED FOR THE PORT AUTHORITY OF ALLEGHENY COUNTY, PENNSYLVANIA. NO. DATE DESCRIPTION REVISIONS

(NOT FOR CONSTRUCTION)

TYPICAL SECTION


NOT TO SCALE STA 141+78.10 TO STA 145+67.52


DESIGNED	RRH	
DRAWN	RRH	
CHECKED	KCF	
IN CHARGE	<u>GEC</u>	
DATE	05/01/24	
SCALE		
	AS SHOWN	

PORT AUTHORITY OF ALLEGHENY COUNTY BUS RAPID TRANSIT UPTOWN TO OAKLAND TYPICAL SECTIONS **FORBES AVE** 

Port Authority

CONTRACT NO. BRT-001 CV34 sнт. 109 DWG NO

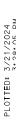

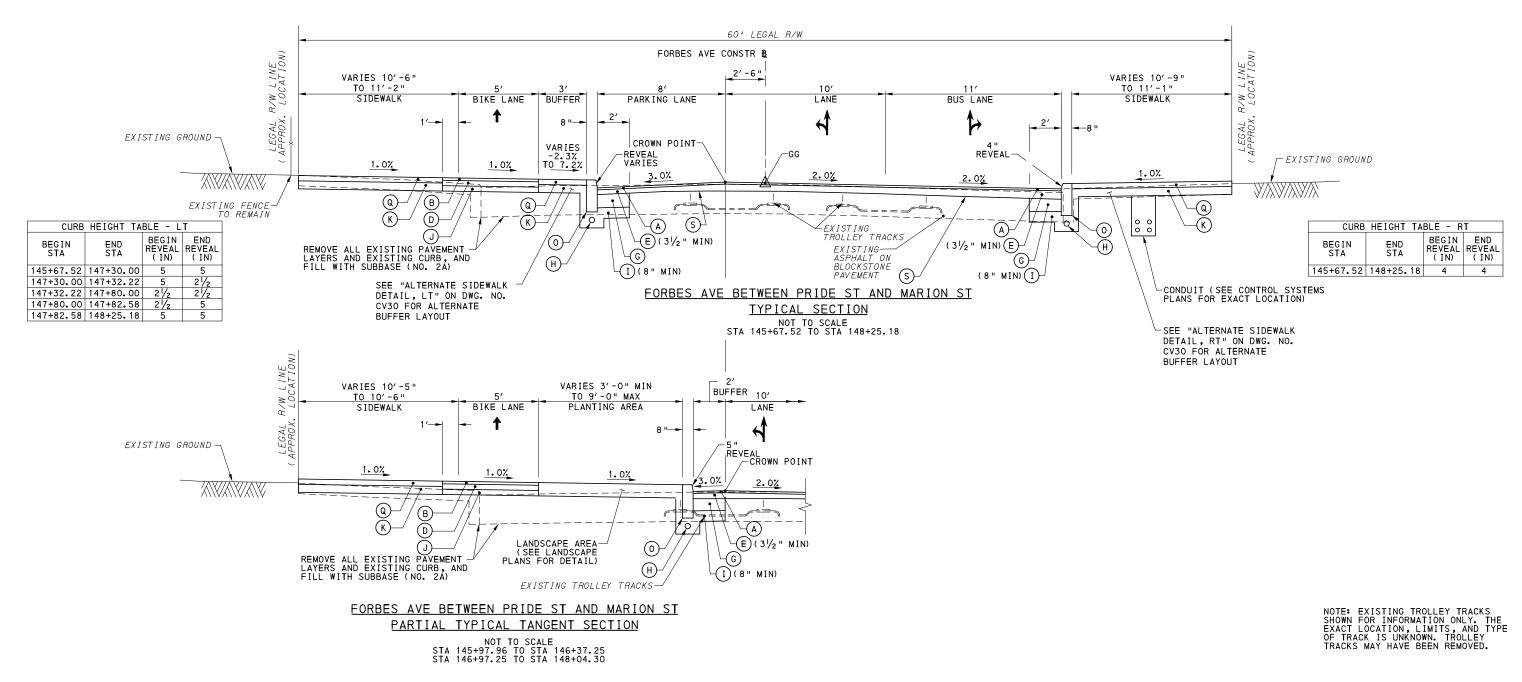

**LEGEND** 

SUPERPAVE ASPHALT MIXTURE DESIGN, WEARING COURSE, PG 64E-22, 10 TO <30 MILLION ESALS, 9.5 MM MIX, 11/2" DEPTH, SRL-H

SUPERPAVE ASPHALT MIXTURE DESIGN, WEARING COURSE, PG 64S-22, <0.3, MILLION ESALS, 9.5 MM MIX, 2" DEPTH, SRL-H

- SUPERPAVE ASPHALT MIXTURE DESIGN, BINDER COURSE, PG 64E-22, 10 TO <300 MILLION ESALS, 19.0 MM MIX, 2" DEPTH
- SUPERPAVE ASPHALT MIXTURE DESIGN, BASE COURSE, PG 64S-22, <0.3 MILLION ESALS, 25.0 MM MIX, 4" DEPTH
- SUPERPAVE ASPHALT MIXTURE DESIGN, BINDER COURSE (LEVELING), PG 64E-22, 10 TO <30 MILLION ESALS, 19.0 MM MIX
- F PLAIN CEMENT CONCRETE PAVEMENT, 4" DEPTH
- G REINFORCED CEMENT CONCRETE BASE COURSE, 10" DEPTH
- 4" PAVEMENT BASE DRAIN
- SUBBASE (NO. 2A) (MATCH ADJACENT SUBBASE DEPTH) OVER GEOTEXTILE CLASS 4, TYPE A
- J SUBBASE 4" DEPTH (NO. 2A)
- (K) SUBBASE 6" DEPTH (NO. 2A)
- SUBBASE 8" DEPTH (NO. 2A)
  OVER GEOTEXTILE CLASS 4. TYPE A
- M PLAIN CONCRETE MOUNTABLE CURB,
- (N) CONCRETE BUFFER
- O REINFORCED CEMENT CONCRETE CURB
- (P) GRANITE CURB

- REINFORCED CEMENT CONCRETE SIDEWALK, 4" DEPTH
- MILLING OF CEMENT CONCRETE PAVEMENT SURFACE, 2" DEPTH
- MILLING OF ASPHALT PAVEMENT SURFACE, VARIABLE DEPTH (MILL TO SANDSTONE BLOCK LAYER)
- MILLING OF ASPHALT PAVEMENT SURFACE, 1 1/2 " DEPTH
- (W) REINFORCED CEMENT CONCRETE CURB, 36"
- X CURB CHEEK WALL
- REMOVE AND RESET INTERLOCKING PAVERS
- Z) EXPOSED AGGREGATE CONCRETE SIDEWALK, BROWN
- PWSA SIDEWALK TRENCH DRAIN WITH ADA COMPLIANT AND BICYCLE SAFE GRATE
- TT DIRECTIONAL ARROWS

NOTE: ASPHALT TACK COAT IS REQUIRED BETWEEN ALL ASPHALT PAVING COURSES AND ON MILLED SURFACES PRIOR TO PLACING OVERLAY

**Gulf Tower** 707 Grant Street 5th Floor Pittsburgh, PA 15219 (ANNETT FLEMING GANNETT FLEMING, INC. Foster Plaza 8 Suite 400 730 Holiday Drive Pittsburgh, PA. 15220

THE PREPARATION OF THIS DOCUMENT HAS BEEN FINANCED IN PART THROUGH A GRANT FROM THE FEDERAL TRANSIT ADMINISTRATION U.S. DEPARTMENT OF TRANSPORTATION, UNDER THE URBAN MASS TRANSPORTATION ACT PORT AUTHORITY OF ALLEGHENY COUNTY, PENNSYLVANIA. NO. DATE DESCRIPTION REVISIONS

(NOT FOR CONSTRUCTION)

DESIGNED	<u>RRH</u>	
DRAWN	RRH	
CHECKED	KCF	
IN CHARGE	<u>GEC</u>	
DATE	05/01/24	
SCALE		

PORT AUTHORITY OF ALLEGHENY COUNTY BUS RAPID TRANSIT UPTOWN TO OAKLAND TYPICAL SECTIONS **FORBES AVE** 


**Port Authority** 

sнт. 110

CONTRACT NO. BRT-001 DWG. NO. CV35

OF 1964 AS AMENDED FOR THE

AS SHOWN

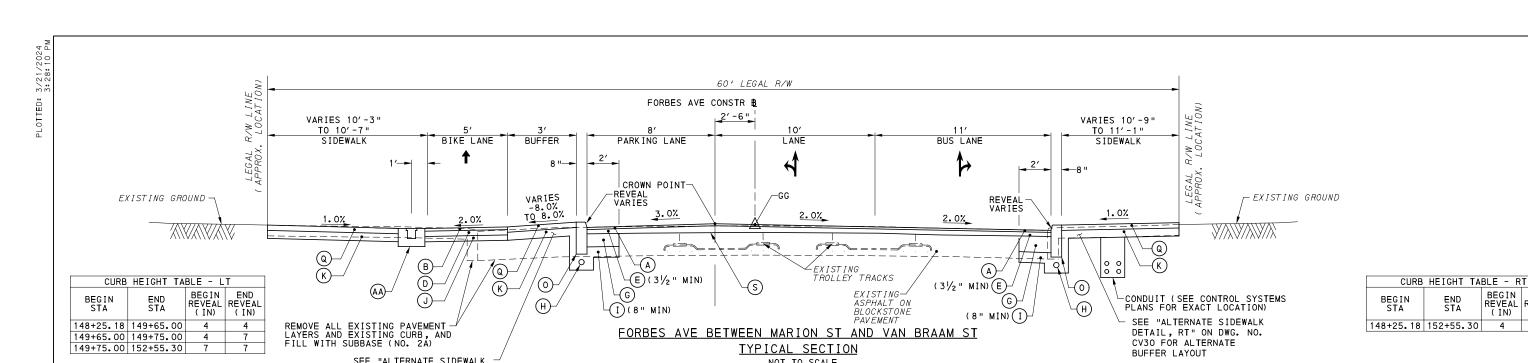

4 SEE "ALTERNATE SIDEWALK NOT TO SCALE STA 148+25.18 TO STA 152+55.30 DETAIL, LT" ON DWG. NO. CV30 FOR ALTERNATE BUFFER LAYOUT /W LINE VARIES SIDEWALK BUFFER PARKING LANE BIKE LANE \* VARIES 10'-2" TO 10'-7" 3'-0" MIN TO BUFFER \*\* 10'-0" 9'-0" MAX SIDEWALK BIKE LANE PLANTING LANE AREA EXISTING GROUND -CROWN POINT EXISTING GROUND -1.5% -REVEAL 1.5% 1.5% VARIES 1.0% TO 1.5% VARIES VARIES 3.0% VARIES 1.0% TO 1.5% 1.0% TO 1.5% CROWN POINT 2.0% (D)--EXISTING TROLLEY TRACKS E (31/2" MIN) (B) Q) (A)REMOVE ALL EXISTING PAVEMENT — LAYERS AND EXISTING CURB, AND FILL WITH SUBBASE (NO. 2A) (D) —(E)(3½" MIN) (K)LANDSCAPE AREA-(NIM "8)(I) (SEE LANDSCAPE PLANS FOR DETAIL) (G) SEE "ALTERNATE SIDEWALK REMOVE ALL EXISTING PAVEMENT -LAYERS AND EXISTING CURB, AND (H)(NIM "8)(I) DETAIL, LT" ON DWG. NO. EXISTING TROLLEY TRACKS CV30 FOR ALTERNATE BUFFER LAYOUT

### FORBES AVE BETWEEN MARION ST AND VAN BRAAM ST PARTIAL TYPICAL TANGENT SECTION

NOT TO SCALE STA 149+75.00 TO STA 151+93.26

### **LEGEND**

- SUPERPAVE ASPHALT MIXTURE DESIGN, WEARING COURSE, PG 64E-22, 10 TO <30 MILLION ESALS, 9.5 MM MIX, 11/2" DEPTH, SRL-H
- SUPERPAVE ASPHALT MIXTURE DESIGN, WEARING COURSE, PG 64S-22, <0.3, MILLION ESALS, 9.5 MM MIX, 2" DEPTH, SRL-H
- SUPERPAVE ASPHALT MIXTURE DESIGN, BINDER COURSE, PG 64E-22, 10 TO <30 MILLION ESALS, 19.0 MM MIX, 2" DEPTH
- SUPERPAVE ASPHALT MIXTURE DESIGN, BASE COURSE, PG 64S-22, <0.3 MILLION ESALS, 25.0 MM MIX, 4" DEPTH
- SUPERPAVE ASPHALT MIXTURE DESIGN, BINDER COURSE (LEVELING), PG 64E-22, 10 TO <30 MILLION ESALS, 19.0 MM MIX
- $\stackrel{\hbox{\scriptsize F}}{\mbox{\scriptsize F}}$  PLAIN CEMENT CONCRETE PAVEMENT, 4" DEPTH
- REINFORCED CEMENT CONCRETE BASE COURSE, 10" DEPTH
- 4" PAVEMENT BASE DRAIN
- SUBBASE (NO. 2A) (MATCH ADJACENT SUBBASE DEPTH) OVER GEOTEXTILE CLASS 4, TYPE A
- J SUBBASE 4" DEPTH (NO. 2A)
- (K) SUBBASE 6" DEPTH (NO. 2A)
- SUBBASE 8" DEPTH (NO. 2A)
  OVER GEOTEXTILE CLASS 4. TYPE A
- M PLAIN CONCRETE MOUNTABLE CURB,
- (N) CONCRETE BUFFER
- (O) REINFORCED CEMENT CONCRETE CURB
- (P) GRANITE CURB

- REINFORCED CEMENT CONCRETE SIDEWALK, 4" DEPTH
- MILLING OF CEMENT CONCRETE PAVEMENT SURFACE, 2" DEPTH
- MILLING OF ASPHALT PAVEMENT SURFACE, VARIABLE DEPTH (MILL TO SANDSTONE BLOCK LAYER)
- MILLING OF ASPHALT PAVEMENT SURFACE, 1 1/2 " DEPTH
- MILLING OF ASPHALT PAVEMENT SURFACE, 2" DEPTH

NOT TO SCALE \* STA 148+55.67 TO STA 148+88.08 \*\* STA 151+93.26 TO STA 152+25.40

FORBES AVE BETWEEN MARION ST AND VAN BRAAM ST

PARTIAL TYPICAL TANGENT SECTION

- (W) REINFORCED CEMENT CONCRETE CURB, 36"
- (X) CURB CHEEK WALL
- REMOVE AND RESET INTERLOCKING PAVERS
- (Z) EXPOSED AGGREGATE CONCRETE SIDEWALK, BROWN
- PWSA SIDEWALK TRENCH DRAIN WITH ADA COMPLIANT AND BICYCLE SAFE GRATE
- ↑↑ DIRECTIONAL ARROWS

ASPHALT TACK COAT IS REQUIRED BETWEEN ALL ASPHALT PAVING COURSES AND ON MILLED SURFACES PRIOR TO PLACING OVERLAY

NOTE: EXISTING TROLLEY TRACKS SHOWN FOR INFORMATION ONLY. THE EXACT LOCATION, LIMITS, AND TYPE OF TRACK IS UNKNOWN. TROLLEY

TRACKS MAY HAVE BEEN REMOVED.

BEGIN END REVEAL REVEAL

(IN) (IN)

**Gulf Tower** 707 Grant Street 5th Floor Pittsburgh, PA 15219 (ANNETT FLEMING GANNETT FLEMING, INC. Foster Plaza 8 Suite 400 730 Holiday Drive Pittsburgh, PA. 15220

THE PREPARATION OF THIS DOCUMENT HAS BEEN FINANCED IN PART THROUGH A GRANT FROM THE FEDERAL TRANSIT ADMINISTRATION U.S. DEPARTMENT OF TRANSPORTATION, UNDER THE URBAN MASS TRANSPORTATION ACT OF 1964 AS AMENDED FOR THE PORT AUTHORITY OF ALLEGHENY COUNTY, PENNSYLVANIA. NO. DATE DESCRIPTION REVISIONS

(NOT FOR CONSTRUCTION)


DESIGNED	RRH	
DRAWN	RRH	
CHECKED	KCF	
IN CHARGE	<u>GEC</u>	
DATE	05/01/24	
SCALE		
	AS SHOWN	

PORT AUTHORITY OF ALLEGHENY COUNTY

BUS RAPID TRANSIT UPTOWN TO OAKLAND TYPICAL SECTIONS **FORBES AVE** 

**Port Authority** 

CONTRACT NO. BRT-001 CV36 DWG NO sнт. **111** 

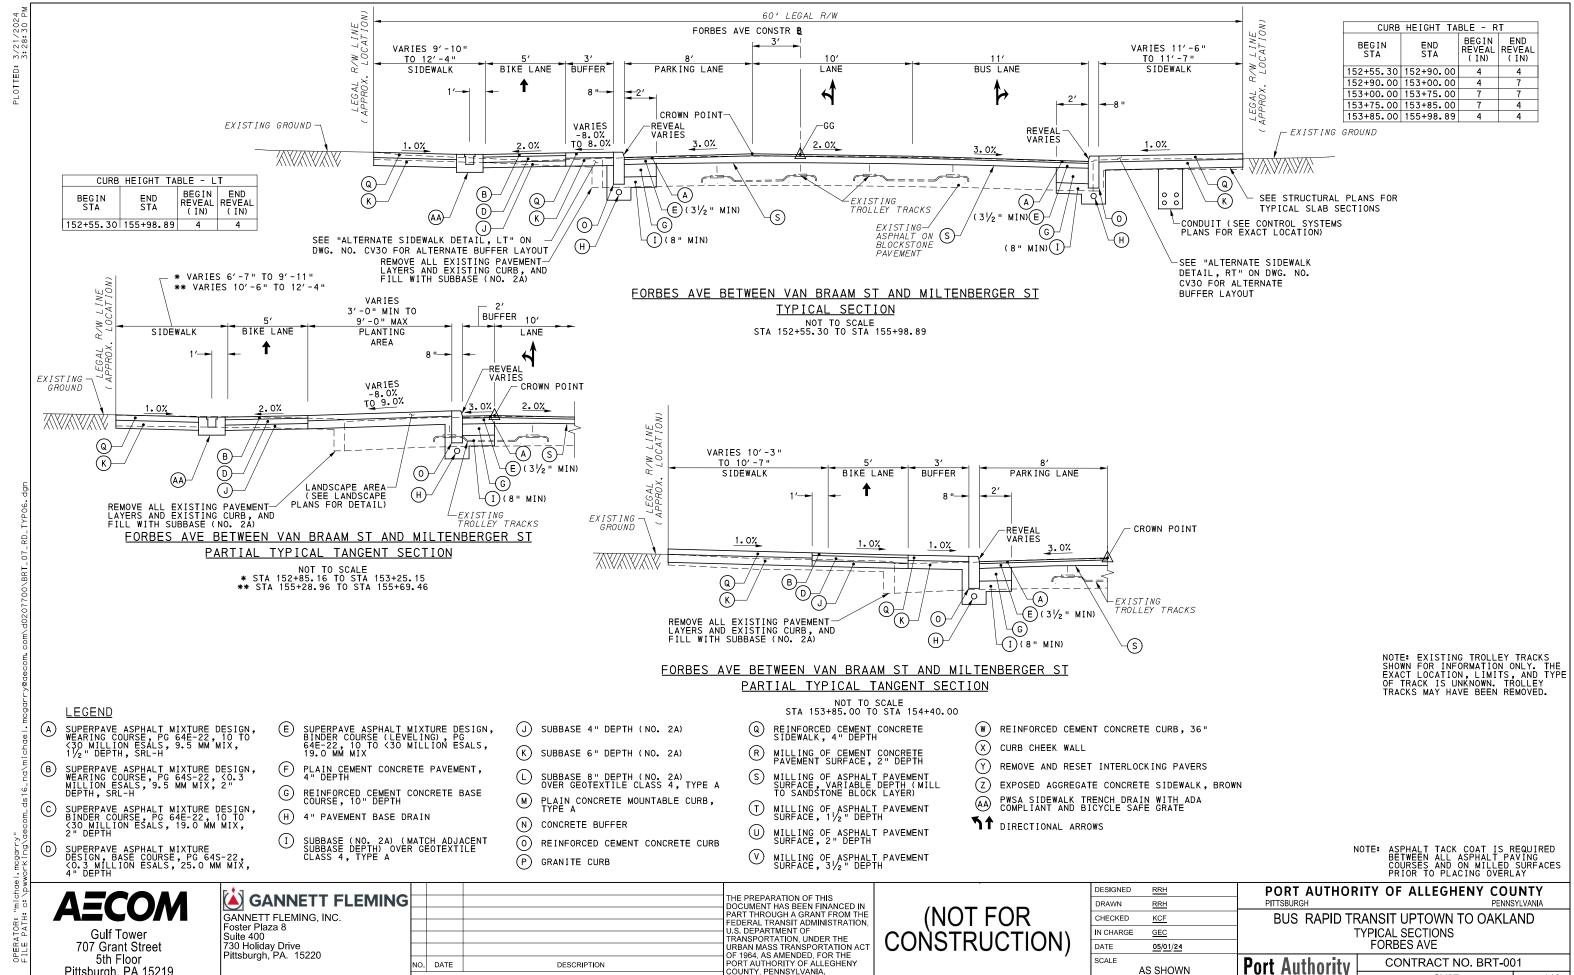

REVISIONS


AS SHOWN


CV37

sнт. 112

DWG NO

Pittsburgh, PA 15219

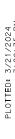

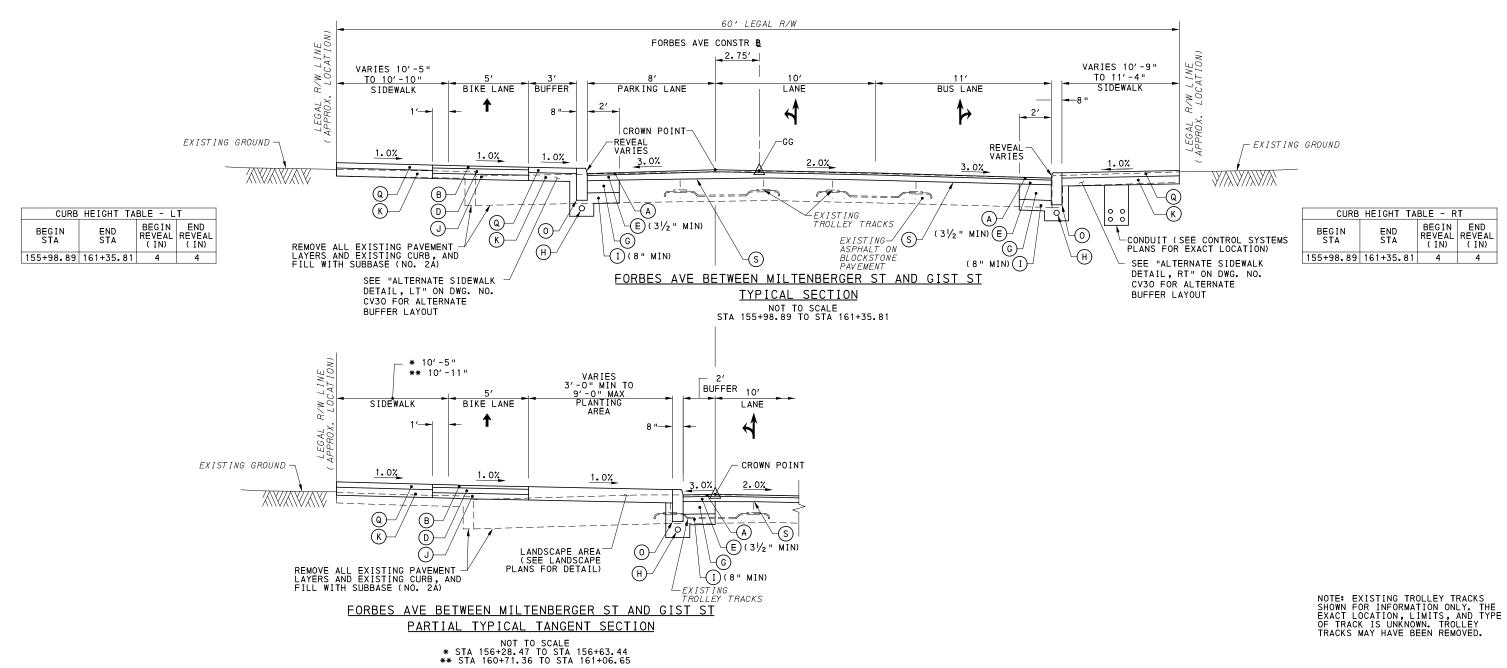

**LEGEND** 

A SUPERPAVE ASPHALT MIXTURE DESIGN, WEARING COURSE, PG 64E-22, 10 TO 430 MILLION ESALS, 9.5 MM MIX, 1½ " DEPTH, SRL-H

B) SUPERPAVE ASPHALT MIXTURE DESIGN, WEARING COURSE, PG 64S-22, <0.3, MILLION ESALS, 9.5 MM MIX, 2" DEPTH, SRL-H

- © SUPERPAVE ASPHALT MIXTURE DESIGN, BINDER COURSE, PG 64E-22, 10 TO <30 MILLION ESALS, 19.0 MM MIX, 2" DEPTH
- D SUPERPAVE ASPHALT MIXTURE
  DESIGN, BASE COURSE, PG 64S-22,
  <0.3 MILLION ESALS, 25.0 MM MIX,
  4" DEPTH
- SUPERPAVE ASPHALT MIXTURE DESIGN, BINDER COURSE (LEVELING), PG 64E-22, 10 TO <30 MILLION ESALS, 19.0 MM MIX
- F) PLAIN CEMENT CONCRETE PAVEMENT, 4" DEPTH
- G REINFORCED CEMENT CONCRETE BASE COURSE, 10" DEPTH
- H 4" PAVEMENT BASE DRAIN
- ) SUBBASE (NO. 2A) (MATCH ADJACENT SUBBASE DEPTH) OVER GEOTEXTILE CLASS 4, TYPE A
- J SUBBASE 4" DEPTH (NO. 2A)
- (K) SUBBASE 6" DEPTH (NO. 2A)
- CL SUBBASE 8" DEPTH (NO. 2A)
  OVER GEOTEXTILE CLASS 4, TYPE A
- M PLAIN CONCRETE MOUNTABLE CURB,
- N CONCRETE BUFFER
- REINFORCED CEMENT CONCRETE CURB
- P GRANITE CURB

- Q REINFORCED CEMENT CONCRETE SIDEWALK, 4" DEPTH
- R MILLING OF CEMENT CONCRETE PAVEMENT SURFACE, 2" DEPTH
- S MILLING OF ASPHALT PAVEMENT SURFACE, VARIABLE DEPTH (MILL TO SANDSTONE BLOKE LAYER
- T MILLING OF ASPHALT PAVEMENT SURFACE, 1 1/2 " DEPTH
- WILLING OF ASPHALT PAVEMENT SURFACE, 2" DEPTH

MILLING OF ASPHALT PAVEMENT SURFACE, 3 1/2 " DEPTH

- (W) REINFORCED CEMENT CONCRETE CURB, 36"
- X CURB CHEEK WALL
- Y) REMOVE AND RESET INTERLOCKING PAVERS
- Z EXPOSED AGGREGATE CONCRETE SIDEWALK, BROWN
- AA PWSA SIDEWALK TRENCH DRAIN WITH ADA COMPLIANT AND BICYCLE SAFE GRATE
- TT DIRECTIONAL ARROWS

NOTE: ASPHALT TACK COAT IS REQUIRED
BETWEEN ALL ASPHALT PAVING
COURSES AND ON MILLED SURFACES
PRIOR TO PLACING OVERLAY

**AECOM** 

Gulf Tower 707 Grant Street 5th Floor Pittsburgh, PA 15219 GANNETT FLEMING
GANNETT FLEMING, INC.
Foster Plaza 8
Suite 400
730 Holiday Drive
Pittsburgh, PA. 15220

THE PREPARATION OF THIS
DOCUMENT HAS BEEN FINANCED IN
PART THROUGH A GRANT FROM THE
FEDERAL TRANSIT ADMINISTRATION
U.S. DEPARTMENT OF
TRANSPORTATION, UNDER THE
URBAN MASS TRANSPORTATION ACT
OF 1964, AS AMENDED, FOR THE
PORT AUTHORITY OF ALLEGHENY
COUNTY, PENNSYLVANIA.

(NOT FOR CONSTRUCTION)

DESIGNED	RRH	
DRAWN	RRH	
CHECKED	KCF	
IN CHARGE	<u>GEC</u>	
DATE	05/01/24	
SCALE		
	AS SHOWN	

PORT AUTHORITY OF ALLEGHENY COUNTY
PITTSBURGH


BUS RAPID TRANSIT UPTOWN TO OAKLAND
TYPICAL SECTIONS
FORBES AVE

Port Authority

CONTRACT NO. BRT-001

DWG. NO. CV38 SHT. 113

OPERATOR: "michael.mcgarry" FILE PATH: c:\pwworking\aecom\_ds1

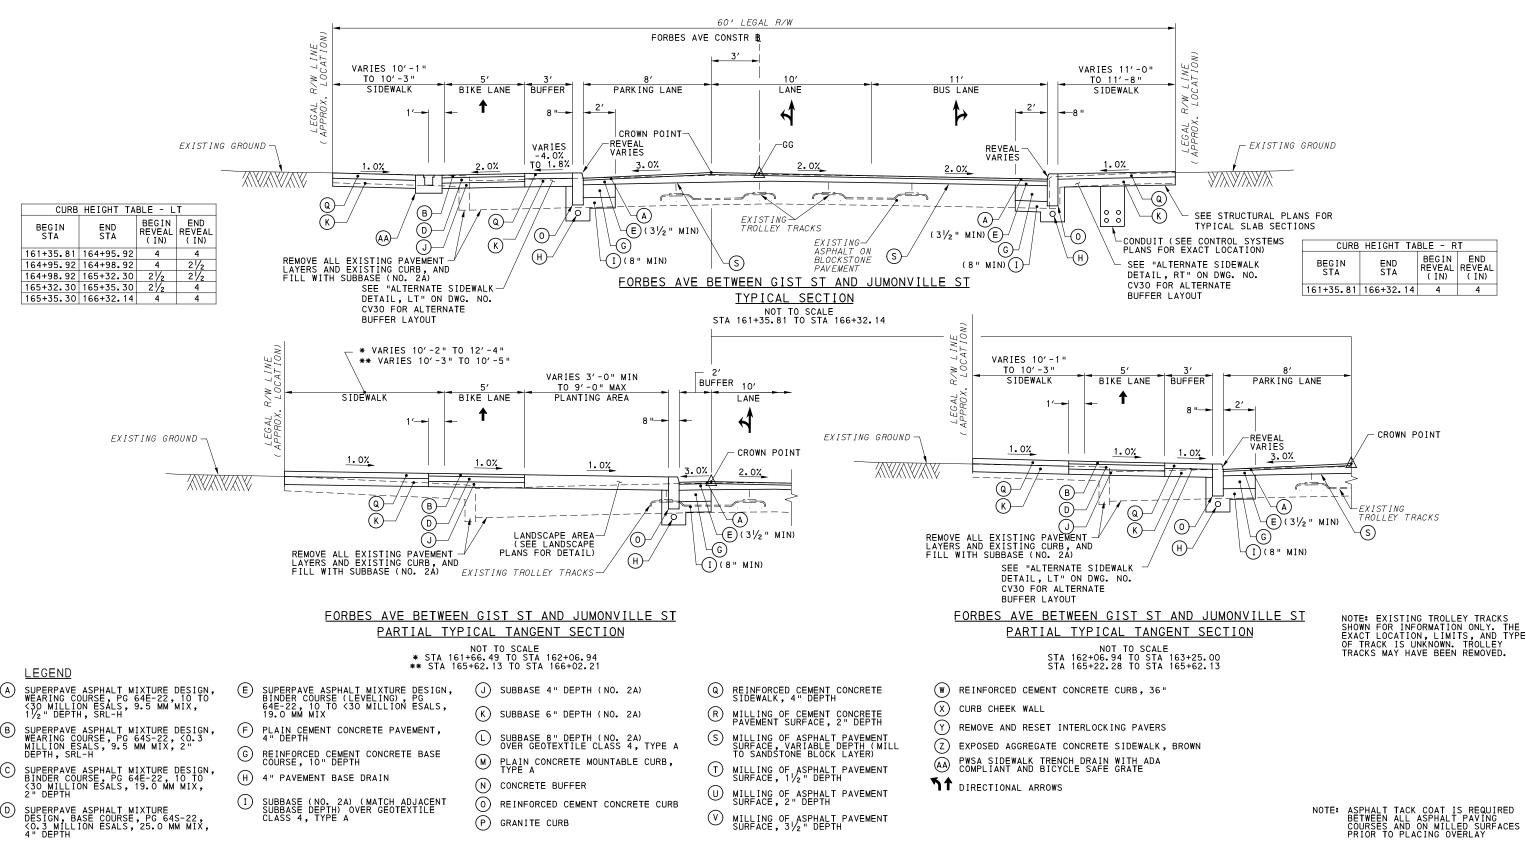

**Gulf Tower** 707 Grant Street

5th Floor Pittsburgh, PA 15219 (ANNETT FLEMING GANNETT FLEMING, INC.

Foster Plaza 8 Suite 400 730 Holiday Drive Pittsburgh, PA. 15220 NO. DATE

THE PREPARATION OF THIS DOCUMENT HAS BEEN FINANCED IN PART THROUGH A GRANT FROM THE FEDERAL TRANSIT ADMINISTRATION U.S. DEPARTMENT OF TRANSPORTATION, UNDER THE URBAN MASS TRANSPORTATION ACT OF 1964 AS AMENDED FOR THE DESCRIPTION COUNTY, PENNSYLVANIA. REVISIONS

(NOT FOR CONSTRUCTION DESIGNED RRH RAWN RRH CHECKED KCF N CHARGE GEC DATE 05/01/24 SCALE AS SHOWN


ASPHALT TACK COAT IS REQUIRED BETWEEN ALL ASPHALT PAYING COURSES AND ON MILLED SURFACES PRIOR TO PLACING OVERLAY PORT AUTHORITY OF ALLEGHENY COUNTY

BUS RAPID TRANSIT UPTOWN TO OAKLAND TYPICAL SECTIONS **FORBES AVE** 

CONTRACT NO. BRT-001 **Port Authority** 

CV39 DWG NO sнт. **114** 



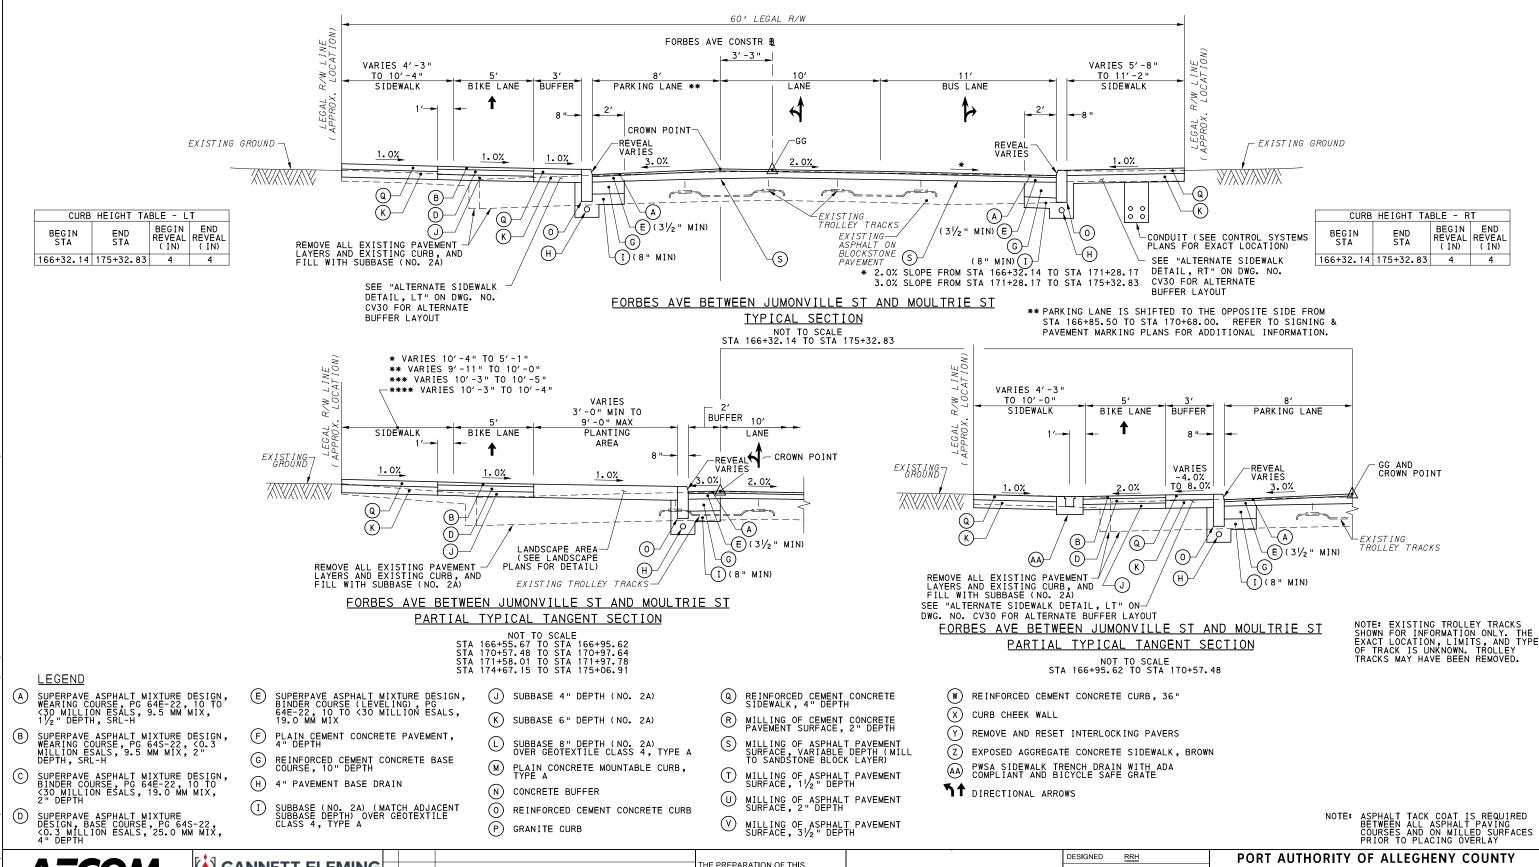

**Gulf Tower** 707 Grant Street

Foster Plaza 8 Suite 400 730 Holiday Drive Pittsburgh, PA. 15220 5th Floor Pittsburgh, PA 15219

(ANNETT FLEMING GANNETT FLEMING, INC.

NO. DATE DESCRIPTION REVISIONS

DOCUMENT HAS BEEN FINANCED IN PART THROUGH A GRANT FROM THE FEDERAL TRANSIT ADMINISTRATION U.S. DEPARTMENT OF TRANSPORTATION, UNDER THE URBAN MASS TRANSPORTATION ACT OF 1964 AS AMENDED FOR THE COUNTY, PENNSYLVANIA.


(NOT FOR CONSTRUCTION

RRH RAWN RRH CHECKED KCF N CHARGE GEC DATE 05/01/24 SCALE AS SHOWN PORT AUTHORITY OF ALLEGHENY COUNTY

BUS RAPID TRANSIT UPTOWN TO OAKLAND TYPICAL SECTIONS **FORBES AVE** 

**Port Authority** 

CONTRACT NO. BRT-001 CV40 DWG NO sнт. 115

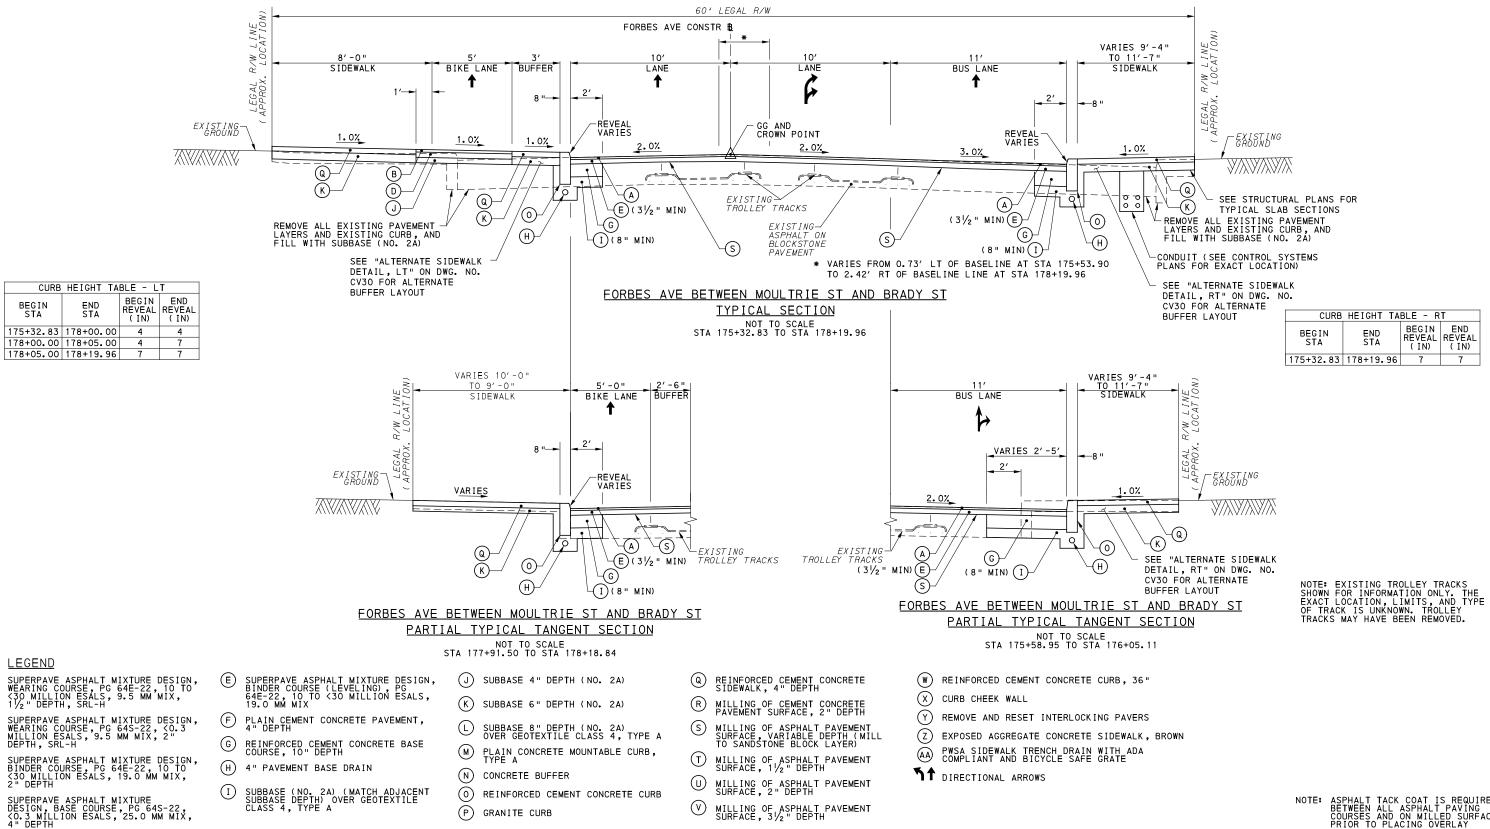

**Gulf Tower** 707 Grant Street 5th Floor Pittsburgh, PA 15219 **ANNETT FLEMING** GANNETT FLEMING, INC.

Foster Plaza 8 Suite 400 730 Holiday Drive Pittsburgh, PA. 15220

THE PREPARATION OF THIS DOCUMENT HAS BEEN FINANCED IN PART THROUGH A GRANT FROM THE FEDERAL TRANSIT ADMINISTRATION U.S. DEPARTMENT OF TRANSPORTATION, UNDER THE URBAN MASS TRANSPORTATION ACT OF 1964 AS AMENDED FOR THE NO. DATE DESCRIPTION REVISIONS

(P) GRANITE CURB

(NOT FOR CONSTRUCTION DESIGNED RRH DRAWN RRH CHECKED KCF N CHARGE GEC DATE 05/01/24 SCALE AS SHOWN


ASPHALT TACK COAT IS REQUIRED BETWEEN ALL ASPHALT PAVING COURSES AND ON MILLED SURFACES PRIOR TO PLACING OVERLAY PORT AUTHORITY OF ALLEGHENY COUNTY

BUS RAPID TRANSIT UPTOWN TO OAKLAND TYPICAL SECTIONS **FORBES AVE** 

**Port Authority** 

CONTRACT NO. BRT-001 DWG. NO. CV41 sнт. 116

PORT AUTHORITY OF ALLEGHENY COUNTY, PENNSYLVANIA.

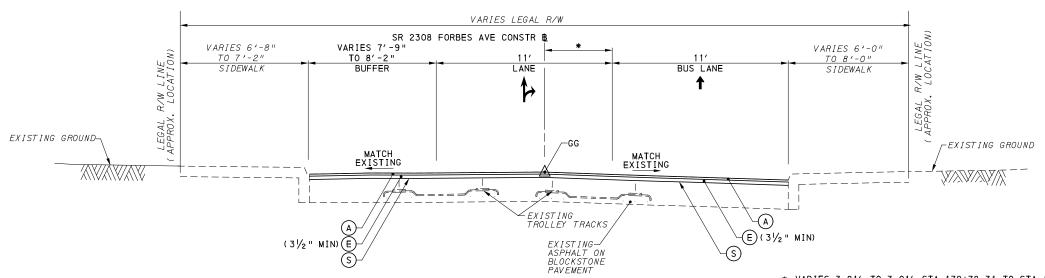

FORBES AVE BETWEEN BRADY ST AND BIRMINGHAM BRIDGE OFF-RAMP

\* VARIES 3.81' TO 3.01' STA 179+78.31 TO STA 180+63.77

TYPICAL SECTION

NOT TO SCALE
STA 178+19.96 TO STA 180+65.89

NOTE: EXISTING TROLLEY TRACKS SHOWN FOR INFORMATION ONLY. THE EXACT LOCATION, LIMITS, AND TYPE OF TRACK IS UNKNOWN. TROLLEY TRACKS MAY HAVE BEEN REMOVED.

### **LEGEND**

- A SUPERPAVE ASPHALT MIXTURE DESIGN, WEARING COURSE, PG 64E-22, 10 TO 430 MILLION ESALS, 9.5 MM MIX, 1½" DEPTH, SRL-H
- B SUPERPAVE ASPHALT MIXTURE DESIGN, WEARING COURSE, PG 645-22, <0.3 MILION ESALS, 9.5 MM MIX, 2" DEPTH, SRL-H
- © SUPERPAVE ASPHALT MIXTURE DESIGN, BINDER COURSE, PG 64E-22, 10 TO <30 MILLION ESALS, 19.0 MM MIX, 2" DEPTH
- D SUPERPAVE ASPHALT MIXTURE DESIGN, BASE COURSE, PG 64S-22, CO. 3 MILLION ESALS, 25.0 MM MIX, 4" DEPTH
- E SUPERPAVE ASPHALT MIXTURE DESIGN, BINDER COURSE (LEVELING), PG 64E-22, 10 TO <30 MILLION ESALS, 19.0 MM MIX
- F PLAIN CEMENT CONCRETE PAVEMENT, 4" DEPTH
- G REINFORCED CEMENT CONCRETE BASE COURSE, 10" DEPTH
- H 4" PAVEMENT BASE DRAIN
- SUBBASE (NO. 2A) (MATCH ADJACENT SUBBASE DEPTH) OVER GEOTEXTILE CLASS 4, TYPE A
- J SUBBASE 4" DEPTH (NO. 2A)
- (K) SUBBASE 6" DEPTH (NO. 2A)
- SUBBASE 8" DEPTH (NO. 2A)
  OVER GEOTEXTILE CLASS 4, TYPE A
- M PLAIN CONCRETE MOUNTABLE CURB,
- N CONCRETE BUFFER
- O REINFORCED CEMENT CONCRETE CURB
- P GRANITE CURB

- Q REINFORCED CEMENT CONCRETE SIDEWALK, 4" DEPTH
- R MILLING OF CEMENT CONCRETE PAVEMENT SURFACE, 2" DEPTH
- S MILLING OF ASPHALT PAVEMENT SURFACE, VARIABLE DEPTH (MILL TO SANDSTONE BLOCK LAYER)
- T MILLING OF ASPHALT PAVEMENT SURFACE, 1 1/2 " DEPTH
- U MILLING OF ASPHALT PAVEMENT SURFACE, 2" DEPTH
- WILLING OF ASPHALT PAVEMENT SURFACE, 3 1/2 " DEPTH

- W REINFORCED CEMENT CONCRETE CURB, 36"
- X CURB CHEEK WALL
- Y) REMOVE AND RESET INTERLOCKING PAVERS
- Z EXPOSED AGGREGATE CONCRETE SIDEWALK, BROWN
- PWSA SIDEWALK TRENCH DRAIN WITH ADA COMPLIANT AND BICYCLE SAFE GRATE
- ↑↑ DIRECTIONAL ARROWS

NOTE: ASPHALT TACK COAT IS REQUIRED BETWEEN ALL ASPHALT PAVING COURSES AND ON MILLED SURFACES PRIOR TO PLACING OVERLAY

sнт. **117** 

AECOM

Gulf Tower 707 Grant Street 5th Floor Pittsburgh, PA 15219 GANNETT FLEMING
GANNETT FLEMING, INC.
Foster Plaza 8
Suite 400
730 Holiday Drive
Pittsburgh, PA. 15220

			PART THROUGH A GRANT FROM THE FEDERAL TRANSIT ADMINISTRATION, U.S. DEPARTMENT OF TRANSPORTATION. UNDER THE
			URBAN MASS TRANSPORTATION ACT OF 1964, AS AMENDED, FOR THE
NO.	DATE	DESCRIPTION	PORT AUTHORITY OF ALLEGHENY COUNTY, PENNSYLVANIA.
		REVISIONS	COUNTY, PENNSTLVANIA.

(NOT FOR CONSTRUCTION)


DESIGNED	RRH	
DRAWN	RRH	
CHECKED	KCF	
IN CHARGE	GEC	
DATE	05/01/24	
SCALE	-	
	AS SHOWN	

PORT AUTHORITY OF ALLEGHENY COUNTY
PITTSBURGH

BUS RAPID TRANSIT UPTOWN TO OAKLAND
TYPICAL SECTIONS
FORBES AVE

Port Authority CONTRACT NO. BRT-001

DWG. NO. CV42

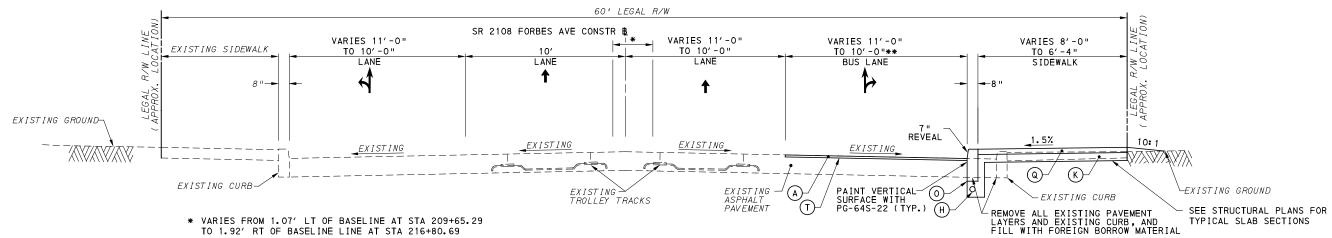


FORBES AVE BETWEEN CRAFT AVE AND HALKET ST

TYPICAL TANGENT SECTION

NOT TO SCALE STA 209+84.00 TO STA 213+88.00

\*\* MILL AND OVERLAY STA 209+84.00 TO STA 211+81.37, RT

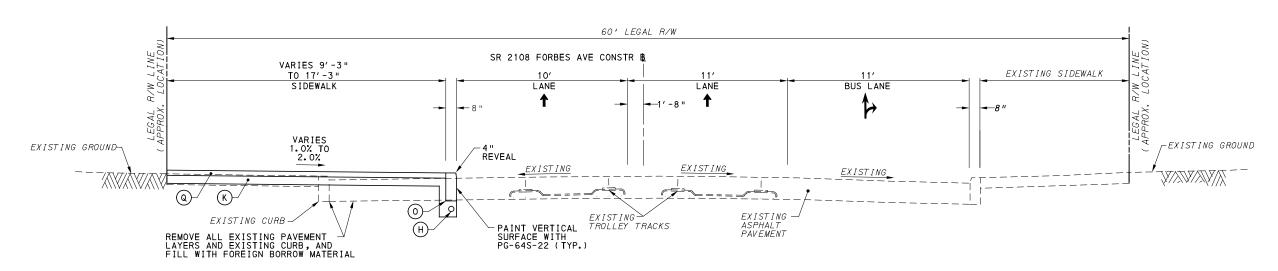

### FORBES AVE BETWEEN HALKET ST AND MCKEE PL

#### TYPICAL TANGENT SECTION

NOT TO SCALE STA 216+96.80 TO STA 217+30.40

NOTE: EXISTING TROLLEY TRACKS SHOWN FOR INFORMATION ONLY. THE EXACT LOCATION, LIMITS, AND TYPE OF TRACK IS UNKNOWN. TROLLEY TRACKS MAY HAVE BEEN REMOVED.

### **LEGEND**

- SUPERPAVE ASPHALT MIXTURE DESIGN, WEARING COURSE, PG 64E-22, 10 TO <30 MILLION ESALS, 9.5 MM MIX, 1/2" DEPTH, SRL-H
- SUPERPAVE ASPHALT MIXTURE DESIGN, WEARING COURSE, PG 64S-22, <0.3, MILLION ESALS, 9.5 MM MIX, 2" DEPTH, SRL-H
- SUPERPAVE ASPHALT MIXTURE DESIGN, BINDER COURSE, PG 64E-22, 10 TO <30 MILLION ESALS, 19.0 MM MIX, 2" DEPTH
- SUPERPAVE ASPHALT MIXTURE DESIGN, BASE COURSE, PG 64S-22, <0.3 MILLION ESALS, 25.0 MM MIX, 4" DEPTH
- SUPERPAVE ASPHALT MIXTURE DESIGN, BINDER COURSE (LEVELING), PG 64E-22, 10 TO <30 MILLION ESALS, 19.0 MM MIX
- $\stackrel{\hbox{\scriptsize F}}{\mbox{\scriptsize F}}$  PLAIN CEMENT CONCRETE PAVEMENT, 4" DEPTH
- G REINFORCED CEMENT CONCRETE BASE COURSE, 10" DEPTH
- 4" PAVEMENT BASE DRAIN
- SUBBASE (NO. 2A) (MATCH ADJACENT SUBBASE DEPTH) OVER GEOTEXTILE CLASS 4, TYPE A
- J SUBBASE 4" DEPTH (NO. 2A)
- (K) SUBBASE 6" DEPTH (NO. 2A)
- SUBBASE 8" DEPTH (NO. 2A)
  OVER GEOTEXTILE CLASS 4. TYPE A
- M PLAIN CONCRETE MOUNTABLE CURB,
- (N) CONCRETE BUFFER
- O REINFORCED CEMENT CONCRETE CURB
- (P) GRANITE CURB

- REINFORCED CEMENT CONCRETE SIDEWALK, 4" DEPTH
- MILLING OF CEMENT CONCRETE PAVEMENT SURFACE, 2" DEPTH
- MILLING OF ASPHALT PAVEMENT SURFACE, VARIABLE DEPTH (MILL TO SANDSTONE BLOCK LAYER)
- MILLING OF ASPHALT PAVEMENT SURFACE, 1 1/2 " DEPTH
- MILLING OF ASPHALT PAVEMENT SURFACE, 2" DEPTH

- (W) REINFORCED CEMENT CONCRETE CURB, 36"
- X CURB CHEEK WALL
- REMOVE AND RESET INTERLOCKING PAVERS
- Z) EXPOSED AGGREGATE CONCRETE SIDEWALK, BROWN
- A PWSA SIDEWALK TRENCH DRAIN WITH ADA COMPLIANT AND BICYCLE SAFE GRATE
- TT DIRECTIONAL ARROWS

NOTE: ASPHALT TACK COAT IS REQUIRED BETWEEN ALL ASPHALT PAVING COURSES AND ON MILLED SURFACES PRIOR TO PLACING OVERLAY

**Gulf Tower** 707 Grant Street 5th Floor Pittsburgh, PA 15219 **ANNETT FLEMING** GANNETT FLEMING, INC. Foster Plaza 8 Suite 400 730 Holiday Drive Pittsburgh, PA. 15220

THE PREPARATION OF THIS DOCUMENT HAS BEEN FINANCED IN PART THROUGH A GRANT FROM THE FEDERAL TRANSIT ADMINISTRATION U.S. DEPARTMENT OF TRANSPORTATION, UNDER THE URBAN MASS TRANSPORTATION ACT OF 1964, AS AMENDED, FOR THE PORT AUTHORITY OF ALLEGHENY NO. DATE DESCRIPTION COUNTY, PENNSYLVANIA. REVISIONS

(NOT FOR CONSTRUCTION)

DESIGNED	RRH	
DRAWN	<u>RRH</u>	
CHECKED	<u>KCF</u>	
IN CHARGE	<u>GEC</u>	
DATE	05/01/24	
SCALE		
	AS SHOWN	

PORT AUTHORITY OF ALLEGHENY COUNTY


BUS RAPID TRANSIT UPTOWN TO OAKLAND TYPICAL SECTIONS FORBES AVE

Port Authority

CONTRACT NO. BRT-001

DWG NO

CV43 sнт. 118

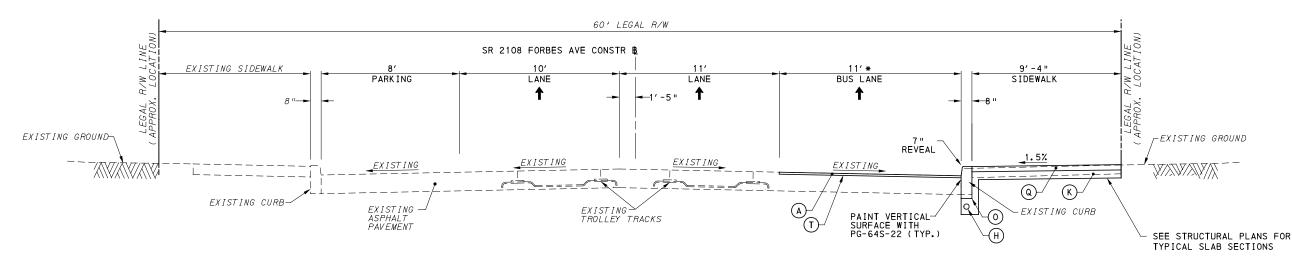


\* MILL AND OVERLAY STA 223+56.75 TO STA 225+05.00, RT

### FORBES AVE BETWEEN MCKEE PL AND SEMPLE ST

TYPICAL TANGENT SECTION

NOT TO SCALE
STA 223+56.75 TO STA 225+77.25

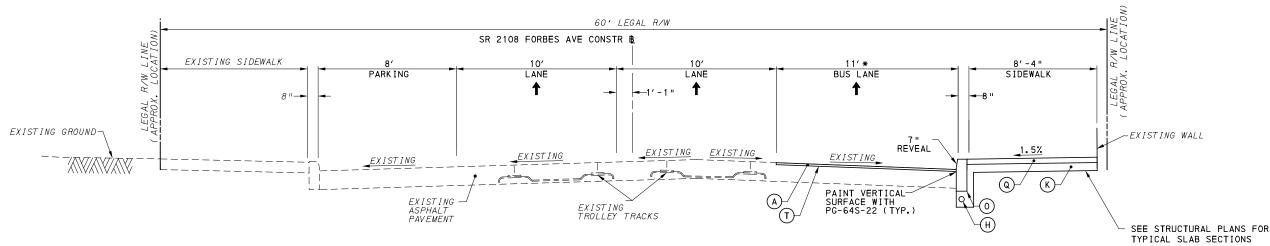

### FORBES AVE BETWEEN BOUQUET ST AND SCHENLEY DR/BIGELOW BLVD

## TYPICAL TANGENT SECTION NOT TO SCALE STA 235+33.00 TO STA 237+60.69

\* MILL AND OVERLAY STA 235+33.00 TO STA 235+96.00, RT

NOTE: EXISTING TROLLEY TRACKS SHOWN FOR INFORMATION ONLY. THE EXACT LOCATION, LIMITS, AND TYPE OF TRACK IS UNKNOWN. TROLLEY TRACKS MAY HAVE BEEN REMOVED.

### LEGEND

- A SUPERPAVE ASPHALT MIXTURE DESIGN, WEARING COURSE, PG 64E-22, 10 TO 30 MILLION ESALS, 9.5 MM MIX, 11/2" DEPTH, SRL-H
- B) SUPERPAVE ASPHALT MIXTURE DESIGN, WEARING COURSE, PG 64S-22, <0.3, MILLION ESALS, 9.5 MM MIX, 2" DEPTH, SRL-H
- C SUPERPAVE ASPHALT MIXTURE DESIGN, BINDER COURSE, PG 64E-22, 10 TO <30 MILLION ESALS, 19.0 MM MIX, 2" DEPTH
- D SUPERPAVE ASPHALT MIXTURE DESIGN, BASE COURSE, PG 64S-22, CO.3 MILLION ESALS, 25.0 MM MIX, 4" DEPTH
- E SUPERPAVE ASPHALT MIXTURE DESIGN, BINDER COURSE (LEVELING), PG 64E-22, 10 TO <30 MILLION ESALS, 19.0 MM MIX
- F) PLAIN CEMENT CONCRETE PAVEMENT, 4" DEPTH
- G REINFORCED CEMENT CONCRETE BASE COURSE, 10" DEPTH
- H 4" PAVEMENT BASE DRAIN
  - SUBBASE (NO. 2A) (MATCH ADJACENT SUBBASE DEPTH) OVER GEOTEXTILE CLASS 4, TYPE A
- J SUBBASE 4" DEPTH (NO. 2A)
- (K) SUBBASE 6" DEPTH (NO. 2A)
- SUBBASE 8" DEPTH (NO. 2A)
  OVER GEOTEXTILE CLASS 4, TYPE A
- M PLAIN CONCRETE MOUNTABLE CURB,
- N CONCRETE BUFFER
- O REINFORCED CEMENT CONCRETE CURB
- P GRANITE CURB

- Q REINFORCED CEMENT CONCRETE SIDEWALK, 4" DEPTH
- R MILLING OF CEMENT CONCRETE PAVEMENT SURFACE, 2" DEPTH
- MILLING OF ASPHALT PAVEMENT SURFACE, VARIABLE DEPTH (MILL TO SANDSTONE BLOCK LAYER)
- T MILLING OF ASPHALT PAVEMENT SURFACE, 1 1/2 " DEPTH
- (U) MILLING OF ASPHALT PAVEMENT SURFACE, 2" DEPTH
- W REINFORCED CEMENT CONCRETE CURB, 36"
- X CURB CHEEK WALL
- (Y) REMOVE AND RESET INTERLOCKING PAVERS
- (Z) EXPOSED AGGREGATE CONCRETE SIDEWALK, BROWN
- PWSA SIDEWALK TRENCH DRAIN WITH ADA COMPLIANT AND BICYCLE SAFE GRATE
- TT DIRECTIONAL ARROWS

NOTE: ASPHALT TACK COAT IS REQUIRED BETWEEN ALL ASPHALT PAVING COURSES AND ON MILLED SURFACES PRIOR TO PLACING OVERLAY

## **AECOM**

Gulf Tower 707 Grant Street 5th Floor Pittsburgh, PA 15219 GANNETT FLEMING
GANNETT FLEMING, INC.
Foster Plaza 8
Suite 400
730 Holiday Drive
Pittsburgh, PA. 15220

THE PREPARATION OF THIS
DOCUMENT HAS BEEN FINANCED IN
PART THROUGH A GRANT FROM THE
FEDERAL TRANSIT ADMINISTRATION,
U.S. DEPARTMENT OF
TRANSPORTATION, UNDER THE
URBAN MASS TRANSPORTATION ACT
OF 1964, AS AMENDED, FOR THE
PORT AUTHORITY OF ALLEGHENY
COUNTY, PENNSYLVANIA.

(NOT FOR CONSTRUCTION)

DESIGNED	RRH	
DRAWN	<u>RRH</u>	
CHECKED	KCF	
IN CHARGE	<u>GEC</u>	
DATE	<u>05/01/24</u>	
SCALE		
	AS SHOWN	

## COURSES AND ON MILLED SURFACES PRIOR TO PLACING OVERLAY PORT AUTHORITY OF ALLEGHENY COUNTY PENNSYLVANIA

BUS RAPID TRANSIT UPTOWN TO OAKLAND TYPICAL SECTIONS FORBES AVE

Port Authority

CONTRACT NO. BRT-001

DWG. NO. CV44 SHT. 119

EXISTING SIDEWALK

Foster Plaza 8 Suite 400

730 Holiday Drive

Pittsburgh, PA. 15220

NO. DATE

DESCRIPTION

REVISIONS

BIKE LANE

BUFFER

80' LEGAL R/W

LANE

FEDERAL TRANSIT ADMINISTRATION

URBAN MASS TRANSPORTATION ACT

U.S. DEPARTMENT OF TRANSPORTATION, UNDER THE

OF 1964, AS AMENDED, FOR THE PORT AUTHORITY OF ALLEGHENY

COUNTY, PENNSYLVANIA

BUS LANE

VARIES 15'-4" TO 9'-4"

SIDEWALK

N CHARGE

DATE

SCALE

CONSTRUCTION

GEC

05/01/24

AS SHOWN

BIKE LANE

-EXISTING GROUND

EXISTING GROUND

NOTE: EXISTING TROLLEY TRACKS SHOWN FOR INFORMATION ONLY. THE EXACT LOCATION, LIMITS, AND TYPE OF TRACK IS UNKNOWN. TROLLEY

ASPHALT TACK COAT IS REQUIRED BETWEEN ALL ASPHALT PAVING COURSES AND ON MILLED SURFACES PRIOR TO PLACING OVERLAY

sнт. 120

CONTRACT NO. BRT-001

CV45

TYPICAL SECTIONS

**FORBES AVE** 

DWG NO

**Port Authority** 

TRACKS MAY HAVE BEEN REMOVED.

SR 2108 FORBES AVE CONSTR B


LANE

**Gulf Tower** 

707 Grant Street


5th Floor

Pittsburgh, PA 15219

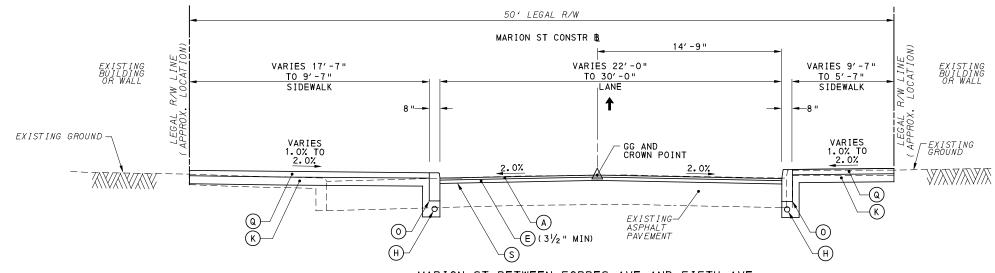

### MARION ST BETWEEN FORBES AVE AND FIFTH AVE TYPICAL SECTION

NOT TO SCALE STA 19+91.52 TO STA 20+42.86

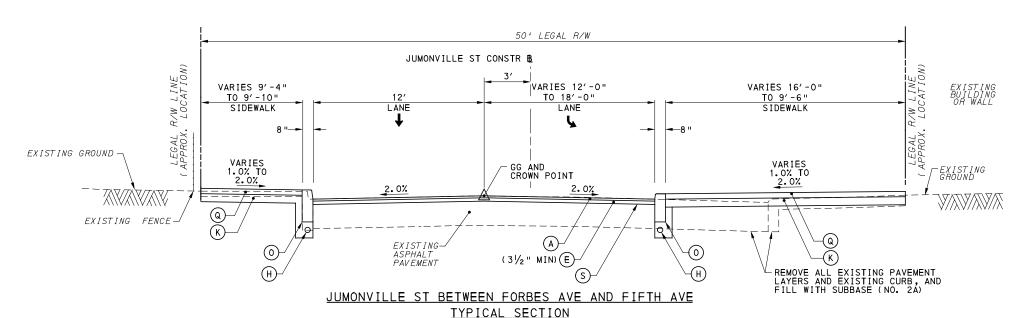

NOT TO SCALE STA 20+00.00 TO STA 20+67.50

### **LEGEND**

- A SUPERPAVE ASPHALT MIXTURE DESIGN, WEARING COURSE, PG 64E-22, 10 TO 50 MILLION ESALS, 9.5 MM MIX, 11/2 " DEPTH, SRL-H
- B) SUPERPAVE ASPHALT MIXTURE DESIGN, WEARING COURSE, PG 64S-22, <0.3, MILLION ESALS, 9.5 MM MIX, 2" DEPTH, SRL-H
- D SUPERPAVE ASPHALT MIXTURE DESIGN, BASE COURSE, PG 64S-22, <0.3 MILLION ESALS, 25.0 MM MIX, 4" DEPTH
- SUPERPAVE ASPHALT MIXTURE DESIGN, BINDER COURSE (LEVELING), PG 64E-22, 10 TO (30 MILLION ESALS, 19.0 MM MIX
- F PLAIN CEMENT CONCRETE PAVEMENT,
- G REINFORCED CEMENT CONCRETE BASE COURSE, 10" DEPTH
- H 4" PAVEMENT BASE DRAIN
- ) SUBBASE (NO. 2A) (MATCH ADJACENT SUBBASE DEPTH) OVER GEOTEXTILE CLASS 4, TYPE A
- J SUBBASE 4" DEPTH (NO. 2A)
- (K) SUBBASE 6" DEPTH (NO. 2A)
- SUBBASE 8" DEPTH (NO. 2A)
  OVER GEOTEXTILE CLASS 4, TYPE A
- M PLAIN CONCRETE MOUNTABLE CURB, TYPE A
- N CONCRETE BUFFER
- O REINFORCED CEMENT CONCRETE CURB
- P GRANITE CURB

- Q REINFORCED CEMENT CONCRETE SIDEWALK, 4" DEPTH
- R MILLING OF CEMENT CONCRETE PAVEMENT SURFACE, 2" DEPTH
- MILLING OF ASPHALT PAVEMENT SURFACE, VARIABLE DEPTH (MILL TO SANDSTONE BLOCK LAYER)
- T MILLING OF ASPHALT PAVEMENT SURFACE, 1 1/2 " DEPTH
- (U) MILLING OF ASPHALT PAVEMENT SURFACE, 2" DEPTH
- MENT TO DIRE
- W REINFORCED CEMENT CONCRETE CURB, 36"
- X CURB CHEEK WALL
- (Y) REMOVE AND RESET INTERLOCKING PAVERS
- (Z) EXPOSED AGGREGATE CONCRETE SIDEWALK, BROWN
- PWSA SIDEWALK TRENCH DRAIN WITH ADA COMPLIANT AND BICYCLE SAFE GRATE
- TT DIRECTIONAL ARROWS

NOTE: ASPHALT TACK COAT IS REQUIRED BETWEEN ALL ASPHALT PAVING COURSES AND ON MILLED SURFACES PRIOR TO PLACING OVERLAY

**AECOM** 

Gulf Tower 707 Grant Street 5th Floor Pittsburgh, PA 15219 GANNETT FLEMING
GANNETT FLEMING, INC.
Foster Plaza 8
Suite 400
730 Holiday Drive
Pittsburgh, PA. 15220

THE PREPARATION OF THIS
DOCUMENT HAS BEEN FINANCED IN
PART THROUGH A GRANT FROM THE
FEDERAL TRANSIT ADMINISTRATION,
U.S. DEPARTMENT OF
TRANSPORTATION, UNDER THE
URBAN MASS TRANSPORTATION OF THE
URBAN MASS TRANSPORTATION OF THE
PORT AUTHORITY OF ALLEGHENY
COUNTY, PENNSYLVANIA.

(NOT FOR CONSTRUCTION)

DESIGNED         RRH           DRAWN         RRH           CHECKED         KCF           IN CHARGE         GEC           DATE         05/01/24           SCALE         O5/01/24			_
CHECKED KCF IN CHARGE GEC  DATE 05/01/24  SCALE	DESIGNED	RRH	
IN CHARGE <u>GEC</u> DATE <u>05/01/24</u> SCALE	DRAWN	RRH	
DATE 05/01/24 SCALE	CHECKED	KCF	
SCALE	IN CHARGE	GEC	_
	DATE	05/01/24	_
	SCALE		

PORT AUTHORITY OF ALLEGHENY COUNTY
PITTSBURGH

BUS RAPID TRANSIT UPTOWN TO OAKLAND
TYPICAL SECTIONS


Port Authority


 MARION ST AND JUMONVILLE ST

 CONTRACT NO. BRT-001


 DWG. NO.
 CV46
 SHT.
 121

DATE 05/01/24
SCALE AS SHOWN

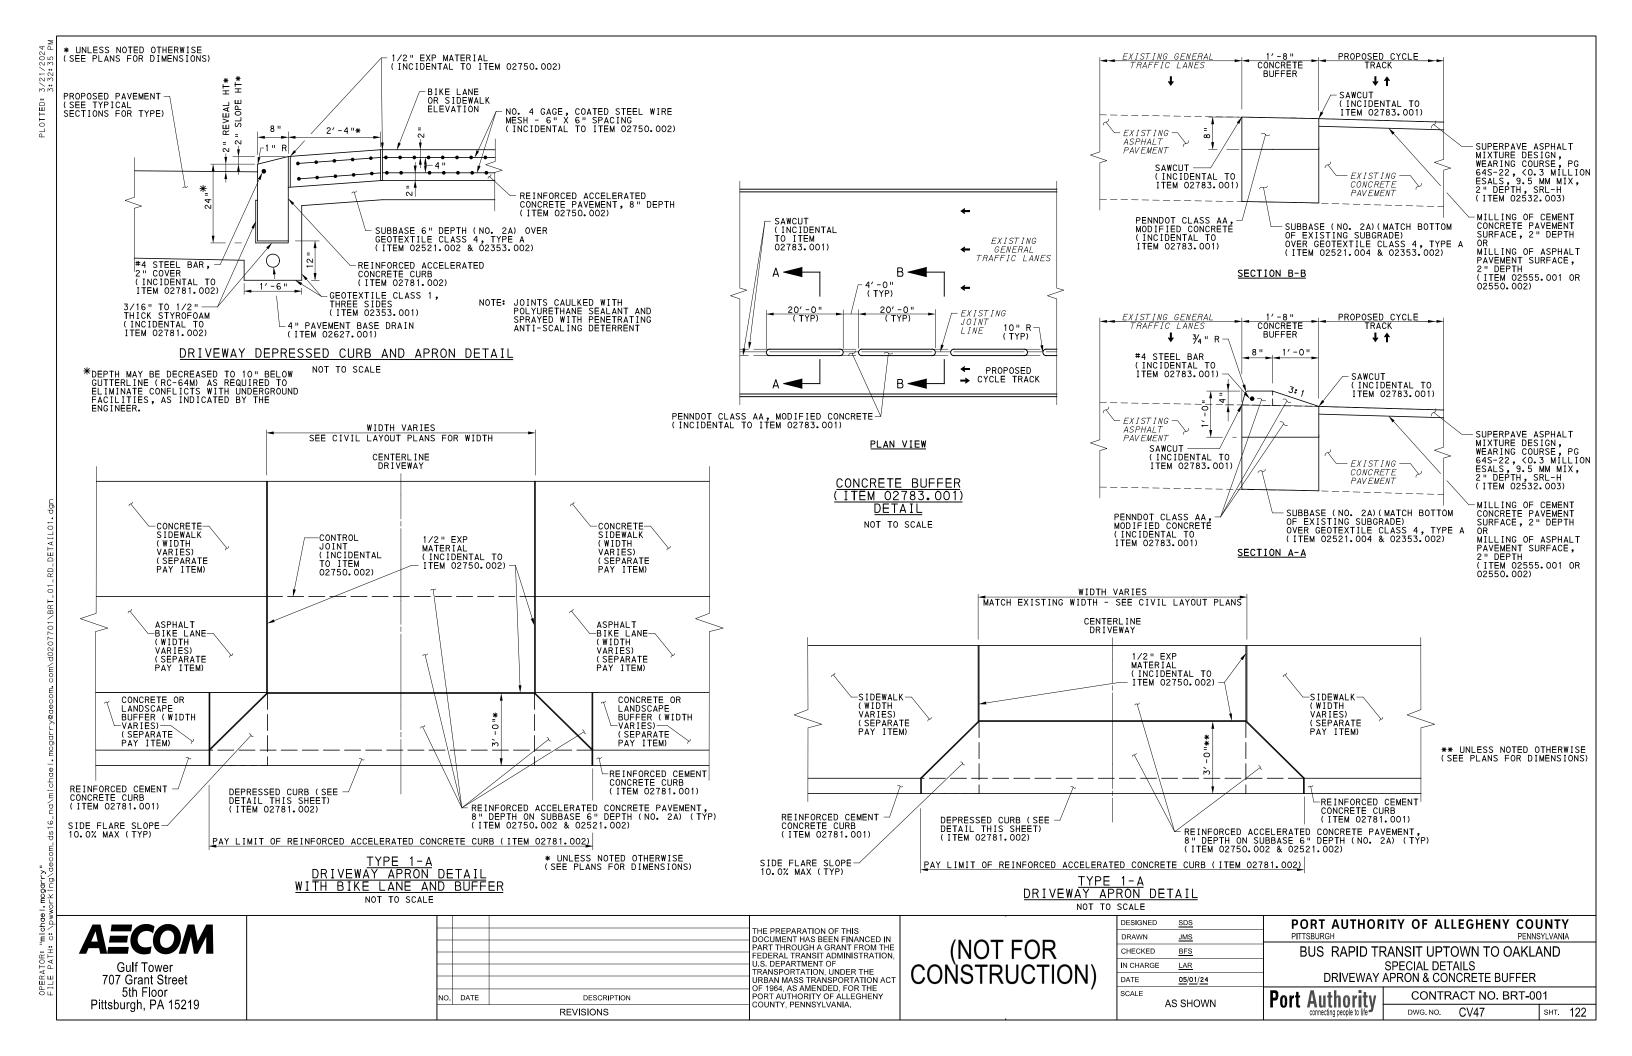

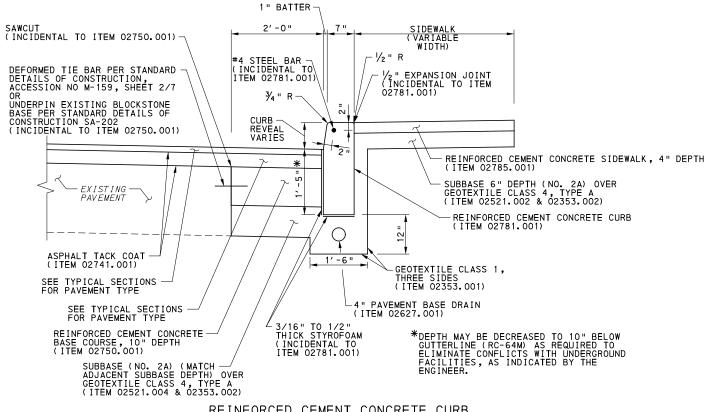


### REINFORCED CEMENT CONCRETE CURB ADJACENT TO PAVEMENT RESTORATION DETAIL NOT TO SCALE

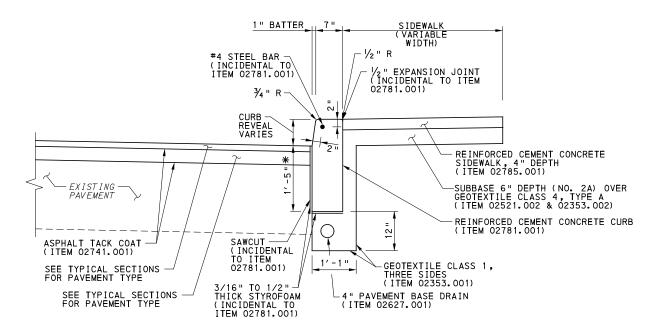


### REINFORCED CEMENT CONCRETE CURBADJACENT TO MILL & OVERLAY DETAIL NOT TO SCALE

FOR USE AT CURB BUMPOUTS WHERE FULL DEPTH PAVEMENT RESTORATION IS NOT POSSIBLE DUE TO MPT RESTRICTIONS AND ALONG PORTIONS OF FORBES AVE DESIGNATED AS A STATE ROUTE

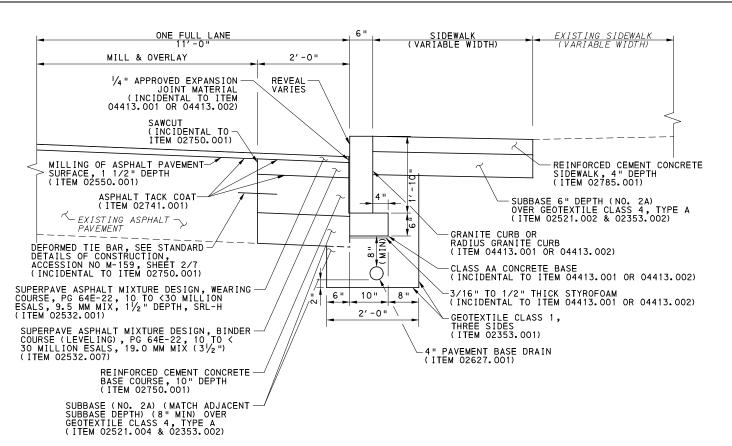

### GRANITE CURB ADJACENT TO COMPOSITE PAVEMENT RESTORATION AND MILL & OVERLAY DETAIL


NOT TO SCALE
FOR USE ON FIFTH AVE BETWEEN DARRAGH ST AND LOTHROP ST, LT

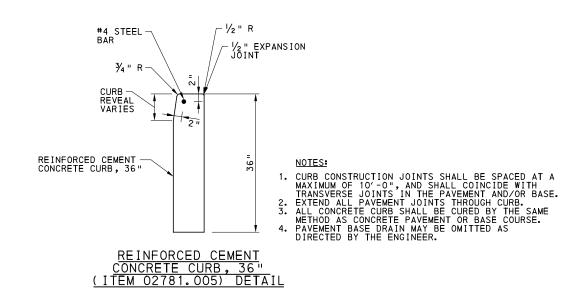

NOT TO SCALE FOR USE AT GI BIORETENTION OR BIOSWALE LOCATIONS SEE STORMWATER MANAGEMENT PLANS (ALSO PLAN) FOR ADDITIONAL DETAIL

## AECOM

707 Grant Street 5th Floor Pittsburgh, PA 15219

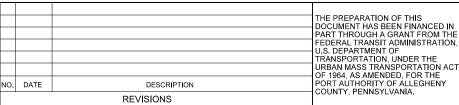

### (NOT FOR CONSTRUCTION)


DESIGNED	SDS	
DRAWN	<u>JMS</u>	
CHECKED	<u>BFS</u>	
IN CHARGE	LAR	
DATE	05/01/24	
SCALE		
	AS SHOWN	

### PORT AUTHORITY OF ALLEGHENY COUNTY BUS RAPID TRANSIT UPTOWN TO OAKLAND

SPECIAL DETAILS CONCRETE AND GRANITE CURB


**Port Authority** 


CONTRACT NO. BRT-001 DWG. NO. CV48 sнт. 123

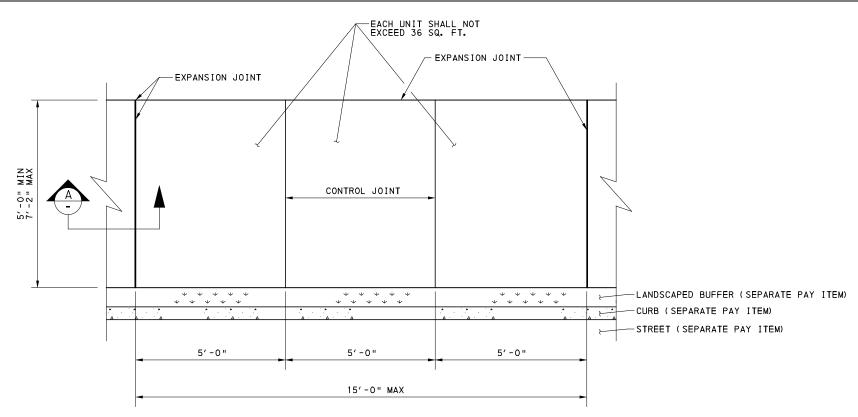

### REINFORCED CONCRETE SIDEWALK, 4" DEPTH DETAIL (ITEM 02785,001)

NOT TO SCALE

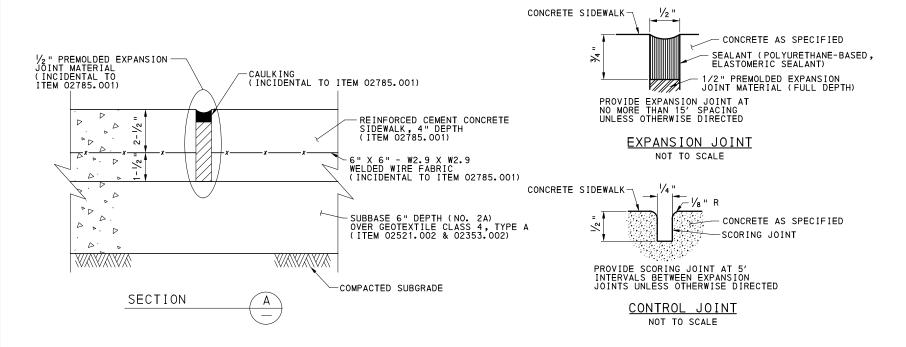

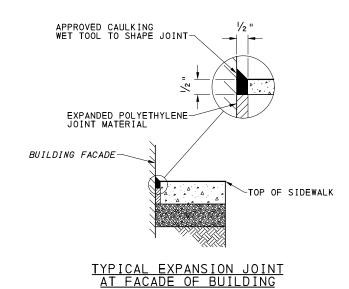

NOT TO SCALE

(NOT FOR CONSTRUCTION)

DESIGNED	<u>SDS</u>	
DRAWN	<u>JMS</u>	
CHECKED	BFS	
IN CHARGE	LAR	
DATE	05/01/24	
SCALE		
	AS SHOWN	

PORT AUTHORITY OF ALLEGHENY COUNTY
PITTSBURGH

RUS RAPID TRANSIT LIPTOWN TO OAKLAND

BUS RAPID TRANSIT UPTOWN TO OAKLAND
SPECIAL DETAILS
REINFORCED CONCRETE SIDEWALK AND JOINTS

sнт. 124


Port Authority CONTRACT NO. BRT-001

DWG. NO. CV49 SI

**AECOM** 

Gulf Tower 707 Grant Street 5th Floor Pittsburgh, PA 15219 THE PREPARATION OF THIS
DOCUMENT HAS BEEN FINANCED IN
PART THROUGH A GRANT FROM THE
FEDERAL TRANSIT ADMINISTRATION,
U.S. DEPARTMENT OF
TRANSPORTATION, UNDER THE
URBAN MASS TRANSPORTATION ACT
OF 1964, AS AMENDED, FOR THE
NO. DATE
DESCRIPTION
REVISIONS

THE PREPARATION OF THIS
FEDERAL TRANSIT ADMINISTRATION, U.S. DEPARTMENT OF
URBAN MASS TRANSPORTATION ACT
OF 1964, AS AMENDED, FOR THE
PORT AUTHORITY OF ALLEGHENY
COUNTY, PENNSYLVANIA.

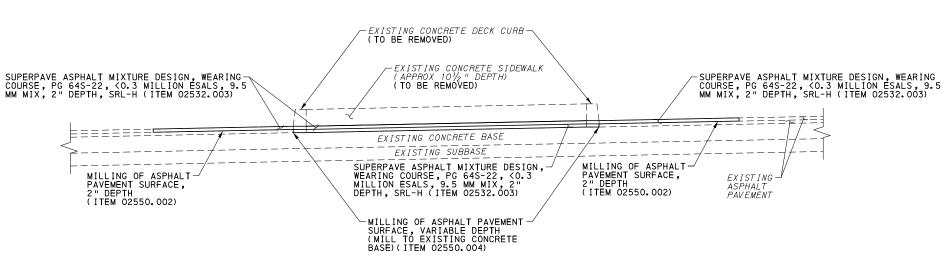

SUPERPAVE ASPHALT MIXTURE DESIGN,
WEARING COURSE, PG 64E-22, 10 TO
<30 MILLION ESALS, 9.5 MM MIX,
1/2 " DEPTH, SRL-H
(ITEM 02532.001)

SIDEWALK
(VARIABLE
WIDTH)

REINFORCED CEMENT CONCRETE
SIDEWALK, 4" DEPTH
(ITEM 02785.001)

SUBBASE 6" DEPTH (NO. 2A)
OVER GEOTEXTILE CLASS 4, TYPE A


PARKING LOT PAVEMENT PATCH


NOT TO SCALE

EXISTING ISLAND TO BE REMOVED DETAIL

(SEE ROADWAY PLANS FOR LOCATIONS)

NOT TO SCALE

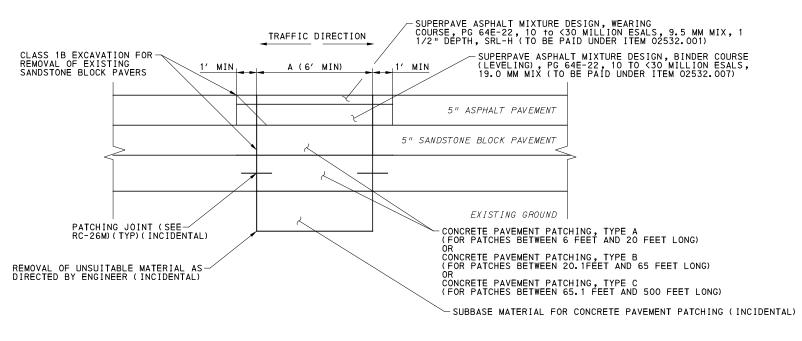

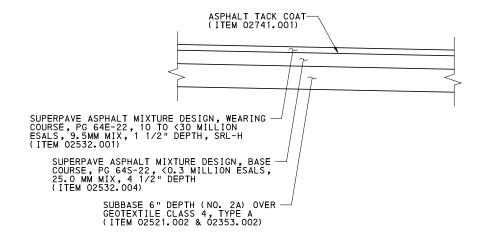

KIRKPATRICK ST PARKING
LOT PAVEMENT DETAIL
NOT TO SCALE

## ACCELERATED CONCRETE PAVEMENT PATCHING (ITEM 02755.001) (AS DIRECTED) NOT TO SCALE



			THE DREDADATION OF THE
			THE PREPARATION OF THIS DOCUMENT HAS BEEN FINANCED IN
			PART THROUGH A GRANT FROM THE
			FEDERAL TRANSIT ADMINISTRATION, U.S. DEPARTMENT OF
			TRANSPORTATION, UNDER THE
			URBAN MASS TRANSPORTATION ACT OF 1964, AS AMENDED, FOR THE
ο.	DATE	DESCRIPTION	PORT AUTHORITY OF ALLEGHENY COUNTY, PENNSYLVANIA.
		REVISIONS	COUNTY, PENNSTEVANIA.

(NOT FOR CONSTRUCTION)

DESIGNED	<u>SDS</u>	
DRAWN	<u>JMS</u>	
CHECKED	<u>BFS</u>	
IN CHARGE	LAR	
DATE	05/01/24	
SCALE		
	AS SHOWN	

## PORT AUTHORITY OF ALLEGHENY COUNTY PITTSBURGH PENNSYLVANIA BUS RAPID TRANSIT UPTOWN TO OAKLAND

SPECIAL DETAILS


ISLAND REMOVAL / PAVEMENT PATCHING

Port Authority |

CONTRACT NO. BRT-001

DWG. NO. CV50 SHT. 125



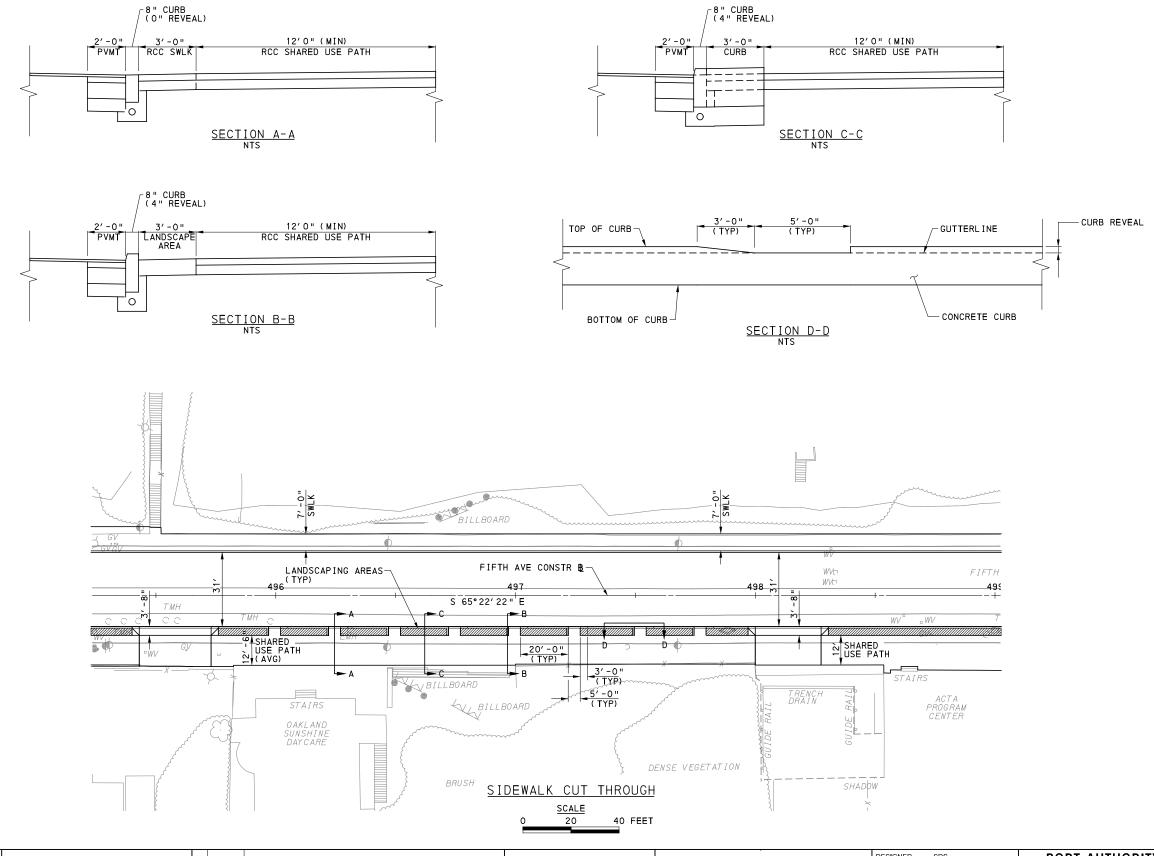

**AECOM** 

**Gulf Tower** 707 Grant Street 5th Floor Pittsburgh, PA 15219

THE PREPARATION OF THIS
DOCUMENT HAS BEEN FINANCED IN
PART THROUGH A GRANT FROM THE
FEDERAL TRANSIT ADMINISTRATION, PEDERAL TRANSIT ADMINISTRATION,
U.S. DEPARTMENT OF
TRANSPORTATION, UNDER THE
URBAN MASS TRANSPORTATION ACT
OF 1964, AS AMENDED, FOR THE
PORT AUTHORITY OF ALLEGHENY
COUNTY, PENNSYLVANIA. NO. DATE DESCRIPTION REVISIONS

(NOT FOR CONSTRUCTION)

DESIGNED	SDS	
DRAWN	<u>JMS</u>	L
CHECKED	BFS	
IN CHARGE	LAR	
DATE	05/01/24	
SCALE		ī
	AS SHOWN	


PORT AUTHORITY OF ALLEGHENY COUNTY

BUS RAPID TRANSIT UPTOWN TO OAKLAND SPECIAL DETAILS SIDEWALK CUT THROUGH


**Port Authority** 


CONTRACT NO. BRT-001

CV51 DWG. NO. sнт. 126

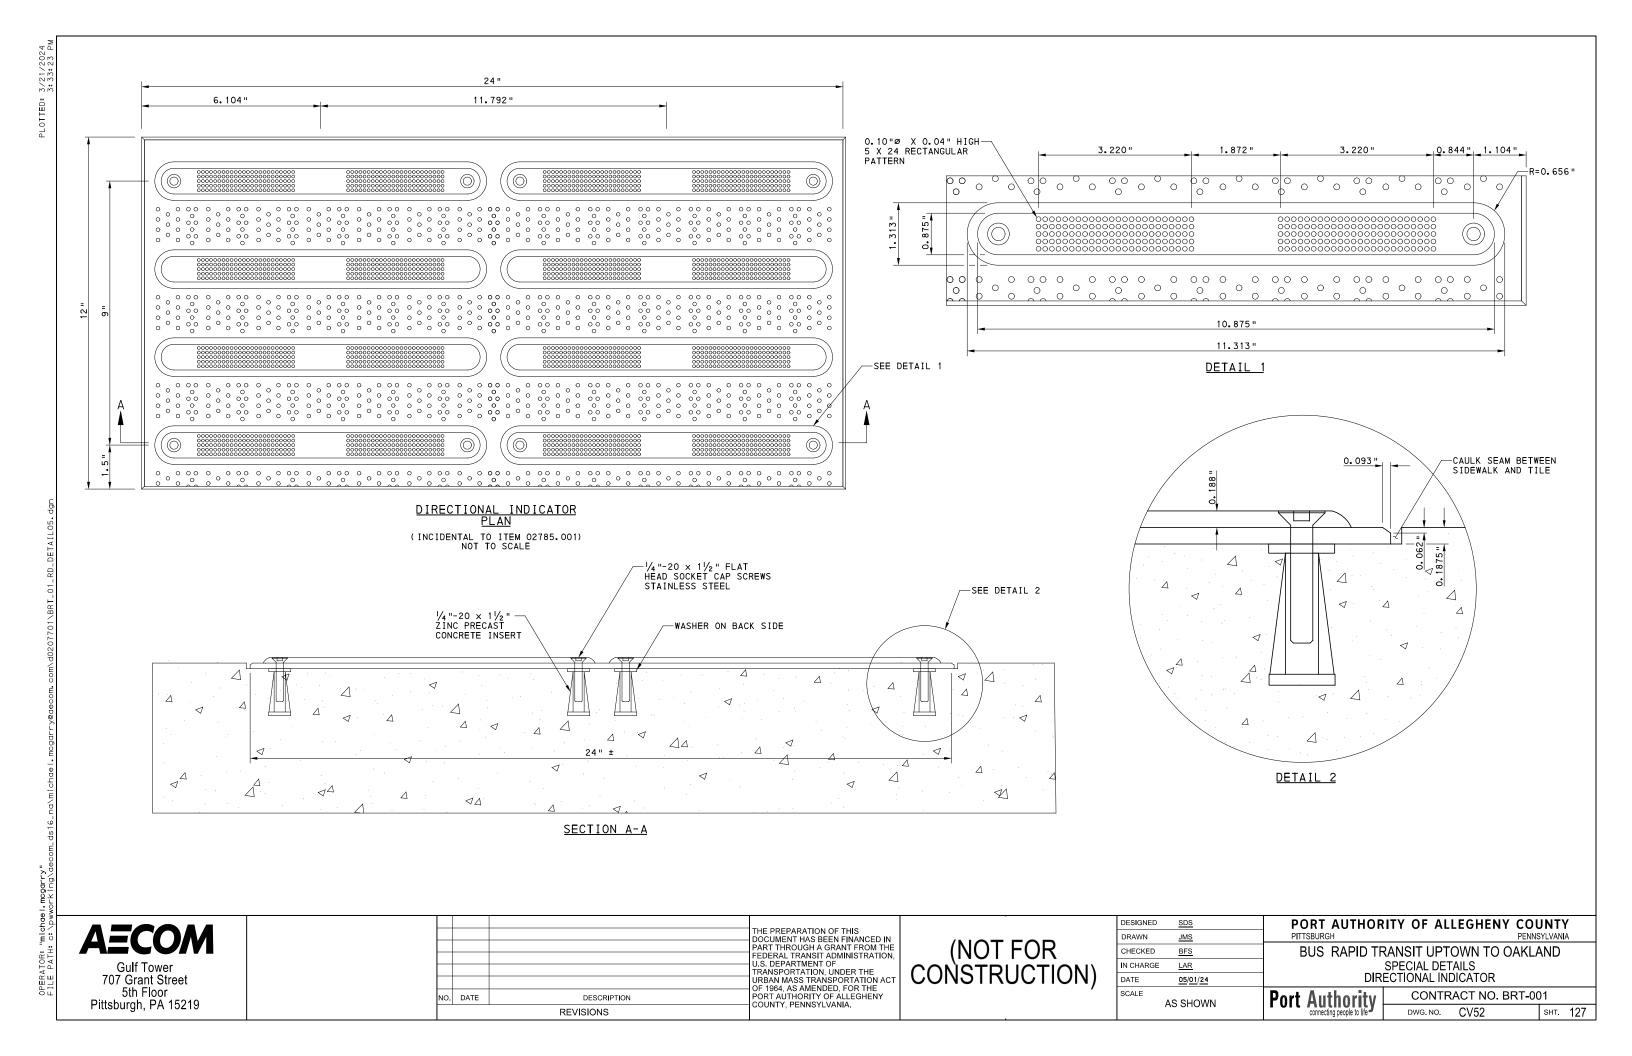




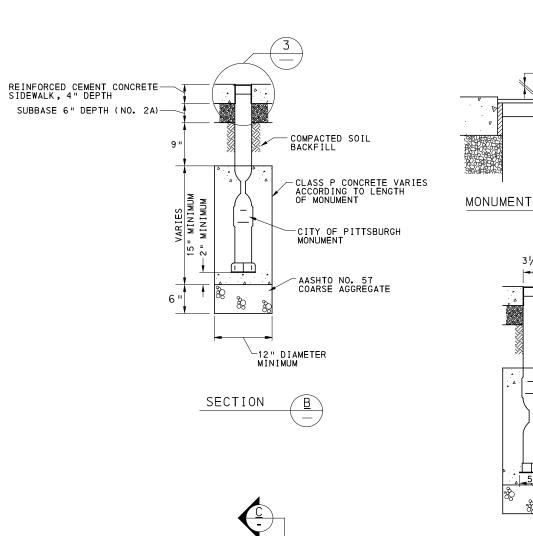

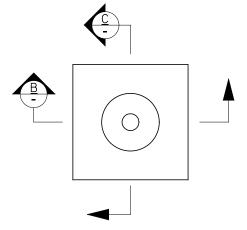


CITY OF PITTSBURGH SURVEY MONUMENT

NOT TO SCALE

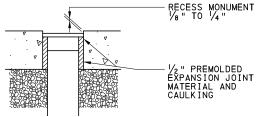



MONUMENT TOP DETAIL

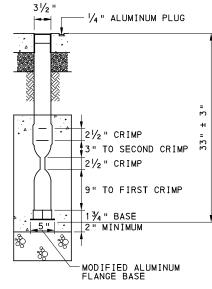

NOTE:
ALL DIMENSIONS SHOWN FOR CITY OF PITTSBURGH
SURVEY MONUMENT ARE APPROXIMATE. THE ACTUAL
MONUMENT THE CITY OF PITTSBURGH IS TO PROVIDE
MAY VARY.

SECTION

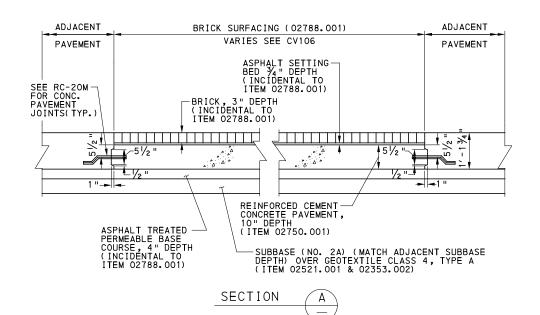

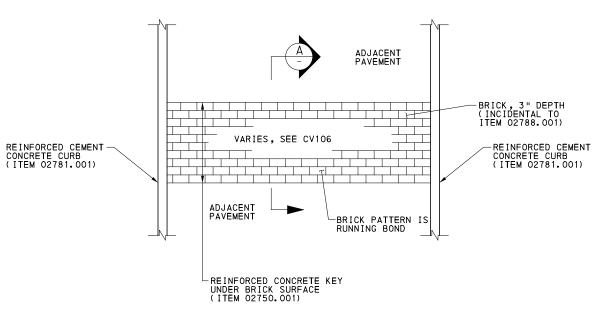

### BRICK SURFACING DETAIL (ITEM 02788.001)

NOT TO SCALE

<b>AECOM</b>	
--------------	--

Gulf Tower 707 Grant Street 5th Floor Pittsburgh, PA 15219

		THE PREPARATION OF THIS DOCUMENT HAS BEEN FINANCED IN
		PART THROUGH A GRANT FROM THE
		FEDERAL TRANSIT ADMINISTRATION, U.S. DEPARTMENT OF
		TRANSPORTATION, UNDER THE
		URBAN MASS TRANSPORTATION ACT OF 1964, AS AMENDED, FOR THE
DATE	DESCRIPTION	PORT AUTHORITY OF ALLEGHENY COUNTY, PENNSYLVANIA.
	REVISIONS	COUNTY, PENNSTEVANIA.

(NOT FOR CONSTRUCTION)

DESIGNED	<u>SDS</u>	
DRAWN	<u>JMS</u>	
CHECKED	BFS	
IN CHARGE	LAR	
DATE	05/01/24	
SCALE		
	AS SHOWN	

## PORT AUTHORITY OF ALLEGHENY COUNTY PENNSYLVANIA

BUS RAPID TRANSIT UPTOWN TO OAKLAND SPECIAL DETAILS SURVEY MONUMENT & BRICK SURFACING

Port	Authority	CON
	connecting people to life	DWG. N

CONTRACT NO. BRT-001

DWG. NO. CV53 SHT. 128

#### SUBGRADE UNDERCUT DETAIL NOT TO SCALE

#### SUBGRADE UNDERCUT, AS SPECIFIED (ITEM 02341.001)

APPLIED LOCATION:

FIFTH AVENUE: STA 440+91 TO STA 449+17 LT


#### SUBGRADE UNDERCUT, AS DIRECTED (ITEM 02341.002)

APPLIED LOCATION:

AS DIRECTED

#### NOTES:


- 1. PERFORM SPECIAL ROLLING TO DETERMINE WEAK SUBGRADE AREAS, SECTION 02342.
- PERFORM UNDERCUTTING EXCAVATION AS DIRECTED BY ENGINEER. DEPTH OF UNDERCUT 1 FOOT IN ACCORDANCE WITH THIS ITEM AND AS DIRECTED.
- 3. GEOTEXTILE, CLASS 4 TYPE C TO BE USED WITH PERMANENT DEFLECTIONS FROM 0.5 TO 3 INCHES.
- 4. USE GEOGRID, CLASS 3, TYPE B SUCH AS TENSAR BIAXIAL GEOGRID BX 1500 (OR EQUAL) FOR AS DIRECTED LOCATIONS WITH PERMANENT DEFLECTION GREATER THAN 3 INCHES.
- 5. PLACE APPROVED COARSE AGGREGATE IN 8" MAX LIFTS.
- 6. GEOTEXTILE, CLASS 4 TYPE A TO BE USED FOR LAYER SEPARATION.
- 7. 8" OF APPROVED COARSE AGGREGATE OR 6" OF SUBBASE MATERIAL IS TO BE IN PLACE ON GEOTEXTILE OR GEOGRID BEFORE PERMITTING COMPACTION.

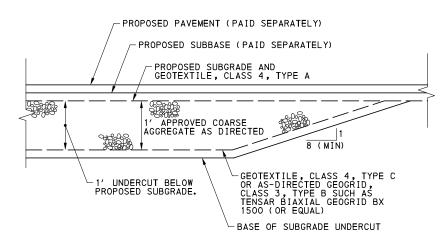


### SUBGRADE UNDERCUT TRANSITION DETAIL

NOT TO SCALE

USE TRANSITION DETAIL AT EACH END OF SUBGRADE UNDERCUT (ITEM 02341.001), AS DIRECTED.

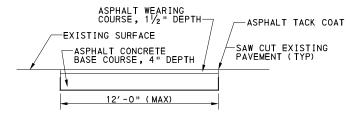

### SIDEWALK TRENCH RESTORATION PIPE INSTALLATION, TEMPORARY NOT TO SCALE INCIDENTAL TO TRENCH RESTORATION 02615.001

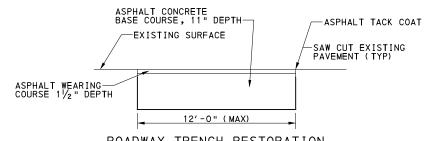

ROADWAY TRENCH RESTORATION (PIPE INSTALLATION), TEMPORARY NOT TO SCALE INCIDENTAL TO TRENCH RESTORATION 02615.001

AECOM

THE PREPARATION OF THIS DOCUMENT HAS BEEN FINANCED IN PART THROUGH A GRANT FROM THE FEDERAL TRANSIT ADMINISTRATION U.S. DEPARTMENT OF TRANSPORTATION, UNDER THE URBAN MASS TRANSPORTATION ACT OF 1964, AS AMENDED, FOR THE PORT AUTHORITY OF ALLEGHENY COUNTY, PENNSYLVANIA.

(NOT FOR CONSTRUCTION)

DESIGNED	SDS
DRAWN	<u>JMS</u>
CHECKED	<u>BFS</u>
IN CHARGE	LAR
DATE	05/01/24
SCALE	

PORT AUTHORITY OF ALLEGHENY COUNTY

BUS RAPID TRANSIT UPTOWN TO OAKLAND SPECIAL DETAILS SUBGRADE UNDERCUT / TRENCH RESTORATION


**Port Authority** 

CONTRACT NO. BRT-001 DWG. NO. CV54 sнт. 129


707 Grant Street 5th Floor Pittsburgh, PA 15219 NO. DATE DESCRIPTION

REVISIONS

AS SHOWN

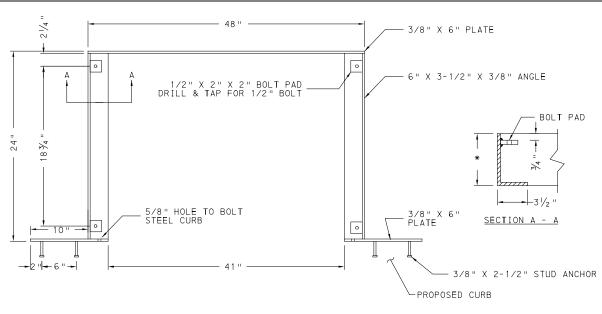


- 1.) ALL MATERIAL SHALL BE HOT ROLLED STEEL.
- 2.) FRAME SHALL BE HOT DIP GALVANIZED PER ASTM A123 AFTER FABRICATION.
- 3.) COVER SHALL BE BOLTED TO FRAME WITH FOUR 1/2"-13 STAINLESS STEEL PENTA-HEAD BOLTS. CURB SHALL BE BOLTED TO FRAME WITH FOUR 1/2"-13 STAINLESS STEEL HEX-HEAD BOLTS.
- \* VARIES BY ADJACENT CURB REVEAL

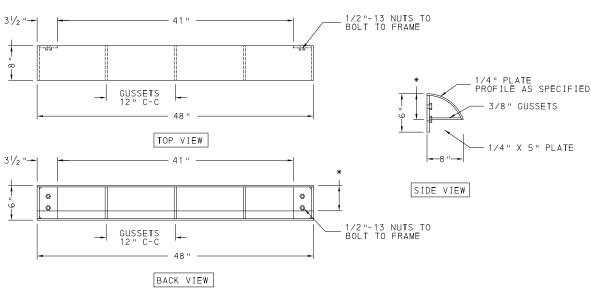


- 1.) ALL MATERIAL SHALL BE HOT ROLLED STEEL.
- 2.) CURB SHALL BE HOT DIP GALVANIZED PER ASTM A123 AFTER FABRICATION.
- 3.) CURB SHALL BE BOLTED TO FRAME WITH FOUR  $1/2\,\text{"--}13$  STAINLESS STEEL HEX-HEAD BOLTS.
- 4.) THIS UNIT DESIGNED TO WITHSTAND H20 WHEEL LOADS WHERE NOT SUBJECT TO HIGH DENSITY TRAFFIC.
- \* VARIES BY ADJACENT CURB REVEAL

### REMOVABLE CURB NOT TO SCALE

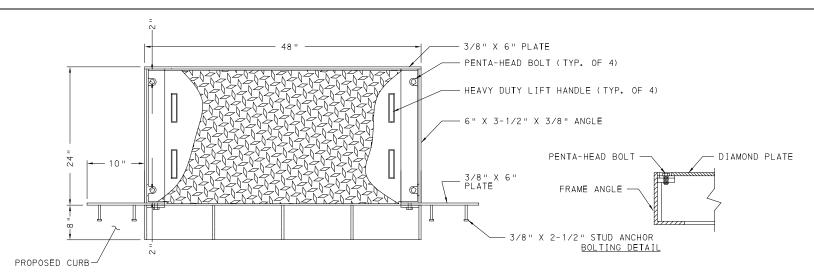

- 1.) ALL MATERIAL SHALL BE HOT ROLLED STEEL. BEARING BARS FOR COVER SHALL CONFORM TO ASTM A572 GR. 50.
- 2.) COMPLETE UNIT SHALL BE HOT DIP GALVANIZED PER ASTM A123 AFTER FABRICATION.
- 3.) COVER SHALL BE BOLTED TO FRAME WITH FOUR 1/2"-13 STAINLESS STEEL PENTA-HEAD BOLTS. CURB SHALL BE BOLTED TO FRAME WITH FOUR 1/2"-13 STAINLESS STEEL HEX-HEAD BOLTS.
- 4.) THIS COVER DESIGNED TO WITHSTAND HS20 WHEEL LOADS WHERE NOT SUBJECT TO HIGH DENSITY TRAFFIC.

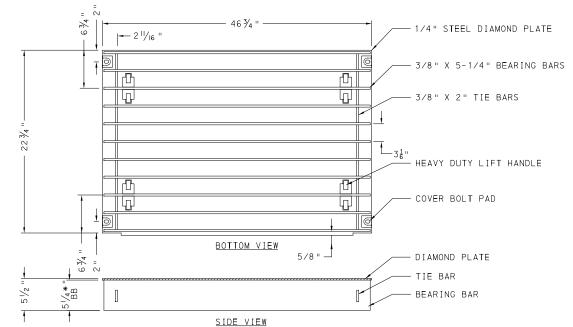

#### NOTES:

- 1.) ALL MATERIAL SHALL BE HOT ROLLED STEEL. BEARING BARS SHALL CONFORM TO ASTM A572 GR. 50.
- 2.) COVER SHALL BE HOT DIP GALVANIZED PER ASTM A123 AFTER FABRICATION.
- 3.) COVER SHALL BE BOLTED TO FRAME WITH FOUR  $1/2\,\text{"--}13$  STAINLESS STEEL PENTA-HEAD BOLTS.
- 4.) THIS COVER DESIGNED TO WITHSTAND HS20 WHEEL LOADS WHERE NOT SUBJECT TO HIGH DENSITY TRAFFIC.

## AECOM

707 Grant Street 5th Floor Pittsburgh, PA 15219

			THE PREPARATION OF THI DOCUMENT HAS BEEN FIN PART THROUGH A GRANT
			FEDERAL TRANSIT ADMINIS U.S. DEPARTMENT OF
			TRANSPORTATION, UNDEF URBAN MASS TRANSPORT OF 1964, AS AMENDED, FO
NO.	DATE	DESCRIPTION	PORT AUTHORITY OF ALLECTION OF
		REVISIONS	COUNTY, PENNSTEVANIA.

ON OF THIS BEEN FINANCED IN I A GRANT FROM THE SIT ADMINISTRATION, ON, UNDER THE RANSPORTATION ACT ENDED, FOR THE
TY OF ALLEGHENY

(NOT FOR CONSTRUCTION)


DESIGNED	<u>ss</u>	
DRAWN	<u>JMS</u>	
CHECKED	<u>ss</u>	
IN CHARGE	LAR	
DATE	05/01/24	
SCALE		
	AS SHOWN	


## PORT AUTHORITY OF ALLEGHENY COUNTY

BUS RAPID TRANSIT UPTOWN TO OAKLAND SPECIAL DETAILS REMOVABLE CURB

**Port Authority** 


CONTRACT NO. BRT-001 CV55 sнт. 130 DWG. NO.

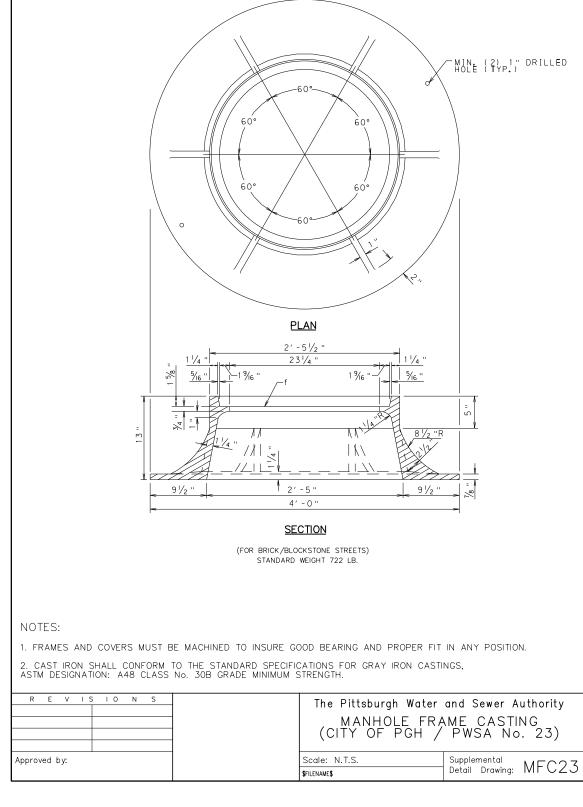

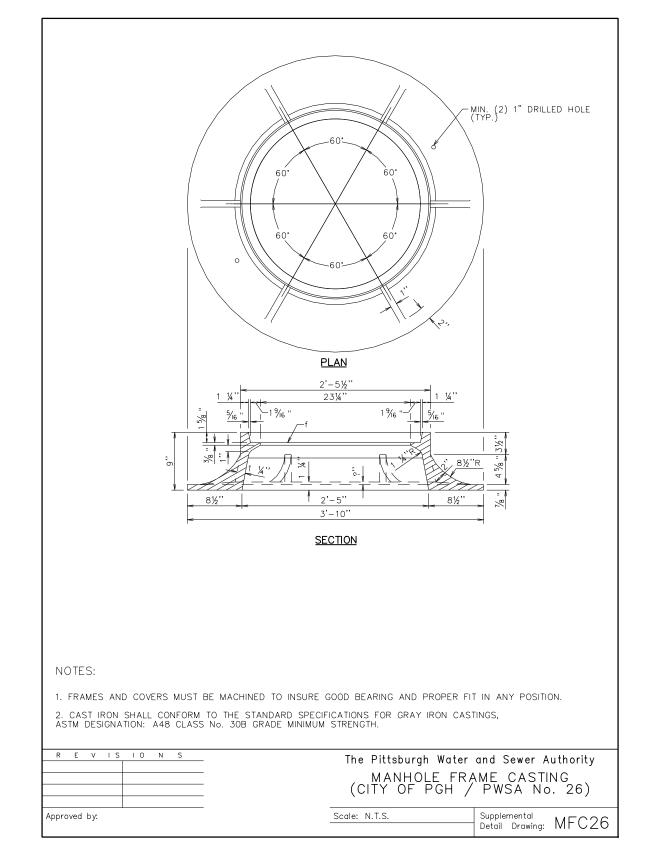



Gulf Tower 707 Grant Street 5th Floor Pittsburgh, PA 15219

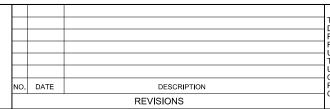

THE PREPARATION OF THIS
DOCUMENT HAS BEEN FINANCED IN
PART THROUGH A GRANT FROM THE
FEDERAL TRANSIT ADMINISTRATION,
U.S. DEPARTMENT OF
TRANSPORTATION, UNDER THE
URBAN MASS TRANSPORTATION ACT
OF 1964, AS AMENDED, FOR THE
PORT AUTHORITY OF ALLEGHENY
COUNTY, PENNSYLVANIA.

# (NOT FOR CONSTRUCTION)

DESIGNED	<u>JMS</u>	
DRAWN	<u>JMS</u>	
CHECKED	DJC	
IN CHARGE	<u>LAR</u>	
DATE	05/01/24	
SCALE		
	AS SHOWN	


### PORT AUTHORITY OF ALLEGHENY COUNTY


BUS RAPID TRANSIT UPTOWN TO OAKLAND SPECIAL DETAILS PWSA - MANHOLE FRAME CASTINGS

Port Authority CONTRAC

CONTRACT NO. BRT-001


DWG. NO. CV56 SHT. 131

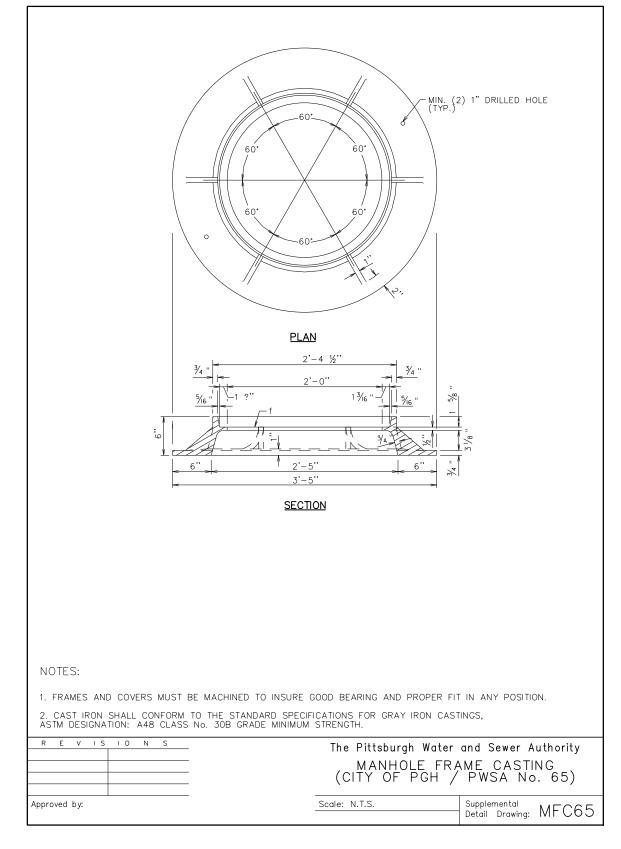

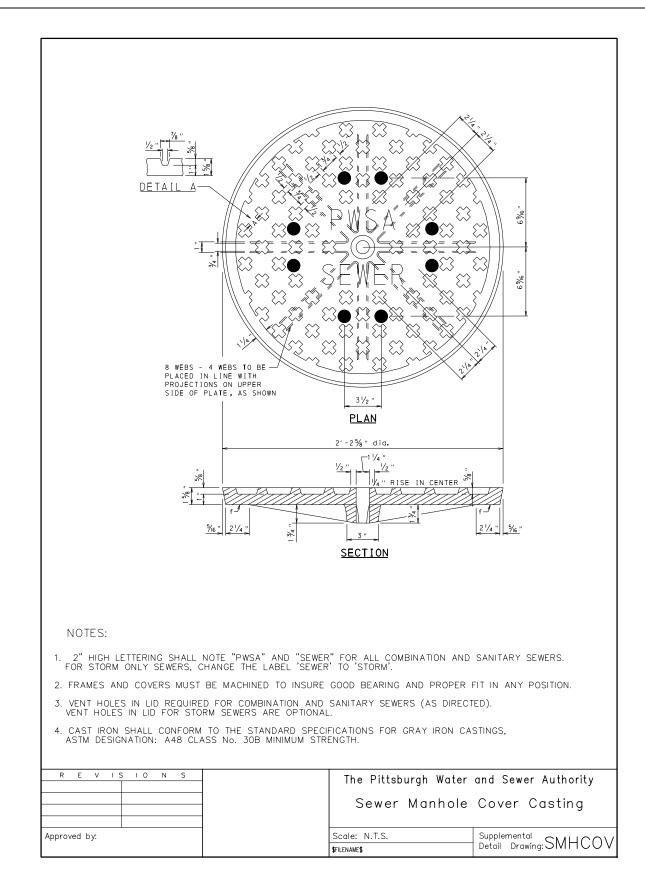



707 Grant Street 5th Floor Pittsburgh, PA 15219

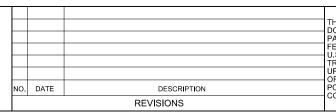

THE PREPARATION OF THIS DOCUMENT HAS BEEN FINANCED IN PART THROUGH A GRANT FROM THE FEDERAL TRANSIT ADMINISTRATION, U.S. DEPARTMENT OF TRANSPORTATION, UNDER THE URBAN MASS TRANSPORTATION ACT OF 1964, AS AMENDED, FOR THE PORT AUTHORITY OF ALLEGHENY COUNTY, PENNSYLVANIA.

# (NOT FOR CONSTRUCTION)

DESIGNED	<u>JMS</u>	
DRAWN	<u>JMS</u>	
CHECKED	DJC	
IN CHARGE	LAR	
DATE	05/01/24	
SCALE		
	AS SHOWN	


### PORT AUTHORITY OF ALLEGHENY COUNTY


BUS RAPID TRANSIT UPTOWN TO OAKLAND SPECIAL DETAILS PWSA - MANHOLE FRAME & COVER CASTINGS

**Port Authority** 

CONTRACT NO. BRT-001


DWG. NO. CV57 sнт. 132

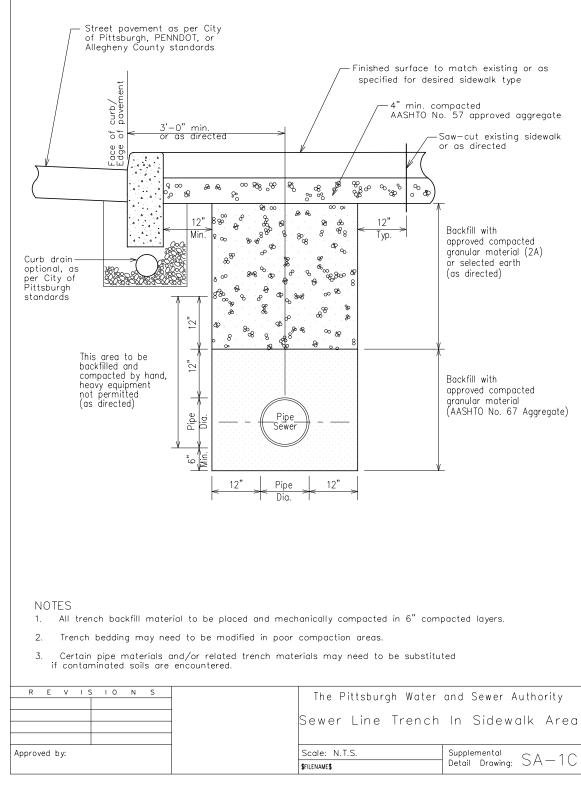

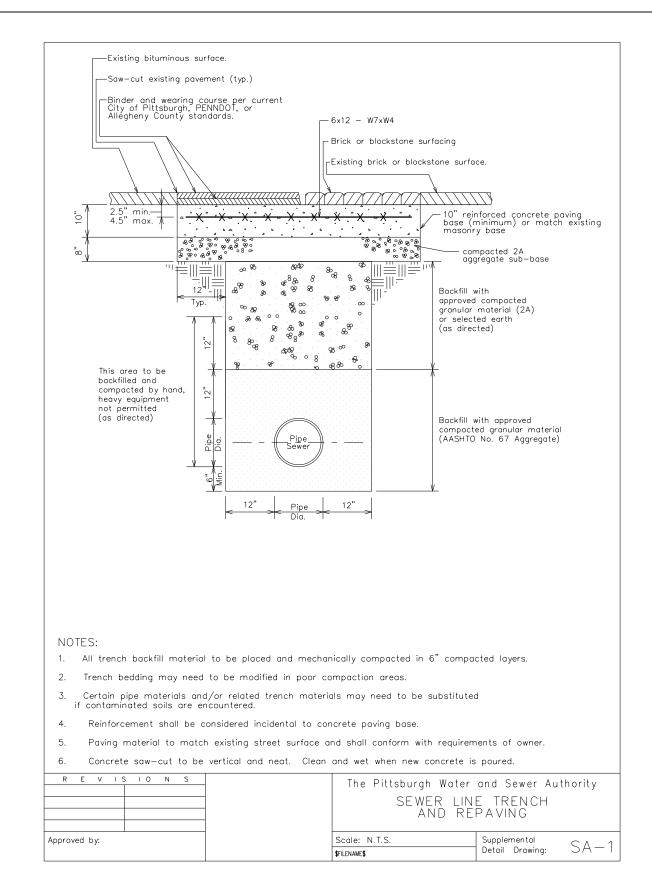



707 Grant Street 5th Floor Pittsburgh, PA 15219

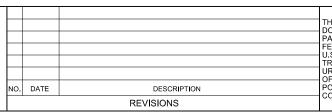

THE PREPARATION OF THIS DOCUMENT HAS BEEN FINANCED IN PART THROUGH A GRANT FROM THE FEDERAL TRANSIT ADMINISTRATION, U.S. DEPARTMENT OF TRANSPORTATION, UNDER THE URBAN MASS TRANSPORTATION ACT OF 1964, AS AMENDED, FOR THE PORT AUTHORITY OF ALLEGHENY COUNTY, PENNSYLVANIA.

# (NOT FOR CONSTRUCTION)

DESIGNED	<u>JMS</u>	
DRAWN	<u>JMS</u>	
CHECKED	DJC	
IN CHARGE	<u>LAR</u>	
DATE	05/01/24	
SCALE		
	AS SHOWN	

### PORT AUTHORITY OF ALLEGHENY COUNTY PITTSBURGH


BUS RAPID TRANSIT UPTOWN TO OAKLAND SPECIAL DETAILS PWSA - TRENCH IN SIDEWALK & TRENCH REPAVING

**Port Authority** 

CONTRACT NO. BRT-001

DWG. NO. CV58 sнт. **133** 

### CONCRETE ENCASEMENT REINFORCEMENTCONCRETE CRADLE REINFORCEMENT

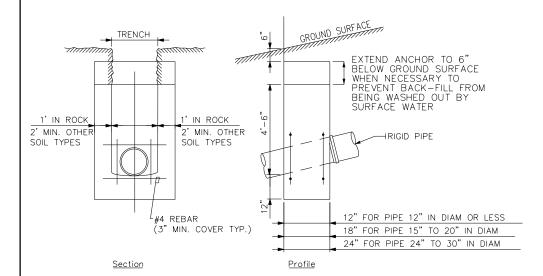

**CONCRETE ANCHORS** 

#### NOTES:


- CEMENT CONCRETE REINFORCEMENT SHALL BE MINIMUM 28 DAY, VIBRATED, 4000# AIR-ENTRAINED.
- 2. DETAILS SHOWN ARE FOR MINIMUM GENERAL CONDITIONS. SPECIFIC CERTAIN SOIL CONDITIONS MAY REQUIRE ADDITIONAL ENGINEERING REINFORCEMENT DESIGN.
- 3. CONCRETE ANCHORS FOR RIGID PIPE ON STEEP GRADES:
  PROVIDE NO ANCHORS ON GRADES LESS THAN 24%
  PROVIDE ANCHORS 36' c. TO c. ON GRADES BETWEEN 24% AND 34%
  PROVIDE ANCHORS 24' c. TO c. ON GRADES BETWEEN 34% AND 50%
  PROVIDE ANCHORS 16' c. TO c. ON GRADES BETWEEN 50% AND 70%
  FOR CONDITIONS OTHER THAN SHOWN HERE, ANCHORS SHALL BE PROVIDED
  AS REQUIRED BY THE CONTRACT PLANS OR AS ORDERED IN THE FIELD BY
  THE DIRECTOR.

	S	N	10	ΙS	٧	Ε	R
PGHAC							
Pittsburgh							
Pittsburgh Water & Sewer							
Authority					by:	oved	Appr

The Pittsburgh Water and Sewer Authority

Concrete Reinforcement For Rigid Pipe


Scale: N.T.S.	Supplemental WC CF
	Detail Drawing: VV5—CE

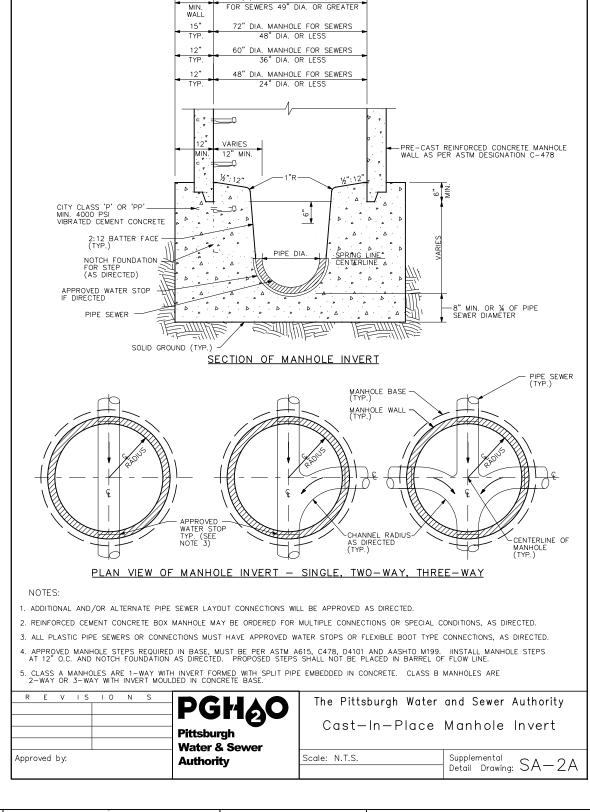

R.C. BOX MANHOLE REQUIRED

## **AECOM**

Gulf Tower 707 Grant Street 5th Floor Pittsburgh, PA 15219

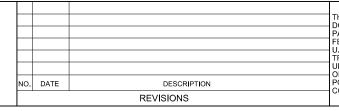

THE PREPARATION OF THIS
DOCUMENT HAS BEEN FINANCED IN
PART THROUGH A GRANT FROM THE
FEDERAL TRANSIT ADMINISTRATION,
U.S. DEPARTMENT OF
TRANSPORTATION, UNDER THE
URBAN MASS TRANSPORTATION ACT
OF 1964, AS AMENDED, FOR THE
PORT AUTHORITY OF ALLEGHENY
COUNTY, PENNSYLVANIA.

(NOT FOR CONSTRUCTION)

DESIGNED	<u>JMS</u>	
DRAWN	<u>JMS</u>	
CHECKED	DJC	
IN CHARGE	<u>LAR</u>	
DATE	05/01/24	
SCALE		
	AS SHOWN	

### PORT AUTHORITY OF ALLEGHENY COUNTY PENNSYLVANIA


BUS RAPID TRANSIT UPTOWN TO OAKLAND SPECIAL DETAILS PWSA - PIPE REINFORCEMENT & CIP MH INVERT


Port Authority |

CONTRACT NO. BRT-001

DWG. NO. CV59 SHT. 134



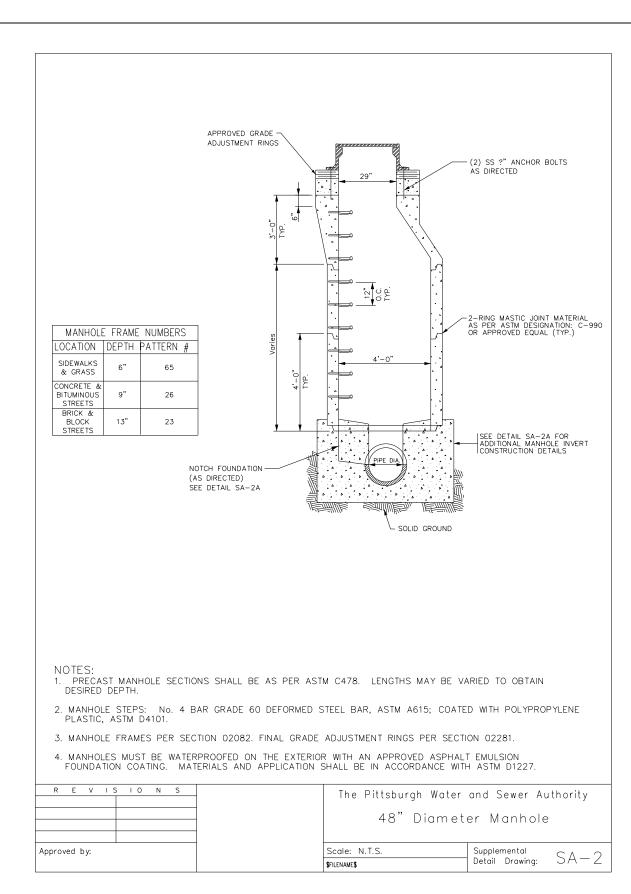

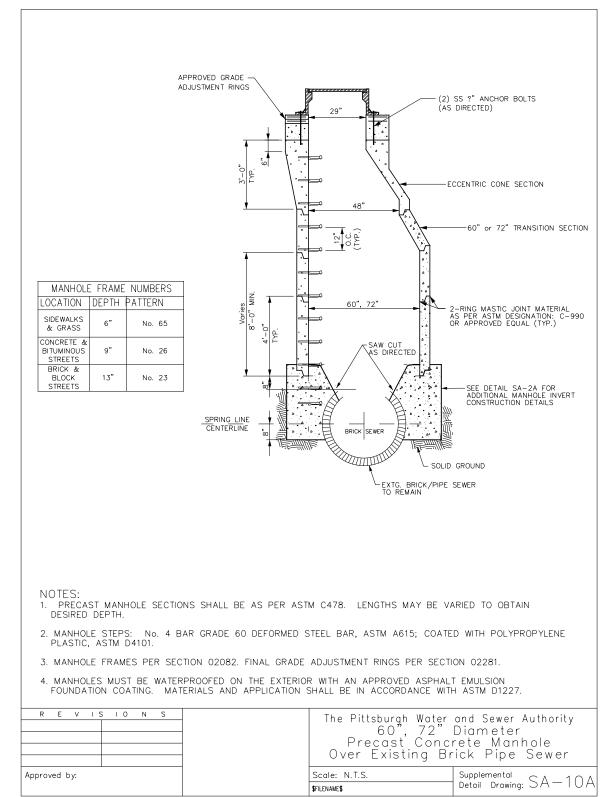

NOTE: SA-10A TO BE PAID UNDER ITEM 20633.007 PWSA DOGHOUSE MANHOLE

S BEEN FINANCED IN H A GRANT FROM THE (NOT FOR CONSTRUCTION) ISIT ADMINISTRATION, RANSPORTATION ACT


DESIGNED	<u>JMS</u>	PORT AUTHOR	ITY OF ALLEGHENY O	OUNTY	
DRAWN	<u>JMS</u>	PITTSBURGH	P	ENNSYLVANIA	
CHECKED	DJC	BUS RAPID TF	RANSIT UPTOWN TO OA	KLAND	
IN CHARGE	LAR	SPECIAL DETAILS			
DATE	05/01/24	PWSA - MANHOLES			
SCALE AS SHOWN		Port Authority CONTRACT NO. BRT-001		Γ-001	
	AS SHOWIN	connecting people to life	DWG. NO. CV60	SHT.	


sнт. **135** 


AECOM

707 Grant Street 5th Floor Pittsburgh, PA 15219

			THE PREPARATION OF THIS DOCUMENT HAS BEEN FINANCED PART THROUGH A GRANT FROM T FEDERAL TRANSIT ADMINISTRATI
			U.S. DEPARTMENT OF TRANSPORTATION, UNDER THE URBAN MASS TRANSPORTATION
			OF 1964. AS AMENDED, FOR THE
٥.	DATE	DESCRIPTION	PORT AUTHORITY OF ALLEGHENY COUNTY, PENNSYLVANIA.
		REVISIONS	COUNTY, FERNOTEVANIA.

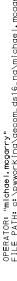


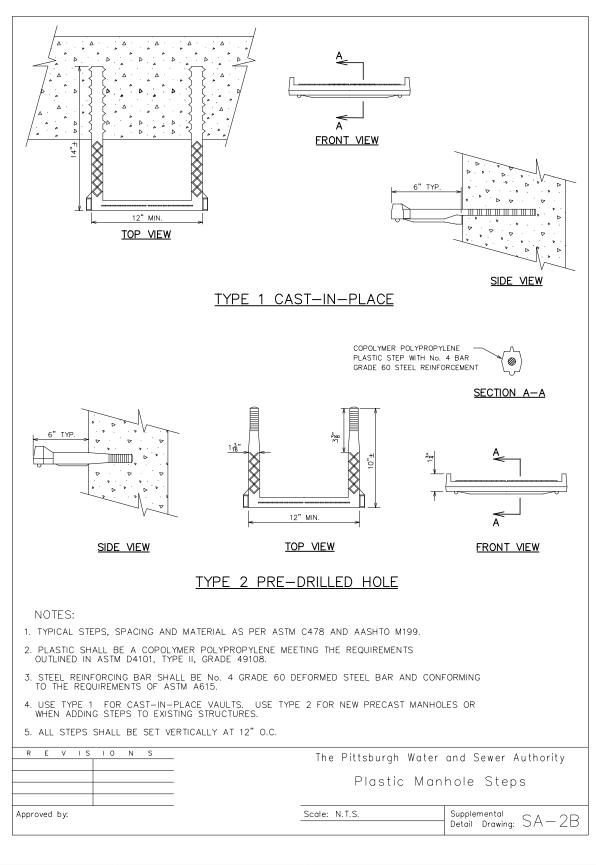

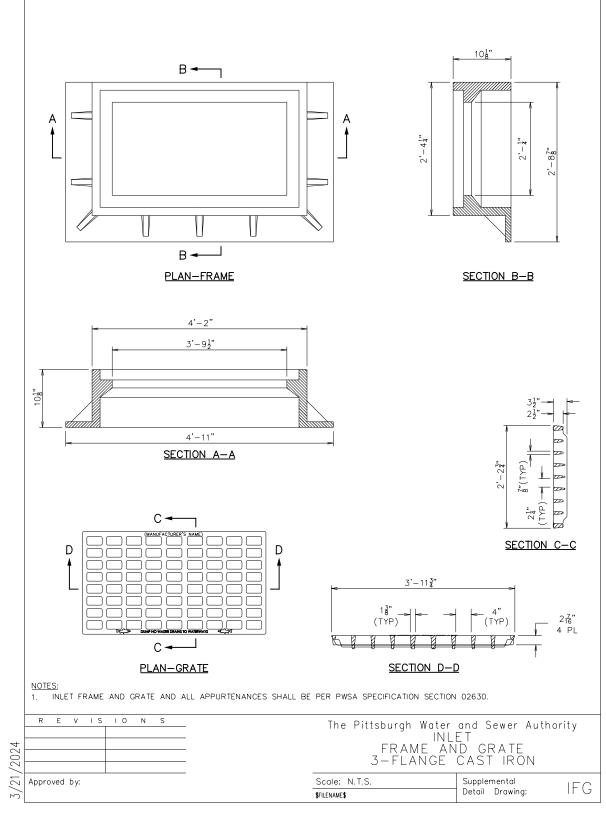



Gulf Tower 707 Grant Street 5th Floor Pittsburgh, PA 15219

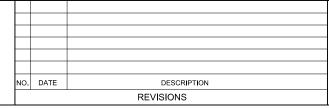

THE PREPARATION OF THIS
DOCUMENT HAS BEEN FINANCED IN
PART THROUGH A GRANT FROM THE
FEDERAL TRANSIT ADMINISTRATION,
U.S. DEPARTMENT OF
TRANSPORTATION, UNDER THE
URBAN MASS TRANSPORTATION ACT
OF 1964, AS AMENDED, FOR THE
PORT AUTHORITY OF ALLEGHENY
COUNTY, PENNSYLVANIA.

# (NOT FOR CONSTRUCTION)

DESIGNED	<u>JMS</u>	
DRAWN	<u>JMS</u>	
CHECKED	DJC	
IN CHARGE	LAR	
DATE	05/01/24	
SCALE		
	AS SHOWN	

### PORT AUTHORITY OF ALLEGHENY COUNTY PENNSYLVANIA

BUS RAPID TRANSIT UPTOWN TO OAKLAND SPECIAL DETAILS PWSA - MANHOLE STEPS / INLET FRAME & GRATE

PWSA - MANHOLE STEPS / INLET FRAME & GRATE


Port Authority | CONTRACT NO. BRT-001

Port Authority CONTRACT

DWG. NO. CV6

DWG. NO. CV61 SHT. 136



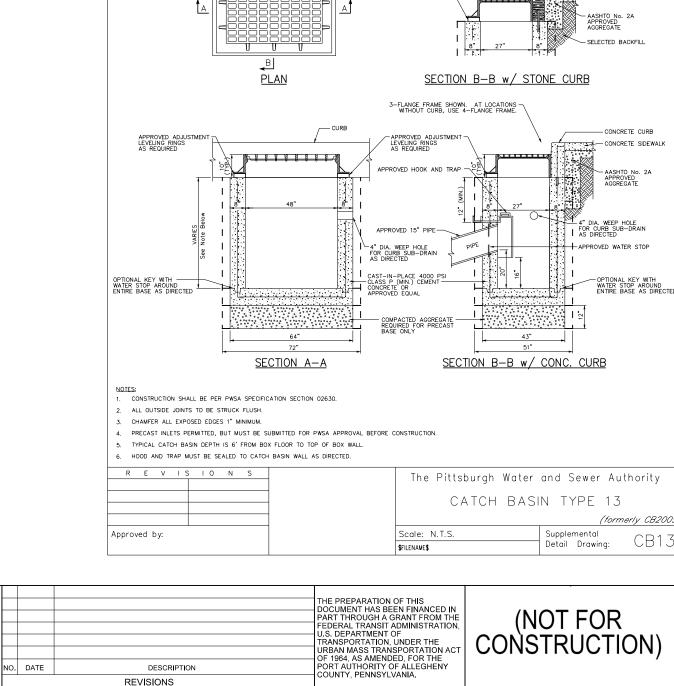

?" RADIUS —

1" BATTEN

REVISIONS

CONCRETE CURB

CONCRETE SIDEWALL  AASHTO No.2A  APPROVED  AGGREGATE  MATCH CURB  DRAIN INVERT  CONCRETE CURB DETAIL	HEVEAL WAS A STATE OF	AASHTO No.2A APPROVED AGGREGATE  MATCH CURB DRAIN INVERT  SELECTED BACKFILL
B CURB A	APPROVED ADJUSTMENT LEVELING RINGS AS REQUIRED  1. 1. 1. 1. 1. 1. 1. 1. 1. 1. 1. 1. 1. 1	STONE OR GRANITE CURB AS DIRECTED CONGRETE SIDEWALK  AASHTO No. 2A APPROVED AGGREGATE SELECTED BACKFILL  ONE CURB
3-	-FLANGE FRAME SHOWN. AT LOCATIONS — WITHOUT CURB, USE 4—FLANGE FRAME.	
APPRO  CAST -   L CONTROL ACCORDANT	ASHTO No. 2A APPROVED AGREGATE  4" DIA. WEEP HOLE FOR CURB SUB-DRAIN AS DIRECTED  APPROVED WATER STOP  APPROVED WATER STOP  OPTIONAL KEY WITH WATER STOP AROUND ENTIRE BASE AS DIRECTED	
NOTES:  1. CONSTRUCTION SHALL BE PER PWSA SPECIFICATION SECTION 02630.  2. ALL OUTSIDE JOINTS TO BE STRUCK FLUSH.  3. CHAMFER ALL EXPOSED EDGES 1" MINIMUM.  4. PRECAST INLETS PERMITTED, BUT MUST BE SUBMITTED FOR PWSA APPROVAL BEFORE C  5. TYPICAL CATCH BASIN DEPTH IS 6" FROM BOX FLOOR TO TOP OF BOX WALL.  6. HOOD AND TRAP MUST BE SEALED TO CATCH BASIN WALL AS DIRECTED.	CONSTRUCTION.	
R E V IS IO N S	The Pittsburgh Water	and Sewer Authority
	CATCH BAS	IN TYPE 13 (formerly CB2005)
Approved by:	Scale: N.T.S. \$FILENAME\$	Supplemental Detail Drawing: CB13


— STONE OR GRANITE CURB AS DIRECTED .


DESIGNED	<u>JMS</u>	
DRAWN	<u>JMS</u>	
CHECKED	DJC	
IN CHARGE	LAR	
DATE	05/01/24	
SCALE	AS SHOWN	

PORT AUTHORITY OF ALLEGHENY COUNTY PENNSYLVANIA BUS RAPID TRANSIT UPTOWN TO OAKLAND SPECIAL DETAILS PWSA - CATCH BASIN TYPE 13

Port Authority connecting people to life CONTRACT NO. BRT-001 DWG. NO. CV62 sнт. 137



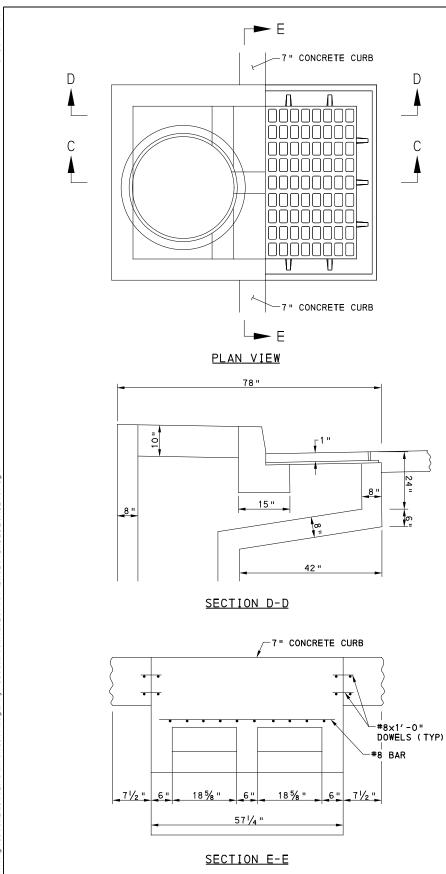

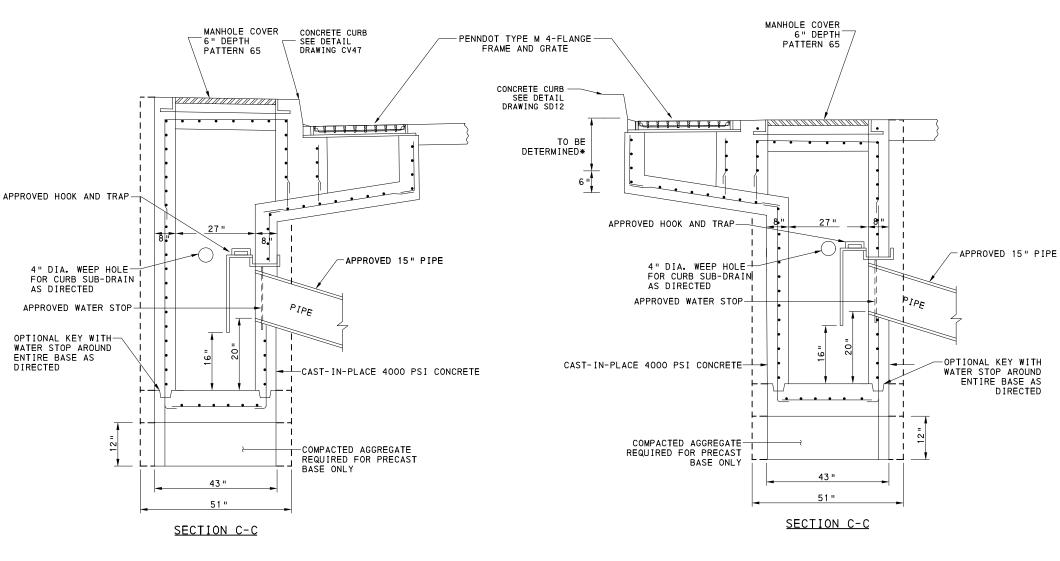

### CATCH BASIN, PWSA TYPE 13 MODIFIED, CONCRETE CURB

(PWSA STANDARD DETAIL CB13M) NOT TO SCALE

CATCH BASIN, REVERSE TYPE PWSA 13 MODIFIED, CONCRETE CURB


NOT TO SCALE

\* BASED ON FIELD CONDITIONS AND STRUCTURAL REVIEW

- 1. ALL FRAMES AND CASTINGS CLASS 30 MIN. STRENGTH CAST OR GRAY IRON.
- 2. ALL CONCRETE 4000 PSI MIN.

## AECOM

707 Grant Street 5th Floor Pittsburgh, PA 15219

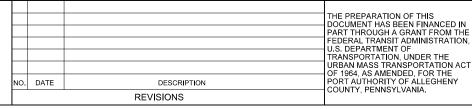

(NOT FOR CONSTRUCTION)


ESIGNED	<u>JMS</u>	PORT /
RAWN	<u>JMS</u>	PITTSBURGH
HECKED	DJC	BUS F
CHARGE	LAR	
ATE	<u>05/01/24</u>	PV
CALE	AS SHOWN	Port Aut


### **AUTHORITY OF ALLEGHENY COUNTY** PENNSYLVANIA RAPID TRANSIT UPTOWN TO OAKLAND SPECIAL DETAILS

sнт. 138

WSA - CATCH BASINS TYPE 13 MODIFIED

CONTRACT NO. BRT-001 Port Authority DWG. NO. CV63

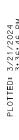

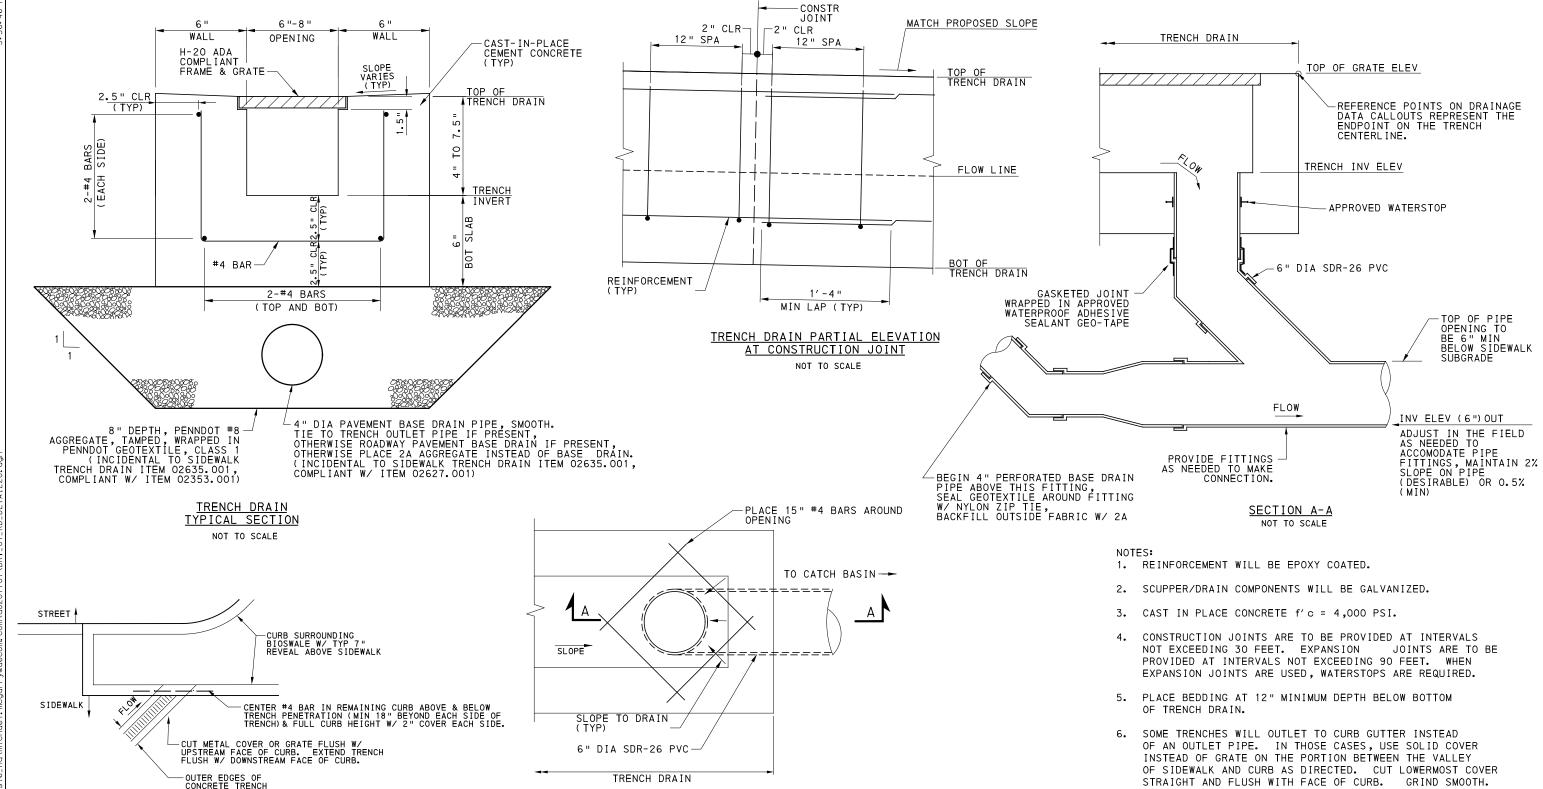

CURB AT BIOSWALE

NOT TO SCALE

TYPICAL PENETRATION THROUGH

### TRENCH DRAIN DETAILS

AECOM

Gulf Tower
707 Grant Street

5th Floor

Pittsburgh, PA 15219

THE PREPARATION OF THIS
DOCUMENT HAS BEEN FINANCED IN
PART THROUGH A GRANT FROM THE
FEDERAL TRANSIT ADMINISTRATION,
U.S. DEPARTMENT OF
TRANSPORTATION, UNDER THE
URBAN MASS TRANSPORTATION ACT
OF 1964, AS AMENDED, FOR THE
PORT AUTHORITY OF ALLEGHENY
COUNTY, PENNSYLVANIA.

REVISIONS

PLAN VIEW

NOT TO SCALE


(NOT FOR CONSTRUCTION)

DESIGNED	<u>JMS</u>	PORT AUTHOR	ITY OF AL	LEGHENY COL	JNTY	′
DRAWN	<u>JMS</u>	PITTSBURGH		PENNS	SYLVANIA	4
CHECKED	DJC	BUS RAPID TRANSIT UPTOWN TO OAKLAND				
IN CHARGE	LAR	SPECIAL DETAILS				
DATE	05/01/24	TRENCH DRAIN				
SCALE AS SHOWN		Port Authority CONTRACT NO. BRT-001				
AS SHOWN		connecting people to life	DWG. NO.	CV64	SHT.	139

7. PROVIDE CLOSED, PLAIN TEXTURED SOLID COVER AS DIRECTED

WHERE TRENCH TRAVERSES FROM SIDEWALK GUTTER TO CURB.

OPERATOR: "michael.mogarry"

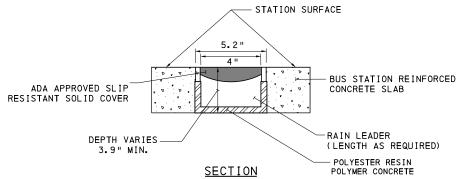

#### NOTES:

- 1. RAIN LEADER AND THROUGH CURB RAIN LEADER ARE TO BE MANUFACTURED FROM POLYESTER RESIN POLYMER CONCRETE.
- 2. THROUGH CURB RAIN LEADER OUTLET IS TO BE 6" OVERALL WIDTH AND 7.9" OVERALL DEPTH. INTERLOCK WITH SURROUNDING CONCRETE.
- 3. THE RAIN LEADER IS TO BE 4 INCHES NOMINAL INSIDE WIDTH WITH A 5.2" OVERALL WIDTH AND 3.9" OVERALL DEPTH. ALL PIECES ARE TO BE INTERLOCKING WITH A MALE/FEMALE JOINT.
- 4. INSTALL AN ADA APPROVED CAST-IN STAINLESS OR GALVANIZED STEEL SLIP RESISTANT SOLID COVER. COVER SHALL BE SECURED USING A BOLTLESS LOCKING SYSTEM. COVER AND LOCKING SYSTEM IS TO BE FULLY REMOVEABLE FROM RAIN LEADER. ENSURE COVER IS FLUSH WITH
- 5. THE RAIN LEADER SYSTEM IS TO BE INDEPENDENTLY CERTIFIED TO WITHSTAND LOADINGS TO LOAD CLASS C (DIN19580)
- 6. POLYMER CONCRETE IS TO HAVE MATERIAL PROPERTIES OF: COMPRESSIVE STRENGTH RANGE BETWEEN 14,000-14,500 PSI; FLEXURAL STRENGTH BETWEEN 3600-4500 PSI; TENSILE STRENGTH OF 1500 PSI. THE MATERIAL WATER ABSORPTION RATE IS TO NOT EXCEED O. 1% BY WEIGHT AND IS TO BE RESISTANT TO PROLONGED SALT EXPOSURE, REPETITIVE FROST CYCLES AND CHEMICALLY RESISTANT TO DILUTE ACIDS AND ALKALIS.
- 7. THE SYSTEM IS TO BE INSTALLED IN ACCORDANCE WITH THE MANUFACTURER'S INSTRUCTIONS AND RECOMMENDATIONS.
- 8. PROVIDE POSITIVE DRAINAGE FROM 3" DOWNSPOUT TO OUTLET THROUGH CURB. MINIMUM SLOPE IS 0.5%
- 9. LOCATE 3" ELBOW SUCH THAT CONNECTING DOWNSPOUT IS LOCATED IN CENTER OF STATION COLUMN. PROVIDE SMOOTH TRANSITION TO CHANNEL.

### THROUGH CURB RAIN LEADER (AT BUS STATIONS)

NOT TO SCALE

AECOM 707 Grant Street 5th Floor Pittsburgh, PA 15219

			THE PREPARATION OF THIS DOCUMENT HAS BEEN FINANCED IN PART THROUGH A GRANT FROM TH
			FEDERAL TRANSIT ADMINISTRATION U.S. DEPARTMENT OF
			TRANSPORTATION, UNDER THE
			URBAN MASS TRANSPORTATION AC OF 1964. AS AMENDED, FOR THE
ю.	DATE	DESCRIPTION	PORT AUTHORITY OF ALLEGHENY COUNTY, PENNSYLVANIA.
REVISIONS			COONTY, FEMNOTEVANIA.

(NOT FOR CONSTRUCTION)


DESIGNED	<u>JMS</u>	
DRAWN	<u>JMS</u>	
CHECKED	DJC	
IN CHARGE	<u>LAR</u>	
DATE	05/01/24	
SCALE		
	AS SHOWN	


PORT AUTHORITY OF ALLEGHENY COUNTY BUS RAPID TRANSIT UPTOWN TO OAKLAND

SPECIAL DETAILS THROUGH CURB RAIN LEADER

**Port Authority** 


CONTRACT NO. BRT-001 DWG. NO. CV65 sнт. **140** 

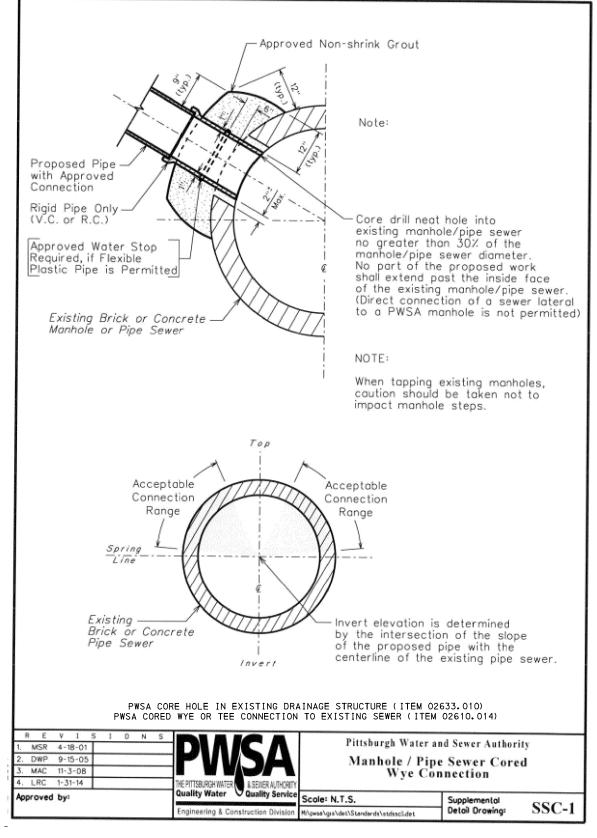

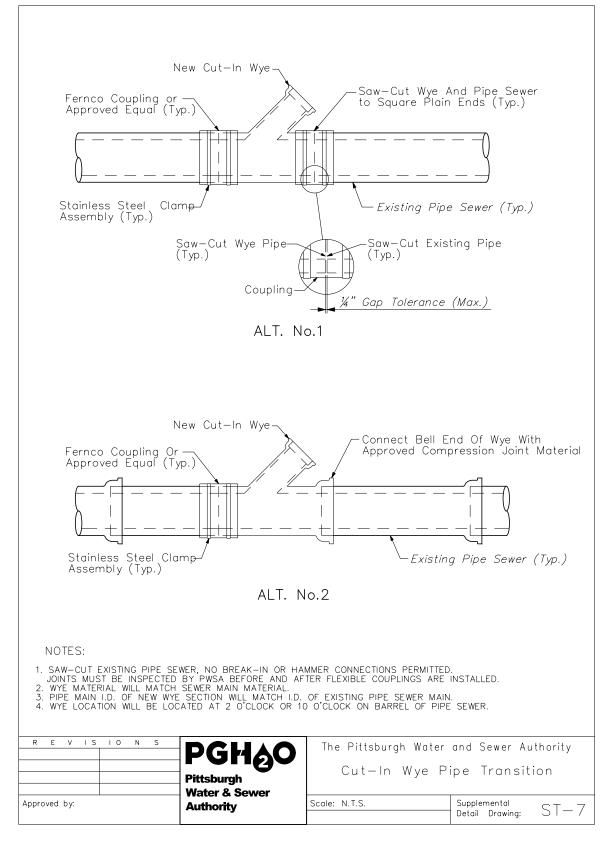



Gulf Tower 707 Grant Street 5th Floor Pittsburgh, PA 15219

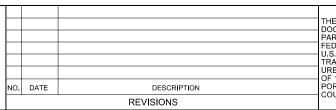

THE PREPARATION OF THIS
DOCUMENT HAS BEEN FINANCED IN
PART THROUGH A GRANT FROM THE
FEDERAL TRANSIT ADMINISTRATION,
U.S. DEPARTMENT OF
TRANSPORTATION, UNDER THE
URBAN MASS TRANSPORTATION ACT
OF 1964, AS AMENDED, FOR THE
PORT AUTHORITY OF ALLEGHENY
COUNTY, PENNSYLVANIA.

## (NOT FOR CONSTRUCTION)

DESIGNED	<u>JMS</u>
DRAWN	<u>JMS</u>
CHECKED	DJC
IN CHARGE	LAR
DATE	05/01/24
SCALE	

AS SHOWN


## PORT AUTHORITY OF ALLEGHENY COUNTY PENNSYLVANIA

BUS RAPID TRANSIT UPTOWN TO OAKLAND
SPECIAL DETAILS
PWSA - WYE CONNECTIONS

PWSA - WYE CONTRACT NO BE

Port Authority CONTRACT NO. BRT-001

DWG. NO. CV66 SHT. 141

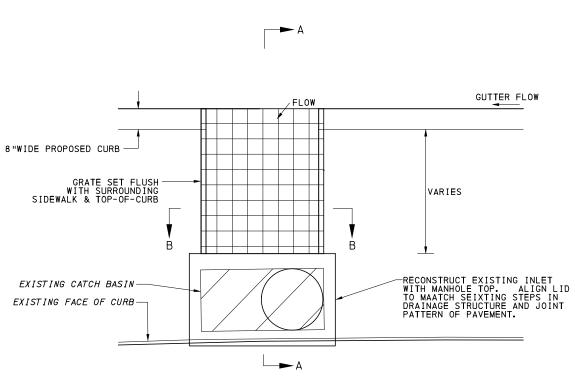

INLET BASELINE STA - OFFSET REVER A25-6 5TH AVE STA 492+34.12 - 19.22' RT A26-3 5TH AVE STA 497+46.65 - 21.39' RT A26-5 5TH AVE STA 492+34.12 - 19.22' RT A27-1 5TH AVE STA 503+46.91 = 21.04' RT A33-1 5TH AVE STA 503+486.43 - 28.54' LT A38-3 BELLEFIELD AVE STA 61+52.54 - 18.91' LT THIS IS CURB REVEAL OF THE ADJACENT CURBS. DEPRESSION OF CURB AT INLET WILL ADD 1".

PLAN VIEW


NOTES:

1. PROVIDE 21/2" DEEP ADA-COMPLIANT PERMA-GRIP GRATES, FRAMES, AND GRATE SEATS OF MATERIALS AND COATINGS PER STANDARD PENNDOT SPECIFICATION 605.2(A) RATED FOR H20 LOADS WITH MAXIMUM 1/4" OR 1/2" OPENINGS AS DIRECTED.

2. PRIOR TO CONSTRUCTION MOBILIZATION, CONFIRM DESIGN SHOWN WILL NOT CONFLICT WITH EXISTING UTILITIES, CATCH BASIN OUTLET, OR OTHER FEATURES. REPORT CONFLICTS TO ENGINEER FOR DESIGN ADJUSTMENT.

3. PROVIDE VANDAL-RESISTANT LOCKING MECHANISM TO HOLD GRATES IN PLACE WITHOUT MOVEMENT UNDER TRAFFIC.

4. PROVIDE STRUCTURAL DETAILING TO FIT FIELD CONDITIONS EQUAL OR STRONGER THAN TYPE 13 MODIFIED CATCH BASIN FOR ENGINEER'S APPROVAL.

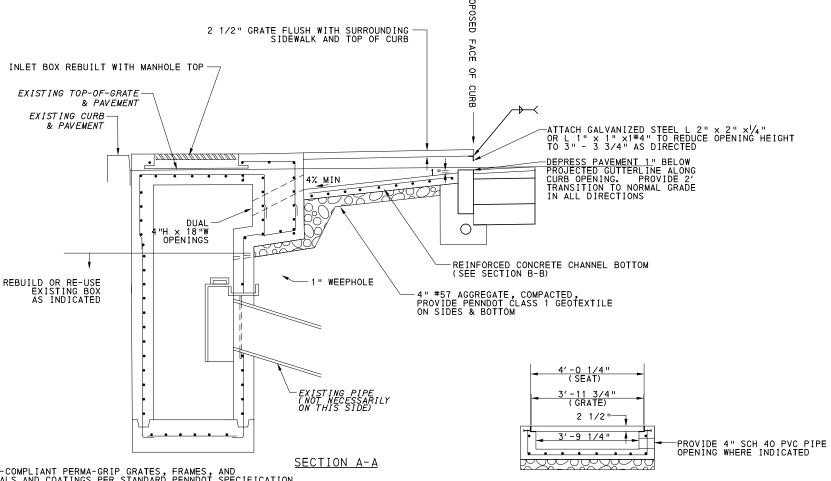

SECTION B-B

### RECESSED CATCH BASIN CONVERSION

NOT TO SCALE

## **AECOM**

Gulf Tower 707 Grant Street 5th Floor Pittsburgh, PA 15219

		THE PREPARATION OF THIS DOCUMENT HAS BEEN FINANCED IN
		PART THROUGH A GRANT FROM THE
		FEDERAL TRANSIT ADMINISTRATION, U.S. DEPARTMENT OF
		TRANSPORTATION, UNDER THE
		URBAN MASS TRANSPORTATION ACT OF 1964, AS AMENDED, FOR THE
DATE	DESCRIPTION	PORT AUTHORITY OF ALLEGHENY COUNTY, PENNSYLVANIA.
	REVISIONS	COUNTY, FEMINOTEVANIA.

# (NOT FOR CONSTRUCTION)

DESIGNED	<u>JMS</u>	
DRAWN	<u>JMS</u>	
CHECKED	DJC	
N CHARGE	LAR	
DATE	05/01/24	
SCALE		
	AS SHOWN	

## PORT AUTHORITY OF ALLEGHENY COUNTY PENNSYLVANIA BUS RAPID TRANSIT UPTOWN TO OAKLAND


BUS RAPID TRANSIT UPTOWN TO OAKLAND
SPECIAL DETAILS
RECESSED CATCH BASIN CONVERSION

Port Authority CONTR

CONTRACT NO. BRT-001

DWG. NO. CV67 SHT. 142

8" MIN BEYOND LARGE PIPE (P1)

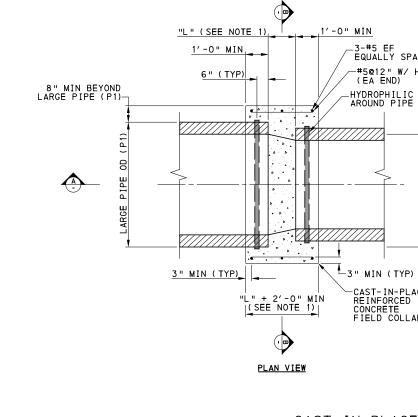

"L" (SEE NOTE 1)\_\_\_

1'-0" MIN

3" MIN (TYP)\_

L" + 2'-0" MIN |(SEE\_NOTE 1)|

SECTION A

6" (TYP)

1'-0" MIN

-3-#5 EF EQUALLY SPACED

(EA END)

-3" MIN (TYP) -CAST-IN-PLACE REINFORCED

CONCRETE FIELD COLLAR

-3-#5 EF EQUALLY SPACED

-#5@12" W/ HOOKS (EA END)

-HYDROPHILIC GASKET AROUND PIPE (TYP)

-CAST-IN-PLACE REINFORCED CONCRETE FIELD COLLAR

-#5@12" W/ HOOKS

-HYDROPHILIC GASKET AROUND PIPE (TYP)

LARGE PIPE OD + 1'-4" MIN -HYDROPHILIC GASKET AROUND PIPE (TYP) -LARGE PIPE OD (P1) -3-#5 EF EQUALLY SPACED \_#5@12" W/ HOOKS (EA END) -CAST-IN-PLACE REINFORCED CONCRETE FIELD COLLAR -3" MIN COVER (TYP) 1'-0" MIN LAP (TYP) SECTION B

### NOTES:

1. SPACING BETWEEN PIPES (L) DEPENDS ON PIPE SIZES, FOR PIPES OF THE SAME SIZE USE 4 ".THE DISTANCE "L" EQUALS THE LARGE PIPE ID MINUS THE SMALL PIPE ID TIMES TWO (L=(P1-P2) X2) BUT NO LESS THAN 4"

- PROPOSED PIPE INVERT SHALL MATCH EXISTING PIPE INVERT UNLESS OTHERWISE NOTED.
- 3. CONCRETE AND REBAR REQUIREMENTS SHALL CONFORM TO CAST-IN-PLACE CONCRETE SPECIFICATIONS.
- 4. LOCATION OF FIELD COLLAR SHAL BE SUBJECT TO THE ENGINEERS APPROVAL.
- 5. FOR NON-PRESSURE PIPES OF DIFFERENT MATERIALS OR SIZES.

### -Approved Non-shrink 4000 PSI Cement Concrete Plug No Part of Proposed — Cement Concrete Plug is Permitted to Extend Past the Inside Face of the Existing Pipe, Sewer or Manhole Anchor Form in -Place as Directed Remove Damaged Brick or Loose Material/Brick and/or Lateral Pipe as Directed Ex. Pipe Sewer-R E V IS IO N S The Pittsburgh Water and Sewer Authority Cement Concrete Plug For Brick Sewer/ Manhole Scale: N.T.S. Supplemental Approved by: $\begin{array}{ccc} \text{Detail} & \text{Drawing:} & \text{SC-CP} \end{array}$ \$FILENAME\$

### CAST-IN-PLACE CONCRETE FIELD COLLAR

## AECOM

707 Grant Street 5th Floor Pittsburgh, PA 15219

		THE PREPARATION OF THIS
		DOCUMENT HAS BEEN FINANCED IN
ļ		PART THROUGH A GRANT FROM THE
		FEDERAL TRANSIT ADMINISTRATION.
		U.S. DEPARTMENT OF
		TRANSPORTATION, UNDER THE
		URBAN MASS TRANSPORTATION ACT
		OF 1964, AS AMENDED, FOR THE
DATE	DESCRIPTION	PORT AUTHORITY OF ALLEGHENY COUNTY, PENNSYLVANIA.
	REVISIONS	COUNTY, FEMINSTEVANIA.

# (NOT FOR CONSTRUCTION)

DESIGNED	<u>JMS</u>
DRAWN	<u>JMS</u>
CHECKED	DJC
IN CHARGE	LAR
DATE	05/01/24
SCALE	


## PORT AUTHORITY OF ALLEGHENY COUNTY

BUS RAPID TRANSIT UPTOWN TO OAKLAND SPECIAL DETAILS PIPE FIELD COLLAR & PWSA - CONCRETE PLUG

**Port Authority** DWG. NO. CV68

AS SHOWN

CONTRACT NO. BRT-001 sнт. **143** 

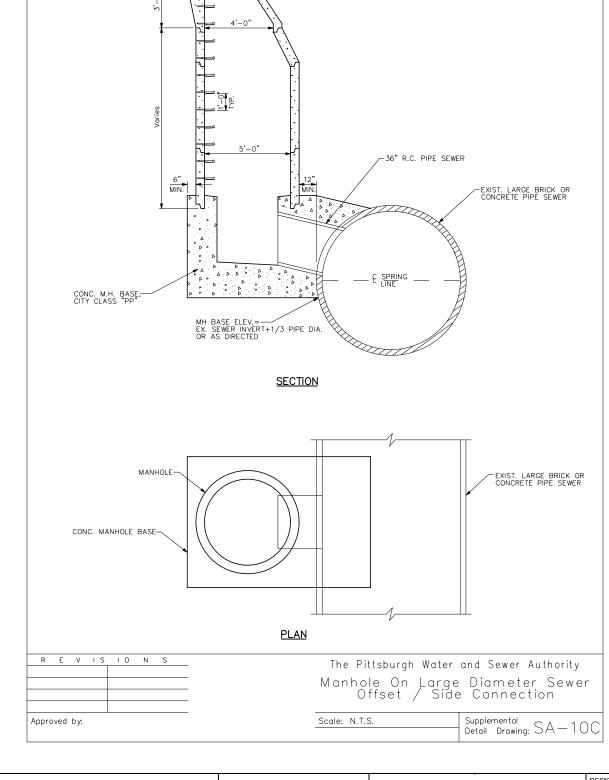

(2) SS 3/4" ANCHOR BOLTS AS DIRECTED

**AECOM** 

707 Grant Street 5th Floor Pittsburgh, PA 15219

THE PREPARATION OF THIS
DOCUMENT HAS BEEN FINANCED IN
PART THROUGH A GRANT FROM THE
FEDERAL TRANSIT ADMINISTRATION,
U.S. DEPARTMENT OF
TRANSPORTATION, UNDER THE
URBAN MASS TRANSPORTATION ACT
OF 1964, AS AMENDED, FOR THE
PORT AUTHORITY OF ALLEGHENY
COUNTY, PENNSYLVANIA. NO. DATE DESCRIPTION REVISIONS

(NOT FOR CONSTRUCTION)

DESIGNED	<u>JMS</u>	
DRAWN	<u>JMS</u>	
CHECKED	DJC	
N CHARGE	LAR	
DATE	05/01/24	
SCALE		
	AS SHOWN	

PORT AUTHORITY OF ALLEGHENY COUNTY

BUS RAPID TRANSIT UPTOWN TO OAKLAND SPECIAL DETAILS
PWSA - LARGE DIAMETER SEWER CONNECTION

Port Authority
connecting people to life

CONTRACT NO. BRT-001 DWG. NO. CV69 sнт. **144** 

A14-1 DIAMOND ST STA 48+02.78 - 14.35' RT
EXISTING INLET
PWSA ID: CB002F013
TG ELEV 764.02
GRADE ADJUSTMENT OF EXISTING PWSA INLET TG ELEV 764.60 EXISTING INVERT ELEVATIONS UNKNOWN A14-2 DIAMOND ST. STA 48+33.33 - 15.11' RT
PWSA DOGHOUSE MANHOLE,
W/ MANHOLE FRAME AND COVER
RIM ELEV 765.44
INV 762.44 (15") IN FROM A14-2A
INV 758.00 (15") OUT TO EXS PIPE
CONNECT TO EXISTING PIPE
(FIELD VERIFY)

A14-8 FIFTH AVE STA 435+03.04 - 19.30 LT CATCH BASIN, PWSA TYPE 13, W/3-FLANGE CAST IRON FRAME AND BICYCLE TO ELEV 765.37
INV 761.37 (15") OUT (FIELD VERIFY)

A14-7 FIFTH AVE STA 435+43.99 - 19.39 LT CATCH BASIN, PWSA TYPE 13, W/3-FLANGE CAST IRON FRAME AND BICYCLE

TO SAFE GRATE
TG ELEV 765.39
INV 761.39 (15") OUT
(FIELD VERIFY, ADJUST TG ELEV
DOWN IF NEEDED)

A15-3 FIFTH AVE STA 440+59.86 - 23.11' RT
4' DIAMETER PWSA MANHOLE,
W/ MANHOLE FRAME AND COVER
RIM ELEV 773.70
INV 768.00 (15") IN FROM A15-7
INV 766.20 (15") OUT
(FIELD VERIFY)

A15-1 FIFTH AVE STA 441+01.48 - 23.00' LT CATCH BASIN, PWSA TYPE 13, W/3-FLANCE\_CAST IRON FRAME AND BICYCLE

INV 768.48 (15") OUT CONNECT TO EXISTING PIPE (FIELD VERIFY)

SAFE GRATE TG ELEV 773.48

A15-8 FIFTH AVE. STA 438+65.94 - 20.25' LT EXISTING INLET] PWSA ID: CBOO2F027 TG ELEV 769.56 GRADE ADJUSTMENT OF EXISTING PWSA INLET TG ELEV 769.87
EXISTING INVERT 765.56

A14-2A FIFTH AVE STA 435+48.51 - 34.50' RT
CATCH BASIN, PWSA TYPE 13, W/
3-FLANGE CAST IRON FRAME AND BICYCLE
SAFE GRATE
TG ELEV 765.42
INV 763.30 (6") IN FROM A14-9
INV 761.62 (15") OUT TO A14-2
PROVIDE ADA COMPLIANT GRATE
INCIDENTAL TO ITEM INCIDENTAL TO ITEM

A14-9 FIFTH AVE STA 436+14.00- 22.80' RT SIDEWALK TRENCH DRAIN, PWSA W/ ADA COMPLIANT AND BICYCLE SAFE GRATE TG ELEV 766.33 TRENCH INV ELEV 765.71 INV 764.23 (6") OUT TO A14-2A

A15-4 CHATHAM SQUARE STA 25+38.88 - 4.71' RT CATCH BASIN, PWSA TYPE 13, W/
3-FLANGE CAST IRON FRAME AND BICYCLE SAFE GRATE
TG ELEV 772.55
INV 765.90 (15") IN
INV 765.85 (15") OUT
CONNECT TO EXISTING PIPE (FIELD VERIFY)

A15-10 FIFTH AVE STA 438+94.00 - 22.67' RT SIDEWALK TRENCH DRAIN, PWSA W/ ADA COMPLIANT AND BICYCLE SAFE GRATE TG ELEV 770.91 TRENCH INV ELEV 770.58

A15-9 FIFTH AVE STA 438+82.39 - 10.00' RT SIDEWALK TRENCH DRAIN, PWSA W/ ADA COMPLIANT AND BLYCLE SAFE GRATE TG ELEV 770.62 TRENCH INV ELEV 770.29

A14-3 DIAMOND ST STA 48+23.92 - 09.58' LT EXS STORM/SEWER MANHOLE PWSA ID: MH002F126 RIM ELEV 765.21 RIM ELEV 765.27
GRADE ADJUSTMENT OF EXS PWSA MANHOLE
RIM ELEV 765.12
CORE HOLE IN EXISTING DRAINAGE STRUCTURE
INV 759.25 (15") IN FROM A14-4 EXISTING INVERT ELEVATIONS UNKNOWN

A14-10 FIFTH AVE STA 436+87.00- 22.67' RT SIDEWALK TRENCH DRAIN, PWSA W/ ADA COMPLIANT AND BICYCLE SAFE GRATE IG ELEV 7.67.40 TRENCH INV ELEV 766.78

A15-5 CHATHAM SQUARE STA 25+58.42 - 32.00' LT STORM INLET, PWSA TYPE 13, W/ 3-FLANGE CAST IRON FRAME AND BICYCLE SAFE GRATE TG ELEV 772.71 INV 767.41 (15") OUT CONNECT TO EXISTING PIPE (FIELD VERIFY)

A15-11 FIFTH AVE STA 439+43.00 - 22.67' RT SIDEWALK TRENCH DRAIN, PWSA W/ ADA COMPLIANT AND BICYCLE SAFE GRATE TG ELEV 771.47 TRENCH INV ELEV 771.14

A14-5 FIFTH AVE STA 434+30.59 - 18.92' RT CATCH BASIN, PWSA TYPE 13 MODIFIED, W/3-FLANGE CAST IRON FRAME AND BICYCLE SAFE GRATE, AND MANHOLE FRAME AND COVER TG ELEV 765.59, RIM ELEV 765.79 INV 761.59 (15") OUT TO A14-4

A15-6 CHATHAM SQUARE STA 23+86.16 - 15.18' LT CATCH BASIN, PWSA TYPE 13, W/3-FLANGE CAST IRON FRAME AND BICYCLE SAFE GRATE
TG ELEV 773.48
INV 769.15 (15") OUT
CONNECT TO EXISTING PIPE
(FIELD VERIFY)

A15-12 FIFTH AVE STA 440+90.00 - 22.67' RT SIDEWALK TRENCH DRAIN, PWSA W/ ADA COMPLIANT AND BICYCLE SAFE GRATE TG ELEV 773.78 TRENCH INV ELEV 773.16 INV 771.68 (6") OUT TO A15-7

A15-7 FIFTH AVE STA 440+71.39 - 10.00′ RT CATCH BASIN, PWSA TYPE 13 REVERSE MODIFIED, W/3-FLANGE CAST IRON FRAME AND BICYCLE SAFE GRATE AND MANHOLE FRAME AND COVER TG ELEV 773.39, RIM ELEV 773.52 INV 771.00 (6") IN FROM A15-12 INV 768.50 (15") OUT TO A15-3

FIFTH AVE STA 441+39.00 - 22.67' RT SIDEWALK TRENCH DRAIN, PWSA W/ ADA COMPLIANT AND BICYCLE SAFE GRATE TG ELEV 774.73 TRENCH INV ELEV 774.11

> GENERAL NOTE: DRAINAGE STRUCTURE LOCATIONS, PIPE SIZES, AND ELEVATIONS SHOULD BE ADJUSTED WHERE NECESSARY TO ALIGN W/ EXISTING PIPE WHERE POSSIBLE. DETERMINE EXISTING PIPE ALIGNMENTS AND DEPTHS AND NOTIFY ENGINEER PRIOR TO CATCH BASIN CONSTRUCTION WHERE ADJUSTMENT IS NEEDED.

## AECOM

**Gulf Tower** 707 Grant Street 5th Floor Pittsburgh, PA 15219

THE PREPARATION OF THIS DOCUMENT HAS BEEN FINANCED IN PART THROUGH A GRANT FROM THE FEDERAL TRANSIT ADMINISTRATION U.S. DEPARTMENT OF TRANSPORTATION, UNDER THE URBAN MASS TRANSPORTATION ACT OF 1964, AS AMENDED, FOR THE PORT AUTHORITY OF ALLEGHENY COUNTY, PENNSYLVANIA. NO. DATE DESCRIPTION REVISIONS

(NOT FOR CONSTRUCTION)

DEGIGINED	IVII CIVI	
DRAWN	<u>MRM</u>	
CHECKED	DJC	
IN CHARGE	LAR	
DATE	05/01/24	
SCALE		
	AS SHOWN	

DESIGNED

#### PORT AUTHORITY OF ALLEGHENY COUNTY PITTSBURGH PENNSYLVANIA

BUS RAPID TRANSIT UPTOWN TO OAKLAND DRAINAGE DATA DRAINAGE STRUCTURES A14 - A16

Port Authority

CONTRACT NO. BRT-001 DWG. NO. CV70 sнт. **145** 

A16-2 FIFTH AVE STA 444+68.20 - 23.00′ LT CATCH BASIN, PWSA TYPE 13, W/
3-FLANGE CAST IRON FRAME AND BICYCLE SAFE GRATE
TG ELEV 782.84
INV 779.50 (15") OUT
CONNECT TO EXISTING
USE DUCTILE IRON PIPE DUE TO SHALLOW RECEIVING PIPE
(FIELD VERIFY)

A16-9 FIFTH AVE STA 443+97.27 - 10.00' RT CATCH BASIN, PWSA TYPE 13, W/3-FLANGE CAST IRON FRAME AND BICYCLE SAFE GRATE
TG ELEV 780.96
INV 776.54 (15") OUT TO A16-9

A17-1 LOGAN ST STA 20+34.38 - 11.26' LT
CATCH BASIN, PWSA TYPE 13 MODIFIED, W/
3-FLANGE CAST IRON FRAME AND BICYCLE
SAFE GRATE, AND MANHOLE FRAME AND COVER
TG ELEV 796.53, RIM ELEV 796.96
INV 791.68 (15") OUT
CONNECT TO EXISTING PIPE
(FIELD VERIFY)

A17-6 FIFTH AVE STA 453+25.97 - 25.73' RT
4' DIAMETER PWSA MANHOLE,
W/ MANHOLE FRAME AND COVER
RIM ELEV 805.45
INV 800.08 (15") IN FROM A17-8
INV 800.00 (15") OUT
CONNECT TO EXISTING PIPE
(FIELD VERIFY)

A16-3 MAGEE ST STA 36+39.87 - 15.18' LT
CATCH BASIN, PWSA TYPE 13, W/
3-FLANGE CAST IRON FRAME AND BICYCLE
SAFE GRATE
TG ELEV 791.25
INV 787.33 (15") OUT TO EXS PIPE
CONNECT TO EXISTING PIPE
(FIELD VERIFY)

A16-10 FIFTH AVE STA 444+42.72 - 10.00' RT SIDEWALK TRENCH DRAIN, PWSA W/ ADA COMPLIANT AND BICYCLE SAFE GRATE TG ELEV 782.59 TRENCH INV ELEV 782.26 A17-2 FIFTH AVE STA 449+61.74 - 18.85' RT CATCH BASIN, PWSA TYPE 13, W/3-FLANGE CAST IRON FRAME AND BICYCLE SAFE GRATE
TG ELEV 795.80
INV 789.84 (15") OUT
CONNECT TO EXISTING PIPE
(FIELD VERIFY)

A17-8 FIFTH AVE STA 453+31.12 - 13.00' RT CATCH BASIN, PWSA TYPE 13, W/3-FLANGE CAST IRON FRAME AND BICYCLE SAFE GRATE TG ELEV 805.17 INV 800.19 (15") OUT TO A17-6

A16-4 MAGEE ST STA 36+39.77 - 14.70' RT
CATCH BASIN, PWSA TYPE 13, W/
3-FLANGE CAST IRON FRAME AND BICYCLE
SAFE GRATE
TG ELEV 792.06
INV 788.06 (15") OUT TO EXS PIPE
CONNECT TO EXISTING PIPE
(FIELD VERIFY)
NOTE: THE PROPOSED STREET GRADING WILL
NOT DRAIN TO THIS CATCH BASIN. IT IS TO
BE BUILT ONLY IF FIELD ADJUSTMENTS RESULT
IN A GUTTER DRAINING TO IT.

ATECH IN THE STA 444+59.49 - 22.67' RT SIDEWALK TRENCH DRAIN, PWSA W/ ADA COMPLIANT AND BICYCLE SAFE GRATE TG ELEV 782.88
TRENCH INV ELEV 782.55

A17-3 FIFTH AVE STA 453+36.11 - 18.00' LT CATCH BASIN, PWSA TYPE 13 MODIFIED, W/3-FLANGE CAST IRON FRAME AND BICYCLE SAFE GRATE, AND MANHOLE FRAME AND COVER TG ELEV 805.06, RIM 805.48
INV 801.10 (15") OUT TO A17-3A

FIFTH AVE. STA 449+19.39 - 22.67' RT SIDEWALK TRENCH DRAIN, PWSA W/ ADA COMPLIANT AND BICYCLE SAFE GRATE TG ELEV 795.20 TRENCH INV ELEV 794.62

A16-7) FIFTH AVE STA 448+37.01 - 20.49' LT CATCH BASIN, PWSA TYPE 13, W/3-FLANGE CAST IRON FRAME AND BICYCLE SAFE GRATE
TG ELEV 792.42
INV 786.80 (UNK DIAMETER) OUT LOCATE AND CONNECT TO EXS INLET OUTLET PIPE

A16-12 FIFTH AVE STA 446+55.09 - 22.67' RT SIDEWALK TRENCH DRAIN, PWSA W/ ADA COMPLIANT AND BICYCLE SAFE GRATE TG ELEV 788.14 TRENCH INV ELEV 787.81

A17-3A)FIFTH AVE STA 453+31.95 - 26.23' LT
4' DIAMETER PWSA MANHOLE,
W/ MANHOLE FRAME AND COVER
RIM ELEV 805.62
INV 801.04 (15") IN FROM A17-3
INV 800.63 OUT (15") MATCH EXS

A17-10 FIFTH AVE. STA 452+44.73 - 22.67' RT SIDEWALK TRENCH DRAIN, PWSA W/ ADA COMPLIANT AND BICYCLE SAFE GRATE TG ELEV 803.22 TRENCH INV ELEV 802.64

A16-8 FIFTH AVE STA 443+89.52 - 6.00' RT
EXS STORM/SEWER MANHOLE
PWSA ID: MHOO2GO63
RIM ELEV 780.86
GRADE ADJUSTMENT OF EXS PWSA MANHOLE
RIM ELEV 780.89
CORE HOLE IN EXISTING STRUCTURE
INV 776.00 (15") IN FROM A16-9

AT6-13 FIFTH AVE STA 448+36.00 - 10.49' RT SIDEWALK TRENCH DRAIN, PWSA W/ ADA COMPLIANT AND BICYCLE SAFE GRATE TG ELEV 793.20 TRENCH INV ELEV 792.62


AT6-14 FIFTH AVE STA 448+45.37 - 20.45' RT SIDEWALK TRENCH DRAIN, PWSA W/ ADA COMPLIANT AND BICYCLE SAFE GRATE TG ELEV 793.33 TRENCH INV ELEV 792.75

GENERAL NOTE:

DRAINAGE STRUCTURE LOCATIONS, PIPE SIZES, AND ELEVATIONS SHOULD BE ADJUSTED WHERE NECESSARY TO ALIGN W/ EXISTING PIPE WHERE POSSIBLE. DETERMINE EXISTING PIPE ALIGNMENTS AND DEPTHS AND NOTIFY ENGINEER PRIOR TO CATCH BASIN CONSTRUCTION WHERE ADJUSTMENT IS NEEDED.

## **AECOM**

Gulf Tower 707 Grant Street 5th Floor Pittsburgh, PA 15219

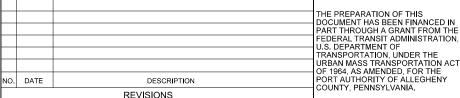

(NOT FOR CONSTRUCTION)

DESIGNED	IVII CIVI	
DRAWN	<u>MRM</u>	
CHECKED	DJC	
IN CHARGE	LAR	
DATE	05/01/24	
SCALE		
	AS SHOWN	

DESIGNED

## PORT AUTHORITY OF ALLEGHENY COUNTY PENNSYLVANIA BUS RAPID TRANSIT UPTOWN TO OAKLAND

IS RAPID TRANSIT UPTOWN TO OAKLANI DRAINAGE DATA DRAINAGE STRUCTURES A16 - A18

Port Authority connecting people to life

CONTRACT NO. BRT-001

DWG. NO. CV71 SHT. 146

COUNTY, PENNSYLVANIA.

A18-1 FIFTH AVE STA 457+22.92 - 9.53' RT CATCH BASIN, PWSA TYPE 5 W/ BASKET GRATE G.I. CONTROL STRUCTURE** RIM ELEV 815.33 INV 810.70 (15") OUT TO A18-1A  **SEE STORMWATER MANAGEMENT PLANS	A18-5 FIFTH AVE STA 454+60.50 - 13.00' RT SIDEWALK TRENCH DRAIN, PWSA W/ ADA COMPLIANT AND BICYCLE SAFE GRATE TG ELEV 808.74 TRENCH INV ELEV 808.41	A19-II VINE ST STA 30+36.33 - 18.21' LT CATCH BASIN, PWSA TYPE 13 MODIFIED, W/ 3-FLANGE CAST IRON FRAME AND BICYCLE SAFE GRATE, AND MANHOLE FRAME AND COVER TG ELEV 823.10, RIM ELEV 823.50 CONNECTED TO G.I. STRUCTURE** INV 819.55 (15") OUT CONNECT TO EXISTING PIPE (FIELD VERIFY) **SEE STORMWATER MANAGEMENT PLANS	A19-6 FIFTH AVE STA 460+44.13 - 11.00' RT CATCH BASIN, PWSA TYPE 13, W/3-FLANGE CAST IRON FRAME AND BICYCLE SAFE GRATE TG ELEV 823.52 INV 818.70 (6") IN FROM A19-14 INV 817.68 (15") OUT TO A19-5	A19-12 FIFTH AVE STA 460+24.51 - 20.67' RT SIDEWALK TRENCH DRAIN, PWSA W/ ADA COMPLIANT AND BICYCLE SAFE GRATE TG ELEV 823.21 TRENCH INV ELEV 822.59 INV 820.91 (6") OUT TO A19-14
A18-1A FIFTH AVE STA 457+10.84 - 19.30' RT 4' DIAMETER PWSA MANHOLE, W/ MANHOLE FRAME AND COVER RIM ELEV 815.68 INV 810.58 (15") IN FROM A18-1 INV 810.50 (15") OUT CONNECT TO EXISTING PIPE (FIELD VERIFY)	A18-6 FIFTH AVE STA 454+72.75 - 22.67' RT SIDEWALK TRENCH DRAIN, PWSA W/ ADA COMPLIANT AND BICYCLE SAFE GRATE TG ELEV 808.89 TRENCH INV ELEV 808.56	A19-2 FIFTH AVE STA 459+92.28 - 17.09' LT PWSA DOGHOUSE MANHOLE, W/ MANHOLE FRAME AND COVER RIM ELEV 822.45 INV 818.65 (15") IN FROM A19-3 INV 818.65 (15") IN FROM A19-4 INV 817.90 (15") OUT TO EX PIPE (FIELD VERIFY)	A19-B FIFTH AVE STA 463+32.83 - 18.00' LT CATCH BASIN, PWSA TYPE 13, W/3-FLANGE CAST IRON FRAME AND BICYCLE SAFE GRATE TG ELEV 829.72 INV 823.92 (15") OUT TO EXS PIPE *LOCATE AND CONNECT TO EXS PIPE FROM EXS INLET, MAINTAIN POSITIVE DRAINAGE	[A19-13] FIFTH AVE STA 460+37.51 - 20.67' RT SIDEWALK TRENCH DRAIN, PWSA W/ ADA COMPLIANT AND BICYCLE SAFE GRATE TG ELEV 823.39 TRENCH INV ELEV 822.77
A18-2 FIFTH AVE STA 457+11.41 - 18.00' LT CATCH BASIN, PWSA TYPE 13, W/ 3-FLANGE CAST IRON FRAME AND BICYCLE SAFE GRATE TG ELEV 814.85 INV 810.95 (15") OUT CONNECT TO EXISTING PIPE (FIELD VERIFY)	FIFTH AVE STA 455+80.00 - 22.67' RT SIDEWALK TRENCH DRAIN, PWSA W/ ADA COMPLIANT AND BICYCLE SAFE GRATE TG ELEV 811.66 TRENCH INV ELEV 811.33	A19-3 VINE ST STA 30+35.36 - 17.74' RT CATCH BASIN, PWSA TYPE 13, W/ 3-FLANGE CAST IRON FRAME AND BICYCLE SAFE GRATE TG ELEV 823.78 INV 819.98 (15") OUT TO A19-2	A19-9 FIFTH AVE STA 458+63.03 - 20.67' RT SIDEWALK TRENCH DRAIN, PWSA W/ ADA COMPLIANT AND BICYCLE SAFE GRATE TG ELEV 819.22 TRENCH INV ELEV 818.64	A19-14 FIFTH AVE STA 460+31.92 - 11.75' RT 6" WYE CONNECTION INV 819.00 OUT TO A19-6
A18-3 PRIDE ST STA 30+32.79 - 22.12' RT EXISTING INLET PWSA ID: CB002H006 TG 815.26 GRADE ADJUSTMENT OF EXISTING PWSA INLET TG ELEV 815.37 ELEV 811.56 WATER	A18-11 FIFTH AVE STA 457+43.48 - 14.27' RT SIDEWALK TRENCH DRAIN, PWSA W/ ADA COMPLIANT AND BICYCLE SAFE GRATE TG ELEV 816.08 TRENCH INV ELEV 815.45	A19-4 FIFTH AVE STA 460+13.96 - 18.00' LT CATCH BASIN, PWSA TYPE 13, W/ 3-FLANGE CAST IRON FRAME AND BICYCLE SAFE GRATE TG ELEV 822.73 INV 818.93 (15") OUT TO A19-2	A19-10 FIFTH AVE STA 459+83.26 - 18.88' RT SIDEWALK TRENCH DRAIN, PWSA W/ ADA COMPLIANT AND BICYCLE SAFE GRATE TG ELEV 822.22 TRENCH INV ELEV 821.60 INV 820.02 (6") OUT TO A19-14	A19-15 FIFTH AVE. STA 464+33.50 - 11.00' RT SIDEWALK TRENCH DRAIN, PWSA W/ ADA COMPLIANT AND BICYCLE SAFE GRATE TG ELEV 832.75 TRENCH INV ELEV 832.42
PRIDE ST STA 30+55.45 - 18.81' LT CATCH BASIN, PWSA TYPE 13, W/ 3-FLANGE CAST IRON FRAME AND BICYCLE SAFE GRATE TG ELEV 817.06 INV 813.21 (15") OUT CONNECT TO EXISTING PIPE (FIELD VERIFY)	A18-12 FIFTH AVE STA 457+51.11 - 20.67' RT SIDEWALK TRENCH DRAIN, PWSA W/ ADA COMPLIANT AND BICYCLE SAFE GRATE TG ELEV 816.26 TRENCH INV ELEV 815.64	A19-5 FIFTH AVE STA 460+63.73 - 23.37' RT PWSA MANHOLE SA-10C, W/ MANHOLE FRAME AND COVER RIM ELEV 823.93 INV 817.40 (15") IN FROM A19-6 INV 814.26 (15") OUT TO EX PIPE CONNECT TO EXISTING PIPE (FIELD VERIFY)	A19-11 FIFTH AVE STA 459+96.21 - 20.18' RT SIDEWALK TRENCH DRAIN, PWSA W/ ADA COMPLIANT AND BICYCLE SAFE GRATE TG ELEV 822.58 TRENCH INV ELEV 821.96	A19-16 FIFTH AVE STA 464+49.81 - 20.67' RT SIDEWALK TRENCH DRAIN, PWSA W/ ADA COMPLIANT AND BICYCLE SAFE GRATE TG ELEV 833.11 TRENCH INV ELEV 832.78

GENERAL NOTE:

DRAINAGE STRUCTURE LOCATIONS, PIPE SIZES, AND ELEVATIONS SHOULD BE ADJUSTED WHERE NECESSARY TO ALIGN W/ EXISTING PIPE WHERE POSSIBLE. DETERMINE EXISTING PIPE ALIGNMENTS AND DEPTHS AND NOTIFY ENGINEER PRIOR TO CATCH BASIN CONSTRUCTION WHERE ADJUSTMENT IS NEEDED.

## **AECOM**

Gulf Tower 707 Grant Street 5th Floor Pittsburgh, PA 15219

		THE PREPARATION OF THIS DOCUMENT HAS BEEN FINANCED IN
		PART THROUGH A GRANT FROM TH
		FEDERAL TRANSIT ADMINISTRATION U.S. DEPARTMENT OF
		TRANSPORTATION, UNDER THE
		URBAN MASS TRANSPORTATION AC OF 1964. AS AMENDED, FOR THE
DATE	DESCRIPTION	PORT AUTHORITY OF ALLEGHENY COUNTY, PENNSYLVANIA.
	REVISIONS	COUNTY, PENNSTEVANIA.

(NOT FOR CONSTRUCTION)

DESIGNED	MRM	
DRAWN	MRM	
CHECKED	DJC	
IN CHARGE	LAR	
DATE	05/01/24	
SCALE		Г

### PORT AUTHORITY OF ALLEGHENY COUNTY PENNSYLVANIA

BUS RAPID TRANSIT UPTOWN TO OAKLAND DRAINAGE DATA DRAINAGE STRUCTURES A19- A20

Port Authority connecting people to life

CONTRACT NO. BRT-001

AS SHOWN

DWG. NO. CV72 sнт. **147** 

A21-1 FIFTH AVE STA 470+95.00 - 11.00' RT
STORM INLET, PWSA TYPE 13 MODIFIED, W/
3-FLANGE CAST IRON FRAME AND BICYCLE
SAFE GRATE, AND MANHOLE FRAME AND COVER
CONNECTED TO G.I. STRUCTURE\*\*
TG ELEV 848.04, RIM ELEV 848.22
INV 844.36 (8") IN FROM GI
CONTROL STRUCTURE
INV 844.04 (15") OUT TO A20-7 A21-8 FIFTH AVE. STA 473+05.40 - 21.49' RT SIDEWALK TRENCH DRAIN, PWSA W/ ADA COMPLIANT AND BICYCLE SAFE GRATE TG ELEV 852.48 TRENCH INV ELEV 852.15 A20-1 FIFTH AVE STA 466+23.86 - 22.79' RT 4' DIAMETER PWSA MANHOLE, W/ MANHOLE FRAME AND COVER A20-6 FIFTH AVE STA 468+97.90 - 18.00' LT CATCH BASIN, PWSA TYPE 13, W/3-FLANGE CAST IRON FRAME AND BICYCLE 3-FLANGE CAST IRON FRAME SAFE GRATE TG 843.23 INV 839.17 (15") OUT CONNECT TO EXISTING PIPE (FIELD VERIFY) W/ MANHOLE FRAME AND COVER RIM ELEV 837.37 INV 834.20 (15") IN FROM A20-2 INV 834.10 (15") OUT TO EXS PIPE (FIELD VERIFY) \*\*SEE STORMWATER MANAGEMENT PLANS A20-6A) FIFTH AVE STA 468+94.08 - 11.95' LT
EXS STORM/SEWER MANHOLE
PWSA ID: X
RIM ELEV 843.51
GRADE ADJUSTMENT OF EXS PWSA MANHOLE
RIM ELEV 843.26
CORE HOLE IN EXISTING STRUCTURE
INV UNK (15") IN FROM A20-6
- MATCH EXISTING (+/- 832.1) A21-2 FIFTH AVE STA 471+07.00 - 20.67' RT SIDEWALK TRENCH DRAIN, PWSA W/ ADA COMPLIANT AND BICYCLE SAFE GRATE TG ELEV 848.50 TRENCH INV ELEV 847.87 INV 846.42 (6") OUT TO GI-A7A WYE INTO SHARED PIPE FROM A21-4 M21-9 FIFTH AVE. STA 473+92.00 - 21.49' RT SIDEWALK TRENCH DRAIN, PWSA W/ ADA COMPLIANT AND BICYCLE SAFE GRATE A20-2 FIFTH AVE STA 466+26.39 - 11.00' RT CATCH BASIN, PWSA TYPE 13, W/3-FLANGE CAST IRON FRAME AND BICYCLE SAFE GRATE TG ELEV 836.96 INV 834.27 (15") OUT TO A20-1 TG ELEV 853.72 TRENCH INV ELEV 853.39 R21-3 FIFTH AVE. STA 471+86.25 - 20.67' RT SIDEWALK TRENCH DRAIN, PWSA W/ ADA COMPLIANT AND BICYCLE SAFE GRATE TG ELEV 849.90 TRENCH INV ELEV 849.28 A21-10 FIFTH AVE. STA 474+40.64 - 21.50' RT SIDEWALK TRENCH DRAIN, PWSA W/ ADA COMPLIANT AND BICYCLE SAFE GRATE TG\_ELEV 853.71 A20-7 FIFTH AVE STA 469+42.00 - 11.00' RT CATCH BASIN, PWSA TYPE 13, W/ 3-FLANGE CAST IRON FRAME AND BICYCLE SAFE GRAIE. A20-3 FIFTH AVE STA 467+47.17 - 9.57' RT EXS PWSA MANHOLE PWSA ID: MH002G067 RIM ELEV 840.00 TG ELEV 844.32 INV 840.32 (15") IN FROM A21-1 INV 840.22 (15") OUT TO A20-4 TRENCH INV ELEV 853.09 GRADE ADJUSTMENT OF EXS PWSA MANHOLE RIM ELEV 839.87 RIM ELEV 839.87 EXS INVERT 824.50 CORE HOLE IN EXISTING DRAINAGE STRUCTURE INV 836.00 (15") IN FROM A20-4 (FIELD VERIFY) <u>M21-4</u>) FIFTH AVE. STA 472+05.90 - 18.71' RT SIDEWALK TRENCH DRAIN, PWSA W/ ADA COMPLIANT AND BICYCLE SAFE GRATE TG ELEV 850.29 TRENCH INV ELEV 849.67 A21-11 FIFTH AVE. STA 474+83.17 - 21.50' RT SIDEWALK TRENCH DRAIN, PWSA W/ ADA COMPLIANT AND BICYCLE SAFE GRATE TG\_ELEV 853.23 A20-4 FIFTH AVE STA 467+81.13 - 11.00' RT CATCH BASIN, PWSA TYPE 13, W/ 3-FLANGE CAST IRON FRAME AND BICYCLE SAFE GRATE A20-9 FIFTH AVE STA 465+06.39 - 20.67' RT SIDEWALK TRENCH DRAIN, PWSA W/ ADA COMPLIANT AND BICYCLE SAFE GRATE TG ELEV 834.23 SAFE GRATE TG ELEV 840.61 INV 837.61 (6") IN FROM A20-10 INV 836.61 (15") IN FROM A20-7 INV 836.41 (15") OUT TO EXS MANHOLE A20-3 TRENCH INV ELEV 852.61 TRENCH INV ELEV 833.90 (FIELD VERIFY) A21-6 FIFTH AVE. STA 472+60.50 - 32.52' RT SIDEWALK TRENCH DRAIN, PWSA W/ ADA COMPLIANT AND BICYCLE SAFE GRATE TG ELEV 851.04 TRENCH INV ELEV 850.71 A20-5 DINWIDDIE ST. STA 20+34.75 - 14.94' LT CATCH BASIN, PWSA TYPE 13, W/
3-FLANGE CAST IRON FRAME AND BICYCLE SAFE GRATE A20-10 FIFTH AVE STA 467+49.00 - 28.60' RT SIDEWALK TRENCH DRAIN, PWSA W/ ADA COMPLIANT AND BICYCLE SAFE GRATE TG ELEV 839.46\*
TRENCH INV ELEV 838.84
INV 837.36 (6") OUT TO A20-4 A21-12 FIFTH AVE. STA 474+89.75 - 14.88' RT SIDEWALK TRENCH DRAIN, PWSA W/ ADA COMPLIANT AND BICYCLE SAFE GRATE TG ELEV 853.02 TRENCH INV ELEV 852.40 TG ELEV 843.28
INV 839.17 (15") OUT
CONNECT TO EXISTING PIPE
(FIELD VERIFY) \* ADJUST IF NEEDED TO DRAIN ADJACENT LAND M21-7 FIFTH AVE. STA 472+84.85 - 19.45' RT SIDEWALK TRENCH DRAIN, PWSA W/ ADA COMPLIANT AND BICYCLE SAFE GRATE TG\_ELEV 852.30 A21-13 FIFTH AVE STA 475+35.00 - 20.00' LT SIDEWALK TRENCH DRAIN, PWSA W/ ADA COMPLIANT AND BICYCLE SAFE GRATE A20-11 FIFTH AVE STA 469+82.00 - 28.57' RT SIDEWALK DRAIN W/ ADA COMPLIANT AND BICYCLE SAFE GRATE TG ELEV 845.24\*
TRENCH INV ELEV 844.62 TG FLEV 852, 56 TRENCH INV ELEV 851.97

> GENERAL NOTE: DRAINAGE STRUCTURE LOCATIONS, PIPE SIZES, AND ELEVATIONS SHOULD BE ADJUSTED WHERE NECESSARY TO ALIGN W/ EXISTING PIPE WHERE POSSIBLE. DETERMINE EXISTING PIPE ALIGNMENTS AND DEPTHS AND NOTIFY ENGINEER PRIOR TO CATCH BASIN CONSTRUCTION WHERE ADJUSTMENT IS NEEDED.



**Gulf Tower** 707 Grant Street 5th Floor Pittsburgh, PA 15219

			THE PREPARATION OF THIS  DOCUMENT HAS BEEN FINANCED IN
			PART THROUGH A GRANT FROM THE
			FEDERAL TRANSIT ADMINISTRATION,
			U.S. DEPARTMENT OF TRANSPORTATION, UNDER THE
			URBAN MASS TRANSPORTATION ACT OF 1964, AS AMENDED, FOR THE
NO.	DATE	DESCRIPTION	PORT AUTHORITY OF ALLEGHENY COUNTY, PENNSYLVANIA.
		REVISIONS	COUNTY, FERINGTEVARIA.

\* ADJUST IF NEEDED TO DRAIN ADJACENT LAND

(NOT FOR CONSTRUCTION)

DESIGNED	MRM
DRAWN	<u>MRM</u>
CHECKED	DJC
IN CHARGE	LAR
DATE	<u>05/01/24</u>
SCALE	

AS SHOWN

TRENCH INV ELEV 851.94

#### PORT AUTHORITY OF ALLEGHENY COUNTY PITTSBURGH PENNSYLVANIA

BUS RAPID TRANSIT UPTOWN TO OAKLAND DRAINAGE DATA

DRAINAGE STRUCTURES A21 - A22

**Port Authority** 

CONTRACT NO. BRT-001 DWG. NO. CV73 sнт. 148 A22-6 FIFTH AVE. STA 477+00.00 - 21.50' RT SIDEWALK TRENCH DRAIN, PWSA W/ ADA COMPLIANT AND BICYCLE SAFE GRATE TG ELEV 848.26 TRENCH INV ELEV 847.64 INV 846.16 (6") OUT FROM A22-2

A23-1A FIFTH AVE STA 482+17.07 - 5.97' RT
4' DIAMETER PWSA MANHOLE,
W/ MANHOLE FRAME AND COVER W/ MANDULE FRAME AND COVER RIM ELEV 829.57 INV 826.30 (15") IN FROM A23-2 INV 822.30 (15") OUT MATCH EXISTING PIPE (FIELD VERIFY)

A22-7 FIFTH AVE. STA 479+75.00 - 13.52' LT SIDEWALK TRENCH DRAIN, PWSA W∕ ADA COMPLIANT AND BICYCLE SAFE GRATE TG ELEV 838.77 TRENCH INV ELEV 838.44

A23-2 FIFTH AVE STA 481+64.00 - 10.50' RT CATCH BASIN, PWSA TYPE 13, W/3-FLANGE CAST IRON FRAME AND BICYCLE SAFE GRATE
TG ELEV 831.54
INV 827.94 (6") IN FROM A23-4
INV 827.74 (15") OUT TO A23-1A

A22-8 FIFTH AVE. STA 479+61.00 - 24.00' LT SIDEWALK TRENCH DRAIN, PWSA W/ ADA COMPLIANT AND BICYCLE SAFE GRATE TG ELEV 839.07 TRENCH INV ELEV 838.74

A23-3 FIFTH AVE STA 482+57.05 - 19.61 LT CATCH BASIN, PWSA TYPE 13, W/3-FLANGE CAST IRON FRAME AND BICYCLE SAFE GRATE
TG ELEV 827.69
INV 823.69 (15") OUT
CONNECT TO EXISTING PIPE
(FIELD VERIFY)

A22-9 FIFTH AVE. STA 478+23.00 - 24.00' LT SIDEWALK TRENCH DRAIN, PWSA W/ ADA COMPLIANT AND BICYCLE SAFE GRATE TG ELEV 844.38 TRENCH INV ELEV 844.05

A23-4 FIFTH AVE. STA 481+66.00 - 21.50' RT SIDEWALK TRENCH DRAIN, PWSA W/ ADA COMPLIANT AND BICYCLE SAFE GRATE TG ELEV 831.51 TRENCH INV ELEV 830.89 INV 829.41 (6") OUT TO A23-2

A22-5 FIFTH AVE. STA 476+39.00 - 21.50' RT SIDEWALK TRENCH DRAIN, PWSA W/ ADA COMPLIANT AND BICYCLE SAFE GRATE TG ELEV 849.53

A22-1 FIFTH AVE STA 477+50.33- 9.17' LT CATCH BASIN, PWSA TYPE 13, W/ 3-FLANGE CAST IRON FRAME AND BICYCLE

FIFTH AVE STA 477+16.00 - 20.00' LT SIDEWALK TRENCH DRAIN, PWSA W/ ADA COMPLIANT AND BICYCLE SAFE GRATE TG ELEV 847.92 TRENCH INV ELEV 847.30 INV 845.82 (6") OUT FROM A22-1

A23-5 FIFTH AVE. STA 482+98.59 - 20.00' RT SIDEWALK TRENCH DRAIN, PWSA W/ ADA COMPLIANT AND BICYCLE SAFE GRATE TG ELEV 826.35 TRENCH INV ELEV 825.73

FIFTH AVE. STA 478+27.00 - 21.50' RT SIDEWALK TRENCH DRAIN, PWSA W/ ADA COMPLIANT AND BICYCLE SAFE GRATE TG ELEV 844.01 TRENCH INV ELEV 843.39

\*SHIFT MANHOLE LID TO MATCH INLET STEPS IF PRESENT. COORDINATE ELEVATION ADJUSTMENT W/ ENGINEER.

**Gulf Tower** 707 Grant Street 5th Floor Pittsburgh, PA 15219

THE PREPARATION OF THIS DOCUMENT HAS BEEN FINANCED IN PART THROUGH A GRANT FROM THE FEDERAL TRANSIT ADMINISTRATION U.S. DEPARTMENT OF TRANSPORTATION, UNDER THE URBAN MASS TRANSPORTATION ACT OF 1964 AS AMENDED FOR THE PORT AUTHORITY OF ALLEGHENY COUNTY, PENNSYLVANIA. NO. DATE DESCRIPTION REVISIONS

(NOT FOR CONSTRUCTION)

DESIGNED	<u>MRM</u>
DRAWN	MRM
CHECKED	DJC
IN CHARGE	LAR
DATE	<u>05/01/24</u>
SCALE	

#### PORT AUTHORITY OF ALLEGHENY COUNTY PITTSBURGH PENNSYLVANIA BUS RAPID TRANSIT UPTOWN TO OAKLAND

DRAINAGE STRUCTURE LOCATIONS, PIPE SIZES, AND ELEVATIONS SHOULD BE ADJUSTED WHERE NECESSARY TO ALIGN W/ EXISTING PIPE WHERE POSSIBLE. DETERMINE EXISTING PIPE ALIGNMENTS AND DEPTHS AND NOTIFY ENGINEER PRIOR TO CATCH BASIN CONSTRUCTION WHERE ADJUSTMENT IS NEEDED.

DRAINAGE DATA DRAINAGE STRUCTURES A23 - A25

**Port Authority** 

GENERAL NOTE:

CONTRACT NO. BRT-001 DWG. NO. CV74 sнт. **149** 

AS SHOWN

A24-1 FIFTH AVE STA 486+34.98 - 20.00' LT EXISTING INLET PWSA ID: CB0011L002 TG ELEV 813.06 ELEV 808.95 (DEBRIS) GRADE ADJUSTMENT OF EXISTING PWSA INLET TG ELEV 813.09	A24-5 FIFTH AVE STA 485+94.78 - 8.94' RT SIDEWALK TRENCH DRAIN, PWSA W/ ADA COMPLIANT AND BICYCLE SAFE GRATE TG ELEV 815.31 TRENCH INV ELEV 814.69	A25-1 FIFTH AVE STA 490+63.62 - 20.00' LT EXISTING INLET GRADE ADJUSTMENT OF EXISTING PWSA INLET TG ELEV 815.37 EXISTING INVERT UNK	A25-4A KIRKPATRICK ST STA 30+89.00 - 15.00' LT CORED WYE CONNECTION INV (15") IN FROM A25-4 (MATCH EXISTING)	A25-15 FIFTH AVE. STA 491+50.21- 80.18' LT TYPE 5 INLET BOX W/ TRANSITION SLAB SIDEWALK DRAIN W/ ADA COMPLIANT AND BICYCLE SAFE GRATE TG ELEV 823.70 INV 817.04 (42") OUT TO A25-21
A24-1A FIFTH AVE STA 486+08.57 - 2.20' LT CUT IN WYE PIPE TRANSITION INV (15") TO FROM A24-2 (MATCH EXISTING)	A24-6 FIFTH AVE STA 488+98.21 - 19.90' LT EXISTING INLET PWSA ID: SIO11L002 TG ELEV 809.75 ELEV 807.64 (DEBRIS) GRADE ADJUSTMENT OF EXISTING PWSA INLET TG ELEV 809.75	A25-2 FIFTH AVE STA 491+35.58 - 27.51' RT CATCH BASIN, PWSA TYPE 13, W/ 3-FLANGE CAST IRON FRAME AND BICYCLE SAFE GRATE TG ELEV 818.76 INV 815.66 (15") OUT TO A25-2A	A25-5 FIFTH AVE STA 491+63.90 - 21.50' LT CATCH BASIN, PWSA TYPE 13, W/ 3-FLANGE CAST IRON FRAME AND BICYCLE SAFE GRATE TG ELEV 819.50 INV 815.42 (15") OUT CONNECT TO EXISTING PIPE (FIELD VERIFY)	A25-16 FIFTH AVE. 491+60.14 - 23.94' LT CCTV STA 5+60.00 SEWER TAP TO EXISTING SEWER WYE, AT EXISTING PWSA 15" VCP SEWER MAIN (8") IN FROM FROM A25-17 MAIN AT INVERT 811.23* 560.0' DOWNSTREAM OF MHO11L001 (FIELD VERIFY) PRIOR TO CONSTRUCTION
A24-2 FIFTH AVE STA 486+04.27 - 6.09' RT CATCH BASIN, PWSA TYPE 5 W/BASKET GRATE G.I. CONTROL STRUCTURE** RIM ELEV 814.26' INV 809.10 (15") OUT TO A24-1A **SEE STORMWATER MANAGEMENT PLANS	A24-7 FIFTH AVE STA 489+35.43 - 17.79' LT CATCH BASIN, PWSA TYPE 13, W/3-FLANGE CAST IRON FRAME AND BICYCLE SAFE GRATE TG ELEV 810.50 INV 806.50 (15") OUT TO A24-8	A25-2A FIFTH AVE STA 490+97.05 - 21.65' RT PWSA REBUILT INLET BOX W/ MANHOLE TOP RIM ELEV 817.52 INV 814.80 (15") IN FROM A25-2 INV 814.80 (15") OUT CONNECT TO EXISTING PIPE (FIELD VERIFY)	A25-5A FIFTH AVE STA 491+53.00 - 24.00' LT CUT IN WYE PIPE TRANSITION INV (15") IN FROM A25-5 (MATCH EXISTING)	A25-17 FIFTH AVE. STA 491+66.20 - 30.63' LT DRAINAGE CLEANOUT STRUCTURE TOP ELEVATION 819.92' INV ELEV 815.00' (8") IN FROM A25-18 INV ELEV 815.00' (8") OUT TO A25-16 (FIELD VERIFY) PRIOR TO CONSTRUCTION
A24-3 FIFTH AVE STA 486+79.74 - 22.51' LT EXISTING INLET PWSA ID: CB0011L001 TG ELEV 812.12 GRADE ADJUSTMENT OF EXISTING PWSA INLET TG ELEV 811.92 ELEV 808.72 (WATER)	A24-8 FIFTH AVE STA 489+46.24 - 21.55' LT PWSA DOGHOUSE MANHOLE, W/ MANHOLE FRAME AND COVER RIM ELEV 811.37 INV 806.00 (15") IN FROM A24-7 INV (15") MATCH EXS	A25-3 KIRKPATRICK ST STA 30+52.36 - 14.26' LT CATCH BASIN, PWSA TYPE 13 REVERSE MODIFIED, W/ 3-FLANGE CAST IRON FRAME AND BICYCLE SAFE GRATE AND MANHOLE FRAME AND COVER TG ELEV 819.20, RIM ELEV 819.34	A25-6 FIFTH AVE STA 492+34.12 - 19.22' RT * PWSA RECESSED CATCH BASIN CONVERSION RIM ELEV 823.33 CONNECTED TO G.I. STRUCTURE SEE STORMWATER MANAGEMENT PLANS	A25-18 FIFTH AVE. STA 491+71.40 - 32.54' LT TRAP AND VENT TOP ELEVATION FLUSH W/ GROUND SURFACE INV ELEV 816.30' (8") IN FROM A25-22 INV ELEV 815.50' (8") OUT TO A25-17 (FIELD VERIFY) PRIOR TO CONSTRUCTION
A24-4 FIFTH AVE STA 487.30+42 - 20.00' LT  EXISTING INLET  PWSA ID: CB0011L004  TG ELEV 810.70  GRADE ADJUSTMENT OF EXISTING PWSA INLET  TG ELEV 811.20  ELEV 807.50 (DEBRIS)	A24-9 FIFTH AVE STA 485+87.00 - 20.00' RT SIDEWALK TRENCH DRAIN, PWSA W/ ADA COMPLIANT AND BICYCLE SAFE GRATE TG ELEV 815.67 TRENCH INV ELEV 815.05	A25-3A KIRKPATRICK ST STA 30+73.43 - 33.60' LT EXISTING INLET GRADE ADJUSTMENT OF EXISTING PWSA INLET TG ELEV 821.00	A25-7 FIFTH AVE STA 494+50.00 - 18'.00 LT CATCH BASIN, PWSA TYPE 13 MODIFIED, W/3-FLANGE CAST IRON FRAME AND BICYCLE SAFE GRATE, AND MANHOLE FRAME AND COVER TG ELEV 831.14, RIM ELEV 831.76 INV 828.26 (15") OUT CONNECT TO EXISTING PIPE (FIELD VERIFY)	
		A25-4 KIRKPATRICK ST. STA 30+92.91 - 22.00' LT CATCH BASIN, PWSA TYPE 13, W/ 3-FLANGE CAST IRON FRAME AND BICYCLE SAFE GRATE TG ELEV 823.25 INV 819.25 (15") OUT CONNECT TO EXISTING PIPE (FIELD VERIFY)		
*SHIFT MANHOLE LID TO MATCH INLET STEPS IF PRESENT. COORDINATE ELEVATION				GENERAL NOTE:  DRAINAGE STRUCTURE LOCATIONS, PIPE SIZES, AND ELEVATIONS SHOULD BE ADJUSTED WHERE NECESSARY TO ALIGN W/ EXISTING PIPE WHERE POSSIBLE.  DETERMINE EXISTING PIPE ALIGNMENTS AND DEPTHS AND NOTIFY ENGINEER PRIOR TO CATCH BASIN CONSTRUCTION WHERE ADJUSTMENT IS NEEDED.

\*SHIFT MANHOLE LID TO MATCH INLET STEPS IF PRESENT. COORDINATE ELEVATION ADJUSTMENT W/ ENGINEER.

<b>AECOM</b>
--------------

Gulf Tower 707 Grant Street 5th Floor Pittsburgh, PA 15219

		THE PREPARATION OF THE	
		THE PREPARATION OF THIS  DOCUMENT HAS BEEN FINANCED IN	
		PART THROUGH A GRANT FROM TH	
		FEDERAL TRANSIT ADMINISTRATION	
		TRANSPORTATION, UNDER THE	
		URBAN MASS TRANSPORTATION A OF 1964, AS AMENDED, FOR THE	URBAN MASS TRANSPORTATION
DATE		PORT AUTHORITY OF ALLEGHENY COUNTY, PENNSYLVANIA.	
	REVISIONS	COUNTY, FERNISTEVANIA.	

(NOT FOR CONSTRUCTION)

DESIGNED	MRM	
DRAWN	MRM	
CHECKED	DJC	
IN CHARGE	<u>LAR</u>	
DATE	05/01/24	
SCALE	AS SHOWN	
	AS SHOWIN	

### PORT AUTHORITY OF ALLEGHENY COUNTY PENNSYLVANIA

BUS RAPID TRANSIT UPTOWN TO OAKLAND DRAINAGE DATA DRAINAGE STRUCTURES A25 - A28

Port Authority connecting people to life

CONTRACT NO. BRT-001

DWG. NO. CV75 sнт. **150**  A22-4 WYANDOTTE ST 30+50.24 - 8.70' RT
EXISTING INLET
PWSA ID: X
TG ELEV 846.32
GRADE ADJUSTMENT OF EXISTING PWSA INLET TG ELEV 846.44

A23-1A FIFTH AVE STA 482+17.07 - 5.97' RT
4' DIAMETER PWSA MANHOLE,
W/ MANHOLE FRAME AND COVER
RIM ELEV 829.57
INV 826.30 (15") IN FROM A23-2
INV 822.30 (15") OUT
MATCH EXISTING PIPE (FIELD VERIFY)

A23-4 FIFTH AVE. STA 481+66.00 - 21.50' RT SIDEWALK TRENCH DRAIN, PWSA W/ ADA COMPLIANT AND BICYCLE SAFE GRATE TG ELEV 831.51 TRENCH INV ELEV 830.89 INV 829.41 (6") OUT TO A23-2

A24-3 FIFTH AVE STA 486+79.74 - 22.51' LT FIFTH AVE STA 4007/3.74 - 22.57 LT
EXISTING INLET
PWSA ID: CB001/L001
TG ELEV 812.12
GRADE ADJUSTMENT OF EXISTING PWSA INLET
TG ELEV 811.92 ELEV 808.72 (WATER)

A24-4 FIFTH AVE STA 487.30+42 - 20.00' LT EXISTING INLET PWSA ID: CB0011L004 TG ELEV 810.70 GRADE ADJUSTMENT OF EXISTING PWSA INLET

A24-5 FIFTH AVE STA 485+94.78 - 8.94' RT SIDEWALK TRENCH DRAIN, PWSA W/ ADA COMPLIANT AND BICYCLE SAFE GRATE TG ELEV 815.31 TRENCH INV ELEV 814.69

TG ELEV 811.20 ELEV 807.50 (DEBRIS)

A22-5 FIFTH AVE. STA 476+39.00 - 21.50' RT SIDEWALK TRENCH DRAIN, PWSA W/ ADA COMPLIANT AND BICYCLE SAFE GRATE TG ELEV 849.53 TRENCH INV ELEV 848.91

A23-2 FIFTH AVE STA 481+64.00 - 10.50' RT CATCH BASIN, PWSA TYPE 13, W/3-FLANGE CAST IRON FRAME AND BICYCLE SAFE GRATE
TG ELEV 831.54
INV 827.94 (6") IN FROM A23-4
INV 827.74 (15") OUT TO A23-1A

A24-1 FIFTH AVE STA 486+34.98 - 20.00' LT
EXISTING INLET
PWSA ID: CB0011L002
TG ELEV 813.06
ELEV 808.95 (DEBRIS)
GRADE ADJUSTMENT OF EXISTING PWSA INLET TG ELEV 813.09

A22-6 FIFTH AVE. STA 477+00.00 - 21.50' RT SIDEWALK TRENCH DRAIN, PWSA W/ ADA COMPLIANT AND BICYCLE SAFE GRATE TG ELEV 848.26 TRENCH INV ELEV 847.64 INV 846.16 (6") OUT FROM A22-2

Δ23-3 FIFTH AVE STA 482+57.05 - 19.61 LT CATCH BASIN, PWSA TYPE 13, W/ 3-FLANGE CAST IRON FRAME AND BICYCLE SAFE GRATE TG ELEV 827.69 INV 823.69 (15") OUT CONNECT TO EXISTING PIPE (FIELD VERIFY)

A24-1A FIFTH AVE STA 486+08.57 - 2.20' LT CUT IN WYE PIPE TRANSITION INV (15") TO FROM A24-2 (MATCH EXISTING)

A22-7 FIFTH AVE. STA 479+75.00 - 13.52' LT SIDEWALK TRENCH DRAIN, PWSA W/ ADA COMPLIANT AND BICYCLE SAFE GRATE TG ELEV 838.77 TRENCH INV ELEV 838.44

A22-8 FIFTH AVE. STA 479+61.00 - 24.00' LT SIDEWALK TRENCH DRAIN, PWSA W/ ADA COMPLIANT AND BICYCLE SAFE GRATE TG ELEV 839.07 TRENCH INV ELEV 838.74

A23-5 FIFTH AVE. STA 482+98.59 - 20.00' RT SIDEWALK TRENCH DRAIN, PWSA W/ ADA COMPLIANT AND BICYCLE SAFE GRATE TG ELEV 826.35 TRENCH INV ELEV 825.73

A24-2 FIFTH AVE STA 486+04.27 - 6.09' RT CATCH BASIN, PWSA TYPE 5 W/BASKET GRATE G.I. CONTROL STRUCTURE\*\*
RIM ELEV 814.26'
INV 809.10 (15") OUT TO A24-1A
\*\*SEE STORMWATER MANAGEMENT PLANS

A24-6 FIFTH AVE STA 488+98.21 - 19.90' LT EXISTING INLET PWSA ID: S1011L002 TG ELEV 809.75 ELEV 807.64 (DEBRIS)
GRADE ADJUSTMENT OF EXISTING PWSA INLET TG ELEV 809.75

A24-7 FIFTH AVE STA 489+35.43 - 17.79' LT CATCH BASIN, PWSA TYPE 13, W/3-FLANGE CAST IRON FRAME AND BICYCLE SAFE GRATE TG ELEV 810.50 INV 806.50 (15") OUT TO A24-8

sнт. **151** 

DWG. NO. CV76

AECOM

**Gulf Tower** 707 Grant Street 5th Floor Pittsburgh, PA 15219

THE PREPARATION OF THIS DOCUMENT HAS BEEN FINANCED IN PART THROUGH A GRANT FROM THE FEDERAL TRANSIT ADMINISTRATION U.S. DEPARTMENT OF TRANSPORTATION, UNDER THE URBAN MASS TRANSPORTATION ACT OF 1964, AS AMENDED, FOR THE PORT AUTHORITY OF ALLEGHENY COUNTY, PENNSYLVANIA. NO. DATE DESCRIPTION REVISIONS

DESIGNED	MRM	PORT AUTHOR	ITY OF ALLEGHENY C	OUNTY				
DRAWN	MRM	PITTSBURGH	P	ENNSYLVANIA				
CHECKED	DJC	BUS RAPID TRANSIT UPTOWN TO OAKLAND						
IN CHARGE	LAR	DRAINAGE DATA						
DATE	05/01/24	DRAINAGE STRUCTURES A29 - A35						
SCALE	AS SHOWN	Port Authority	CONTRACT NO. BR1	-001				
	AS SHOWIN	I OIL / tutilolity	0) (=0					

(NOT FOR CONSTRUCTION) [A25-1] FIFTH AVE STA 490+63.62 - 20.00' LT EXISTING INLET GRADE ADJUSTMENT OF EXISTING PWSA INLET TG ELEV 815.37 EXISTING INVERT UNK

A25-2 FIFTH AVE STA 491+35.58 - 27.51' RT
CATCH BASIN, PWSA TYPE 13, W/
3-FLANGE CAST IRON FRAME AND BICYCLE SAFE
GRATE
TG ELEV 818.76
INV 815.66 (15") OUT TO A25-2A

A25-2A FIFTH AVE STA 490+97.05 - 21.65' RT
PWSA REBUILT INLET BOX
W/ MANHOLE TOP
RIM ELEV 817.52
INV 814.80 (15") IN FROM A25-2
INV 814.80 (15") OUT
CONNECT TO EXISTING PIPE
(FIELD VERIFY)

A25-10 FIFTH AVE. STA 492+02.79 - 25.17' LT TRAP, VENT, AND CLEANOUT INVERT ELEV 816.70' (6") IN FROM A25-11 INVERT ELEV 816.00' (6") OUT TO A25-9 A25-3 KIRKPATRICK ST STA 30+52.36 - 14.26' LT CATCH BASIN, PWSA TYPE 13 REVERSE MODIFIED, W/ 3-FLANGE CAST IRON FRAME AND BICYCLE SAFE GRATE AND MANHOLE FRAME AND COVER TG ELEV 819.20, RIM ELEV 819.34

A25-3A KIRKPATRICK ST STA 30+73.43 - 33.60' LT EXISTING INLET GRADE ADJUSTMENT OF EXISTING PWSA INLET TO FIEW 821.00

A25-4 KIRKPATRICK ST. STA 30+92.91 - 22.00' LT CATCH BASIN, PWSA TYPE 13, W/ 3-FLANGE CAST IRON FRAME AND BICYCLE SAFE GRATE TG ELEV 823.25 INV 819.25 (15") OUT CONNECT TO EXISTING PIPE (FIELD VERIFY) FIFTH AVE STA 496+92.64 - 18.00' LT CATCH BASIN, PWSA TYPE 13 MODIFIED, W/3-FLANGE CAST IRON FRAME AND BICYCLE SAFE GRATE, AND MANHOLE FRAME AND COVER TG ELEV 840.60, RIM ELEV 841.25 INV 837.25 (15") OUT CONNECT TO EXISTING PIPE (FIELD VERIFY)

FIFTH AVE STA 497+34.97 - 18.00' LT CATCH BASIN, PWSA TYPE 13 MODIFIED, W/3-FLANGE CAST IRON FRAME AND BICYCLE SAFE GRATE, AND MANHOLE FRAME AND COVER TG ELEV 842.32, RIM ELEV 842.93 INV 838.06 (15") OUT CONNECT TO EXISTING PIPE (FIELD VERIFY)

FIFTH AVE STA 503+46.91 - 21.04' RT \* PWSA RECESSED CATCH BASIN CONVERSION RIM ELEV 866.93

A26-3 FIFTH AVE STA 497+46.65 - 21.39' RT \*
PWSA RECESSED CATCH BASIN CONVERSION
RIM ELEV 842.90

FIFTH AVE STA 504+37.71 - 19.00' LT
CATCH BASIN, PWSA TYPE 13, W/
3-FLANGE CAST IRON FRAME AND BICYCLE
SAFE GRATE
TG ELEV 869.84
INV 865.84 (15") OUT
CONNECT TO EXISTING PIPE
(FIELD VERIFY)

A26-4 FIFTH AVE STA 500+49.13 - 18.00' LT CATCH BASIN, PWSA TYPE 13 MODIFIED, W/3-FLANGE CAST IRON FRAME AND BICYCLE SAFE GRATE, AND MANHOLE FRAME AND COVER TG ELEV 854.32, RIM ELEV 854.96 INV 850.96 (15") OUT CONNECT TO EXISTING PIPE (FIELD VERIFY)

FIFTH AVE STA 504+84.46 - 19.00' LT CATCH BASIN, PWSA TYPE 13, W/3-FLANGE CAST IRON FRAME AND BICYCLE SAFE GRATE TG ELEV 871.69 INV 867.69 (15") OUT CONNECT TO EXISTING PIPE (FIELD VERIFY)

A26-5 FIFTH AVE STA 501+88.76 - 20.85' RT \*
PWSA RECESSED CATCH BASIN CONVERSION
RIM ELEV 860.82

SCALE

AS SHOWN

PERSONNEL TO EXECUTE TO SELECT THE PROPERTY OF 
**AECOM** 

Gulf Tower 707 Grant Street 5th Floor Pittsburgh, PA 15219 THE PREPARATION OF THIS
DOCUMENT HAS BEEN FINANCED IN
PART THROUGH A GRANT FROM THE
FEDERAL TRANSIT ADMINISTRATION,
U.S. DEPARTMENT OF
TRANSPORTATION, UNDER THE
URBAN MASS TRANSPORTATION ACT
OF 1964, AS AMENDED, FOR THE
NO. DATE
DESCRIPTION
REVISIONS

THE PREPARATION OF THIS
PEDERAL TRANSPORTATION, UNDER THE
URBAN MASS TRANSPORTATION ACT
OF 1964, AS AMENDED, FOR THE
PORT AUTHORITY OF ALLEGHENY
COUNTY, PENNSYLVANIA.

(NOT FOR CONSTRUCTION)

DESIGNED	MRM	PORT AUTHORITY OF ALLEGHENY COUNTY
DRAWN	MRM	PITTSBURGH PENNSYLVANIA
CHECKED	DJC	BUS RAPID TRANSIT UPTOWN TO OAKLAND
IN CHARGE	LAR	DRAINAGE DATA
DATE	05/01/24	DRAINAGE STRUCTURES A36 - A38

Port Authority

CONTRACT NO. BRT-001

DWG. NO. CV77 SHT. 152

GOT-1 FORBES AVE STA 123+02. CATCH BASIN, PWSA TYPE W/ 3-FLANGE CAST IRON BICYCLE SAFE GRATE TG ELEV 781.80 INV 777.39* (15") OUT *FIELD VERIFY PRIOR TO	13, C FRAME AND W B G TO EXS PIPE TI CONSTRUCTION I	ORBES AVE STA 142+30.52 - 34.9' LT ATCH BASIN, PWSA TYPE 13, '7 3-FLANGE CAST IRON FRAME AND ICYCLE SAFE GRATE .I. CONTROL STRUCTURE* G ELEV 799.31 NV 791.31 (15") OUT TO GO4-5 SEE STORMWATER MANAGEMENT PLANS	CATCH W/ 3-F BICYCL G.I. C TG ELE INV 80 *SEE S	AVE STA 146+00.00 - 18.5' RT BASIN, PWSA TYPE 13, LANGE CAST IRON FRAME AND E SAFE GRATE ONTROL STRUCTURE* V 804.85 0.25** (15") OUT TO EXS PIPE TORMWATER MANAGEMENT PLANS D VERIFY PRIOR TO CONSTRUCTIO		CATCH BASIN, PWS. W/3-FLANGE CAST BICYCLE SAFE GRA' G.I. CONTROL STRI TG ELEV 811.24 INV 807.30** (15 *SEE STORWWATER!	IRON FRAME AND TE JCTURE* ") OUT TO EXS PIPE	PWSA SIDEWALK COMPLIANT AND TG ELEV 812.69 TRENCH INV ELE		
GO1-2 FORBES AVE STA 126+25. CATCH BASIN, PWSA TYPE W/3-FLANGE CAST IRON BICYCLE SAFE GRATE TG ELEV 791.67 INV 787.73* (15") OUT *FIELD VERIFY PRIOR TO	13 MODIFIED, E FRAME AND R M TO EXS PIPE C CONSTRUCTION I	ORBES AVE STA 142+63.86 - 5.0' LT XS MANHOLE IM ELEVATION 800.32 ANHOLE COVER ADJUSTMENT IM ELEVATION 800.22' ORE HOLE IN EXISTING DRAINAGE STRUCTURE NV 789.23 (15") IN FROM GO4-4 NV 782.82 (36") IN FROM EX PIPE PWSA MH002M035)	CUT IN	AVE STA 146+39.65 - 3.4' LT WYE PIPE TRANSITION 5") IN FROM GOS-7 (MATCH EXIS		J FORBES AVE STA 14 CATCH BASIN, PWS. W/3-FLANGE CAST BICYCLE SAFE GRA' TG ELEV 812.21 INV 810.37 (6") INV 802.21 (15")	IRON FRAME AND TE IN FROM GO5-19	BICYCLE SAFE GR TG ELEV 814.90	SA TYPE 13, T IRON FRAME AND	
GO1-3 FORBES AVE STA 127+37. CATCH BASIN, PWSA TYPE W/3-FLANGE CAST IRON BICYCLE SAFE GRATE TG ELEV 794.76 INV 792.38* (15") OUT *FIELD VERIFY PRIOR TO	13, FRAME AND TO EXS PIPE	STEVENSON ST STA 12+15.28 - 17.9' LT CATCH BASIN, PWSA TYPE 13, W/ 3-FLANGE CAST IRON FRAME AND BICYCLE SAFE GRATE TG ELEV 800.88 INV 796.01* (15") OUT TO EXS PIPE *FIELD VERIFY PRIOR TO CONSTRUCTION	CATCH W/ 3-F BICYCL G. I. C TG ELE INV 79	AVE STA 146+39.65 - 10.5' LT BASIN, PWSA TYPE 13, LANGE CAST IRON FRAME AND E SAFE GRATE ONTROL STRUCTURE* V 806.00 6.00 (15") OUT TO GO5-7 TORMWATER MANAGEMENT PLANS	r ( <u>G05-1</u>	4 MARION ST STA 20- CUT IN WYE PIPE - INV (15") IN FROM		BICYCLE SAFE GR G.I. CONTROL ST TG ELEV 814.83 INV 805.83 (15"	SA TYPE 13, T IRON FRAME AND ATE	
GO2-1 FORBES AVE STA 129+56. CATCH BASIN, PWSA TYPE W/ 3-FLANGE CAST IRON BICYCLE SAFE GRATE TG ELEV 800.11 INV 795.80* (15") OUT *FIELD VERIFY PRIOR TO	13 MODIFIED, CFRAME AND WB  TO EXS PIPE TO CONSTRUCTION	ORBES AVE STA 143+60.00 - 20.9' RT ATCH BASIN, PWSA TYPE 13, / 3-FLANGE CAST IRON FRAME AND ICYCLE SAFE GRATE I. CONTROL STRUCTURE* G ELEV 801.39 NV 791.39 (15") OUT TO GO5-2 SEE STORMWATER MANAGEMENT PLANS	CATCH W/ 3-F BICYCL TG ELE	ST STA 27+15.09 - 14.4′ RT BASIN, PWSA TYPE 13, LANGE CAST IRON FRAME AND E SAFE GRATE V 805.08 7.08 (15") OUT TO G05-9	(G05-1	5 MARION ST STA 20- CATCH BASIN, PWS, W/3-FLANGE CAST BICYCLE SAFE GRA' TG ELEV 810.94 INV 802.94 (15")	A TYPE 13, IRON FRAME AND IE	GO6-3 FORBES AVE STA CUT IN WYE PIPE INV (15") IN FR		IG)
GO2-2 FORBES AVE STA 132+45. CATCH BASIN, PWSA TYPE W/ 3-FLANGE CAST IRON BICYCLE SAFE GRATE TG ELEV 803.28 INV 798.41* (15") OUT *FIELD VERIFY PRIOR TO	13 MODIFIED, E	ORBES AVE STA 143+78.68 - 2.7' LT  XS MANHOLE ANHOLE COVER ADJUSTMENT IM ELEVATION 801.76' ORE HOLE IN EXISTING DRAINAGE STRUCTURE NV 790.56 (15") IN FROM GO5-1  NV. 784.46 (36") IN FROM EX PIPE PWSA MH002M018)	CUT IN	ST STA 27+15.09 - 3.6′ LT WYE PIPE TRANSITION 5") IN FROM GO5-8 (MATCH EXIS		6 MARION ST STA 20- CATCH BASIN, PWS. W/3-FLANGE CAST BICYCLE SAFE GRA' TG ELEV 810.87 INV 802.87 (15")	A TYPE 13, IRON FRAME AND TE	W/ 3-FLANGE´CAS BICYCLE SAFE GR TG ELEV 822.36	SA TYPE 13 MODIFIED, T IRON FRAME AND ATE IN FROM GO6-13	
GO2-3 FORBES AVE STA 132+35. CATCH BASIN, PWSA TYPE W/3-FLANGE CAST IRON BICYCLE SAFE GRATE TG ELEV 803.21 INV 799.27* (15") OUT *FIELD VERIFY PRIOR TO	13 MODIFIED, C FRAME AND W B T TO EXS PIPE I	RIDE ST STA 12+07.00 - 14.8' LT ATCH BASIN, PWSA TYPE 13, '3-FLANGE CAST IRON FRAME AND ICYCLE SAFE GRATE G ELEV 804.20 NV 796.20 (15") OUT TO GO5-4	CATCH W/ 3- BICYC TG EL INV 7	ST STA 12+08.50 - 15.0' RT BASIN, PWSA TYPE 13, FLANGE CAST IRON FRAME AND LE SAFE GRATE EV 804.63 99.47* (15") OUT TO EXS PIPE D VERIFY PRIOR TO CONSTRUCTIO		7 MARION ST STA 20- CUT IN WYE PIPE - INV (15") IN FROM		GO6-5 VAN BRAAM ST ST CATCH BASIN, PW W/3-FLANGE CAS BICYCLE SAFE GR TG ELEV 821.87 INV 813.87 (15"	SA TYPE 13, T IRON FRAME AND ATE	
GO4-3 FORBES AVE STA 141+56. CATCH BASIN, PWSA TYPE W/3-FLANGE CAST IRON BICYCLE SAFE GRATE TG ELEV 799.70 INV 795.76* (15") OUT *FIELD VERIFY PRIOR TO	13 MODIFIED, CI FRAME AND II	RIDE ST STA 12+07.32 - 5.3′ RT UT IN WYE PIPE TRANSITION NV (15") IN FROM GO5-3 (MATCH EXISTING)	CUT I	S AVE STA 148+92.05 - 2.4′ LT N WYE PIPE TRANSITION 15") IN FROM GOS-13 (MATCH EX		8 MARION ST STA 12: EXISTING INLET PO ELEVATION 810.33 INLET GRATE ADJU: PROPOSED GRATE EI EXISTING INVERT	VSA INOO2MOO3 STMENT	ELEVATIONS SHOULD BE TO ALIGN WITH EXISTI DETERMINE EXISTING P	GINEER PRIOR TO CATCH	ARY
GANN Gulf Tower  GANN Suite	GANNETT FLEMING NETT FLEMING, INC. r Plaza 8 400		Di   Pi   Fi   U.	HE PREPARATION OF THIS OCUMENT HAS BEEN FINANCED IN ART THROUGH A GRANT FROM THE EDERAL TRANSIT ADMINISTRATION, S. DEPARTMENT OF RANSPORTATION, UNDER THE	(NOT ONSTRI		DESIGNED         TCG           DRAWN         DPV           CHECKED         KCF           IN CHARGE         GEC	PITTSBURGH BUS RAPID TR	ANSIT UPTOWN TO OA DRAINAGE DATA	PENNSYLVANIA NKLAND
707 Grant Street 730 H 5th Floor Pittsburgh, PA 15219	oliday Drive urgh, PA. 15220	O. DATE DESCRIPTION REVISIONS	UI O Pri	RBAN MASS TRANSPORTATION ACT F 1964, AS AMENDED, FOR THE DORT AUTHORITY OF ALLEGHENY DUNTY, PENNSYLVANIA.			DATE 05/01/24  SCALE  AS SHOWN	Port Authority	E STRUCTURES G01 - G06 CONTRACT NO. BR DWG. NO. CV78	

GO6-G FORBES AVE STA 152+94.19 - 18.0' RT CATCH BASIN, PWSA TYPE 13, W/ 3-FLANGE CAST IRON FRAME AND BICYCLE SAFE GRATE TG ELEV 821.88 INV 817.78* (15") OUT TO EXS PIPE *FIELD VERIFY PRIOR TO CONSTRUCTION	GO7-1 FORBES AVE STA 156+67.30 - 10.8' LT STORM INLET, PWSA TYPE 13, W/3-FLANGE CAST IRON FRAME AND BICYCLE SAFE GRATE TG ELEV 831.07 INV 826.98 (15") OUT TO GO7-2	GO8-3 FORBES AVE STA 164+01.87 - 11.0' LT PWSA SIDEWALK TRENCH DRAIN WITH ADA COMPLIANT AND BICYCLE SAFE GRATE TG ELEV 833.57 TRENCH INV ELEV 833.24	GO9-6 FORBES AVE STA 164+90.50 - 1.3' LT CUT IN WYE PIPE TRANSITION INV (15") IN FROM GO9-1 (MATCH EXISTING)	G10-2 FORBES AVE STA 170+55.00 - 4.6' LT CUT IN WYE PIPE TRANSITION INV (15") IN FROM G10-1 (MATCH EXISTING)
GO6-7 FORBES AVE STA 152+68.00 - 3.1' LT 48" DIAMETER MANHOLE, W/ MANHOLE FRAME AND COVER TR ELEV 821.93 INV 813.07 (15") IN FROM GO6-4 INV 813.07 (15") IN FROM GO6-5 INV 812.77 (15") OUT TO GO6-8	GO7-2 FORBES AVE STA 156+17.50 - 9.5' LT CATCH BASIN, PWSA TYPE 13, W/ 3-FLANGE CAST IRON FRAME AND BICYCLE SAFE GRATE TG ELEV 830.25 INV 826.51 (15") IN FROM GO7-1 INV 826.31 (15") OUT TO GO7-3	GO8-4 FORBES AVE STA 164+27.77 - 20.7' LT PWSA SIDEWALK TRENCH DRAIN WITH ADA COMPLIANT AND BICYCLE SAFE GRATE TG ELEV 833.16 TRENCH INV ELEV 832.54	GO9-7 JUMONVILLE ST STA 20+61.50 - 14.9' RT CATCH BASIN, PWSA TYPE 13, W/ 3-FLANGE CAST IRON FRAME AND BICYCLE SAFE GRATE TG ELEV 830.74 INV 826.80 (15") OUT TO GO9-8	G10-3 FORBES AVE STA 170+95.00 - 17.8' RT CATCH BASIN, PWSA TYPE 13, W/ 3-FLANGE CAST IRON FRAME AND BICYCLE SAFE GRATE G.I. CONTROL STRUCTURE* TG ELEV 808.65 INV 802.42** (15") OUT TO EXS PIPE *SEE STORMWATER MANAGEMENT PLANS **FIELD VERIFY PRIOR TO CONSTRUCTION
GOG-8 FORBES AVE STA 152+32.31 - 3.1' LT EXS MANHOLE RIM ELEVATION 820.95 MANHOLE COVER ADJUSTMENT RIM ELEVATION 821.22 CORE HOLE IN EXISTING DRAINAGE STRUCTURE INV 809.45 (15") IN FROM GO6-7 INV. 809.25 (36") OUT TO EX PIPE (PWSA MH011J025)	GO7-3 MILTENBERGER ST STA 12+94.92 - 11.9' RT 48" DIAMETER MANHOLE, W/ MANHOLE FRAME AND COVER TR ELEV 830.10 INV 826.15 (15") IN FROM GO7-2 INV 825.95* (15") OUT TO EXS PIPE *FIELD VERIFY PRIOR TO CONSTRUCTION	GO9-1 FORBES AVE STA 164+90.50 - 11.0' LT CATCH BASIN, PWSA TYPE 13, W/3-FLANGE CAST IRON FRAME AND BICYCLE SAFE GRATE TG ELEV 831.37 INV 828.05 (6") IN FROM GO9-11 INV 823.95 (15") OUT TO GO9-6	GO9-8 JUMONVILLE ST STA 20+36.46 - 16.2' RT 48" DIAMETER MANHOLE, W/ MANHOLE FRAME AND COVER TR ELEV 829.05 INV 824.95 (15") IN FROM GO9-7 INV 824.65* (15") OUT TO EXS PIPE *FIELD VERIFY PRIOR TO CONSTRUCTION	G10-4 SENECA ST STA 12+16.70 - 15.1' LT CATCH BASIN, PWSA TYPE 13, W/ 3-FLANGE CAST IRON FRAME AND BICYCLE SAFE GRATE TG ELEV 807.50 INV 803.56 (15") OUT TO EXS PIPE
GOG-9 VAN BRAAM ST STA 20+31.50 - 14.9' LT CATCH BASIN, PWSA TYPE 13, W/3-FLANGE CAST IRON FRAME AND BICYCLE SAFE GRATE TG ELEV 821.42 INV 817.22* (15") OUT TO EXS PIPE *FIELD VERIFY PRIOR TO CONSTRUCTION	GO7-4 FORBES AVE STA 156+42.00 - 18.3' RT CATCH BASIN, PWSA TYPE 13, W/ 3-FLANGE CAST IRON FRAME AND BICYCLE SAFE GRATE G.I. CONTROL STRUCTURE* TG ELEV 830.37 INV 826.37*** (15") OUT TO EXS PIPE *SEE STORMWATER MANAGEMENT PLANS **FIELD VERIFY PRIOR TO CONSTRUCTION	GO9-2 FORBES AVE STA 165+96.50 - 5.0' LT CATCH BASIN, PWSA TYPE 13, W/ 3-FLANGE CAST IRON FRAME AND BICYCLE SAFE GRATE TG ELEV 829.36 INV 821.36 (15") OUT TO GO9-3	GO9-9 JUMONVILLE ST STA 12+02.80 - 15.0' RT CATCH BASIN, PWSA TYPE 13, W/ 3-FLANGE CAST IRON FRAME AND BICYCLE SAFE GRATE TG ELEV 827.82 INV 823.88* (15") OUT TO EXS PIPE *FIELD VERIFY PRIOR TO CONSTRUCTION	G10-6 SENECA ST STA 12+21.41 - 14.9' RT CATCH BASIN, PWSA TYPE 13, W/ 3-FLANGE CAST IRON FRAME AND BICYCLE SAFE GRATE TG ELEV 806.12 INV 801.31* (15") OUT TO EXS *FIELD VERIFY PRIOR TO CONSTRUCTION
GOG-10 FORBES AVE STA 149+61.50 - 20.2' LT PWSA SIDEWALK TRENCH DRAIN WITH ADA COMPLIANT AND BICYCLE SAFE GRATE TG ELEV 814.47 TRENCH INV ELEV 813.84	GO7-8 FORBES AVE STA 155+12.65 - 20.7' LT PWSA SIDEWALK TRENCH DRAIN WITH ADA COMPLIANT AND BICYCLE SAFE GRATE TG ELEV 827.75 TRENCH INV ELEV 827.12	GO9-3 FORBES AVE STA 165+96.50 - 2.0' RT CUT IN WYE PIPE TRANSITION INV (15") IN FROM GO9-2 (MATCH EXISTING)	GO9-11 FORBES AVE STA 165+31.85 - 20.7' LT PWSA SIDEWALK TRENCH DRAIN WITH ADA COMPLIANT AND BICYCLE SAFE GRATE TG ELEV 830.81 TRENCH INV ELEV 830.18 INV 828.71 (6") OUT TO GO9-1	G10-9 FORBES AVE STA 170+55.40 - 20.9' LT PWSA SIDEWALK TRENCH DRAIN WITH ADA COMPLIANT AND BICYCLE SAFE GRATE TG ELEV 810.35 TRENCH INV ELEV 809.72 INV 808.25 (6") OUT TO G10-1
GOG-12 FORBES AVE STA 149+97.50 - 3.1' LT CUT IN WYE PIPE TRANSITION INV (15") IN FROM GOG-2 (MATCH EXISTING)	GO8-1 FORBES AVE STA 163+52.78 - 20.7' LT PWSA SIDEWALK TRENCH DRAIN WITH ADA COMPLIANT AND BICYCLE SAFE GRATE TG ELEV 834.34 TRENCH INV ELEV 833.72	GO9-4 FORBES AVE STA 165+96.50 - 18.0' RT CATCH BASIN, PWSA TYPE 13, W/ 3-FLANGE CAST IRON FRAME AND BICYCLE SAFE GRATE G. I. CONTROL STRUCTURE* TG ELEV 829.00 INV 822.76 (15") OUT TO EXS PIPE *SEE STORMWATER MANAGEMENT PLANS	GO9-12 FORBES AVE STA 166+81.40 - 20.9' LT PWSA SIDEWALK TRENCH DRAIN WITH ADA COMPLIANT AND BICYCLE SAFE GRATE TG ELEV 822.69 TRENCH INV ELEV 822.06	G11-1 FORBES AVE STA 174+65.00 - 11.3' LT STORM INLET, PWSA TYPE 13, W/3-FLANGE CAST IRON FRAME AND BICYCLE SAFE GRATE TG ELEV 790.50 INV 780.50 (15") OUT TO G11-2
GO6-13 FORBES AVE STA 152+95.00 - 20.7' LT PWSA SIDEWALK TRENCH DRAIN WITH ADA COMPLIANT AND BICYCLE SAFE GRATE TG ELEV 822.70 TRENCH INV ELEV 822.07 INV 820.60 (6") OUT TO GO6-4	GO8-2 FORBES AVE STA 163+82.50 - 20.7' LT PWSA SIDEWALK TRENCH DRAIN WITH ADA COMPLIANT AND BICYCLE SAFE GRATE TG ELEV 833.92 TRENCH INV ELEV 833.30	GO9-5 JUMONVILLE ST STA 20+34.00 - 15.1' LT CATCH BASIN, PWSA TYPE 13 MODIFIED, W/3-FLANGE CAST IRON FRAME AND BICYCLE SAFE GRATE TG ELEV 828.75 INV 824.93* (15") OUT TO EXS PIPE *FIELD VERIFY PRIOR TO CONSTRUCTION	G10-1 FORBES AVE STA 170+55.40 - 11.3' LT CATCH BASIN, PWSA TYPE 13, W/ 3-FLANGE CAST IRON FRAME AND BICYCLE SAFE GRATE TG ELEV 810.87 INV 808.05 (6") IN FROM G10-9 INV 800.87 (15") OUT TO G10-2	GENERAL NOTE:  DRAINAGE STRUCTURE LOCATIONS, PIPE SIZES, AND ELEVATIONS SHOULD BE ADJUSTED WHERE NECESSARY TO ALIGN WITH EXISTING PIPE WHERE POSSIBLE. DETERMINE EXISTING PIPE ALIGNMENTS AND DEPTHS AND NOTIFY ENGINEER PRIOR TO CATCH BASIN CONSTRUCTION WHERE ADJUSTMENT IS NEEDED.
Gulf Tower 707 Grant Street 5th Floor Pittsburgh, PA 15219  GANNETT FLEMING, INC. Foster Plaza 8 Suite 400 730 Holiday Drive Pittsburgh, PA. 15220	NO. DATE DESCRIPTION REVISIONS		DESIGNED   TCG	PORT AUTHORITY OF ALLEGHENY COUNTY PITTSBURGH  BUS RAPID TRANSIT UPTOWN TO OAKLAND DRAINAGE DATA DRAINAGE STRUCTURES G06 - G11  Port Authority CONTRACT NO. BRT-001 DWG. NO. CV79 SHT. 154

G11-2 FORBES AVE STA 174+65.00 - 4.2' LT CUT IN WYE PIPE TRANSITION INV (15") IN FROM G10-1 (MATCH EXISTING)

G12-6 FORBES AVE STA 178+46.77 - 35.7' RT
48" DIAMETER MANHOLE,
W/ MANHOLE FRAME AND COVER
TR ELEV 774.40
INV 770.04 (15") IN FROM G12-4
INV 769.28\* (15") OUT TO EXS PIPE
\*FIELD VERIFY PRIOR TO CONSTRUCTION

G11-3 FORBES AVE STA 175+02.00 - 17.8' RT CATCH BASIN, PWSA TYPE 13, W/3-FLANGE CAST IRON FRAME AND BICYCLE SAFE GRATE TG ELEV 788.38 INV 784.44 (15") OUT TO G11-4

G19-1 FORBES AVE STA 213+82.10 - 21.8' RT
EXISTING INLET PWSA CB028K011
ELEVATION 915.91
INLET GRATE ADJUSTMENT
PROPOSED GRATE ELEVATION
TO MATCH EXISTING, VERIFY
EXISTING INVERT ELEVATIONS UNKNOWN

G11-5 MOULTRIE ST STA 53+35.50 - 11.0' RT
CATCH BASIN, PWSA TYPE 13 MODIFIED,
W/ 3-FLANGE CAST IRON FRAME AND
BICYCLE SAFE GRATE
TG ELEV 787.64
INV 784.03\* (15") OUT TO EXS PIPE
\*FIELD VERIFY PRIOR TO CONSTRUCTION

G21-1 FORBES AVE STA 224+08.20 - 20.1' RT EXISTING INLET PWSA CB028F013 ELEVATION 905.71 INLET GRATE ADJUSTMENT
PROPOSED GRATE ELEVATION
TO MATCH EXISTING, VERIFY
EXISTING INVERT ELEVATIONS UNKNOWN

G12-1 FORBES AVE STA 177+48.00 - 8.1' LT CATCH BASIN, PWSA TYPE 13 MODIFIED, W/3-FLANGE CAST IRON FRAME AND BICYCLE SAFE GRATE TG ELEV 776.31 INV 764.31 (15") OUT TO G12-2

G12-2 FORBES AVE STA 177+48 - 0.0' LT/RT CUT IN WYE PIPE TRANSITION INV (15") IN FROM G12-1 (MATCH EXISTING)

G12-3 FORBES AVE STA 177+65.00 - 23.0' RT
CATCH BASIN, PWSA TYPE 13 MODIFIED,
W/ 3-FLANGE CAST IRON FRAME AND
BICYCLE SAFE GRATE
TG ELEV 775.48
INV 771.54\* (15") OUT TO EXS PIPE
\*FIELD VERIFY PRIOR TO CONSTRUCTION

G12-4 FORBES AVE STA 178+46.51 - 29.5' RT CATCH BASIN, PWSA TYPE 13, W/3-FLANGE CAST IRON FRAME AND BICYCLE SAFE GRATE TG ELEV 774.48 INV 770.54 (15") OUT TO G12-6

GENERAL NOTE:

DRAINAGE STRUCTURE LOCATIONS, PIPE SIZES, AND ELEVATIONS SHOULD BE ADJUSTED WHERE NECESSARY TO ALIGN WITH EXISTING PIPE WHERE POSSIBLE. DETERMINE EXISTING PIPE ALIGNMENTS AND DEPTHS AND NOTIFY ENGINEER PRIOR TO CATCH BASIN CONSTRUCTION WHERE ADJUSTMENT IS NEEDED.

DWG. NO. CV80

sнт. 155

AECOM

**Gulf Tower** 707 Grant Street 5th Floor Pittsburgh, PA 15219 GANNETT FLEMING
GANNETT FLEMING, INC.

Foster Plaza 8 Suite 400 730 Holiday Drive Pittsburgh, PA. 15220

			THE PREPARATION OF THIS DOCUMENT HAS BEEN FINANCED IN
			PART THROUGH A GRANT FROM THE
			FEDERAL TRANSIT ADMINISTRATION, U.S. DEPARTMENT OF
			TRANSPORTATION, UNDER THE
			URBAN MASS TRANSPORTATION ACT OF 1964. AS AMENDED. FOR THE
NO.	DATE	DESCRIPTION	PORT AUTHORITY OF ALLEGHENY COUNTY, PENNSYLVANIA.
		REVISIONS	COUNTY, PENNSTEVANIA.

(NOT FOR CONSTRUCTION)

DESIGNED	TCG	PORT AUTHOR	ITY OF AL	LEGHENY	COUNTY		
DRAWN	<u>DPV</u>	PITTSBURGH			PENNSYLVANIA		
CHECKED	KCF	BUS RAPID TRANSIT UPTOWN TO OAKLAND					
IN CHARGE	<u>GEC</u>	DRAINAGE DATA					
DATE	05/01/24	DRAINAGE STRUCTURES G11 - G21					
SCALE AS SHOWN		Port Authority	CONTR	RACT NO. BF	RT-001		
		connecting people to life	DWG. NO.	CV80	sнт. <b>1</b>		

TRENCH	DRAIN	DATA	TABLE
(STA, O	FFSET, EI	LEV ARE	IN FT)

		NEAR EN	NDPOINT			TO NEX	T POINT			VER	RTEX			TO NEX	T POINT			FAR EN	IDPOINT			OUTLET PIPE
CALLOUT	STA	OFFSET	SIDE	TG ELEV	INV ELEV	LENGTH	SL0PE	CALLOUT	STA	OFFSET	SIDE	TG ELEV	INV ELEV	LENGTH	SLOPE	CALLOUT	STA	OFFSET	SIDE	TG ELEV	INV ELEV	INV ELEV
G05-19	149+07.50	20.2'	LT	812.69	812.06	54.00	-4.46%	-	-	_	-	-	-	-		G06-10	149+61.50	20.2′	LT	814.47	813.84	810.59
G06-13	152+95.00	20.7′	LT	822.7	822.07	217.65	-2.61%	-	-	_	_	-	-	-	_	G07-8	155+12.65	20.7′	LT	827.75	827.12	820.6
G08-1	163+52.78	20.7′	LT	834.34	833.72	29.22	1.44%	G08-2	163+82.00	20.7′	LT	833.92	833.30	19.87	0.30%	G08-3	164+01.87	11.0′	LT	833.57	833.24	N/A
G08-4	164+27.77	20.7′	LT	833.16	832.54	104.08	1.66%	-	-	-	_	-	-	-	-	G09-11	165+31.85	20.7′	LT	830.81	830.18	828.71
G09-12	166+81.40	20.9′	LT	822.69	822.06	374.00	3.13%	-	-	-	_	-	-	-	-	G10-9	170+55.40	20.9′	LT	810.35	809.72	808.25
A14-9	436+14.00	22.8	RT	766.33	765.71	73.00	-2.32%	-	-	_	_	-	-	-	-	A14-10	436+87.00	22.67	RT	767.40	766.78	764.23
A15-9	438+82.39	10	RT	770.62	770.29	11.61	-2.50%	A15-10	438+94.00	22.67	RT	770.91	770.58	49.00	-1.14%	A15-11	439+43.00	22.67	RT	771.47	771.14	-
A15-12	440+90.00	22.67	RT	773.78	773.16	49.00	-3.20%	-	-	-	-	-	-	-	-	A15-13	441+39.00	22.67	RT	774.73	774.11	771.68
A16-10	444+42.72	10	RT	782.59	782.26	16.77	-1.73%	A16-11	444+59.49	22.67	RT	782.88	782.55	195.60	-2.69%	A16-12	446+55.09	22.67	RT	788.14	787.81	-
A16-13	448+36.00	10.49	RT	793.20	792.62	9.37	-1.39%	A16-14*	448+45.37	20.45	RT	793.33	792.75									
								A17-9*	449+19.39	22.67	RT	795.20	794.62	325.34	-2.47%	A17-10	452+44.73	22.67	RT	803.22	802.64	-
A18-5	454+60.50	13	RT	808.74	808.41	12.25	-1.22%	A18-6	454+72.75	22.67	RT	808.89	808.56	107.25	-2.58%	A18-7	455+80.00	22.67	RT	811.66	811.33	-
A18-11	457+43.48	14.27	RT	816.08	815.45	7.63	-2.49%	A18-12	457+51.11	20.67	RT	816.26	815.64	111.92	-2.68%	A19-9	458+63.03	20.67	RT	819.22	818.64	-
A19-10	459+83.26	18.88	RT	822.22	821.60	12.95	-7.57%	-	-	-	-	-	-	-	-	A19-11	459+96.21	20.18	RT	822.58	821.96	820.02
A19-12	460+24.51	20.67	RT	823.21	822.59	13.00	-6.15%	-	-	-	-	-	-	-	-	A19-13	460+37.51	20.67	RT	823.39	822.77	820.91
A19-15	464+33.50	11	RT	832.75	832.42	16.31	-2.21%	A19-16	464+49.81	20.67	RT	833.11	832.78	56.58	-1.98%	A20-9	465+06.39	20.67	RT	834.23	833.9	-
A20-10	467+49.00	28.6	RT	839.46	838.84	233.00	-2.75%	-	-	-	-	-	-	-	-	A20-11	469+82.00	28.57	RT	845.24	844.62	837.36
A21-2	471+07.00	20.67	RT	848.50	847.87	79.25	-1.78%	A21-3	471+86.25	20.67	RT	849.90	849.28	19.65	-1.98%	A21-4	472+05.90	18.71	RT	850.29	849.67	846.42
A21-6	472+60.50	32.52	RT	851.04	850.71	24.35	-5.17%	A21-7*	472+84.85	19.45	RT	852.30	851.97									
								A21-8*	473+05.40	21.49	RT	852.48	852.15	86.60	-1.43%	A21-9	473+92.00	21.49	RT	853.72	853.39	-
A21-10	474+40.64	21.5	RT	853.71	853.09	42.53	1.13%	A21-11	474+83.17	21.5	RT	853.23	852.61	6.58	3.19%	A21-12	474+89.75	14.88	RT	853.02	852.40	-
A21-13	475+35.00	20	LT	852.56	851.94	181.00	2.22%	-	-	-	-	-	-	-	-	A22-10	477+16.00	20	LT	847.92	847.30	845.82
A22-5	476+39.00	21.5	RT	849.53	848.91	61.00	1.07%	-	-	-	-	-	-	-	-	A22-6	477+00.00	21.5	RT	848.26	847.64	846.16
A22-9	478+23.00	24	LT	844.38	844.05	138.00	3.85%	A22-8	479+61.00	24	LT	839.07	838.74	14.00	2.14%	A22-7	479+75.00	13.52	LT	838.77	838.44	-
A22-11	478+27.00	21.5	RT	844.01	843.39	339.00	3.50%	-	-	-	-	-	-	-	-	A23-4	481+66.00	21.5	RT	831.51	830.89	829.41
A23-5	482+98.59	20	RT	826.35	825.73	285.41	3.74%	A24-9	485+84.00	20	RT	815.66	815.06	7.72	3.24%	A24-5	485+91.72	8.94	RT	815.43	814.81	-
A32-3	533+80.95	29.54	LT	929.53	928.91	101.09	0.08%	-	-	-	-	-	-	-	-	A33-4	534+82.04	29.52	LT	928.83	928.21	926.73
A33-5	534+90.78	29.51	LT	928.79	928.17	61.04	-1.47%	-	-	-	-	-	-	-	-	A33-6	535+51.82	29.54	LT	929.07	928.45	926.69
A33-11	538+15.00	23	LT	931.81	931.35	11.23	-0.53%	A33-12	538+26.23	34.18	LT	931.76	931.41	84.44	-1.17%	A33-13	539+10.67	34.18	LT	932.86	932.40	-
					-			-											1	-		-

#### NOTES:

- 1. ENDOINTS REFER TO THE LONGITUDINAL CENTERLINE OF THE TRENCH EITHER AT THE OUTSIDE EDGE OF THE CONCRETE OR, IF THE TRENCH OUTLETS TO THE STREET, AT THE BASE OF CURB. BETWEEN POINTS, FOLLOW SURFACE ELEV OF ADJOINING PAVEMENT.
- 2. NOT ALL TRENCHES HAVE A VERTEX OR OUTLET PIPE.
- 3. THIS TRENCH DRAIN HAS FOUR VERTECES.

<b>AECOM</b>
Gulf Tower
707 Grant Street
5th Floor
Pittsburgh, PA 15219

		THE PREPARATION OF THIS DOCUMENT HAS BEEN FINANCED IN	
		PART THROUGH A GRANT FROM THE	
		FEDERAL TRANSIT ADMINISTRATION, U.S. DEPARTMENT OF	
		TRANSPORTATION, UNDER THE	
		URBAN MASS TRANSPORTATION ACT OF 1964, AS AMENDED, FOR THE	
DATE	DESCRIPTION	PORT AUTHORITY OF ALLEGHENY COUNTY, PENNSYLVANIA.	
	REVISIONS	COUNTY, FEMINISTEVANIA.	

# (NOT FOR CONSTRUCTION)

DESIGNED	MRM	
DRAWN	<u>MRM</u>	
CHECKED	DJC	
IN CHARGE	LAR	
DATE	05/01/24	
SCALE		
	AS SHOWN	


## PORT AUTHORITY OF ALLEGHENY COUNTY PENNSYLVANIA

BUS RAPID TRANSIT UPTOWN TO OAKLAND DRAINAGE DATA TRENCH DRAIN DATA TABLE


Port Authority connecting people to life

CONTRACT NO. BRT-001

DWG. NO. CV81 SHT. 156

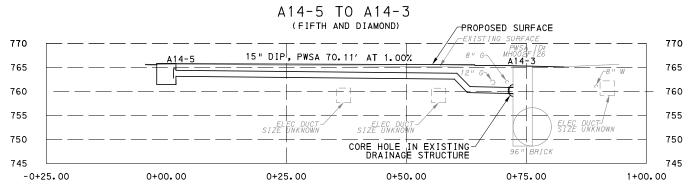


NOTE: DIP IS SPECIFIED ONLY TO REDUCE MIN COVER REQUIREMENT BY 3" COMPARED TO PVC IF NEEDED TO PROVIDE CLEARANCE OVER UTILITY SHOWN. DETERMINE DEPTH OF UTILITY PRIOR TO ORDERING MATERIALS THEN REVIEW NEED FOR DIP WITH ENGINEER

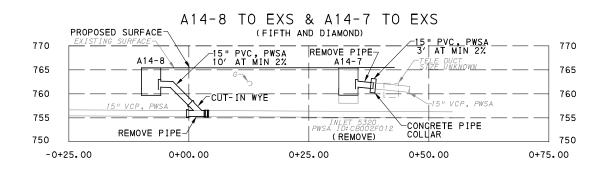


#### A14-2A TO A14-2 (FIFTH AND DIAMOND) PROPOSED SURFACE-770 770 REMOVE PIPE ( REMOVE) 765 765 SIZE UNKNOWN 760 760 PIPE COLLAR 755 755 15" PVC, PWSA / 19.55' AT 0.87% -15" PVC, PWSA 5' AT MIN 2% 750 750 0+50.00 -0+25.00 0+00.00 0+25.00



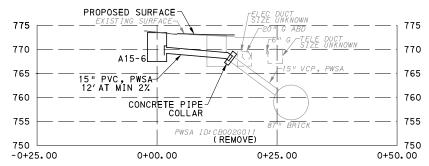

#### A15-5 TO EXS & A15-4 TO EXS (FIFTH AND WASHINGTON PLACE)

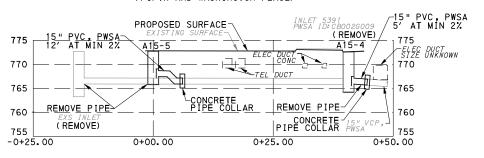



		U.S. DEPARTMENT OF TRANSPORTATION, UNDER THE
		FEDERAL TRANSIT ADMINISTRATION
		URBAN MASS TRANSPORTATION AC
DATE	DESCRIPTION	OF 1964, AS AMENDED, FOR THE PORT AUTHORITY OF ALLEGHENY COUNTY, PENNSYLVANIA.
	REVISIONS	COUNTY, FEINING (EVAINIA.

(NOT FOR CONSTRUCTION)

DESIGNED	MRM	
DRAWN	MRM	
CHECKED	DJC	
IN CHARGE	LAR	
DATE	<u>05/01/24</u>	
SCALE		

### PORT AUTHORITY OF ALLEGHENY COUNTY BUS RAPID TRANSIT UPTOWN TO OAKLAND


DRAINAGE PROFILES DRAINAGE STRUCTURES A14 - A15


**Port Authority** CONTRACT NO. BRT-001 DWG. NO. CV82

AS SHOWN


sнт. **157** 

### A15-7 TO A15-3

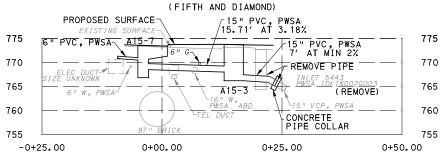


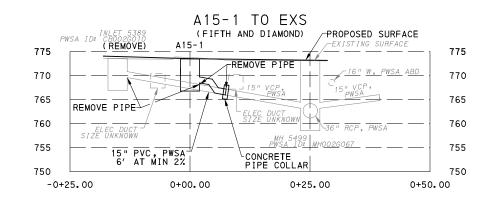


### A16-2 TO EXS (FIFTH BETWEEN CHATHAM AND MAGEE)

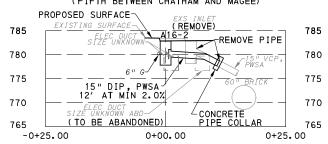

### A16-9 TO A16-8 (FIFTH BETWEEN CHATHAM AND MAGEE)

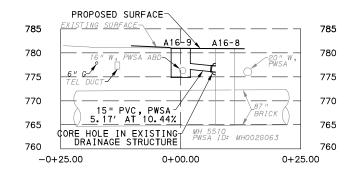


### A16-3 TO EXS (FIFTH BETWEEN CHATHAM AND MAGEE)

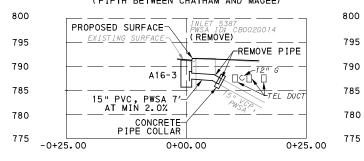

## **AECOM**

Gulf Tower 707 Grant Street 5th Floor Pittsburgh, PA 15219

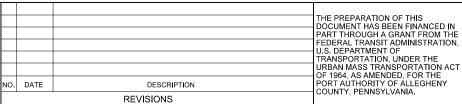

# (NOT FOR CONSTRUCTION)

DESIGNED	<u>MRM</u>	
DRAWN	<u>MRM</u>	
CHECKED	DJC	
IN CHARGE	LAR	
DATE	05/01/24	
SCALE		
	AS SHOWN	

## PORT AUTHORITY OF ALLEGHENY COUNTY PITTSBURGH BUS RAPID TRANSIT UPTOWN TO OAKLAND


RAPID TRANSIT UPTOWN TO OAKLAND DRAINAGE PROFILES DRAINAGE STRUCTURES A15 - A16


Port Authority

CONTRACT NO. BRT-001


DWG. NO. CV83 SHT. 158

SCALE AS SI

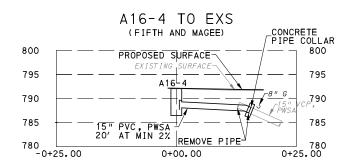


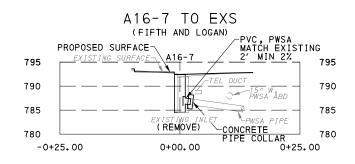


A17-1 TO EXS (FIFTH AND LOGAN)

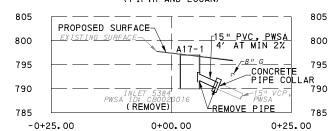

A17-2 TO EXS (FIFTH AND LOGAN)

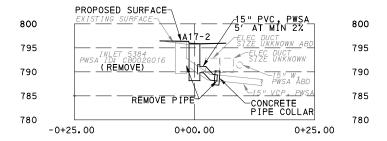

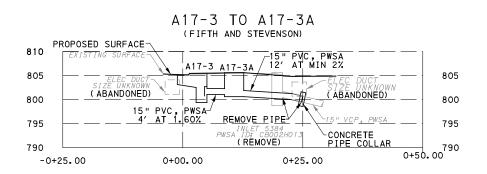



Gulf Tower 707 Grant Street 5th Floor Pittsburgh, PA 15219

		THE PREPARATION OF THIS DOCUMENT HAS BEEN FINANCED IN
		PART THROUGH A GRANT FROM THE
		FEDERAL TRANSIT ADMINISTRATION, U.S. DEPARTMENT OF
		TRANSPORTATION, UNDER THE
		URBAN MASS TRANSPORTATION ACT OF 1964, AS AMENDED, FOR THE
DATE	DESCRIPTION	PORT AUTHORITY OF ALLEGHENY COUNTY, PENNSYLVANIA.
	REVISIONS	COUNTY, PENNSTEVANIA.

(NOT FOR CONSTRUCTION)

DESIGNED	<u>MRM</u>	
DRAWN	<u>MRM</u>	
CHECKED	DJC	
IN CHARGE	LAR	
DATE	05/01/24	
SCALE		
	AS SHOWN	


## PORT AUTHORITY OF ALLEGHENY COUNTY BUS RAPID TRANSIT UPTOWN TO OAKLAND

DRAINAGE PROFILES DRAINAGE STRUCTURES A16 - A17


**Port Authority** CONTRACT NO. BRT-001 DWG. NO. CV84

sнт. **159** 


### A17-8 TO A17-6 TO EXS

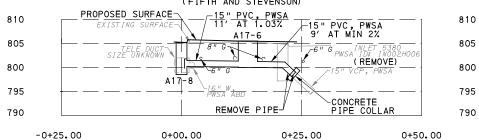


### A18-2 TO EXS

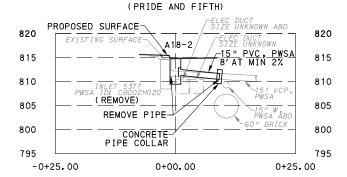


#### A19-1 TO EXS

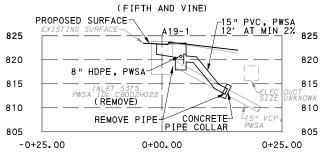


### A18-4 TO EXS

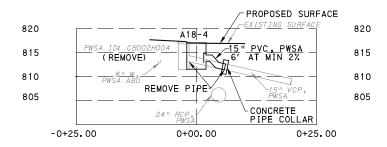


### A18-1 TO A18-1A TO EXS

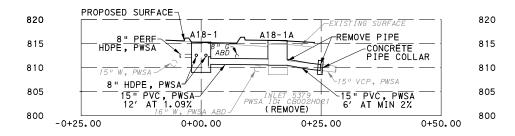

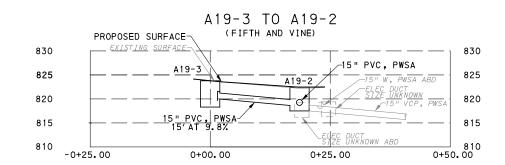

## **AECOM**

Gulf Tower 707 Grant Street 5th Floor Pittsburgh, PA 15219

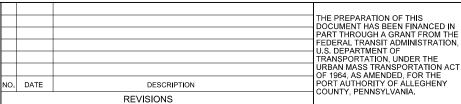

## (NOT FOR CONSTRUCTION)

DESIGNED	MRM	
DRAWN	<u>MRM</u>	
CHECKED	DJC	
IN CHARGE	<u>LAR</u>	
DATE	<u>05/01/24</u>	
SCALE		
	AS SHOWN	

## PORT AUTHORITY OF ALLEGHENY COUNTY PITTSBURGH PENNSYLVANIA RUS RAPID TRANSIT LIPTOWN TO OAKLAND


BUS RAPID TRANSIT UPTOWN TO OAKLAND DRAINAGE PROFILES DRAINAGE STRUCTURES A17 - A19

Port Authority —

CONTRACT NO. BRT-001

DWG. NO. CV85 SHT. 160

A19-4 TO A19-2

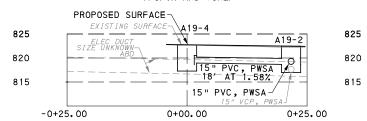

## A19-8 TO EXS

(FIFTH AND VAN BRAAM)

A19-6 TO EXS

(FIFTH AND MARION)

15" PVC, PWSA 21.42' AT 1.31%

> CORED WYE OR TEE-CONNECTION

A19-5

0+25.00

825

820

815

810

805

0+50.00

7-15" PVC, PWSA 8' AT MIN 2%

PROPOSED SURFACE-

825

820


810

805

-0+25.00


EXISTING SURFAC

0+00.00

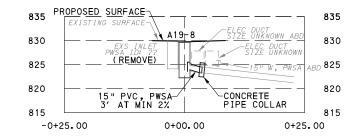


#### A20-6 TO A20-6A (FIFTH AND DINWIDDIE) PROPOSED SURFACE-845 845 840 840 835 835 ELEC DUCT SIZE UNKNOWN ABD 830 830 CORE HOLE IN EXISTING DRAINAGE STRUCTURE 15" PVC, PWSA-6' AT 13.98% 825 825 -0+25.00 0+00.00 0+25.00

### A20-2 TO A20-1 TO EXS

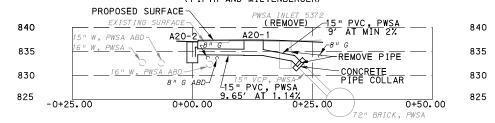

# AECOM Gulf Tower 707 Creat Street

Gulf Tower 707 Grant Street 5th Floor Pittsburgh, PA 15219

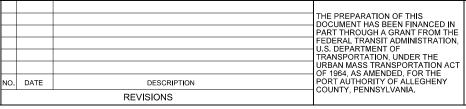

# (NOT FOR CONSTRUCTION)

DESIGNED	MRM	
DRAWN	<u>MRM</u>	
CHECKED	DJC	
IN CHARGE	LAR	
DATE	05/01/24	
SCALE		
	AS SHOWN	

## PORT AUTHORITY OF ALLEGHENY COUNTY PENNSYLVANIA BUS RAPID TRANSIT UPTOWN TO OAKLAND


S RAPID TRANSIT UPTOWN TO OAKLAND DRAINAGE PROFILES DRAINAGE STRUCTURES A19 - A20

Port Authority

CONTRACT NO. BRT-001


DWG. NO. CV86 SHT. 161

### A20-5 TO EXS

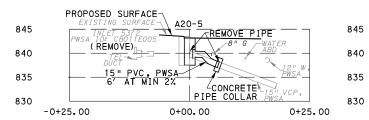


#### A23-2 TO EXS (FIFTH AND SENECA) PROPOSED SURFACE 835 835 15" PVC, PWSA 43.50' AT 3.31% 830 830 825 825 6" PVC, PWSA-820 820 15" PVC, PWSA 8' AT MIN 2% 815 815 0+25.00 -0+25.00 0+00.00 0+50.00 0+75.00


#### A22-1 TO A22-1A (FIFTH AND WYANDOTTE)

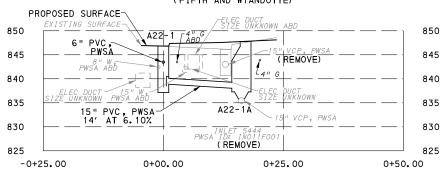

### A22-2 TO EXS

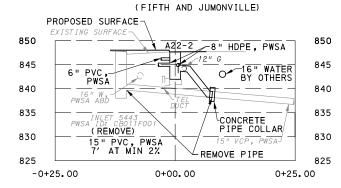


### A23-3 TO EXS

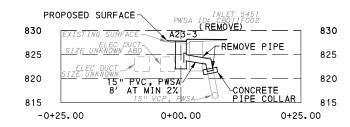

## **AECOM**

Gulf Tower 707 Grant Street 5th Floor Pittsburgh, PA 15219

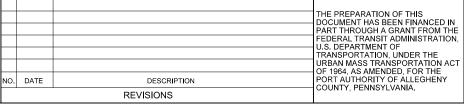

# (NOT FOR CONSTRUCTION)

DESIGNED	<u>MRM</u>	
DRAWN	<u>MRM</u>	
CHECKED	DJC	
IN CHARGE	LAR	
DATE	05/01/24	
SCALE		
	AS SHOWN	


## PORT AUTHORITY OF ALLEGHENY COUNTY PITTSBURGH BUS RAPID TRANSIT UPTOWN TO OAKLAND


DRAINAGE PROFILES

DRAINAGE STRUCTURES A20 - A23

Port Authority CONTRACT NO. BRT-001

DWG. NO. CV87 SHT. 162

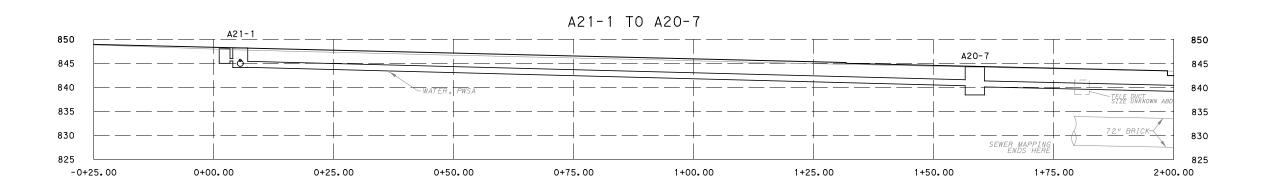

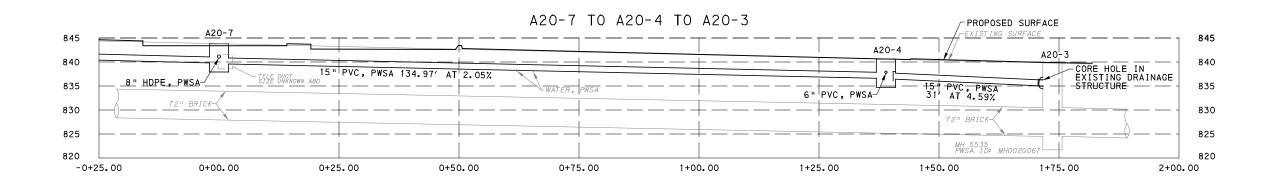

Gulf Tower 707 Grant Street 5th Floor Pittsburgh, PA 15219 THE PREPARATION OF THIS
DOCUMENT HAS BEEN FINANCED IN
PART THROUGH A GRANT FROM THE
FEDERAL TRANSIT ADMINISTRATION,
U.S. DEPARTMENT OF
TRANSPORTATION, UNDER THE
URBAN MASS TRANSPORTATION ACT
OF 1964, AS AMENDED, FOR THE
NO. DATE
DESCRIPTION
REVISIONS
THE OCUNTY, PENNSYLVANIA.

(NOT FOR CONSTRUCTION)

DESIGNED	MRM	
DRAWN	MRM	
CHECKED	DJC	
IN CHARGE	LAR	
DATE	05/01/24	
SCALE		
	AS SHOWN	

PORT AUTHORITY OF ALLEGHENY COUNTY
PITTSBURGH

BUS RAPID TRANSIT UPTOWN TO OAKLAND

BUS RAPID TRANSIT UPTOWN TO OAKLAND DRAINAGE PROFILES DRAINAGE STRUCTURES A20


Port Authority connecting people to life

CONTRACT NO. BRT-001


DWG. NO. CV88 SHT. 163

OPERATOR: "michael.mcgarry" FILE PATH: c:\pwworking\aecom\_ds16\_na\michael.mcgarry@ae


A24-2 TO A24-1A (FIFTH AND MOULTRIE)

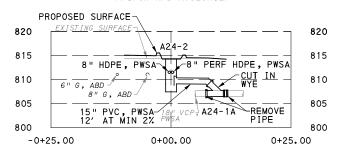


A25-2 TO A25-2A TO EXS

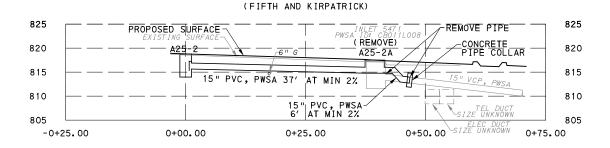

A24-7 TO A24-8
(FIFTH BETWEEN MOULTIRE AND KIRPATRICK)

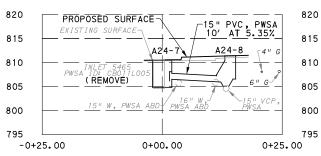


A25-4 TO EXS

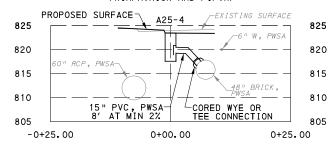

**AECOM**Gulf Tower

Gulf Tower 707 Grant Street 5th Floor Pittsburgh, PA 15219

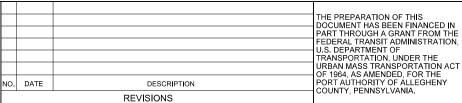

(NOT FOR CONSTRUCTION)

DESIGNED	MRM	
DRAWN	<u>MRM</u>	
CHECKED	DJC	
IN CHARGE	MW	
DATE	<u>05/01/24</u>	
SCALE		
	AS SHOWN	

## PORT AUTHORITY OF ALLEGHENY COUNTY PITTSBURGH PENNSYLVANIA


BUS RAPID TRANSIT UPTOWN TO OAKLAND
DRAINAGE PROFILES
DRAINAGE STRUCTURES A24 - A25

Port Authority


CONTRACT NO. BRT-001

DWG. NO. CV89 SHT. 164


### A25-5A TO EXS

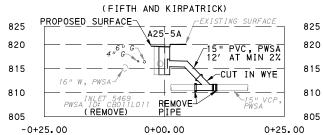


#### A25-7 TO EXS (FIFTH AND KIRPATRICK)

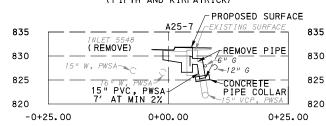


#### A26-1 TO EXS (FIFTH BETWEEN KIRPATRICK AND BRENHAM)

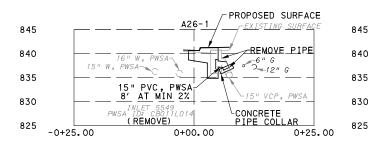

#### A26-2 TO EXS (FIFTH BETWEEN KIRPATRICK AND BRENHAM)

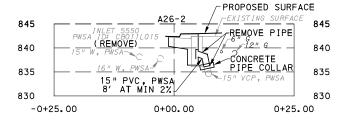


#### A26-4 TO EXS (FIFTH BETWEEN KIRPATRICK AND BRENHAM)

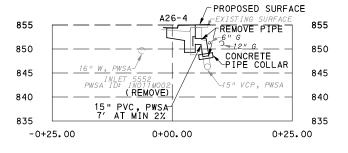

10 20 FEET

Gulf Tower 707 Grant Street 5th Floor Pittsburgh, PA 15219

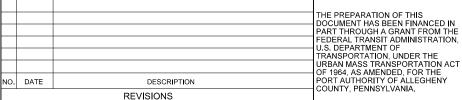

## (NOT FOR CONSTRUCTION)

DESIGNED	<u>MRM</u>	
DRAWN	<u>MRM</u>	
CHECKED	DJC	
IN CHARGE	LAR	
DATE	<u>05/01/24</u>	
SCALE		
	AS SHOWN	


## PORT AUTHORITY OF ALLEGHENY COUNTY


BUS RAPID TRANSIT UPTOWN TO OAKLAND DRAINAGE PROFILES DRAINAGE STRUCTURES A25 - A26


**Port Authority** 

CONTRACT NO. BRT-001 DWG. NO. CV90 sнт. 165

A27-3 TO EXS

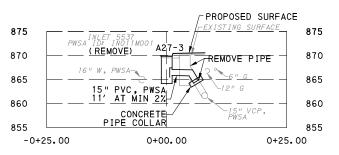

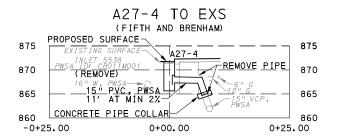

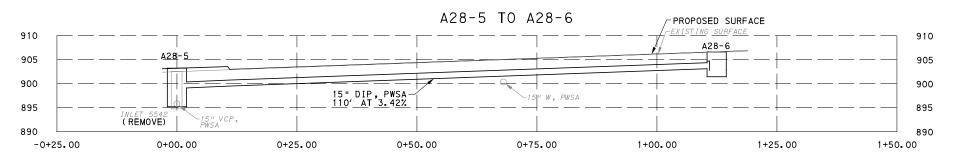

NOTE:
DIP IS SPECIFIED ONLY TO REDUCE MIN COVER REQUIREMENT BY 3" COMPARED TO PVC IF NEEDED TO PROVIDE CLEARANCE OVER UTILITY SHOWN. DETERMINE DEPTH OF UTILITY PRIOR TO ORDERING MATERIALS THEN REVIEW NEED FOR DIP WITH ENGINEER

SCALE 0 10 20 FEET

Gulf Tower
707 Grant Street
5th Floor
Pittsburgh, PA 15219

		THE PREPARATION OF THIS DOCUMENT HAS BEEN FINANCED IN
		PART THROUGH A GRANT FROM THE
		FEDERAL TRANSIT ADMINISTRATION,
		U.S. DEPARTMENT OF TRANSPORTATION, UNDER THE
		URBAN MASS TRANSPORTATION ACT
DATE	DESCRIPTION	OF 1964, AS AMENDED, FOR THE PORT AUTHORITY OF ALLEGHENY COUNTY, PENNSYLVANIA.
	REVISIONS	COUNTY, PENNSTEVANIA.

(NOT FOR CONSTRUCTION)

DESIGNED	MRM	PORT AUTHORIT
DRAWN	MRM	PITTSBURGH
CHECKED	DJC	BUS RAPID TRA
IN CHARGE	LAR	DRA
DATE	05/01/24	DRAINAGE
SCALE	AS SHOWN	Port Authority
I		


PORT AUTHORITY OF ALLEGHENY COUNTY
PITTSBURGH

BUS RAPID TRANSIT UPTOWN TO OAKLAND
DRAINAGE PROFILES
DRAINAGE STRUCTURES A27 - A28


Port Authority CONTRACT NO. BRT-001

DWG. NO. CV91 SHT. 166


#### A29-3 TO A29-2 (FIFTH AND ROBINSON)

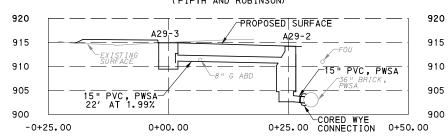


### A32-1 TO EXS

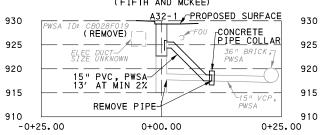

## A31-8 TO EXS (FIFTH AND CHESTERFIELD)

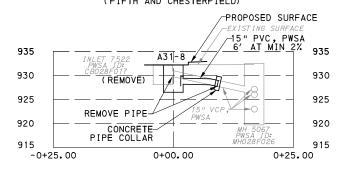


### A34-1 TO EXS

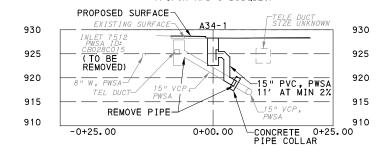

SCALE 0 10 20 FEET

**AECOM** 

Gulf Tower 707 Grant Street 5th Floor Pittsburgh, PA 15219

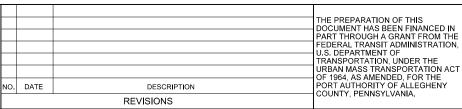

# (NOT FOR CONSTRUCTION)

DESIGNED	MRM	
DRAWN	<u>MRM</u>	
CHECKED	DJC	
IN CHARGE	LAR	
DATE	05/01/24	
SCALE		
	AS SHOWN	

## PORT AUTHORITY OF ALLEGHENY COUNTY PENNSYLVANIA BUS RAPID TRANSIT UPTOWN TO OAKLAND


DRAINAGE PROFILES
DRAINAGE STRUCTURES A29 - A34

Port Authority


CONTRACT NO. BRT-001
DWG. NO. CV92 SHT. 167

TH: c:\pwworking\dec


A36-3 TO A36-2 (FIFTH AND BIGELOW)

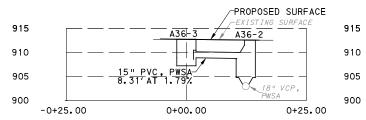


A37-5 TO EXS (FIFTH AND LYTTON)

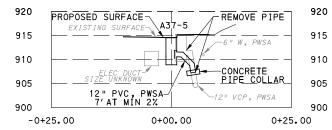


A37-13 TO A37-12 (FIFTH AND TENYSON)

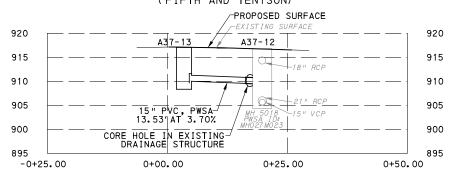


A36-7 TO EXS (FIFTH AND BIGELOW)

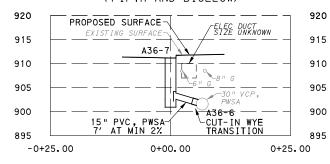

A37-8 TO EXS (FIFTH AND LYTTON)

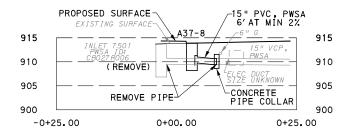


A38-2 TO EXS

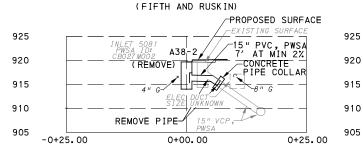

AECOM

Gulf Tower 707 Grant Street 5th Floor Pittsburgh, PA 15219

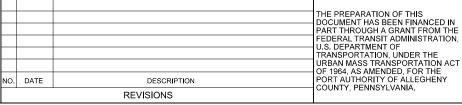

(NOT FOR CONSTRUCTION)

DESIGNED	MRM	
DRAWN	MRM	
CHECKED	DJC	
IN CHARGE	LAR	
DATE	<u>05/01/24</u>	
SCALE		
	AS SHOWN	

## PORT AUTHORITY OF ALLEGHENY COUNTY


BUS RAPID TRANSIT UPTOWN TO OAKLAND DRAINAGE PROFILES DRAINAGE STRUCTURES A36 - A38

**Port Authority** 

CONTRACT NO. BRT-001


DWG. NO. CV93 sнт. 168

#### GO1-1 TO EXISTING

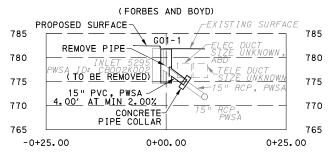


#### GO1-3 TO EXISTING

(FORBES AND ARMSTRONG TUNNEL)

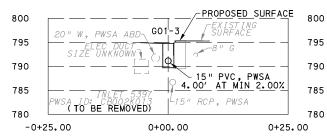


#### GO2-2 TO EXISTING

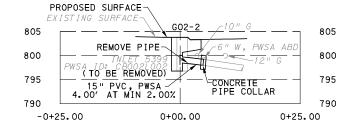


#### GO1-2 TO EXISTING

(FORBES AND ARMSTRONG TUNNEL)

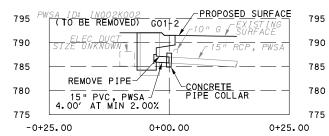


#### GO2-1 TO EXISTING

(FORBES AND CHATHAM SQ)

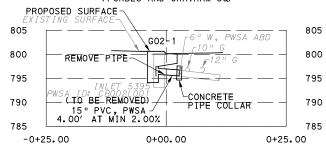

#### GO2-3 TO EXISTING

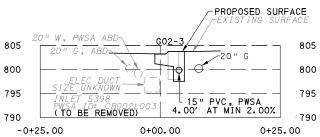



Gulf Tower 707 Grant Street 5th Floor Pittsburgh, PA 15219



: [ ]			THE PREPARATION OF THIS
'-			I DOCUMENT HAS BEEN FINANCED IN
			PART THROUGH A GRANT FROM THE
			FEDERAL TRANSIT ADMINISTRATION,
			U.S. DEPARTMENT OF
			TRANSPORTATION, UNDER THE
			URBAN MASS TRANSPORTATION ACT
			OF 1964, AS AMENDED, FOR THE
NO.	DATE	DESCRIPTION	PORT AUTHORITY OF ALLEGHENY COUNTY, PENNSYLVANIA.
		REVISIONS	COUNTY, PENNSTEVANIA.

(NOT FOR CONSTRUCTION)

DESIGNED	ICG	
DRAWN	<u>TCG</u>	
CHECKED	KCF	
IN CHARGE	GEC	
DATE	05/01/24	
SCALE		
	AS SHOWN	

### PORT AUTHORITY OF ALLEGHENY COUNTY BUS RAPID TRANSIT UPTOWN TO OAKLAND


DRAINAGE PROFILES DRAINAGE STRUCTURES G01 - G02

**Port Authority** 


CONTRACT NO. BRT-001 sнт. 169

DWG. NO. CV94


## GO4-3 TO EXISTING (FORBES AND STEVENSON)

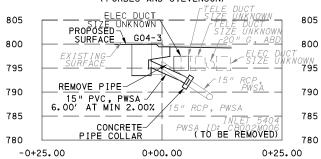

#### GO4-12 TO EXISTING

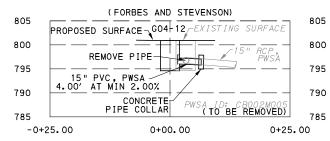


### G05-3 T0 G05-4

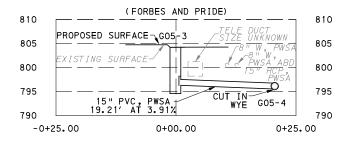


#### G04-4 T0 G04-5


#### (FORBES AND STEVENSON)

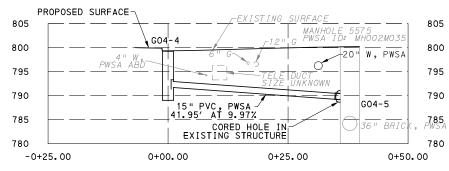

#### G05-1 T0 G05-2

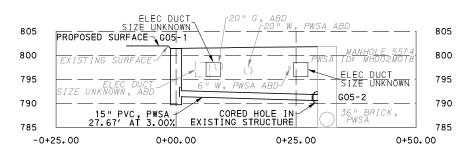

#### GO5-5 TO EXISTING

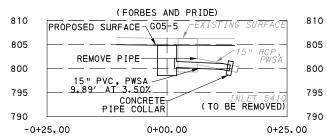

## **AECOM**

Gulf Tower 707 Grant Street 5th Floor Pittsburgh, PA 15219 GANNETT FLEMING
GANNETT FLEMING, INC.
Foster Plaza 8
Suite 400
730 Holiday Drive
Pittsburgh, PA. 15220

-			THE PREPARATION OF THIS
			DOCUMENT HAS BEEN FINANCED IN
			PART THROUGH A GRANT FROM THE
			FEDERAL TRANSIT ADMINISTRATION,
			U.S. DEPARTMENT OF
			TRANSPORTATION, UNDER THE
			URBAN MASS TRANSPORTATION ACT
$\vdash$			OF 1964, AS AMENDED, FOR THE
NO.	DATE	DESCRIPTION	PORT AUTHORITY OF ALLEGHENY
		REVISIONS	COUNTY, PENNSYLVANIA.

(NOT FOR CONSTRUCTION)

DESIGNED	<u>TCG</u>	
DRAWN	<u>TCG</u>	
CHECKED	<u>KCF</u>	
IN CHARGE	<u>GEC</u>	
DATE	05/01/24	
SCALE		
	AS SHOWN	

## PORT AUTHORITY OF ALLEGHENY COUNTY PITTSBURGH PENNSYLVANIA PLIS PADID TRANSIT LIDTOWN TO OAKLAND


BUS RAPID TRANSIT UPTOWN TO OAKLAND
DRAINAGE PROFILES
DRAINAGE STRUCTURES G04 - G05

Port Authority


CONTRACT NO. BRT-001

DWG. NO. CV95 SHT. 170


#### G05-8 TO G05-9

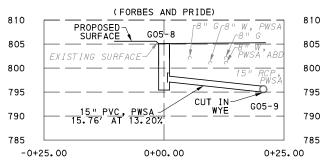

#### G05-7 TO G05-6

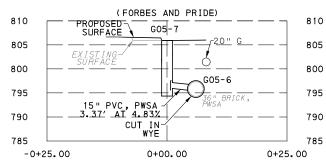


### G05-15 TO G05-14

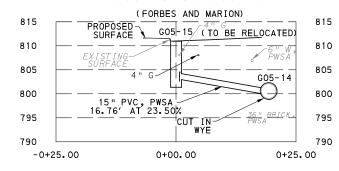


#### GO5-10 TO EXISTING

(FORBES AND PRIDE)

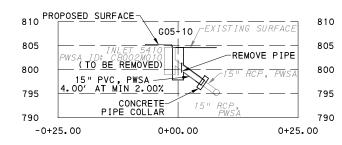


#### G05-16 TO G05-17

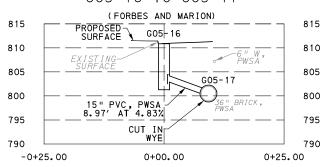

### G05-13 TO G05-11

(FORBES AND MARION)

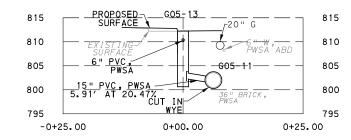

## **AECOM**

Gulf Tower 707 Grant Street 5th Floor Pittsburgh, PA 15219 GANNETT FLEMING
GANNETT FLEMING, INC.
Foster Plaza 8
Suite 400
730 Holiday Drive
Pittsburgh, PA. 15220

NO. DATE

		THE PREPARATION OF THIS
_		DOCUMENT HAS BEEN FINANCED IN
		PART THROUGH A GRANT FROM THE
		FEDERAL TRANSIT ADMINISTRATION,
_		U.S. DEPARTMENT OF
		TRANSPORTATION, UNDER THE
		URBAN MASS TRANSPORTATION ACT
_		OF 1964, AS AMENDED, FOR THE
	DESCRIPTION	PORT AUTHORITY OF ALLEGHENY COUNTY, PENNSYLVANIA.
	DEVISIONS	COUNTY, PENNSTLVANIA.

(NOT FOR CONSTRUCTION)

DESIGNED	ICG	
DRAWN	<u>TCG</u>	
CHECKED	KCF	
IN CHARGE	GEC	
DATE	05/01/24	
SCALE		
	AS SHOWN	

## PORT AUTHORITY OF ALLEGHENY COUNTY PITTSBURGH BUS RAPID TRANSIT UPTOWN TO OAKLAND

RAPID TRANSIT UPTOWN TO OAKLAND DRAINAGE PROFILES DRAINAGE STRUCTURES G05

Port Authority


CONTRACT NO. BRT-001

DWG. NO. CV96 SHT. 171


TRANSPORTATION, UNDER THE URBAN MASS TRANSPORTATION ACT OF 1964, AS AMENDED, FOR THE PORT AUTHORITY OF ALLEGHENY COUNTY, PENNSYLVANIA.

### GO5-12 TO EXISTING

(FORBES AND MARION)

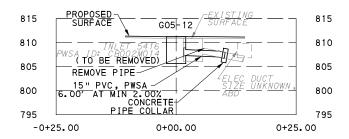


#### G06-2 TO G06-12

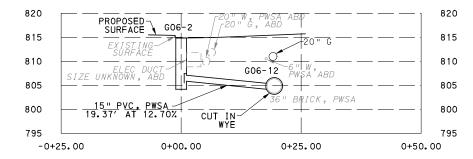


#### GO6-9 TO EXISTING


(FORBES AND VAN BRAAM)

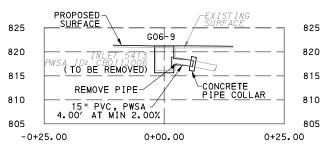

#### G06-1 TO G06-3

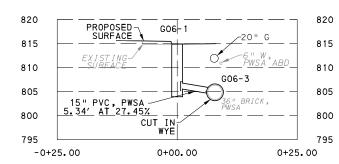

#### GO6-6 TO EXISTING

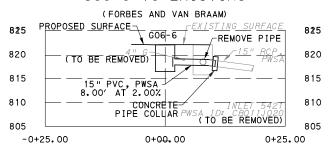

**Gulf Tower** 707 Grant Street 5th Floor Pittsburgh, PA 15219 GANNETT FLEMING Foster Plaza 8 Suite 400 730 Holiday Drive Pittsburgh, PA. 15220

NO. DATE


		THE PREPARATION OF THIS
_		DOCUMENT HAS BEEN FINANCED IN
		PART THROUGH A GRANT FROM THE
		FEDERAL TRANSIT ADMINISTRATION,
		U.S. DEPARTMENT OF
		TRANSPORTATION, UNDER THE
		URBAN MASS TRANSPORTATION ACT
		OF 1964, AS AMENDED, FOR THE
	DESCRIPTION	PORT AUTHORITY OF ALLEGHENY COUNTY, PENNSYLVANIA.
	REVISIONS	COUNTY, PENNSTEVANIA.

(NOT FOR CONSTRUCTION)

DESIGNED ]	<u>rcg</u>	PORT A	UTHOR	ITY OF A	LLEGHENY	COUN	<b>NTY</b>	,
DRAWN ]	<u>rcg</u>	PITTSBURGH				PENNSYL	VANIA	١.
CHECKED E	<u>KCF</u>	BUS R	APID TR	ANSIT UP	TOWN TO O	AKLAN	1D	
IN CHARGE	<u>GEC</u>		DF	RAINAGE PI	ROFILES			
DATE <u>(</u>	05/ <u>01/24</u>		DRAINAG	E STRUCTI	JRES G05 - G0	06		
SCALE	SHOWN	Port Auth	nority	CONT	RACT NO. BI	RT-001		
AG	OHOWN		people to life	DWG. NO.	CV97	s	HT.	1


sнт. 172

### G06-5 TO G06-8

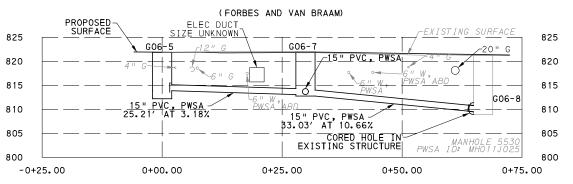


G06-4 TO G06-7

(FORBES AND VAN BRAAM)

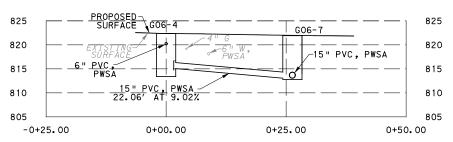

G07-1 TO G07-3

(FORBES AND MILTENBERGER)

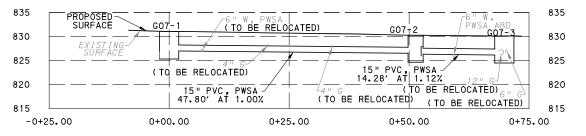

**AECOM** 

Gulf Tower 707 Grant Street 5th Floor Pittsburgh, PA 15219 GANNETT FLEMING
GANNETT FLEMING, INC.
Foster Plaza 8
Suite 400
730 Holiday Drive
Pittsburgh, PA. 15220


		THE PREPARATION OF THIS DOCUMENT HAS BEEN FINANCED IN PART THROUGH A GRANT FROM THE FEDERAL TRANSIT ADMINISTRATION, U.S. DEPARTMENT OF TRANSPORTATION, UNDER THE URBAN MASS TRANSPORTATION ACT
DATE	DESCRIPTION	OF 1964, AS AMENDED, FOR THE PORT AUTHORITY OF ALLEGHENY COUNTY, PENNSYLVANIA.
	REVISIONS	COUNTY, PENNSYLVANIA.

(NOT FOR CONSTRUCTION)


DESIGNED	TCG	PORT AUTHOR	ITY OF AL	LEGHENY COL	JNTY	
DRAWN	TCG	PITTSBURGH		PENNS	SYLVANIA	
CHECKED	KCF	BUS RAPID TRANSIT UPTOWN TO OAKLAND				
IN CHARGE	<u>GEC</u>	DRAINAGE PROFILES				
DATE	05/01/24	DRAINAGE STRUCTURES G06 - G07				
SCALE ^	S SHOWN	Port Authority	CONTR	RACT NO. BRT-00	)1	
AS SHOWN		connecting people to life	DWG. NO.	CV98	sнт. <b>173</b>	

#### GO7-4 TO EXISTING

(FORBES AND MILTENBERGER)

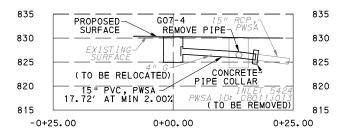


### G09-2 TO G09-3 (FORBES AND JUMONVILLE)

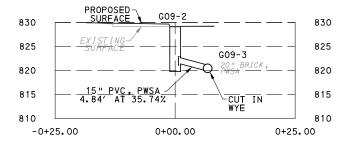


#### GO9-5 TO EXISTING

(FORBES AND JUMONVILLE)

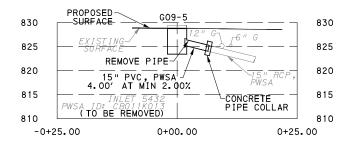


#### G09-1 T0 G09-6

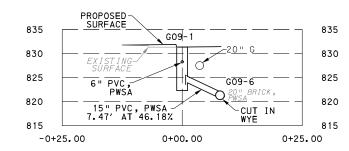


#### GO9-4 TO EXISTING

(FORBES AND JUMONVILLE)

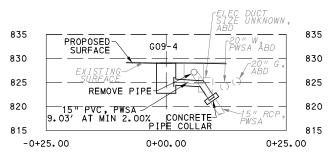

#### GO9-9 TO EXISTING

(FORBES AND JUMONVILLE)

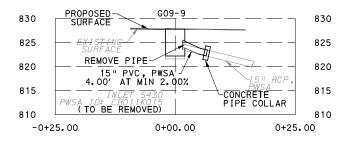



Gulf Tower 707 Grant Street 5th Floor Pittsburgh, PA 15219



NO. DATE

	THE PREPARATION OF THIS DOCUMENT HAS BEEN FINANCED IN
	PART THROUGH A GRANT FROM THE
	FEDERAL TRANSIT ADMINISTRATION, U.S. DEPARTMENT OF
	TRANSPORTATION, UNDER THE
	URBAN MASS TRANSPORTATION ACT OF 1964, AS AMENDED, FOR THE
DESCRIPTION	PORT AUTHORITY OF ALLEGHENY COUNTY, PENNSYLVANIA.
REVISIONS	COUNTY, PENNSTEVANIA.

(NOT FOR CONSTRUCTION)

DESIGNED	TCG	
DRAWN	TCG	
CHECKED	KCF	
IN CHARGE	GEC	
DATE	05/01/24	
SCALE	AS SHOWN	


### PORT AUTHORITY OF ALLEGHENY COUNTY BUS RAPID TRANSIT UPTOWN TO OAKLAND

DRAINAGE PROFILES DRAINAGE STRUCTURES G07 - G09

Port Authority


CONTRACT NO. BRT-001 DWG. NO. CV99 sнт. **174** 

### G09-7 TO G09-8 (FORBES AND JUMONVILLE)

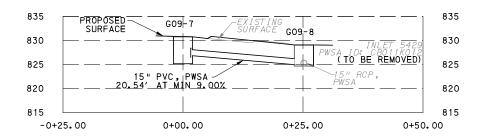

### G10-3 TO EXISTING


(FORBES AND SENECA)

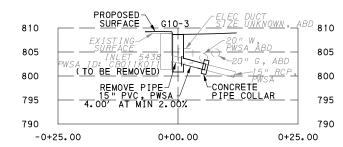

#### G10-6 TO EXISTING (FORBES AND SENECA)


810 810 805 805 800 800 (TO BE REMOVED) REMOVE PIPE-795 795 15" PVC, PWSA 7 4.00' AT MIN 2.00% 790 790 -0+25.00 0+00.00 0+25.00

### G10-1 TO G10-2

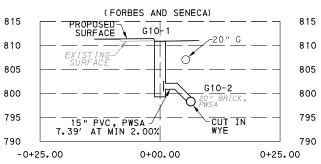


#### G10-4 TO EXISTING

(FORBES AND SENECA)

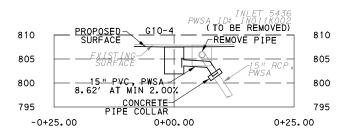

#### G11-1 TO G11-2

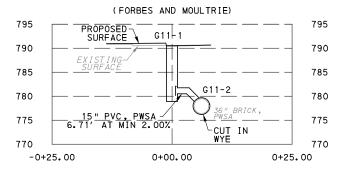

**Gulf Tower** 707 Grant Street 5th Floor Pittsburgh, PA 15219 GANNETT FLEMING Foster Plaza 8 Suite 400 730 Holiday Drive Pittsburgh, PA. 15220

NO. DATE

	THE PREPARATION OF THIS	
	DOCUMENT HAS BEEN FINANCED IN	
	PART THROUGH A GRANT FROM THE	
	FEDERAL TRANSIT ADMINISTRATION.	
	U.S. DEPARTMENT OF	
	TRANSPORTATION, UNDER THE	
	URBAN MASS TRANSPORTATION ACT	
	OF 1964, AS AMENDED, FOR THE	
DESCRIPTION	PORT AUTHORITY OF ALLEGHENY	
DEVISIONS	COUNTY, PENNSYLVANIA.	

(NOT FOR CONSTRUCTION)

SCALE		
DATE	05/01/24	
IN CHARGE	GEC	
CHECKED	KCF	
DRAWN	<u>TCG</u>	
DESIGNED	100	

### PORT AUTHORITY OF ALLEGHENY COUNTY BUS RAPID TRANSIT UPTOWN TO OAKLAND

DRAINAGE PROFILES DRAINAGE STRUCTURES G09 - G11


**Port Authority** 

CONTRACT NO. BRT-001 DWG.NO. CV100 sнт. **175** 


AS SHOWN

#### G11-3 TO EXISTING

(FORBES AND MOULTRIE)

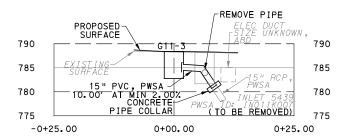


#### G12-1 TO G12-2

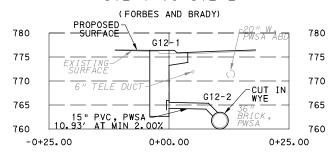


#### G12-4 TO G12-6

(FORBES AND BIRMINGHAM BR)

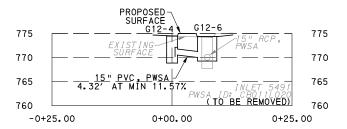


#### G11-5 TO EXISTING

(FORBES AND MOULTRIE)

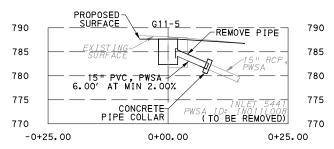

#### G12-3 TO EXISTING

(FORBES AND BRADY)

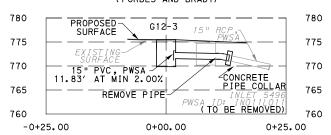

**AECOM** 

Gulf Tower 707 Grant Street 5th Floor Pittsburgh, PA 15219 GANNETT FLEMING
GANNETT FLEMING, INC.
Foster Plaza 8
Suite 400
730 Holiday Drive
Pittsburgh, PA. 15220

. —			THE PREPARATION OF THIS
1			
$\vdash$			DOCUMENT HAS BEEN FINANCED IN
			PART THROUGH A GRANT FROM THE
			FEDERAL TRANSIT ADMINISTRATION.
-			U.S. DEPARTMENT OF
			TRANSPORTATION, UNDER THE
			URBAN MASS TRANSPORTATION ACT
			OF 1964, AS AMENDED, FOR THE
NO.	DATE	DESCRIPTION	PORT AUTHORITY OF ALLEGHENY COUNTY, PENNSYLVANIA.
		REVISIONS	COUNTY, PENNSTEVANIA.

(NOT FOR CONSTRUCTION)

DESIGNED	<u>TCG</u>	
DRAWN	<u>TCG</u>	
CHECKED	KCF	
IN CHARGE	GEC	
DATE	05/01/24	
SCALE		
	AS SHOWN	


# PORT AUTHORITY OF ALLEGHENY COUNTY PITTSBURGH PENNSYLVANIA BUS RAPID TRANSIT UPTOWN TO OAKLAND

DRAINAGE PROFILES
DRAINAGE STRUCTURES G11- G12

Port Authority

 CONTRACT NO. BRT-001

 DWG. NO.
 CV101
 SHT.
 176

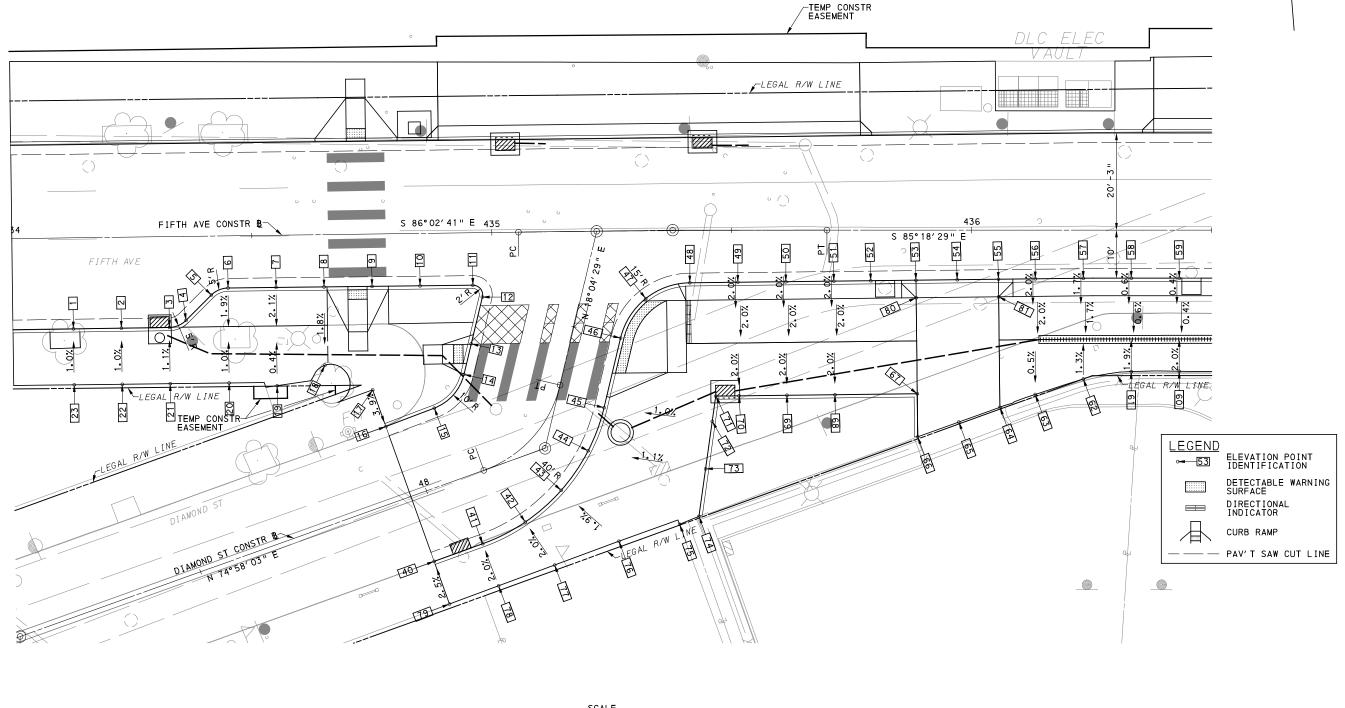

20 FEET

**AECOM** 

Gulf Tower 707 Grant Street 5th Floor Pittsburgh, PA 15219 THE PREPARATION OF THIS
DOCUMENT HAS BEEN FINANCED IN
PART THROUGH A GRANT FROM THE
FEDERAL TRANSIT ADMINISTRATION,
U.S. DEPARTMENT OF
TRANSPORTATION, UNDER THE
URBAN MASS TRANSPORTATION ACT
OF 1984, AS AMENDED, FOR THE
NO. DATE
DESCRIPTION
REVISIONS

THE PREPARATION OF THIS
PORT AUTHORITY OF ALLEGHENY
COUNTY, PENNSYLVANIA.

(NOT FOR CONSTRUCTION)

ESIGNED	MJ <u>P/A</u> GO	
RAWN	<u>JBM</u>	
HECKED	<u>BFS</u>	
N CHARGE	LAR	
ATE	05/01/24	
CALE	AS SHOWN	Po

FOR ROADWAY PLAN SEE SHEET 357

PORT AUTHORITY OF ALLEGHENY PENNSYLVANIA

BUS RAPID TRANSIT UPTOWN TO OAKLAND

BUS RAPID TRANSIT UPTOWN TO OAKLAND
INTERSECTION DETAILS
FIFTH AVE & DIAMOND ST

sнт. **177** 

Port Authority CONTRACT NO. BRT-001
DWG. NO. ID1 SH

OPERATOR: "michdel

	·m/d0212166/BR]
	I. mcdarry@decom, cc
	s16_na\michae
: "michael.mcgarry"	FILE PATH; c:/bwworking/decom_ds16_ng/michdel.mcdgrry@decom.com/d0212166/BR]
OPERATOR: "mi	FILE PATH: C:

**AECOM** 

Gulf Tower 707 Grant Street 5th Floor Pittsburgh, PA 15219

SOUTHWEST QUADRANT							
POINT NUMBER	BASEL INE	POINT	STATION	OFFSET	ELEVATION BOTTOM OF CURB	ELEVATION TOP OF CURB	ELEVATION BACK OF SIDEWALK
1	FIFTH AVE	POT	434+12.59	18.96′ RT	765.68	765.84	-
2	FIFTH AVE	POT	434+22.59	18.94′ RT	765.65	765.82	-
3	FIFTH AVE	PC	434+32.59	18.91' RT	765.62	765.76	-
4	FIFTH AVE	PŤ	434+36.07	17.49' RT	765.63	765.79	-
5	FIFTH AVE	PC	434+41.42	12.28' RT	765.73	765.90	-
6	FIFTH AVE	PT	434+44.91	10.86′ RT	765.75	765.92	-
7	FIFTH AVE	POT	434+54.91	10.88' RT	765.70	765.87	-
8	FIFTH AVE	POT	434+64.91	10.89' RT	765.65	765.82*	-
9	FIFTH AVE	POT	434+74.91	10.91'RT	765.60	*	-
10	FIFTH AVE	POT	434+84.91	10.92' RT	765.55	765.72	-
11	FIFTH AVE	PC	434+95.92	10.94' RT	765.50	765.67	-
12	DIAMOND ST	PT	48+51.60	20.00' LT	765.48	765.65	-
13	DIAMOND ST	POT	48+41.60	20.00' LT	[765.43]	765.59*	-
14	DIAMOND ST	PC	48+26.07	19.43'LT	[765.25]	*	-
15	DIAMOND ST	PT	48+07.34	15.67'LT	[764.98]	765.15	-
16	DIAMOND ST	POT	47+96.54	15.47'LT	[764.78]	[764.96]	-
17	DIAMOND ST	-	47+96.54	23.58'LT	-	-	[765.28]
18	DIAMOND ST	-	434+64.91	27. 20' RT	-	-	[765.55]
19	DIAMOND ST	-	434+54.91	31.35′ RT	-	-	[765.76]
20	DIAMOND ST	-	434+44.91	30.65′ RT	-	-	[765.87]
21	FIFTH AVE	-	434+32.59	30.64′ RT	-	-	[765.89]
22	FIFTH AVE	-	434+22.59	30.63′ RT	-	-	765.93
23	FIFTH AVE	-	434+12.59	30.62' RT	-	-	765.95

POINT NUMBER	BASEL INE	POINT	STATION	OFFSET	ELEVATION BOTTOM OF CURB	ELEVATION TOP OF CURB	ELEVATION BACK OF SIDEWAL
40	DIAMOND ST	POT	47+96.54	14.37' RT	[764.56]	[764.73]	-
41	DIAMOND ST	PC	48+07.29	14.33' RT	764.63	764.87	-
42	DIAMOND ST	POC	48+15.63	13.32' RT	764.69	764.98	-
43	DIAMOND ST	POC	48+22.21	12.02' RT	[764.84]	765.00	_
44	DIAMOND ST	POC	48+29.03	10.91' RT	[765.07]	765.23	_
45	DIAMOND ST	PT	48+35.75	10.09' RT	[765.32]	765.48	-
46	DIAMOND ST	PC	48+49.95	10.00' RT	765.53	*	-
47	FIFTH AVE	POC	435+31.96	14.10' RT	765.65	*	-
48	FIFTH AVE	PT	435+41.20	10.88' RT	765.71	765.88*	_
49	FIFTH AVE	POT	435+51.22	10.81' RT	765.73	765.89	_
50	FIFTH AVE	POT	435+61.24	10.72' RT	765.81	765.97	_
51	FIFTH AVE	POT	435+71.26	10.62' RT	765.89	766.06	_
52	FIFTH AVE	POT	435+78.95	10.53' RT	765.95	766. 12	_
53	FIFTH AVE	POT	435+88.37	10. 42' RT	766.02	766. 18	_
54	FIFTH AVE	POT	435+96.97	10.32' RT	766.07	766.24	-
55	FIFTH AVE	POT	436+05.56	10. 22' RT	766.15	766.32	_
56	FIFTH AVE	POT	436+13.24	10.14' RT	766.23	766.56	-
57	FIFTH AVE	POT	436+23.24	10.00' RT	766.33	766.66	_
58	FIFTH AVE	POT	436+33.24	10.00' RT	766.44	766.77	_
59	FIFTH AVE	POT	436+43.24	10.00' RT	766.56	766.89	_
60	FIFTH AVE	-	436+43.21	29. 40' RT	-	-	[766.97]
61	FIFTH AVE	-	436+33.21	29. 45' RT	-	-	[766.83]
62	FIFTH AVE	-	436+23.23	31.00' RT	-	-	[766.56]
63	FIFTH AVE	-	436+13.21	34. 23' RT	_	_	[766.38]
64	FIFTH AVE	-	436+05.86	36.90' RT	_	_	[766.01]
65	FIFTH AVE	-	435+97.30	39.98' RT	-	-	[765.81]
66	FIFTH AVE	-	435+88.74	43.05' RT	[765,73]	766.31	-
67	FIFTH AVE	-	435+88.64	34.09' RT	765.73	766.30	-
68	FIFTH AVE	_	435+71.50	34. 28' RT	765.60	766.18	_
69	FIFTH AVE	-	435+61.44	34.39' RT	765.52	766.10	-
70	FIFTH AVE	-	435+51.37	34. 48' RT	765.43	766.01	-
71	FIFTH AVE	-	435+46.51	34.51'RT	765.42	766.00	-
72	DIAMOND ST	-	48+37.51	32.59' RT	765.72	766.30	-
73	DIAMOND ST	-	48+33.29	34.37′ RT	765.50	766.08	-
74	DIAMOND ST	-	48+29.43	37.72′RT	[765.41]	765.99	-
75	DIAMOND ST	-	48+27.96	35.27′ RT	-	-	[765.30]
76	DIAMOND ST	-	48+23.13	27.98' RT	-	-	[765.31]
77	DIAMOND ST	-	48+16.37	24. 10' RT	-	-	[765.18]
78	DIAMOND ST	-	48+07.46	23.70' RT	-	-	[765.05]
79	DIAMOND ST	-	47+96.54	23.81' RT	-	-	[764.95]
80	FIFTH AVE	-	435+88.41	14.09' RT	-	-	766.12
81	FIFTH AVE	-	436+05.60	13.89' RT	_	-	766.26

NOTE:

\* TOP OF CURB ELEVATION TO BE DETERMINED PER ITEM # 01900.001-DESIGN OF CURB RAMPS

[] MATCH EXISTING ELEVATION


_	Ditte	REVISIONS	COUNTY, PENNSYLVANIA.
`	DATE	DESCRIPTION	PORT AUTHORITY OF ALLEGHENY
			URBAN MASS TRANSPORTATION AC OF 1964, AS AMENDED, FOR THE
			TRANSPORTATION, UNDER THE
			FEDERAL TRANSIT ADMINISTRATION U.S. DEPARTMENT OF
			PART THROUGH A GRANT FROM THE
			THE PREPARATION OF THIS DOCUMENT HAS BEEN FINANCED IN

(NOT FOR CONSTRUCTION)

ESIGNED	MJ <u>P/A</u> GO	PORT AU
DRAWN	<u>JBM</u>	PITTSBURGH
CHECKED	<u>BFS</u>	BUS RA
N CHARGE	<u>LAR</u>	
ATE	<u>05/01/24</u>	
CALE	AS SHOWN	Port Autho

## JTHORITY OF ALLEGHENY COUNTY PENNSYLVANIA APID TRANSIT UPTOWN TO OAKLAND INTERSECTION DATA FIFTH AVE & DIAMOND ST

CONTRACT NO. BRT-001 DWG. NO. ID2 sнт. 178

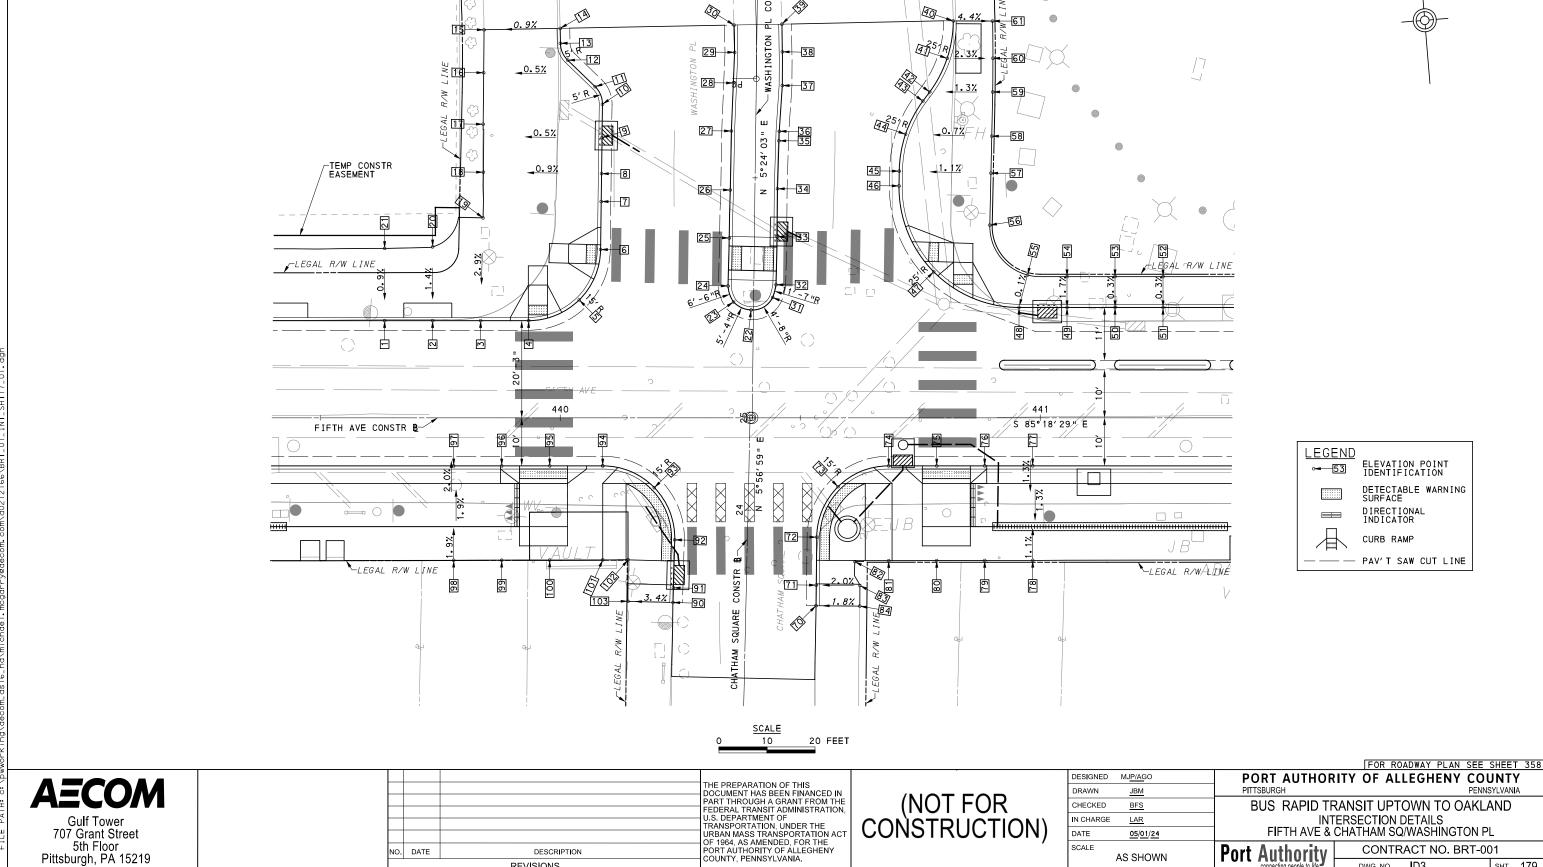

SCALE

AS SHOWN

Port Authority connecting people to life

CONTRACT NO. BRT-001

sнт. **179** 

DWG. NO. ID3

5th Floor Pittsburgh, PA 15219

NO. DATE

DESCRIPTION

REVISIONS

			NORTH	HWEST QUA	ADRANT		
POINT NUMBER	BASEL INE	POINT	STATION	OFFSET	ELEVATION BOTTOM OF CURB	ELEVATION TOP OF CURB	ELEVATION BACK OF SIDEWALK
1	FIFTH AVE	POT	439+63.42	20.25′ LT	771.29	771.61	-
2	FIFTH AVE	POT	439+73.42	20.25′ LT	771.47	771.80	-
3	FIFTH AVE	POT	439+83.42	20.25′ LT	771.64	771.97	-
4	FIFTH AVE	PC	439+93.42	20.25′ LT	771.83	*	-
5	FIFTH AVE	POC	440+03.96	24.58′ LT	772.09	772.55	-
6	WASHINGTON PLACE	PT	25+34.67	32.00′ LT	772.28	*	-
7	WASHINGTON PLACE	POT	25+44.67	32.00′ LT	772.47	773.05	-
8	WASHINGTON PLACE	PC	25+50.48	32.00′ LT	772.58	773.16	-
9	WASHINGTON PLACE	POC	25+57.96	33.14′ LT	772.71	773.29	-
10	WASHINGTON PLACE	PC	25+64.94	32.00′ LT	772.93	773.51	-
11	WASHINGTON PLACE	PT	25+68.58	39.69′ LT	773.04	773.55	-
12	WASHINGTON PLACE	PC	25+74.45	39.33′ LT	773.21	773.60	-
13	WASHINGTON PLACE	PT	25+78.40	40.84′ LT	773.35	773.67	-
14	WASHINGTON PLACE	POT	25+81.92	40.84′ LT	[773.44]	[773.69]	-
15	WASHINGTON PLACE	-	25+81.92	56.71′ LT	-	-	[773.56]
16	WASHINGTON PLACE	-	25+71.30	56.83′ LT	-	-	[773.47]
17	WASHINGTON PLACE	-	25+60.48	56.80′ LT	-	-	[773.26]
18	WASHINGTON PLACE	-	25+50.48	56.62′ LT	-	-	[772.95]
19	WASHINGTON PLACE	-	25+40.95	56.57′ LT	-	-	[772.60]
20	FIFTH AVE	-	439+73.42	35.62′ LT	-	-	[772.02]
21	FIFTH AVE	-	439+63.42	35.30′ LT	-	-	[771.75]
22	WASHINGTON PLACE	PCC	25+22.46	0.50' LT	[772.81]	773.02	-
23	WASHINGTON PLACE	PCC	25+24.09	4.19' LT	[772.72]	773.04	-
24	WASHINGTON PLACE	PT	25+27.41	5.36′ LT	[772.62]	772.95	-
25	WASHINGTON PLACE	POT	25+37.41	5.24′ LT	[772.60]	772.94	-
26	WASHINGTON PLACE	POT	25+47.41	5.14′ LT	[772.79]	773.12	-
27	WASHINGTON PLACE	ΡI	25+59.71	5.07′ LT	[773.01]	773.34	-
28	WASHINGTON PLACE	POT	25+69.70	4.79′ LT	[773.19]	773.53	-
29	WASHINGTON PLACE	ΡI	25+76.16	4.56′ LT	[773.34]	773.65	-
30	WASHINGTON PLACE	POT	25+81.92	4.61′ LT	[773.42]	[773.75]	-

SOUTHWEST QUADRANT							
POINT NUMBER	BASEL INE	POINT	STATION	OFFSET	ELEVATION BOTTOM OF CURB	ELEVATION TOP OF CURB	ELEVATION BACK OF SIDEWALK
90	CHATHAM SQUARE	POT	23+80.41	15.21' LT	[773.92]	[774.33]	-
91	CHATHAM SQUARE	POT	23+83.48	15.19' LT	[773.64]	774.05*	-
92	CHATHAM SQUARE	PC	23+93.48	15.14′ LT	772.88	*	-
93	FIFTH AVE	POC	440+19.60	14.54′ RT	772.64	*	-
94	FIFTH AVE	PT	440+08.85	10.00' RT	772.42	772.45*	-
95	FIFTH AVE	POT	439+97.81	10.00' RT	772.18	*	-
96	FIFTH AVE	POT	439+87.81	10.00' RT	771.96	*	-
97	FIFTH AVE	POT	439+77.81	10.00' RT	771.75	772.30	-
98	FIFTH AVE	-	439+77.81	29.69' RT	-	-	[772.66]
99	FIFTH AVE	-	439+87.81	29.67′ RT	-	-	[772.79]
100	FIFTH AVE	-	439+97.81	29.64′ RT	-	-	[773.22]
101	FIFTH AVE	-	440+08.86	29.60' RT	-	-	[773.22]
102	FIFTH AVE	-	440+14.14	29.58' RT	-	-	[773.26]
103	CHATHAM SQUARE	-	23+80.46	24.59′ LT	-	-	[774.01]

			NORTH	HEAST QUA	DRANT		
POINT NUMBER	BASEL INE	POINT	STATION	OFFSET	ELEVATION BOTTOM OF CURB	ELEVATION TOP OF CURB	ELEVATION BACK OF SIDEWALK
31	WASHINGTON PLACE	POC	25+25.12	3.97′ RT	[772.82]	773.15	-
32	WASHINGTON PLACE	PC	25+27.79	4.63′ RT	[772.75]	773.08	-
33	WASHINGTON PLACE	POT	25+37.79	4.71′ RT	772.56	772.88	-
34	WASHINGTON PLACE	POT	25+47.79	4.69′ RT	[772.89]	773.22	-
35	WASHINGTON PLACE	POT	25+57.79	4.87′ RT	[773.10]	773.43	-
36	WASHINGTON PLACE	ΡI	25+59.77	4.90' RT	[773.17]	773.48	-
37	WASHINGTON PLACE	ΡI	25+69.31	5.43′ RT	[773.34]	773.67	-
38	WASHINGTON PLACE	POT	25+76.24	5.39' RT	[773.49]	773.82	-
39	WASHINGTON PLACE	POT	25+81.92	5.36′ RT	[773.61]	773.94	-
40	WASHINGTON PLACE	PC	25+81.92	41.07′ RT	[773.96]	[774.55]	-
41	WASHINGTON PLACE	POC	25+74.93	39.72′ RT	773.82	774.38	-
42	WASHINGTON PLACE	PT	25+68.35	36.13′ RT	773.67	774.20	-
43	WASHINGTON PLACE	PC	25+66.43	34.74′ RT	773.57	774.15	-
44	WASHINGTON PLACE	POC	25+59.48	31.22′ RT	773.40	773.98	-
45	WASHINGTON PLACE	PT	25+51.78	30.00′ RT	773.23	773.81	-
46	WASHINGTON PLACE	PC	25+48.68	30.00' RT	773.14	773.72	-
47	FIFTH AVE	POC	440+77.80	30. 43' LT	773.26	*	-
48	FIFTH AVE	PT	440+95.59	23.00' LT	773.40	773.74	-
49	FIFTH AVE	POT	441+05.59	23.00′ LT	773.56	773.89	-
50	FIFTH AVE	POT	441+15.59	23.00′ LT	773.76	774.09	-
51	FIFTH AVE	POT	441+25.59	23.00′ LT	773.95	774.29	-
52	FIFTH AVE	-	441+25.59	29. 42' LT	-	-	[774.31]
53	FIFTH AVE	-	441+15.59	29. 42' LT	-	-	[774.11]
54	FIFTH AVE	-	441+05.59	29. 42' LT	-	-	[774.00]
55	FIFTH AVE	-	440+97.34	29.76′LT	-	-	[773.75]
56	WASHINGTON PLACE	-	25+40.76	49.00' RT	-	-	[773.83]
57	WASHINGTON PLACE	-	25+51.59	49.10' RT	-	-	[774.01]
58	WASHINGTON PLACE	-	25+59.30	49.18' RT	-	-	[774.10]
59	WASHINGTON PLACE	-	25+68.51	49.26′ RT	-	-	[774.37]
60	WASHINGTON PLACE	-	25+74.94	49.26′ RT	-	-	[774.58]
61	WASHINGTON PLACE	-	25+81.76	49.25′ RT	-	-	[774.81]

			SOUTH	HEAST QUA	ADRANT		
POINT NUMBER	BASELINE	POINT	STATION	OFFSET	ELEVATION BOTTOM OF CURB	ELEVATION TOP OF CURB	ELEVATION BACK OF SIDEWAL
70	CHATHAM SQUARE	POT	23+80.41	14.60' RT	[774.24]	[774.60]	-
71	CHATHAM SQUARE	POT	23+84.69	14.55′ RT	[773.85]	774.25*	-
72	CHATHAM SQUARE	PC	23+94.69	14.43′ RT	773.27	*	-
73	FIFTH AVE	POC	440+57.88	14.34′ RT	773.04	*	-
74	FIFTH AVE	PT	440+68.43	10.00' RT	773.36	773.38*	-
75	FIFTH AVE	POT	440+78.43	10.00' RT	773.46	*	-
76	FIFTH AVE	POT	440+88.44	10.00' RT	773.56	*	-
77	FIFTH AVE	POT	440+98.43	10.00' RT	773.66	773.99	-
78	FIFTH AVE	-	440+98.44	29.70' RT	-	-	[773.91]
79	FIFTH AVE	-	440+88.43	29.72′ RT	-	=	[773.87]
80	FIFTH AVE	-	440+78.43	29.74′ RT	-	-	[773.86]
81	FIFTH AVE	-	440+68.43	29.76′ RT	-	-	[773.80]
82	FIFTH AVE	-	440+61.38	29.96′ RT	-	-	[773.94]
83	CHATHAM SQUARE	-	23+84.80	23.65′ RT	-	-	[774.42]
84	CHATHAM SQUARE	-	23+80.52	23.71' RT	_	-	[774.76]

\* TOP OF CURB ELEVATION TO BE DETERMINED PER ITEM # 01900.001-DESIGN OF CURB RAMPS

[] MATCH EXISTING ELEVATION

NO.	DATE	DES

THE PREPARATION OF THIS

DOCUMENT HAS BEEN FINANCED IN
PART THROUGH A GRANT FROM THE
FEDERAL TRANSIT ADMINISTRATION,
U.S. DEPARTMENT OF
TRANSPORTATION, UNDER THE
URBAN MASS TRANSPORTATION ACT
OF 1964, AS AMENDED, FOR THE
PORT AUTHORITY OF ALLEGHENY
COUNTY, PENNSYLVANIA. ESCRIPTION REVISIONS

(NOT FOR CONSTRUCTION)

ESIGNED	MJ <u>P/A</u> GO	
RAWN	<u>JBM</u>	
HECKED	BFS	
CHARGE	<u>LAR</u>	
ATE	05/01/24	
CALE		
	AS SHOWN	

### PORT AUTHORITY OF ALLEGHENY COUNTY PITTSBURGH BUS RAPID TRANSIT UPTOWN TO OAKLAND

INTERSECTION DATA
FIFTH AVE & CHATHAM SQ/WASHINGTON PL

Port Authority connecting people to life

CONTRACT NO. BRT-001 DWG. NO. D4 sнт. 180

Gulf Tower 707 Grant Street 5th Floor Pittsburgh, PA 15219

**AECOM** 

SCALE

AS SHOWN

Port Authority

CONTRACT NO. BRT-001

sнт. 181

DWG. NO. ID5

5th Floor Pittsburgh, PA 15219

NO. DATE

DESCRIPTION

REVISIONS

SOUTHEAST QUADRANT							
POINT NUMBER	BASEL INE	POINT	STATION	OFFSET	ELEVATION BOTTOM OF CURB	ELEVATION TOP OF CURB	ELEVATION BACK OF SIDEWALK
30	MAGEE ST	POT	36+35.22	14.69' RT	[792.18]	[792.70]	-
31	MAGEE ST	POT	36+45.22	14.66′ RT	791.93	*	-
32	MAGEE ST	PC	36+50.24	14.60' RT	791.91	*	-
33	FIFTH AVE	POC	448+05.46	14.33′ RT	791.85	*	-
34	FIFTH AVE	PT	448+16.01	10.00' RT	792.14	*	-
35	FIFTH AVE	PI	448+19.54	10.00' RT	792.22	*	-
36	FIFTH AVE	POT	448+29.54	10.30' RT	792.46	793.05	-
37	FIFTH AVE	POT	448+39.54	10.60' RT	792.70	793.29	-
38	FIFTH AVE	POT	448+49.54	10.90' RT	792.95	793.53	-
39	FIFTH AVE	-	448+49.54	29.92′ RT	-	-	[793.53]
40	FIFTH AVE	-	448+39.54	26.30' RT	-	-	[793.23]
41	FIFTH AVE	-	448+29.54	29.83′ RT	-	-	[793.15]
42	FIFTH AVE	-	448+19.54	29.82′RT	-	-	[792.91]
43	FIFTH AVE	-	448+16.01	29.84′ RT	-	-	[792.82]
44	FIFTH AVE	-	448+10.72	29.88′RT	-	-	[792.82]
45	MAGEE ST	-	36+35.21	24.54′ RT	-	-	[793.28]

SOUTHWEST QUADRANT								
POINT NUMBER	BASEL INE	POINT	STATION	OFFSET	ELEVATION BOTTOM OF CURB	ELEVATION TOP OF CURB	ELEVATION BACK OF SIDEWALK	
50	MAGEE ST	POT	36+35.22	15.19'LT	[791.42]	[791.80]	-	
51	MAGEE ST	POT	36+39.03	15.18'LT	791.29	791.68*	-	
52	MAGEE ST	PC	36+49.03	15.17'LT	791.04	*	-	
53	FIFTH AVE	POC	447+66.95	14.52′ RT	790.80	*	-	
54	FIFTH AVE	PT	447+56.22	10.00' RT	790.57	*	-	
55	FIFTH AVE	POT	447+46.22	10.00' RT	790.25	790.58	-	
56	FIFTH AVE	POT	447+36.22	10.00' RT	789.98	790.31	-	
57	FIFTH AVE	POT	447+26.22	10.00' RT	789.71	790.04	-	
58	FIFTH AVE	-	447+26.22	29.82′ RT	-	-	[789.71]	
59	FIFTH AVE	-	447+36.22	29.73′ RT	-	-	[789.97]	
60	FIFTH AVE	-	447+46.22	29.58′ RT	-	-	[790.34]	
61	FIFTH AVE	-	447+56.22	29. 47′ RT	-	-	[790.94]	
62	FIFTH AVE	-	447+60.50	29.44′ RT	-	-	[791.34]	
63	MAGEE ST	-	36+39.04	25.67′LT	-	-	[791.66]	
64	MAGEE ST	-	36+35.22	25.59′LT	-	-	[791.85]	

[] MATCH EXISTING ELEVATION

**AECOM** Gulf Tower 707 Grant Street 5th Floor Pittsburgh, PA 15219

		THE PREPARATION OF THIS DOCUMENT HAS BEEN FINANCED I
		PART THROUGH A GRANT FROM T
		FEDERAL TRANSIT ADMINISTRATIO
		U.S. DEPARTMENT OF TRANSPORTATION, UNDER THE
		URBAN MASS TRANSPORTATION A OF 1964. AS AMENDED, FOR THE
DATE	DESCRIPTION	PORT AUTHORITY OF ALLEGHENY COUNTY, PENNSYLVANIA.
	REVISIONS	COUNTY, PENNSTEVANIA.

(NOT FOR CONSTRUCTION)

 DESIGNED	MJ <u>P/A</u> GO	
DRAWN	<u>JBM</u>	
CHECKED	BFS	
IN CHARGE	LAR	
DATE	05/01/24	
SCALE		
	AS SHOWN	

PORT AUTHORITY OF ALLEGHENY PITTSBURGH	COUNTY PENNSYLVANIA
BUS RAPID TRANSIT UPTOWN TO O	AKLAND

INTERSECTION DATA FIFTH AVE & MAGEE ST

Port	Authority	
016	connecting people to life	

CONTRACT NO. BRT-001 DWG. NO. ID6

sнт. 182

REVISIONS

DWG. NO. D7

sнт. **183** 

	NORTHWEST QUADRANT								
POINT NUMBER	BASEL INE	POINT	STATION	OFFSET	ELEVATION BOTTOM OF CURB	ELEVATION TOP OF CURB	ELEVATION BACK OF SIDEWALK		
1	FIFTH AVE	POT	449+00.00	18.60' LT	794.16	794.66	-		
2	FIFTH AVE	POT	449+10.00	18.30' LT	794.45	794.95	-		
3	FIFTH AVE	ΡI	449+20.00	18.00' LT	794.74	795.24	-		
4	FIFTH AVE	PC	449+32.86	18.00' LT	795.10	795.60	-		
5	LOGAN ST	PT	20+23.01	11.28' LT	795.43	*	-		
6	LOGAN ST	POT	20+33.01	11.26′ LT	796.40	796.90*	-		
7	LOGAN ST	POT	20+39.31	11.25′ LT	[796.90]	[797.36]	-		
8	LOGAN ST	-	20+39.31	19.21′LT	[797.47]	[797.49]	-		
9	FIFTH AVE	-	449+29.91	28.86′ LT	795.56	795.61	-		
10	FIFTH AVE	-	449+20.00	28.86′LT	795.34	795.92	-		
11	FIFTH AVE	-	449+10.00	28.86′LT	795.05	795.63	-		
12	FIFTH AVE	-	449+00.00	28.86′ LT	794.75	795.34	-		


	NORTHEAST QUADRANT							
POINT NUMBER	BASEL INE	POINT	STATION	OFFSET	ELEVATION BOTTOM OF CURB	ELEVATION TOP OF CURB	ELEVATION BACK OF SIDEWALK	
21	LOGAN ST	POT	20+39.42	10.55′ RT	[797.48]	[797.83]	-	
22	LOGAN ST	POT	20+33.03	10.49' RT	796.80	797.16*	-	
23	LOGAN ST	PC	20+23.03	10.38' RT	796.09	*	-	
24	FIFTH AVE	PT	449+64.52	18.00' LT	795.93	796.44	-	
25	FIFTH AVE	POT	449+74.52	18.00' LT	796.16	796.66	-	
26	FIFTH AVE	POT	449+84.52	18.00' LT	796.40	796.90	-	
27	FIFTH AVE	POT	449+94.52	18.00' LT	796.63	797.13	-	
28	FIFTH AVE	-	449+94.52	29.95′LT	-	-	797.24	
29	FIFTH AVE	-	449+84.52	29.95'LT	-	-	[797.07]	
30	FIFTH AVE	-	449+74.52	29.95'LT	-	-	[797.02]	
31	FIFTH AVE	-	449+68.54	29.95'LT	-	-	[796.96]	
32	LOGAN ST	-	20+39.42	19.51′RT	-	-	[797.83]	

[] MATCH EXISTING ELEVATION

**AECOM** Gulf Tower 707 Grant Street 5th Floor Pittsburgh, PA 15219

		THE PREPARATION OF THIS DOCUMENT HAS BEEN FINANCED IN	
		PART THROUGH A GRANT FROM THE	
		FEDERAL TRANSIT ADMINISTRATION,	
		U.S. DEPARTMENT OF TRANSPORTATION, UNDER THE	
		URBAN MASS TRANSPORTATION ACT OF 1964, AS AMENDED, FOR THE	
DATE		PORT AUTHORITY OF ALLEGHENY COUNTY, PENNSYLVANIA.	
	REVISIONS	COUNTY, PENNSTEVANIA.	

ESIGNED	MJ <u>P/A</u> GO	PORT AUTHOR	ITY OF ALLEGHENY	COUNTY	
RAWN	<u>JBM</u>	PITTSBURGH		PENNSYLVANIA	
HECKED	BFS	BUS RAPID TRANSIT UPTOWN TO OAKLAND			
CHARGE	<u>LAR</u>	INTERSECTION DATA			
ATE	<u>05/01/24</u>	FIF	TH AVE & LOGAN ST		
CALE	AS SHOWN	Port Authority	CONTRACT NO. BF	RT-001	
	AS SHOWN	connecting people to life	DWG NO ID8	SHT 18/	

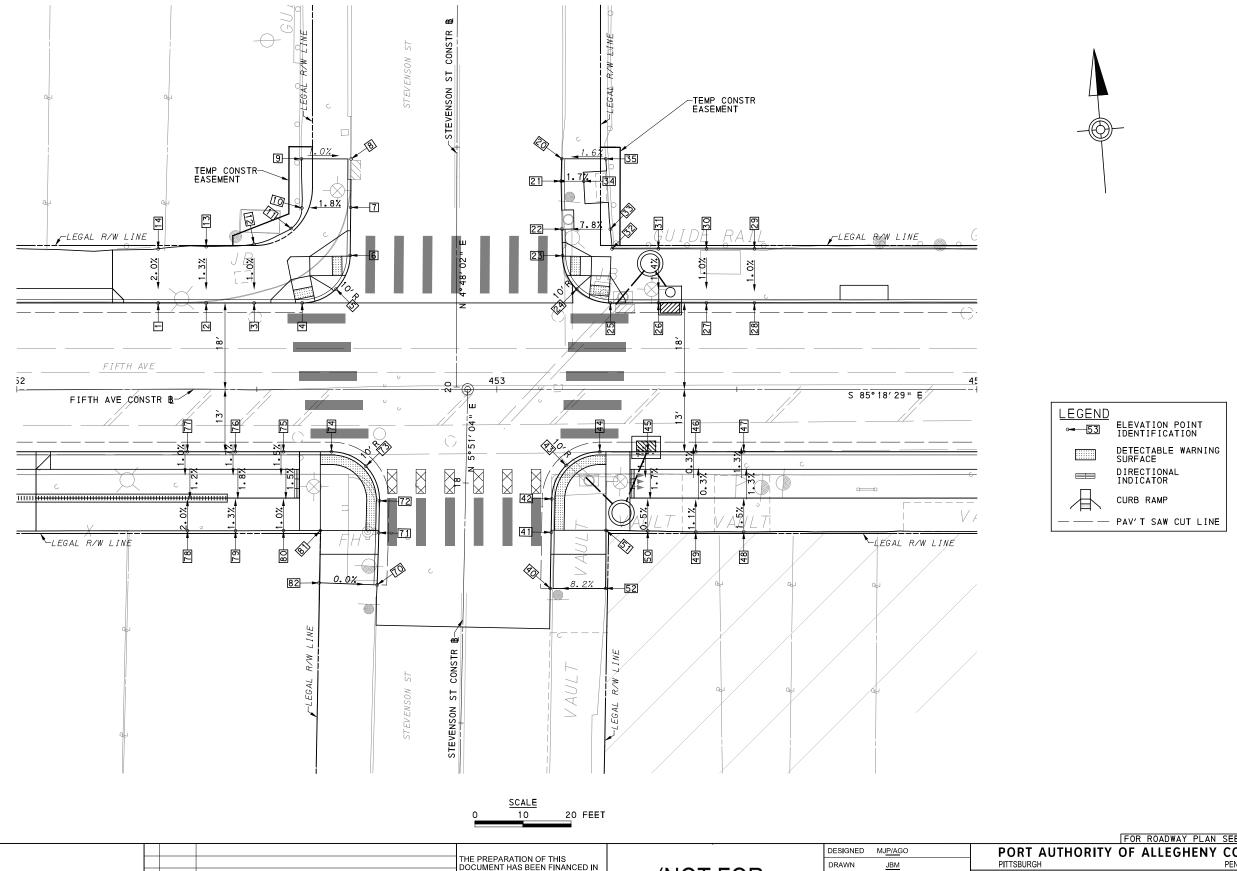

**AECOM** 

707 Grant Street 5th Floor Pittsburgh, PA 15219

THE PREPARATION OF THIS
DOCUMENT HAS BEEN FINANCED IN
PART THROUGH A GRANT FROM THE
FEDERAL TRANSIT ADMINISTRATION, PEDERAL TRANSIT ADMINISTRATION,
U.S. DEPARTMENT OF
TRANSPORTATION, UNDER THE
URBAN MASS TRANSPORTATION ACT
OF 1964, AS AMENDED, FOR THE
PORT AUTHORITY OF ALLEGHENY
COUNTY, PENNSYLVANIA. NO. DATE DESCRIPTION REVISIONS

(NOT FOR CONSTRUCTION)

ESIGNED	MJ <u>P/A</u> GO	
RAWN	<u>JBM</u>	
HECKED	BFS	
CHARGE	<u>LAR</u>	
ATE	05/01/24	
CALE		
	AS SHOWN	

FOR ROADWAY PLAN SEE SHEET 360 PORT AUTHORITY OF ALLEGHENY COUNTY

BUS RAPID TRANSIT UPTOWN TO OAKLAND INTERSECTION DETAILS FIFTH AVE & STEVENSON ST

Port Authority connecting people to life DWG. NO.

CONTRACT NO. BRT-001 ID9 sнт. 185

	NORTHWEST QUADRANT								
POINT NUMBER	BASEL INE	POINT	STATION	OFFSET	ELEVATION BOTTOM OF CURB	ELEVATION TOP OF CURB	ELEVATION BACK OF SIDEWALK		
1	FIFTH AVE	POT	452+29.45	18.00' LT	802.59	803.09	-		
2	FIFTH AVE	POT	452+39.45	18.00' LT	802.84	803.34	-		
3	FIFTH AVE	POT	452+49.45	18.00' LT	803.09	803.59	-		
4	FIFTH AVE	PC	452+59.45	18.00' LT	803.31	*	-		
5	FIFTH AVE	POC	452+66.49	20.89' LT	803.45	*	-		
6	STEVENSON ST	PT	20+27.38	22.20' LT	803.94	*	-		
7	STEVENSON ST	POT	20+37.38	22.12' LT	805.06	805.56	-		
8	STEVENSON ST	POT	20+47.48	22.04′ LT	[806.37]	[806.86]	-		
9	STEVENSON ST	-	20+47.48	32.39'LT	-	-	[806.95]		
10	STEVENSON ST	-	20+37.23	32.28′ LT	-	-	[805.35]		
11	FIFTH AVE	-	452+57.16	33.51′LT	-	-	[804.39]		
12	FIFTH AVE	-	452+49.41	30.25′ LT	-	-	[803.71]		
13	FIFTH AVE	-	452+39.46	29.72′ LT	-	-	[803.45]		
14	FIFTH AVE	-	452+29.46	29. 28' LT	-	-	[803.31]		

POINT NUMBER	BASELINE	POINT	STATION	OFFSET	ELEVATION BOTTOM OF CURB	ELEVATION TOP OF CURB	ELEVATION BACK OF SIDEWAL
20	STEVENSON ST	POT	20+47.60	21.83′ RT	[806.51]	[807.13]	-
21	STEVENSON ST	PI	20+42.94	21.72′ RT	[805.98]	806.50	-
22	STEVENSON ST	POT	20+32.94	21.91′ RT	[804.86]	805.53	-
23	STEVENSON ST	PC	20+27.40	22.02' RT	[804.60]	*	-
24	FIFTH AVE	POC	453+16.66	20.87'LT	[804.59]	*	-
25	FIFTH AVE	PT	453+23.67	18.00' LT	804.78	*	-
26	FIFTH AVE	POT	453+33.67	18.00' LT	805.02	805.48	-
27	FIFTH AVE	POT	453+43.67	18.00' LT	805.25	805.50	-
28	FIFTH AVE	POT	453+53.67	18.00' LT	805.49	805.74	-
29	FIFTH AVE	-	453+53.67	29.27'LT	-	-	[805.85]
30	FIFTH AVE	-	453+43.67	29.27'LT	-	-	[805.61]
31	FIFTH AVE	-	453+33.67	29.27′LT	-	-	[805.63]
32	FIFTH AVE	-	453+23.99	29.27′LT	-	-	[805.74]
33	STEVENSON ST	-	20+32.94	31.98′ RT	-	-	[806.32]
34	STEVENSON ST	-	20+42.95	26. 43' RT	-	-	[806.57]
35	STEVENSON ST	-	20+47.60	31.02' RT	-	-	[807.27]

NORTHEAST QUADRANT

	SOUTHWEST QUADRANT								
POINT NUMBER	BASELINE	POINT	STATION	OFFSET	ELEVATION BOTTOM OF CURB	ELEVATION TOP OF CURB	ELEVATION BACK OF SIDEWALK		
70	STEVENSON ST	POT	17+78.41	18.04' LT	[802.97]	[803.37]	-		
71	STEVENSON ST	POT	17+89.27	17.91'LT	[803.28]	803.56*	-		
72	STEVENSON ST	PC	17+95.93	17.90'LT	[803.41]	*	-		
73	FIFTH AVE	POC	452+72.71	16.01' RT	803.69	*	-		
74	FIFTH AVE	PT	452+65.56	13.00' RT	803.68	*	-		
75	FIFTH AVE	POT	452+55.56	13.00' RT	803.46	803.62	-		
76	FIFTH AVE	POT	452+45.56	13.00' RT	803.22	803.39	-		
77	FIFTH AVE	POT	452+35.56	13.00' RT	802.97	803.14	-		
78	FIFTH AVE	-	452+35.56	29.47′ RT	-	-	[803.18]		
79	FIFTH AVE	-	452+45.56	29.47′ RT	-	-	[803.32]		
80	FIFTH AVE	-	452+55.56	29.45′ RT	-	-	[803.56]		
81	FIFTH AVE	-	452+63.22	29.42′ RT	-	-	[803.75]		
82	STEVENSON ST	-	17+78.59	30.12′ LT	-	-	[803.52]		

SOUTHEAST QUADRANT								
POINT NUMBER	BASEL INE	POINT	STATION	OFFSET	ELEVATION BOTTOM OF CURB	ELEVATION TOP OF CURB	ELEVATION BACK OF SIDEWALK	
40	STEVENSON ST	POT	17+78.41	18.05' RT	[803.49]	[803.77]	-	
41	STEVENSON ST	POT	17+90.09	18.01' RT	[804.05]	*	-	
42	STEVENSON ST	PC	17+97.05	17.98' RT	804.22	*	-	
43	FIFTH AVE	POC	453+14.43	15.87′ RT	804.60	*	-	
44	FIFTH AVE	PT	453+21.45	13.00' RT	804.96	*	-	
45	FIFTH AVE	POT	453+31.45	13.00' RT	805.20	805.78	-	
46	FIFTH AVE	POT	453+41.45	13.00' RT	805.43	806.02	-	
47	FIFTH AVE	POT	453+51.45	13.00' RT	805.67	806.33	-	
48	FIFTH AVE	-	453+51.45	29.69' RT	-	-	806.56	
49	FIFTH AVE	-	453+41.45	29.70' RT	-	-	806.11	
50	FIFTH AVE	-	453+31.45	29.51'RT	-	-	805.66	
51	FIFTH AVE	-	453+22.75	29.37′ RT	-	-	[805.25]	
52	STEVENSON ST	-	17+78.64	29.59' RT	-	-	[804.63]	

NOTE:

\* TOP OF CURB ELEVATION TO BE DETERMINED PER ITEM # 01900.001-DESIGN OF CURB RAMPS

[] MATCH EXISTING ELEVATION

**AECOM** Gulf Tower 707 Grant Street 5th Floor Pittsburgh, PA 15219

		THE PREPARATION OF THIS DOCUMENT HAS BEEN FINANCED IN
		PART THROUGH A GRANT FROM THE
		FEDERAL TRANSIT ADMINISTRATION, U.S. DEPARTMENT OF
		TRANSPORTATION, UNDER THE
		URBAN MASS TRANSPORTATION ACT OF 1964, AS AMENDED, FOR THE
DATE		PORT AUTHORITY OF ALLEGHENY COUNTY, PENNSYLVANIA.
	REVISIONS	COUNTY, FENNSTEVANIA.

(NOT FOR CONSTRUCTION)

DESIGNED	MJ <u>P/A</u> GO	
DRAWN	<u>JBM</u>	
CHECKED	BFS	
IN CHARGE	LAR	
DATE	05/01/24	
SCALE		Г
	AS SHOWN	ĺ

## PORT AUTHORITY OF ALLEGHENY COUNTY PITTSBURGH PENNSYLVANIA


BUS RAPID TRANSIT UPTOWN TO OAKLAND
INTERSECTION DATA
FIFTH AVE & STEVENSON ST

Port Authority connecting people to life

CONTRACT NO. BRT-001

DWG. NO. ID10

sнт. 186

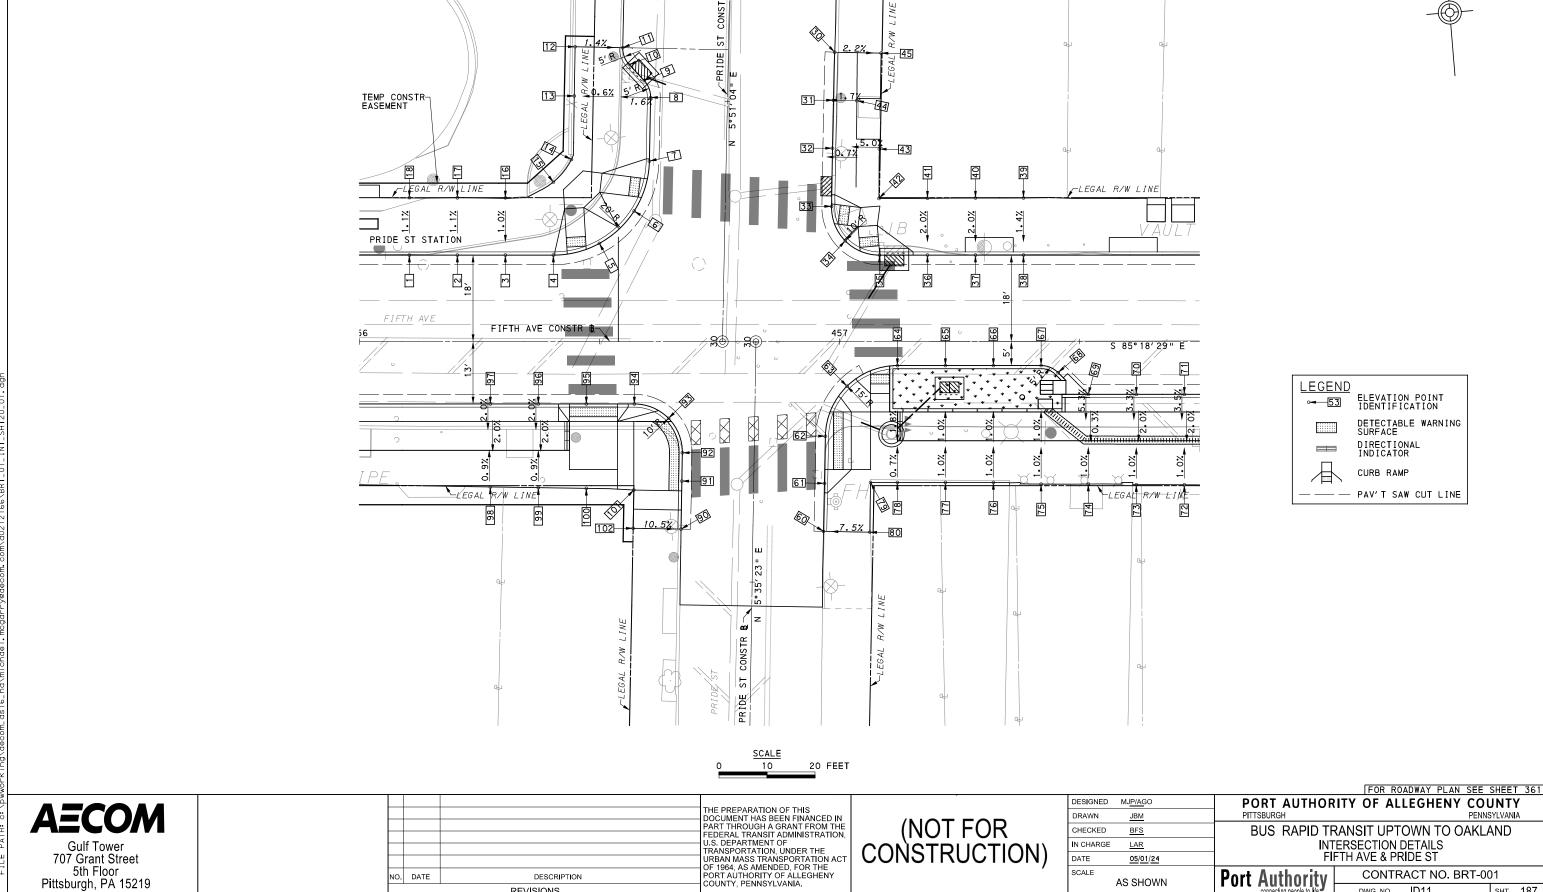

SCALE

AS SHOWN

Port Authority connecting people to life

CONTRACT NO. BRT-001

sнт. 187

ID11

DWG. NO.

5th Floor Pittsburgh, PA 15219

NO. DATE

DESCRIPTION

REVISIONS

POINT NUMBER	BASELINE		1				
	DASELINE	POINT	STATION	OFFSET	ELEVATION BOTTOM OF CURB	ELEVATION TOP OF CURB	ELEVATION BACK OF SIDEWALK
1	FIFTH AVE	POT	456+10.39	18.00' LT	812.13	812.71	-
2	FIFTH AVE	POT	456+20.39	18.00' LT	812.40	812.98	-
3	FIFTH AVE	POT	456+30.39	18.00' LT	812.67	813.25	-
4	FIFTH AVE	PC	456+40.39	18.00' LT	812.98	813.44*	-
5	FIFTH AVE	POC	456+49.98	20.45′ LT	[813.14]	*	-
6	PRIDE ST	POC	30+26.82	18.96' LT	[813.88]	*	-
7	PRIDE ST	PT	30+37.28	16.00' LT	[815.02]	*	-
8	PRIDE ST	PC	30+50.53	16.00' LT	[816.50]	816.71	-
9	PRIDE ST	PT	30+54.03	17.42' LT	816.86	817.06	-
10	PRIDE ST	PC	30+57.28	20.60' LT	817.14	817.34	-
11	PRIDE ST	PT	30+60.79	22.02' LT	[817.53]	[818.02]	-
12	PRIDE ST	-	30+60.79	31.96′ LT	-	-	[817.79]
13	PRIDE ST	-	30+50.53	31.91′LT	-	-	[816.55]
14	PRIDE ST	-	30+37.28	32.23′ LT	-	-	[815.13]
15	FIFTH AVE	-	456+40.39	33.22′ LT	-	-	[814.16]
16	FIFTH AVE	-	456+30.39	29.93'LT	-	-	[813.36]
17	FIFTH AVE	-	456+20.39	29.95′LT	-	-	[813.10]
18	FIFTH AVE	-	456+10.39	29.97'LT	-	-	[812.83]

			SOUT	HWEST QUA	DRANT		
POINT NUMBER	BASELINE	POINT	STATION	OFFSET	ELEVATION BOTTOM OF CURB	ELEVATION TOP OF CURB	ELEVATION BACK OF SIDEWALK
90	PRIDE ST	POT	29+60.80	14.99'LT	[812.83]	[813.46]	-
91	PRIDE ST	POT	29+70.80	14.98'LT	[813.21]	*	-
92	PRIDE ST	PC	29+76.70	14.97'LT	[813.47]	*	-
93	FIFTH AVE	POC	456+64.39	15.99' RT	[813.72]	*	-
94	FIFTH AVE	PT	456+57.26	13.00' RT	813.60	*	-
95	FIFTH AVE	POT	456+47.26	13.00' RT	813.35	*	-
96	FIFTH AVE	POT	456+37.26	13.00' RT	813.08	813.25	-
97	FIFTH AVE	POT	456+27.26	13.00' RT	812.81	812.98	-
98	FIFTH AVE	-	456+27.26	30.′30 RT	-	-	[813.02]
99	FIFTH AVE	-	456+37.26	29.06' RT	-	-	[813.38]
100	FIFTH AVE	-	456+47.26	29.07' RT	-	-	[813.68]
101	FIFTH AVE	-	456+57.73	29.07' RT	-	-	[813.94]
102	PRIDE ST	-	29+60.81	24.41' LT	-	-	[813.64]

NORTHEAST QUADRANT								
POINT NUMBER	BASEL INE	POINT	STATION	OFFSET	ELEVATION BOTTOM OF CURB	ELEVATION TOP OF CURB	ELEVATION BACK OF SIDEWALK	
30	PRIDE ST	POT	30+60.74	22. 15′ RT	[818.05]	[818.35]	-	
31	PRIDE ST	POT	30+50.74	22.09' RT	[816.99]	817.32	-	
32	PRIDE ST	POT	30+40.74	22.09' RT	[816.06]	816.39	-	
33	PRIDE ST	PC	30+28.62	22.13′ RT	[815.11]	*	-	
34	FIFTH AVE	POC	457+01.20	20.99'LT	[814.55]	*	-	
35	FIFTH AVE	PT	457+08.33	18.00' LT	814.77	815.28	-	
36	FIFTH AVE	POT	457+18.33	18.00' LT	815.03	815.62	-	
37	FIFTH AVE	POT	457+28.33	18.00' LT	815.30	815.89	-	
38	FIFTH AVE	POT	457+38.33	18.00' LT	815.57	816.12	-	
39	FIFTH AVE	-	457+38.33	29.91'LT	-	-	[816.28]	
40	FIFTH AVE	-	457+28.33	29.91′LT	-	-	816.11	
41	FIFTH AVE	-	457+18.33	29.87′LT	-	-	815.84	
42	FIFTH AVE	-	457+08.22	29.82′LT	-	-	815.92	
43	PRIDE ST	-	30+40.74	31.85′ RT	-	-	[816.66]	
44	PRIDE ST	-	30+50.74	26.96′ RT	-	-	[817.39]	
45	PRIDE ST	-	30+60.74	31.82′ RT	-	-	[818.55]	

			SOUTI	HEAST QUA	DRANT		
POINT NUMBER	BASEL INE	POINT	STATION	OFFSET	ELEVATION BOTTOM OF CURB	ELEVATION TOP OF CURB	ELEVATION BACK OF SIDEWALK
60	PRIDE ST	POT	29+60.80	14.71′ RT	[813.50]	[813.84]	-
61	PRIDE ST	POT	29+70.80	14.74′ RT	[813.77]	*	-
62	PRIDE ST	PC	29+80.63	14.78′ RT	[814.09]	*	-
63	FIFTH AVE	POC	457+01.56	9.29′ RT	[814.65]	815.15*	-
64	FIFTH AVE	PT	457+12.06	5.00′ RT	815.23	815.73*	-
65	FIFTH AVE	POT	457+22.06	5.00' RT	815.50	816.08	-
66	FIFTH AVE	POT	457+32.06	5.00′ RT	815.76	816.35	-
67	FIFTH AVE	PC	457+42.00	5.00' RT	816.03	816.61	-
68	FIFTH AVE	PT	457+45.54	6.47′ RT	816.08	816.66	-
69	FIFTH AVE	POT	457+51.84	11.00′ RT	816.21	816.45	-
70	FIFTH AVE	POT	457+61.84	11.00' RT	816.39	816.73	-
71	FIFTH AVE	POT	457+71.84	11.00' RT	816.67	817.01	-
72	FIFTH AVE	-	457+71.84	29.85′ RT	-	-	[816.87]
73	FIFTH AVE	-	457+61.84	29.81′RT	-	-	[816.60]
74	FIFTH AVE	-	457+51.84	29.69' RT	-	-	[816.36]
75	FIFTH AVE	-	457+42.00	29.70′ RT	-	-	[816.21]
76	FIFTH AVE	-	457+32.06	29.36′ RT	-	-	[816.11]
77	FIFTH AVE	-	457+22.06	29.36′ RT	-	-	[816.01]
78	FIFTH AVE	-	457+12.06	29.36′ RT	-	-	[815.80]
79	FIFTH AVE	-	457+06.47	29.36′ RT	-	-	[815.57]
80	PRIDE ST	-	29+60.76	24.33' RT	-	-	[814.37]

[] MATCH EXISTING ELEVATION

<b>AECOM</b>
Gulf Tower 707 Grant Street 5th Floor Pittsburgh, PA 15219

		THE PREPARATION OF THIS DOCUMENT HAS BEEN FINANCED IN
		PART THROUGH A GRANT FROM TH
		FEDERAL TRANSIT ADMINISTRATION U.S. DEPARTMENT OF
		TRANSPORTATION, UNDER THE
		URBAN MASS TRANSPORTATION AC OF 1964. AS AMENDED. FOR THE
DATE	DESCRIPTION	PORT AUTHORITY OF ALLEGHENY COUNTY, PENNSYLVANIA.
	REVISIONS	COUNTY, PENNSTEVANIA.


(NOT FOR CONSTRUCTION)

DESIGNED	MJ <u>P/A</u> GO	
DRAWN	<u>JBM</u>	
CHECKED	BFS	
IN CHARGE	LAR	
DATE	05/01/24	
SCALE		
	AS SHOWN	

### PORT AUTHORITY OF ALLEGHENY COUNTY PENNSYLVANIA BUS RAPID TRANSIT UPTOWN TO OAKLAND INTERSECTION DATA FIFTH AVE & PRIDE ST

Port Authority connecting people to life DWG. NO. D12

CONTRACT NO. BRT-001 sнт. 188

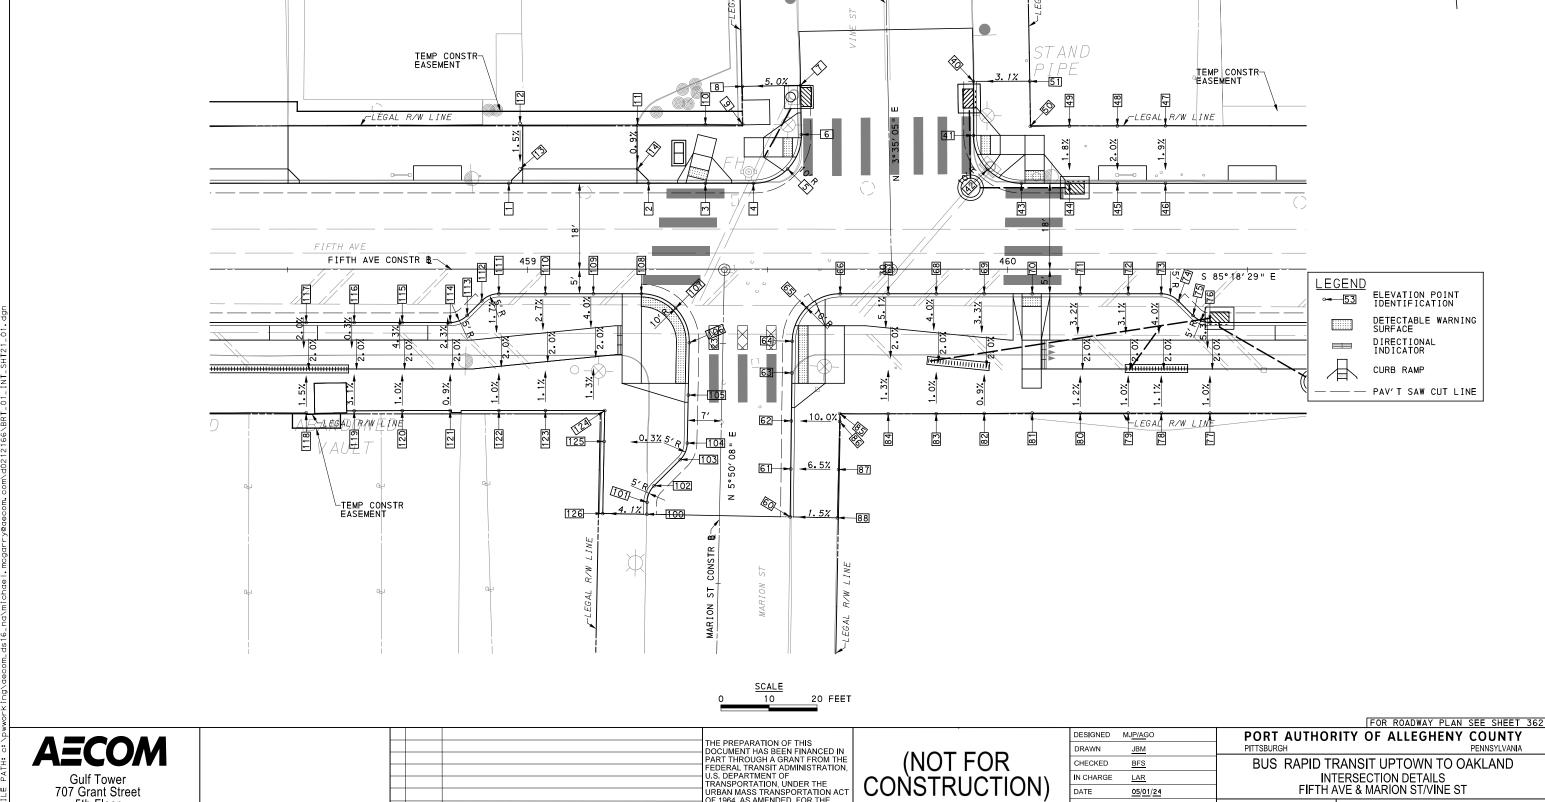

PEDERAL TRANSIT ADMINISTRATION,
U.S. DEPARTMENT OF
TRANSPORTATION, UNDER THE
URBAN MASS TRANSPORTATION ACT
OF 1964, AS AMENDED, FOR THE
PORT AUTHORITY OF ALLEGHENY
COUNTY, PENNSYLVANIA.

UPTOWN

INTERSECTION DETAILS FIFTH AVE & MARION ST/VINE ST

DWG. NO. ID13

CONTRACT NO. BRT-001

sнт. 189

Port Authority connecting people to life

N CHARGE

DATE

SCALE

LAR

05/01/24

AS SHOWN

707 Grant Street

5th Floor

Pittsburgh, PA 15219

NO. DATE

DESCRIPTION

REVISIONS

			NORT	THWEST QU	ADRANT		
POINT NUMBER	BASEL INE	POINT	STATION	OFFSET	ELEVATION BOTTOM OF CURB	ELEVATION TOP OF CURB	ELEVATION BACK OF SIDEWALK
1	FIFTH AVE	POT	458+96.08	18.00' LT	819.74	820.24	-
2	FIFTH AVE	POT	459+25.21	18.00' LT	820.53	821.03	-
3	FIFTH AVE	POT	459+37.02	18.00' LT	820.90	*	-
4	FIFTH AVE	PC	459+47.02	18.00′ LT	821.27	821.77	-
5	FIFTH AVE	POC	459+54.15	20.99′ LT	821.82	*	-
6	VINE ST	PT	30+28.52	18.23′ LT	[822.36]	*	-
7	VINE ST	POT	30+38.79	18.20' LT	[823.39]	[823.85]	-
8	VINE ST	-	30+38.79	30.32′ LT	-	-	[823.28]
9	FIFTH AVE	-	459+44.77	30.32′ LT	-	-	[821.80]
10	FIFTH AVE	=	459+37.02	30.24′ LT	-	-	[821.52]
11	FIFTH AVE	-	459+22.87	30.13′ LT	-	-	[821.09]
12	FIFTH AVE	-	458+98.42	30.52′ LT	-	-	[820.48]
13	FIFTH AVE	-	458+98.42	21.00′ LT	-	-	820.34
14	FIFTH AVE	-	459+22.87	21.00' LT	-	-	821.01

			SOUT	THWEST QU	ADRANT		
POINT NUMBER	BASEL INE	POINT	STATION	OFFSET	ELEVATION BOTTOM OF CURB	ELEVATION TOP OF CURB	ELEVATION BACK OF SIDEWALI
100	MARION ST	POT	22+64.16	15.13′ LT	[819.14]	[819.41]	-
101	MARION ST	PC	22+66.65	15.14′ LT	819.25	819.51	-
102	MARION ST	PT	22+70.12	13.74′ LT	819.41	819.70	-
103	MARION ST	PC	22+75.69	8.39′ LT	819.80	820.12	-
104	MARION ST	PT	22+79.15	7.00' LT	819.96	820.30	-
105	MARION ST	POT	22+89.15	7.00' LT	820.34	*	-
106	MARION ST	PC	23+00.07	7.00' LT	820.68	*	-
107	FIFTH AVE	POC	459+30.82	8.00' RT	820.85	*	-
108	FIFTH AVE	PT	459+23.68	5.00' RT	820.85	*	-
109	FIFTH AVE	POT	459+13.68	5.00' RT	820.57	820.90	-
110	FIFTH AVE	POT	459+03.68	5.00' RT	820.30	820.63	-
111	FIFTH AVE	PC	458+94.00	5.00' RT	820.04	820.37	-
112	FIFTH AVE	PT	458+90.46	6.46′ RT	819.90	820.25	-
113	FIFTH AVE	PC	458+87.39	9.54′ RT	819.73	820.08	-
114	FIFTH AVE	PT	458+83.86	11.00' RT	819.60	819.92	-
115	FIFTH AVE	POT	458+73.86	11.00' RT	819.32	819.65	-
116	FIFTH AVE	POT	458+63.86	11.00' RT	819.05	819.39	-
117	FIFTH AVE	POT	458+53.86	11.00' RT	818.78	819.12	-
118	FIFTH AVE	-	458+53.86	29.83′ RT	-	-	[819.08]
119	FIFTH AVE	-	458+63.86	29.39' RT	-	-	[819.53]
120	FIFTH AVE	-	458+73.86	29.35′ RT	-	-	[819.75]
121	FIFTH AVE	-	458+83.86	29.33′ RT	-	-	[819.95]
122	FIFTH AVE	-	458+94.00	29.33′ RT	-	-	820.20
123	FIFTH AVE	-	459+03.68	29.33′ RT	-	-	820.42
124	FIFTH AVE	-	459+16.06	29.33' RT	-	-	820.68
125	MARION ST	-	22+79.15	24.33′ LT	-	-	820.33
126	MARION ST	-	22+64.13	24.33′ LT	-	-	[819.51]

			NORT	HEAST QU	ADRANT		
POINT NUMBER	BASEL INE	POINT	STATION	OFFSET	ELEVATION BOTTOM OF CURB	ELEVATION TOP OF CURB	ELEVATION BACK OF SIDEWALK
40	VINE ST	POT	30+38.92	17.80' RT	[824.16]	[824.51]	-
41	VINE ST	PC	30+27.65	17.60' RT	[823.02]	*	-
42	FIFTH AVE	POC	459+95.80	20.92′ LT	822.72	*	-
43	FIFTH AVE	PT	460+02.87	18.00' LT	822.56	*	-
44	FIFTH AVE	POT	460+12.87	18.00' LT	822.71	823.30*	-
45	FIFTH AVE	POT	460+22.87	18.00' LT	822.90	823.48	-
46	FIFTH AVE	POT	460+32.87	18.00' LT	823.11	823.69	-
47	FIFTH AVE	-	460+32.87	30.00′ LT	-	-	823.91
48	FIFTH AVE	-	460+22.87	29.97′LT	-	-	823.71
49	FIFTH AVE	-	460+12.87	29.96′LT	-	-	823.50
50	FIFTH AVE	-	460+04.71	29.88′LT	-	-	823.35
51	VINE ST	-	30+38.71	29.56′ RT	-	-	[824.86]

			SOUT	HEAST QL	IADRANT		
POINT NUMBER	BASELINE	POINT	STATION	OFFSET	ELEVATION BOTTOM OF CURB	ELEVATION TOP OF CURB	ELEVATION BACK OF SIDEWALK
60	MARION ST	POT	22+64.21	14.73′ RT	[819.65]	[820.02]	-
61	MARION ST	POT	22+74.21	14.64′ RT	[820.03]	820.39	-
62	MARION ST	POT	22+84.20	14.56′ RT	[820.50]	820.84	-
63	MARION ST	POT	22+94.20	14.48′ RT	[820.99]	*	-
64	MARION ST	PC	23+00.81	14.42′ RT	821.25	*	-
65	FIFTH AVE	POC	459+58.08	7.89′ RT	821.55	*	-
66	FIFTH AVE	PŤ	459+65.11	5.00' RT	821.85	822.18	-
67	FIFTH AVE	POT	459+75.11	5.00' RT	822.09	822.42	-
68	FIFTH AVE	POT	459+85.11	5.00' RT	822.36	822.69	-
69	FIFTH AVE	POT	459+95.11	5.00' RT	822.62	822.96	-
70	FIFTH AVE	POT	460+05.11	5.00' RT	822.87	*	-
71	FIFTH AVE	POT	460+15.11	5.00' RT	823.10	823.43	-
72	FIFTH AVE	POT	460+25.11	5.00' RT	823.31	823.64	-
73	FIFTH AVE	PC	460+32.00	5.00' RT	823.45	823.78	-
74	FIFTH AVE	PT	460+35.54	6.46′ RT	823.48	823.80	-
75	FIFTH AVE	PC	460+38.61	9.54′ RT	823.55	823.88	-
76	FIFTH AVE	PT	460+42.14	11.00' RT	823.49	823.81	-
77	FIFTH AVE	-	460+42.14	29.85' RT	-	-	[823.62]
78	FIFTH AVE	-	460+32.00	29.85′ RT	-	-	[ 823. 40]
79	FIFTH AVE	-	460+25.11	29.85′ RT	-	-	[823.33]
80	FIFTH AVE	-	460+15.11	29.85′ RT	-	-	[ 823. 13]
81	FIFTH AVE	-	460+05.11	29.85′ RT	-	-	[822.85]
82	FIFTH AVE	-	459+95.11	29.94′ RT	-	-	[822.65]
83	FIFTH AVE	-	459+85.11	30.00' RT	-	-	[822.38]
84	FIFTH AVE	-	459+75.11	30.01′RT	-	-	[822.13]
85	FIFTH AVE	-	459+65.04	29.95′ RT	-	-	[821.86]
86	MARION ST	-	22+84.29	24.64′ RT	-	-	[821.75]
87	MARION ST	-	22+74.29	24.61′RT	-	-	[820.93]
88	MARION ST	-	22+64.21	24.58' RT	-	-	[820.34]

[] MATCH EXISTING ELEVATION

			COUNTY, PENNSYLVANIA.
NO.	DATE	DESCRIPTION	PORT AUTHORITY OF ALLEGHENY
			URBAN MASS TRANSPORTATION ACT OF 1964, AS AMENDED, FOR THE
			TRANSPORTATION, UNDER THE
			U.S. DEPARTMENT OF
			FEDERAL TRANSIT ADMINISTRATION.
			PART THROUGH A GRANT FROM THE
			DOCUMENT HAS BEEN FINANCED IN
			THE PREPARATION OF THIS

REVISIONS

(NOT FOR CONSTRUCTION)

DESIGNED	MJ <u>P/A</u> GO	
DRAWN	<u>JBM</u>	
CHECKED	<u>BFS</u>	
IN CHARGE	LAR	
DATE	05/01/24	
SCALE		
	AS SHOWN	

### PORT AUTHORITY OF ALLEGHENY COUNTY PITTSBURGH PENNSYLVANIA


BUS RAPID TRANSIT UPTOWN TO OAKLAND
INTERSECTION DATA
FIFTH AVE & MARION ST/VINE ST

Port Authority
connecting people to life

CONTRACT NO. BRT-001 DWG. NO. ID14 sнт. 190

Gulf Tower 707 Grant Street 5th Floor Pittsburgh, PA 15219

**AECOM** 

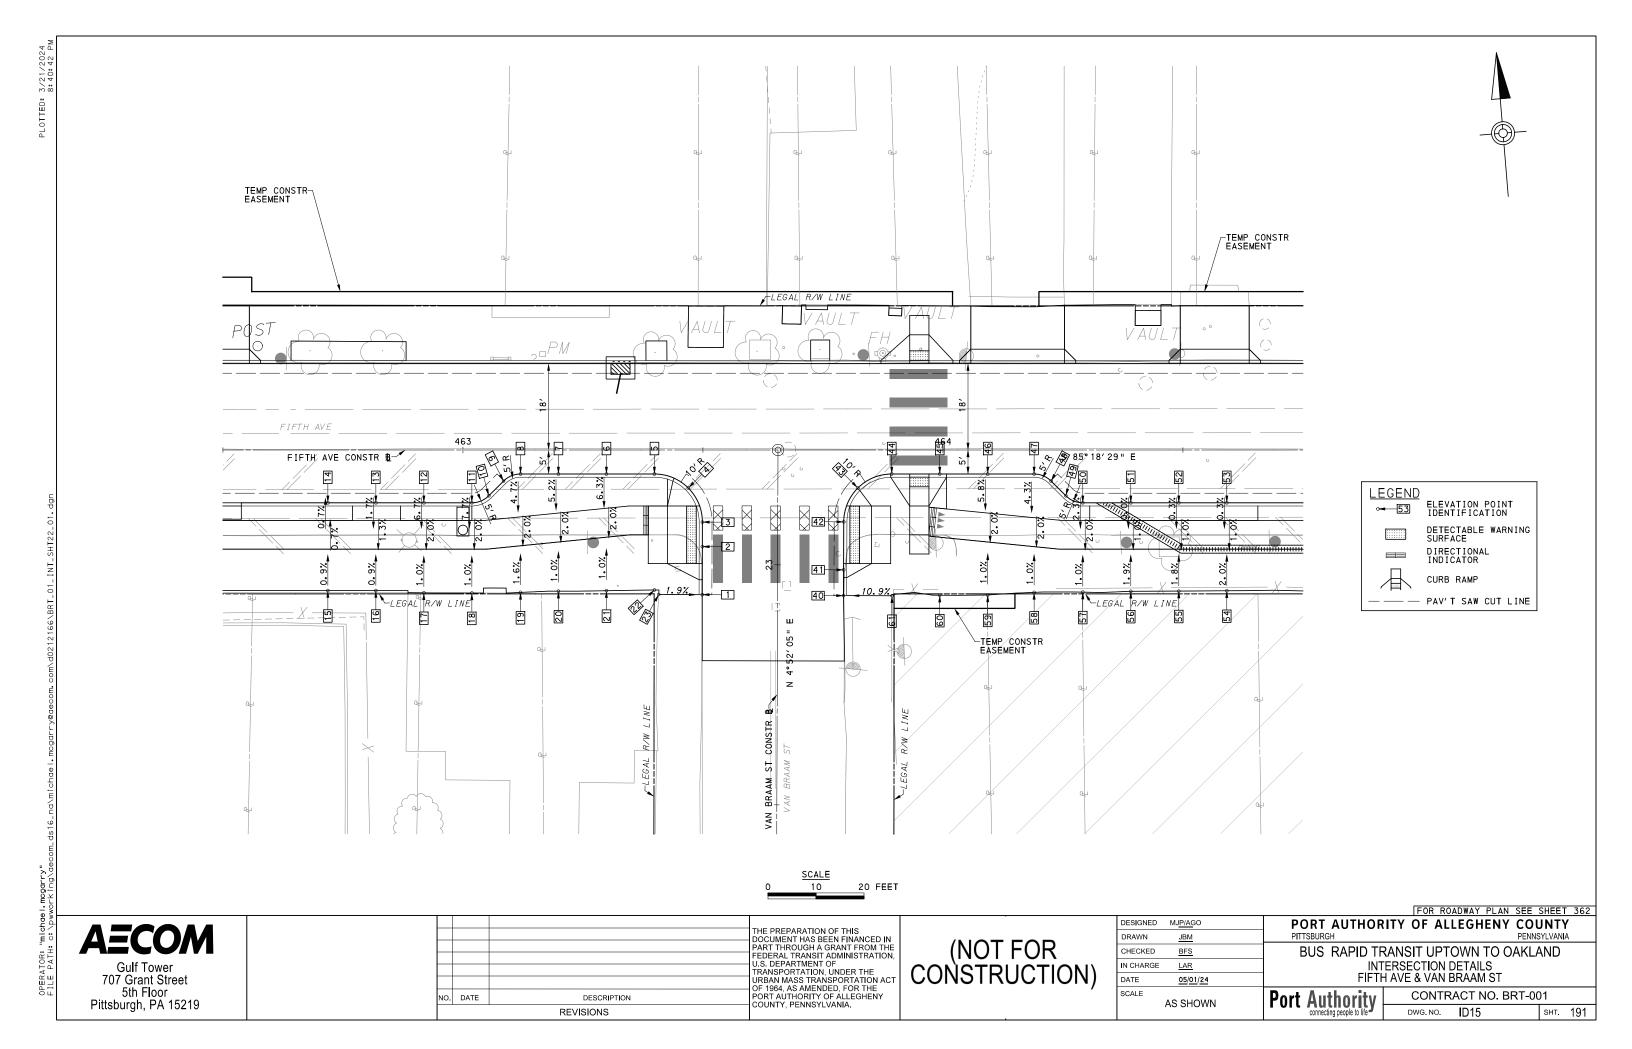

POINT NUMBER	BASEL I NE	POINT	STATION	OFFSET	ELEVATION BOTTOM OF CURB	ELEVATION TOP OF CURB	ELEVATION BACK OF SIDEWAL
1	VAN BRAAM ST	POT	22+93.74	15.67'LT	[829.32]	[829.76]	-
2	VAN BRAAM ST	POT	23+03.74	15.68'LT	[829.77]	*	-
3	VAN BRAAM ST	PC	23+08.87	15.69'LT	[830.04]	*	-
4	FIFTH AVE	POC	463+46.97	7.93′ RT	[830.30]	*	-
5	FIFTH AVE	PT	463+39.90	5.00' RT	[830.33]	830.66	-
6	FIFTH AVE	POT	463+29.90	5.00' RT	830.13	830.47	-
7	FIFTH AVE	POT	463+19.90	5.00' RT	829.93	830.27	-
8	FIFTH AVE	PC	463+12.00	5.00' RT	829.78	830.11	-
9	FIFTH AVE	PT	463+08.46	6.46′ RT	829.67	830.01	-
10	FIFTH AVE	PC	463+05.39	9.54′ RT	829.51	829.85	-
11	FIFTH AVE	PT	463+01.86	11.00' RT	829.41	829.73	-
12	FIFTH AVE	POT	462+91.86	11.00' RT	829.17	829.50	-
13	FIFTH AVE	POT	462+81.86	11.00' RT	828.93	829.27	-
14	FIFTH AVE	POT	462+71.86	11.00' RT	828.70	829.03	-
15	FIFTH AVE	-	462+71.86	29.28' RT	-	=	829.17
16	FIFTH AVE	-	462+81.86	29.28' RT	-	=	829.22
17	FIFTH AVE	-	462+91.86	29.76′ RT	-	-	829.27
18	FIFTH AVE	-	463+01.86	29.79' RT	-	=	[829.47]
19	FIFTH AVE	-	463+12.00	29.68' RT	-	=	[829.76]
20	FIFTH AVE	-	463+19.90	29. 42' RT	-	-	[829.86]
21	FIFTH AVE	-	463+29.90	29.32' RT	-	-	[830.05]
22	FIFTH AVE	-	463+39.90	29.17' RT	-	-	[830.03]
23	VAN BRAAM ST	-	22+93.74	24.74' RT	_	-	[829.92]

			SOUTH	HEAST QUA	DRANT		
POINT NUMBER	BASEL INE	POINT	STATION	OFFSET	ELEVATION BOTTOM OF CURB	ELEVATION TOP OF CURB	ELEVATION BACK OF SIDEWALK
40	VAN BRAM ST	POT	22+93.63	13.76′ RT	[829.61]	[829.82]	-
41	VAN BRAM ST	POT	22+99.00	13.76′ RT	[829.84]	*	-
42	VAN BRAM ST	PC	23+09.00	13.76′ RT	[830.59]	*	-
43	FIFTH AVE	POC	463+82.28	7.92′ RT	831.07	831.40*	-
44	FIFTH AVE	PŤ	463+89.34	5.00' RT	831.47	*	-
45	FIFTH AVE	POT	463+99.34	5.00' RT	831.71	*	-
46	FIFTH AVE	POT	464+09.34	5.00' RT	831.97	832.31	-
47	FIFTH AVE	PC	464+19.00	5.00' RT	832.22	832.56	-
48	FIFTH AVE	PT	464+22.54	6.46′ RT	832.27	832.60	-
49	FIFTH AVE	PC	464+25.61	9.54′ RT	832.36	832.58	-
50	FIFTH AVE	PT	464+29.14	11.00' RT	832.32	832.64	-
51	FIFTH AVE	POT	464+39.14	11.00' RT	832.57	832.90	-
52	FIFTH AVE	POT	464+49.14	11.00' RT	832.83	833.16	-
53	FIFTH AVE	POT	464+59.14	11.00' RT	833.06	833.39	-
54	FIFTH AVE	-	464+59.14	29.32' RT	-	-	[833.49]
55	FIFTH AVE	-	464+49.14	29. 40' RT	-	-	[833.25]
56	FIFTH AVE	-	464+39.14	29. 43' RT	-	-	[833.01]
57	FIFTH AVE	-	464+29.14	29.61' RT	-	-	[832.54]
58	FIFTH AVE	-	464+19.00	29.66' RT	-	-	[832.18]
59	FIFTH AVE	-	464+09.34	30.21'RT	-	-	[831.87]
60	FIFTH AVE	-	463+99.34	30.26' RT	-	-	[831.50]
61	FIFTH AVE	-	463+89.39	30.37' RT	-	-	[830.85]


sнт. 192

[] MATCH EXISTING ELEVATION

<b>AECOM</b>
Gulf Tower
707 Grant Street
5th Floor
Pittsburgh, PA 15219

		THE PREPARATION OF THIS  OCUMENT HAS BEEN FINANCED IN
		PART THROUGH A GRANT FROM TH
		FEDERAL TRANSIT ADMINISTRATION
		U.S. DEPARTMENT OF TRANSPORTATION, UNDER THE
		URBAN MASS TRANSPORTATION AC
DATE	DESCRIPTION	OF 1964, AS AMENDED, FOR THE PORT AUTHORITY OF ALLEGHENY COUNTY, PENNSYLVANIA.
	REVISIONS	COUNTY, PENNSTEVANIA.

DESIGNED MJ <u>P</u>	<u>/A</u> GO	PORT AUTI	HORITY	OF AL	LEGHENY	cour	NTY	1
DRAWN <u>JI</u>	<u>3M</u>	PITTSBURGH				PENNSYL	VANIA	٩
CHECKED B	FS	BUS RAPI	D TRAN	SIT UPT	OWN TO O	AKLAN	۷D	
N CHARGE L	<u>AR</u>			SECTION				
DATE <u>0</u>	5/01/24	F	FIFTH AV	E & VAN E	BRAAM ST			
SCALE AS G	SHOWN	Port Authori	itv	CONTR	ACT NO. BF	RT-001		
70 0	DIOWN	connecting people to	life	DWG. NO.	ID16	s	нт.	19

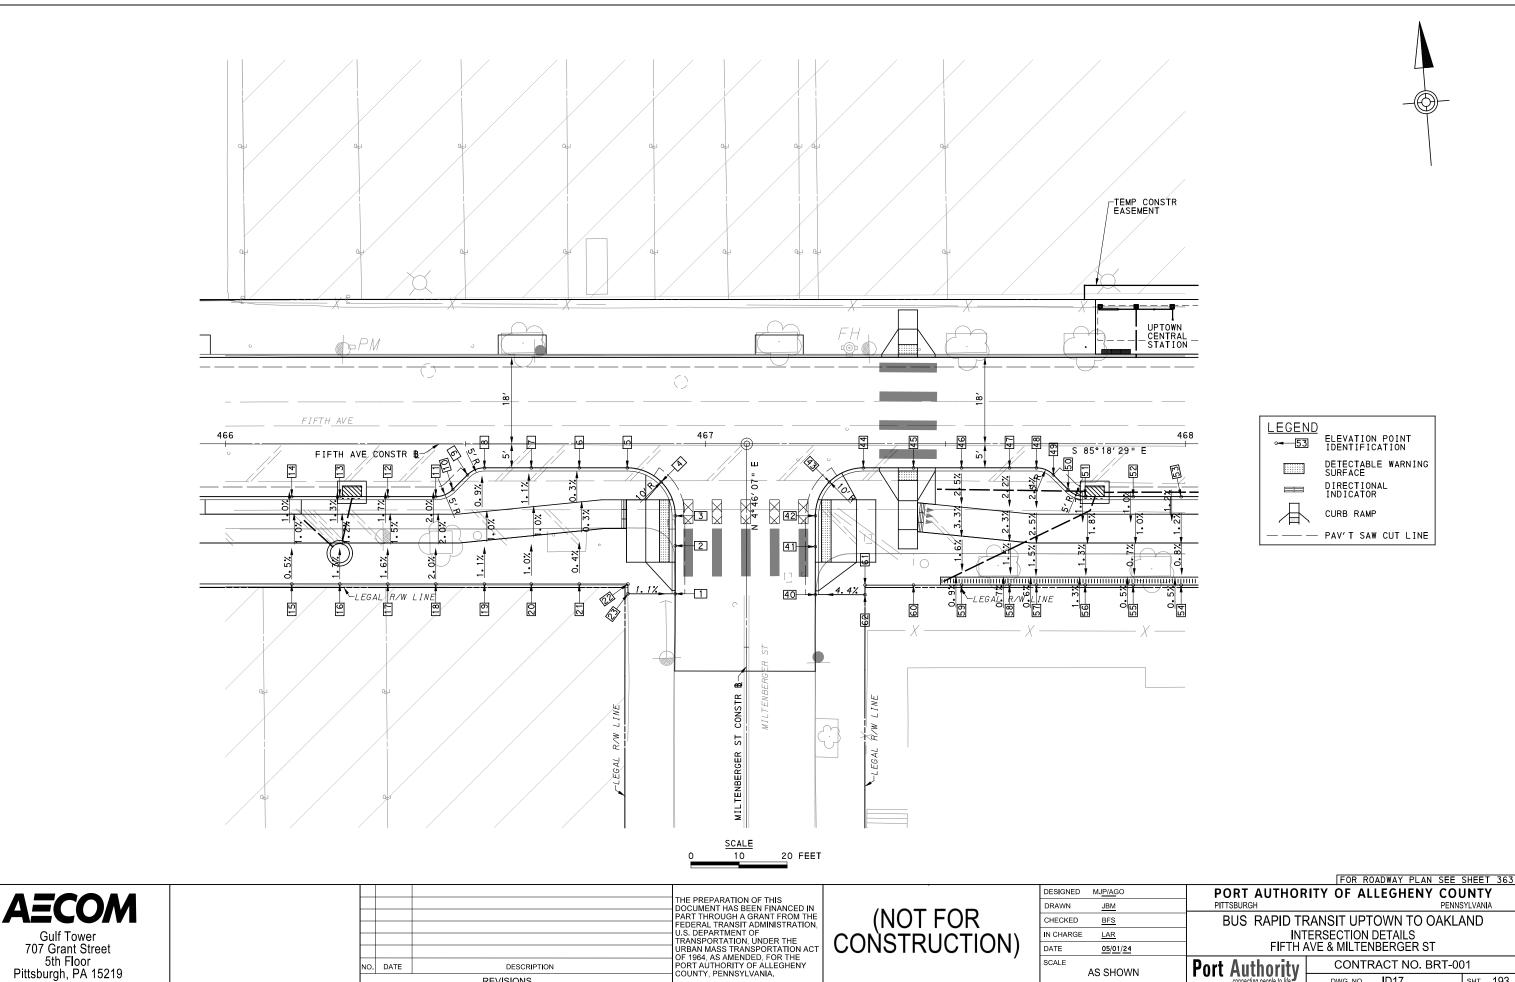

SCALE

AS SHOWN

Port Authority connecting people to life

CONTRACT NO. BRT-001

sнт. 193

ID17

DWG. NO.

707 Grant Street

5th Floor Pittsburgh, PA 15219

NO. DATE

DESCRIPTION

REVISIONS

	SOUTHWEST QUADRANT										
POINT NUMBER	BASEL INE	POINT	STATION	OFFSET	ELEVATION BOTTOM OF CURB	ELEVATION TOP OF CURB	ELEVATION BACK OF SIDEWALK				
1	MILTENBERGER ST	POT	15+61.09	14.87′LT	[838.00]	[838.41*]	-				
2	MILTENBERGER ST	POT	15+71.09	14.88' LT	[838.35]	*	-				
3	MILTENBERGER ST	PC	15+77.33	14.88' LT	[838.56]	*	-				
4	FIFTH AVE	POC	466+90.83	7.93′ RT	[838.58]	838.91*	-				
5	FIFTH AVE	PT	466+83.76	5.00' RT	838.51	838.84	-				
6	FIFTH AVE	POT	466+73.76	5.00' RT	838.27	838.60	-				
7	FIFTH AVE	POT	466+63.76	5.00' RT	838.03	838.36	-				
8	FIFTH AVE	PC	466+54.00	5.00' RT	837.80	838.13	-				
9	FIFTH AVE	PT	466+50.46	6.46′ RT	837.67	838.02	-				
10	FIFTH AVE	PC	466+47.39	9.54′ RT	837.50	837.86	-				
11	FIFTH AVE	PT	466+43.86	11.00' RT	837.39	837.71	-				
12	FIFTH AVE	POT	466+33.86	11.00' RT	837.14	837.47	-				
13	FIFTH AVE	POT	466+23.86	11.00' RT	836.90	837.23	-				
14	FIFTH AVE	POT	466+13.86	11.00' RT	836.66	837.00	-				
15	FIFTH AVE	-	466+13.86	29.20' RT	-	-	837.17				
16	FIFTH AVE	-	466+23.86	29.20' RT	-	-	837.45				
17	FIFTH AVE	-	466+33.86	29.20' RT	-	-	837.75				
18	FIFTH AVE	-	466+43.86	29. 20' RT	-	-	838.06				
19	FIFTH AVE	-	466+54.00	29.20' RT	-	-	838.37				
20	FIFTH AVE	-	466+63.76	29.20' RT	-	-	838.60				
21	FIFTH AVE	-	466+73.76	29.20' RT	-	-	838.68				
22	FIFTH AVE	-	466+83.89	29.20' RT	-	-	[838.58]				
23	MILTENBERGER ST	-	15+61.09	24.71′LT	-	-	[838.51]				

			SOUTH	HEAST QUA	DRANT		
POINT NUMBER	BASEL INE	POINT	STATION	OFFSET	ELEVATION BOTTOM OF CURB	ELEVATION TOP OF CURB	ELEVATION BACK OF SIDEWAL
40	MILTENBERGER ST	POT	15+60.96	14.30' RT	[838.39]	[838.56*]	-
41	MILTENBERGER ST	POT	15+70.96	14.30' RT	[838.80]	*	-
42	MILTENBERGER ST	PC	15+77.39	14.30' RT	[839.15]	*	-
43	FIFTH AVE	POC	467+25.87	7.92′ RT	[839.41]	*	-
44	FIFTH AVE	PŤ	467+32.94	5.00′ RT	839.60	839.77	-
45	FIFTH AVE	POT	467+43.39	5.00′ RT	839.83	*	-
46	FIFTH AVE	POT	467+53.39	5.00′ RT	840.06	840.22	-
47	FIFTH AVE	POT	467+63.39	5.00′ RT	840.32	840.48	-
48	FIFTH AVE	PC	467+69.00	5.00′ RT	840.47	840.63	-
49	FIFTH AVE	PT	467+72.54	6.46′ RT	840.50	840.66	-
50	FIFTH AVE	PC	467+75.61	9.54′ RT	840.53	840.69	-
51	FIFTH AVE	PT	467+79.14	11.00' RT	840.56	840.72	-
52	FIFTH AVE	POT	467+89.14	11.00′ RT	840.82	840.98	-
53	FIFTH AVE	POT	467+99.14	11.00' RT	841.08	841.25	-
54	FIFTH AVE	-	467+99.14	29. 43' RT	-	-	841.07
55	FIFTH AVE	-	467+89.14	29. 43' RT	-	-	840.83
56	FIFTH AVE	-	467+79.14	29. 43' RT	-	-	840.45
57	FIFTH AVE	-	467+69.00	29. 43' RT	-	-	840.16
58	FIFTH AVE	-	467+63.39	29. 43′ RT	-	-	840.02
59	FIFTH AVE	-	467+53.39	29. 43' RT	-	-	839.67
60	FIFTH AVE	-	467+43.39	29. 43' RT	-	-	839.34
61	FIFTH AVE	-	467+33.28	29. 43′ RT	-	-	838.98
62	MILTENBERGER ST	-	15+60.96	24.66′ RT	-	-	[838.99]

[] MATCH EXISTING ELEVATION

<b>AECOM</b>				THE PREPARATION OF THIS DOCUMENT HAS BEEN FINANCED IN PART THROUGH A GRANT FROM THE FEDERAL TRANSIT ADMINISTRATION.	
Gulf Tower 707 Grant Street				U.S. DEPARTMENT OF TRANSPORTATION, UNDER THE URBAN MASS TRANSPORTATION ACT OF 1964. AS AMENDED, FOR THE	
5th Floor Pittsburgh, PA 15219	NO.	DATE	DESCRIPTION	PORT AUTHORITY OF ALLEGHENY COUNTY, PENNSYLVANIA.	

ESIGNED	MJ <u>P/A</u> GO	PORT AUTHOR	ITY OF ALLEGHENY	COUNTY
RAWN	<u>JBM</u>	PITTSBURGH		PENNSYLVANIA
HECKED	BFS	BUS RAPID TF	RANSIT UPTOWN TO C	DAKLAND
I CHARGE	LAR	IN	ITERSECTION DATA	
ATE	05/01/24	FIFTH <i>F</i>	AVE & MILTENBERGER S	Τ
CALE	AS SHOWN	Port Authority	CONTRACT NO. B	BRT-001
	AS SHOWN	I dit /tatilolity	DWO NO ID10	QUE 40

DESCRIPTION

REVISIONS

TEMP CONSTR

NO. DATE

-LEGAL R/W LINE

8

7

3.0%



PEDERAL TRANSIT ADMINISTRATION,
U.S. DEPARTMENT OF
TRANSPORTATION, UNDER THE
URBAN MASS TRANSPORTATION ACT
OF 1964, AS AMENDED, FOR THE
PORT AUTHORITY OF ALLEGHENY
COUNTY, PENNSYLVANIA.

(NOT FOR CONSTRUCTION)

[74EGAL R/W LĮNĖ]

DESIGNED	MJ <u>P/A</u> GO	
DRAWN	JBM	
CHECKED	BFS	
N CHARGE	LAR	
DATE	05/01/24	
SCALE		
	AS SHOWN	

S 85°18′29" E

FOR ROADWAY PLAN SEE SHEET 363 PORT AUTHORITY OF ALLEGHENY COUNTY

BUS RAPID TRANSIT UPTOWN TO OAKLAND

INTERSECTION DETAILS FIFTH AVE & DINNWIDDIE ST

**A** 

CURB RAMP - --- PAV'T SAW CUT LINE

Port Authority connecting people to life CONTRACT NO. BRT-001 ID19 sнт. 195 DWG. NO.

5th Floor Pittsburgh, PA 15219

	NORTHWEST QUADRANT									
POINT NUMBER	BASEL INE	POINT	STATION	OFFSET	ELEVATION BOTTOM OF CURB	ELEVATION TOP OF CURB	ELEVATION BACK OF SIDEWALK			
1	FIFTH AVE	POT	468+18.13	18.00' LT	841.38	841.96	-			
2	FIFTH AVE	POT	468+28.13	18.00' LT	841.62	842.21	-			
3	FIFTH AVE	POT	468+38.13	18.00' LT	841.87	842.45	-			
4	FIFTH AVE	PC	468+48.13	18.00' LT	842.12	*	-			
5	FIFTH AVE	POC	468+55.19	20.91′ LT	842.48	842.87*	-			
6	DINWIDDIE ST	PT	20+27.93	14.97′ LT	842.85	*	-			
7	DINWIDDIE ST	POT	20+39.54	14.92′ LT	[843.61]	[843.84]	-			
8	DINWIDDIE ST	-	20+39.54	25.05′ LT	-	-	843.93			
9	FIFTH AVE	-	468+48.05	30.08′ LT	-	-	842.93			
10	FIFTH AVE	-	468+38.13	30.08′ LT	-	-	842.68			
11	FIFTH AVE	-	468+28.13	30.08′ LT	-	-	[842.43]			
12	FIFTH AVE	-	468+18.13	30.08' LT	-	-	[842.11]			

	NORTHEAST QUADRANT										
POINT NUMBER	BASEL INE	POINT	STATION	OFFSET	ELEVATION BOTTOM OF CURB	ELEVATION TOP OF CURB	ELEVATION BACK OF SIDEWALK				
30	DINWIDDIE ST	POT	20+39.58	14.80′ RT	[844.29]	[844.39]	-				
31	DINWIDDIE ST	ΡI	20+36.26	14.67′ RT	[844.08]	844.31*	-				
32	DINWIDDIE ST	PC	20+28.03	14.67′ RT	[843.49]	*	_				
33	FIFTH AVE	POC	468+90.70	20.93′ LT	843.30	843.80*	-				
34	FIFTH AVE	PT	468+97.77	18.00' LT	843.22	*	-				
35	FIFTH AVE	POT	469+07.77	18.00' LT	843.45	*	-				
36	FIFTH AVE	POT	469+19.16	18.00' LT	843.70	844.29	-				
37	FIFTH AVE	POT	469+29.16	18.00' LT	843.93	844.51	-				
38	FIFTH AVE	-	469+29.16	30.09′ LT	-	-	[844.63]				
39	FIFTH AVE	-	469+19.16	33.09′ LT	-	-	[844.51]				
40	FIFTH AVE	-	469+07.77	30.08′ LT	-	-	[844.26]				
41	FIFTH AVE	-	468+98.05	33.28′ LT	-	-	[844.18]				
42	DINWIDDIE ST	-	20+36.27	24.95′ RT	-	-	[844.57]				
43	DINWIDDIE ST	-	20+39.55	24.95′ RT	-	-	[844.72]				

POINT NUMBER	BASEL INE	POINT	STATION	OFFSET	ELEVATION BOTTOM OF CURB	ELEVATION TOP OF CURB	ELEVATION BACK OF SIDEWAL
60	FIFTH AVE	POT	468+09.14	11.00' RT	841.33	841.50	
61	FIFTH AVE	POT	468+19.14	11.00' RT	841.58	841.74	_
62	FIFTH AVE	POT	468+29.14	11.00' RT	841.83	841.99	_
63	FIFTH AVE	POT	468+39.14	11.00' RT	842.08	842.24	_
64	FIFTH AVE	POT	468+49.14	11.00' RT	842.32	*	_
65	FIFTH AVE	POT	468+59.14	11.00' RT	842.55	842.71	_
66	FIFTH AVE	PC	468+67.81	11.00' RT	842.76	843.32	_
67	FIFTH AVE	PT	468+71.35	9.54′ RT	842.86	843.45	_
68	FIFTH AVE	PC	468+74.42	6.46′ RT	843.02	843.61	_
69	FIFTH AVE	PT	468+77.95	5.00' RT	843.14	843.73	_
70	FIFTH AVE	POT	468+88.00	5.00' RT	843.37	843.95	_
71	FIFTH AVE	POT	468+98.00	5.00' RT	843.59	*	_
72	FIFTH AVE	POT	469+08.00	5.00' RT	843.81	*	_
73	FIFTH AVE	POT	469+18.00	5.00' RT	844.04	844.62	-
74	FIFTH AVE	POT	469+28.00	5.00' RT	844.27	844.85	_
75	FIFTH AVE	PC	469+30.00	5.00' RT	844.31	844.89	_
76	FIFTH AVE	PT	469+33.54	6.46′ RT	844.35	844.93	_
77	FIFTH AVE	POT	469+40.14	11.00' RT	844.37	844.52	_
78	FIFTH AVE	POT	469+50.14	11.00' RT	844.59	844.75	-
79	FIFTH AVE	POT	469+60.14	11.00' RT	844.82	844.98	-
80	FIFTH AVE	POT	469+70.14	11.00' RT	845.05	845.21	-
81	FIFTH AVE	-	469+70.14	29.41′ RT	-	-	[845.00]
82	FIFTH AVE	-	469+60.14	29.41′ RT	-	-	[844.72]
83	FIFTH AVE	-	469+50.14	29.41′ RT	-	-	[844.45]
84	FIFTH AVE	-	469+40.14	29.41′ RT	-	-	[844.20]
85	FIFTH AVE	-	469+30.05	29.41′ RT	-	-	[844.01]
86	FIFTH AVE	-	469+28.00	29.41′ RT	-	-	[843.97]
87	FIFTH AVE	-	469+18.00	29.41′ RT	-	-	[843.77]
88	FIFTH AVE	-	469+08.00	29.42′ RT	-	-	[843.57]
89	FIFTH AVE	-	468+98.00	29.42′ RT	-	-	[843.36]
90	FIFTH AVE	-	468+88.00	29.42′ RT	-	-	[843.12]
91	FIFTH AVE	-	468+77.95	29.42′ RT	-	-	[842.90]
92	FIFTH AVE	-	468+67.81	29.42′ RT	-	-	[842.67]
93	FIFTH AVE	-	468+59.14	29.42′ RT	-	-	[842.41]
94	FIFTH AVE	-	468+49.14	29.42′ RT	-	-	[842.20]
95	FIFTH AVE	-	468+39.14	29.42′ RT	-	-	[842.04]
96	FIFTH AVE	-	468+29.14	29.42′ RT	-	-	[841.89]
97	FIFTH AVE	-	468+19.14	29.42′ RT	-	-	[841.66]
98	FIFTH AVE	_	468+09.14	29.42′ RT	_	_	[841.38]

sнт. 196


[] MATCH EXISTING ELEVATION


**AECOM** Gulf Tower 707 Grant Street 5th Floor Pittsburgh, PA 15219

		THE PREPARATION OF THIS DOCUMENT HAS BEEN FINANCED IN	
		PART THROUGH A GRANT FROM THE	
		FEDERAL TRANSIT ADMINISTRATION, U.S. DEPARTMENT OF	
		TRANSPORTATION, UNDER THE	
		URBAN MASS TRANSPORTATION ACT OF 1964, AS AMENDED, FOR THE	
DATE		PORT AUTHORITY OF ALLEGHENY COUNTY, PENNSYLVANIA.	
	REVISIONS	COUNTY, FEMINISTEVANIA.	

DESIGNED	MJ <u>P/A</u> GO	
DRAWN	<u>JBM</u>	
CHECKED	BFS	
IN CHARGE	LAR	
DATE	05/01/24	
SCALE		
	AS SHOWN	

	PORT AUTHOR PITTSBURGH	ITY OF ALLEGHENY CO	UNTY NSYLVANIA
	IN	RANSIT UPTOWN TO OAKL ITERSECTION DATA	.AND
	FIFT	H AVE & DINWIDD <b>I</b> E ST	
/N	Port Authority	CONTRACT NO. BRT-0	01
· IN	connecting people to life	dwg. no.   D20	sнт. <b>19</b> 6

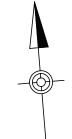

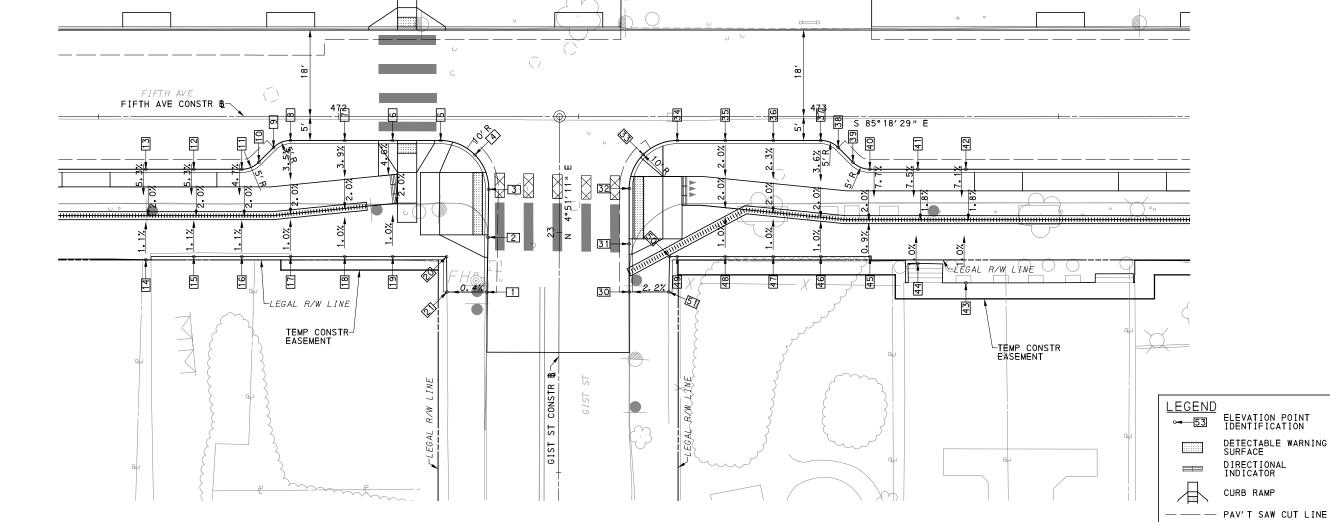

SCALE 10

20 FEET

**AECOM** 

707 Grant Street 5th Floor Pittsburgh, PA 15219

THE PREPARATION OF THIS
DOCUMENT HAS BEEN FINANCED IN
PART THROUGH A GRANT FROM THE
FEDERAL TRANSIT ADMINISTRATION, PEDERAL TRANSIT ADMINISTRATION,
U.S. DEPARTMENT OF
TRANSPORTATION, UNDER THE
URBAN MASS TRANSPORTATION ACT
OF 1964, AS AMENDED, FOR THE
PORT AUTHORITY OF ALLEGHENY
COUNTY, PENNSYLVANIA. NO. DATE DESCRIPTION REVISIONS

(NOT FOR CONSTRUCTION)

DESIGNED MJP/AGO DRAWN CHECKED BFS N CHARGE LAR DATE 05/01/24 SCALE AS SHOWN

FOR ROADWAY PLAN SEE SHEET 364 PORT AUTHORITY OF ALLEGHENY COUNTY

BUS RAPID TRANSIT UPTOWN TO OAKLAND INTERSECTION DETAILS FIFTH AVE & GIST ST

Port Authority

CONTRACT NO. BRT-001 ID21 sнт. 197 DWG. NO.

			SOUTH	HWEST QUA	DRANT		
POINT NUMBER	BASEL INE	POINT	STATION	OFFSET	ELEVATION BOTTOM OF CURB	ELEVATION TOP OF CURB	ELEVATION BACK OF SIDEWALK
1	GIST ST	POT	22+87.51	15.00' LT	[849.84]	[850.11]	-
2	GIST ST	POT	22+98.94	14.85′ LT	[850.29]	*	-
3	GIST ST	PC	22+08.94	14.72′ LT	[850.76]	*	-
4	FIFTH AVE	POC	472+28.42	7.99' RT	850.95	*	-
5	FIFTH AVE	PT	472+21.29	5.00' RT	850.87	851.04*	-
6	FIFTH AVE	POT	472+11.29	5.00' RT	850.66	850.82*	-
7	FIFTH AVE	POT	472+01.29	5.00' RT	850.44	850.61	-
8	FIFTH AVE	PC	471+90.00	5.00' RT	850.22	850.39	-
9	FIFTH AVE	PT	471+86.46	6.46′ RT	850.11	850.29	-
10	FIFTH AVE	PC	471+83.39	9.54′ RT	849.96	850.14	-
11	FIFTH AVE	PT	471+79.86	11.00' RT	849.86	850.02	-
12	FIFTH AVE	POT	471+69.86	11.00' RT	849.66	849.83	-
13	FIFTH AVE	POT	471+59.86	11.00' RT	849.47	849.63	-
14	FIFTH AVE	-	471+59.86	29.85′ RT	-	-	[849.45]
15	FIFTH AVE	-	471+69.86	29.20' RT	-	-	849.64
16	FIFTH AVE	-	471+79.86	29.20' RT	-	-	849.85
17	FIFTH AVE	-	471+90.00	29.20' RT	-	-	850.06
18	FIFTH AVE	-	472+01.29	29. 20' RT	-	-	850.30
19	FIFTH AVE	-	472+11.29	29.20' RT	-	-	850.51
20	FIFTH AVE	-	472+22.51	29. 20' RT	-	-	850.66
21	GIST ST	-	22+87.51	23.37′ LT	_	-	[850.08]


			SOUT	HEAST QUA	DRANT		
POINT NUMBER	BASEL INE	POINT	STATION	OFFSET	ELEVATION BOTTOM OF CURB	ELEVATION TOP OF CURB	ELEVATION BACK OF SIDEWALK
30	GIST ST	POT	22+87.64	14.60' RT	[850.55]	[850.89]	-
31	GIST ST	POT	22+97.64	14.58′ RT	[850.98]	*	-
32	GIST ST	PC	23+09.19	14.55′ RT	[851.38]	*	-
33	FIFTH AVE	POC	472+63.49	7.92′ RT	[851.67]	852.00*	-
34	FIFTH AVE	PT	472+70.56	5.00' RT	851.94	852.27	-
35	FIFTH AVE	POT	472+80.56	5.00′ RT	852.15	852.48	-
36	FIFTH AVE	POT	472+90.56	5.00' RT	852.36	852.70	-
37	FIFTH AVE	PC	473+00.47	5.00′ RT	852.57	852.91	-
38	FIFTH AVE	PŤ	473+04.10	6.46′ RT	852.60	852.93	-
39	FIFTH AVE	PC	473+07.17	9.54′ RT	852.64	852.97	-
40	FIFTH AVE	PT	473+10.70	11.00' RT	852.65	852.98	-
41	FIFTH AVE	POT	473+20.70	11.00' RT	852.78	853.12	-
42	FIFTH AVE	POT	473+30.70	11.00′ RT	852.96	853.30	-
43	FIFTH AVE	-	473+30.70	34.65′ RT	-	-	[853.04]
44	FIFTH AVE	-	473+20.70	30.61′ RT	-	-	[852.80]
45	FIFTH AVE	-	473+10.70	29.18' RT	-	-	852.58
46	FIFTH AVE	-	473+00.47	29.18' RT	-	-	852.53
47	FIFTH AVE	-	472+90.56	29.18′ RT	-	-	852.48
48	FIFTH AVE	-	472+80.56	29.18' RT	-	-	852.32
49	FIFTH AVE	-	472+70.56	29.18 RT	-	-	852.04
50	FIFTH AVE	-	472+68.97	29.18' RT	-	-	851.96
51	GIST ST	-	22+87.64	22.88′ RT	-	-	[851.05]

[] MATCH EXISTING ELEVATION

<b>AECOM</b>
Gulf Tower 707 Grant Street
5th Floor Pittsburgh, PA 15219

		THE PREPARATION OF THIS  DOCUMENT HAS BEEN FINANCED IN
		PART THROUGH A GRANT FROM THE
		FEDERAL TRANSIT ADMINISTRATION, U.S. DEPARTMENT OF
		TRANSPORTATION, UNDER THE
		URBAN MASS TRANSPORTATION ACT OF 1964, AS AMENDED, FOR THE
DATE	DESCRIPTION	PORT AUTHORITY OF ALLEGHENY COUNTY, PENNSYLVANIA.
	REVISIONS	COONTY, PENNSTEVANIA.

ESIGNED MJ <u>P/A</u> GO	PORT AUTHOR	ITY OF ALLEGHENY COU	NTY	
RAWN <u>JBM</u>	PITTSBURGH	PENNS	YLVANIA	
HECKED <u>BFS</u>	BUS RAPID TRANSIT UPTOWN TO OAKLAND			
CHARGE <u>LAR</u>	INTERSECTION DATA			
ATE <u>05/01/24</u>	FIFTH AVE & GIST ST			
CALE AS SHOWN	Port Authority	CONTRACT NO. BRT-00	1	
AS SHOWN	connecting people to life	DWC NO ID22	ент 10	

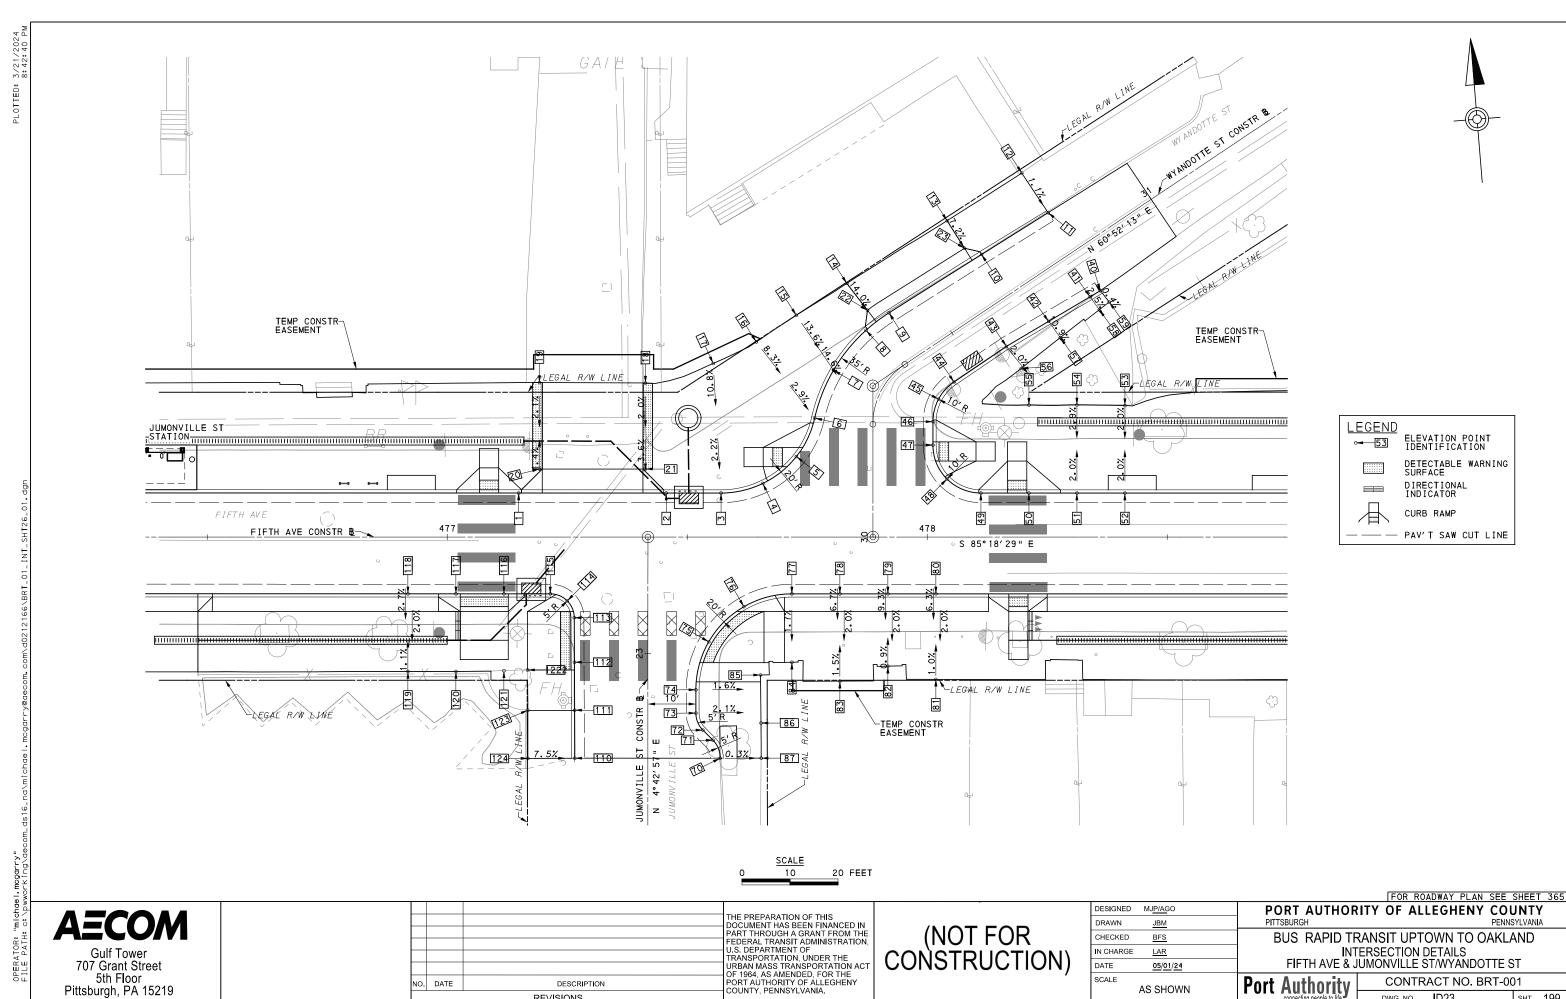

SCALE

AS SHOWN

Port Authority connecting people to life

CONTRACT NO. BRT-001

sнт. **199** 

ID23

DWG. NO.

5th Floor Pittsburgh, PA 15219

NO. DATE

DESCRIPTION

REVISIONS

POINT NUMBER	BASELINE	POINT	STATION	OFFSET	ELEVATION BOTTOM OF CURB	ELEVATION TOP OF CURB	ELEVATION BACK OF SIDEWALK
1	FIFTH AVE	POT	477+14.89	9.17′LT	847.77	848.11*	-
2	FIFTH AVE	POT	477+45.63	9.17′LT	846.94	847.39	-
3	FIFTH AVE	PC	477+57.04	9.17′LT	846.58	847.16	-
4	FIFTH AVE	POC	477+65.75	11.16' LT	846.39	*	-
5	FIFTH AVE	POC	477+72.75	16.77'LT	846.32	*	-
6	WYANDOTTE ST	PRC	30+24.21	12.15' LT	846.57	847.15	-
7	WYANDOTTE ST	POC	30+30.28	10.78' LT	846.89	847.48	-
8	WYANDOTTE ST	POC	30+36.83	10.57'LT	[847.22]	847.80	-
9	WYANDOTTE ST	PT	30+41.45	10.76′ LT	[847.41]	847.57	-
10	WYANDOTTE ST	POT	30+64.25	10.13' LT	[848.88]	849.46	-
11	WYANDOTTE ST	POT	30+80.61	9.63′LT	[850.46]	[851.20]	-
12	WYANDOTTE ST	-	30+80.64	19.57' LT	-	=	[850.94]
13	WYANDOTTE ST	-	30+62.20	19.97'LT	-	-	[849.98]
14	WYANDOTTE ST	-	30+37.94	20.75′ LT	-	-	[848.98]
15	WYANDOTTE ST	-	30+32.99	23.39' LT	-	-	[848.83]
16	WYANDOTTE ST	-	30+29.68	27.86′ LT	-	-	[848.63]
17	FIFTH AVE	-	477+55.41	36.17'LT	-	-	[848.47]
18	FIFTH AVE	-	477+41.30	32.09'LT	-	-	[847.78]
19	FIFTH AVE	-	477+19.22	32.19'LT	-	-	[848.09]
20	FIFTH AVE	-	477+19.22	14.17'LT	-	-	[847.92]
21	FIFTH AVE	-	477+41.30	14.17'LT	-	-	[847.32]
22	WYANDOTTE ST	-	30+38.12	13.69' LT	-	-	848.04
23	WYANDOTTE ST	-	30+62.01	13.19'LT	-	-	849.52

NORTHWEST QUADRANT

	SOUTHWEST QUADRANT						
POINT NUMBER	BASEL INE	POINT	STATION	OFFSET	ELEVATION BOTTOM OF CURB	ELEVATION TOP OF CURB	ELEVATION BACK OF SIDEWALK
110	JUMONVILLE ST	POT	22+78.17	15.21'LT	[845.75]	[845.92]	-
111	JUMONVILLE ST	POT	22+88.17	15.25′ LT	846.45	*	-
112	JUMONVILLE ST	POT	22+98.17	15.30' LT	847.02	*	-
113	JUMONVILLE ST	PC	23+07.44	15.34′ LT	847.32	*	-
114	JUMONVILLE ST	POC	477+25.00	13.29' RT	847.45	*	-
115	FIFTH AVE	PT	477+21.47	11.83′ RT	847.57	847.91*	-
116	FIFTH AVE	POT	477+11.81	11.83′ RT	847.79	*	-
117	FIFTH AVE	POT	477+01.81	11.83′ RT	848.05	*	-
118	FIFTH AVE	POT	476+91.81	11.83′ RT	848.30	848.64	-
119	FIFTH AVE	-	476+91.81	28.01' RT	-	-	[848.51]
120	FIFTH AVE	-	477+01.81	28.01' RT	-	-	[848.28]
121	FIFTH AVE	-	477+11.81	27.86′ RT	-	-	[848.02]
122	FIFTH AVE	-	477+16.73	27.69' RT	-	-	[847.85]
123	JUMONVILLE ST	-	22+88.17	25.01′LT	-	-	847.26
124	JUMONVILLE ST	-	22+78.13	24.99′ LT	-	-	[846.56]

			NOF	RTHEAST Q	JADRANT		
POINT NUMBER	BASEL INE	POINT	STATION	OFFSET	ELEVATION BOTTOM OF CURB	ELEVATION TOP OF CURB	ELEVATION BACK OF SIDEWALK
40	WYANDOTTE ST	POT	30+80.61	9.94′ RT	[850.01]	[850.16]	-
41	WYANDOTTE ST	POT	30+78.12	9.78′ RT	[849.69]	849.86	-
42	WYANDOTTE ST	POT	30+68.10	9.23′ RT	[848.51]	848.67	-
43	WYANDOTTE ST	PI	30+57.89	8.66′ RT	[847.18]	847.35	-
44	WYANDOTTE ST	PC	30+44.68	8.73′ RT	[846.04]	846.21	-
45	WYANDOTTE ST	POC	30+40.01	9.92′ RT	[845.83]	846.01	-
46	WYANDOTTE ST	PT	30+26.64	12.44′ RT	[845.10]	845.27*	-
47	WYANDOTTE ST	PC	30+19.16	12.50' RT	[844.94]	*	-
48	FIFTH AVE	POC	478+04.11	12.10' LT	[844.88]	*	-
49	FIFTH AVE	PT	478+11.18	9• 17′ LT	[844.62]	*	-
50	FIFTH AVE	POT	478+21.18	9.17′LT	844.24	*	-
51	FIFTH AVE	POT	478+31.18	9.17′LT	843.85	844.02	-
52	FIFTH AVE	POT	478+41.18	9.17'LT	843.47	843.64	-
53	FIFTH AVE	-	478+41.18	27.37′LT	-	-	[843.58]
54	FIFTH AVE	-	478+31.18	27.53′ LT	-	-	[844.04]
55	FIFTH AVE	-	478+21.18	27.49' LT	-	-	[844.56]
56	WYANDOTTE ST	_	30+57.89	14.19' RT	-	-	[847.22]
57	WYANDOTTE ST	-	30+68.23	13.39′ RT	-	-	[848.34]
58	WYANDOTTE ST	_	30+78.22	13.10' RT	-	-	[849.61]
59	WYANDOTTE ST	-	30+80.81	12.91' RT	-	-	[850.00]

			SOL	JTHEAST Q	UADRANT		
POINT NUMBER	BASEL INE	POINT	STATION	OFFSET	ELEVATION BOTTOM OF CURB	ELEVATION TOP OF CURB	ELEVATION BACK OF SIDEWALK
70	JUMONVILLE ST	PC	22+78.17	15.05′ RT	[844.96]	[845.12]	-
71	JUMONVILLE ST	PΤ	22+81.93	13.58′ RT	[845.26]	845.43	-
72	JUMONVILLE ST	PC	22+84.04	11.47′ RT	[845.49]	845.65	-
73	JUMONVILLE ST	PT	22+87.58	10.00' RT	[845.79]	846.96	-
74	JUMONVILLE ST	PC	22+92.44	10.00' RT	[846.13]	846.30*	-
75	JUMONVILLE ST	POC	23+02.44	12.68′ RT	846.36	*	-
76	FIFTH AVE	POC	477+61.80	14.51′RT	846.27	*	-
77	FIFTH AVE	PT	477+71.80	11.83′ RT	845.98	846.30	-
78	FIFTH AVE	POT	477+81.80	11.83′ RT	845.60	845.93	-
79	FIFTH AVE	POT	477+91.80	11.83′ RT	845.25	845.57	-
80	FIFTH AVE	POT	478+01.80	11.83′ RT	844.89	845.22	-
81	FIFTH AVE	-	478+01.80	29.66′ RT	-	-	[844.99]
82	FIFTH AVE	-	477+91.80	26.91'RT	-	-	[845.23]
83	FIFTH AVE	-	477+81.80	30.02' RT	-	-	[845.74]
84	FIFTH AVE	-	477+71.80	26.09' RT	-	-	[846.07]
85	FIFTH AVE	-	477+65.27	28.75′ RT	-	-	846.30
86	JUMONVILLE ST	-	22+85.52	23.58′ RT	-	-	845.56
87	JUMONVILLE ST	-	22+78.20	23.61' RT	-	-	[845.04]

NOTE:

\* TOP OF CURB ELEVATION TO BE DETERMINED PER ITEM # 01900.001-DESIGN OF CURB RAMPS

[] MATCH EXISTING ELEVATION

**AECOM** Gulf Tower 707 Grant Street 5th Floor Pittsburgh, PA 15219

		THE PREPARATION OF THIS
		DOCUMENT HAS BEEN FINANCED IN
		PART THROUGH A GRANT FROM THE
		FEDERAL TRANSIT ADMINISTRATION
		U.S. DEPARTMENT OF TRANSPORTATION, UNDER THE
		URBAN MASS TRANSPORTATION AC
DATE	DESCRIPTION	OF 1964, AS AMENDED, FOR THE PORT AUTHORITY OF ALLEGHENY COUNTY, PENNSYLVANIA.
	REVISIONS	COUNTY, PENNSTEVANIA.

(NOT FOR CONSTRUCTION)

DESIGNED	MJ <u>P/A</u> GO	_
DRAWN	<u>JBM</u>	L
CHECKED	<u>BFS</u>	
IN CHARGE	<u>LAR</u>	
DATE	05/01/24	
SCALE		Ī
	AS SHOWN	

### PORT AUTHORITY OF ALLEGHENY COUNTY PITTSBURGH PENNSYLVANIA


BUS RAPID TRANSIT UPTOWN TO OAKLAND
INTERSECTION DATA
FIFTH AVE & JUMONVILLE ST/WYANDOTTE ST

CONTRACT NO. BRT-001 DWG. NO. D24

Port Authority

sнт. 200



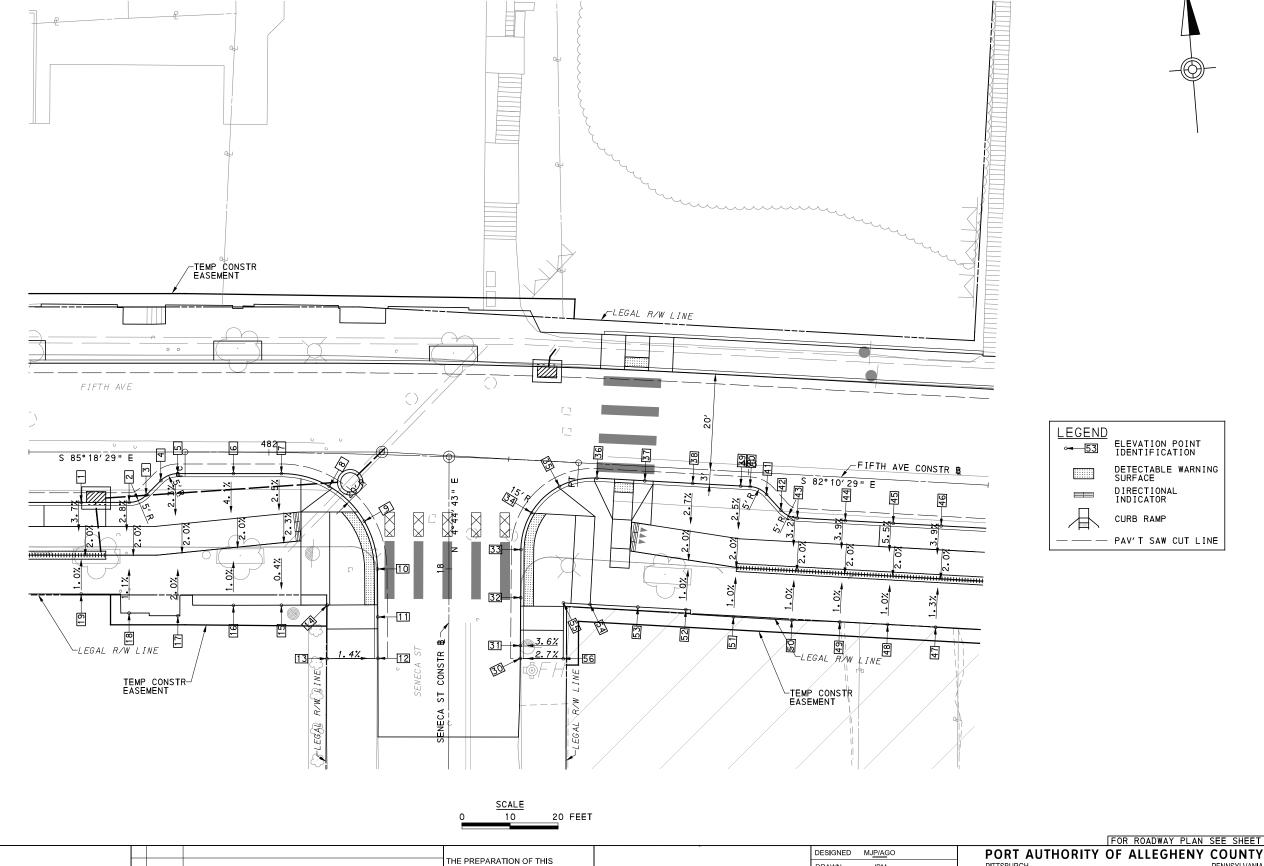

**AECOM** 

**Gulf Tower** 707 Grant Street 5th Floor Pittsburgh, PA 15219

THE PREPARATION OF THIS
DOCUMENT HAS BEEN FINANCED IN
PART THROUGH A GRANT FROM THE
FEDERAL TRANSIT ADMINISTRATION, PEDERAL TRANSIT ADMINISTRATION,
U.S. DEPARTMENT OF
TRANSPORTATION, UNDER THE
URBAN MASS TRANSPORTATION ACT
OF 1964, AS AMENDED, FOR THE
PORT AUTHORITY OF ALLEGHENY
COUNTY, PENNSYLVANIA. NO. DATE DESCRIPTION REVISIONS

(NOT FOR CONSTRUCTION)

SIGNED	MJ <u>P/A</u> GO	
RAWN	JBM	L
HECKED	BFS	
CHARGE	<u>LAR</u>	
ATE	05/01/24	
CALE		Г
	AS SHOWN	

FOR ROADWAY PLAN SEE SHEET 366

BUS RAPID TRANSIT UPTOWN TO OAKLAND INTERSECTION DETAILS FIFTH AVE & SENECA ST

Port	Author connecting peop		
------	------------------------	--	--

CONTRACT NO. BRT-001 DWG. NO. ID25

sнт. 201

	SOUTHWEST QUADRANT							
POINT NUMBER	BASELINE	POINT	STATION	OFFSET	ELEVATION BOTTOM OF CURB	ELEVATION TOP OF CURB	ELEVATION BACK OF SIDEWALK	
1	FIFTH AVE	POT	481+60.87	10.50' RT	831.66	831.99	-	
2	FIFTH AVE	PC	481+70.87	10.50' RT	831.26	831.60	-	
3	FIFTH AVE	PT	481+74.40	9.04′ RT	831.17	831.50	-	
4	FIFTH AVE	PC	481+77.47	5.96′ RT	831.14	831.47	-	
5	FIFTH AVE	PT	481+81.01	4.50' RT	831.05	831.38	-	
6	FIFTH AVE	POT	481+92.63	4. 47′ RT	830.59	830.92	_	
7	FIFTH AVE	PC	482+02.66	4.37′ RT	830.20	830.53	_	
8	FIFTH AVE	POC	482+12.70	6.86′ RT	829.70	830.03*	_	
9	SENECA ST	POC	18+09.93	17.63′LT	829.21	*	_	
10	SENECA ST	PT	17+99.99	14.90' LT	828.71	*	_	
11	SENECA ST	POT	17+89.99	14.83′ LT	827.59	*	-	
12	SENECA ST	POT	17+81.38	14.77′ LT	[826.97]	[827.83]	-	
13	SENECA ST	-	17+81.30	25.39'LT	-	ı	[827.97]	
14	FIFTH AVE	-	482+12.76	31.61′ RT	-	ı	829.71	
15	FIFTH AVE	-	482+03.03	31.80' RT	-	ı	[830.14]	
16	FIFTH AVE	-	481+92.82	31.93′ RT	-	ı	[830.56]	
17	FIFTH AVE	-	481+81.02	34.13′ RT	-	ı	831.29	
18	FIFTH AVE	-	481+70.87	33.57′ RT	-	ı	[831.49]	
19	FIFTH AVE	-	481+60.87	29.60′ RT	-	-	[831.79]	

			SOUTH	HEAST QUA	DRANT		
POINT NUMBER	BASEL INE	POINT	STATION	OFFSET	ELEVATION BOTTOM OF CURB	ELEVATION TOP OF CURB	ELEVATION BACK OF SIDEWALK
30	SENECA ST	POT	17+81.38	14.88′ RT	[826.25]	[826.83]	-
31	SENECA ST	POT	17+84.06	14.89' RT	826.45	827.04	-
32	SENECA ST	POT	17+94.06	14.94' RT	827.18	*	-
33	SENECA ST	PC	18+04.06	15.00' RT	827.75	*	-
34	SENECA ST	POC	18+11.75	17. 17' RT	828.05	*	-
35	FIFTH AVE	POC	482+60.81	5.13′ RT	827.94	828.27*	-
36	FIFTH AVE	PT	482+68.53	3.00′ RT	827.61	*	-
37	FIFTH AVE	POT	482+78.53	3.00' RT	827.20	*	-
38	FIFTH AVE	POT	482+88.53	3.00′ RT	826.80	827.13	-
39	FIFTH AVE	POT	482+98.53	3.00' RT	826.39	826.73	-
40	FIFTH AVE	PC	483+00.50	3.00' RT	826.31	826.65	-
41	FIFTH AVE	PT	483+04.01	4.44′ RT	826.14	826.48	-
42	FIFTH AVE	PC	483+07.18	7.56′ RT	825.93	826.27	-
43	FIFTH AVE	PT	483+10.69	9.00' RT	825.76	826.09	-
44	FIFTH AVE	POT	483+20.69	9.00' RT	825.38	825.71	-
45	FIFTH AVE	POT	483+30.69	9.00' RT	825.01	825.34	-
46	FIFTH AVE	POT	483+40.69	9.00' RT	824.63	824.97	-
47	FIFTH AVE	-	483+40.69	30.16' RT	-	-	[824.81]
48	FIFTH AVE	-	483+30.69	30.13′ RT	-	-	[825.08]
49	FIFTH AVE	-	483+20.69	30.15′ RT	-	-	[825.52]
50	FIFTH AVE	-	483+10.69	30.32′ RT	-	-	[825.93]
51	FIFTH AVE	-	482+98.53	30.31'RT	-	-	[826.45]
52	FIFTH AVE	-	482+88.53	29.33' RT	-	-	826.86
53	FIFTH AVE	-	482+78.53	29.33' RT	-	-	827.37
54	FIFTH AVE	-	482+68.53	29.33' RT	-	-	827.88
55	FIFTH AVE	-	482+62.96	29.33' RT	-	-	827.90
56	SENECA ST	-	17+81.34	23.83' RT	-	-	[827.02]


[] MATCH EXISTING ELEVATION

$\Lambda = C \cap \Lambda \Lambda$			
AECOM			
Gulf Tower			
707 Grant Street			
5th Floor	NO.	DATE	DESCRIPTION
Pittsburgh, PA 15219			DEVISIONS

THE PREPARATION OF THIS

DOCUMENT HAS BEEN FINANCED IN
PART THROUGH A GRANT FROM THE
FEDERAL TRANSIT ADMINISTRATION,
U.S. DEPARTMENT OF
TRANSPORTATION, UNDER THE
URBAN MASS TRANSPORTATION ACT
OF 1964, AS AMENDED, FOR THE
PORT AUTHORITY OF ALLEGHENY
COUNTY, PENNSYLVANIA. REVISIONS

DESIGNED N	/J <u>P/A</u> GO	PORT AUTHOR	ITY OF AL	LEGHENY COL	'TNL	Υ
DRAWN	<u>JBM</u>	PITTSBURGH		PENNS	SYLVAN	lΑ
CHECKED	BFS	BUS RAPID TE	RANSIT UPT	OWN TO OAKL	AND	
IN CHARGE	LAR	IN	ITERSECTION	I DATA		
DATE	05/01/24	FIF	TH AVE & SEN	IECA ST		
SCALE A	S SHOWN	Port Authority	CONTR	ACT NO. BRT-00	01	
	3 31 IOVVIV	connecting people to life	DWG, NO.	ID26	SHT.	202

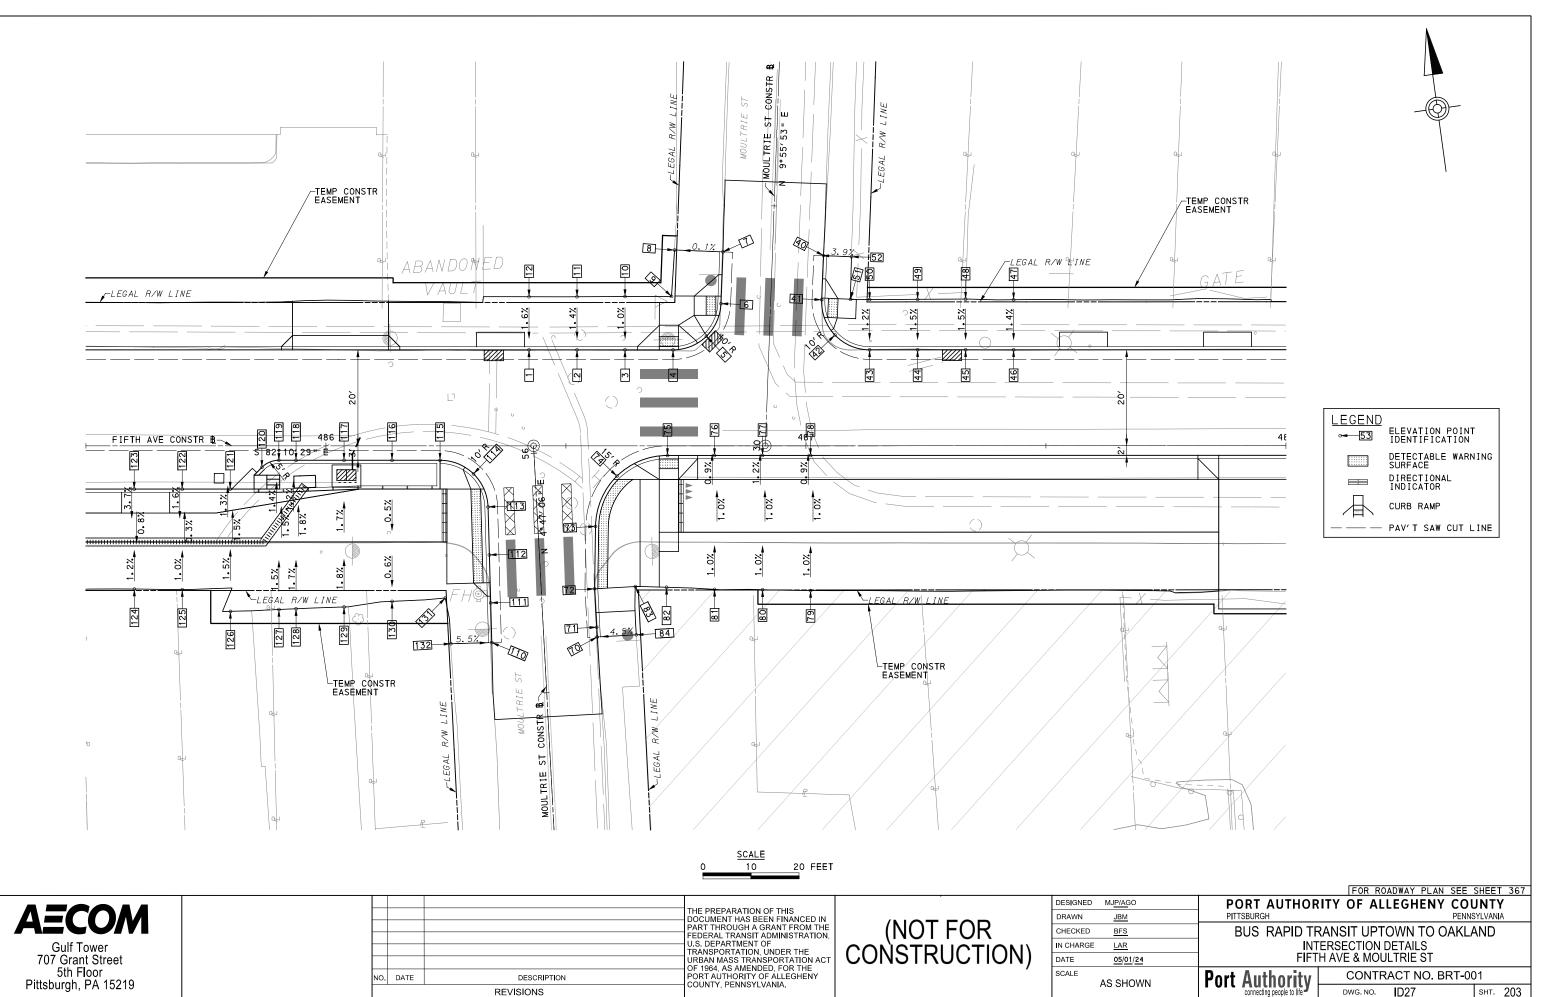

REVISIONS

AS SHOWN

ID27

sнт. 203

DWG. NO.

	NORTHWEST QUADRANT								
POINT NUMBER	BASEL INE	POINT	STATION	OFFSET	ELEVATION BOTTOM OF CURB	ELEVATION TOP OF CURB	ELEVATION BACK OF SIDEWALK		
1	FIFTH AVE	POT	486+42.32	20.00' LT	812.86	813.06	-		
2	FIFTH AVE	POT	486+52.32	20.00' LT	812.58	812.88	-		
3	FIFTH AVE	POT	486+62.32	20.00' LT	812.34	812.68*	-		
4	FIFTH AVE	PC	486+72.32	20.00' LT	812.11	*	-		
5	FIFTH AVE	POC	486+79.25	22.80' LT	812.15	812.49*	-		
6	MOULTRIE ST	PT	30+29.26	10.32'LT	812.19	*	-		
7	MOULTRIE ST	POT	30+40.05	10.31'LT	[812.69]	[812.83]	-		
8	FIFTH AVE	-	30+40.05	20. 40' LT	-	-	[812.82]		
9	FIFTH AVE	-	486+72.00	31.14′LT	-	-	[812.65]		
10	FIFTH AVE	-	486+62.32	31.10'LT	-	-	[812,78]		
11	FIFTH AVE	-	486+52.32	31.05′LT	-	-	[813.03]		
12	FIFTH AVE	-	486+42.32	31.05′ LT	-	-	[813.23]		

	NORTHEAST QUADRANT								
POINT NUMBER	BASEL INE	POINT	STATION	OFFSET	ELEVATION BOTTOM OF CURB	ELEVATION TOP OF CURB	ELEVATION BACK OF SIDEWALK		
40	MOULTRIE ST	POT	30+40.05	10.66′ RT	[812.02]	[812.33]	-		
41	MOULTRIE ST	PC	30+30.83	10.61' RT	[811.60]	*	-		
42	FIFTH AVE	POC	487+06.05	23.08' LT	811.48	811.94*	-		
43	FIFTH AVE	PT	487+13.27	20.00' LT	811.44	811.94	-		
44	FIFTH AVE	POT	487+23.27	20.00' LT	811.30	811.80	-		
45	FIFTH AVE	POT	487+33.27	20.00' LT	811.16	811.66	-		
46	FIFTH AVE	POT	487+43.27	20.00' LT	811.02	811.52	-		
47	FIFTH AVE	-	487+43.27	30.44′LT	-	-	811.66		
48	FIFTH AVE	-	487+33.27	30.55′LT	-	-	[811.81]		
49	FIFTH AVE	-	487+23.27	30.52′ LT	-	-	[811.95]		
50	FIFTH AVE	-	487+13.27	30.48′LT	-	-	[812.09]		
51	FIFTH AVE	-	487+09.30	30.53′LT	-	-	[812.05]		
52	MOULTRIE ST	-	30+40.02	16.50' RT	-	-	[812.43]		

			SOUTI	HWEST QUA	DRANT		
POINT NUMBER	BASELINE	POINT	STATION	OFFSET	ELEVATION BOTTOM OF CURB	ELEVATION TOP OF CURB	ELEVATION BACK OF SIDEWALK
110	MOULTRIE ST	POT	55+61.07	10.87'LT	[811.35]	[811.68]	-
111	MOULTRIE ST	POT	55+69.34	10.66' LT	812.08	812.65*	-
112	MOULTRIE ST	POT	55+79.34	10.41′LT	812.63	*	-
113	MOULTRIE ST	PC	55+89.33	10.16'LT	813.15	*	-
114	FIFTH AVE	POC	486+30.75	5.83′ RT	813.45	*	-
115	FIFTH AVE	PT	486+23.77	3.00' RT	813.80	814.38	-
116	FIFTH AVE	POT	486+13.77	3.00' RT	814.17	814.75	-
117	FIFTH AVE	POT	486+03.77	3.00' RT	814.54	815.12	-
118	FIFTH AVE	POT	485+93.77	3.00' RT	814.91	815.49	-
119	FIFTH AVE	PC	485+90.20	3.00' RT	815.04	815.63	-
120	FIFTH AVE	PT	485+86.66	4.46′ RT	815.13	815.71	-
121	FIFTH AVE	POT	485+80.06	9.00' RT	815.26	815.58	-
122	FIFTH AVE	POT	485+70.06	9.00' RT	815.63	815.97	-
123	FIFTH AVE	POT	485+60.06	9.00' RT	816.03	816.37	-
124	FIFTH AVE	-	485+60.06	29.84′ RT	-	-	[816.28]
125	FIFTH AVE	-	485+70.06	29.94′ RT	-	-	816.01
126	FIFTH AVE	-	485+80.10	34.48′ RT	-	-	815.90
127	FIFTH AVE	-	485+90.20	34.09' RT	-	-	[815.83]
128	FIFTH AVE	-	485+93.77	33.93′ RT	-	-	[815.77]
129	FIFTH AVE	-	486+03.77	33.57′ RT	-	-	[815.40]
130	FIFTH AVE	-	486+13.77	32.40′ RT	-	-	[814.34]
131	FIFTH AVE	-	486+24.87	31.69′ RT	-	-	[813.57]
132	FIFTH AVE	-	55+61.29	19.40' LT	-	-	[812.32]

	SOUTHEAST QUADRANT									
POINT NUMBER	BASELINE	POINT	STATION	OFFSET	ELEVATION BOTTOM OF CURB	ELEVATION TOP OF CURB	ELEVATION BACK OF SIDEWALK			
70	MOULTRIE ST	POT	55+61.07	11.12′ RT	[810.90]	[810.99]	-			
71	MOULTRIE ST	POT	55+63.10	11.12′ RT	811.08	811.23	-			
72	MOULTRIE ST	PI	55+71.12	11.11' RT	811.59	*	-			
73	MOULTRIE ST	PC	55+84.09	11.99′ RT	812.43	*	-			
74	FIFTH AVE	POC	486+60.63	6.32′ RT	812.77	*	-			
75	FIFTH AVE	PT	486+71.16	2.00′ RT	812.58	*	-			
76	FIFTH AVE	POT	486+80.97	2.00′ RT	812.39	812.72	-			
77	FIFTH AVE	POT	486+90.97	2.00′ RT	812.22	812.55	-			
78	FIFTH AVE	POT	487+00.97	2.00' RT	812.05	812.39	-			
79	FIFTH AVE	-	487+00.97	30.16′ RT	-	-	812.66			
80	FIFTH AVE	-	486+90.97	29.98' RT	-	-	812.83			
81	FIFTH AVE	-	486+80.97	29.90' RT	-	-	812.99			
82	FIFTH AVE	-	486+70.97	29.47′ RT	-	-	812.54			
83	FIFTH AVE	-	486+64.45	29.32′ RT	-	-	[812.18]			
84	FIFTH AVE	-	55+61.08	19.28' RT	-	-	[811.29]			

[] MATCH EXISTING ELEVATION

**AECOM** Gulf Tower 707 Grant Street 5th Floor Pittsburgh, PA 15219

		THE PREPARATION OF THIS DOCUMENT HAS BEEN FINANCED IN
		PART THROUGH A GRANT FROM THE
		FEDERAL TRANSIT ADMINISTRATION, U.S. DEPARTMENT OF
		TRANSPORTATION, UNDER THE
		URBAN MASS TRANSPORTATION ACT OF 1964, AS AMENDED, FOR THE
DATE	DESCRIPTION	PORT AUTHORITY OF ALLEGHENY COUNTY, PENNSYLVANIA.
	REVISIONS	COUNTY, PENINSTEVANIA.

(NOT FOR CONSTRUCTION)

DESIGNED	MJ <u>P/A</u> GO	
DRAWN	<u>JBM</u>	
CHECKED	<u>BFS</u>	
IN CHARGE	LAR	
DATE	05/01/24	
SCALE		
	AS SHOWN	


### PORT AUTHORITY OF ALLEGHENY COUNTY PENNSYLVANIA

BUS RAPID TRANSIT UPTOWN TO OAKLAND
INTERSECTION DATA
FIFTH AVE & MOULTRIE ST

Port Authority
connecting people to life

CONTRACT NO. BRT-001

DWG. NO. D28 sнт. 204

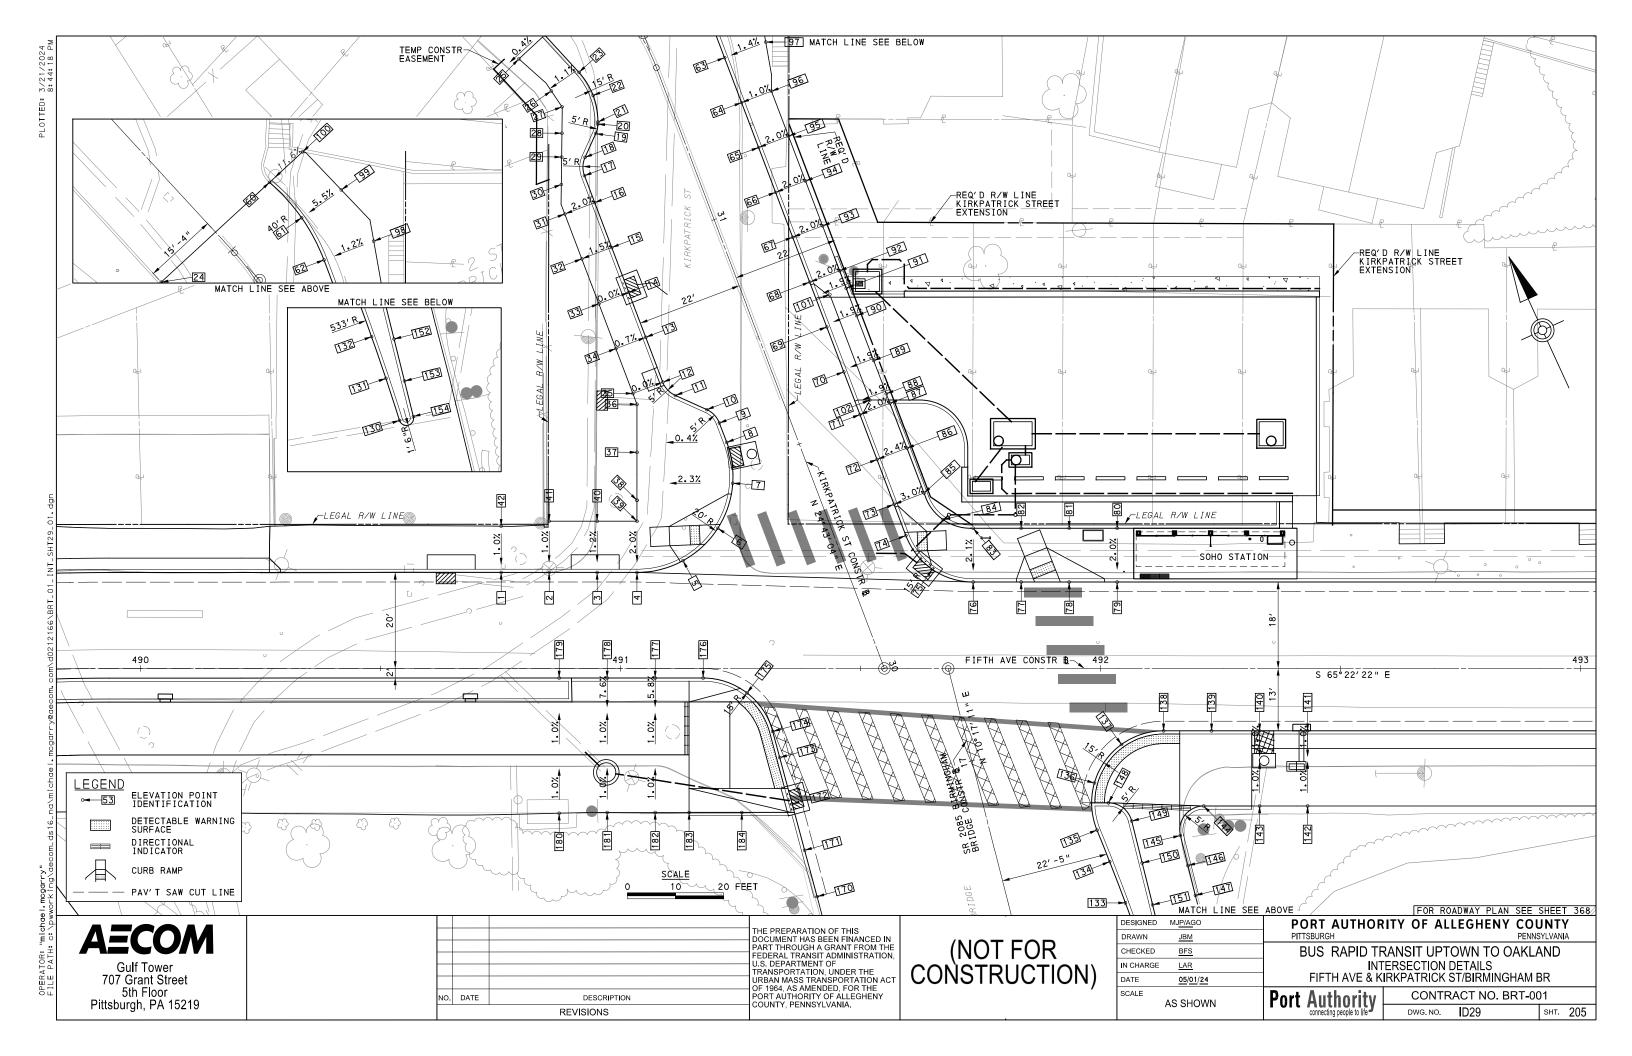

37 KI	ζ I		
AECOM  Gulf Tower 707 Grant Street 5th Floor Pittsburgh, PA 15219		36	ΚI
38 KI 39 40 41 42  AECOM  Gulf Tower 707 Grant Street 5th Floor Pittsburgh, PA 15219		37	ΚI
A=COM  Gulf Tower 707 Grant Street 5th Floor Pittsburgh, PA 15219		38	ΚI
AECOM  Gulf Tower 707 Grant Street 5th Floor Pittsburgh, PA 15219		39	
A=COM  Gulf Tower 707 Grant Street 5th Floor Pittsburgh, PA 15219		40	
AECOM  Gulf Tower 707 Grant Street 5th Floor Pittsburgh, PA 15219		41	
<b>AECOM</b> Gulf Tower 707 Grant Street 5th Floor Pittsburgh, PA 15219		42	
<b>AECOM</b> Gulf Tower 707 Grant Street 5th Floor Pittsburgh, PA 15219			
AECOM  Gulf Tower 707 Grant Street 5th Floor Pittsburgh, PA 15219			
AECOM  Gulf Tower 707 Grant Street 5th Floor Pittsburgh, PA 15219			
AECOM  Gulf Tower 707 Grant Street 5th Floor Pittsburgh, PA 15219			
A=COM  Gulf Tower  707 Grant Street  5th Floor  Pittsburgh, PA 15219			
Gulf Tower 707 Grant Street 5th Floor Pittsburgh, PA 15219			
Gulf Tower 707 Grant Street 5th Floor Pittsburgh, PA 15219			
Gulf Tower 707 Grant Street 5th Floor Pittsburgh, PA 15219			
AECOM  Gulf Tower 707 Grant Street 5th Floor Pittsburgh, PA 15219			
Gulf Tower 707 Grant Street 5th Floor Pittsburgh, PA 15219	<u>"</u>		
Gulf Tower 707 Grant Street 5th Floor Pittsburgh, PA 15219			
Gulf Tower 707 Grant Street 5th Floor Pittsburgh, PA 15219			
Gulf Tower 707 Grant Street 5th Floor Pittsburgh, PA 15219	A <b>—</b>		4
Gulf Tower 707 Grant Street 5th Floor Pittsburgh, PA 15219	$\mathbf{A} = \mathbf{C}$	UN	7
Gulf Tower 707 Grant Street 5th Floor Pittsburgh, PA 15219			
707 Grant Street 5th Floor Pittsburgh, PA 15219	Gulf To	wer	
Pittsburgh, PA 15219	/0/ Grant	Street	
Pillsburgh, PA 15219	- Sth Flo	00ľ	
	Pittsburgh, F	A 15219	

			NORTH	HWEST QUA	DRANT		
POINT NUMBER	BASEL INE	POINT	STATION	OFFSET	ELEVATION BOTTOM OF CURB	ELEVATION TOP OF CURB	ELEVATION BACK OF SIDEWALK
1	FIFTH AVE	POT	490+75.16	20.00' LT	815.89	816.39	-
2	FIFTH AVE	POT	490+85.16	20.00' LT	816.40	816.90	-
3	FIFTH AVE	POT	490+95.16	20.00' LT	816.93	817.43	-
4	FIFTH AVE	PC	491+03.46	20.00' LT	817.37	817.87	-
5	FIFTH AVE	POC	491+13.05	22.45′LT	817.82	818.33*	-
6	KIRKPATRICK ST	POC	30+39.61	22.10'LT	818.29	*	-
7	KIRKPATRICK ST	POC	30+47.28	15.85' LT	818.85	819.43	-
8	KIRKPATRICK ST	PT	30+55.68	14.00' LT	819.44	820.03	-
9	KIRKPATRICK ST	PC	30+60.00	14.00' LT	819.80	820.38	-
10	KIRKPATRICK ST	PT	30+63.54	15.46' LT	820.05	820.64	-
11	KIRKPATRICK ST	PC	30+68.61	20.54' LT	820.32	820.91	-
12	KIRKPATRICK ST	PT	30+72.14	22.00' LT	820.64	821.20	-
13	KIRKPATRICK ST	POT	30+82.14	22.00' LT	821.89	822.45	-
14	KIRKPATRICK ST	POT	30+92.14	22.00' LT	823.18	823.77	-
15	KIRKPATRICK ST	POT	31+02.14	22.00′ LT	824.47	825.05	-
16	KIRKPATRICK ST	POT	31+12.14	22.00' LT	825.71	826.30	-
17	KIRKPATRICK ST	PC	31+18.14	22.00′ LT	826.44	827.02	-
18	KIRKPATRICK ST	PŤ	31+21.68	20.54' LT	826.96	827.51	-
19	KIRKPATRICK ST	PC	31+25.51	16.70'LT	827.55	828.15	-
20	KIRKPATRICK ST	PŤ	31+27.20	15.59'LT	827.79	828.37	-
21	KIRKPATRICK ST	PC	31+27.61	15.43'LT	827.84	828.43	-
22	KIRKPATRICK ST	POC	31+33.14	14.37'LT	828.48	829.07	-
23	KIRKPATRICK ST	PT	31+41.60	14.97'LT	829.34	829.91	-
24	KIRKPATRICK ST	POT	31+55.00	15.38'LT	[830.68]	[831.13]	-
25	KIRKPATRICK ST	-	31+55.00	22.72′LT	-	_	[830.94]
26	KIRKPATRICK ST	-	31+41.01	21.91'LT	-	_	[829.85]
27	KIRKPATRICK ST	-	31+33.22	21.29' LT	-	-	[829,22]
28	KIRKPATRICK ST	-	31+28.08	23. 25' LT	-	_	[828,38]
29	KIRKPATRICK ST	-	31+23.46	25.07'LT	_	_	[827,75]
30	KIRKPATRICK ST	-	31+18.14	27.16' LT	-	_	[826,96]
31	KIRKPATRICK ST	-	31+12.14	28.67'LT	-	_	826.18
32	KIRKPATRICK ST	-	31+02.14	28.67'LT	_	_	824.96
33	KIRKPATRICK ST	_	30+92.14	28.67'LT	_	_	823.77
34	KIRKPATRICK ST	-	30+82.14	28.67'LT	-		822.49
35	KIRKPATRICK ST	_	30+72.14	28.67'LT	-		821.20
36	KIRKPATRICK ST	-	30+69.74	28.67'LT	_	_	820.89
37	KIRKPATRICK ST	_	30+60.39	32.21'LT	-	_	819.72
38	KIRKPATRICK ST	_	30+51.04	35.76′LT	-	_	818.57
39	FIFTH AVE	_	491+03.46	30.67'LT	-	_	818.07
40	FIFTH AVE	_	490+95.16	30.67'LT	-	_	817.55
41	FIFTH AVE	-	490+85.16	30.67' LT	-	_	817.00
42	FIFTH AVE	_	490+75.16	29.63' LT	_	_	816.48

			NORTH	HEAST QUA	DRANT			
POINT NUMBER	BASEL INE	POINT	STATION	OFFSET	ELEVATION BOTTOM OF CURB	ELEVATION TOP OF CURB	ELEVATION BACK OF SIDEWALK	
60	KIRKPATRICK ST	PC	31+55.00	15.29′ RT	[832.36]	[832.89]	-	
61	KIRKPATRICK ST	POC	31+46.19	15.37′ RT	831.38	831.96	-	
62	KIRKPATRICK ST	PŤ	31+38.96	14. 44' RT	830.54	831.12	-	
63	KIRKPATRICK ST	POT	31+30.78	14.00' RT	829.61	830.21	-	
64	KIRKPATRICK ST	POT	31+20.78	14.00' RT	828.46	829.05	-	
65	KIRKPATRICK ST	POT	31+10.78	14.00' RT	827.25	827.84	-	
66	KIRKPATRICK ST	POT	31+00.78	14.00' RT	826.00	826.57	-	
67	KIRKPATRICK ST	POT	30+90.78	14.00' RT	824.65	825.24	-	
68	KIRKPATRICK ST	POT	30+80.77	14.00' RT	823.28	823.87	-	
69	KIRKPATRICK ST	POT	30+70.77	14.00' RT	822.00	822.17	-	
70	KIRKPATRICK ST	POT	30+60.77	14.00' RT	820.93	821.10	-	
71	KIRKPATRICK ST	POT	30+51.24	14.00' RT	820.11	820.69	-	
72	KIRKPATRICK ST	POT	30+41.24	14.00' RT	819.46	820.04	-	
73	KIRKPATRICK ST	POT	30+30.03	14.00' RT	819.13	819.71	-	
74	KIRKPATRICK ST	PC	30+24.29	14.00' RT	819.14	*	-	
75	FIFTH AVE	POC	491+64.98	20.65' LT	819.65	820.23	-	
76	FIFTH AVE	PŤ	491+73.50	18.00' LT	820.09	820.67	-	
77	FIFTH AVE	POT	491+83.50	18.00' LT	820.45	*	_	
78	FIFTH AVE	POT	491+93.50	18.00' LT	820.84	*	_	
79	FIFTH AVE	POT	492+03.50	18.00' LT	821.25	821.83	-	
80	FIFTH AVE	_	492+03.50	29.21'LT	-	_	822.04	
81	FIFTH AVE	-	941+93.50	29.21'LT	-	_	821.63	
82	FIFTH AVE	-	491+83.50	29.21'LT	-	-	821.05	
83	FIFTH AVE	-	491+73.50	29.21'LT	-	_	820.89	
84	FIFTH AVE	-	491+67.24	30.98'LT	-	-	820.11	
85	KIRKPATRICK ST	-	30+31.24	20.67' RT	-	_	819.89	
86	KIRKPATRICK ST	-	30+41.24	20.67' RT	-	_	820.15	
87	KIRKPATRICK ST	-	30+51.24	20.67' RT	-	_	820.81	
88	KIRKPATRICK ST	-	30+53.36	20.67' RT	-	_	820.98	
89	KIRKPATRICK ST	-	30+60.77	20.67' RT	-	-	821.64	
90	KIRKPATRICK ST	-	30+70.77	20.67' RT	-	-	822.71	
91	KIRKPATRICK ST	-	30+76.89	20.67' RT	-	-	823.47	
92	KIRKPATRICK ST	-	30+80.77	20.67' RT	-	-	823.99	
93	KIRKPATRICK ST	-	30+90.78	20.67' RT	-		825.36	
94	KIRKPATRICK ST	_	31+00.78	20.67' RT	-	-	826.71	
95	KIRKPATRICK ST	-	31+10.77	20.67' RT	_	_	827.96	
96	KIRKPATRICK ST	_	31+20.77	20.69' RT	-		[829.11]	
97	KIRKPATRICK ST	-	31+30.77	23. 19' RT	-	_	[830.33]	
98	KIRKPATRICK ST	_	31+38.10	25. 46' RT	_	_	[831.51]	
99	KIRKPATRICK ST	_	31+45.82	25. 46' RT	_	-	[832, 48]	
100	KIRKPATRICK ST	_	31+55.00	24.68' RT	_	_	[833.90]	
101	KIRKPATRICK ST	_	30+76.89	17.00' RT	_	_	823.40	
102	KIRKPATRICK ST	_	30+53.36	17.00 RT	_		820.91	

[] MATCH EXISTING ELEVATION

		THE PREPARATION OF THIS DOCUMENT HAS BEEN FINANCED I
		PART THROUGH A GRANT FROM T
		FEDERAL TRANSIT ADMINISTRATIO
		U.S. DEPARTMENT OF TRANSPORTATION, UNDER THE
		URBAN MASS TRANSPORTATION A OF 1964. AS AMENDED, FOR THE
DATE	DESCRIPTION	PORT AUTHORITY OF ALLEGHENY COUNTY, PENNSYLVANIA.
	REVISIONS	COUNTY, PENNSTEVANIA.

(NOT FOR CONSTRUCTION)

DESIGNED	MJ <u>P/A</u> GO	
DRAWN	<u>JBM</u>	
CHECKED	BFS	
IN CHARGE	LAR	
DATE	05/01/24	
SCALE		D
	AS SHOWN	

		RITY	OF	ALLEG	IENY	COUNTY
PITTSBURG	jΗ					PENNSYLVAN <b>I</b> A
BUS	RAPID :					AKLAND

INTERSECTION DATA FIFTH AVE & KIRKPATRICK ST/BIRMINGHAM BR

sнт. 206

CONTRACT NO. BRT-001 Port Authority connecting people to life DWG. NO. ID30

	v
	-
	Z
	_
	C
	_
	α
	σ
	ú
	9
	2
	TNI TO TARABLA TOTAL
	3
	Ť
	6
	5
	Č
	2
	č
	Ç
	q
	Č
	?
	i
	Ĉ
	Ç
	È
	_
	0
	Č
	÷
	÷
	Ε
	6
	č
	1
	4
	(
	Ε
	ç
_	à
5	Ċ
Cadrry	6
₽	č
Š	ή.
	Ť
michdel.	ç
Φ	Š
michae	ć
ㅎ	7
Έ	(
=	
••	ĭ
OR:	ATTA CONSTRUCTION OF THE CONTRACT OF THE CONTR
$\sim$	<

	SOUTHWEST QUADRANT							
POINT NUMBER	BASELINE	POINT	STATION	OFFSET	ELEVATION BOTTOM OF CURB	ELEVATION TOP OF CURB	ELEVATION BACK OF SIDEWALK	
170	SR 2085 BIRMINGHAM BRIDGE	POT	16+80.56	38.24′ LT	[819.55]	[820.06]	-	
171	SR 2085 BIRMINGHAM BRIDGE	POT	16+90.56	38.36′ LT	819.03	819.61	-	
172	SR 2085 BIRMINGHAM BRIDGE	POT	17+00.55	38.48′LT	818.77	*	-	
173	SR 2085 BIRMINGHAM BRIDGE	POT	17+10.55	38.60′ LT	818.67	*	-	
174	SR 2085 BIRMINGHAM BRIDGE	PC	17+16.20	38.67′LT	818.61	*	-	
175	FIFTH AVE	POC	491+26.37	5.10' RT	818.49	*	-	
176	FIFTH AVE	ΡŤ	491+17.24	2.00' RT	818.19	818.51	-	
177	FIFTH AVE	POT	491+07.24	2.00' RT	817.79	818.13	-	
178	FIFTH AVE	POT	490+97.24	2.00' RT	817.38	817.71	-	
179	FIFTH AVE	POT	490+87.24	2.00' RT	816.90	817.49	-	
180	FIFTH AVE	-	490+87.24	30.17′ RT	-	-	817.11	
181	FIFTH AVE	-	490+97.24	30.00' RT	=	-	817.61	
182	FIFTH AVE	-	491+07.24	30.00' RT	=	=	818.11	
183	FIFTH AVE	-	491+14.32	30.00' RT	-	-	818.47	
184	FIFTH AVE	-	491+25.29	30.00' RT	=	-	818.74	

SOUTHEAST QUADRANT							
POINT NUMBER	BASELINE	POINT	STATION	OFFSET	ELEVATION BOTTOM OF CURB	ELEVATION TOP OF CURB	ELEVATION BACK OF SIDEWALK
130	SR 2085 BIRMINGHAM BRIDGE	PCC	16+35.87	25.89′ RT	823.62	824.20	-
131	SR 2085 BIRMINGHAM BRIDGE	POC	16+45.05	25.31′ RT	822.99	823.57	-
132	SR 2085 BIRMINGHAM BRIDGE	POC	16+54.22	24.56′ RT	822.36	822.93	-
133	SR 2085 BIRMINGHAM BRIDGE	POC	16+63.37	23.66′ RT	821.85	822.43	-
134	SR 2085 BIRMINGHAM BRIDGE	POC	16+72.51	22.60' RT	821.40	821.99	-
135	SR 2085 BIRMINGHAM BRIDGE	PRC	16+79.54	21.68′ RT	821.29	821.87	-
136	SR 2085 BIRMINGHAM BRIDGE	POC	16+89.17	23.59' RT	821.48	*	-
137	FIFTH AVE	POC	492+04.39	15.84′ RT	821.68	*	-
138	FIFTH AVE	PT	492+13.17	13.00′ RT	821.86	*	-
139	FIFTH AVE	POT	492+23.17	13.00′ RT	822.26	*	-
140	FIFTH AVE	POT	492+33.17	13.00' RT	822.65	823.24	-
141	FIFTH AVE	POT	492+43.17	13.00′ RT	823.05	823.63	-
142	FIFTH AVE	-	492+43.17	28.67′ RT	-	-	823.78
143	FIFTH AVE	-	492+33.17	28.67′ RT	-	-	823.39
144	FIFTH AVE	PC	492+21.52	28.67′ RT	-	-	822.54
145	SR 2085 BIRMINGHAM BRIDGE	PT	16+74.14	38.23′ RT	822.20	822.78	-
146	SR 2085 BIRMINGHAM BRIDGE	POT	16+67.68	38.20' RT	[822.21]	822.79	-
147	SR 2085 BIRMINGHAM BRIDGE	POT	16+61.26	38.17′ RT	[822.45]	[822.80]	-
148	SR 2085 BIRMINGHAM BRIDGE	PC	16+84.45	25.40′ RT	821.90	822.40	-
149	SR 2085 BIRMINGHAM BRIDGE	ΡŤ	16+79.57	29.16' RT	822.02	822.61	-
150	SR 2085 BIRMINGHAM BRIDGE	POT	16+70.57	29.11' RT	822.02	822.60	-
151	SR 2085 BIRMINGHAM BRIDGE	POT	16+61.57	29.05′ RT	822.03	822.62	-
152	SR 2085 BIRMINGHAM BRIDGE	POT	16+52.57	28.99' RT	822.52	823.10	-
153	SR 2085 BIRMINGHAM BRIDGE	POT	16+43.57	28.94′ RT	823.12	823.70	-
154	SR 2085 BIRMINGHAM BRIDGE	PC	16+35.94	28.89' RT	823.58	824.11	-

[] MATCH EXISTING ELEVATION

**AECOM** Gulf Tower 707 Grant Street 5th Floor Pittsburgh, PA 15219

		THE PREPARATION OF THIS DOCUMENT HAS BEEN FINANCED IN	
		PART THROUGH A GRANT FROM THE	
		FEDERAL TRANSIT ADMINISTRATION, U.S. DEPARTMENT OF	
		TRANSPORTATION, UNDER THE	
		URBAN MASS TRANSPORTATION ACT OF 1964, AS AMENDED, FOR THE	
DATE		PORT AUTHORITY OF ALLEGHENY COUNTY, PENNSYLVANIA.	
	REVISIONS	COUNTY, PENNSTEVANIA.	

(NOT FOR CONSTRUCTION)

DESIGNED	MJ <u>P/A</u> GO	
DRAWN	<u>JBM</u>	
CHECKED	BFS	
IN CHARGE	<u>LAR</u>	
DATE	05/01/24	
SCALE		
	AS SHOWN	

PORT AUTHORITY OF ALLEGHENY COUNTY
PITTSBURGH PENNSYLVANIA
BUS RAPID TRANSIT UPTOWN TO OAKLAND
INTERSECTION DATA
1 FIETH AVE & KIDKDATDICK CT/DIDMINICHAM DD

FIFTH AVE & KIRKPATRICK ST/BIRMINGHAM BR

Port	Authority	CONTRACT NO. BRT-00	)1	
	connecting people to life	DWG. NO.   D31	SHT.	207

**AECOM** 

Gulf Tower 707 Grant Street 5th Floor Pittsburgh, PA 15219

THE PREPARATION OF THIS
DOCUMENT HAS BEEN FINANCED IN
PART THROUGH A GRANT FROM THE
FEDERAL TRANSIT ADMINISTRATION,
U.S. DEPARTMENT OF
TRANSPORTATION, UNDER THE
URBAN MASS TRANSPORTATION ACT
OF 1964, AS AMENDED, FOR THE
PORT AUTHORITY OF ALLEGHENY
COUNTY, PENNSYLVANIA. NO. DATE DESCRIPTION REVISIONS

(NOT FOR CONSTRUCTION)

20 FEET

DESIGNED	MJ <u>P/A</u> GO	
DRAWN	<u>JBM</u>	
CHECKED	BFS	
N CHARGE	LAR	
DATE	05/01/24	
SCALE	40.01101441	
	AS SHOWN	

### FOR ROADWAY PLAN SEE SHEET 371 PORT AUTHORITY OF ALLEGHENY COUNTY PENNSYLVANIA

sнт. 208

BUS RAPID TRANSIT UPTOWN TO OAKLAND INTERSECTION DETAILS FIFTH AVE & BLVD OF THE ALLIES RAMP

Port	Authority	CONTRACT NO. BRT-00	)1
·	connecting people to life	DWC NO ID22	СП

	SOUTHWEST QUADRANT										
POINT NUMBER	BASEL INE	POINT	STATION	OFFSET	ELEVATION BOTTOM OF CURB	ELEVATION TOP OF CURB	ELEVATION BACK OF SIDEWALK				
1	SR 8119 BLVD OF THE ALLIES RAMP	PC	11+07.01	13.56′ LT	[891.44]	[891.94]	-				
2	SR 8119 BLVD OF THE ALLIES RAMP	POC	11+19.97	13.70′ LT	[892.02]	892.52					
3	SR 8119 BLVD OF THE ALLIES RAMP	POC	11+35.44	13.66′ LT	[892.92]	893.42	-				
4	SR 8119 BLVD OF THE ALLIES RAMP	PRC	11+50.69	12.21'LT	893.09	893.59	-				
5	SR 8119 BLVD OF THE ALLIES RAMP	POC	11+60.13	11.40'LT	893.31	893.81	-				
6	SR 8119 BLVD OF THE ALLIES RAMP	PT	11+67.49	12.24′ LT	893.52	*	-				
7	SR 8119 BLVD OF THE ALLIES RAMP	POT	11+73.20	13.98'LT	893.79	*	-				
8	SR 8119 BLVD OF THE ALLIES RAMP	PC	11+78.92	15.71′LT	893.83	*	-				
9	FIFTH AVE	PT	509+89.75	12.00' RT	893.72	*	-				
10	FIFTH AVE	POC	509+80.05	12.00' RT	893.31	893.89	-				
11	FIFTH AVE	POC	509+70.36	12.00' RT	892.92	893.50	-				
12	FIFTH AVE	POC	509+60.67	12.00' RT	892.47	893.06	-				
13	FIFTH AVE	-	509+60.67	26.50' RT	-	-	893.19				
14	FIFTH AVE	-	509+70.36	26.50' RT	-	-	893.64				
15	FIFTH AVE	-	509+80.06	26.50' RT	-	-	894.03				

		S	OUTHEAST	QUADRAN	IT		
POINT NUMBER	BASEL INE	POINT	STATION	OFFSET	ELEVATION BOTTOM OF CURB	ELEVATION TOP OF CURB	ELEVATION BACK OF SIDEWALK
30	SR 8119 BLVD OF THE ALLIES RAMP	PC	11+76.44	15.31' RT	895.12	895.69	-
31	SR 8119 BLVD OF THE ALLIES RAMP	POC	11+85.61	19.25′ RT	895.50	*	_
32	FIFTH AVE	POC	510+33.29	15.83' RT	895.85	*	-
33	FIFTH AVE	POC	510+42.46	12.83' RT	896.25	*	-
34	FIFTH AVE	PRC	540+50.72	12.00' RT	896.61	897.19	-
35	FIFTH AVE	POC	510+60.41	12.00' RT	897.04	897.63	-
36	FIFTH AVE	POC	510+70.10	12.00' RT	897.49	898.07	-
37	FIFTH AVE	POC	510+79.79	12.00' RT	897.96	898.54	-
38	FIFTH AVE	-	510+79.79	27.67′ RT	-	-	898.69
39	FIFTH AVE	-	510+70.10	27.67′ RT	-	-	898.23
40	FIFTH AVE	-	510+60.41	27.67′ RT	-	-	897.78
41	FIFTH AVE	-	510+50.72	15.67' RT	-	-	897.34
42	FIFTH AVE	-	510+39.95	13.62′ RT	-	-	896.29
43	FIFTH AVE	-	510+29.08	27.67′ RT	-	_	895.78

**AECOM** Gulf Tower 707 Grant Street 5th Floor Pittsburgh, PA 15219

THE PREPARATION OF THIS

DOCUMENT HAS BEEN FINANCED IN
PART THROUGH A GRANT FROM THE
FEDERAL TRANSIT ADMINISTRATION,
U.S. DEPARTMENT OF
TRANSPORTATION, UNDER THE
URBAN MASS TRANSPORTATION ACT
OF 1964, AS AMENDED, FOR THE
PORT AUTHORITY OF ALLEGHENY
COUNTY, PENNSYLVANIA. NO. DATE DESCRIPTION REVISIONS

(NOT FOR CONSTRUCTION)

DESIGNED	MJ <u>P/A</u> GO	
DRAWN	<u>JBM</u>	
CHECKED	<u>BFS</u>	
IN CHARGE	LAR	
DATE	05/01/24	
SCALE		
	AS SHOWN	

PORT AUTHORITY OF ALLEGHENY COUNTY PITTSBURGH PENNSYLVANIA

BUS RAPID TRANSIT UPTOWN TO OAKLAND INTERSECTION DATA FIFTH AVE & BLVD OF THE ALLIES RAMP

Port Authority connecting people to life

CONTRACT NO. BRT-001 DWG. NO. D33 sнт. 209

**AECOM** 

Gulf Tower 707 Grant Street 5th Floor Pittsburgh, PA 15219

NO. DATE DESCRIPTION REVISIONS

THE PREPARATION OF THIS
DOCUMENT HAS BEEN FINANCED IN
PART THROUGH A GRANT FROM THE
FEDERAL TRANSIT ADMINISTRATION,
U.S. DEPARTMENT OF
TRANSPORTATION, UNDER THE
URBAN MASS TRANSPORTATION ACT
OF 1964, AS AMENDED, FOR THE
PORT AUTHORITY OF ALLEGHENY
COUNTY, PENNSYLVANIA.

(NOT FOR CONSTRUCTION)

ESIGNED	MJ <u>P/A</u> GO	
DRAWN	<u>JBM</u>	
CHECKED	BFS	
N CHARGE	LAR	
ATE	05/01/24	
CALE		
	AS SHOWN	

PORT AUTHORITY OF ALLEGHENY COUNTY PENNSYLVANIA BUS RAPID TRANSIT UPTOWN TO OAKLAND INTERSECTION DETAILS FIFTH AVE & CRAFT AVE

Port Authority connecting people to life CONTRACT NO. BRT-001 ID34 sнт. 210 DWG. NO.

				NORTH			
POINT NUMBER	BASEL INE	POINT	STATION	OFFSET	ELEVATION BOTTOM OF CURB	ELEVATION TOP OF CURB	ELEVATION BACK OF SIDEWALK
40	FIFTH AVE	POT	518+36.44	21.37′ LT	[926.28]	[926.62]	-
41	FIFTH AVE	POT	518+46.99	21.57′ LT	[926.75]	[927.27]	-
42	FIFTH AVE	-	518+46.85	29.34′ LT	-	-	[ 927. 47]
43	FIFTH AVE	-	518+36.15	29.08' LT	-	-	[927.13]

71 72 73 74 75	BASEL INE CRAFT AVE CRAFT AVE CRAFT AVE CRAFT AVE CRAFT AVE CRAFT AVE FIFTH AVE FIFTH AVE	POINT POT POT POT POT POT POT POT POT PC POC	STATION  20+17.94  20+20.44  20+30.44  20+40.44  20+50.44	0FFSET 0.00' RT 0.00' RT 0.00' RT 0.00' RT	ELEVATION BOTTOM OF CURB [925.17] 925.64 926.23	ELEVATION TOP OF CURB [925.74] 925.93	ELEVATION BACK OF SIDEWALK -
71 72 73 74 75	CRAFT AVE CRAFT AVE CRAFT AVE CRAFT AVE CRAFT AVE FIFTH AVE	POT POT POT POT PC	20+20.44 20+30.44 20+40.44	0.00' RT 0.00' RT	925.64	925.93	
72 73 74 75	CRAFT AVE CRAFT AVE CRAFT AVE CRAFT AVE FIFTH AVE	POT POT POT PC	20+30.44 20+40.44	0.00' RT			-
73 74 75	CRAFT AVE CRAFT AVE CRAFT AVE FIFTH AVE	POT POT PC	20+40.44		926.23	926 70	
74 75	CRAFT AVE CRAFT AVE FIFTH AVE	POT PC		0.00' RT		926.70	-
75	CRAFT AVE	PC	20+50.44		926.61	926.97	-
	FIFTH AVE			0.00' RT	926.82	*	-
76		POC	20+54.26	0.00' RT	926.90	*	-
	FIFTH AVE	1 00	000+15.90	0.00' RT	926.77	*	-
77		PRC	518+31.57	1.39′ RT	926.41	927.00	-
78	FIFTH AVE	POC	518+21.61	1.54′ RT	926.03	926.62	-
79	FIFTH AVE	POC	518+11.65	1.70′ RT	925.62	926.20	-
80	FIFTH AVE	POC	518+01.68	1.86′ RT	925.20	925.79	-
81	FIFTH AVE	POC	517+91.73	2.03' RT	924.80	925.39	-
82	FIFTH AVE	POC	517+81.78	2.21' RT	924.36	924.95	-
83	FIFTH AVE	POC	517+71.84	2.40' RT	923.94	924.52	-
84	FIFTH AVE	PRC	517+68.00	2.47′ RT	923.76	924.36	-
85	FIFTH AVE	POC	517+58.08	3.11' RT	923.34	923.93	-
86	FIFTH AVE	POC	517+48.20	4.55′ RT	922.90	923.49	-
87	FIFTH AVE	-	517+52.51	28.44′ RT	-	-	923.92
88	FIFTH AVE	-	517+60.66	28.37′ RT	-	-	924.29
89	FIFTH AVE	-	517+68.47	28.30' RT	-	-	924.63
90	FIFTH AVE	-	517+72.29	28.26′ RT	-	-	924.79
91	FIFTH AVE	-	517+82.23	28.17′ RT	-	-	925.22
92	FIFTH AVE	-	517+92.16	28.09' RT	-	-	925.66
93	FIFTH AVE	-	518+02.10	28.02' RT	-	-	926.06
94	FIFTH AVE	-	518+12.05	27.96′ RT	-	-	926.47
95	FIFTH AVE	-	518+21.99	28.20' RT	-	-	926.89
96	FIFTH AVE	-	518+30.18	27.86′ RT	-	-	927.21
97	FIFTH AVE	-	518+39.74	27.83′ RT	-	-	927.44
98	FIFTH AVE	-	518+46.98	30.05′ RT	-	-	927.25
99	CRAFT AVE	-	20+31.51	22.59' RT	-	-	926.84
100	CRAFT AVE	-	20+30.36	22.58′ RT	-	-	926.77
101	CRAFT AVE	-	20+19.97	22.49' RT	-	-	926.0000
102	CRAFT AVE	-	20+17.92	22.47′ RT	-	-	[925.84]


	SOUTHEAST QUADRANT										
POINT NUMBER	BASELINE	POINT	STATION	OFFSET	ELEVATION BOTTOM OF CURB	ELEVATION TOP OF CURB	ELEVATION BACK OF SIDEWALK				
20	CRAFT AVE	POT	19+83.48	15.00' RT	[924.01]	[ 924. 26]	-				
21	CRAFT AVE	POT	19+91.81	14.99' RT	924.77	925.10	-				
22	CRAFT AVE	PC	20+01.81	14.97′ RT	925.77	926.10	-				
23	CRAFT AVE	POC	20+11.40	17.40' RT	926.76	927.09	-				
24	FIFTH AVE	POC	518+96.75	29.59' RT	927.69	*	-				
25	FIFTH AVE	POC	519+04.13	23.48′ RT	928.34	*	-				
26	FIFTH AVE	PRC	519+11.29	21.91′ RT	928.78	*	-				
27	FIFTH AVE	POC	519+20.83	21.88′ RT	929.22	929.55	-				
28	FIFTH AVE	POC	519+25.51	21.86′ RT	[929.41]	[929.72]	-				
29	FIFTH AVE	-	519+26.85	26.90' RT	-	-	[929.82]				
30	FIFTH AVE	-	519+20.84	26.87′ RT	-	-	[929.36]				
31	FIFTH AVE	-	519+20.84	30.64′ RT	-	-	[928.61]				
32	FIFTH AVE	-	519+06.03	37.27′ RT	-	-	[927.61]				
33	CRAFT AVE	-	20+01.83	26.42′ RT	-	-	[ 926. 72]				
34	CRAFT AVE	-	19+91.79	24.55′ RT	-	-	[ 925. 59]				
35	CRAFT AVE	-	19+83.49	24.53′ RT	-	-	[ 925. 04]				

[] MATCH EXISTING ELEVATION

**AECOM** Gulf Tower 707 Grant Street 5th Floor Pittsburgh, PA 15219

		THE PREPARATION OF THIS DOCUMENT HAS BEEN FINANCED IN PART THROUGH A GRANT FROM THE
		FEDERAL TRANSIT ADMINISTRATION, U.S. DEPARTMENT OF TRANSPORTATION, UNDER THE
		URBAN MASS TRANSPORTATION ACT OF 1964, AS AMENDED, FOR THE
DATE	DESCRIPTION	PORT AUTHORITY OF ALLEGHENY COUNTY, PENNSYLVANIA.
	REVISIONS	COUNTY, FEMINSTEVANIA.

ESIGNED	MJ <u>P/A</u> GO	PORT AUTHOR	ITY OF ALL	EGHENY COL	JNT	1
RAWN	<u>JBM</u>	PITTSBURGH		PENNS	SYLVANI	4
HECKED	BFS	BUS RAPID TE	RANSIT UPTO	WN TO OAKLA	√ND	
CHARGE	<u>LAR</u>		ITERSECTION [			
ATE	<u>05/01/24</u>	FIF	TH AVE & CRAF	FT AVE		
CALE	AS SHOWN	Port Authority	CONTRA	CT NO. BRT-00	)1	
	AO ONOWN	connecting people to life	DWG. NO.	ID35	SHT.	211

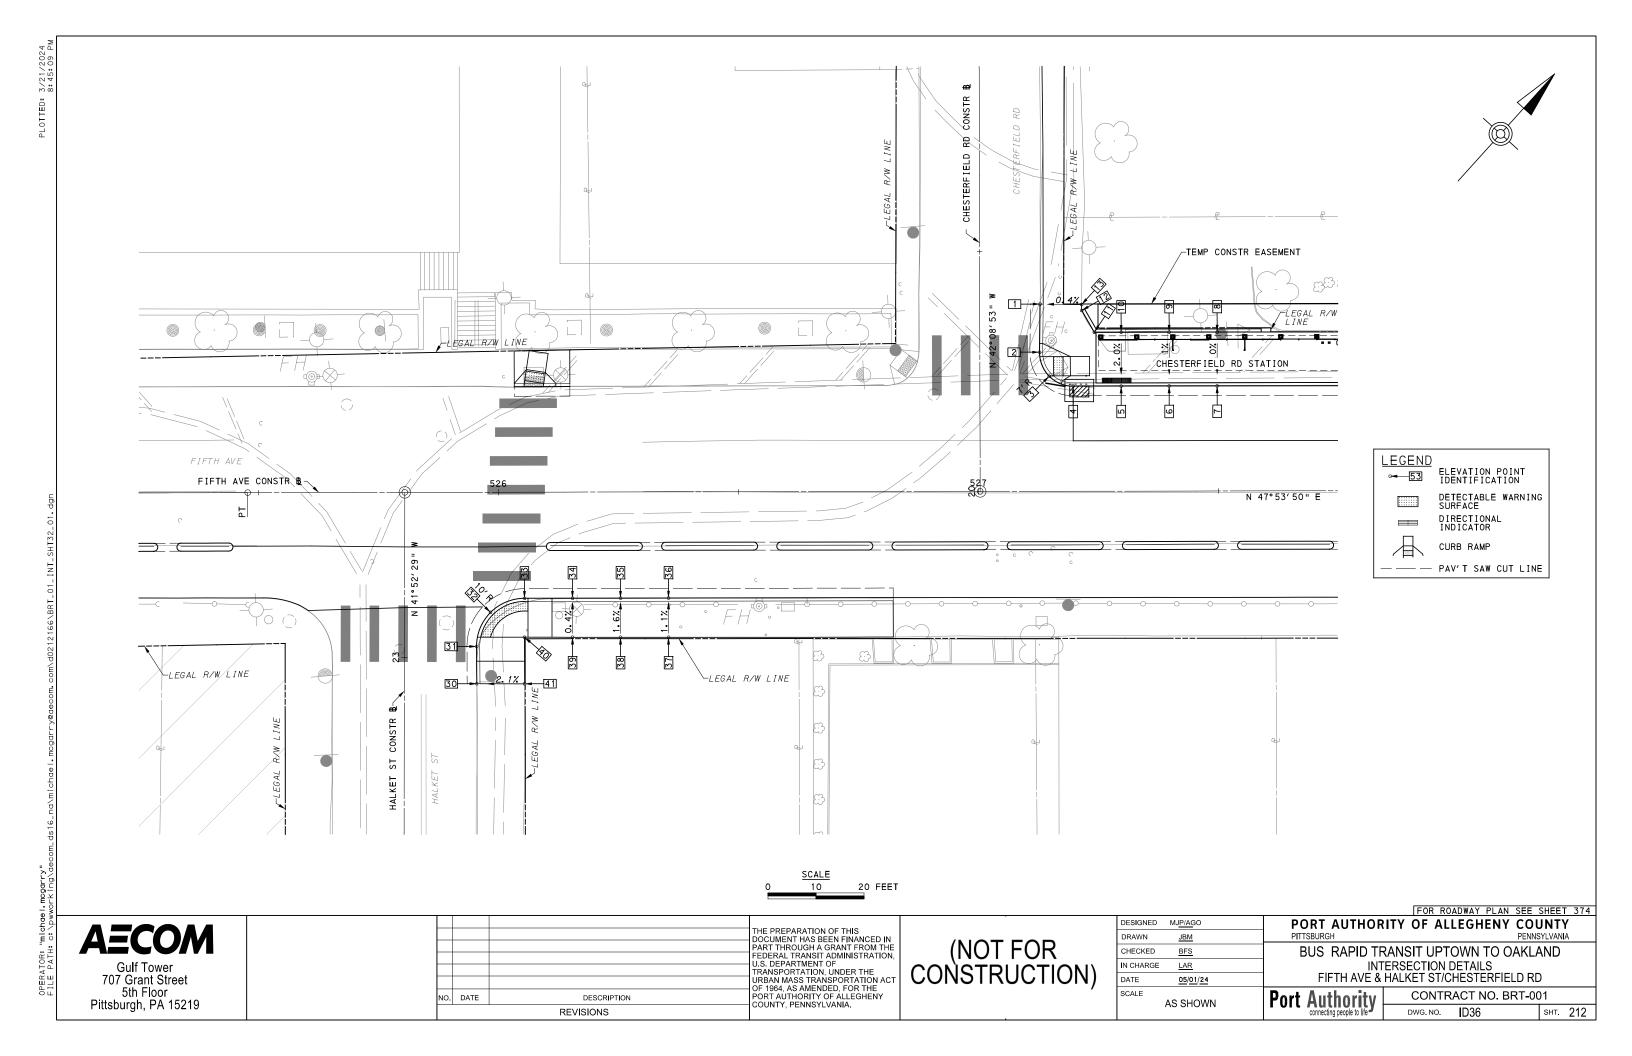

NORTHEAST QUADRANT										
POINT NUMBER	BASEL INE	POINT	STATION	OFFSET	ELEVATION BOTTOM OF CURB	ELEVATION TOP OF CURB	ELEVATION BACK OF SIDEWALK			
1	CHESTERFIELD RD	POT	20+38.99	12.57′ RT	[ 933. 68]	[ 934. 19]	-			
2	CHESTERFIELD RD	PC	20+28.97	12.43′ RT	[ 932. 77]	*	-			
3	FIFTH AVE	POC	527+14.82	23.94′ LT	[932.27]	*	-			
4	FIFTH AVE	PT	527+19.80	21.89' LT	[ 932, 22]	932.80	-			
5	FIFTH AVE	POT	527+29.80	21.89' LT	932.27	932.86	-			
6	FIFTH AVE	POT	527+39.80	21.89' LT	[932.35]	932.93	-			
7	FIFTH AVE	POT	527+49.80	21.89' LT	[ 932. 45]	933.03	-			
8	FIFTH AVE	-	527+49.80	33.11′ LT	-	-	933.24			
9	FIFTH AVE	-	527+39.80	33.11′ LT	-	-	933.15			
10	FIFTH AVE	-	527+29.80	33.11′ LT	-	-	933.07			
11	FIFTH AVE	-	527+24.22	33.11′ LT	-	-	933.51			
12	CHESTERFIELD RD	-	20+37.76	21.21' RT	-	-	934.33			
13	CHESTERFIELD RD	-	20+38.87	21.22' RT	-	-	[ 934. 22]			

	SOUTHEAST QUADRANT										
POINT NUMBER	BASELINE	POINT	STATION	OFFSET	ELEVATION BOTTOM OF CURB	ELEVATION TOP OF CURB	ELEVATION BACK OF SIDEWALK				
30	HALKET ST	POT	22+94.55	15.07' RT	[ 930. 61]	[931.12]	-				
31	HALKET ST	PC	23+02.30	15.02' RT	[ 930. 95]	931.28	-				
32	FIFTH AVE	POC	525+98.34	25.04′ RT	[931.24]	*	-				
33	FIFTH AVE	PT	526+05.42	22.11' RT	[931.27]	*	-				
34	FIFTH AVE	POT	526+15.42	22.11' RT	[931.35]	931.68	-				
35	FIFTH AVE	POT	526+25.42	22.11' RT	[931.44]	931.77	-				
36	FIFTH AVE	POT	526+35.42	22.11' RT	[931.53]	931.88	-				
37	FIFTH AVE	-	526+35.42	30.28′ RT	-	-	[931.96]				
38	FIFTH AVE	-	526+25.42	30.26′ RT	-	-	[931.89]				
39	FIFTH AVE	-	526+15.42	30.25′ RT	-	-	[931.71]				
40	FIFTH AVE	-	526+05.40	30.23′ RT	-	-	[931.51]				
41	HALKET ST	-	22+94.55	25.04′ RT	-	-	[931.30]				

sнт. 213

[] MATCH EXISTING ELEVATION


**AECOM** Gulf Tower 707 Grant Street 5th Floor Pittsburgh, PA 15219

i l		
		THE PREPARATION OF THIS DOCUMENT HAS BEEN FINANCED IN
		PART THROUGH A GRANT FROM TH
		FEDERAL TRANSIT ADMINISTRATION U.S. DEPARTMENT OF
		TRANSPORTATION, UNDER THE
		URBAN MASS TRANSPORTATION AC OF 1964, AS AMENDED, FOR THE
DATE	DESCRIPTION	PORT AUTHORITY OF ALLEGHENY COUNTY, PENNSYLVANIA.
	REVISIONS	COUNTY, FERNISTEVANIA.

DESIGNED	MJ <u>P/A</u> GO	Γ
DRAWN	<u>JBM</u>	L
CHECKED	BFS	
IN CHARGE	LAR	
DATE	05/01/24	
SCALE		Γ
	AS SHOWN	

MJ <u>P/A</u> GO	PORT AUTHORITY OF ALLEGHENY COUNTY
<u>JBM</u>	PITTSBURGH PENNSYLVANIA
BFS	BUS RAPID TRANSIT UPTOWN TO OAKLAND
LAR	INTERSECTION DATA
05/01/24	FIFTH AVE & HALKET ST/CHESTERFIELD RD

	INTERSECTION DATA FIFTH AVE & HALKET ST/CHESTERFIELD RD					
	Port	Authority	CONTRA	ACT NO. BRT-00	)1	
	. 010	connecting people to life	DWG. NO.	ID37	SHT	

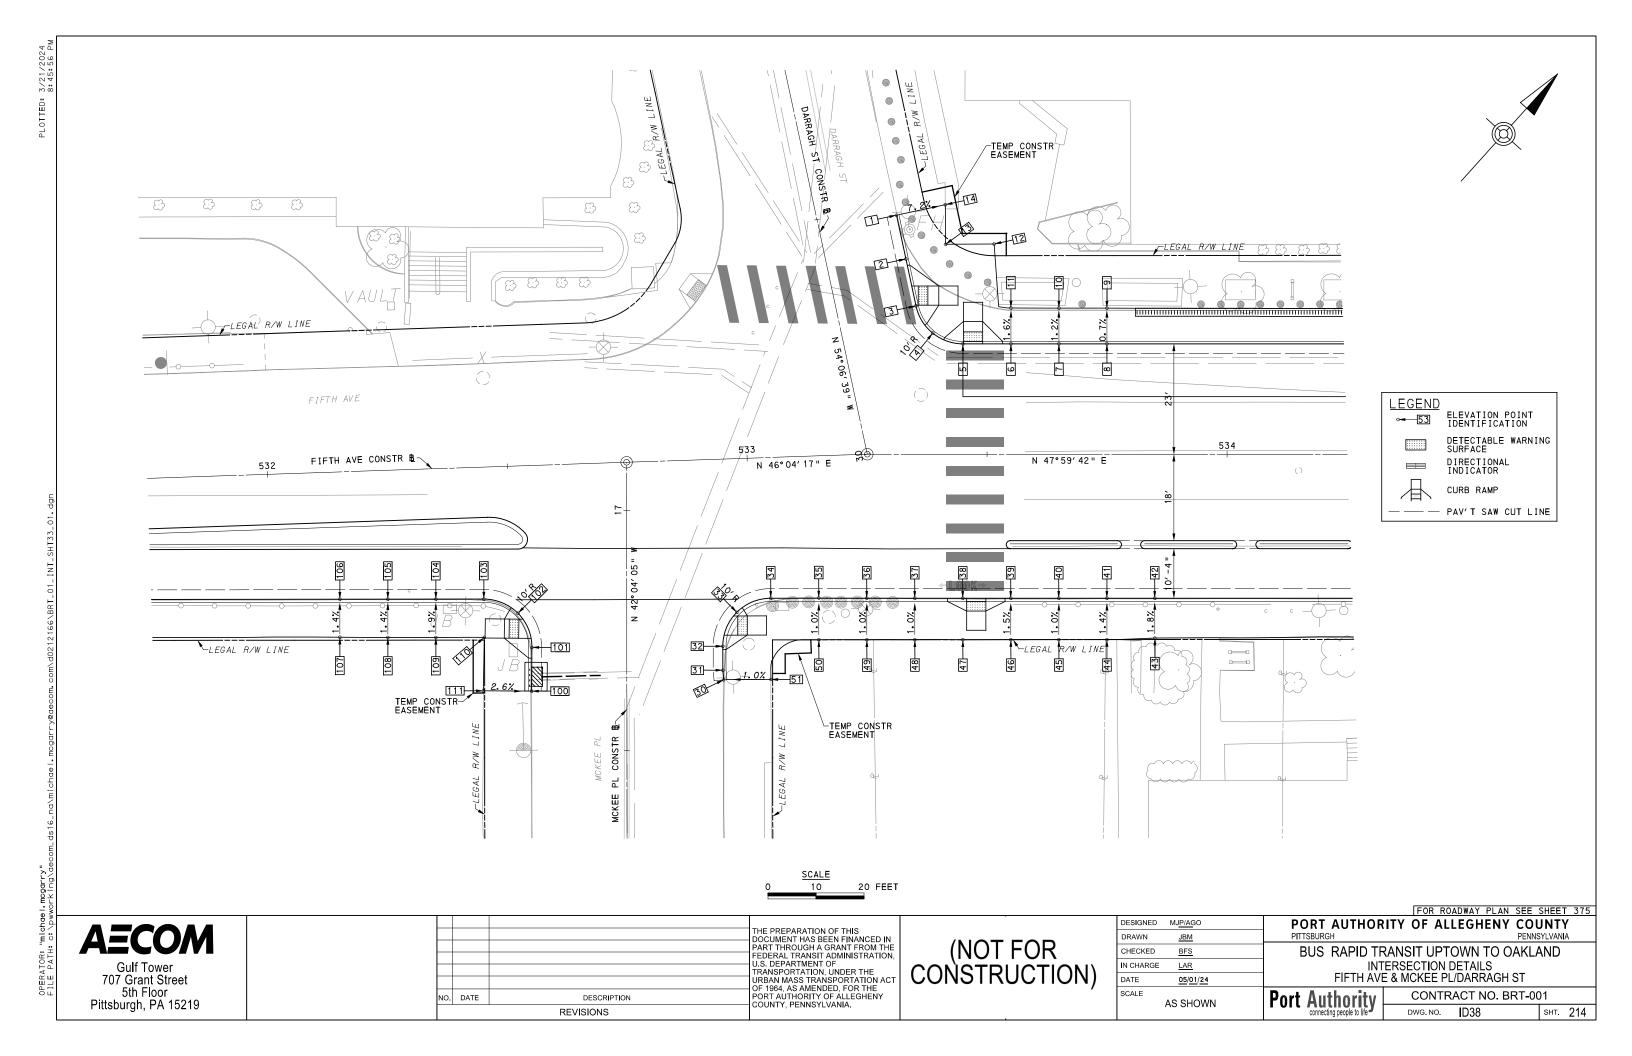

SOUTHWEST QUADRANT							
POINT NUMBER	BASELINE	POINT	STATION	OFFSET	ELEVATION BOTTOM OF CURB	ELEVATION TOP OF CURB	ELEVATION BACK OF SIDEWALK
100	MCKEE PL	POT	16+62.37	19.84'LT	[929.13]	[929.63]	-
101	MCKEE PL	PC	16+71.48	19.77′LT	[929.77]	*	-
102	FIFTH AVE	POC	532+51.19	30.67′ RT	[930.28]	*	-
103	FIFTH AVE	PT	532+44.19	27.49' RT	[ 930, 37]	930.71	-
104	FIFTH AVE	POT	532+34.20	27.17′ RT	930.51	930.92	-
105	FIFTH AVE	POT	532+24.20	26.84′ RT	930.66	931.05	-
106	FIFTH AVE	POT	532+14.21	26.51' RT	930.77	931.16	-
107	FIFTH AVE	POT	532+13.94	34.43′ RT	-	-	[931.26]
108	FIFTH AVE	POT	532+23.94	34.81′RT	-	=	[ 931. 15]
109	FIFTH AVE	POT	532+33.93	35.14′ RT	-	-	[931.06]
110	FIFTH AVE	-	532+44.02	35.46′ RT	-	-	[ 930. 76]
111	MCKEE PL	-	000+22.58	29.85' LT	-	_	[ 930. 03]

NORTHEAST QUADRANT							
					ELEVATION BOTTOM OF CURB	ELEVATION TOP OF CURB	ELEVATION BACK OF SIDEWALK
1	DARRAGH ST	POT	30+47.41	16.39' RT	[ 931. 10]	[931.54]	-
2	DARRAGH ST	POT	30+38.09	16.39' RT	[ 930. 52]	930.96	-
3	DARRAGH ST	PC	30+28.09	16.39' RT	[ 930. 17]	*	-
4	FIFTH AVE	POC	553+38.68	25.22′ RT	[929.94]	930.38*	_
5	FIFTH AVE	PŤ	533+44.97	23.00' LT	[929.78]	*	-
6	FIFTH AVE	POT	533+54.97	23.00' LT	[929.59]	930.03	-
7	FIFTH AVE	POT	533+64.97	23.00' LT	[929.41]	929.85	-
8	FIFTH AVE	POT	533+74.97	23.00' LT	[929.24]	929.68	-
9	FIFTH AVE	-	533+74.97	30.43′LT	-	-	[929.62]
10	FIFTH AVE	-	533+64.97	30.44′ LT	-	-	[929.76]
11	FIFTH AVE	-	533+54.97	30.45′LT	-	-	[929.92]
12	DARRAGH ST	-	30+37.28	35.02'LT	-	-	[930.21]
13	DARRAGH ST	-	30+39.34	25.11'LT	-	-	[ 930. 40]
14	DARRAGH ST	-	30+47.41	26.78'LT	-	-	[ 930. 77]

SOUTHEAST QUADRANT							
POINT NUMBER	BASEL INE	POINT	STATION	OFFSET	ELEVATION BOTTOM OF CURB	ELEVATION TOP OF CURB	ELEVATION BACK OF SIDEWALK
30	MCKEE PL	POT	16+64.69	20.18' RT	[928.94]	[ 929. 50]	-
31	MCKEE PL	PI	16+66.69	20.00' RT	[929.11]	929.53	-
32	MCKEE PL	PC	16+71.68	20.00' RT	[929.51]	929.93	-
33	FIFTH AVE	POC	532+96.78	32.00′ RT	[929.81]	*	-
34	FIFTH AVE	PT	533+03.94	29.31' RT	[929.86]	930.28	-
35	FIFTH AVE	POT	533+13.90	29.64′ RT	929.84	930.26	-
36	FIFTH AVE	POT	533+23.93	29.98′ RT	929.79	930.21	-
37	FIFTH AVE	POT	533+34.94	30.00' RT	929.74	930.16	-
38	FIFTH AVE	POT	533+44.94	30.00' RT	929.68	*	-
39	FIFTH AVE	POT	533+54.94	30.00' RT	929.52	929.94	-
40	FIFTH AVE	POT	533+64.94	30.00′ RT	929.38	929.80	-
41	FIFTH AVE	POT	533+74.94	30.00' RT	929.24	929.67	-
42	FIFTH AVE	POT	533+84.94	30.00' RT	929.11	929.53	-
43	FIFTH AVE	-	533+84.94	38.29' RT	-	-	[929.67]
44	FIFTH AVE	-	533+74.94	38.63′ RT	-	-	[929.78]
45	FIFTH AVE	-	533+64.94	38.64′ RT	-	-	[929.88]
46	FIFTH AVE	-	533+54.94	38.69' RT	-	-	[ 930. 16]
47	FIFTH AVE	-	533+44.94	38.68′ RT	-	-	[ 930. 18]
48	FIFTH AVE	-	533+34.94	38.64′ RT	-	-	[930.24]
49	FIFTH AVE	-	533+23.66	38.63′ RT	-	-	[ 930. 29]
50	FIFTH AVE	-	533+13.90	38.29′ RT	-	-	[930.34]
51	MCKEE PL	-	000+00.00	9.76′ RT	-	-	[929.59]

[] MATCH EXISTING ELEVATION

<b>AECOM</b>
Gulf Tower 707 Grant Street
5th Floor
Pittsburgh, PA 15219

		THE PREPARATION OF THIS DOCUMENT HAS BEEN FINANCED IN
		PART THROUGH A GRANT FROM THE
		FEDERAL TRANSIT ADMINISTRATION, U.S. DEPARTMENT OF
		TRANSPORTATION, UNDER THE
		URBAN MASS TRANSPORTATION ACT OF 1964. AS AMENDED. FOR THE
DATE	DESCRIPTION	PORT AUTHORITY OF ALLEGHENY COUNTY, PENNSYLVANIA.
	REVISIONS	COUNTY, PENNSTEVANIA.


(NOT FOR CONSTRUCTION)

DESIGNED	MJ <u>P/A</u> GO	
DRAWN	<u>JBM</u>	
CHECKED	BFS	
IN CHARGE	LAR	
DATE	<u>05/01/24</u>	
SCALE		
	AS SHOWN	

# PORT AUTHORITY OF ALLEGHENY COUNTY PENNSYLVANIA

BUS RAPID TRANSIT UPTOWN TO OAKLAND
INTERSECTION DATA
FIFTH AVE & MCKEE PL/DARRAGH ST

Port Authority connecting people to life CONTRACT NO. BRT-001 DWG. NO. D39 sнт. 215

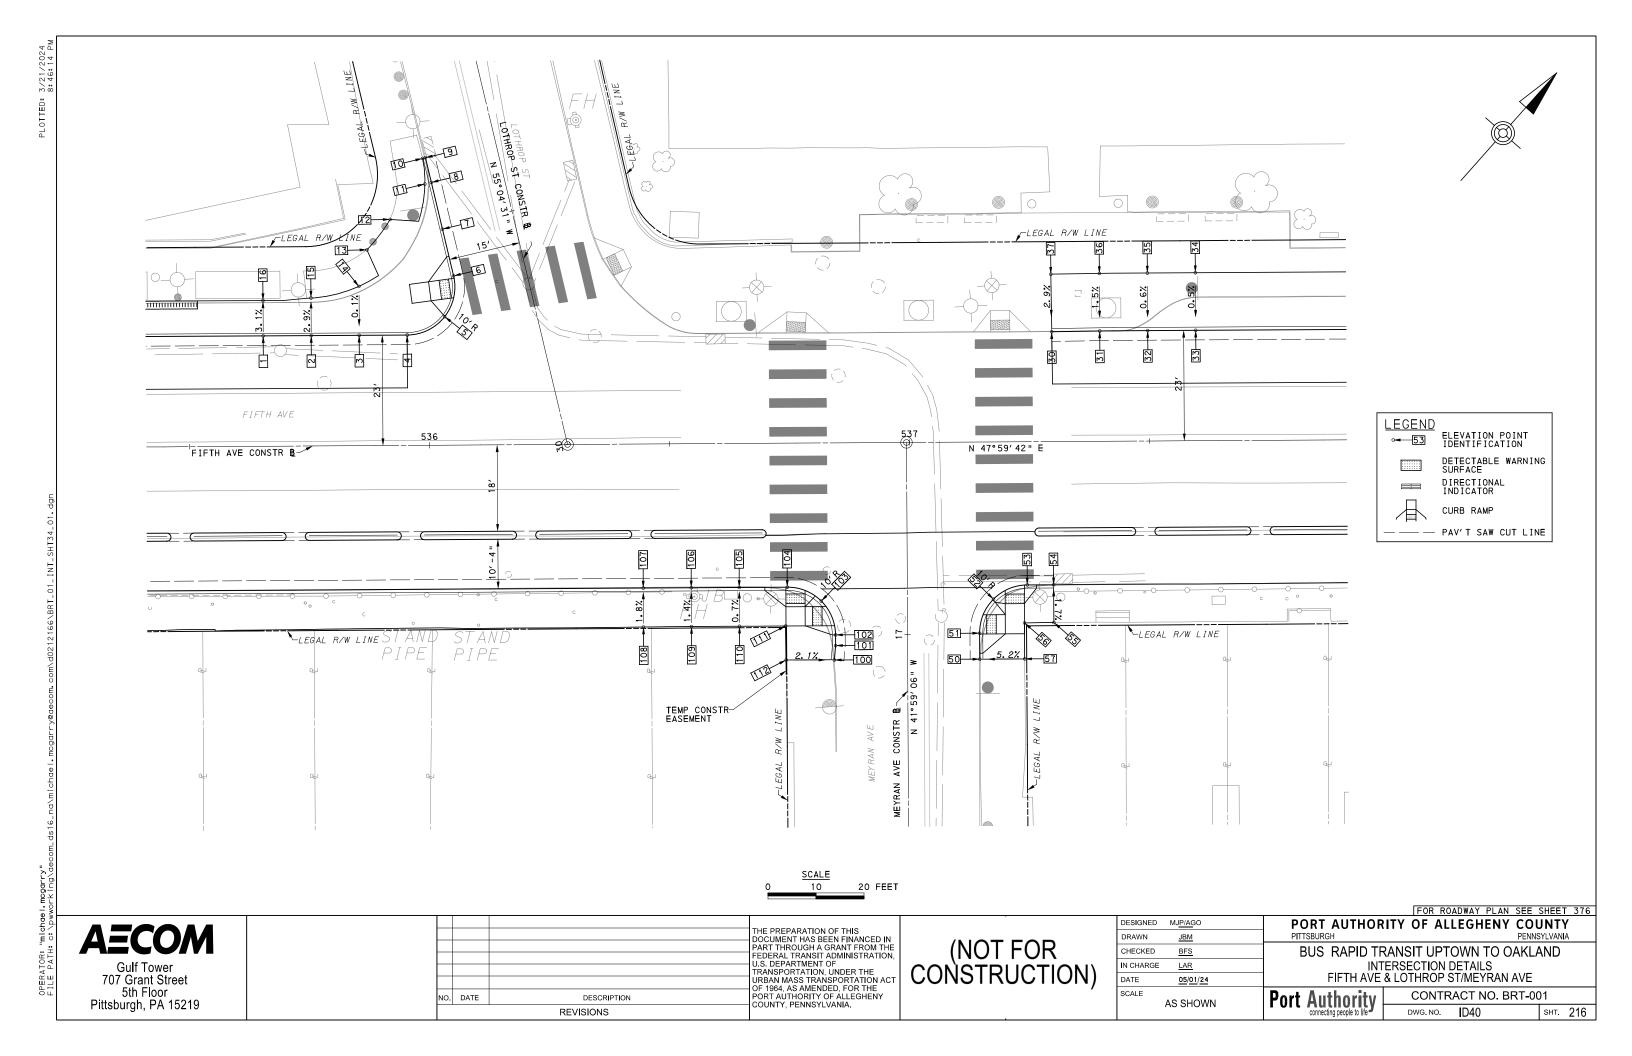

	NORTHWEST QUADRANT								
POINT NUMBER	BASEL INE	POINT	STATION	OFFSET	ELEVATION BOTTOM OF CURB	ELEVATION TOP OF CURB	ELEVATION BACK OF SIDEWALK		
1	FIFTH AVE	POT	535+65.48	23.00′ LT	[928.92]	929.36	-		
2	FIFTH AVE	POT	535+75.48	23.00′ LT	[929.07]	929.51	-		
3	FIFTH AVE	POT	535+85.48	23.00′ LT	[929.20]	929.63	-		
4	FIFTH AVE	PC	535+95.48	23.00′ LT	[929.32]	929.90	-		
5	FIFTH AVE	POC	536+03.31	26.78′ LT	[929.42]	*	-		
6	LOTHROP ST	PT	30+39.67	14.96′ LT	[929.70]	*	-		
7	LOTHROP ST	POT	30+49.68	14.96′ LT	[ 930. 31]	930.89	-		
8	LOTHROP ST	POT	30+59.69	14.96′ LT	[931.23]	931.69	-		
9	LOTHROP ST	POT	30+64.98	14.96′ LT	[931.60]	[932.18]	-		
10	LOTHROP ST	-	30+64.98	15.57′ LT	-	-	[ 932. 18]		
11	LOTHROP ST	-	30+59.67	16.35′ LT	-	-	[931.71]		
12	LOTHROP ST	-	30+54.19	25.09' LT	-	-	[ 930• 47]		
13	LOTHROP ST	-	30+49.14	31.27′ LT	-	-	[ 929. 56]		
14	FIFTH AVE	-	535+85.48	33.18′ LT	-	-	[929.64]		
15	FIFTH AVE	-	535+75.48	30.83′ LT	-	-	[929.30]		
16	FIFTH AVE	-	535+65.48	30.36′ LT	-	-	[ 929. 15]		

	NORTHEAST QUADRANT							
POINT NUMBER	BASELINE	POINT	STATION	OFFSET	ELEVATION BOTTOM OF CURB	ELEVATION TOP OF CURB	ELEVATION BACK OF SIDEWALK	
30	FIFTH AVE	POT	537+29.75	22.87′LT	[ 930. 47]	[ 930. 80]	-	
31	FIFTH AVE	POT	537+39.75	22.97′LT	[ 930. 57]	931.02	-	
32	FIFTH AVE	POT	537+49.75	23.00′ LT	[ 930. 70]	931.16	-	
33	FIFTH AVE	POT	537+59.75	23.00′ LT	[ 930. 75]	[931.21]	-	
34	FIFTH AVE	-	537+59.75	35.00′ LT	-	-	[931.27]	
35	FIFTH AVE	-	537+49.75	35.00′ LT	-	-	[931.23]	
36	FIFTH AVE	-	537+39.75	34.97′LT	-	-	[931.19]	
37	FIFTH AVE	-	537+29.64	34.87′LT	-	-	[931.13]	

SOUTHWEST QUADRANT							
POINT BASELINE STATION OFFSET					ELEVATION BOTTOM OF CURB	ELEVATION TOP OF CURB	ELEVATION BACK OF SIDEWALK
100	MEYRAN AVE	POT	16+94.80	15.28' LT	[928.90]	[929.47]	-
101	MEYRAN AVE	PI	16+97.81	15.00' LT	[929.14]	929.72	-
102	MEYRAN AVE	PC	17+00.03	15.00' LT	[ 929. 29]	*	-
103	FIFTH AVE	POC	536+81.41	32.93′ RT	[929.67]	*	-
104	FIFTH AVE	PT	536+74.34	30.00′ RT	[929.84]	*	-
105	FIFTH AVE	POT	536+64.34	30.00' RT	929.74	930.24	-
106	FIFTH AVE	POT	536+54.34	30.00' RT	929.67	930.17	-
107	FIFTH AVE	POT	536+44.34	30.00' RT	[ 929. 53]	930.03	-
108	FIFTH AVE	-	536+44.34	38.14′ RT	-	-	[ 930. 16]
109	FIFTH AVE	-	536+54.34	38.09' RT	-	-	[ 930, 27]
110	FIFTH AVE	-	536+64.34	38.09' RT	-	-	[ 930. 29]
111	FIFTH AVE	-	536+73.97	38.09' RT	-	-	[ 930, 21]
112	MEYRAN AVE	-	16+94.87	25.31'LT	-	-	[929.69]

	SOUTHEAST QUADRANT							
POINT NUMBER	BASEL I NE	POINT	STATION	OFFSET	ELEVATION BOTTOM OF CURB	ELEVATION TOP OF CURB	ELEVATION BACK OF SIDEWALK	
50	MEYRAN AVE	POT	16+94.80	15.01' RT	[929.14]	[929.56]	-	
51	MEYRAN AVE	PC	17+00.21	15.01' RT	[929.47]	*	-	
52	FIFTH AVE	POC	537+17.28	32.76′ RT	[ 930. 02]	*	-	
53	FIFTH AVE	PT	537+24.35	29.83′ RT	[ 930. 38]	*	-	
54	FIFTH AVE	POT	537+29.84	29.83′ RT	[ 930. 16]	[ 930. 78]	-	
55	FIFTH AVE	-	537+29.84	37.70′ RT	-	-	[ 930. 89]	
56	FIFTH AVE	-	537+23.73	37.75′ RT	-	-	[ 930, 59]	
57	MEYRAN AVE	-	16+94.80	24.38′ RT	-	-	[ 930. 01]	

[] MATCH EXISTING ELEVATION

**AECOM** Gulf Tower 707 Grant Street 5th Floor Pittsburgh, PA 15219

		THE PREPARATION OF THIS DOCUMENT HAS BEEN FINANCED IN
		PART THROUGH A GRANT FROM THE
		FEDERAL TRANSIT ADMINISTRATION, U.S. DEPARTMENT OF
		TRANSPORTATION, UNDER THE
		URBAN MASS TRANSPORTATION ACT OF 1964, AS AMENDED, FOR THE
DATE		PORT AUTHORITY OF ALLEGHENY COUNTY, PENNSYLVANIA.
	DEVISIONS	COUNTY, PENNSTEVANIA.

(NOT FOR CONSTRUCTION)


DESIGNED	MJ <u>P/A</u> GO					
DRAWN	<u>JBM</u>					
CHECKED	<u>BFS</u>					
IN CHARGE	LAR					
DATE	05/01/24					
SCALE						
AS SHOWN						

PORT AUTHORITY OF ALLEGHENY COUNTY PENNSYLVANIA

BUS RAPID TRANSIT UPTOWN TO OAKLAND
INTERSECTION DATA
FIFTH AVE & LOTHROP ST/MEYRAN AVE

Port Authority connecting people to life

CONTRACT NO. BRT-001 DWG. NO. ID41 sнт. 217

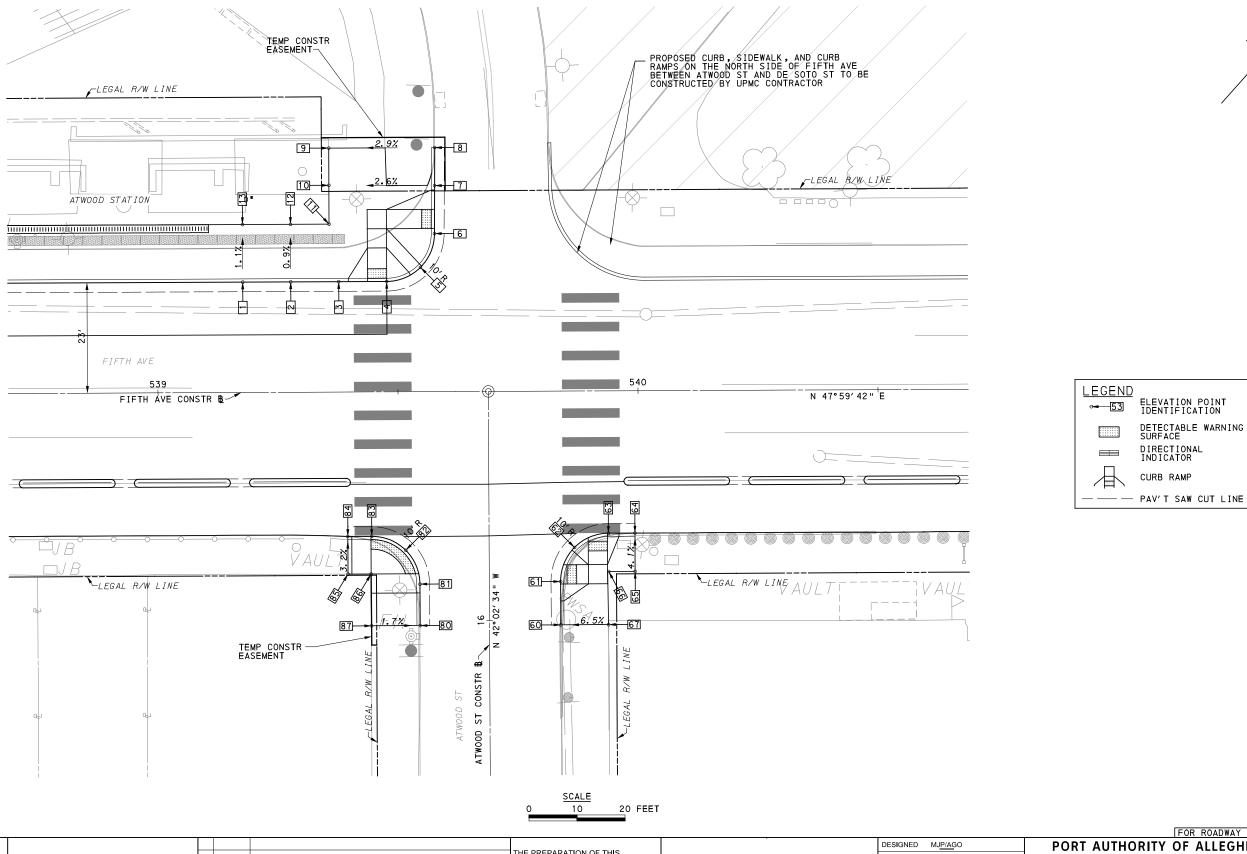

OPERATOR: "michael.mcgarry"

Gulf Tower 707 Grant Street 5th Floor Pittsburgh, PA 15219 THE PREPARATION OF THIS
DOCUMENT HAS BEEN FINANCED IN
PART THROUGH A GRANT FROM THE
FEDERAL TRANSIT ADMINISTRATION,
U.S. DEPARTMENT OF
TRANSPORTATION, UNDER THE
URBAN MASS TRANSPORTATION ACT
OF 1964, AS AMENDED, FOR THE
NO. DATE
DESCRIPTION
REVISIONS

THE PREPARATION OF THIS
PORTAL THAN BEEN FINANCED IN
PORTAL THAN BEEN FINANCED IN
PORTAL THAN BEEN FINANCED IN
COUNTY, PENNSYLVANIA.

(NOT FOR CONSTRUCTION)

ESIGNED	MJ <u>P/AG</u> O						
RAWN	<u>JBM</u>						
HECKED	BFS						
CHARGE	<u>LAR</u>						
ATE	<u>05/01/24</u>						
CALE							
AS SHOWN							

PORT AUTHORITY OF ALLEGHENY COUNTY PENNSYLVANIA

BUS RAPID TRANSIT UPTOWN TO OAKLAND INTERSECTION DETAILS FIFTH AVE & ATWOOD ST

Port Authority CONTRACT NO. E

 CONTRACT NO. BRT-001

 DWG. NO.
 ID42
 SHT.
 218

	剪
	99
	216
	2
	유
	Έ
	8
	Ę
	ő
	ğ
	۲
	Ë
	ğ
	E
	Φ
	ř
	ĕ
	눔
	č
	9
	ф
	Ę
	8
-	, de
F	Ó
ğ	÷
Ĕ	5
<u>_</u>	š
폱	9
Ĕ	ö
DPERATOR: "michael.mcgarry	FILE PATH: c:\pwworKing\decom_ds16_na\michael.mcgarry&aecom.com\d0212166\BF
9	Ā
Ā	α_
Ě	Щ
4	

			NORT	HWEST QUA	DRANT		
POINT NUMBER	BASEL INE	POINT	STATION	OFFSET	ELEVATION BOTTOM OF CURB	ELEVATION TOP OF CURB	ELEVATION BACK OF SIDEWALK
1	FIFTH AVE	POT	539+17.75	23.00' LT	[ 932. 46]	933.04	-
2	FIFTH AVE	POT	539+27.75	23.00' LT	[ 932.55]	933.13	-
3	FIFTH AVE	POT	539+37.75	23.00' LT	[ 932. 62]	933.20	-
4	FIFTH AVE	PC	539+47.75	23.00' LT	[ 932, 69]	*	-
5	FIFTH AVE	POC	539+54.80	25.90' LT	[ 932, 71]	933.29*	-
6	FIFTH AVE	PT	539+57.75	32.93′LT	[ 932. 86]	*	-
7	FIFTH AVE	POT	539+57.82	42.93′ LT	[933.21]	933.79*	-
8	FIFTH AVE	POT	539+57.87	50.84' LT	[ 933. 49]	[ 933. 90]	-
9	FIFTH AVE	-	539+35.78	50.83′LT	-	-	[ 933. 33]
10	FIFTH AVE	-	539+35.79	43.08' LT	-	-	[ 933. 23]
11	FIFTH AVE	-	539+35.79	35.00' LT	-	-	[ 933. 11]
12	FIFTH AVE	-	539+27.75	35.00' LT	-	=	[ 933. 03]
13	FIFTH AVE	-	539+17.75	35.00' LT	-	-	[932.92]

	SOUTHEAST QUADRANT							
POINT NUMBER	BASEL INE	POINT	STATION	OFFSET	ELEVATION BOTTOM OF CURB	ELEVATION TOP OF CURB	ELEVATION BACK OF SIDEWALK	
60	ATWOOD ST	POT	15+99.02	14.86′ RT	[931.83]	[932.41]	-	
61	ATWOOD ST	PC	16+08.05	14.86′ RT	[932.21]	*	-	
62	FIFTH AVE	POC	539+86.63	32.59' RT	[932,38]	*	-	
63	FIFTH AVE	PT	539+93.71	29.65′ RT	[ 932. 36]	[932.77]	-	
64	FIFTH AVE	POT	539+99.24	29.65′ RT	[ 932, 29]	[ 932, 75]	-	
65	FIFTH AVE	-	539+99.24	37.63′ RT	-	-	[ 933. 05]	
66	FIFTH AVE	-	539+93.74	37.63′ RT	-	-	[ 932. 99]	
67	ATWOOD ST	-	15+99.02	24.80′ RT	-	-	[ 933. 00]	


	SOUTHWEST QUADRANT								
POINT NUMBER	BASELINE	POINT	STATION	OFFSET	ELEVATION BOTTOM OF CURB	ELEVATION TOP OF CURB	ELEVATION BACK OF SIDEWALK		
80	ATWOOD ST	POT	15+99.02	14.45′ LT	[931.77]	[ 932. 25]	-		
81	ATWOOD ST	PC	16+07.65	14.45′ LT	[932.21]	*	-		
82	FIFTH AVE	POC	539+51.47	33.01′ RT	[ 932, 55]	*	-		
83	FIFTH AVE	PT	539+44.40	33.09′ RT	[932.67]	*	-		
84	FIFTH AVE	POT	539+39.42	33.09' RT	[ 932. 67]	[ 933. 00]	-		
85	FIFTH AVE	-	539+39.42	37.94′ RT	-	-	[ 933. 23]		
86	FIFTH AVE	-	539+44.23	37.94′ RT	-	-	[ 933. 05]		
87	ATWOOD ST	-	15+99.02	24.57′ LT	-	-	[ 932. 41]		

[] MATCH EXISTING ELEVATION

**AECOM** Gulf Tower 707 Grant Street 5th Floor Pittsburgh, PA 15219

		THE PREPARATION OF THIS DOCUMENT HAS BEEN FINANCED IN	
		PART THROUGH A GRANT FROM THE	
		FEDERAL TRANSIT ADMINISTRATION, U.S. DEPARTMENT OF	
		TRANSPORTATION, UNDER THE	
		URBAN MASS TRANSPORTATION ACT OF 1964, AS AMENDED, FOR THE	
DATE		PORT AUTHORITY OF ALLEGHENY COUNTY, PENNSYLVANIA.	
	REVISIONS	COUNTY, FEMINISTEVANIA.	

DESIGNED N	/J <u>P/A</u> GO	PORT AUTHORITY OF ALLEGHE			LEGHENY CO	NY COUNTY		
DRAWN	<u>JBM</u>	PITT	SBURGH		PENN	SYLVANI	Α	
CHECKED	BFS	BUS RAPID TRANSIT UPTOWN TO OAKLAND INTERSECTION DATA FIFTH AVE & ATWOOD ST						
IN CHARGE	LAR							
DATE	05/01/24							
SCALE	S SHOWN	Port	Port Authority -		RACT NO. BRT-0	01		
· ^`	S OF IOVVIA	. 0.0	connecting people to life	DWG. NO.	<b>I</b> D43	SHT.	219	

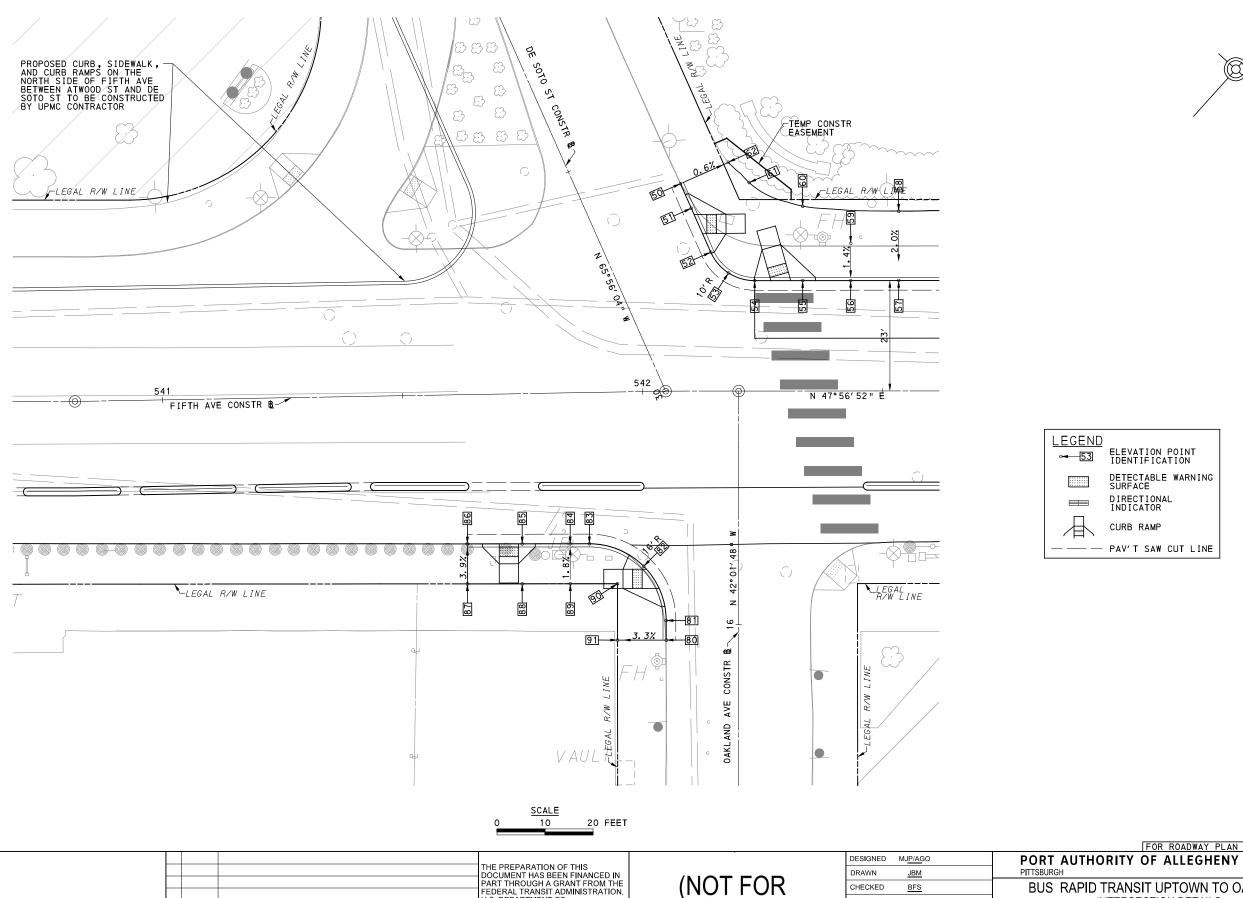

**AECOM** 

**Gulf Tower** 707 Grant Street 5th Floor Pittsburgh, PA 15219

PEDERAL TRANSIT ADMINISTRATION,
U.S. DEPARTMENT OF
TRANSPORTATION, UNDER THE
URBAN MASS TRANSPORTATION ACT
OF 1964, AS AMENDED, FOR THE
PORT AUTHORITY OF ALLEGHENY
COUNTY, PENNSYLVANIA. NO. DATE DESCRIPTION REVISIONS

(NOT FOR CONSTRUCTION)

SIGNED	MJ <u>P/AG</u> O	l
RAWN	<u>JBM</u>	L
HECKED	BFS	
CHARGE	<u>LAR</u>	
TE	05/01/24	
ALE		Г
	AS SHOWN	

FOR ROADWAY PLAN SEE SHEET 377 PORT AUTHORITY OF ALLEGHENY COUNTY

BUS RAPID TRANSIT UPTOWN TO OAKLAND INTERSECTION DETAILS FIFTH AVE & OAKLAND AVE/DE SOTO ST

Port Authority connecting people to life CONTRACT NO. BRT-001 ID44 DWG. NO. sнт. 220

NORTHEAST QUADRANT								
POINT NUMBER	BASELINE	POINT	STATION	OFFSET	ELEVATION BOTTOM OF CURB	ELEVATION TOP OF CURB	ELEVATION BACK OF SIDEWALK	
50	DE SOTO ST	POT	30+38.25	20.34' RT	[929.88]	[ 930. 32]	-	
51	DE SOTO ST	POT	30+32.66	20.34' RT	[929.70]	*	-	
52	DE SOTO ST	PC	30+22.66	20.34′ RT	[929.59]	*	-	
53	FIFTH AVE	POC	542+17.95	24.62′ LT	[929.56]	929.89 *	-	
54	FIFTH AVE	PT	542+23.40	23.00′ LT	[929.46]	929.79 *	-	
55	FIFTH AVE	POT	542+33.40	23.00′ LT	[929.31]	929.64	-	
56	FIFTH AVE	POT	542+43.40	23.00′ LT	[929.11]	929.44	-	
57	FIFTH AVE	POT	542+53.40	23.00′ LT	[928.96]	929.29	-	
58	FIFTH AVE	-	542+53.40	30.77′ LT	-	-	[929.59]	
59	FIFTH AVE	-	542+43.40	30.76′ LT	-	-	[929.54]	
60	FIFTH AVE	-	542+33.40	38.51′ LT	-	-	[ 930. 02]	
61	DE SOTO ST	-	30+32.66	33.53′ RT	-	-	[ 930. 14]	
62	DE SOTO ST	-	30+38.31	31.26' RT	-	-	[ 930. 26]	

SOUTHWEST QUADRANT								
POINT NUMBER	BASEL INE	POINT	STATION	OFFSET	ELEVATION BOTTOM OF CURB	ELEVATION TOP OF CURB	ELEVATION BACK OF SIDEWALK	
80	OAKLAND AVE	POT	15+96.81	15.09'LT	[928.93]	[929.34]	-	
81	OAKLAND AVE	PC	16+00.88	15.09'LT	[929.05]	929.50*	-	
82	FIFTH AVE	POC	541+99.63	36.39' RT	[929.31]	*	-	
83	FIFTH AVE	PT	541+88.39	31.51′RT	[929.53]	930.11	-	
84	FIFTH AVE	POT	541+84.40	31.45′ RT	[929.47]	930.05	-	
85	FIFTH AVE	POT	541+74.40	31.28′ RT	[929.61]	*	-	
86	FIFTH AVE	POT	541+62.98	31.09' RT	[929.85]	[ 930. 34]	-	
87	FIFTH AVE	-	541+62.84	39.43′ RT	-	-	[ 930. 63]	
88	FIFTH AVE	-	541+74.26	39.61′RT	-	-	[ 930. 49]	
89	FIFTH AVE	-	541+84.28	39.78′ RT	-	-	[ 930. 24]	
90	OAKLAND AVE	-	16+08.55	25.25′ LT	-	-	[929.84]	
91	OAKLAND AVE	-	15+96.81	25.25'LT	-	-	[929.65]	

[] MATCH EXISTING ELEVATION


**AECOM** Gulf Tower 707 Grant Street 5th Floor Pittsburgh, PA 15219

		THE PREPARATION OF THIS DOCUMENT HAS BEEN FINANCED IN
		PART THROUGH A GRANT FROM THE
		FEDERAL TRANSIT ADMINISTRATION, U.S. DEPARTMENT OF
		TRANSPORTATION, UNDER THE
		URBAN MASS TRANSPORTATION ACT OF 1964, AS AMENDED, FOR THE
DATE	DESCRIPTION	PORT AUTHORITY OF ALLEGHENY COUNTY, PENNSYLVANIA.
	REVISIONS	COUNTY, PENNSTEVANIA.

(NOT FOR CONSTRUCTION)

ESIGNED	MJ <u>P/AG</u> O	PORT AUT
RAWN	<u>JBM</u>	PITTSBURGH
HECKED	<u>BFS</u>	BUS RAPI
CHARGE	LAR	
ATE	05/01/24	FIFTH
CALE	AS SHOWN	Port Author

THORITY OF ALLEGHENY COUNTY PENNSYLVANIA PID TRANSIT UPTOWN TO OAKLAND INTERSECTION DATA I AVE & OAKLAND AVE/DE SOTO ST Port Authority connecting people to life CONTRACT NO. BRT-001 DWG. NO. ID45 sнт. 221

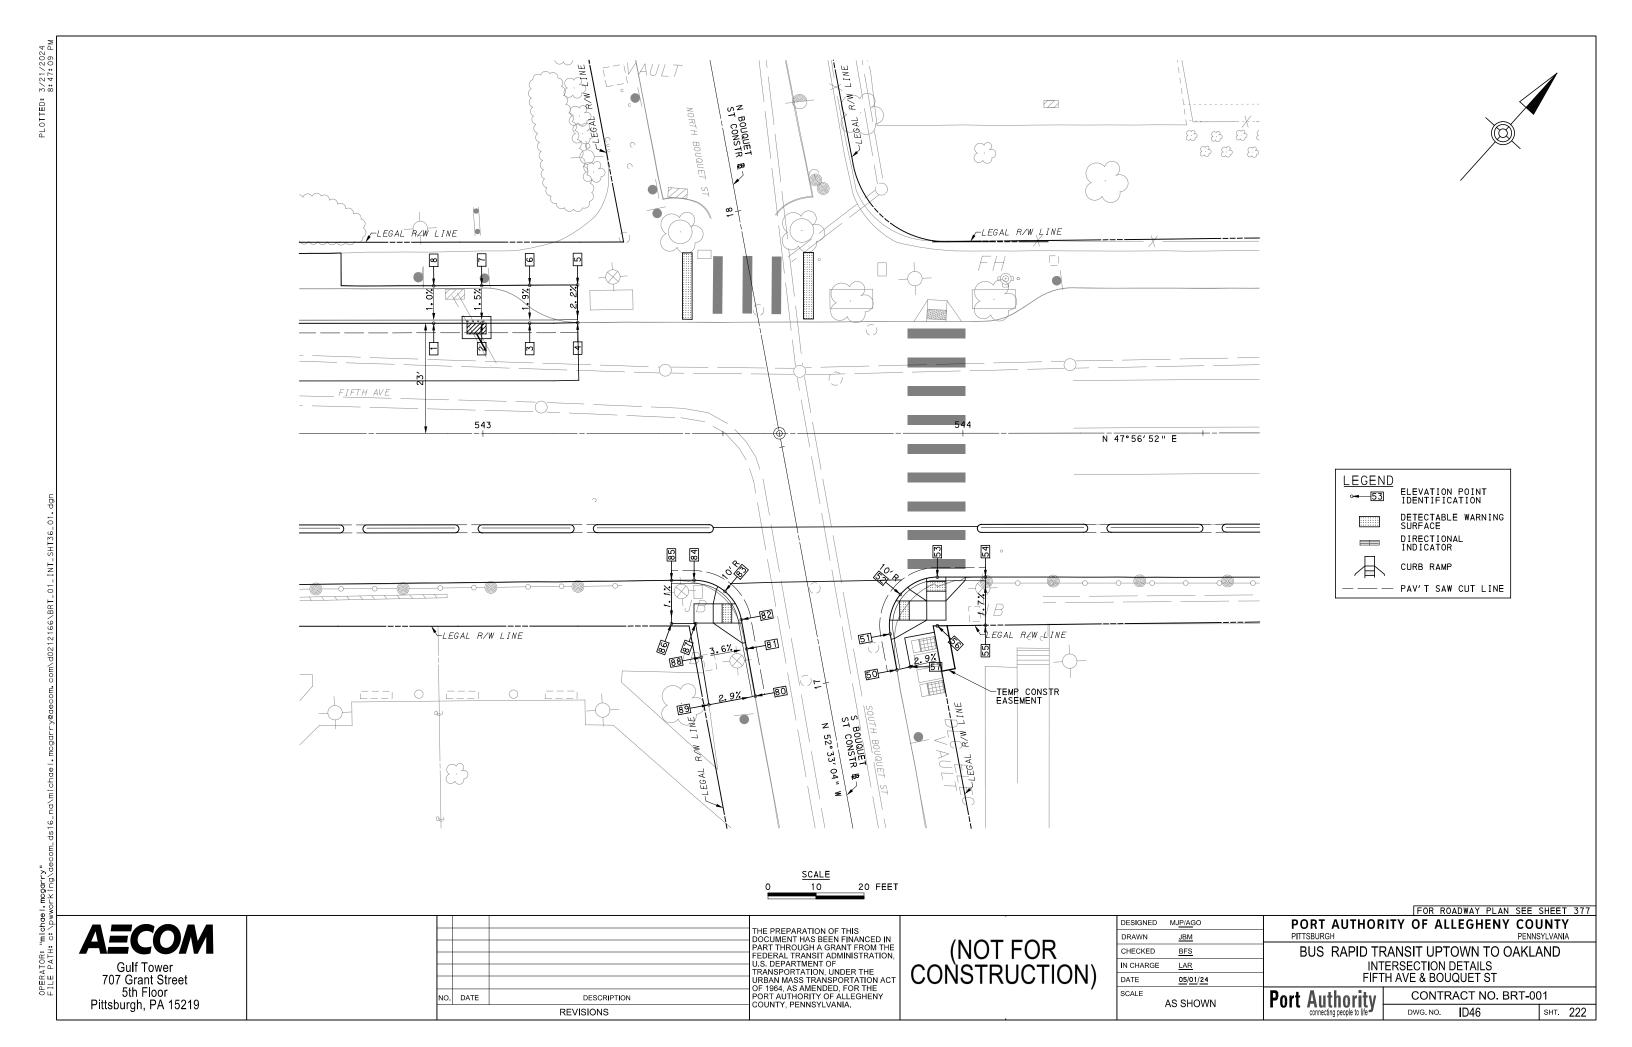

	NORTHWEST QUADRANT									
POINT NUMBER	BASELINE	POINT	STATION	OFFSET	ELEVATION BOTTOM OF CURB	ELEVATION TOP OF CURB	ELEVATION BACK OF SIDEWALK			
1	FIFTH AVE	POT	542+89.77	23.00′ LT	[928.39]	928.72	-			
2	FIFTH AVE	POT	542+99.77	23.00′ LT	[928.23]	928.57	-			
3	FIFTH AVE	POT	543+09.77	23.00′ LT	[928.14]	928.47	-			
4	FIFTH AVE	POT	543+19.76	23.09′ LT	[927.96]	[928.40]	-			
5	FIFTH AVE	-	543+19.75	30.96′ LT	-	-	[928.54]			
6	FIFTH AVE	-	543+09.77	30.91′ LT	-	-	[928.61]			
7	FIFTH AVE	-	542+99.77	30.86′ LT	-	-	[928.67]			
8	FIFTH AVE	-	542+89.77	30.82′ LT	-	-	[928.79]			

	SOUTHWEST QUADRANT									
POINT NUMBER	BASELINE	POINT	STATION	OFFSET	ELEVATION BOTTOM OF CURB	ELEVATION TOP OF CURB	ELEVATION BACK OF SIDEWALK			
80	S BOUQUET ST	POT	17+00.00	14.96' LT	[925.91]	[926.50]	-			
81	S BOUQUET ST	POT	17+10.00	14.93′ LT	[926.41]	[926.91]	-			
82	S BOUQUET ST	PC	17+16.20	14.91'LT	[926.71]	*	-			
83	FIFTH AVE	POC	543+50.38	32.91′ RT	[926.97]	*	-			
84	FIFTH AVE	PT	543+43.98	30.59′ RT	[927.24]	[927.74]	-			
85	FIFTH AVE	POT	543+39.26	30.59' RT	[927.33]	[927.88]	-			
86	FIFTH AVE	-	543+39.26	39.62′ RT	-	-	[927.79]			
87	FIFTH AVE	-	543+44.28	39.62′ RT	-	-	927.60			
88	S BOUQUET ST	-	17+10.00	24.58′ LT	-	-	927.09			
89	S BOUQUET ST	-	17+00.00	24.79′ LT	-	-	[ 926. 63]			

	SOUTHEAST QUADRANT								
POINT NUMBER	BASELINE	POINT	STATION	OFFSET	ELEVATION BOTTOM OF CURB	ELEVATION TOP OF CURB	ELEVATION BACK OF SIDEWALK		
50	S BOUQUET ST	POT	17+00.00	15.03′ RT	[926.01]	[ 926. 32]	-		
51	S BOUQUET ST	PC	17+07.60	15.03′ RT	[ 926. 32]	[926.65]	-		
52	FIFTH AVE	POC	543+86.96	33.58′ RT	[ 926. 37]	*	-		
53	FIFTH AVE	PT	543+94.65	29.98′ RT	[ 926. 32]	*	-		
54	FIFTH AVE	POT	544+04.67	29.98′ RT	[926.01]	[926.59]	-		
55	FIFTH AVE	-	544+04.66	40.01' RT	-	-	[926.75]		
56	FIFTH AVE	-	543+94.65	40.12' RT	-	-	[926.66]		
57	S BOUQUET ST	-	17+00.10	17.88′ RT	-	-	[926.37]		

[] MATCH EXISTING ELEVATION

**AECOM** Gulf Tower 707 Grant Street 5th Floor Pittsburgh, PA 15219

		THE PREPARATION OF THIS DOCUMENT HAS BEEN FINANCED IN
		PART THROUGH A GRANT FROM THE
		FEDERAL TRANSIT ADMINISTRATION, U.S. DEPARTMENT OF
		TRANSPORTATION, UNDER THE
		URBAN MASS TRANSPORTATION ACT OF 1964, AS AMENDED, FOR THE
ATE		PORT AUTHORITY OF ALLEGHENY COUNTY, PENNSYLVANIA.
	DEVISIONS	COUNTY, FEMINOTEVANIA.

ESIGNED	MJ <u>P/A</u> GO	PORT AUTHOR	ITY OF AL	LEGHENY COL	/TNL	7
RAWN	<u>JBM</u>	PITTSBURGH		PENNS	SYLVANI	Α
HECKED	BFS	BUS RAPID TRANSIT UPTOWN TO OAKLAND				
CHARGE	<u>LAR</u>	INTERSECTION DATA				
ATE	<u>05/01/24</u>	FIFTH AVE & BOUQUET ST				
CALE AS SHOWN		Port Authority	CONTR	RACT NO. BRT-00	)1	
	AOOHOWN	connecting people to life	DWG. NO.	<b>I</b> D47	SHT.	223

20 FEET

**Gulf Tower** 707 Grant Street 5th Floor Pittsburgh, PA 15219

THE PREPARATION OF THIS
DOCUMENT HAS BEEN FINANCED IN
PART THROUGH A GRANT FROM THE
FEDERAL TRANSIT ADMINISTRATION, PEDERAL TRANSIT ADMINISTRATION,
U.S. DEPARTMENT OF
TRANSPORTATION, UNDER THE
URBAN MASS TRANSPORTATION ACT
OF 1964, AS AMENDED, FOR THE
PORT AUTHORITY OF ALLEGHENY
COUNTY, PENNSYLVANIA. NO. DATE DESCRIPTION

(NOT FOR CONSTRUCTION)

DESIGNED	MJ <u>P/A</u> GO	
DRAWN	<u>JBM</u>	
CHECKED	BFS	
IN CHARGE	LAR	
DATE	05/01/24	
SCALE		
	AS SHOWN	

FOR ROADWAY PLAN SEE SHEET 378 PORT AUTHORITY OF ALLEGHENY COUNTY

BUS RAPID TRANSIT UPTOWN TO OAKLAND INTERSECTION DETAILS FIFTH AVE & THACKERY AVE

Port Authority connecting people to life

CONTRACT NO. BRT-001 ID48 sнт. 224 DWG. NO.

**AECOM** 

REVISIONS

	NORTHWEST QUADRANT											
POINT NUMBER	BASEL INE	POINT	STATION	OFFSET	ELEVATION BOTTOM OF CURB	ELEVATION TOP OF CURB	ELEVATION BACK OF SIDEWALK					
1	FIFTH AVE	POT	546+58.61	22.96′LT	[922.28]	[922.61]	-					
2	FIFTH AVE	POT	546+67.79	22.96′ LT	[922.26]	922.64	-					
3	FIFTH AVE	PC	546+76.98	0.00' RT	[922.11]	*	_					
4	FIFTH AVE	POC	546+84.04	0.00' RT	[922.08]	*	-					
5	THACKERAY AVE	PŤ	30+32.93	0.00' RT	[922.26]	*	-					
6	THACKERAY AVE	POT	30+44.62	0.00' RT	[922.91]	923.29	-					
7	THACKERAY AVE	POT	30+56.30	0.00' RT	[923.81]	[824.02]	-					
8	THACKERAY AVE	-	30+56.30	6.38'LT	-	-	[924.12]					
9	THACKERAY AVE	-	30+44.61	10.06' LT	-	-	[923.16]					
10	FIFTH AVE	-	546+67.81	37.93′LT	-	-	[922.87]					
11	FIFTH AVE	-	546+58.61	37.62′ LT	-	-	[922.74]					

	NORTHEAST QUADRANT										
POINT NUMBER	BASEL INE	POINT	STATION	OFFSET	ELEVATION BOTTOM OF CURB	ELEVATION TOP OF CURB	ELEVATION BACK OF SIDEWALK				
30	THACKERAY AVE	POT	30+56.30	14.98′ RT	[ 923. 00]	[923.63]	-				
31	THACKERAY AVE	POT	30+44.72	14.98′ RT	[922.38]	922.96	-				
32	THACKERAY AVE	PC	30+33.14	14.98′ RT	921.93	*	-				
33	FIFTH AVE	POC	547+20.38	26.04' LT	921.68	*	-				
34	FIFTH AVE	PC	547+27.46	23.10' LT	921.44	*	-				
35	FIFTH AVE	POT	547+35.53	23.10' LT	[921.27]	921.85*	-				
36	FIFTH AVE	POT	547+43.60	23.10' LT	[921.11]	[921.65]	-				
37	FIFTH AVE	-	547+43.65	40.08' LT	-	_	[921.62]				
38	FIFTH AVE	-	547+35.54	41.61′LT	-	-	[921.99]				
39	THACKERAY AVE	-	30+44.73	28.89'LT	-	-	[ 922. 50]				
40	THACKERAY AVE	-	30+56.30	24.88′ LT	-	=	[ 923. 73]				

	SOUTHEAST QUADRANT											
POINT NUMBER	BASEL INE	POINT	STATION	OFFSET	ELEVATION BOTTOM OF CURB	ELEVATION TOP OF CURB	ELEVATION BACK OF SIDEWALK					
50	FIFTH AVE	POT	547+20.75	30.06′ RT	[921.08]	[921.20]	-					
51	FIFTH AVE	POT	547+30.55	30.08′ RT	[ 920. 99]	*	_					
52	FIFTH AVE	POT	547+40.36	30. 10' RT	[ 920. 85]	[921.43]	-					
53	FIFTH AVE	-	547+40.36	39.93′ RT	-	-	[921.61]					
54	FIFTH AVE	-	547+30.55	39.93′ RT	-	-	[921.76]					
55	FIFTH AVE	-	547+20.75	39.93′ RT	-	-	[921.85]					

[] MATCH EXISTING ELEVATION

**AECOM** Gulf Tower 707 Grant Street 5th Floor Pittsburgh, PA 15219

		THE PREPARATION OF THIS  DOCUMENT HAS BEEN FINANCED
		PART THROUGH A GRANT FROM TH
		FEDERAL TRANSIT ADMINISTRATIO
		TRANSPORTATION, UNDER THE
		URBAN MASS TRANSPORTATION A OF 1964, AS AMENDED, FOR THE
DATE	DESCRIPTION	PORT AUTHORITY OF ALLEGHENY COUNTY, PENNSYLVANIA.
	REVISIONS	COUNTY, PENNSTEVANIA.

ESIGNED	MJ <u>P/A</u> GO	PORT AUTHOR	ITY OF AL	LEGHENY COL	JNTY	,	
RAWN	<u>JBM</u>	PITTSBURGH		PENNS	SYLVANIA	1	
HECKED	<u>BFS</u>	BUS RAPID TRANSIT UPTOWN TO OAKLAND					
CHARGE	LAR	IN	ITERSECTION	N DATA			
ATE	05/01/24	FIFTH	I AVE & THAC	CKERY AVE			
CALE	AS SHOWN	Port Authority	CONTF	RACT NO. BRT-00	01		
	AO OI IOVIII	connecting people to life	DWG NO	ID40	СПТ	2	

**AECOM** 

Gulf Tower 707 Grant Street 5th Floor Pittsburgh, PA 15219

THE PREPARATION OF THIS
DOCUMENT HAS BEEN FINANCED IN
PART THROUGH A GRANT FROM THE
FEDERAL TRANSIT ADMINISTRATION,
U.S. DEPARTMENT OF
TRANSPORTATION, UNDER THE
URBAN MASS TRANSPORTATION ACT
OF 1964, AS AMENDED, FOR THE
PORT AUTHORITY OF ALLEGHENY
COUNTY, PENNSYLVANIA. DESCRIPTION REVISIONS

(NOT FOR CONSTRUCTION)

DESIGNED	MJ <u>P/A</u> GO	
DRAWN	<u>JBM</u>	
CHECKED	BFS	
IN CHARGE	LAR	
DATE	05/01/24	
SCALE		
	AS SHOWN	

FOR ROADWAY PLAN SEE SHEET 379 PORT AUTHORITY OF ALLEGHENY COUNTY

BUS RAPID TRANSIT UPTOWN TO OAKLAND INTERSECTION DETAILS FIFTH AVE & BIGELOW BLVD

Port Authority connecting people to life DWG. NO.

CONTRACT NO. BRT-001 ID50 sнт. 226

NO. DATE

20 FEET

OPERATOR: "michael.mcgarry" FILE PATH: c:\pwworking\aecom_ds16_na\mich	<b>AECO</b> A Gulf Tower
OPERATOR: File Path	Gulf Tower 707 Grant Street 5th Floor Pittsburgh, PA 15219


NORTHWEST QUADRANT									
POINT NUMBER	BASEL I NE	POINT	STATION	OFFSET	ELEVATION BOTTOM OF CURB	ELEVATION TOP OF CURB	ELEVATION BACK OF SIDEWALK		
1	FIFTH AVE	POT	552+81.13	34.00' LT	913.22	913.80	-		
2	FIFTH AVE	POT	552+91.13	34.00' LT	913.13	913.72	-		
3	FIFTH AVE	PC	553+01.22	34.00′ LT	913.00	913.59	-		
4	FIFTH AVE	PT	553+03.24	33.58′ LT	912.97	913.56	-		
5	FIFTH AVE	POT	553+13.64	29.00' LT	912.51	913.45	-		
6	FIFTH AVE	PC	553+28.58	22. 42′ LT	912.39	*	-		
7	FIFTH AVE	PT	553+30.60	22.00′ LT	912.36	*	-		
8	FIFTH AVE	PC	553+39.84	22.00′ LT	912.22	*	-		
9	FIFTH AVE	POC	553+50.58	26.52′LT	912.11	912.69	-		
10	BIGELOW BLVD	PT	37+17.48	25.00′ LT	912.44	913.02*	-		
11	BIGELOW BLVD	POT	37+27.48	25.00′ LT	912.71	*	-		
12	BIGELOW BLVD	ΡI	37+35.00	25.00′ LT	913.08	913.66	-		
13	BIGELOW BLVD	POT	37+41.49	25.05′ LT	[913.13]	[913.71]	-		
14	BIGELOW BLVD	-	37+41.65	44.81′LT	-	-	[913.99]		
15	FIFTH AVE	-	553+29.46	48.87'LT	-	-	[913.57]		
16	FIFTH AVE	-	553+28.04	45.02′ LT	-	-	[913.52]		
17	FIFTH AVE	-	553+13.17	48.46′LT	-	-	[913.80]		
18	FIFTH AVE	-	553+01.23	44.39' LT	-	-	[913.78]		
19	FIFTH AVE	-	552+91.13	44.15′LT	-	-	[913.91]		
20	FIFTH AVE	-	552+81.13	47.65' LT	-	-	[914.06]		

			NORTH	HEAST QUA	ADRANT		
POINT NUMBER	BASEL INE	POINT	STATION	OFFSET	ELEVATION BOTTOM OF CURB	ELEVATION TOP OF CURB	ELEVATION BACK OF SIDEWAL
30	BIGELOW BLVD	POT	37+37.45	24.50' RT	[912.34]	[912.92]	-
31	BIGELOW BLVD	PC	37+32.20	24.50′ RT	[912.23]	[912.81]	-
32	BIGELOW BLVD	POC	37+25.44	25. 22' RT	911.98	*	-
33	BIGELOW BLVD	POC	37+16.15	28.81' RT	911.70	*	-
34	FIFTH AVE	POC	554+17.88	27.65′ LT	911.33	*	-
35	FIFTH AVE	POC	554+26.87	23.38' LT	911.25	*	-
36	FIFTH AVE	PT	554+37.29	22.00' LT	911.26	911.84	-
37	FIFTH AVE	POT	554+47.29	22.00' LT	911.21	911.79	-
38	FIFTH AVE	PC	554+56.46	24.00' LT	911.20	911.79	-
39	FIFTH AVE	PT	554+60.00	25.46′ LT	911.19	911.77	-
40	FIFTH AVE	PC	554+63.06	28.52′ LT	[911.17]	911.75	-
41	FIFTH AVE	PT	554+66.61	30.00' LT	[911.15]	911.73	-
42	FIFTH AVE	POT	554+73.89	29.97′LT	[911.21]	[911.79]	-
43	FIFTH AVE	-	554+73.92	39.82′LT	-	-	[911.92]
44	FIFTH AVE	-	554+66.63	39.82′LT	-	-	[911.92]
45	FIFTH AVE	-	554+58.00	39.82′LT	-	-	912.09
46	FIFTH AVE	-	554+47.29	39.82′LT	-	-	912.13
47	FIFTH AVE	-	554+37.30	39.99'LT	-	-	912.17
48	FIFTH AVE	-	554+31.17	40.78'LT	-	-	912.10
49	FIFTH AVE	-	554+26.44	43.38'LT	-	-	912.17
50	BIGELOW BLVD	-	37+23.96	44.15′LT	-	-	[912.29]
51	BIGELOW BLVD	-	37+28.15	41.12'LT	-	-	[912.46]
52	BIGELOW BLVD	-	37+32.18	39. 49' RT	-	-	[912.61]
53	BIGELOW BLVD	-	37+37.45	36.94'LT	-	-	[912.82]

[] MATCH EXISTING ELEVATION

		THE PREPARATION OF THIS DOCUMENT HAS BEEN FINANCED II
		PART THROUGH A GRANT FROM TH
		FEDERAL TRANSIT ADMINISTRATIO
		TRANSPORTATION, UNDER THE
		URBAN MASS TRANSPORTATION A OF 1964, AS AMENDED, FOR THE
DATE	DESCRIPTION	PORT AUTHORITY OF ALLEGHENY COUNTY, PENNSYLVANIA.
	REVISIONS	COUNTY, FEMINISTEVANIA.

SIGNED	MJ <u>P/A</u> GO	PORT AUTHOR	ITY OF ALL	EGHENY COL	JNT	1	
RAWN	<u>JBM</u>	PITTSBURGH		PENNS	YLVANI	Α	
HECKED	BFS	BUS RAPID TRANSIT UPTOWN TO OAKLAND					
CHARGE	LAR	INTERSECTION DATA					
ATE.	05/01/24	FIFTH AVE & BIGELOW BLVD					
ALE	AS SHOWN	Port Authority	CONTRA	ACT NO. BRT-00	)1		
	ASSITOWN	connecting people to life	DWC NO	IDE1	спт	227	

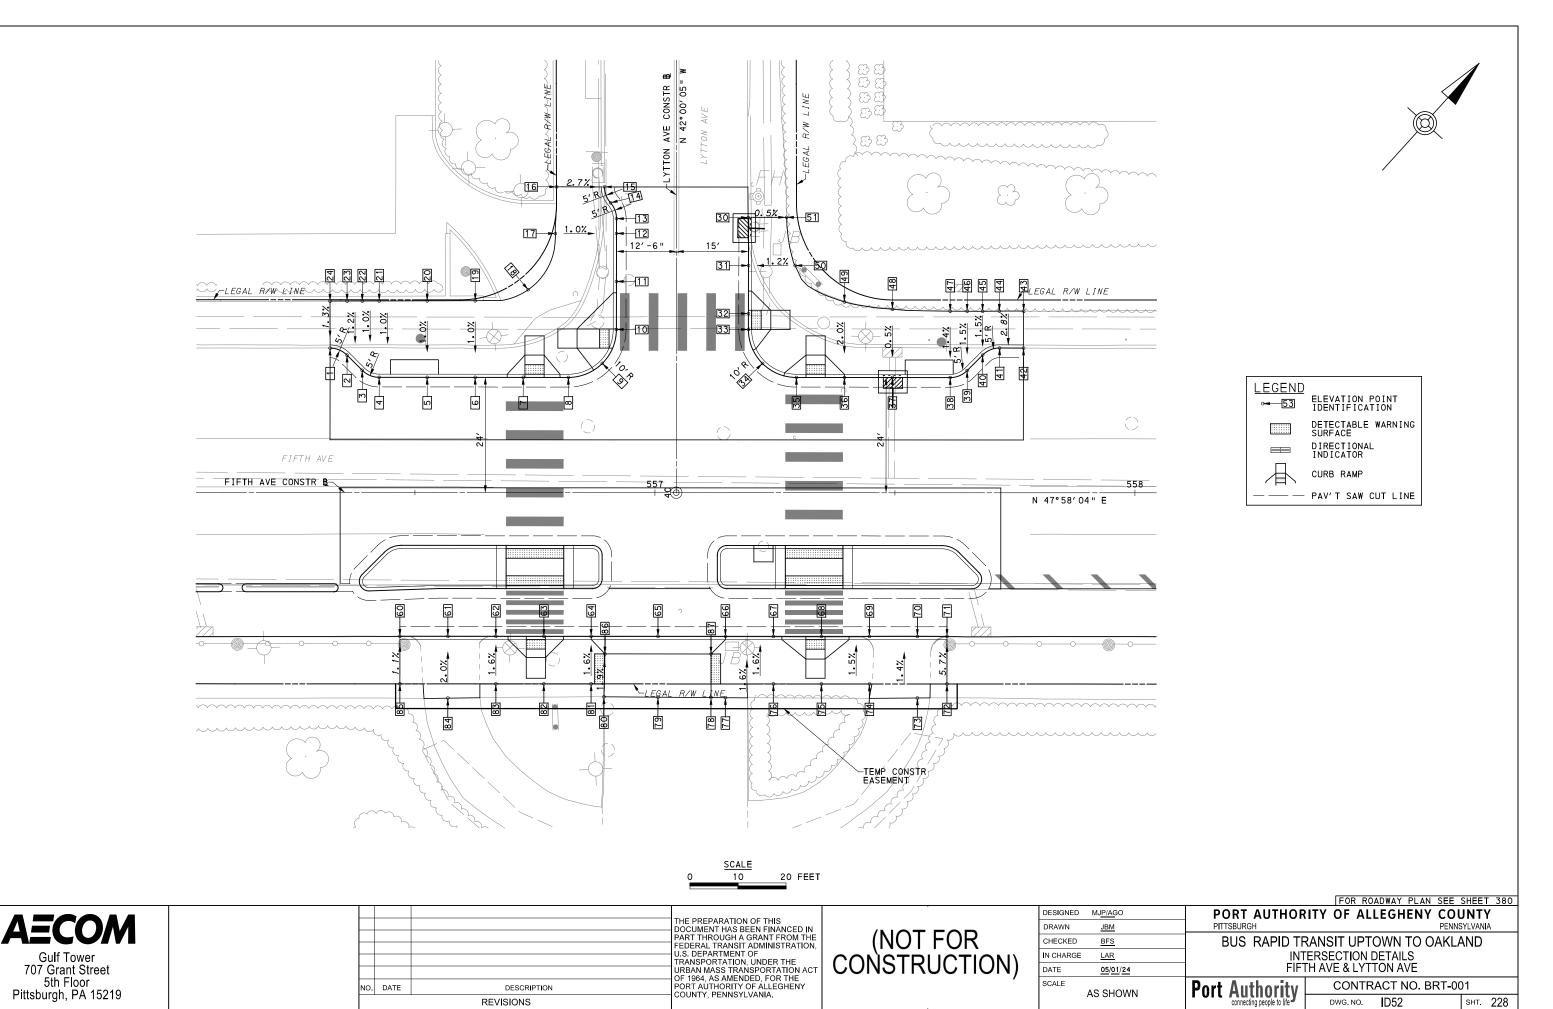

**Gulf Tower** 

			NORTI	HWEST QUA	DRANT		
POINT NUMBER	BASEL INE	POINT	STATION	OFFSET	ELEVATION BOTTOM OF CURB	ELEVATION TOP OF CURB	ELEVATION BACK OF SIDEWALK
1	FIFTH AVE	PC	556+32.31	30.09' LT	[912.71]	[913.17]	-
2	FIFTH AVE	PT	556+35.85	28.63′ LT	[912.75]	913.21	-
3	FIFTH AVE	PC	556+39.01	25.46′ LT	[912.83]	913.28	-
4	FIFTH AVE	PT	556+42.55	24.00' LT	[912.89]	913.34	-
5	FIFTH AVE	POT	556+52.55	24.00' LT	[913.00]	913.46	-
6	FIFTH AVE	POT	556+62.55	24.00′ LT	[913.15]	* 913.61	-
7	FIFTH AVE	POT	556+72.55	24.00' LT	[913.32]	* *	-
8	FIFTH AVE	PC	556+81.97	24.00′ LT	[913.52]	*	-
9	FIFTH AVE	POC	556+89.04	26.93′ LT	[913.65]	*	-
10	LYTTON AVE	PT	40+33.99	12.50′ LT	[913.79]	*	-
11	LYTTON AVE	POT	40+43.99	12.50′ LT	[914.29]	914.56*	-
12	LYTTON AVE	POT	40+53.99	12.50′ LT	[914.54]	914.94	-
13	LYTTON AVE	PC	40+57.08	12.50′ LT	[914.65]	915.11	-
14	LYTTON AVE	PRC	40+60.38	13.75′ LT	[914.75]	915.30	-
15	LYTTON AVE	PT	40+63.99	15.00′ LT	[914.84]	915.26	-
16	LYTTON AVE	-	40+63.69	25.00′ LT	-	-	[915.51]
17	LYTTON AVE	-	40+53.97	25.24′ LT	-	-	[915.07]
18	LYTTON AVE	-	40+42.25	30.89′ LT	-	-	[914.15]
19	FIFTH AVE	-	556+62.55	39.98′ LT	-	-	[913.73]
20	FIFTH AVE	-	556+52.55	39.95′ LT	-	-	[913.57]
21	FIFTH AVE	-	556+42.55	39.92′ LT	-	-	[913.43]
22	FIFTH AVE	-	556+39.01	39.90′ LT	-	-	[913.38]
23	FIFTH AVE	-	556+35.85	39.89′ LT	-	-	[913.33]
24	FIFTH AVE	-	556+32.30	39.88′ LT	-	-	[913.29]

NORTHEAST QUADRANT								
POINT BASELINE POINT S		STATION	OFFSET	ELEVATION BOTTOM OF CURB	ELEVATION TOP OF CURB	ELEVATION BACK OF SIDEWALK		
30	LYTTON AVE	POT	40+57.32	14.91′RT	[914.60]	[915.38]	-	
31	LYTTON AVE	POT	40+47.33	15.00' RT	[914.35]	914.77	-	
32	LYTTON AVE	POT	40+37.33	15.00' RT	[913.98]	*	-	
33	LYTTON AVE	PC	40+34.01	15.00' RT	[913.89]	*	-	
34	FIFTH AVE	POC	557+22.39	26.93′LT	[913.78]	914.20	-	
35	FIFTH AVE	PT	557+29.47	24.00' LT	[913.81]	*	-	
36	FIFTH AVE	POT	557+39.47	24.00' LT	[913.84]	914.25	-	
37	FIFTH AVE	POT	557+49.47	24.00' LT	[913.86]	914.28	-	
38	FIFTH AVE	PC	557+61.50	24.00' LT	913.93	914.35	-	
39	FIFTH AVE	PT	557+65.04	25.46′ LT	913.95	914.37	-	
40	FIFTH AVE	PC	557+68.26	28.68' LT	913.97	914.39	-	
41	FIFTH AVE	PT	557+71.80	30.15′LT	913.99	914.41	-	
42	FIFTH AVE	POT	557+76.79	30.14′ LT	[914.02]	[914.46]	-	
43	FIFTH AVE	-	557+76.80	37.85′LT	-	_	[914.63]	
44	FIFTH AVE	-	557+71.74	37.84′ LT	-	-	[914.59]	
45	FIFTH AVE	-	557+68.26	37.82′LT	-	_	[914.57]	
46	FIFTH AVE	-	557+65.04	37.81′LT	-	-	[914.55]	
47	FIFTH AVE	-	557+61.50	37.82′LT	-	-	[914.53]	
48	FIFTH AVE	-	557+49.47	38.23′ LT	-	-	[914.47]	
49	FIFTH AVE	-	557+39.46	39.76′LT	-	-	[914.56]	
50	LYTTON AVE	-	40+47.34	24.70′ LT	-	-	[914.88]	
51	LYTTON AVE	-	40+57.38	22.94' LT	-	-	[915.34]	

	SOUTH QUADRANT									
POINT NUMBER	BASEL INE	POINT	STATION	0FFSET	ELEVATION BOTTOM OF CURB	ELEVATION TOP OF CURB	ELEVATION BACK OF SIDEWALK			
60	FIFTH AVE	POT	556+46.88	29.93' RT	[912.97]	[913.47]	-			
61	FIFTH AVE	POT	556+56.88	29.93' RT	913.08	913.50	-			
62	FIFTH AVE	POT	556+66.88	29.93' RT	913.15	913.57*	-			
63	FIFTH AVE	POT	556+76.88	29.93′ RT	913.27	*	-			
64	FIFTH AVE	POT	556+86.72	29.93′ RT	913.41	913.83	-			
65	FIFTH AVE	POT	557+00.65	29.93′ RT	913.57	913.99	-			
66	FIFTH AVE	POT	557+14.70	29.93′ RT	913.74	914.16	-			
67	FIFTH AVE	POT	557+24.70	29.93′ RT	913.81	914.25	-			
68	FIFTH AVE	POT	557+34.70	29.93′ RT	913.84	*	-			
69	FIFTH AVE	POT	557+44.70	29.93′ RT	913.91	914.40	-			
70	FIFTH AVE	POT	557+54.70	29.93′ RT	913.94	914.49	-			
71	FIFTH AVE	POT	557+60.86	29.93′ RT	[913.98]	[914.28]	-			
72	FIFTH AVE	-	557+60.86	39.84′ RT	-	-	[914.68]			
73	FIFTH AVE	-	557+54.70	42.76′ RT	-	-	[914.63]			
74	FIFTH AVE	-	557+44.70	39.84′ RT	-	-	[914.52]			
75	FIFTH AVE	-	557+34.70	39.84′ RT	-	-	[914.45]			
76	FIFTH AVE	-	557+24.70	39.84′ RT	-	-	[914.35]			
77	FIFTH AVE	-	557+14.70	42.70′ RT	-	-	[914.39]			
78	FIFTH AVE	-	557+11.70	42.68′ RT	-	-	[914.37]			
79	FIFTH AVE	-	557+00.65	42.61′ RT	-	-	[914.25]			
80	FIFTH AVE	-	556+89.59	42.53′ RT	-	-	[914.07]			
81	FIFTH AVE	-	556+86.72	39.84′ RT	-	-	[913.97]			
82	FIFTH AVE	-	556+76.87	39.84′ RT	-	-	[913.86]			
83	FIFTH AVE	-	556+66.87	39.84′ RT	-	-	[913.72]			
84	FIFTH AVE	-	556+56.87	42.82′ RT	-	-	[913.73]			
85	FIFTH AVE	-	556+46.88	39.84′ RT	-	-	[913.57]			
86	FIFTH AVE	-	556+89.59	33.60′ RT	-	-	913.94			
87	FIFTH AVE	-	557+11.70	33.60′ RT	-	-	914.19			

[] MATCH EXISTING ELEVATION

<b>AECOM</b>
Gulf Tower
707 Grant Street
5th Floor
Pittsburgh, PA 15219

		THE PREPARATION OF THIS  DOCUMENT HAS BEEN FINANCED IN
		PART THROUGH A GRANT FROM THE
		FEDERAL TRANSIT ADMINISTRATION, U.S. DEPARTMENT OF
		TRANSPORTATION, UNDER THE
		URBAN MASS TRANSPORTATION ACT OF 1964, AS AMENDED, FOR THE
DATE	DESCRIPTION	PORT AUTHORITY OF ALLEGHENY COUNTY, PENNSYLVANIA.
	REVISIONS	COUNTY, FEMINGTEVANIA.

# (NOT FOR CONSTRUCTION)

ESIGNED	MJ <u>P/A</u> GO	
DRAWN	<u>JBM</u>	
CHECKED	BFS	
N CHARGE	LAR	
DATE	05/01/24	
CALE	AS SHOWN	I
	AO OHOWN	

### PORT AUTHORITY OF ALLEGHENY COUNTY PENNSYLVANIA


BUS RAPID TRANSIT UPTOWN TO OAKLAND
INTERSECTION DATA
FIFTH AVE & LYTTON AVE

Port Authority
connecting people to life

CONTRACT NO. BRT-001 sнт. 229

DWG. NO. D53



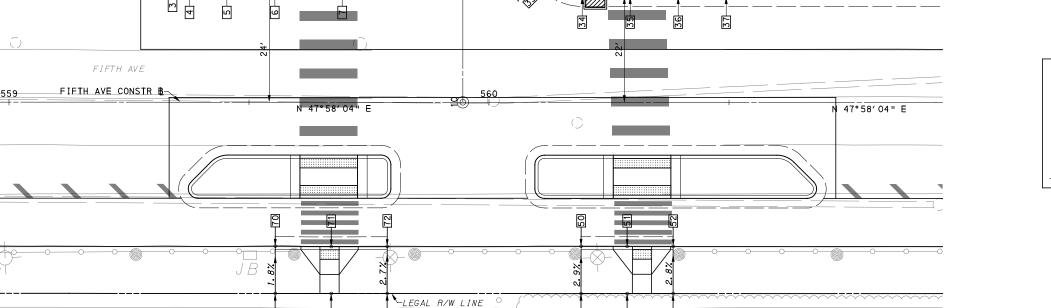

LEGEND

= 53 ELEVATION POINT IDENTIFICATION

DETECTIONAL INDICATOR

CURB RAMP

PAV'T SAW CUT LINE

<u>SCALE</u> 0 10 20 FEET

**AECOM** 

Gulf Tower 707 Grant Street 5th Floor Pittsburgh, PA 15219 THE PREPARATION OF THIS

DOCUMENT HAS BEEN FINANCED IN
PART THROUGH A GRANT FROM THE
FEDERAL TRANSIT ADMINISTRATION,
U.S. DEPARTMENT OF
TRANSPORTATION, UNDER THE
URBAN MASS TRANSPORTATION ACT
OF 1964, AS AMENDED, FOR THE
NO. DATE

DESCRIPTION
REVISIONS

THE PREPARATION OF THIS
POPTAL TRANSPORTATION OF THE
PORT AUTHORITY OF ALLEGHENY
COUNTY, PENNSYLVANIA.

(NOT FOR CONSTRUCTION)

ESIGNED	MJ <u>P/A</u> GO	
RAWN	<u>JBM</u>	
HECKED	<u>BFS</u>	
N CHARGE	LAR	
ATE	05/01/24	
CALE	AS SHOWN	
	AS SHOWIN	

TENNYSON AVE STATION

PORT AUTHORITY OF ALLEGHENY COUNTY PENNSYLVANIA

BUS RAPID TRANSIT UPTOWN TO OAKLAND

BUS RAPID TRANSIT UPTOWN TO OAKLAND
INTERSECTION DETAILS
FIFTH AVE & TENNYSON AVE

Port Authority CONTRAC DWG. NO. ID

CONTRACT NO. BRT-001

DWG. NO. ID54 SHT. 230

	NORTHWEST SHARRANT										
			NORTH	HWEST QUA	ADRANT						
POINT BASELINE		POINT	STATION	OFFSET	ELEVATION BOTTOM OF CURB	ELEVATION TOP OF CURB	ELEVATION BACK OF SIDEWALK				
1	FIFTH AVE	PC	559+27.43	30.02′ LT	[915.46]	[916.00]	_				
2	FIFTH AVE	PT	559+30.97	28.55′ LT	[915.52]	916.02	-				
3	FIFTH AVE	PC	559+34.06	25.46′ LT	[915.62]	916.10	_				
4	FIFTH AVE	PT	559+37.59	24.00' LT	[915.69]	916.15	-				
5	FIFTH AVE	POT	559+45.37	24.00′ LT	[915.77]	916.20	_				
6	FIFTH AVE	POT	559+55.37	24.00′ LT	[915.92]	916.42	-				
7	FIFTH AVE	PC	559+69.40	24.00′ LT	[916.21]	*	-				
8	FIFTH AVE	POC	559+76.45	26.94′ LT	[916.35]	916.93*	-				
9	TENNYSON AVE P	PT	10+33.99	15.17′ LT	[916.54]	*	_				
10	TENNYSON AVE	ENNYSON AVE POT 10+43.99 15.	15.17′ LT	[916.90]	917.48	-					
11	TENNYSON AVE	POT	10+55.27	15.17′ LT	[916.31]	[917.85]	_				
12	TENNYSON AVE	-	10+55.27	21.54′ LT	-	-	[917.98]				
13	TENNYSON AVE	-	10+44.00	25.47′ LT	-	-	[917.29]				
14	FIFTH AVE	-	559+55.37	39.27′ LT	-	-	[916.58]				
15	FIFTH AVE	-	559+45.37	38.47′ LT	-	-	[916.40]				
16	FIFTH AVE	-	559+37.59	37.76′ LT	-	-	[916.29]				
17	FIFTH AVE	-	559+34.06	37.81′ LT	-	-	[916.23]				
18	FIFTH AVE	-	559+30.97	37.78′ LT	-	-	[916.20]				
19	FIFTH AVE	-	559+27.43	37.76′ LT	-	-	[916.17]				

	NORTHEAST QUADRANT									
POINT BASELINE POINT		POINT	STATION	OFFSET	ELEVATION BOTTOM OF CURB	ELEVATION TOP OF CURB	ELEVATION BACK OF SIDEWALK			
30	TENNYSON AVE	POT	10+54.41	14.83′ RT	[917.15]	[917.78]	-			
31	TENNYSON AVE	POT	10+42.01	14.83′ RT	[916.85]	917.43	-			
32	TENNYSON AVE	PC	10+32.01	14.83′ RT	[916.62]	*	-			
33	FIFTH AVE	POC	560+12.31	24.92'LT	[916.49]	917.07	-			
34	FIFTH AVE	PŤ	560+19.40	22.00' LT	[916.43]	917.01	-			
35	FIFTH AVE	POT	560+29.40	22.00′ LT	[916.48]	*	-			
36	FIFTH AVE	POT	560+39.40	22.00′ LT	[916.56]	917.14	-			
37	FIFTH AVE	POT	560+49.40	22.00′ LT	[916.67]	917.25	-			
38	FIFTH AVE	-	560+49.40	37.67′LT	-	-	[917.45]			
39	FIFTH AVE	-	560+39.40	37.67′LT	-	-	[917.27]			
40	TENNYSON AVE	-	10+46.54	34.86; RT	-	-	[917.55]			
41	TENNYSON AVE	-	10+54.41	27.07′ RT	-	-	[917.84]			

	SOUTHWEST QUADRANT										
POINT NUMBER	BASELINE	POINT STATION OFFSET B		ELEVATION BOTTOM OF CURB	ELEVATION TOP OF CURB	ELEVATION BACK OF SIDEWALK					
70	FIFTH AVE	POT	559+55.47	29.97′ RT	[915.48]	[916.19]	-				
71	FIFTH AVE	POT	559+67.13	30.06′ RT	[915.55]	*	-				
72	FIFTH AVE	POT	559+78.79	30.01′ RT	[915.71]	[916.26]	-				
73	FIFTH AVE	-	559+78.79	39.83′ RT	-	-	[916.52]				
74	FIFTH AVE	-	559+67.13	39.83′ RT	-	-	[916.44]				
75	FIFTH AVE	-	559+55.47	39.83′ RT	-	-	[916.36]				

SOUTHEAST QUADRANT								
POINT NUMBER	BASEL INE	POINT	STATION	OFFSET	ELEVATION BOTTOM OF CURB	ELEVATION TOP OF CURB	ELEVATION BACK OF SIDEWALK	
50	FIFTH AVE	POT	560+19.19	29.98' RT	[916.01]	[916.45]	-	
51	FIFTH AVE	POT	560+28.78	30.00′ RT	[916.06]	*	-	
52	FIFTH AVE	POT	560+38.37	30.02′ RT	[916.13]	[916.63]	-	
53	FIFTH AVE	-	560+38.38	39.82′RT	-	-	[916.89]	
54	FIFTH AVE	-	560+28.78	39.82′ RT	-	-	[916.73]	
55	FIFTH AVE	-	560+19.19	39.82′RT	-	-	[916.72]	


sнт. 231


[] MATCH EXISTING ELEVATION


**AECOM** Gulf Tower 707 Grant Street 5th Floor Pittsburgh, PA 15219

		THE PREPARATION OF THIS DOCUMENT HAS BEEN FINANCED IN	
		PART THROUGH A GRANT FROM THE	
		FEDERAL TRANSIT ADMINISTRATION, U.S. DEPARTMENT OF	
		TRANSPORTATION, UNDER THE	
		URBAN MASS TRANSPORTATION ACT OF 1964, AS AMENDED, FOR THE	
ATE	DESCRIPTION	PORT AUTHORITY OF ALLEGHENY COUNTY, PENNSYLVANIA.	
	REVISIONS	COUNTY, FENNSTEVANIA.	

DESIGNED	MJ <u>P/A</u> GO	PORT	AUTHOR	ITY OF	ALLEGHENY	COL	JNT	7	
DRAWN	<u>JBM</u>	PITTSBURG	+			PENNS	YLVANI	A	
CHECKED	BFS	BUS	BUS RAPID TRANSIT UPTOWN TO OAKLAND						
IN CHARGE	LAR		IN	ITERSECTI	ON DATA				
DATE	05/01/24		FIFTH	I AVE & TEI	NNYSON AVE				
SCALE AS SHOWN		<b>Port Authority</b> ■		CONTRACT NO.		RT-00	)1		
	OUIOVII	connectin	g people to life	DWG. NO	. <b>I</b> D55		SHT.	23	

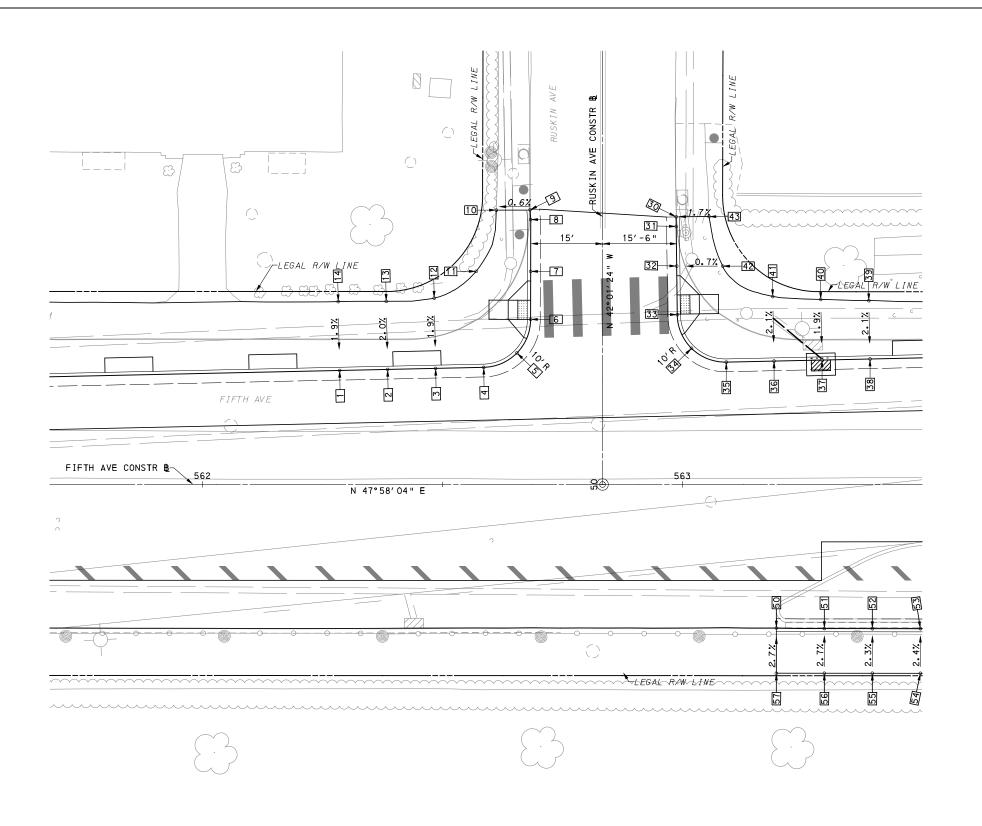

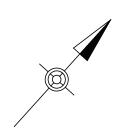

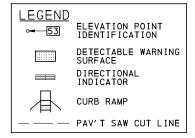

SCALE 0 10 20 FEET

**AECOM** 

Gulf Tower 707 Grant Street 5th Floor Pittsburgh, PA 15219 THE PREPARATION OF THIS

DOCUMENT HAS BEEN FINANCED IN
PART THROUGH A GRANT FROM THE
FEDERAL TRANSIT ADMINISTRATION,
U.S. DEPARTMENT OF
TRANSPORTATION, UNDER THE
URBAN MASS TRANSPORTATION ACT
OF 1964, AS AMENDED, FOR THE
NO. DATE

DESCRIPTION
REVISIONS

THE PREPARATION OF THIS
POPTAL TRANSPORTATION OF THE
PORT AUTHORITY OF ALLEGHENY
COUNTY, PENNSYLVANIA.

		FOR ROADWAY PLAN SEE	SHEET 381
DESIGNED MJ <u>P/A</u> GO	PORT AUTHOR	ITY OF ALLEGHENY CO	UNTY
DRAWN JBM	PITTSBURGH	PENN	SYLVANIA
CHECKED <u>BFS</u>	BUS RAPID TRANSIT UPTOWN TO OAKLAND		
IN CHARGE <u>LAR</u>	INTERSECTION DETAILS		
DATE <u>05/01/24</u>	FIF"	ΓΗ AVE & RUSKIN AVE	
SCALE AS SHOWN	Port Authority	CONTRACT NO. BRT-0	01
ASSHOWN	connecting people to life	DWG. NO.   <b>                  </b>	sнт. <b>232</b>

	NORTHWEST QUADRANT						
POINT NUMBER	BASELINE	POINT	STATION	OFFSET	ELEVATION BOTTOM OF CURB	ELEVATION TOP OF CURB	ELEVATION BACK OF SIDEWALK
1	FIFTH AVE	POT	562+28.60	23.73′ LT	[918.51]	918.93	-
2	FIFTH AVE	POT	562+38.60	23.95′LT	[918.60]	919.02	-
3	FIFTH AVE	POT	562+48.60	24.17'LT	[918.79]	919.21	-
4	FIFTH AVE	PC	562+58.61	24.39'LT	[919.08]	919.50	-
5	FIFTH AVE	POC	562+65.54	27.40′ LT	[919.27]	919.69	-
6	RUSK IN AVE	PT	50+34.39	15.00' LT	[919.37]	*	-
7	RUSK IN AVE	POT	50+44.39	15.00' LT	[919.77]	920.19	-
8	RUSK IN AVE	PΙ	50+55.18	15.00' LT	[920.26]	920.68	-
9	RUSK IN AVE	POT	50+57.20	15.14' LT	[920.33]	[ 920. 72]	-
10	RUSK IN AVE	-	50+57.15	22.17′LT	-	-	[ 920. 76]
11	RUSK IN AVE	-	50+44.39	26.37'LT	-	-	[919.95]
12	FIFTH AVE	-	562+48.29	38.80'LT	-	-	919.48
13	FIFTH AVE	-	562+38.20	38.15′LT	-	-	919.29
14	FIFTH AVE	-	562+28.30	38.09'LT	-	-	919.19

	NORTHEAST QUADRANT						
POINT NUMBER	BASEL INE	POINT	STATION	OFFSET	ELEVATION BOTTOM OF CURB	ELEVATION TOP OF CURB	ELEVATION BACK OF SIDEWALK
30	RUSKIN AVE	POT	50+55.76	15.31' RT	[ 920. 48]	[ 920. 89]	-
31	RUSKIN AVE	ΡI	50+53.76	15.32' RT	[ 920. 40]	920.81	-
32	RUSKIN AVE	POT	50+45.51	15. 42' RT	[920.08]	920.49*	-
33	RUSKIN AVE	PC	50+35.58	15.54′ RT	[919.79]	*	-
34	FIFTH AVE	POC	563+01.92	28.37' LT	[919.66]	920.07*	-
35	FIFTH AVE	PT	563+09.15	25.50' LT	[919.66]	920.08	-
36	FIFTH AVE	POT	563+19.11	25.72′LT	[919.66]	920.08	-
37	FIFTH AVE	POT	563+29.07	25.94′LT	[919.65]	920.07	-
38	FIFTH AVE	POT	563+39.10	26.16'LT	[919.74]	920.16	-
39	FIFTH AVE	-	563+38.84	38.33′LT	-	-	[ 920. 40]
40	FIFTH AVE	-	563+28.82	38.57′LT	-	-	[ 920. 30]
41	FIFTH AVE	-	563+18.81	39.17′LT	-	-	[ 920. 35]
42	RUSKIN AVE	-	50+45.49	25.01'LT	-	-	[ 920. 57]
43	RUSKIN AVE	-	50+55.82	22.15′LT	-	-	[921.02]


	SOUTH QUADRANT							
POINT NUMBER	BASEL INE	POINT	STATION	OFFSET	ELEVATION BOTTOM OF CURB	ELEVATION TOP OF CURB	ELEVATION BACK OF SIDEWALK	
50	FIFTH AVE	POT	563+19.61	28.89' RT	[919.21]	[919.71]	-	
51	FIFTH AVE	POT	563+29.61	30.00' RT	919.31	919.81	-	
52	FIFTH AVE	POT	563+39.61	30.00' RT	919.41	919.91	-	
53	FIFTH AVE	POT	563+49.61	30.00' RT	919.51	920.01	-	
54	FIFTH AVE	-	563+49.61	39.31′ RT	-	-	[920.22]	
55	FIFTH AVE	-	563+39.61	39.31′ RT	-	-	[920.11]	
56	FIFTH AVE	-	563+29.61	39.31′ RT	-	-	[920.04]	
57	FIFTH AVE	-	563+19.61	39.31' RT	-	-	[919.95]	

[] MATCH EXISTING ELEVATION

**AECOM** Gulf Tower 707 Grant Street 5th Floor Pittsburgh, PA 15219

		THE PREPARATION OF THIS DOCUMENT HAS BEEN FINANCED I
		PART THROUGH A GRANT FROM TH
		FEDERAL TRANSIT ADMINISTRATIO
		U.S. DEPARTMENT OF TRANSPORTATION, UNDER THE
		URBAN MASS TRANSPORTATION A
		OF 1964, AS AMENDED, FOR THE
DATE	DESCRIPTION	PORT AUTHORITY OF ALLEGHENY COUNTY, PENNSYLVANIA.
	REVISIONS	COUNTY, PENNSTEVANIA.

	DESIGNED N	Л <u>Р/A</u> GO	PORT AUTHORITY OF ALLEGHENY COU					
	DRAWN	<u>JBM</u>	PIT	TSBURGH		PEN	ISYLVAN	IA
	CHECKED	BFS	BUS RAPID TRANSIT UPTOWN TO OAKLAND INTERSECTION DATA				AND	
	IN CHARGE	LAR						
	DATE	05/01/24	FIFTH AVE & RUSKIN AVE			SKIN AVE		
	SCALE AS SHOWN		S SHOWN Port Authority		CONTRACT NO. BRT-001		01	
			. 0.0	connecting people to life	DWG NO	ID57	SHT	233

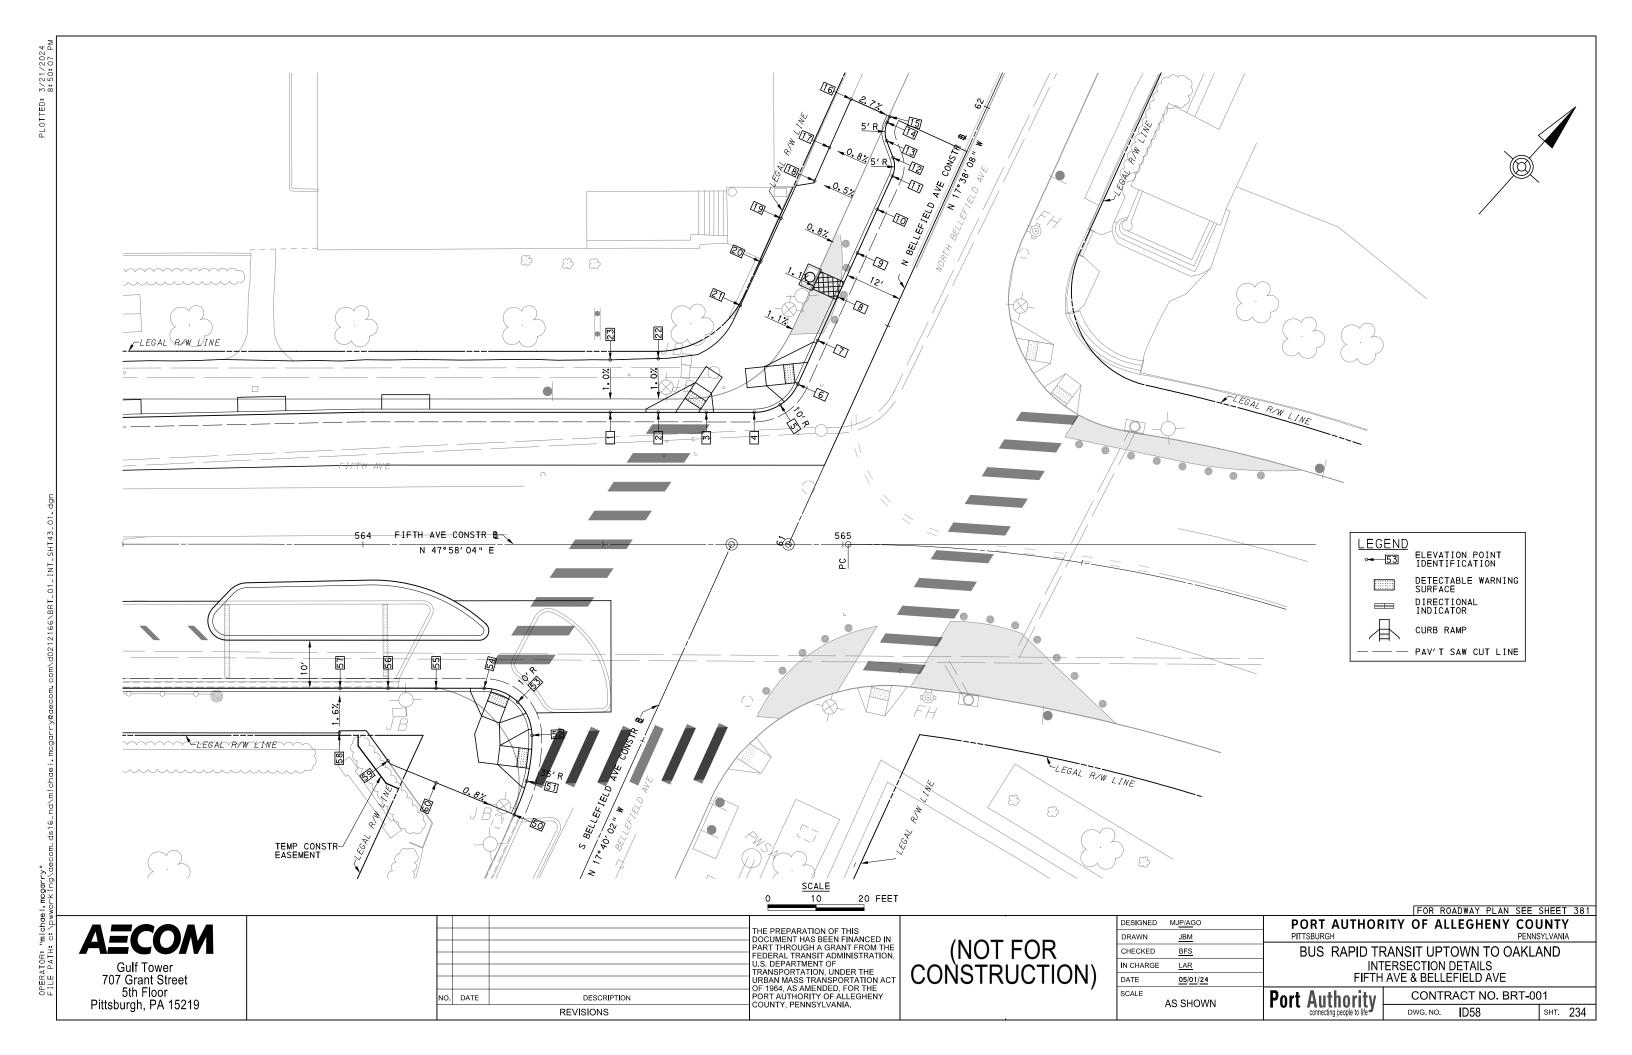

FILE PATH: c:\pwworking\aecom_ds16_na\michael.mcgarry@aecom.cor	
FILE PATH: O: \pw	Gulf Tower 707 Grant Street 5th Floor Pittsburgh, PA 15219


			NORTHV	VEST QUAD	DRANT		
POINT NUMBER	BASEL INE	POINT	STATION	OFFSET	ELEVATION BOTTOM OF CURB	ELEVATION TOP OF CURB	ELEVATION BACK OF SIDEWALK
1	FIFTH AVE	POT	564+51.52	27.50' LT	[920.96]	921.38	-
2	FIFTH AVE	POT	564+61.52	27.50' LT	[921.09]	921.51	-
3	FIFTH AVE	POT	564+71.52	27.50' LT	[921.20]	*	-
4	FIFTH AVE	PC	564+81.50	27.50' LT	[921.37]	921.79	-
5	FIFTH AVE	POC	564+86.91	29.09'LT	[921.54]	921.96	-
6	N BELLEFIELD AVE	PT	61+31.19	12.00' LT	[921.60]	*	-
7	N BELLEFIELD AVE	POT	61+41.19	12.00' LT	[921.90]	922.32	-
8	N BELLEFIELD AVE	POT	61+51.19	12.00' LT	[922.26]	922.68	-
9	N BELLEFIELD AVE	POT	61+61.20	12.00' LT	[922.68]	923.10	-
10	N BELLEFIELD AVE	POT	61+71.20	12.00' LT	[ 923.05]	923.47	-
11	N BELLEFIELD AVE	PC	61+78.82	12.00' LT	[923.34]	923.76	-
12	N BELLEFIELD AVE	PT	61+82.35	13.46′ LT	[923.41]	923.83	-
13	N BELLEFIELD AVE	PC	61+85.02	16.13'LT	[923.47]	923.89	-
14	N BELLEFIELD AVE	PT	61+88.55	17.59' LT	[923.60]	924.02	-
15	N BELLEFIELD AVE	POT	61+89.89	17.59' LT	[923.55]	923.76	-
16	N BELLEFIELD AVE	-	61+89.85	26.47'LT	-	-	[923.98]
17	N BELLEFIELD AVE	-	61+78.82	26.39'LT	-	-	[ 923.65]
18	N BELLEFIELD AVE	-	61+71.19	26.33'LT	-	-	[ 923. 40]
19	N BELLEFIELD AVE	-	61+61.20	29.49'LT	-	-	[923.54]
20	N BELLEFIELD AVE	-	61+51.20	29.61'LT	-	-	[922.87]
21	N BELLEFIELD AVE	-	61+41.20	29.69'LT	-	-	[922.06]
22	FIFTH AVE	-	564+61.51	38.72′LT	-	-	[921.62]
23	FIFTH AVE	-	564+51.50	38. 42' LT	-	-	921.48

	SOUTHWEST QUADRANT						
POINT NUMBER	BASEL INE	POINT	STATION	OFFSET	ELEVATION BOTTOM OF CURB	ELEVATION TOP OF CURB	ELEVATION BACK OF SIDEWALK
50	S BELLEFIELD AVE	POC	60+25.02	17.99'LT	[919.67]	[ 920. 06]	-
51	S BELLEFIELD AVE	POC	60+32.50	18.54' LT	[919.92]	*	-
52	S BELLEFIELD AVE	PRC	60+41.63	21.44′ LT	[ 920. 15]	*	-
53	FIFTH AVE	POC	564+32.24	32.86′ RT	[ 920. 26]	*	-
54	FIFTH AVE	PC	564+25.24	30.00' RT	920.18	*	-
55	FIFTH AVE	POT	564+15.24	30.00' RT	920.16	920.49	-
56	FIFTH AVE	POT	564+05.24	30.00′ RT	920.13	920.46	-
57	FIFTH AVE	POT	563+95.24	30.00' RT	920.11	920.44	-
58	FIFTH AVE	-	563+95.08	39.31′RT	-	-	[920.61]
59	FIFTH AVE	-	564+05.24	45. 10' RT	-	-	[ 920. 49]
60	S BELLEFIELD AVE	-	60+24.38	35.58′LT	-	-	[ 920. 19]

[] MATCH EXISTING ELEVATION

			Ī
		THE PREPARATION OF THIS DOCUMENT HAS BEEN FINANCED IN	
		PART THROUGH A GRANT FROM THE	
		FEDERAL TRANSIT ADMINISTRATION, U.S. DEPARTMENT OF	
		TRANSPORTATION, UNDER THE	
		URBAN MASS TRANSPORTATION ACT OF 1964, AS AMENDED, FOR THE	
DATE	DESCRIPTION	PORT AUTHORITY OF ALLEGHENY COUNTY, PENNSYLVANIA.	
	REVISIONS	COUNTY, FEMINISTEVANIA.	

ESIGNED	MJ <u>P/A</u> GO	PORT AUTHORITY OF ALLEGHENY COUNTY					
RAWN	<u>JBM</u>	PITTSBURGH	PENI	NSYLVAN <b>I</b> A			
HECKED	<u>BFS</u>	BUS RAPID TRANSIT UPTOWN TO OAKLAND					
CHARGE	<u>LAR</u>	INTERSECTION DATA					
ATE	<u>05/01/24</u>	FIFTH AVE & BELLEFIELD AVE					
CALE AS SHOWN		Port Authority	CONTRACT NO. BRT-001				
	AO OHOWN	connecting people to life	DWG NO ID50	SHT 235			

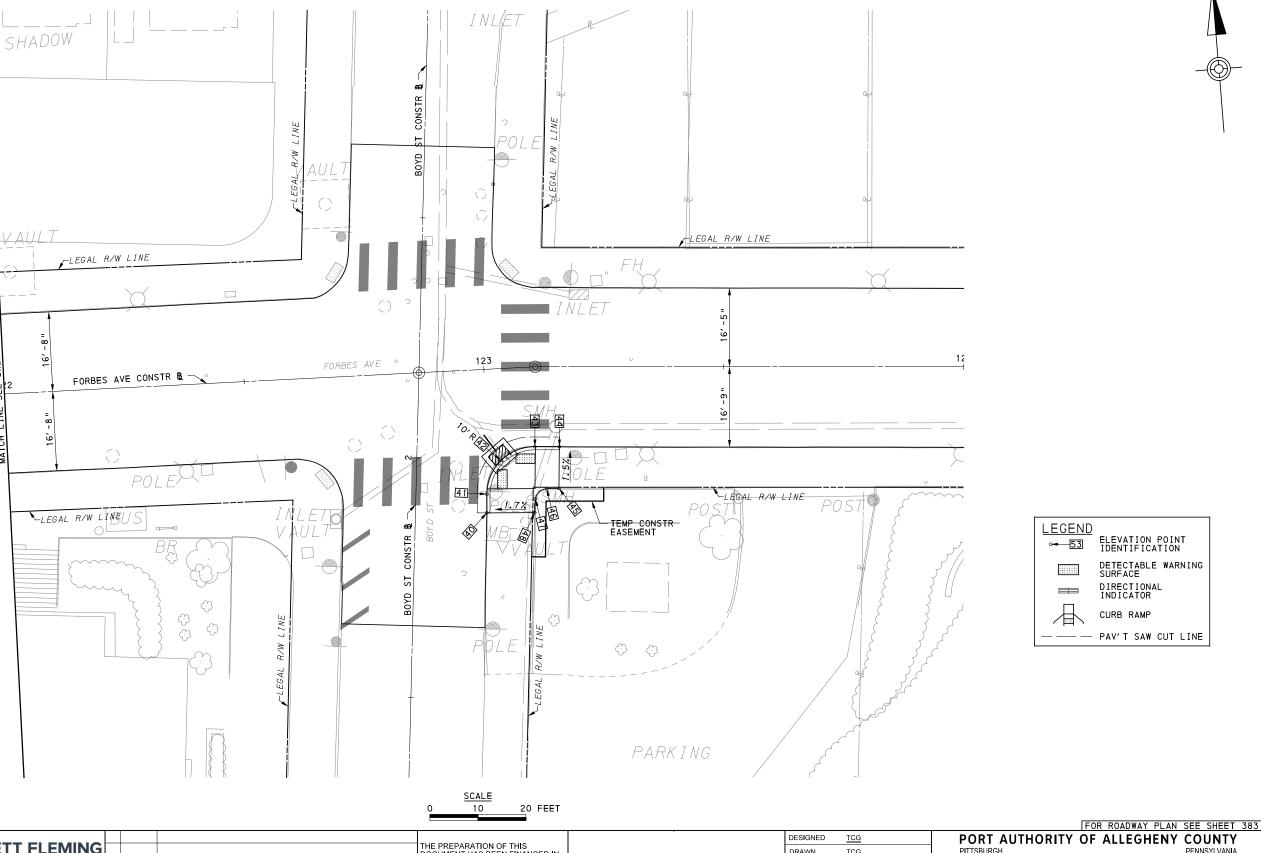

**AECOM** 

**Gulf Tower** 707 Grant Street 5th Floor Pittsburgh, PA 15219 GANNETT FLEMING Foster Plaza 8 Suite 400 730 Holiday Drive Pittsburgh, PA. 15220

THE PREPARATION OF THIS
DOCUMENT HAS BEEN FINANCED IN
PART THROUGH A GRANT FROM THE
FEDERAL TRANSIT ADMINISTRATION, PEDERAL TRANSIT ADMINISTRATION,
U.S. DEPARTMENT OF
TRANSPORTATION, UNDER THE
URBAN MASS TRANSPORTATION ACT
OF 1964, AS AMENDED, FOR THE
PORT AUTHORITY OF ALLEGHENY
COUNTY, PENNSYLVANIA. NO. DATE DESCRIPTION REVISIONS

(NOT FOR CONSTRUCTION)

DESIGNED	TCG	
DRAWN	<u>TCG</u>	
CHECKED	KCF	
IN CHARGE	GEC	
DATE	05/01/24	
SCALE		
	AS SHOWN	

BUS RAPID TRANSIT UPTOWN TO OAKLAND INTERSECTION DETAILS FORBES AVE & BOYD ST

Port Authority connecting people to life

CONTRACT NO. BRT-001 ID60 DWG. NO. sнт. 236

[] MATCH EXISTING ELEVATION


**AECOM** Gulf Tower 707 Grant Street 5th Floor Pittsburgh, PA 15219

GANNETT FLEMING GANNETT FLEMING, INC.

Foster Plaza 8 Suite 400 730 Holiday Drive Pittsburgh, PA. 15220

		THE PREPARATION OF THIS DOCUMENT HAS BEEN FINANCED IN PART THROUGH A GRANT FROM THE FEDERAL TRANSIT ADMINISTRATION, U.S. DEPARTMENT OF
DATE		TRANSPORTATION, UNDER THE URBAN MASS TRANSPORTATION ACT 0F 1964, AS AMENDED, FOR THE PORT AUTHORITY OF ALLEGHENY
DATE	DESCRIPTION	COUNTY, PENNSYLVANIA.
	REVISIONS	COUNTY, PENNSTEVANIA.

DESIGNED	<u>TCG</u>	PORT AUTHOR	ITY OF AL	LEGHENY COL	JNT	7	
DRAWN	TCG	PITTSBURGH		PENN	SYLVANI	A	
CHECKED	KCF	BUS RAPID TRANSIT UPTOWN TO OAKLAND					
IN CHARGE	<u>GEC</u>	INTERSECTION DATA					
DATE	<u>05/01/24</u>	FOI	FORBES AVE & BOYD ST				
SCALE	AS SHOWN	Port Authority	CONTR	ACT NO. BRT-00	)1		
	AO OI IOWN	connecting people to life	DWG, NO.	ID61	SHT.	237	

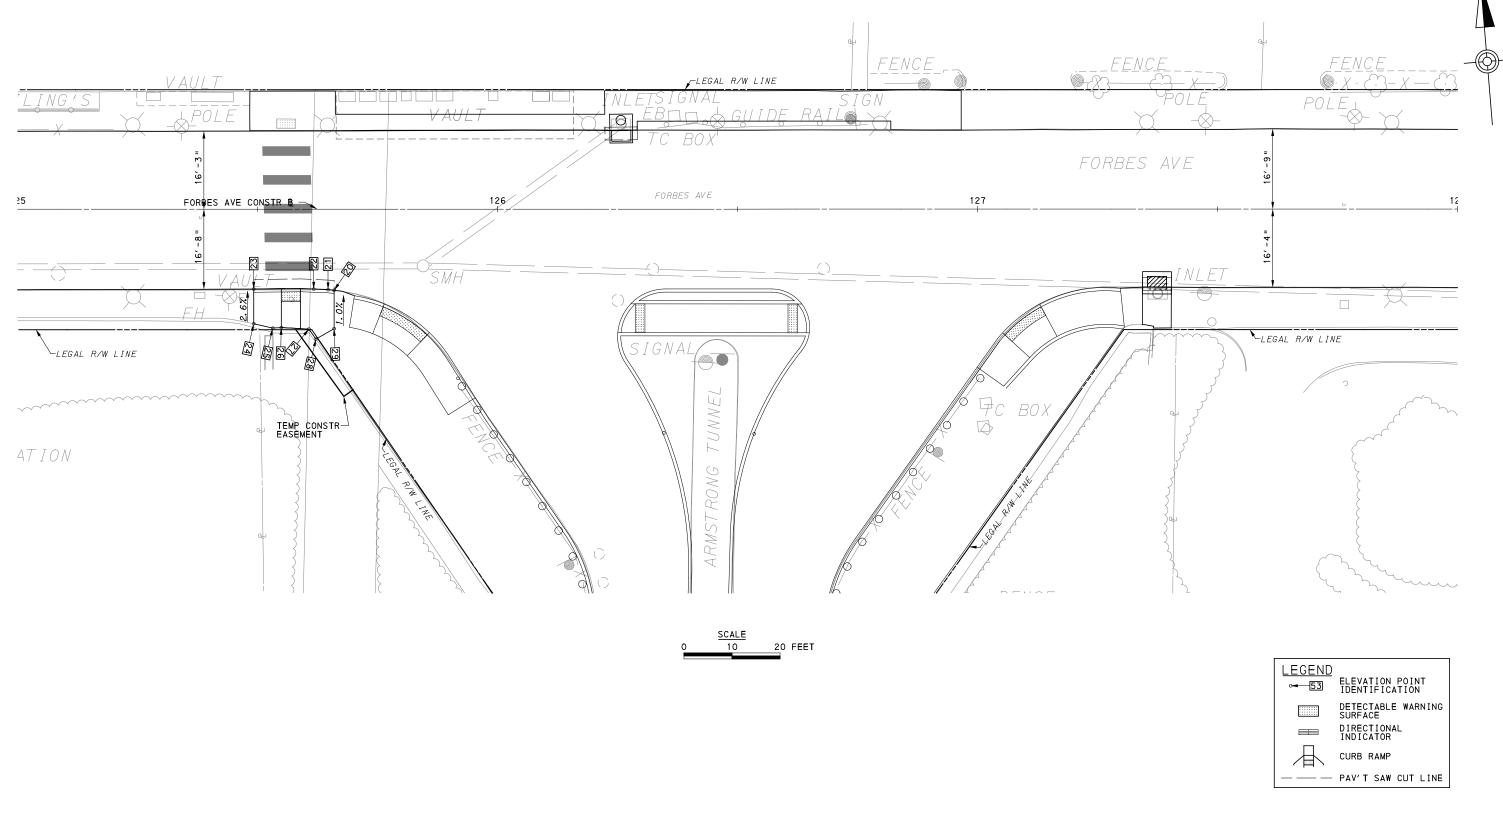

**AECOM** 

**Gulf Tower** 707 Grant Street 5th Floor Pittsburgh, PA 15219

GANNETT FLEMING Foster Plaza 8 Suite 400 730 Holiday Drive Pittsburgh, PA. 15220

THE PREPARATION OF THIS
DOCUMENT HAS BEEN FINANCED IN
PART THROUGH A GRANT FROM THE
FEDERAL TRANSIT ADMINISTRATION, PEDERAL TRANSIT ADMINISTRATION,
U.S. DEPARTMENT OF
TRANSPORTATION, UNDER THE
URBAN MASS TRANSPORTATION ACT
OF 1964, AS AMENDED, FOR THE
PORT AUTHORITY OF ALLEGHENY
COUNTY, PENNSYLVANIA. NO. DATE DESCRIPTION REVISIONS

(NOT FOR CONSTRUCTION)

DESIGNED	TCG	
DRAWN	<u>TCG</u>	
CHECKED	KCF	
IN CHARGE	<u>GEC</u>	
DATE	05/01/24	
SCALE		
	AS SHOWN	

FOR ROADWAY PLAN SEE SHEET 383 PORT AUTHORITY OF ALLEGHENY COUNTY

BUS RAPID TRANSIT UPTOWN TO OAKLAND INTERSECTION DETAILS FORBES AVE & ARMSTRONG TUNNEL

Port Authority connecting people to life CONTRACT NO. BRT-001 ID62 sнт. 238 DWG. NO.

	SOUTHWEST QUADRANT								
POINT NUMBER	BASEL INE	POINT	STATION	OFFSET	ELEVATION BOTTOM OF CURB	ELEVATION TOP OF CURB	ELEVATION BACK OF SIDEWALK		
20	FORBES AVE	POT	125+65.97	16.91′ RT	[789.65]	[789.76*]	-		
21	FORBES AVE	PC	125+64.71	16.77′ RT	789.62	*	-		
22	FORBES AVE	POC	125+61.72	16.65' RT	789.55	*	-		
23	FORBES AVE	PT	125+49.23	16.64' RT	[789.29]	[789.29*]	-		
24	FORBES AVE	POT	125+49.23	23.88′ RT	-	-	[789.69]		
25	FORBES AVE	POT	125+53.19	24.80′ RT	-	-	790.03		
26	FORBES AVE	POT	125+54.97	24.96′ RT	-	-	790.07		
27	FORBES AVE	POT	125+60.73	24.99' RT	-	-	790.19		
28	FORBES AVE	POT	125+62.19	27.05′ RT	-	-	[790.35]		
29	FORBES AVE	POT	125+65.97	24.89' RT	_	-	[790.31]		

[] MATCH EXISTING ELEVATION

**AECOM** Gulf Tower 707 Grant Street 5th Floor Pittsburgh, PA 15219

GANNETT FLEMING
GANNETT FLEMING, INC.
Foster Plaza 8
Suite 400
730 Holiday Drive
Pittsburgh, PA. 15220

		THE PREPARATION OF THIS DOCUMENT HAS BEEN FINANCED IN	
		PART THROUGH A GRANT FROM THE	
		FEDERAL TRANSIT ADMINISTRATION,	
		U.S. DEPARTMENT OF	
		TRANSPORTATION, UNDER THE	
		URBAN MASS TRANSPORTATION ACT OF 1964, AS AMENDED, FOR THE	
DATE	DESCRIPTION	PORT AUTHORITY OF ALLEGHENY COUNTY, PENNSYLVANIA.	
	REVISIONS	COUNTY, FERINGTEVANIA.	

DESIGNED	<u>TCG</u>	PORT AUTHOR	ITY OF ALLEGHENY C	OUNTY			
DRAWN	TCG	PITTSBURGH	PE	NNSYLVANIA			
CHECKED	KCF	BUS RAPID TRANSIT UPTOWN TO OAKLAND					
IN CHARGE	<u>GEC</u>	INTERSECTION DATA					
DATE	05/01/24	FORBES AVE & ARMSTRONG TUNNEL					
SCALE AS SHOWN		Port Authority	CONTRACT NO. BRT-001				
	OOHOWN	connecting people to life	DWG. NO. ID63	sнт. 239			

**Gulf Tower** 707 Grant Street 5th Floor Pittsburgh, PA 15219 Foster Plaza 8 Suite 400 730 Holiday Drive Pittsburgh, PA. 15220

PEDERAL TRANSIT ADMINISTRATION,
U.S. DEPARTMENT OF
TRANSPORTATION, UNDER THE
URBAN MASS TRANSPORTATION ACT
OF 1964, AS AMENDED, FOR THE
PORT AUTHORITY OF ALLEGHENY
COUNTY, PENNSYLVANIA. NO. DATE DESCRIPTION REVISIONS

(NOT FOR CONSTRUCTION)

DESIGNED	<u>TCG</u>	
DRAWN	TCG	
CHECKED	KCF	
IN CHARGE	GEC	
DATE	05/01/24	
SCALE	-	
	AS SHOWN	

INTERSECTION DETAILS FORBES AVE & CHATHAM SQ

Port Authority connecting people to life CONTRACT NO. BRT-001

ID64 DWG. NO. sнт. 240

	NORTHWEST QUADRANT								
POINT NUMBER	BASEL INE	POINT	STATION	OFFSET	ELEVATION BOTTOM OF CURB	ELEVATION TOP OF CURB	ELEVATION BACK OF SIDEWALK		
1	FORBES AVE	POT	128+90.36	16.59' LT	[799.25]	[799.50*]	-		
2	FORBES AVE	PC	128+94.36	16.58' LT	799.29	*	-		
3	CHATHAM SQ	POC	21+20.49	18.72' LT	798.87	*	-		
4	CHATHAM SQ	PT	21+31.06	14.47′ LT	[797.70]	[798.12*]	-		
5	FORBES AVE	POT	128+99.58	31.51′ LT	-	-	[798.38]		
6	FORBES AVE	POT	128+99.57	24.99' LT	-	-	798.93		
7	FORBES AVE	POT	128+90.38	24.92′ LT	-	-	[799.02]		

	NORTHEAST QUADRANT								
POINT NUMBER	BASEL INE	POINT	STATION	OFFSET	ELEVATION BOTTOM OF CURB	ELEVATION TOP OF CURB	ELEVATION BACK OF SIDEWALK		
20	CHATHAM SQ	POT	21+35.43	15.12' RT	[797.59]	[797.86]	-		
21	CHATHAM SQ	PC	21+27.25	15.06′ RT	798.68	*	-		
22	CHATHAM SQ	POC	21+20.06	18.04′ RT	799.54	*	-		
23	FORBES AVE	PT	129+48.82	16.63′ LT	799.99	*	-		
24	FORBES AVE	POT	129+64.35	16.64' LT	[800.20]	[800.27]	-		
25	FORBES AVE	POT	129+64.36	30.46′ LT	-	-	800.10		
26	FORBES AVE	POT	129+50.06	30.32′ LT	-	-	799.08		
27	FORBES AVE	POT	129+50.05	34.78′ LT	-	-	798.45		

SOUTHEAST QUADRANT								
POINT NUMBER	BASELINE	POINT	STATION	OFFSET	ELEVATION BOTTOM OF CURB	ELEVATION TOP OF CURB	ELEVATION BACK OF SIDEWALK	
40	McANULTY DR	POT	3+65.06	16.24′ RT	[801.29]	[801.74]	-	
41	McANULTY DR	PC	3+71.08	16.17′ RT	800.94	*	-	
42	McANULTY DR	POC	3+81.30	20.02' RT	800.34	*	-	
43	FORBES AVE	PT	129+52.74	16.50' RT	800.32	*	-	
44	FORBES AVE	POT	129+58.20	16.50' RT	800.45	800.79	-	
45	FORBES AVE	POT	129+68.00	16.50' RT	[800.57]	[800.81]	-	
46	FORBES AVE	POT	129+68.00	26.50' RT	-	-	[801.04]	
47	FORBES AVE	POT	129+63.06	26.50' RT	-	-	801.00	
48	FORBES AVE	POT	129+58.20	26.50' RT	-	-	800.92	
49	FORBES AVE	POT	129+58.20	30.93′ RT	-	-	800.98	
50	FORBES AVE	POT	129+52.37	32.13′ RT	-	-	801.26	
51	FORBES AVE	POT	129+48.39	37.20' RT	-	-	[801.90]	


[] MATCH EXISTING ELEVATION

**AECOM** Gulf Tower 707 Grant Street 5th Floor Pittsburgh, PA 15219

GANNETT FLEMING
GANNETT FLEMING, INC.
Foster Plaza 8
Suite 400
730 Holiday Drive
Pittsburgh, PA. 15220

		THE PREPARATION OF THIS
		DOCUMENT HAS BEEN FINANCED IN PART THROUGH A GRANT FROM THE
		FEDERAL TRANSIT ADMINISTRATION, U.S. DEPARTMENT OF
		TRANSPORTATION, UNDER THE
		URBAN MASS TRANSPORTATION ACT OF 1964, AS AMENDED, FOR THE
DATE	DESCRIPTION	PORT AUTHORITY OF ALLEGHENY COUNTY, PENNSYLVANIA.
	REVISIONS	COUNTY, FERRISTEVARIA.

DESIGNED	TCG	PORT AUTHOR	ITY OF ALL	EGHENY COL	JNTY	,
DRAWN	<u>TCG</u>	PITTSBURGH		PENNS	YLVANIA	4
CHECKED	<u>KCF</u>	BUS RAPID TRANSIT UPTOWN TO OAKLAND				
IN CHARGE	<u>GEC</u>	INTERSECTION DATA				
DATE	<u>05/01/24</u>	FORBES AVE & CHATHAM SQ				
SCALE AS SHOWN		Port Authority	CONTRACT NO. BRT-001			
,	AS SHOWN	connecting people to life	DWG. NO.	ID65	SHT.	241

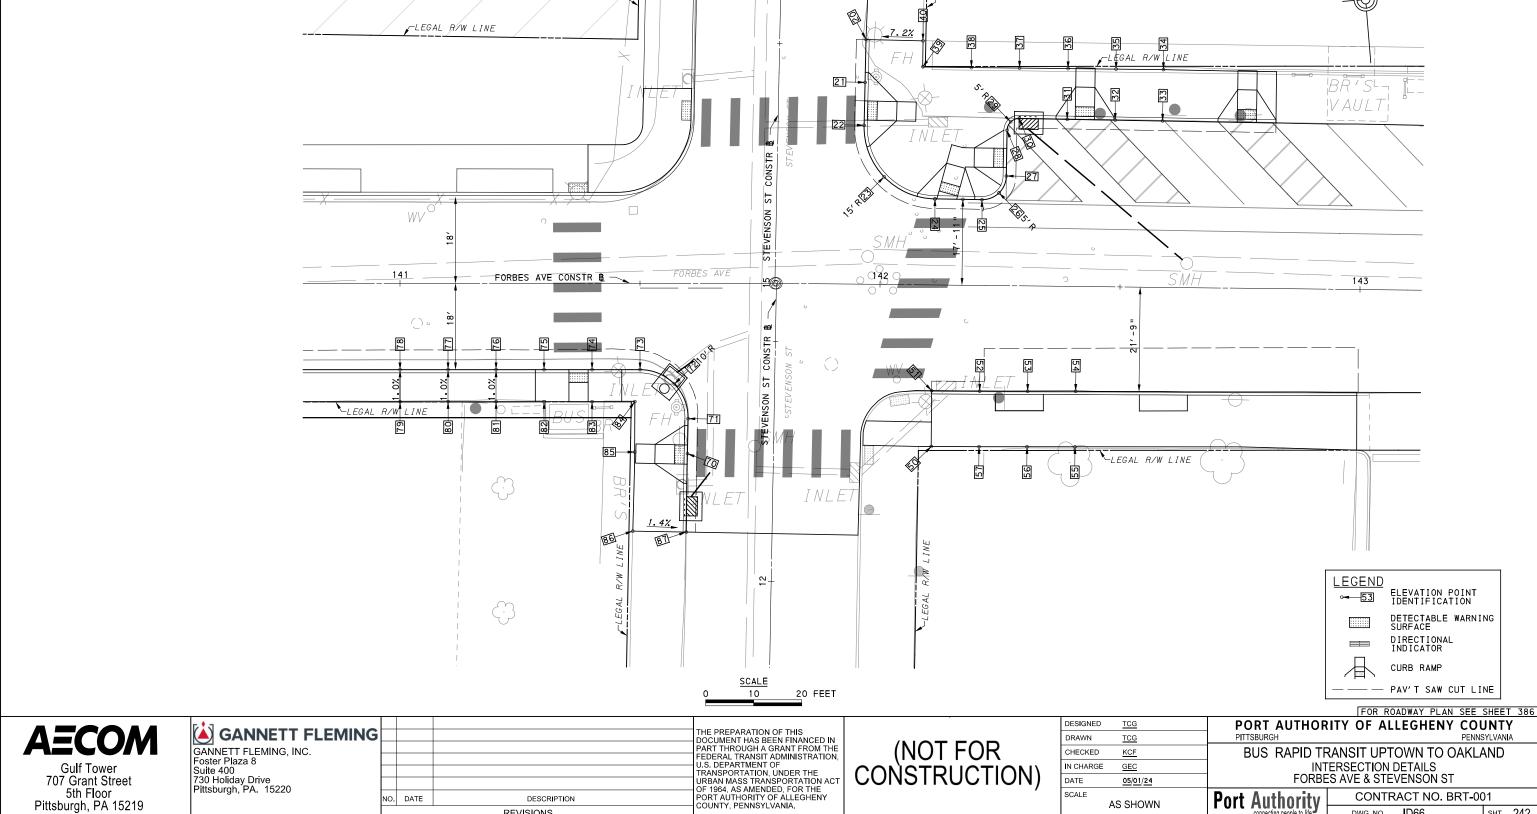

INTERSECTION DETAILS FORBES AVE & STEVENSON ST

DWG. NO.

CONTRACT NO. BRT-001

sнт. 242

ID66

Port Authority connecting people to life

N CHARGE

DATE

SCALE

GEC

05/01/24

AS SHOWN

**Gulf Tower** 

707 Grant Street

5th Floor Pittsburgh, PA 15219

NO. DATE

DESCRIPTION

REVISIONS

	SOUTHWEST QUADRANT								
POINT NUMBER	BASEL INE	POINT	STATION	OFFSET	ELEVATION BOTTOM OF CURB	ELEVATION TOP OF CURB	ELEVATION BACK OF SIDEWALK		
70	STEVENSON ST	POT	12+26.33	17.90' LT	[800.18]	*	-		
71	STEVENSON ST	PC	12+33.63	17.91' LT	800.07	*	-		
72	STEVENSON ST	POC	12+40.78	20.89' LT	799.70	*	-		
73	FORBES AVE	PT	141+50.01	18.00' RT	799.73	*	-		
74	FORBES AVE	POT	141+40.01	18.00' RT	799.76	*	-		
75	FORBES AVE	POT	141+30.01	18.00' RT	799.84	*	-		
76	FORBES AVE	POT	141+20.01	18.00' RT	799.99	800.32	-		
77	FORBES AVE	POT	141+10.01	18.00' RT	800.16	800.50	-		
78	FORBES AVE	POT	141+00.01	18.00' RT	800.36	800.70	-		
79	FORBES AVE	POT	141+00.01	24.67′ RT	-	-	800.76		
80	FORBES AVE	POT	141+10.01	24.67′ RT	-	-	800.56		
81	FORBES AVE	POT	141+20.01	24.67′ RT	-	-	800.38		
82	FORBES AVE	POT	141+30.01	24.67′ RT	-	-	800.25		
83	FORBES AVE	POT	141+40.01	24.67′ RT	-	-	800.19		
84	FORBES AVE	POT	141+48.92	24.67′ RT	-	-	[800.40]		
85	FORBES AVE	POT	141+48.90	35.17′ RT	-	-	[800.82]		
86	STEVENSON ST	POT	12+10.00	29.02' LT	-	-	[801.52]		
87	STEVENSON ST	POT	12+10.00	17.87' LT	[801.22]	[801.36]	-		

POINT NUMBER	BASEL INE	POINT	STATION	OFFSET	ELEVATION BOTTOM OF CURB	ELEVATION TOP OF CURB	ELEVATION BACK OF SIDEWAL
20	STEVENSON ST	POT	15+51.14	17.98' RT	[798.96]	[799.03]	-
21	STEVENSON ST	POT	15+42.21	17.95' RT	799.02	*	-
22	STEVENSON ST	PC	15+33.27	17.92' RT	799.13	*	-
23	STEVENSON ST	POC	15+22.61	22.32′ RT	799.24	799.57	-
24	FORBES AVE	PT	142+11.26	17.92' LT	799.41	*	-
25	FORBES AVE	PC	142+21.05	17.88' LT	799.50	*	-
26	FORBES AVE	POC	142+24.59	19.33' LT	799.49	799.82	-
27	FORBES AVE	PT	142+26.07	22.86′ LT	799.42	-	-
28	FORBES AVE	PC	142+26.12	32.38' LT	799.33	*	-
29	FORBES AVE	POC	142+26.86	34.14' LT	799.29	-	-
30	FORBES AVE	PT	142+28.63	34.87′ LT	799.25	-	-
31	FORBES AVE	POT	142+38.63	34.80' LT	799.3	*	-
32	FORBES AVE	POT	142+48.63	34.73' LT	799.48	709.81	-
33	FORBES AVE	POT	142+58.50	34.66' LT	799.71	800.04	-
34	FORBES AVE	POT	142+58.57	45.38' LT	-	-	800.6
35	FORBES AVE	POT	142+48.70	45.38' LT	-	-	800.41
36	FORBES AVE	POT	142+38.70	45.38' LT	-	-	800.17
37	FORBES AVE	POT	142+28.60	45.38' LT	-	-	800.02
38	FORBES AVE	POT	142+18.56	45.38' LT	-	-	799.84
39	FORBES AVE	POT	142+08.42	45.38' LT	-	-	799.65
40	FORBES AVE	POT	142+08.42	50.82′ LT	-	-	799.89

	SOUTHEAST QUADRANT								
POINT NUMBER	BASELINE	POINT	STATION	OFFSET	ELEVATION BOTTOM OF CURB	ELEVATION TOP OF CURB	ELEVATION BACK OF SIDEWALK		
50	FORBES AVE	POT	142+11.04	33.66′ RT	-	-	800.08		
51	FORBES AVE	POT	142+11.00	22.04′ RT	[799.4]	[799.98]	-		
52	FORBES AVE	POT	142+21.00	22.01′ RT	799.49	800.07	-		
53	FORBES AVE	POT	142+31.00	21.93′ RT	799.56	800.15	-		
54	FORBES AVE	POT	142+41.00	21.82′ RT	799.62	800.21	-		
55	FORBES AVE	POT	142+41.00	33.39′ RT	-	-	80.31		
56	FORBES AVE	POT	142+31.00	33.49′ RT	-	-	800.26		
57	FORBES AVE	POT	142+21.00	33.59′ RT	-	-	800.18		

[] MATCH EXISTING ELEVATION

**AECOM** 

Gulf Tower 707 Grant Street 5th Floor Pittsburgh, PA 15219

GANNETT FLEMING
GANNETT FLEMING, INC.
Foster Plaza 8
Suite 400
730 Holiday Drive
Pittsburgh, PA. 15220

		THE PREPARATION OF THIS DOCUMENT HAS BEEN FINANCED IN PART THROUGH A GRANT FROM THE FEDERAL TRANSIT ADMINISTRATION, U.S. DEPARTMENT OF TRANSPORTATION, UNDER THE URBAN MASS TRANSPORTATION ACT
DATE	DESCRIPTION	OF 1964, AS AMENDED, FOR THE PORT AUTHORITY OF ALLEGHENY COUNTY, PENNSYLVANIA.
	REVISIONS	COUNTY, PENNSTEVANIA.


(NOT FOR CONSTRUCTION)

DESIGNED	TCG	
DRAWN	<u>TCG</u>	
CHECKED	KCF	
IN CHARGE	<u>GEC</u>	
DATE	05/01/24	
SCALE		
	AS SHOWN	

	PORT PITTSBURG		JTHOR	ITY (	ΟF	Α	LL	ΕŒ	Н	ΕN	ΙY	COUNTY PENNSYLVANIA	
	BUS	R/		ITERS	EC	TIC	ÌΝ	DΑ	TΑ		_	AKLAND	
_	- 4	- 1	1.0		~~		-	. ~-				T 004	

Port Authority connecting people to life

CONTRACT NO. BRT-001 DWG. NO. ID67 sнт. 243

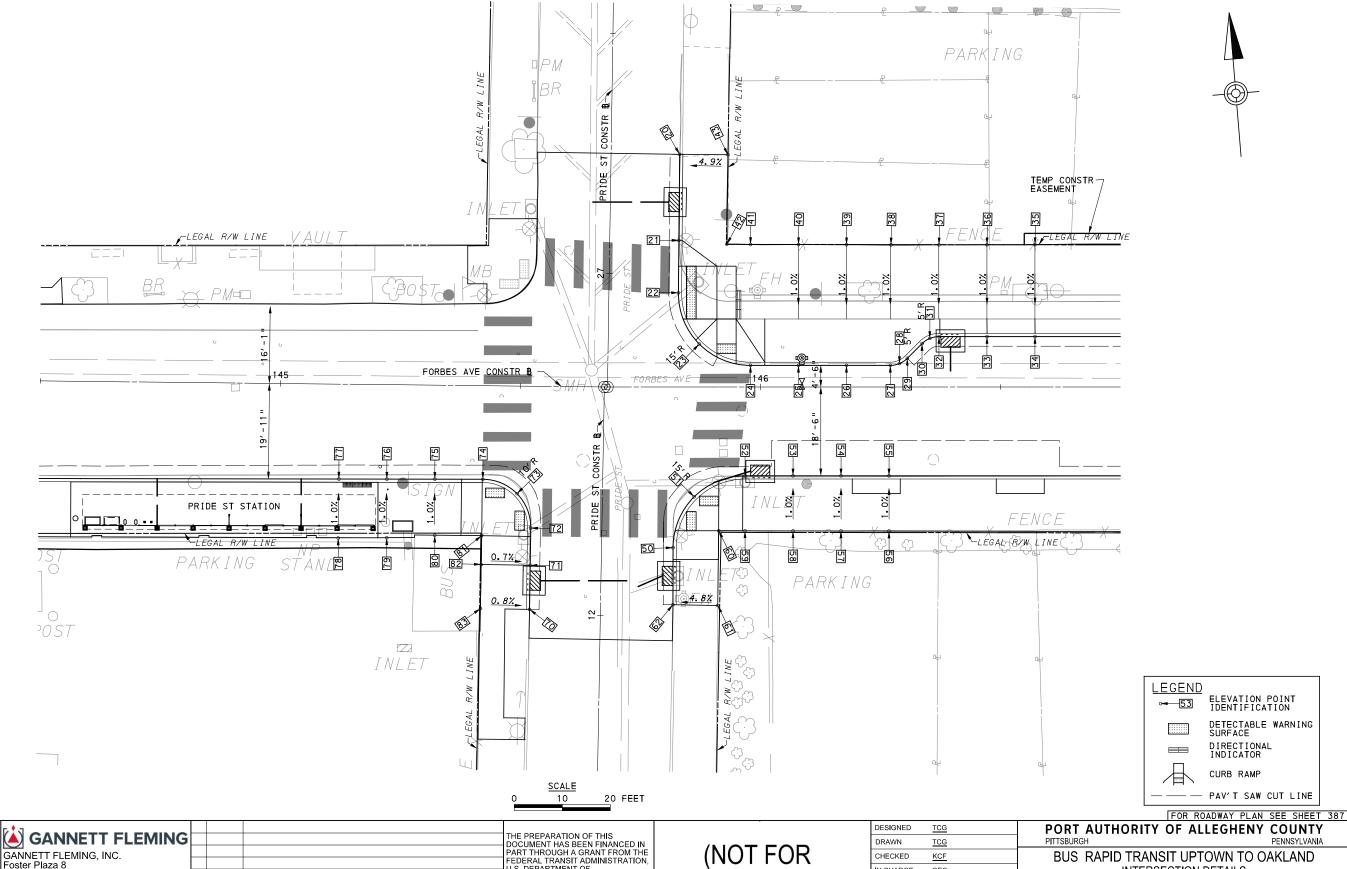

OPERATOR: "michael.mogarry"

Gulf Tower 707 Grant Street 5th Floor Pittsburgh, PA 15219

GANNETT FLEMING, INC. Foster Plaza 8 Suite 400 730 Holiday Drive Pittsburgh, PA. 15220

II FLEMIN NG, INC. 220 THE PREPARATION OF THIS DOCUMENT HAS BEEN FINANCED IN PART THROUGH A GRANT FROM THE FEDERAL TRANSIT ADMINISTRATION, U.S. DEPARTMENT OF TRANSPORTATION, UNDER THE URBAN MASS TRANSPORTATION ACT OF 1964, AS AMENDED, FOR THE PORT AUTHORITY OF ALLEGHENY COUNTY, PENNSYLVANIA.

REVISIONS

(NOT FOR CONSTRUCTION)

SCALE	AS SHOWN	
SCALE		
DATE	05/01/24	
IN CHARGE	<u>GEC</u>	
CHECKED	KCF	
DRAWN	<u>TCG</u>	
DESIGNED	<u>TCG</u>	

BUS RAPID TRANSIT UPTOWN TO OAKLAND
INTERSECTION DETAILS
FORBES AVE & PRIDE ST

Port Authority Own DW

CONTRACT NO. BRT-001

DWG. NO. ID68 SHT. 244

	SOUTHWEST QUADRANT								
POINT NUMBER	BASEL INE	POINT	STATION	0FFSET	ELEVATION BOTTOM OF CURB	ELEVATION TOP OF CURB	ELEVATION BACK OF SIDEWALK		
70	PRIDE ST	POT	12+01.01	14.78' LT	[804.39]	[804.66]	-		
71	PRIDE ST	POT	12+10.19	14.79' LT	804.09	804.45	-		
72	PRIDE ST	PC	12+17.95	14.81' LT	803.92	*	-		
73	FORBES AVE	POC	145+49.57	22.42′ RT	803.89	*	-		
74	FORBES AVE	PT	145+42.42	19.51' RT	803.58	*	-		
75	FORBES AVE	POT	145+32.42	19.60' RT	803.47	804.06	-		
76	FORBES AVE	POT	145+22.42	19.69' RT	803.32	803.9	-		
77	FORBES AVE	POT	145+12.42	19.78′ RT	803.19	803.77			
78	FORBES AVE	POT	145+12.42	32.07′ RT	-	-	803.89		
79	FORBES AVE	POT	145+22.53	31.90' RT	-	-	804.02		
80	FORBES AVE	POT	145+32.53	31.26′ RT	-	-	804.16		
81	FORBES AVE	POT	145+42.31	31.25′ RT	-	-	804.32		
82	FORBES AVE	POT	145+42.27	37.24′ RT	-	-	804.55		
83	FORBES AVE	POT	145+42.21	46.43′ RT	-	-	[804.73]		

	NORTHEAST QUADRANT								
POINT NUMBER	BASELINE	POINT	STATION	OFFSET	ELEVATION BOTTOM OF CURB	ELEVATION TOP OF CURB	ELEVATION BACK OF SIDEWALK		
20	PRIDE ST	POT	27+25.00	14.29' LT	[805.35]	[805.90]	-		
21	PRIDE ST	POT	27+07.09	14.40' LT	804.93	*	-		
22	PRIDE ST	PC	26+96.15	14.48′ LT	805.00	*	-		
23	PRIDE ST	POC	26+85.53	18.99' LT	805.08	*	-		
24	FORBES AVE	PT	145+97.96	4.50′ LT	805.16	*	-		
25	FORBES AVE	POT	146+07.96	4.50′ LT	805.36	805.77	-		
26	FORBES AVE	POT	146+17.96	4.50′ LT	805.55	805.97	-		
27	FORBES AVE	PC	146+27.10	4.50′ LT	805.74	806.15	-		
28	FORBES AVE	POC	146+29.02	4.88′ LT	805.78	806.19	-		
29	FORBES AVE	PT	146+30.64	5.96′ LT	805.79	806.21	-		
30	FORBES AVE	PC	146+33.71	9.04′ LT	805.79	806.21	-		
31	FORBES AVE	POC	146+35.33	10.12' LT	805.81	806.22	-		
32	FORBES AVE	PT	146+37.25	10.5′ LT	805.85	806.27	-		
33	FORBES AVE	POT	146+47.25	10.5′ LT	806.11	806.53	-		
34	FORBES AVE	POT	146+57.25	10.5′ LT	806.39	806.81	-		
35	FORBES AVE	POT	146+57.25	29.66′ LT	-	-	807.10		
36	FORBES AVE	POT	146+47.25	29.63′ LT	-	-	806.88		
37	FORBES AVE	POT	146+37.25	29.61′ LT	-	-	806.53		
38	FORBES AVE	POT	146+27.25	29.61' LT	-	-	806.36		
39	FORBES AVE	POT	146+17.96	29.64′ LT	-	-	806.2		
40	FORBES AVE	POT	146+07.96	29.67′ LT	-	=	806.01		
41	FORBES AVE	POT	145+97.96	29.69' LT	-	-	805.72		
42	FORBES AVE	POT	145+93.06	29.75′ LT	-	-	805.48		
43	FORBES AVE	POT	145+93.08	39.81′ LT	-	-	[805.72]		

	SOUTHEAST QUADRANT								
POINT NUMBER	BASELINE	POINT	STATION	OFFSET	ELEVATION BOTTOM OF CURB	ELEVATION TOP OF CURB	ELEVATION BACK OF SIDEWALK		
50	PRIDE ST	PC	12+14.38	14.90' RT	805.14	*	-		
51	PRIDE ST	POC	12+25.05	19.11' RT	805.14	*	-		
52	FORBES AVE	PT	145+96.83	18.50' RT	804.77	*	-		
53	FORBES AVE	POT	146+06.83	18.50' RT	804.98	805.31	-		
54	FORBES AVE	POT	146+16.83	18.50' RT	805.17	805.50	-		
55	FORBES AVE	POT	146+26.83	18.50′ RT	805.37	805.71	-		
56	FORBES AVE	POT	146+26.83	30.02' RT	-	-	805.81		
57	FORBES AVE	POT	146+16.83	30.00' RT	-	-	805.61		
58	FORBES AVE	POT	146+06.83	29.98' RT	-	-	805.42		
59	FORBES AVE	POT	145+96.83	29.96′ RT	-	-	805.28		
60	FORBES AVE	POT	145+91.34	29.95' RT	-	-	805.19		
61	FORBES AVE	POT	145+91.16	45.52′ RT	-	-	[805.57]		
62	PRIDE ST	POT	12+02.50	15.08' RT	[804.74]	[805.15]	-		

[] MATCH EXISTING ELEVATION


**AECOM** Gulf Tower 707 Grant Street 5th Floor Pittsburgh, PA 15219

GANNETT FLEMING
GANNETT FLEMING, INC.
Foster Plaza 8
Suite 400
730 Holiday Drive
Pittsburgh, PA. 15220

		THE PREPARATION OF THIS	
		DOCUMENT HAS BEEN FINANCED IN	
		PART THROUGH A GRANT FROM THE	
		FEDERAL TRANSIT ADMINISTRATION, U.S. DEPARTMENT OF	
		TRANSPORTATION, UNDER THE	
		URBAN MASS TRANSPORTATION ACT OF 1964, AS AMENDED, FOR THE	
ATE	DESCRIPTION	PORT AUTHORITY OF ALLEGHENY COUNTY, PENNSYLVANIA.	
	REVISIONS	COUNTY, FEININGTEVAINIA.	

DESIGNED	TCG	
DRAWN	<u>TCG</u>	
CHECKED	KCF	
IN CHARGE	GEC	
DATE	05/01/24	
SCALE		
	AS SHOWN	

<u>cg</u>	PORT AUTHOR	ITY OF AL	LEGHENY COL	JNTY
<u>cg</u>	PITTSBURGH		PENNS	SYLVANIA
CF	BUS RAPID TF	RANSIT UPT	OWN TO OAKLA	AND
EC		ITERSECTION		
<u>5/01/24</u>	FOF	RBES AVE & F	PRIDE ST	
SHOWN	Port Authority	CONTR	RACT NO. BRT-00	)1
SITOVVIA	connecting people to life	DWG. NO.	ID69	sнт. 245

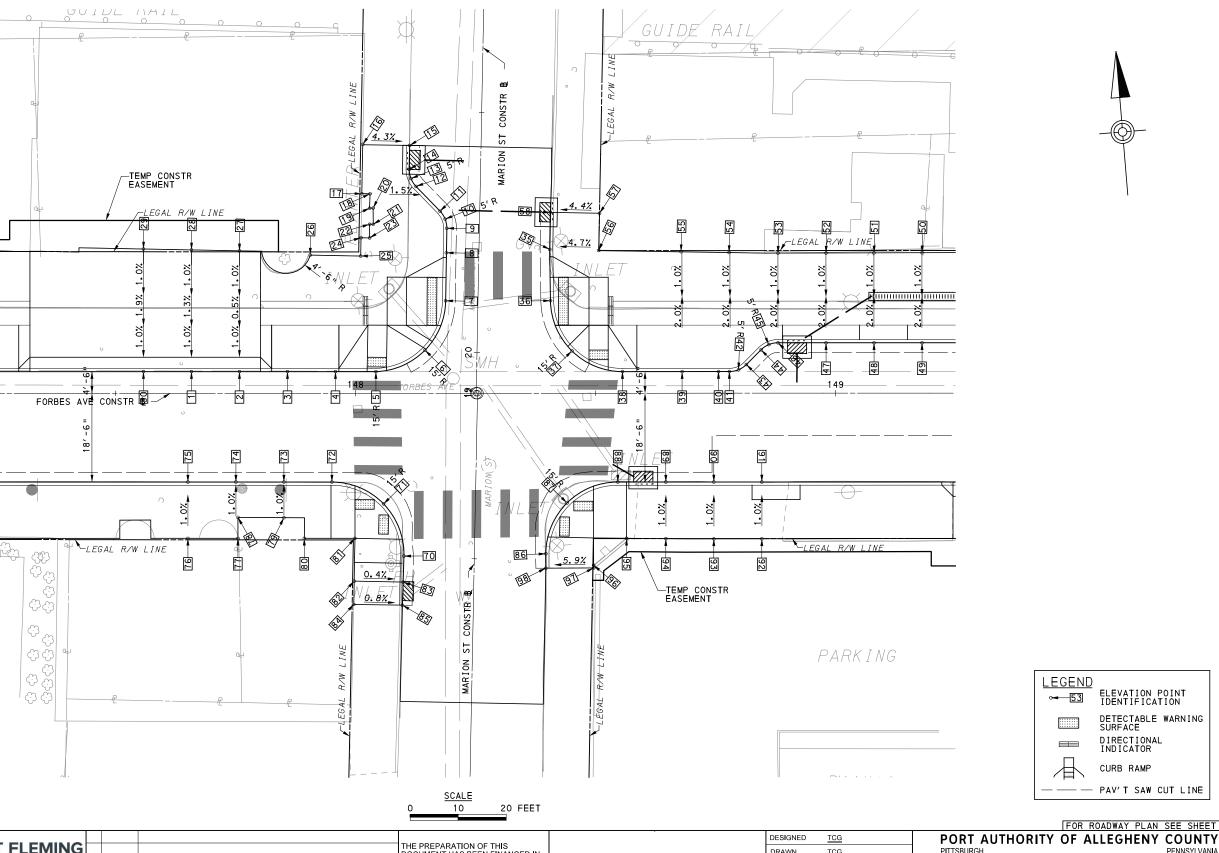

**AECOM** 

**Gulf Tower** 707 Grant Street 5th Floor Pittsburgh, PA 15219

GANNETT FLEMING Foster Plaza 8 Suite 400 730 Holiday Drive Pittsburgh, PA. 15220

THE PREPARATION OF THIS
DOCUMENT HAS BEEN FINANCED IN
PART THROUGH A GRANT FROM THE
FEDERAL TRANSIT ADMINISTRATION, PEDERAL TRANSIT ADMINISTRATION,
U.S. DEPARTMENT OF
TRANSPORTATION, UNDER THE
URBAN MASS TRANSPORTATION ACT
OF 1964, AS AMENDED, FOR THE
PORT AUTHORITY OF ALLEGHENY
COUNTY, PENNSYLVANIA. NO. DATE DESCRIPTION REVISIONS

(NOT FOR CONSTRUCTION)

DESIGNED	TCG	
DRAWN	<u>TCG</u>	
CHECKED	KCF	
IN CHARGE	<u>GEC</u>	
DATE	05/01/24	
SCALE	4.0.011014/81	
	AS SHOWN	

FOR ROADWAY PLAN SEE SHEET 387

BUS RAPID TRANSIT UPTOWN TO OAKLAND INTERSECTION DETAILS FORBES AVE & MARION ST

CONTRACT NO. BRT-001

Port Authority connecting people to life ID70 DWG. NO. sнт. 246

POINT NUMBER	BASEL INE	POINT	STATION	OFFSET	ELEVATION BOTTOM OF CURB	ELEVATION TOP OF CURB	ELEVATION BACK OF SIDEWA
1	FORBES AVE	POT	147+65.87	4.50' LT	809.29	809.50	-
2	FORBES AVE	POT	147+75.87	4.50' LT	809.52	809.73	-
3	FORBES AVE	POT	147+85.87	4.50' LT	809.75	810.17	-
4	FORBES AVE	POT	147+95.87	4.50' LT	809.98	*	-
5	FORBES AVE	PC	148+04.30	4.50′ LT	810.19	*	-
6	MARION ST	POC	20+00.27	10.84′ LT	810.43	*	-
7	MARION ST	PT	20+10.64	6.73′ LT	810.49	*	-
8	MARION ST	POT	20+20.64	6.78′ LT	810.58	*	-
9	MARION ST	PC	20+25.75	6.79′ LT	810.71	811.04	-
10	MARION ST	POC	20+27.67	7.18' LT	810.76	811.09	-
11	MARION ST	PT	20+29.28	8.27′ LT	810.76	811.09	-
12	MARION ST	PC	20+34.34	13.36′ LT	810.71	811.04	-
13	MARION ST	POC	20+35.96	14.45′ LT	810.73	811.06	-
14	MARION ST	PT	20+37.87	14.84' LT	810.79	811.12	-
15	MARION ST	POT	20+42.86	14.86' LT	[811.02]	[811.41]	-
16	FORBES AVE	POT	148+01.57	51.79' LT	-	-	[811.70]
17	FORBES AVE	POT	148+01.37	41.56' LT	-	-	811.49
18	FORBES AVE	POT	148+03.08	41.55′ LT	-	-	811.48
19	FORBES AVE	POT	148+02.99	38.55′ LT	-	-	811.27
20	FORBES AVE	POT	148+03.73	38.59' LT	-	-	811.23
21	FORBES AVE	POT	148+03.74	35.20' LT	-	-	810.93
22	FORBES AVE	POT	148+02.99	35.20' LT	-	-	810.93
23	FORBES AVE	POT	148+02.99	32.35′ LT	-	-	810.65
24	FORBES AVE	POT	148+01.20	32.39' LT	-	=	810.64
25	FORBES AVE	POT	148+01.13	28.58' LT	-	-	810.52
26	FORBES AVE	POT	147+90.61	28.78′ LT	-	-	810.07
27	FORBES AVE	POT	147+75.86	29.67′ LT	-	=	809.98
28	FORBES AVE	POT	147+65.87	29.86′ LT	-	-	809.77
29	FORBES AVE	POT	147+55.86	30.05′ LT	-	-	809.57
30	FORBES AVE	POT	147+55.86	4.50' LT	809.06	809.27	-

	SOUTHWEST QUADRANT											
POINT NUMBER	BASEL INE	POINT	STATION	OFFSET	ELEVATION BOTTOM OF CURB	ELEVATION TOP OF CURB	ELEVATION BACK OF SIDEWALK					
70	MARION ST	PC	12+50.27	14.68′ LT	810.05	*	-					
71	MARION ST	POC	12+61.07	19.13′ LT	810.06	*	-					
72	FORBES AVE	PT	147+95.13	18.50' RT	809.60	*	-					
73	FORBES AVE	POT	147+85.13	18.50′ RT	809.37	809.71	-					
74	FORBES AVE	POT	147+75.13	18.50′ RT	809.14	809.48	-					
75	FORBES AVE	POT	147+65.13	18.50′ RT	808.91	809.25	-					
76	FORBES AVE	POT	147+65.13	30.24′ RT	-	-	809.36					
77	FORBES AVE	POT	147+75.55	30.24′ RT	-	-	809.59					
78	FORBES AVE	POT	147+75.56	25.87′ RT	-	-	809.56					
79	FORBES AVE	POT	147+85.13	25.93′ RT	-	-	809.77					
80	FORBES AVE	POT	147+89.38	30.23′ RT	-	-	809.91					
81	FORBES AVE	POT	147+99.93	30.23′ RT	-	-	810.54					
82	FORBES AVE	POT	147+99.77	39.15′ RT	-	-	810.64					
83	MARION ST	POT	12+44.85	14.73′ LT	810.00	810.60	-					
84	FORBES AVE	POT	147+99.70	44.00' RT	-	-	[810.69]					
85	MARION ST	POT	12+40.04	14.78′ LT	[809.97]	[810.60]	-					

			NORTH	HEAST QUA	ADRANT		
POINT NUMBER	BASELINE	POINT	STATION	OFFSET	ELEVATION BOTTOM OF CURB	ELEVATION TOP OF CURB	ELEVATION BACK OF SIDEWALK
35	MARION ST	POT	20+21.78	14.73′ RT	810.94	[811.21]	-
36	MARION ST	PC	20+11.10	15.10' RT	810.78	*	-
37	MARION ST	POC	20+00.72	19.78′ RT	811.13	*	-
38	MARION ST	PT	148+55.67	4.50' LT	811.50	*	-
39	MARION ST	POT	148+68.10	4.50' LT	811.80	812.14	-
40	MARION ST	POT	148+75.67	4.50' LT	811.99	812.32	-
41	MARION ST	PC	148+77.94	4.50' LT	812.04	812.37	-
42	MARION ST	POC	148+79.85	4.88′ LT	812.08	812.41	-
43	MARION ST	PT	148+81.48	5.97′ LT	812.09	812.41	-
44	FORBES AVE	PC	148+84.54	9.03′ LT	812.10	812.40	-
45	FORBES AVE	POC	148+86.16	10.12' LT	812.09	812.43	-
46	FORBES AVE	PT	148+88.08	10.50' LT	812.12	812.46	-
47	FORBES AVE	POT	148+98.08	10.50' LT	812.36	812.69	-
48	FORBES AVE	POT	149+08.08	10.50' LT	812.62	812.95	-
49	FORBES AVE	POT	149+18.08	10.50' LT	812.88	813.22	-
50	FORBES AVE	POT	149+18.08	29.26′ LT	-	-	813.01
51	FORBES AVE	POT	149+08.08	29.24' LT	-	-	812.78
52	FORBES AVE	POT	148+98.08	29.21' LT	-	-	812.59
53	FORBES AVE	POT	148+88.08	29.18' LT	-	-	812.46
54	FORBES AVE	POT	148+77.98	29.30' LT	-	-	812.21
55	FORBES AVE	POT	148+67.88	29.48′ LT	-	-	811.89
56	FORBES AVE	POT	148+50.74	29.71′ LT	-	-	811.40
57	FORBES AVE	POT	148+50.88	37.48′ LT	-	-	[811.63]
58	MARION ST	POT	20+29.50	14.72' RT	[810.94]	[811.21]	-

			SULLE	JEAST OIL	A DR A NT								
	SOUTHEAST QUADRANT												
POINT NUMBER	BASELINE	POINT	STATION	OFFSET	BOTTOM OF CURB	ELEVATION TOP OF CURB	ELEVATION BACK OF SIDEWALK						
86	MARION ST	PC	12+51.34	14.88′ RT	810.73	*	-						
87	MARION ST	POC	12+62.00	19.08' RT	810.85	*	-						
88	FORBES AVE	PŤ	148+54.69	18.50' RT	811.11	*	-						
89	FORBES AVE	POT	148+64.69	18.50' RT	811.36	811.69	-						
90	FORBES AVE	POT	148+74.69	18.50' RT	811.60	811.94	-						
91	FORBES AVE	POT	148+84.69	18.50' RT	811.85	812.18	-						
92	FORBES AVE	POT	148+84.69	30.34′ RT	-	-	812.29						
93	FORBES AVE	POT	148+74.69	30.35′ RT	-	=	812.05						
94	FORBES AVE	POT	148+64.69	30.31' RT	-	-	811.80						
95	FORBES AVE	POT	148+56.51	30.23' RT	-	-	811.60						
96	FORBES AVE	POT	148+49.65	35.83′ RT	-	-	811.31						
97	FORBES AVE	POT	148+49.66	36.41′ RT	-	-	[811.32]						
98	MARION ST	POT	12+48.33	14.92' LT	[810.65]	[810.71*]	-						

sнт. 247

[] MATCH EXISTING ELEVATION

**AECOM** 

Gulf Tower 707 Grant Street 5th Floor Pittsburgh, PA 15219

GANNETT FLEMING
GANNETT FLEMING, INC.
Foster Plaza 8
Suite 400
730 Holiday Drive
Pittsburgh, PA. 15220


		THE PREPARATION OF THIS DOCUMENT HAS BEEN FINANCED IN
		PART THROUGH A GRANT FROM THE
		FEDERAL TRANSIT ADMINISTRATION, U.S. DEPARTMENT OF
		TRANSPORTATION, UNDER THE
		URBAN MASS TRANSPORTATION ACT OF 1964, AS AMENDED, FOR THE
DATE	DESCRIPTION	PORT AUTHORITY OF ALLEGHENY COUNTY, PENNSYLVANIA.
	REVISIONS	COUNTY, FEMINSTEVANIA.

(NOT FOR CONSTRUCTION)

DESIGNED	<u>TCG</u>	PORT AUTHOR	ITY C
DRAWN	TCG	PITTSBURGH	
CHECKED	KCF	BUS RAPID TF	RANSI
IN CHARGE	<u>GEC</u>	l IN	ITERSI
DATE	05/01/24	FOR	BES A
SCALE	AS SHOWN	Port Authority	C
	AS SHOWIN	I OIL / LUCITOTICS	

OF ALLEGHENY COUNTY PENNSYLVANIA SIT UPTOWN TO OAKLAND SECTION DATA AVE & MARION ST CONTRACT NO. BRT-001

DWG. NO. ID71 connecting people to life

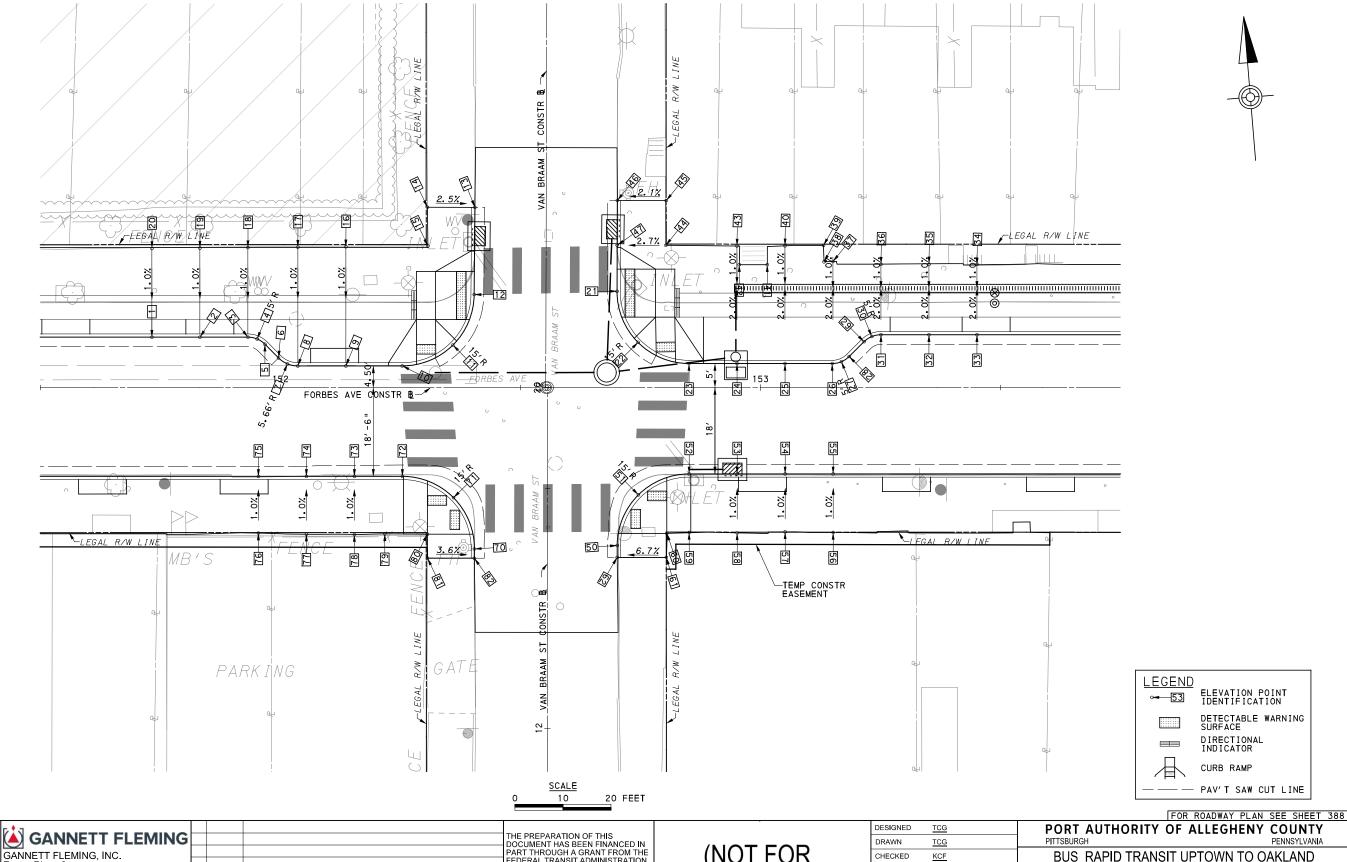

**AECOM Gulf Tower** 707 Grant Street 5th Floor Pittsburgh, PA 15219

Foster Plaza 8 Suite 400 730 Holiday Drive Pittsburgh, PA. 15220

THE PREPARATION OF THIS
DOCUMENT HAS BEEN FINANCED IN
PART THROUGH A GRANT FROM THE
FEDERAL TRANSIT ADMINISTRATION, PEDERAL TRANSIT ADMINISTRATION,
U.S. DEPARTMENT OF
TRANSPORTATION, UNDER THE
URBAN MASS TRANSPORTATION ACT
OF 1964, AS AMENDED, FOR THE
PORT AUTHORITY OF ALLEGHENY
COUNTY, PENNSYLVANIA. NO. DATE DESCRIPTION REVISIONS

(NOT FOR CONSTRUCTION)

DESIGNED	TCG	
DRAWN	<u>TCG</u>	
CHECKED	KCF	
IN CHARGE	GEC	
DATE	05/01/24	
SCALE	AS SHOWN	
	AS SHOWIN	

BUS RAPID TRANSIT UPTOWN TO OAKLAND INTERSECTION DETAILS FORBES AVE & VAN BRAAM ST

CONTRACT NO. BRT-001

Port Authority connecting people to life DWG. NO.

ID72 sнт. 248

			NORTH	HWEST QUA	ADRANT		
POINT NUMBER	BASELINE	POINT	STATION	OFFSET	ELEVATION BOTTOM OF CURB	ELEVATION TOP OF CURB	ELEVATION BACK OF SIDEWALK
1	FORBES AVE	POT	151+73.26	10.50 LT	819.51	819.85	-
2	FORBES AVE	P0 <b>T</b>	151+83.26	10.50' LT	819.78	820.11	-
3	FORBES AVE	PC	151+93.26	10.50' LT	820.06	820.39	-
4	FORBES AVE	POC	151+95.18	10.12' LT	820.12	820.46	-
5	FORBES AVE	PT	151+96.80	9.03′ LT	820.19	820.57	-
6	FORBES AVE	PC	151+99.65	6.17′ LT	820.42	820.71	-
7	FORBES AVE	POC	152+01.49	4.93′ LT	820.43	820.76	_
8	FORBES AVE	PT	152+03.66	4.50′ LT	820.49	820.82	-
9	FORBES AVE	POT	152+13.66	4.50' LT	820.72	821.06	-
10	FORBES AVE	PC	152+25.40	4.50' LT	820.99	*	-
11	FORBES AVE	POC	152+35.96	8.85′ LT	821.12	*	-
12	VAN BRAAM ST	PT	20+19.34	14.96' LT	821.28	*	-
13	VAN BRAAM ST	POT	20+37.50	14.86' LT	[821.68]	[821.87]	-
14	FORBES AVE	P0 <b>T</b>	152+30.67	37.57′ LT	-	-	[822.10]
15	FORBES AVE	POT	152+25.42	29.45′LT	-	-	821.81
16	FORBES AVE	POT	152+13.66	29.34′ LT	-	-	821.30
17	FORBES AVE	POT	152+03.66	29.25′ LT	-	-	821.05
18	FORBES AVE	POT	151+93.26	29.15' LT	-	-	820.57
19	FORBES AVE	POT	151+83.26	29.06' LT	-	=	820.29
20	FORBES AVE	POT	151+73.26	28.97′ LT	-	-	820.20

	SOUTHWEST QUADRANT											
POINT NUMBER	BASEL INE	POINT	STATION	OFFSET	ELEVATION BOTTOM OF CURB	ELEVATION TOP OF CURB	ELEVATION BACK OF SIDEWALK					
70	VAN BRAAM ST	PŤ	12+37.38	15.25' LT	820.32	*	-					
71	VAN BRAAM ST	POC	12+48.06	19.61' LT	820.76	*	-					
72	FORBES AVE	PC	152+25.44	18.50' RT	820.63	*	-					
73	FORBES AVE	POT	152+15.44	18.50' RT	820.40	820.74	-					
74	FORBES AVE	POT	152+05.44	18.50' RT	820.17	820.51	-					
75	FORBES AVE	POT	151+95.44	18.50' RT	819.93	820.26	-					
76	FORBES AVE	POT	151+95.44	30.32' RT	-	-	820.37					
77	FORBES AVE	POT	152+05.44	30.55′ RT	-	-	820.62					
78	FORBES AVE	POT	152+15.43	30.59' RT	-	-	820.85					
79	FORBES AVE	POT	152+21.77	30.47′ RT	-	-	820.99					
80	FORBES AVE	POT	152+30.66	30.56' RT	-	-	820.99					
81	FORBES AVE	POT	152+30.68	35.56′ RT	-	-	[820.83]					
82	VAN BRAAM ST	POT	12+35.44	15.25' LT	[820.25]	[820.50*]	-					

			NORTH	HEAST QUA	ADRANT		
POINT NUMBER	BASELINE	POINT	STATION	OFFSET	ELEVATION BOTTOM OF CURB	ELEVATION TOP OF CURB	ELEVATION BACK OF SIDEWALK
21	VAN BRAAM ST	PC	20+20.10	14.80' RT	821.63	*	-
22	VAN BRAAM ST	POC	20+09.47	19.20' RT	821.84	*	-
23	FORBES AVE	PT	152+85.16	5.00' LT	822.19	*	-
24	FORBES AVE	POT	152+95.16	5.00' LT	822.36	822.70	-
25	FORBES AVE	POT	153+05.16	5.00' LT	822.57	822.91	-
26	FORBES AVE	PC	153+14.99	5.00' LT	822.80	823.14	-
27	FORBES AVE	POC	153+16.90	5.38′ LT	822.84	823.15	-
28	FORBES AVE	PŤ	153+18.52	6.46′ LT	822.84	823.16	-
29	FORBES AVE	PC	153+21.62	9.54′ LT	822.85	823.18	-
30	FORBES AVE	POC	153+23.24	10.62' LT	822.85	823.18	-
31	FORBES AVE	PT	153+25.15	11.00' LT	822.88	823.20	-
32	FORBES AVE	POT	153+35.15	11.00' LT	823.10	823.43	-
33	FORBES AVE	POT	153+45.15	11.00' LT	823.34	823.67	-
34	FORBES AVE	POT	153+45.15	25.56' LT	-	-	823.87
35	FORBES AVE	POT	153+35.15	25.78' LT	-	-	823.44
36	FORBES AVE	POT	153+25.15	25.71′ LT	-	-	822.97
37	FORBES AVE	POT	153+15.15	26.25' LT	-	-	822.55
38	FORBES AVE	POT	153+13.27	26.18' LT	-	-	822.51
39	FORBES AVE	POT	153+13.17	29.61' LT	-	-	822.68
40	FORBES AVE	POT	153+05.15	29.52' LT	-	-	822.38
41	FORBES AVE	POT	153+01.46	25.59' LT	-	-	822.13
42	FORBES AVE	POT	152+95.63	25.59' LT	-	-	821.97
43	FORBES AVE	POT	152+95.15	29.48' LT	-	-	822.07
44	FORBES AVE	POT	152+80.33	29.63' LT	-	-	822.19
45	VAN BRAAM ST	POT	20+39.02	24.91' RT	-	-	[822.45]
46	VAN BRAAM ST	POT	20+39.02	14.81′ RT	[822.07]	[822.32]	-
47	VAN BRAAM ST	POT	20+29.70	14.81' RT	821.85	821.93*	-

			SOUTH	HEAST QUA	ADRANT		
POINT NUMBER	BASELINE	POINT	STATION	OFFSET	ELEVATION BOTTOM OF CURB	ELEVATION TOP OF CURB	ELEVATION BACK OF SIDEWALK
50	VAN BRAAM ST	PC	12+38.13	14.49′ RT	820.75	*	-
51	VAN BRAAM ST	POC	12+48.67	18.91′ RT	821.43	*	-
52	FORBES AVE	PT	152+85.18	18.00' RT	821.82	*	-
53	FORBES AVE	POT	152+95.18	18.00' RT	821.89	822.23	-
54	FORBES AVE	POT	153+05.18	18.00′ RT	822.10	822.44	-
55	FORBES AVE	POT	153+15.18	18.00′ RT	822.34	822.67	-
56	FORBES AVE	POT	153+15.19	30.20' RT	-	-	822.79
57	FORBES AVE	POT	153+05.18	30.06′ RT	-	-	822.55
58	FORBES AVE	POT	152+95.18	30.27′ RT	-	-	822.34
59	FORBES AVE	POT	152+85.18	30.25′ RT	-	-	822.23
60	FORBES AVE	POT	152+80.52	30.38′ RT	-	-	821.89
61	FORBES AVE	POT	152+80.42	35.38′ RT	-	-	[821.53]
62	VAN BRAAM ST	POT	12+35.65	14.49' RT	[820.62]	[820.89*]	-

### NOTE:

\* TOP OF CURB ELEVATION TO BE DETERMINED PER ITEM # 01900.001-DESIGN OF CURB RAMPS

[] MATCH EXISTING ELEVATION

<b>AECOM</b>
Gulf Tower 707 Grant Street 5th Floor Pittsburgh, PA 15219

GANNETT FLEMING
GANNETT FLEMING, INC.
Foster Plaza 8
Suite 400
730 Holiday Drive
Pittsburgh, PA. 15220

THE PREPARATION OF THIS
DOCUMENT HAS BEEN FINANCED IN
PART THROUGH A GRANT FROM THE
FEDERAL TRANSIT ADMINISTRATION,
U.S. DEPARTMENT OF
TRANSPORTATION, UNDER THE
URBAN MASS TRANSPORTATION ACT
OF 1964, AS AMENDED, FOR THE
PORT AUTHORITY OF ALLEGHENY
COUNTY, PENNSYLVANIA.

(NOT FOR CONSTRUCTION)

DESIGNED	TCG		1
DRAWN	<u>TCG</u>	, and the second	L
CHECKED	KCF		l
IN CHARGE	<u>GEC</u>		l
DATE	<u>05/01/24</u>		
SCALE			Ī
	V & SHOWN		

## PORT AUTHORITY OF ALLEGHENY COUNTY PITTSBURGH PENNSYLVANIA BUS RAPID TRANSIT UPTOWN TO OAKLAND

SUS RAPID TRANSIT UPTOWN TO OAKLAND INTERSECTION DATA FORBES AVE & VAN BRAAM ST

Port Authority connecting people to life

CONTRACT NO. BRT-001

DWG. NO. ID73 SHT. 249


URBAN MASS TRANSPORTATION ACT OF 1964, AS AMENDED, FOR THE PORT AUTHORITY OF ALLEGHENY COUNTY, PENNSYLVANIA.

URBAN MASS TRANSPORTATION ACT OF 1964, AS AMENDED, FOR THE PORT AUTHORITY OF ALLEGHENY COUNTY, PENNSYLVANIA.

DATE 05/01/24

SCALE SCALE

AS SHOWN

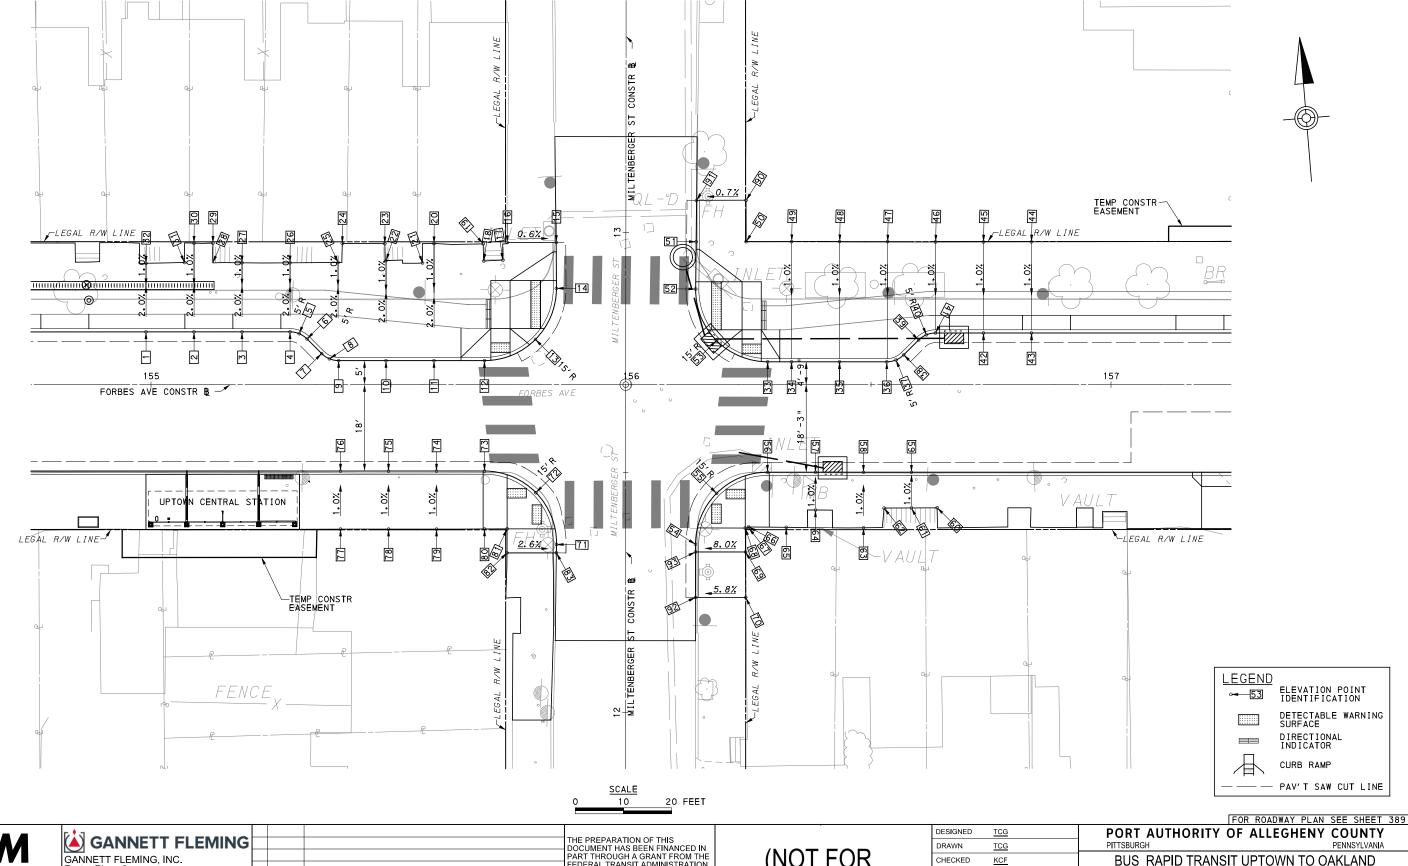

**AECOM Gulf Tower** 707 Grant Street

5th Floor Pittsburgh, PA 15219

Foster Plaza 8 Suite 400 730 Holiday Drive Pittsburgh, PA. 15220

THE PREPARATION OF THIS
DOCUMENT HAS BEEN FINANCED IN
PART THROUGH A GRANT FROM THE
FEDERAL TRANSIT ADMINISTRATION, PEDERAL TRANSIT ADMINISTRATION,
U.S. DEPARTMENT OF
TRANSPORTATION, UNDER THE
URBAN MASS TRANSPORTATION ACT
OF 1964, AS AMENDED, FOR THE
PORT AUTHORITY OF ALLEGHENY
COUNTY, PENNSYLVANIA. NO. DATE DESCRIPTION REVISIONS

(NOT FOR CONSTRUCTION)

DESIGNED	TCG	
DRAWN	<u>TCG</u>	
CHECKED	KCF	
IN CHARGE	GEC	
DATE	05/01/24	
SCALE		
	AS SHOWN	

BUS RAPID TRANSIT UPTOWN TO OAKLAND INTERSECTION DETAILS FORBES AVE & MILTENBERGER ST

Port Authority connecting people to life CONTRACT NO. BRT-001 **I**D74 DWG. NO. sнт. 250

NORTHWEST QUADRANT							
POINT NUMBER	BASEL INE	POINT	STATION	OFFSET	ELEVATION BOTTOM OF CURB	ELEVATION TOP OF CURB	ELEVATION BACK OF SIDEWALK
1	FORBES AVE	POT	154+98.96	11.00' LT	827.22	827.55	-
2	FORBES AVE	POT	155+08.96	11.00' LT	827.47	827.80	-
3	FORBES AVE	POT	155+18.96	11.00' LT	827.72	828.06	-
4	FORBES AVE	PC	155+28.96	11.00' LT	827.99	828.31	-
5	FORBES AVE	POC	155+30.87	10.62' LT	828.05	828.38	-
6	FORBES AVE	PŤ	155+32.50	9.53′ LT	828.12	828.46	-
7	FORBES AVE	PC	155+35.54	6.47′ LT	828.28	828.63	-
8	FORBES AVE	POC	155+37.17	5.38' LT	828.35	828.68	-
9	FORBES AVE	PT	155+39.08	5.00' LT	828.41	828.73	-
10	FORBES AVE	POT	155+48.96	5.00' LT	828.66	829.00	-
11	FORBES AVE	POT	155+58.96	5.00' LT	828.96	829.29	-
12	FORBES AVE	PC	155+69.46	5.00' LT	829.27	*	-
13	MILTENBERGER ST	POC	12+77.74	18.81' LT	829.43	*	-
14	MILTENBERGER ST	PT	12+88.38	14.45′ LT	829.49	*	-
15	MILTENBERGER ST	POT	12+97.97	14.50' LT	[829.51]	[829.79*]	-
16	FORBES AVE	POT	155+74.21	29.60' LT	-	-	[829.85]
17	FORBES AVE	POT	155+73.30	25.95′ LT	-	-	829.65
18	FORBES AVE	POT	155+69.31	25.75′ LT	-	-	829.43
19	FORBES AVE	POT	155+69.21	29.33' LT	-	-	829.45
20	FORBES AVE	POT	155+58.96	29.39' LT	-	-	829.12
21	FORBES AVE	POT	155+56.56	25.35' LT	-	-	828.96
22	FORBES AVE	POT	155+48.96	25.83' LT	-	-	828.73
23	FORBES AVE	POT	155+48.70	29.36′ LT	-	-	828.73
24	FORBES AVE	POT	155+39.86	29.40′ LT	_	-	828.61
25	FORBES AVE	POT	155+38.96	25.45′ LT	-	-	828.44
26	FORBES AVE	POT	155+28.96	25.38' LT	-	-	828.05
27	FORBES AVE	POT	155+18.96	25.39' LT	_	-	827.81
28	FORBES AVE	POT	155+12.87	25.37′ LT	-	-	827.80
29	FORBES AVE	POT	155+12.89	29.49' LT	-	-	827.93
30	FORBES AVE	POT	155+08.96	29.48' LT	-	-	827.75
31	FORBES AVE	POT	155+06.96	25.45′ LT	-	-	827.62
32	FORBES AVE	POT	154+98.96	25.28' LT	-	-	827.46

	SOUTHWEST QUADRANT							
POINT NUMBER	BASEL INE	POINT	STATION	OFFSET	ELEVATION BOTTOM OF CURB	ELEVATION TOP OF CURB	ELEVATION BACK OF SIDEWALK	
71	MILTENBERGER ST	PT	12+35.05	14.38' LT	828.48	*	-	
72	MILTENBERGER ST	POC	155+45.83	18.69' LT	828.91	*	-	
73	FORBES AVE	PC	155+69.47	18.00' RT	828.91	*	-	
74	FORBES AVE	POT	155+59.47	18.00' RT	828.50	828.84	-	
75	FORBES AVE	POT	155+49.47	18.00' RT	828.21	828.54	-	
76	FORBES AVE	POT	155+39.47	18.00' RT	827.95	828.29	-	
77	FORBES AVE	POT	155+39.47	30.10' RT	-	-	828.40	
78	FORBES AVE	POT	155+49.47	30.10' RT	-	-	828.65	
79	FORBES AVE	POT	155+59.47	30.10' RT	-	-	828.95	
80	FORBES AVE	POT	155+69.47	30.08' RT	-	-	829.25	
81	FORBES AVE	POT	155+74.19	30.04' RT	-	-	829.06	
82	FORBES AVE	POT	155+74.15	35.05′ RT	-	-	[828.82]	
83	MILTENBERGER ST	POT	12+33.28	14.41′ LT	[828.38]	[828.57*]	-	

NORTHEAST QUADRANT							
POINT NUMBER	BASEL INE	POINT	STATION	OFFSET	ELEVATION BOTTOM OF CURB	ELEVATION TOP OF CURB	ELEVATION BACK OF SIDEWALK
33	FORBES AVE	PT	156+28.47	4.75′ LT	830.63	*	-
34	FORBES AVE	POT	156+33.44	4.75′ LT	830.70	*	-
35	FORBES AVE	POT	156+43.44	4.75′ LT	830.86	831.19	-
36	FORBES AVE	PC	156+53.28	4.75′ LT	831.00	831.33	-
37	FORBES AVE	POC	156+55.19	5.13′ LT	831.01	831.34	-
38	FORBES AVE	PΤ	156+56.81	6.21′ LT	831.02	831.35	-
39	FORBES AVE	PC	156+59.91	9.29′ LT	831.03	831.36	-
40	FORBES AVE	POC	156+61.53	10.37′ LT	831.04	831.37	-
41	FORBES AVE	PT	156+63.44	10.75′ LT	831.05	831.38	-
42	FORBES AVE	POT	156+73.44	10.75′ LT	831.20	831.54	-
43	FORBES AVE	POT	156+83.44	10.75′ LT	831.38	831.71	-
44	FORBES AVE	POT	156+83.44	29.75′ LT	-	-	831.90
45	FORBES AVE	POT	156+73.44	29.73′ LT	-	-	831.72
46	FORBES AVE	POT	156+63.47	29.72′ LT	-	-	831.56
47	FORBES AVE	POT	156+53.47	29.73′ LT	-	-	831.59
48	FORBES AVE	POT	156+43.47	29.77′ LT	-	-	831.44
49	FORBES AVE	POT	156+33.47	29.80′ LT	-	-	831.28
50	FORBES AVE	POT	156+24.00	29.80' LT	-	-	830.77
51	MILTENBERGER ST	POT	12+98.12	14.65′ RT	830.15	830.32*	-
52	MILTENBERGER ST	PC	12+88.12	14.55′ RT	829.94	*	-
53	MILTENBERGER ST	POC	12+77.56	18.90′ RT	830.27	*	-
90	FORBES AVE	POT	156+23.98	38.42′ LT	-	-	[831.02]
91	MILTENBERGER ST	POT	13+06.75	14.74′ RT	[830.46]	[830.94]	-

			SOUTH	HEAST QUA	ADRANT		
POINT NUMBER	BASEL INE	POINT	STATION	OFFSET	ELEVATION BOTTOM OF CURB	ELEVATION TOP OF CURB	ELEVATION BACK OF SIDEWAL
54	MILTENBERGER ST	PC	12+35.10	14.58′ RT	829.04	*	-
55	MILTENBERGER ST	POC	12+45.72	18.95′ RT	829.70	*	-
56	FORBES AVE	PT	156+28.43	18.25′ RT	830.16	*	-
57	FORBES AVE	POT	156+38.43	18.25′ RT	830.31	830.65	-
58	FORBES AVE	POT	156+48.43	18.25′ RT	830.47	830.80	-
59	FORBES AVE	POT	156+58.43	18.25′ RT	830.64	830.98	-
60	FORBES AVE	POT	156+63.77	29.66′ RT	-	-	831.14
61	FORBES AVE	POT	156+58.43	25.96′ RT	-	-	831.04
62	FORBES AVE	POT	156+52.71	25.73' RT	-	-	830.94
63	FORBES AVE	POT	156+48.43	29.84′ RT	-	-	830.91
64	FORBES AVE	POT	156+38.43	29.79' RT	-	-	830.75
65	FORBES AVE	POT	156+32.34	29.73′ RT	-	-	830.66
66	FORBES AVE	POT	156+24.49	29.65′ RT	-	-	830.17
67	FORBES AVE	POT	156+24.52	29.87' RT	-	-	830.17
68	FORBES AVE	POT	156+23.79	29.88' RT	-	_	830.11
69	FORBES AVE	POT	156+23.84	34.86′ RT	-	_	830.01
70	FORBES AVE	POT	156+23.92	44.36′ RT	-	_	[829.39]
92	MILTENBERGER ST	POT	12+24.03	14.59' RT	[828.43]	[828.78]	-
93	MILTENBERGER ST	POT	12+33.49	14.58′ RT	828.95	829.21*	-

[] MATCH EXISTING ELEVATION

**AECOM** 

GANNETT FLEMING
GANNETT FLEMING, INC.
Foster Plaza 8
Suite 400
730 Holiday Drive
Pittsburgh, PA. 15220

		THE PREPARATION OF THIS
		DOCUMENT HAS BEEN FINANCED IN PART THROUGH A GRANT FROM THE
		FEDERAL TRANSIT ADMINISTRATION, U.S. DEPARTMENT OF
		TRANSPORTATION, UNDER THE
		URBAN MASS TRANSPORTATION ACT OF 1964, AS AMENDED, FOR THE
DATE		PORT AUTHORITY OF ALLEGHENY COUNTY, PENNSYLVANIA.
	REVISIONS	COUNTY, FERINGTEVARIA.

(NOT FOR CONSTRUCTION)

DESIGNED	TCG		1
DRAWN	<u>TCG</u>	, and the second	L
CHECKED	KCF		l
IN CHARGE	<u>GEC</u>		l
DATE	<u>05/01/24</u>		
SCALE			Ī
	V & SHOWN		

## PORT AUTHORITY OF ALLEGHENY COUNTY


BUS RAPID TRANSIT UPTOWN TO OAKLAND INTERSECTION DATA FORBES AVE & MILTENBERGER ST

Port Authority connecting people to life

CONTRACT NO. BRT-001 DWG. NO. ID75 sнт. 251

THE TION ACT THE SHENY AS SHOWN

Gulf Tower 707 Grant Street 5th Floor Pittsburgh, PA 15219

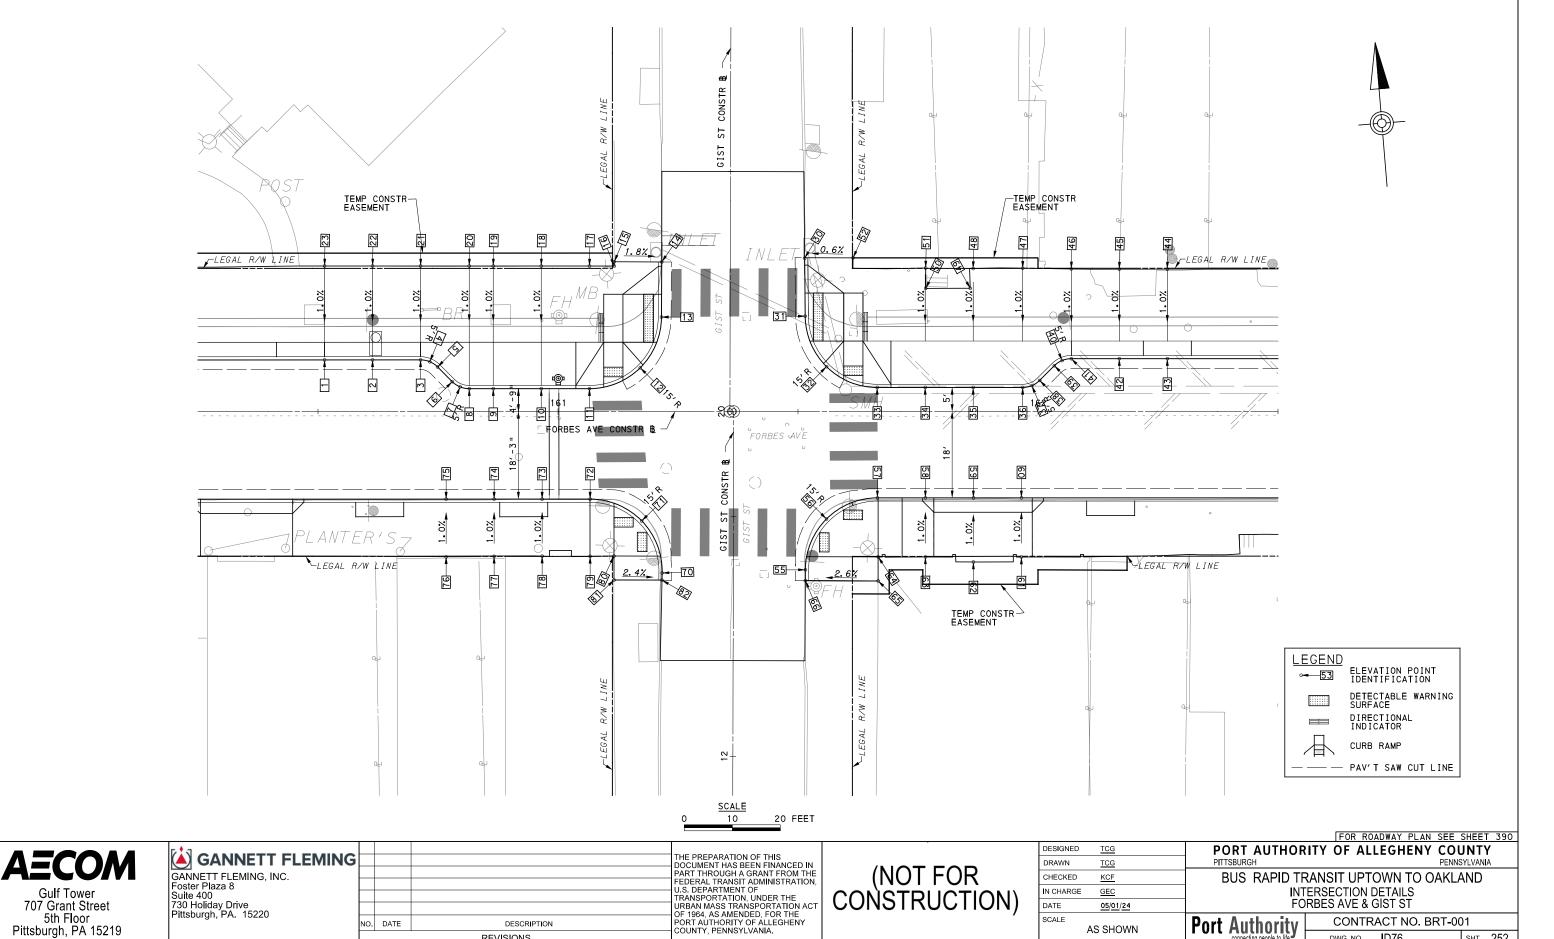

REVISIONS

AS SHOWN

ID76

sнт. 252

DWG. NO.

**Gulf Tower** 

			NORTH	HWEST QU	ADRANT		
POINT NUMBER	BASEL INE	POINT	STATION	OFFSET	ELEVATION BOTTOM OF CURB	ELEVATION TOP OF CURB	ELEVATION BACK OF SIDEWALK
1	FORBES AVE	P0 <b>T</b>	160+51.36	10.75′ LT	837.44	837.68	-
2	FORBES AVE	POT	160+61.36	10.75′ LT	837.61	837.84	-
3	FORBES AVE	PC	160+71.36	10.75′ LT	837.78	803.02	-
4	FORBES AVE	POC	160+73.28	10.37′ LT	837.80	838.04	-
5	FORBES AVE	PT	160+74.90	9.29' LT	837.84	838.08	-
6	FORBES AVE	PC	160+77.97	6.21' LT	837.98	838.22	-
7	FORBES AVE	POC	160+79.59	5.13' LT	838.04	838.28	-
8	FORBES AVE	PT	160+81.51	4.75′ LT	838.08	838.32	-
9	FORBES AVE	POT	160+86.51	4.75′ LT	838.16	838.49	-
10	FORBES AVE	POT	160+96.51	4.75′ LT	838.30	838.63	-
11	FORBES AVE	PC	161+06.55	4.75′ LT	838.41	*	-
12	GIST ST	POC	20+09.07	18.70' LT	838.41	*	-
13	GIST ST	PT	20+19.64	14.31' LT	838.47	*	-
14	GIST ST	POT	20+31.12	14.28' LT	[838.77]	[839.11*]	-
15	FORBES AVE	POT	161+11.83	31.71′ LT	-	-	[839.25]
16	FORBES AVE	POT	161+11.73	30.30' LT	-	-	839.20
17	FORBES AVE	POT	161+06.55	30.31' LT	-	-	838.99
18	FORBES AVE	POT	160+96.51	30.31' LT	-	-	838.88
19	FORBES AVE	POT	160+86.51	30.31' LT	-	-	838.74
20	FORBES AVE	POT	160+81.51	30.32' LT	-	-	838.66
21	FORBES AVE	POT	160+71.36	30.32' LT	-	-	838.30
22	FORBES AVE	POT	160+61.36	30.33' LT	-	-	838.10
23	FORBES AVE	POT	160+51.36	30.33' LT	_	-	837.95

SOUTHWEST QUADRANT								
POINT NUMBER	BASEL INE	POINT	STATION	OFFSET	ELEVATION BOTTOM OF CURB	ELEVATION TOP OF CURB	ELEVATION BACK OF SIDEWALK	
70	GIST ST	PT	12+38.21	14.84′ LT	837.18	*	-	
71	GIST ST	POC	12+49.06	19.12' LT	837.85	*	-	
72	FORBES AVE	PC	161+06.69	18.25′ RT	838.05	*	-	
73	FORBES AVE	POT	160+96.69	18.25′ RT	837.83	838.16	-	
74	FORBES AVE	POT	160+86.69	18.25′ RT	837.69	838.02	-	
75	FORBES AVE	POT	160+76.69	18.25′ RT	837.55	837.88	-	
76	FORBES AVE	POT	160+76.69	30.27′ RT	-	-	838.00	
77	FORBES AVE	POT	160+86.69	30.17′ RT	-	-	838.13	
78	FORBES AVE	POT	160+96.69	30.13′ RT	-	-	838.25	
79	FORBES AVE	POT	161+06.69	30.17′ RT	-	-	838.39	
80	FORBES AVE	POT	161+11.66	30.10' RT	-	-	837.98	
81	FORBES AVE	POT	161+11.67	35.11′ RT	-	-	[837.62]	
82	GIST ST	POT	12+36.72	14.87′ LT	[837.09]	[837.39*]	-	

	NORTHEAST QUADRANT								
POINT NUMBER	BASEL INE	POINT	STATION	OFFSET	ELEVATION BOTTOM OF CURB	ELEVATION TOP OF CURB	ELEVATION BACK OF SIDEWALK		
30	GIST ST	POT	20+31.97	15.49' RT	[838.88]	[839.29*]	-		
31	GIST ST	PC	20+19.90	15.63′ RT	838.51	*	-		
32	GIST ST	POC	20+09.40	20.1′ RT	838.39	*	-		
33	FORBES AVE	PT	161+66.49	5.00' LT	838.30	*	-		
34	FORBES AVE	POT	161+76.50	5.00' LT	838.17	838.50	-		
35	FORBES AVE	POT	161+86.49	5.00' LT	837.96	838.29	-		
36	FORBES AVE	PC	161+96.80	5.00' LT	837.74	838.06	-		
37	FORBES AVE	POC	161+98.72	5.38′ LT	837.68	838.01	-		
38	FORBES AVE	PT	162+00.34	6.47′ LT	837.62	837.97	-		
39	FORBES AVE	PC	162+03.40	9.53′ LT	837.46	837.79	-		
40	FORBES AVE	POC	162+05.02	10.62′ LT	837.40	837.73	-		
41	FORBES AVE	PT	162+06.94	11.00′ LT	837.35	837.68	-		
42	FORBES AVE	POT	162+16.94	11.00′ LT	837.13	837.47	-		
43	FORBES AVE	POT	162+26.94	11.00' LT	836.92	837.26	-		
44	FORBES AVE	POT	162+26.94	29.66′ LT	-	-	837.43		
45	FORBES AVE	POT	162+16.94	25.65′ LT	-	-	837.61		
46	FORBES AVE	POT	162+06.94	29.7′ LT	-	-	837.87		
47	FORBES AVE	POT	161+96.80	29.85′ LT	-	-	837.88		
48	FORBES AVE	POT	161+86.49	29.79′ LT	-	-	838.18		
49	FORBES AVE	POT	161+85.88	25.66′ LT	-	-	838.06		
50	FORBES AVE	POT	161+76.61	25.64′ LT	-	=	838.40		
51	FORBES AVE	POT	161+76.60	29.89' LT	-	=	838.47		
52	FORBES AVE	POT	161+61.48	32.00′ LT	-	=	[839.35]		

	SOUTHEAST QUADRANT								
POINT NUMBER	BASELINE	POINT	STATION	OFFSET	ELEVATION BOTTOM OF CURB	ELEVATION TOP OF CURB	ELEVATION BACK OF SIDEWALK		
55	GIST ST	PC	12+38.94	15.00' RT	837.38	*	-		
56	GIST ST	POC	12+49.55	19.38' RT	837.91	*	-		
57	FORBES AVE	PŤ	161+66.53	18.00' RT	837.94	*	-		
58	FORBES AVE	POT	161+76.53	18.00' RT	837.81	838.14	-		
59	FORBES AVE	POT	161+86.53	18.00' RT	837.59	837.93	-		
60	FORBES AVE	POT	161+96.53	18.00' RT	837.38	837.72	-		
61	FORBES AVE	POT	161+96.53	30.32' RT	-	_	837.84		
62	FORBES AVE	POT	161+86.53	31.36′ RT	-	_	838.05		
63	FORBES AVE	POT	161+76.53	30.31' RT	-	-	838.26		
64	FORBES AVE	POT	161+66.69	30.29' RT	-	-	838.39		
65	FORBES AVE	POT	161+66.68	35.29' RT	-	-	[837.97]		
66	GIST ST	POT	12+36.68	15.01' RT	[837.30]	[837.60*]	-		

\* TOP OF CURB ELEVATION TO BE DETERMINED PER ITEM \* 01900.001-DESIGN OF CURB RAMPS

[] MATCH EXISTING ELEVATION

**AECOM** Gulf Tower 707 Grant Street 5th Floor Pittsburgh, PA 15219

GANNETT FLEMING
GANNETT FLEMING, INC.
Foster Plaza 8
Suite 400
730 Holiday Drive
Pittsburgh, PA. 15220

		THE PREPARATION OF THIS DOCUMENT HAS BEEN FINANCED IN PART THROUGH A GRANT FROM THE FEDERAL TRANSIT ADMINISTRATION, U.S. DEPARTMENT OF TRANSPORTATION, UNDER THE URBAN MASS TRANSPORTATION ACT OF 1984. AS AMENDED FOR THE
DATE	DESCRIPTION	PORT AUTHORITY OF ALLEGHENY COUNTY, PENNSYLVANIA.
	REVISIONS	COUNTY, PENNSYLVANIA.

(NOT FOR CONSTRUCTION)

DESIGNED	<u>TCG</u>	
DRAWN	TCG	
CHECKED	KCF	
IN CHARGE	<u>GEC</u>	
DATE	05/01/24	
SCALE		
	AS SHOWN	


# PORT AUTHORITY OF ALLEGHENY COUNTY PITTSBURGH PENNSYLVANIA

BUS RAPID TRANSIT UPTOWN TO OAKLAND INTERSECTION DATA FORBES AVE & GIST ST

Port Authority
connecting people to life

CONTRACT NO. BRT-001 sнт. 253

DWG. NO. ID77

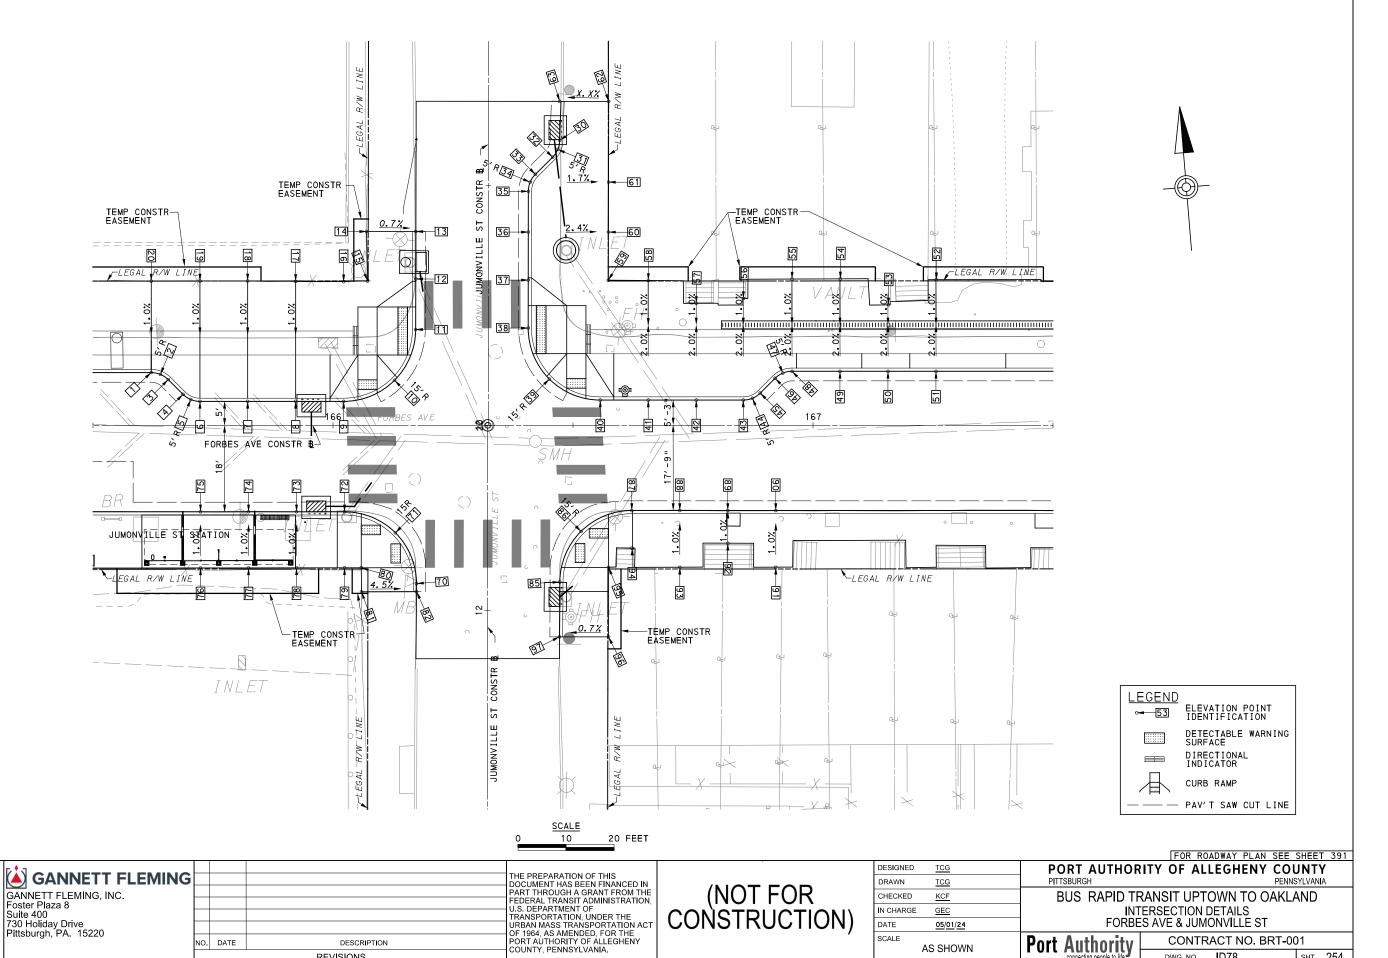

SCALE

AS SHOWN

Port Authority connecting people to life

CONTRACT NO. BRT-001

sнт. 254

ID78

DWG. NO.

**AECOM** 

**Gulf Tower** 707 Grant Street 5th Floor Pittsburgh, PA 15219

NO. DATE

DESCRIPTION

REVISIONS

			NORTH	HWEST QU	ADRANT		
POINT NUMBER	BASEL INE	POINT	STATION	OFFSET	ELEVATION BOTTOM OF CURB	ELEVATION TOP OF CURB	ELEVATION BACK OF SIDEWALE
1	FORBES AVE	PC	165+62.13	11.00' LT	829.86	830.19	-
2	FORBES AVE	POC	165+64.04	10.62' LT	829.84	830.17	-
3	FORBES AVE	PT	165+65.66	9.54′ LT	829.82	830.15	-
4	FORBES AVE	PC	165+68.74	6.46′ LT	829.77	830.10	-
5	FORBES AVE	POC	165+70.36	5.38' LT	829.75	830.08	-
6	FORBES AVE	PT	165+72.28	5.00' LT	829.73	830.06	-
7	FORBES AVE	POT	165+82.21	5.00' LT	829.64	829.97	-
8	FORBES AVE	POT	165+92.21	5.00' LT	829.44	829.77	-
9	FORBES AVE	PC	166+02.21	5.00' LT	829.24	*	-
10	JUMONVILLE ST	POC	20+09.38	19.54' LT	829.08	*	-
11	JUMONVILLE ST	PT	20+19.96	15.14′ LT	828.92	*	-
12	JUMONVILLE ST	POT	20+30.49	15.11' LT	828.77	*	-
13	JUMONVILLE ST	POT	20+40.37	15.09' LT	[829.51]	[829.93]	-
14	FORBES AVE	POT	166+07.00	40.38' LT	-	-	[830.00]
15	FORBES AVE	POT	166+07.20	30.09' LT	-	-	829.42
16	FORBES AVE	POT	166+02.21	29.94′ LT	-	-	829.43
17	FORBES AVE	POT	165+92.21	29.99′ LT	-	-	830.02
18	FORBES AVE	POT	165+82.21	30.10' LT	-	-	830.21
19	FORBES AVE	POT	165+72.28	30.07′ LT	-	-	830.39
20	FORBES AVE	P0 <b>T</b>	165+62.13	30.05′ LT	-	-	830.38

	SOUTHWEST QUADRANT							
POINT NUMBER	BASEL INE	POINT	STATION	OFFSET	ELEVATION BOTTOM OF CURB	ELEVATION TOP OF CURB	ELEVATION BACK OF SIDEWALK	
70	JUMONVILLE ST	PŤ	12+05.65	14.78' LT	828.42	*	-	
71	JUMONVILLE ST	POC	12+16.24	19.17' LT	828.47	*	-	
72	FORBES AVE	PC	166+02.39	18.00' RT	828.88	*	-	
73	FORBES AVE	POT	165+92.39	18.00' RT	829.08	829.41	-	
74	FORBES AVE	POT	165+82.39	18.00' RT	829.27	829.60	-	
75	FORBES AVE	POT	165+72.39	18.00' RT	829.47	829.80	-	
76	FORBES AVE	POT	165+72.39	28.00' RT	-	-	829.91	
77	FORBES AVE	POT	165+82.39	28.00' RT	-	-	829.72	
78	FORBES AVE	POT	165+92.39	29.68' RT	-	-	829.52	
79	FORBES AVE	POT	166+02.39	29.68' RT	-	-	829.10	
80	FORBES AVE	POT	166+05.88	29.68' RT	-	-	829.02	
81	FORBES AVE	POT	166+05.93	34.68' RT	-	-	[829.07]	
82	JUMONVILLE ST	POT	12+03.96	14.77′ LT	[828.43]	[828.61*]	-	

	NORTHEAST QUADRANT							
POINT NUMBER	BASELINE	POINT	STATION	OFFSET	ELEVATION BOTTOM OF CURB	ELEVATION TOP OF CURB	ELEVATION BACK OF SIDEWALK	
30	JUMONVILLE ST	PC	20+59.40	14.86′ RT	OUTSIDE DTM	OUTSIDE DTM	-	
31	JUMONVILLE ST	POC	20+57.49	14.48′ RT	830.25	830.67	-	
32	JUMONVILLE ST	PT	20+55.87	13.40′ RT	830.22	830.63	-	
33	JUMONVILLE ST	PC	20+52.29	9.81′ RT	830.19	830.60	-	
34	JUMONVILLE ST	POC	20+50.66	8.73′ RT	830.12	830.53	-	
35	JUMONVILLE ST	PΤ	20+48.75	8.34′ RT	830.00	830.41	-	
36	JUMONVILLE ST	POT	20+40.27	8.34′ RT	829.40	829.81	-	
37	JUMONVILLE ST	POT	20+30.27	8.33′ RT	828.77	*	-	
38	JUMONVILLE ST	PC	20+20.27	8.32′ RT	828.39	*	-	
39	FORBES AVE	POC	20+09.65	12.71′ RT	828.10	*	-	
40	FORBES AVE	PT	166+55.67	5.25′ LT	827.83	*	-	
41	FORBES AVE	POT	166+65.67	5.25′ LT	827.44	827.78	-	
42	FORBES AVE	POT	166+75.67	5.25′ LT	827.06	827.39	-	
43	FORBES AVE	PC	166+85.47	5.25′ LT	826.64	826.97	-	
44	FORBES AVE	POC	166+87.38	5.63′ LT	826.54	826.89	-	
45	FORBES AVE	PT	166+89.00	6.71′ LT	826.44	826.80	-	
46	FORBES AVE	PC	166+92.08	9.79′ LT	826.21	826.57	-	
47	FORBES AVE	POC	166+93.70	10.87′ LT	826.12	826.46	-	
48	FORBES AVE	PT	166+95.62	11.25′ LT	826.03	826.36	-	
49	FORBES AVE	POT	167+05.62	11.25′ LT	825.59	825.92	-	
50	FORBES AVE	POT	167+15.62	11.25′ LT	825.15	825.49	-	
51	FORBES AVE	POT	167+25.62	11.25′ LT	824.72	825.05	-	
52	FORBES AVE	POT	167+25.62	30.34′ LT	-	-	825.23	
53	FORBES AVE	POT	167+15.69	25.10' LT	-	-	825.62	
54	FORBES AVE	POT	167+05.69	30.51′ LT	-	-	825.87	
55	FORBES AVE	POT	166+95.62	30.47′ LT	-	-	826.23	
56	FORBES AVE	POT	166+85.47	26.41′ LT	-	-	826.53	
57	FORBES AVE	POT	166+75.67	25.41′ LT	-	-	826.95	
58	FORBES AVE	POT	166+65.67	30.18′ LT	-	-	827.92	
59	FORBES AVE	POT	166+57.35	30.23′ LT	-	-	828.42	
60	FORBES AVE	POT	166+57.38	40.25′ LT	-	-	829.43	
61	FORBES AVE	POT	166+57.40	50.66′ LT	-	-	830.27	
62	JUMONVILLE ST	POT	20+67.50	25.08′ RT	-	-	[OUTSIDE DTM]	
63	JUMONVILLE ST	POT	20+67.50	15.13′ RT	[OUTSIDE DTM]	[OUTSIDE DTM]	-	

	SOUTHEAST QUADRANT								
POINT NUMBER	BASEL INE	POINT	STATION	OFFSET	ELEVATION BOTTOM OF CURB	ELEVATION TOP OF CURB	ELEVATION BACK OF SIDEWALK		
85	JUMONVILLE ST	PC	12+05.94	15.07′ RT	827.75	*	-		
86	JUMONVILLE ST	POC	12+16.48	19.51' RT	827.54	*	-		
87	FORBES AVE	PŤ	166+62.24	17.75′ RT	827.21	*	-		
88	FORBES AVE	POT	166+72.24	17.75′ RT	826.83	827.16	-		
89	FORBES AVE	POT	166+82.24	17.75′ RT	826.42	826.75	-		
90	FORBES AVE	POT	166+92.24	17.75′ RT	825.99	826.32	-		
91	FORBES AVE	POT	166+92.24	29.56′ RT	-	-	826.43		
92	FORBES AVE	POT	166+82.24	24.58′ RT	-	-	826.81		
93	FORBES AVE	POT	166+72.24	29.56′ RT	-	-	827.28		
94	FORBES AVE	POT	166+62.32	25.59' RT	-	-	827.62		
95	FORBES AVE	POT	166+57.37	29.59' RT	-	-	828.00		
96	FORBES AVE	POT	166+57.38	44.06′ RT	-	-	[828.30]		
97	JUMONVILLE ST	POT	11+94.52	14.99' RT	[827.99]	[828.23*]	-		

DESIGNED

NOTE:

\* TOP OF CURB ELEVATION TO BE DETERMINED PER ITEM # 01900.001-DESIGN OF CURB RAMPS

sнт. 255

[] MATCH EXISTING ELEVATION

PORT AUTHORITY OF ALLEGHENY COUNTY

В	<u>KCF</u>	KED
	<u>GEC</u>	ARGE
	<u>05/01/24</u>	
Port	AS SHOWN	

AECOM	1
Gulf Tower	
707 Grant Street 5th Floor	
Pittsburgh, PA 15219	)




THE PREPARATION OF THIS

DOCUMENT HAS BEEN FINANCED IN
PART THROUGH A GRANT FROM THE
FEDERAL TRANSIT ADMINISTRATION,
U.S. DEPARTMENT OF
TRANSPORTATION, UNDER THE
URBAN MASS TRANSPORTATION ACT
OF 1964, AS AMENDED, FOR THE
PORT AUTHORITY OF ALLEGHENY
COUNTY, PENNSYLVANIA. DESCRIPTION NO. DATE REVISIONS

(NOT FOR CONSTRUCTION)

DRAWN <u>TCG</u>	PITTSBURGH	PENNSYLVA						
CHECKED KCF	BUS RAPID TE	BUS RAPID TRANSIT UPTOWN TO OAKLAN						
IN CHARGE GEC		ITERSECTION DATA						
DATE <u>05/01/24</u>	FORBE	ES AVE & JUMONVILLE ST						
SCALE AS SHOWN	Port Authority	CONTRACT NO. BRT-001						
ASSHOWN	connecting people to life	DWG. NO. ID79 SHT						

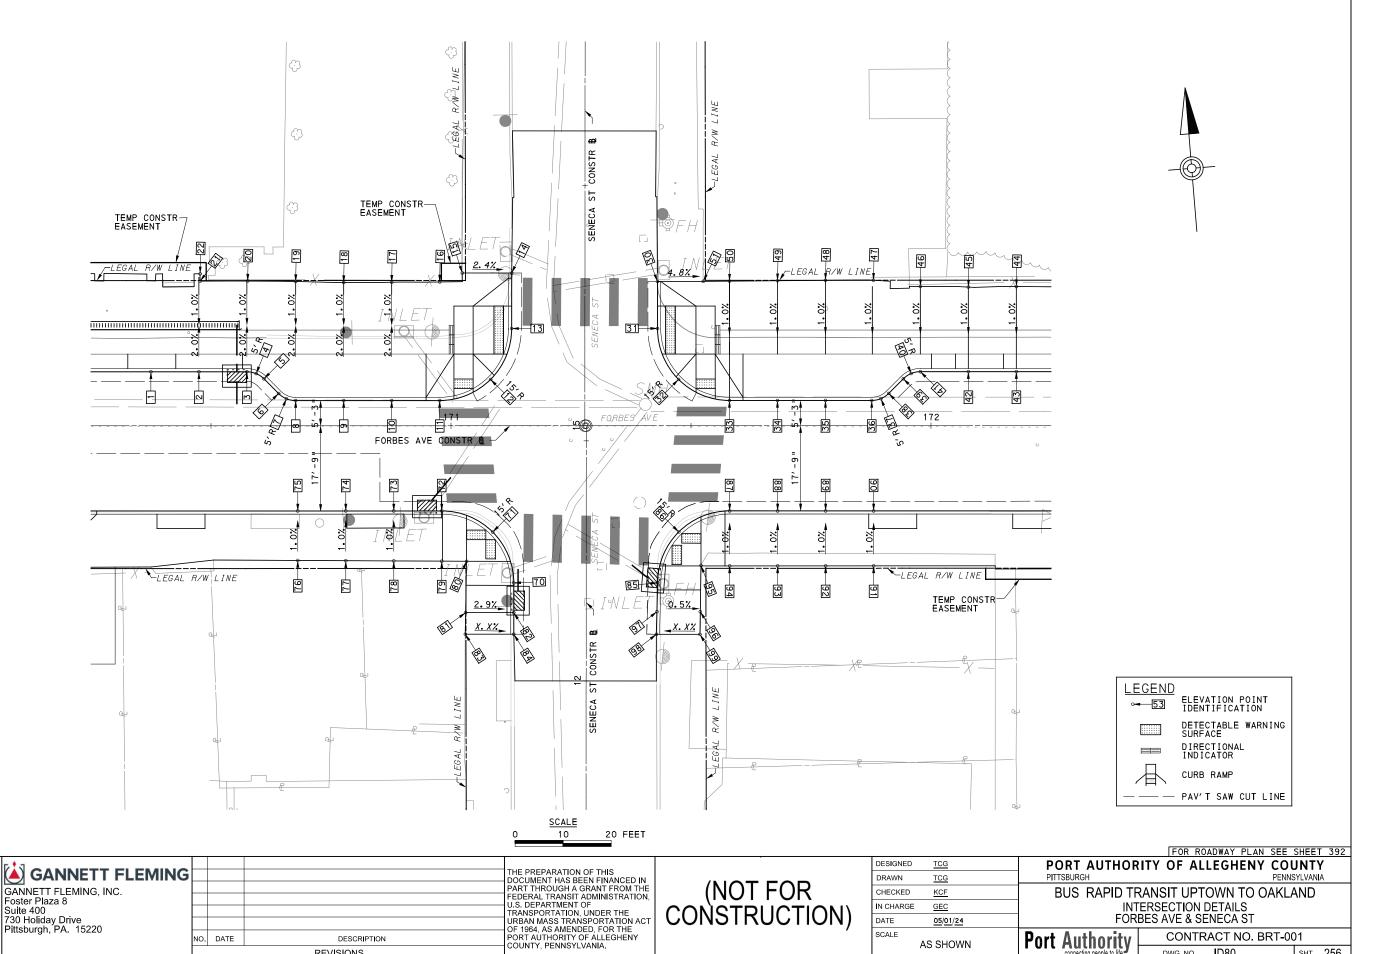

SCALE

AS SHOWN

Port Authority connecting people to life

CONTRACT NO. BRT-001

sнт. 256

ID80

DWG. NO.

**AECOM** 

**Gulf Tower** 707 Grant Street 5th Floor Pittsburgh, PA 15219

NO. DATE

DESCRIPTION

REVISIONS

NORTHWEST QUADRANT							
POINT NUMBER	BASEL INE	POINT	STATION	OFFSET	ELEVATION BOTTOM OF CURB	ELEVATION TOP OF CURB	ELEVATION BACK OF SIDEWALK
1	FORBES AVE	POT	170+37.48	11.25' LT	811.31	811.64	-
2	FORBES AVE	POT	170+47.48	11.25' LT	810.87	811.21	-
3	FORBES AVE	PC	170+57.48	11.25' LT	810.47	810.79	-
4	FORBES AVE	POC	170+59.40	10.87' LT	810.40	810.72	-
5	FORBES AVE	PT	170+61.02	9.78' LT	810.36	810.68	-
6	FORBES AVE	PC	170+64.08	6.72′ LT	810.30	810.61	-
7	FORBES AVE	POC	170+65.70	5.63′ LT	810.26	810.58	-
8	FORBES AVE	PT	170+67.62	5.25' LT	810.19	810.51	-
9	FORBES AVE	POT	170+77.64	5.25′ LT	809.76	810.09	-
10	FORBES AVE	POT	170+87.64	5.25' LT	809.33	809.66	-
11	FORBES AVE	PC	170+97.64	5.25′ LT	808.90	*	-
12	SENECA ST	POC	15+09.63	19.64' LT	808.06	*	-
13	SENECA ST	PT	15+20.24	15.26' LT	807.70	*	-
14	SENECA ST	POT	15+31.81	15.26' LT	[807.93]	[808.23*]	-
15	FORBES AVE	POT	171+02.35	31.82' LT	-	-	[808.46]
16	FORBES AVE	POT	170+97.64	29.96′ LT	-	-	808.61
17	FORBES AVE	POT	170+87.64	29.90' LT	-	-	809.14
18	FORBES AVE	POT	170+77.64	29.84' LT	-	-	809.52
19	FORBES AVE	POT	170+67.64	30.05' LT	-	-	809.91
20	FORBES AVE	POT	170+57.64	30.15' LT	-	-	810.35
21	FORBES AVE	POT	170+47.73	30.12' LT	-	-	810.82
22	FORBES AVE	POT	170+47.73	31.65' LT	-	-	811.05

SOUTHWEST QUADRANT							
POINT NUMBER	BASEL INE	POINT	STATION	OFFSET	ELEVATION BOTTOM OF CURB	ELEVATION TOP OF CURB	ELEVATION BACK OF SIDEWALK
70	SENECA ST	PT	12+20.39	15.08' LT	807.40	*	-
71	SENECA ST	POC	12+31.00	19.48' LT	807.90	*	-
72	FORBES AVE	PC	170+98.08	17.75′ RT	808.52	*	-
73	FORBES AVE	POT	170+88.08	17.75′ RT	808.95	809.28	-
74	FORBES AVE	P0 <b>T</b>	170+78.08	17.75′ RT	809.38	809.72	-
75	FORBES AVE	POT	170+68.08	17.75′ RT	809.81	810.14	-
76	FORBES AVE	POT	170+68.08	28.06′ RT	-	-	810.24
77	FORBES AVE	POT	170+78.08	28.11' RT	-	-	809.81
78	FORBES AVE	POT	170+88.08	28.17′ RT	-	-	809.38
79	FORBES AVE	POT	170+98.08	28.22' RT	-	-	808.73
80	FORBES AVE	POT	171+03.25	28.25′ RT	-	-	808.47
81	SENECA ST	POT	12+14.21	25.10' LT	-	-	808.36
82	SENECA ST	POT	12+14.21	15.08' LT	807.53	808.09	-
83	SENECA ST	POT	12+09.72	25.18' LT	-	-	[OUTSIDE DTM]
84	SENECA ST	POT	12+09.72	15.08' LT	[OUTSIDE DTM]	COUTSIDE DTM3	-

NORTHEAST QUADRANT							
POINT NUMBER	BASEL INE	POINT	STATION	OFFSET	ELEVATION BOTTOM OF CURB	ELEVATION TOP OF CURB	ELEVATION BACK OF SIDEWAL
30	SENECA ST	POT	15+30.04	15.12' RT	[806.45]	[806.76*]	-
31	SENECA ST	PC	15+20.27	15.12' RT	806.35	*	-
32	SENECA ST	POC	15+09.66	19.51′ RT	806.25	*	-
33	FORBES AVE	PT	171+58.01	5.25′ LT	805.91	*	-
34	FORBES AVE	POT	171+68.01	5.25′ LT	805.36	805.70	-
35	FORBES AVE	POT	171+78.01	5.25′ LT	804.83	805.16	-
36	FORBES AVE	PC	171+87.65	5.25′ LT	804.34	804.66	-
37	FORBES AVE	POC	171+89.56	5.63′ LT	804.23	804.57	-
38	FORBES AVE	PT	171+91.19	6.72′ LT	804.11	804.48	-
39	FORBES AVE	PC	171+94.24	9.78′ LT	803.86	804.23	-
40	FORBES AVE	POC	171+95.87	10.87′ LT	803.75	804.09	-
41	FORBES AVE	PT	171+97.78	11.25′ LT	803.64	803.97	-
42	FORBES AVE	POT	172+07.78	11.25′ LT	803.15	803.48	-
43	FORBES AVE	POT	172+17.78	11.25' LT	802.67	803.00	-
44	FORBES AVE	POT	172+17.78	28.67′ LT	-	=	803.18
45	FORBES AVE	POT	172+07.78	28.98' LT	-	-	803.65
46	FORBES AVE	POT	171+97.78	28.87′ LT	-	-	804.08
47	FORBES AVE	POT	171+88.01	30.31′ LT	-	-	804.72
48	FORBES AVE	POT	171+78.01	30.21' LT	-	-	805.23
49	FORBES AVE	POT	171+68.01	30.21' LT	-	-	805.76
50	FORBES AVE	POT	171+58.01	30.12' LT	-	-	806.06
51	FORBES AVE	POT	171+52.54	30.08' LT	-	-	[806.37]
52	FORBES AVE	POT	171+52.56	31.85′ LT			

	SOUTHEAST QUADRANT							
POINT NUMBER	BASELINE	POINT	STATION	OFFSET	ELEVATION BOTTOM OF CURB	ELEVATION TOP OF CURB	ELEVATION BACK OF SIDEWALK	
85	SENECA ST	PC	12+20.44	14.89' RT	806.11	*	-	
86	SENECA ST	POC	12+31.04	19.28' RT	805.97	*	-	
87	FORBES AVE	PT	171+58.05	17.75′ RT	805.55	*	-	
88	FORBES AVE	POT	171+68.05	17.75′ RT	805.00	805.59	-	
89	FORBES AVE	POT	171+78.05	17.75′ RT	804.47	805.33	-	
90	FORBES AVE	POT	171+88.05	17.75′ RT	803.96	805.05	-	
91	FORBES AVE	POT	171+88.05	29.20' RT	-	-	804.65	
92	FORBES AVE	POT	171+78.05	29.20' RT	-	-	805.16	
93	FORBES AVE	POT	171+68.05	29.21' RT	-	-	805.69	
94	FORBES AVE	POT	171+58.05	29.21' RT	-	-	805.73	
95	FORBES AVE	POT	171+52.07	29.21' RT	-	-	806.31	
96	SENECA ST	POT	12+14.43	23.77′ RT	-	-	806.67	
97	SENECA ST	POT	12+14.43	14.74′ RT	806.21	806.70	-	
98	SENECA ST	POT	12+09.72	14.63′ RT	[OUTSIDE DTM]	[OUTSIDE DTM]	-	
99	SENECA ST	POT	12+09.72	23.70' RT	-	-	[OUTSIDE DTM]	

\* TOP OF CURB ELEVATION TO BE DETERMINED PER ITEM # 01900.001-DESIGN OF CURB RAMPS

[] MATCH EXISTING ELEVATION

**AECOM** Gulf Tower 707 Grant Street 5th Floor Pittsburgh, PA 15219

GANNETT FLEMING
GANNETT FLEMING, INC.
Foster Plaza 8
Suite 400
730 Holiday Drive
Pittsburgh, PA. 15220

THE PREPARATION OF THIS

DOCUMENT HAS BEEN FINANCED IN
PART THROUGH A GRANT FROM THE
FEDERAL TRANSIT ADMINISTRATION,
U.S. DEPARTMENT OF
TRANSPORTATION, UNDER THE
URBAN MASS TRANSPORTATION ACT
OF 1964, AS AMENDED, FOR THE
PORT AUTHORITY OF ALLEGHENY
COUNTY, PENNSYLVANIA. NO. DATE DESCRIPTION

(NOT FOR CONSTRUCTION)

DESIGNED	TCG
DRAWN	TCG
CHECKED	KCF
IN CHARGE	GEC
DATE	05/01/24
SCALE	

## PORT AUTHORITY OF ALLEGHENY COUNTY PENNSYLVANIA BUS RAPID TRANSIT UPTOWN TO OAKLAND


INTERSECTION DATA FORBES AVE & SENECA ST

Port Authority connecting people to life

CONTRACT NO. BRT-001 DWG. NO. ID81 sнт. 257

AS SHOWN

REVISIONS

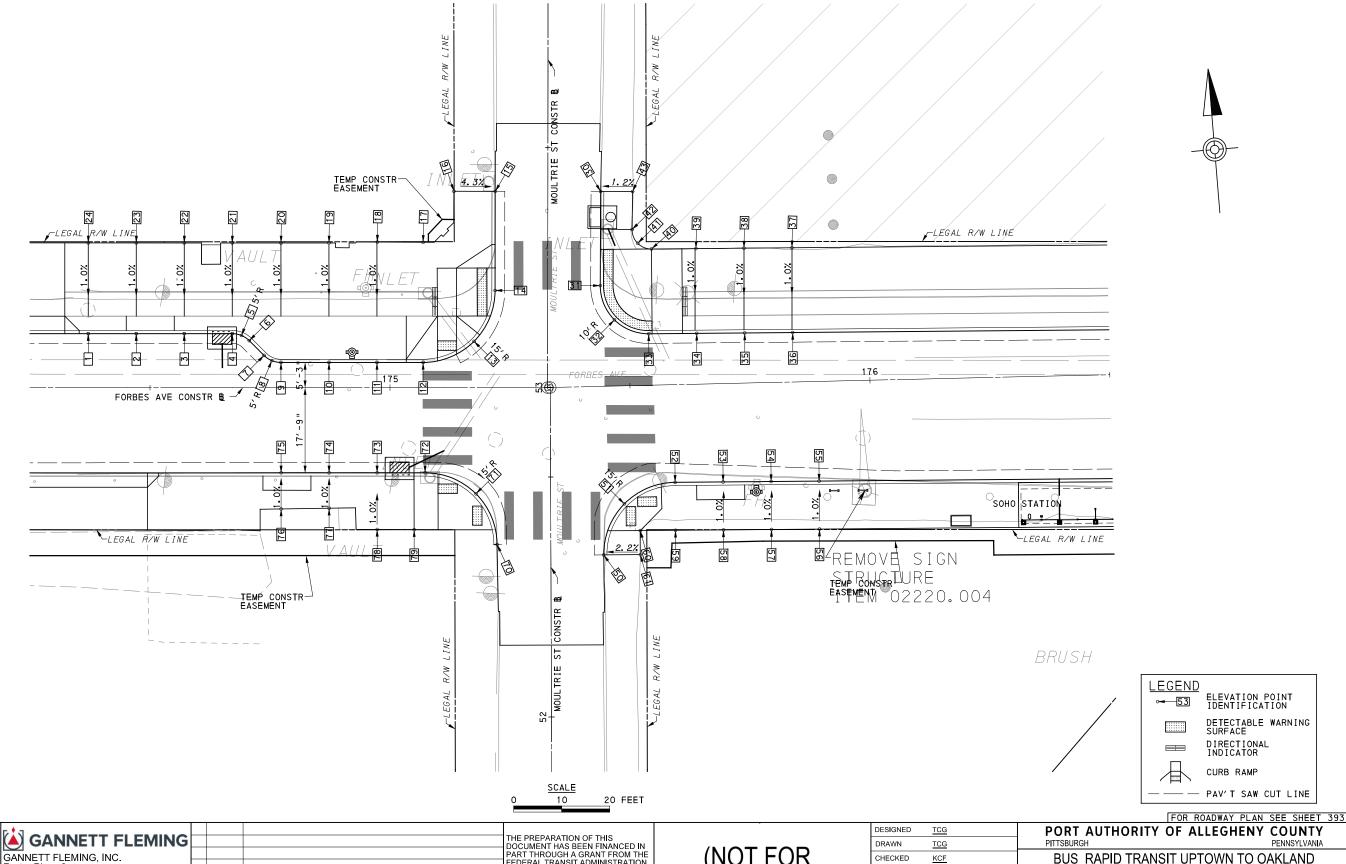

**AECOM Gulf Tower** 707 Grant Street

5th Floor Pittsburgh, PA 15219

Foster Plaza 8 Suite 400 730 Holiday Drive Pittsburgh, PA. 15220

NO. DATE

THE PREPARATION OF THIS
DOCUMENT HAS BEEN FINANCED IN
PART THROUGH A GRANT FROM THE
FEDERAL TRANSIT ADMINISTRATION, PEDERAL TRANSIT ADMINISTRATION,
U.S. DEPARTMENT OF
TRANSPORTATION, UNDER THE
URBAN MASS TRANSPORTATION ACT
OF 1964, AS AMENDED, FOR THE
PORT AUTHORITY OF ALLEGHENY
COUNTY, PENNSYLVANIA. DESCRIPTION REVISIONS

(NOT FOR CONSTRUCTION)

DESIGNED	TCG	
DRAWN	TCG	
CHECKED	KCF	
N CHARGE	GEC	
DATE	05/01/24	
SCALE	AS SHOWN	

BUS RAPID TRANSIT UPTOWN TO OAKLAND

INTERSECTION DETAILS FORBES AVE & MOULTRIE ST

Port Authority connecting people to life CONTRACT NO. BRT-001 ID82 sнт. 258 DWG. NO.

NORTHWEST QUADRANT							
POINT NUMBER	BASEL INE	POINT	STATION	OFFSET	ELEVATION BOTTOM OF CURB	ELEVATION TOP OF CURB	ELEVATION BACK OF SIDEWAL
1	FORBES AVE	POT	174+37.15	11.25' LT	791.91	792.24	-
2	FORBES AVE	POT	174+47.15	11.25' LT	791.39	791.73	-
3	FORBES AVE	POT	174+57.15	11.25' LT	790.89	791.22	-
4	FORBES AVE	PC	174+67.15	11.25' LT	790.41	790.74	-
5	FORBES AVE	POC	174+69.06	10.87' LT	790.34	790.65	-
6	FORBES AVE	PT	174+70.68	9.79' LT	790.28	790.59	-
7	FORBES AVE	PC	174+73.76	6.71′ LT	790.20	790.52	-
8	FORBES AVE	POC	174+75.39	5.63′ LT	790.15	790.47	-
9	FORBES AVE	PT	174+77.30	5.25′ LT	790.07	790.40	-
10	FORBES AVE	POT	174+87.30	5.25′ LT	789.58	789.91	-
11	FORBES AVE	POT	174+97.30	5.25′ LT	789.08	789.41	-
12	FORBES AVE	PC	175+06.91	5.25′ LT	788.63	*	-
13	MOULTRIE ST	POC	53+09.61	15.34' LT	787.93	*	-
14	MOULTRIE ST	PT	53+20.21	10.95' LT	787.69	*	-
15	MOULTRIE ST	POT	53+40.87	10.95' LT	[789.35]	[789.68]	-
16	FORBES AVE	POT	175+13.33	40.89' LT	-	-	[790.02]
17	FORBES AVE	POT	175+06.91	30.27′ LT	-	-	789.37
18	FORBES AVE	POT	174+97.37	30.32' LT	-	-	789.76
19	FORBES AVE	POT	174+87.30	30.13' LT	-	-	790.12
20	FORBES AVE	POT	174+77.30	30.13' LT	-	-	790.53
21	FORBES AVE	POT	174+67.15	30.13' LT	-	-	791.11
22	FORBES AVE	POT	174+57.15	30.14' LT	-	-	791.66
23	FORBES AVE	POT	174+47.15	30.15' LT	-	-	792.15
24	FORBES AVE	POT	174+37.15	30.15' LT	-	-	792.78

	SOUTHWEST QUADRANT						
POINT NUMBER	BASEL INE	POINT	STATION	OFFSET	ELEVATION BOTTOM OF CURB	ELEVATION TOP OF CURB	ELEVATION BACK OF SIDEWALK
70	MOULTRIE ST	PT	52+35.96	11.20' LT	[786.42]	*	-
71	MOULTRIE ST	POC	52+46.57	15.58' LT	787.19	*	-
72	FORBES AVE	PC	175+07.32	17.75′ RT	788.14	*	-
73	FORBES AVE	POT	174+97.32	17.75′ RT	788.61	788.94	_
74	FORBES AVE	POT	174+87.32	17.75′ RT	789.11	789.44	_
75	FORBES AVE	POT	174+77.32	17.75′ RT	789.60	789.93	_
76	FORBES AVE	POT	174+77.32	25.28′ RT	-	-	790.05
77	FORBES AVE	POT	174+87.32	25.13′ RT	_	-	789.55
78	FORBES AVE	POT	174+97.34	29.55′ RT	-	-	789.05
79	FORBES AVE	POT	175+05.05	29.61' RT	-	-	788.69

	NORTHEAST QUADRANT							
			NORTE	TEASI QUA	AURANI			
POINT NUMBER	BASELINE	POINT	STATION	OFFSET	ELEVATION BOTTOM OF CURB	ELEVATION TOP OF CURB	ELEVATION BACK OF SIDEWALK	
30	MOULTRIE ST	POT	53+40.87	11.00' RT	[788.57]	[788.75]	-	
31	MOULTRIE ST	PC	53+21.26	10.96′ RT	786.91	*	-	
32	MOULTRIE ST	POC	53+14.14	13.92′ RT	786.61	*	-	
33	FORBES AVE	PŤ	175+54.16	10.73′ LT	786.23	*	-	
34	FORBES AVE	POT	175+64.15	10.59' LT	785.70	786.04	-	
35	FORBES AVE	POT	175+74.15	10.44' LT	785.16	785.50	-	
36	FORBES AVE	POT	175+84.15	10.3' LT	784.63	784.96	-	
37	FORBES AVE	POT	175+84.40	27.97′ LT	-	-	785.12	
38	FORBES AVE	POT	175+74.40	28.11' LT	-	-	785.65	
39	FORBES AVE	POT	175+64.41	28.25′ LT	-	_	786.19	
40	FORBES AVE	PC	175+55.13	28.38' LT	-	-	787.24	
41	FORBES AVE	POC	175+52.29	29.62′ LT	-	-	787.60	
42	FORBES AVE	PT	175+51.19	32.52′ LT	-	-	787.90	
43	FORBES AVE	POT	175+51.47	40.43′ LT	-	-	[788.82]	

	SOUTHEAST QUADRANT							
POINT NUMBER	BASEL I NE	POINT	STATION	OFFSET	ELEVATION BOTTOM OF CURB	ELEVATION TOP OF CURB	ELEVATION BACK OF SIDEWALK	
50	MOULTRIE ST	PC	52+33.74	11.00' RT	[785.48]	[785.65*]	-	
51	MOULTRIE ST	POC	52+44.35	15.35′ RT	786.02	*	-	
52	FORBES AVE	PŤ	175+58.95	20.34' RT	785.64	*	-	
53	FORBES AVE	POT	175+68.95	20.49' RT	785.11	785.69	-	
54	FORBES AVE	POT	175+78.94	20.63' RT	784.58	785.16	-	
55	FORBES AVE	POT	175+88.94	20.77′ RT	784.04	784.62	-	
56	FORBES AVE	POT	175+88.80	30.77′ RT	-	-	784.72	
57	FORBES AVE	POT	175+78.80	30.63' RT	-	-	785.26	
58	FORBES AVE	POT	175+68.80	30.48′ RT	-	-	785.79	
59	FORBES AVE	POT	175+58.80	30.34' RT	-	-	785.97	
60	FORBES AVE	POT	175+51.45	30.22' RT	-	-	785.98	
61	FORBES AVE	POT	175+51.36	35.23' RT	-	-	[785.82]	

\* TOP OF CURB ELEVATION TO BE DETERMINED PER ITEM \* 01900.001-DESIGN OF CURB RAMPS

[] MATCH EXISTING ELEVATION

**AECOM** Gulf Tower 707 Grant Street 5th Floor Pittsburgh, PA 15219


GANNETT FLEMING
GANNETT FLEMING, INC.
Foster Plaza 8
Suite 400
730 Holiday Drive
Pittsburgh, PA. 15220

		THE PREPARATION OF THIS DOCUMENT HAS BEEN FINANCED IN PART THROUGH A GRANT FROM THE FEDERAL TRANSIT ADMINISTRATION, U.S. DEPARTMENT OF TRANSPORTATION, UNDER THE URBAN MASS TRANSPORTATION ACT OF 1964, AS AMENDED, FOR THE
DATE	DESCRIPTION	PORT AUTHORITY OF ALLEGHENY
	REVISIONS	COUNTY, PENNSYLVANIA.

(NOT FOR CONSTRUCTION)

DESIGNED	TCG	
DRAWN	<u>TCG</u>	
CHECKED	KCF	
IN CHARGE	<u>GEC</u>	
DATE	05/01/24	
SCALE		
	V & SHU/WI	

## PORT AUTHORITY OF ALLEGHENY COUNTY PITTSBURGH PENNSYLVANIA BUS RAPID TRANSIT UPTOWN TO OAKLAND INTERSECTION DATA FORBES AVE & MOULTRIE ST Port Authority connecting people to life CONTRACT NO. BRT-001 AS SHOWN DWG. NO. ID83 sнт. 259

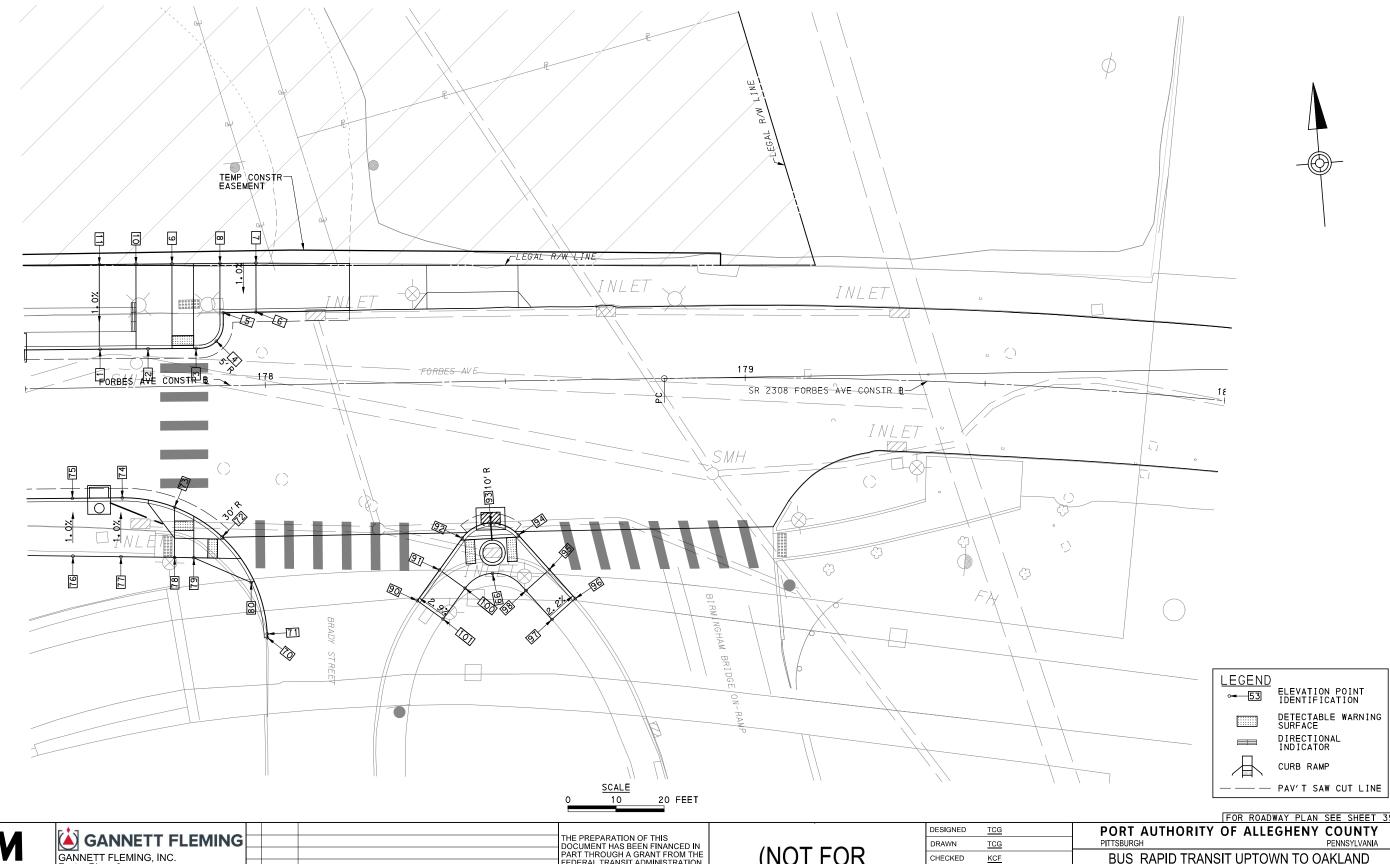

**AECOM Gulf Tower** 707 Grant Street

5th Floor Pittsburgh, PA 15219

Foster Plaza 8 Suite 400 730 Holiday Drive Pittsburgh, PA. 15220

NO. DATE

THE PREPARATION OF THIS
DOCUMENT HAS BEEN FINANCED IN
PART THROUGH A GRANT FROM THE
FEDERAL TRANSIT ADMINISTRATION,
U.S. DEPARTMENT OF
TRANSPORTATION, UNDER THE
URBAN MASS TRANSPORTATION ACT
OF 1964, AS AMENDED, FOR THE
PORT AUTHORITY OF ALLEGHENY
COUNTY, PENNSYLVANIA. DESCRIPTION REVISIONS

(NOT FOR CONSTRUCTION)

DESIGNED	<u>TCG</u>	
DRAWN	<u>TCG</u>	
CHECKED	KCF	
IN CHARGE	<u>GEC</u>	
DATE	05/01/24	
SCALE		
	AS SHOWN	

FOR ROADWAY PLAN SEE SHEET 394

sнт. 260

BUS RAPID TRANSIT UPTOWN TO OAKLAND INTERSECTION DETAILS FORBES AVE & BIRMINGHAM BR

Port Authority
connecting people to life CONTRACT NO. BRT-001 ID84 DWG. NO.

	NORTHWEST QUADRANT							
POINT NUMBER	BASEL INE	POINT	STATION	OFFSET	ELEVATION BOTTOM OF CURB	ELEVATION TOP OF CURB	ELEVATION BACK OF SIDEWALK	
1	FORBES AVE	POT	177+65.71	8.00' LT	775.78	776.12	-	
2	FORBES AVE	POT	177+75.71	7.92′ LT	775.51	*	-	
3	FORBES AVE	PC	177+86.43	7.84′ LT	775.35	*	-	
4	FORBES AVE	POC	177+89.97	9.27′ LT	775.26	*	-	
5	FORBES AVE	PT	177+91.49	15.18' LT	775.14	*	-	
6	FORBES AVE	POT	177+98.33	15.19' LT	775.01	*	-	
7	FORBES AVE	POT	177+98.48	25.42′ LT	-	-	775.42	
8	FORBES AVE	POT	177+90.98	25.47′ LT	-	-	775.56	
9	FORBES AVE	POT	177+80.98	25.55′ LT	-	-	775.95	
10	FORBES AVE	POT	177+73.48	25.61′ LT	-	-	776.07	
11	FORBES AVE	POT	177+66.85	25.67′ LT	-	-	776.28	

SOUTHWEST QUADRANT							
POINT NUMBER	BASEL INE	POINT	STATION	OFFSET	ELEVATION BOTTOM OF CURB	ELEVATION TOP OF CURB	ELEVATION BACK OF SIDEWALK
70	FORBES AVE	POT	177+99.62	52.66′ RT	773.34	774.05	-
71	FORBES AVE	PT	177+99.59	51.88' RT	773.41	774.11	-
72	FORBES AVE	POC	177+90.49	31.49' RT	774.74	*	-
73	FORBES AVE	POC	177+80.71	25.16' RT	775.06	*	-
74	FORBES AVE	PC	177+69.84	23.03' RT	775.34	775.92	-
75	FORBES AVE	POT	177+59.45	22.95′ RT	775.63	776.22	-
76	FORBES AVE	POT	177+59.36	35.01' RT	-	-	776.33
77	FORBES AVE	POT	177+69.36	35.30' RT	-	-	776.05
78	FORBES AVE	POT	177+80.55	35.62' RT	-	-	774.78
79	FORBES AVE	POT	177+84.55	35.76′ RT	-	-	774.49
80	FORBES AVE	POT	177+96.41	41.10' RT	-	-	774.00
90	FORBES AVE	POT	178+30.97	45.47′ RT	[773.65]	[774.19]	-
91	FORBES AVE	POT	178+35.68	39.12' RT	773.95	774.53	-
92	FORBES AVE	PC	178+40.54	32.56′ RT	774.35	774.93	-
93	FORBES AVE	POC	178+46.55	29.53' RT	774.40	774.98	-
94	FORBES AVE	PT	178+52.23	32.11' RT	774.44	775.02	-
95	FORBES AVE	POT	178+58.57	39.41′ RT	774.50	775.08	-
96	FORBES AVE	POT	178+63.87	45.53′ RT	[774.63]	[775.32]	-
97	FORBES AVE	POT	178+58.93	49.83' RT	-	-	[775.40]
98	FORBES AVE	PT	178+53.62	43.71′ RT	-	-	775.23
99	FORBES AVE	POC	178+46.69	40.00' RT	-	-	774.93
100	FORBES AVE	PC	178+40.95	43.03' RT	-	-	774.54
101	FORBES AVE	POT	178+36.25	49.37′ RT	-	-	[774.44]

NOTE:

\* TOP OF CURB ELEVATION TO BE DETERMINED PER ITEM # 01900.001-DESIGN OF CURB RAMPS

[] MATCH EXISTING ELEVATION

**AECOM** Gulf Tower 707 Grant Street 5th Floor Pittsburgh, PA 15219

GANNETT FLEMING
GANNETT FLEMING, INC.
Foster Plaza 8
Suite 400
730 Holiday Drive
Pittsburgh, PA. 15220

THE PREPARATION OF THIS

DOCUMENT HAS BEEN FINANCED IN
PART THROUGH A GRANT FROM THE
FEDERAL TRANSIT ADMINISTRATION,
U.S. DEPARTMENT OF
TRANSPORTATION, UNDER THE
URBAN MASS TRANSPORTATION ACT
OF 1964, AS AMENDED, FOR THE
PORT AUTHORITY OF ALLEGHENY
COUNTY, PENNSYLVANIA. NO. DATE DESCRIPTION REVISIONS

(NOT FOR CONSTRUCTION)

DESIGNED	<u>TCG</u>	PORT AUTHOR	ITY OF AL	LEGHENY COL	JNTY	7
DRAWN	TCG	PITTSBURGH		PENNS	YLVANIA	4
CHECKED	<u>KCF</u>	BUS RAPID TRANSIT UPTOWN TO OAKLAND				
IN CHARGE	<u>GEC</u>	INTERSECTION DATA				
DATE	05/01/24	FORBES AVE & BIRMINGHAM BR				
SCALE AS SHOWN		Port Authority CONTRACT NO. BRT-001		)1		
AS SHOWN		connecting people to life	DWG. NO.	ID85	SHT.	261

NORTHEAST QUADRANT

OFFSET

17.28' RT

21. 46' RT

13.40' LT

11.61' LT

18.28' LT

STATION

20+29.33

20+18.19

217+04.58

217+10.28

217+26.87

217+18.12 | 11.61' LT

217+20.04 | 11.99' LT

217+21.66 | 13.07' LT

217+28.49 19.36' LT

217+30.40 19.74′ LT

217+30.41 29.65' LT

217+25.16 29.62' LT

217+15.16 29.56' LT

217+05.07 | 29.14' LT

POINT

POT

PC

ΡŤ

PC

POC

ΡŤ

POC

PΤ

POT

POT

POT

POT

ELEVATION BOTTOM OF CURB

[913.88]

913.70

913.62

913.51

913.35

913.30

913.25

913.05

912.99

[912.94]

ELEVATION TOP OF CURB

914.03

913.68

913.63

913.58

913.38

913.32

[913.27]

ELEVATION BACK OF SIDEWALK

[913.71]

913.74 913.81

[914.05]

NOTE:

\* TOP OF CURB ELEVATION TO BE DETERMINED PER ITEM # 01900.001-DESIGN OF CURB RAMPS

[] MATCH EXISTING ELEVATION

**AECOM** 

Gulf Tower 707 Grant Street 5th Floor Pittsburgh, PA 15219 GANNETT FLEMING

GANNETT FLEMING, INC. Foster Plaza 8 Sulte 400 730 Holiday Drive Pittsburgh, PA. 15220

		THE PREPARATION OF THIS DOCUMENT HAS BEEN FINANCED IN PART THROUGH A GRANT FROM THE FEDERAL TRANSIT ADMINISTRATION, U.S. DEPARTMENT OF TRANSPORTATION, UNDER THE
		URBAN MASS TRANSPORTATION ACT OF 1964, AS AMENDED, FOR THE
DATE	DESCRIPTION	PORT AUTHORITY OF ALLEGHENY COUNTY, PENNSYLVANIA.
	REVISIONS	COUNTY, FEMINSTEVANIA.

(NOT FOR CONSTRUCTION)

POINT NUMBER

200

201

202

203

204

205

206

207

208

209

210

211

212

213


BASEL INE

HALKET ST

HALKET ST

FORBES AVE

DESIGNED	<u>TCG</u>	PORT AUTHOR	ITY OF ALLE	GHENY COL	JNT	7
DRAWN	TCG	PITTSBURGH		PENNS	YLVANI	Α
CHECKED	KCF	BUS RAPID TRANSIT UPTOWN TO OAKLAND				
IN CHARGE	<u>GEC</u>	INTERSECTION DATA				
DATE	05/01/24	FORBES AVE & HALKET ST				
SCALE AS SHOWN		Port Authority CONTRACT NO. BRT-001				
	IO OI IOVVIA	connecting people to life	DWG, NO.	D87	SHT.	263

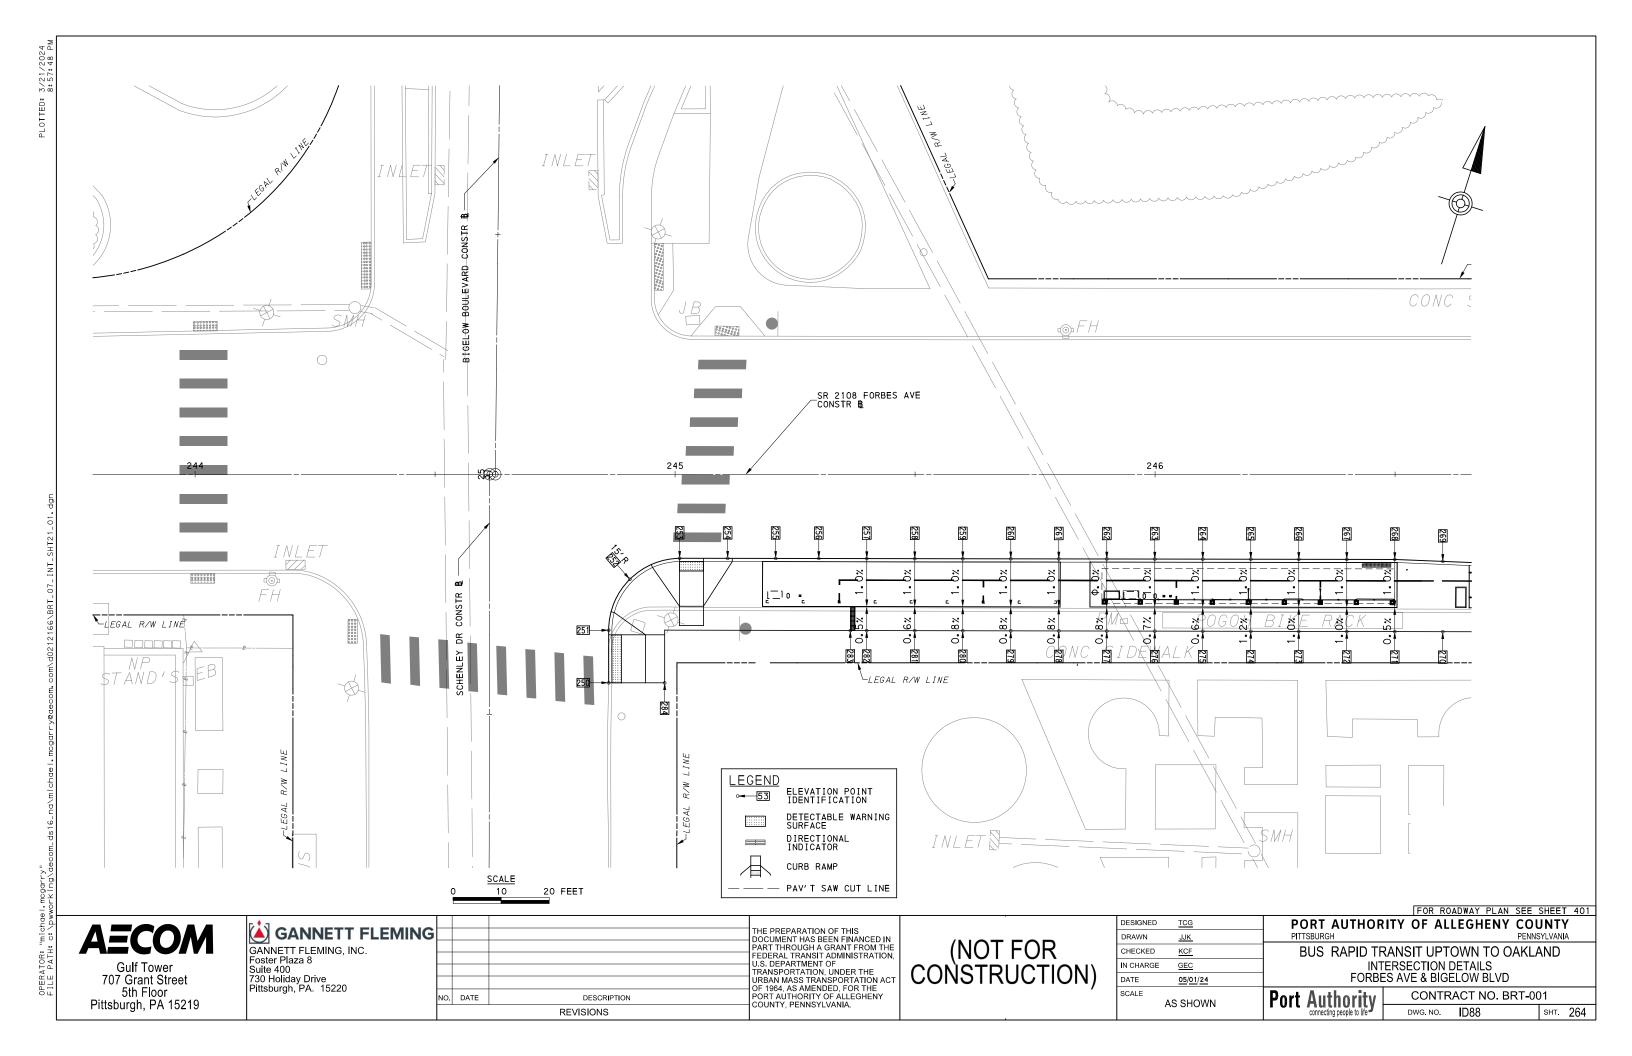

**AECOM** Gulf Tower 707 Grant Street 5th Floor Pittsburgh, PA 15219

<b>ANNETT FLEMING</b>	ŀ
GANNETT FLEMING, INC.	ŀ
Foster Plaza 8	l
Suite 400	
730 Holiday Drive	Ì
Pittsburgh, PA. 15220	ŀ

DATE	DESCRIPTION	THE PREPARATION OF THIS DOCUMENT HAS BEEN FINANCED I PART THROUGH A GRANT FROM T FEDERAL TRANSIT ADMINISTRATIC U.S. DEPARTMENT OF TRANSPORTATION, UNDER THE URBAN MASS TRANSPORTATION A OF 1964, AS AMENDED, FOR THE PORT AUTHORITY OF ALLEGHENY COUNTY, PENNSYLVANIA.
	REVISIONS	, , , , , , , , , , , , , , , , , , , ,

(NOT FOR CONSTRUCTION)

POINT NUMBER

250

**BASELINE** 

SCHENLEY DR

POINT

POT

STATION

DESIGNED	<u>TCG</u>	
DRAWN	JJK	
CHECKED	KCF	
IN CHARGE	GEC	
DATE	05/01/24	
SCALE		
	AS SHOWN	

GNED	<u>TCG</u>	PORT AUTHORITY OF ALLEGHENY COUNTY
٧N	JJK_	PITTSBURGH PENNSYLVANIA
CKED	KCF	BUS RAPID TRANSIT UPTOWN TO OAKLAND
IARGE	<u>GEC</u>	INTERSECTION DATA

TO OAKLAND FORBES AVE & BIGELOW BLVD

Port Authority

CONTRACT NO. BRT-001				
DWG. NO.	ID89	SHT.	265	

	001111111111111111111111111111111111111	101	27130.00	27.07 1(1	F030• 133	•	
251	SCHENLEY DR	PC	24+67.53	24.59′ RT	[899.02]	*	-
252	FORBES AVE	POC	244+90.57	21.88′ RT	[899.18]	899.64	-
253	FORBES AVE	PT	245+00.96	17.50′ RT	[899.15]	*	-
254	FORBES AVE	POT	245+10.96	17.51′ RT	[899.00]	*	-
255	FORBES AVE	POT	245+20.96	17.53′ RT	[898.85]	899.31	-
256	FORBES AVE	POT	245+29.94	17.54′ RT	[898.72]	899.18	-
257	FORBES AVE	POT	245+39.94	17.56′ RT	[898.57]	899.03	-
258	FORBES AVE	POT	245+49.94	17.57′ RT	[898.42]	898.88	-
259	FORBES AVE	POT	245+59.94	17.59′ RT	[898.28]	898.74	-
260	FORBES AVE	POT	245+69.94	17.61′ RT	[898.14]	898.6	-
261	FORBES AVE	POT	245+79.94	17.62′ RT	[898.00]	898.46	-
262	FORBES AVE	POT	245+89.94	17.64′ RT	[897.85]	898.31	-
263	FORBES AVE	РОТ	245+99.94	17.65′ RT	[897.71]	898.17	-
264	FORBES AVE	POT	246+09.94	17.67′ RT	[897.57]	898.03	-
265	FORBES AVE	POT	246+19.94	17.69′ RT	[897.43]	897.89	-
266	FORBES AVE	POT	246+29.94	17.70′ RT	[897.29]	897.75	-
267	FORBES AVE	POT	246+39.94	17.72′ RT	[897.16]	897.62	-
268	FORBES AVE	POT	246+49.94	17.74′ RT	[897.05]	897.5	-
269	FORBES AVE	POT	246+59.94	18.13′ RT	[896.91]	897.37	-
270	FORBES AVE	POT	246+59.94	32.78′ RT	-	-	[897.29]
271	FORBES AVE	POT	246+49.94	32.77′ RT	-	-	[897.44]
272	FORBES AVE	POT	246+39.94	32.75′ RT	-	-	[897.58]
273	FORBES AVE	POT	246+29.94	32.73′ RT	=	-	[897.71]
274	FORBES AVE	POT	246+19.94	32.71′ RT	-	-	[897.86]
275	FORBES AVE	POT	246+09.94	32.69' RT	-	=	[897.97]
276	FORBES AVE	POT	245+99.94	32.67′ RT	-	-	[898.07]
277	FORBES AVE	POT	245+89.94	32.65′ RT	-	-	[898.16]
278	FORBES AVE	POT	245+79.94	32.63′ RT	-	-	[898.43]
279	FORBES AVE	POT	245+69.94	32.62′ RT	-	-	[898.55]
280	FORBES AVE	POT	245+59.94	32.60′ RT	-	-	[898.69]
281	FORBES AVE	POT	245+49.94	32.58′ RT	-	-	[898.82]
282	FORBES AVE	POT	245+39.92	32.56′ RT	-	-	[898.95]
283	FORBES AVE	POT	245+35.51	32.55′ RT	-	-	[899.00]
284	SCHENLEY DR	POT	24+56.60	36.51′ RT	-	-	[899.46]

SOUTHEAST QUADRANT

OFFSET

24+56.60 24.84′ RT

ELEVATION BOTTOM OF CURB

[898.75]

ELEVATION TOP OF CURB

ELEVATION BACK OF SIDEWALK

NOTE:

\* TOP OF CURB ELEVATION TO BE DETERMINED PER ITEM # 01900.001-DESIGN OF CURB RAMPS

[] MATCH EXISTING ELEVATION



SR 2108 FORBES AVE
FORBES AVE

247

248

SCALE

20 FEET

LEGEND

ELEVATION POINT IDENTIFICATION

DETECTABLE WARNING SURFACE

DIRECTIONAL INDICATOR

CURB RAMP

PAV'T SAW CUT LINE

FOR ROADWAY PLAN SEE SHEET 402

**AECOM** 

Gulf Tower 707 Grant Street 5th Floor Pittsburgh, PA 15219 GANNETT FLEMING

GANNETT FLEMING, INC. Foster Plaza 8 Suite 400 730 Holiday Drive Pittsburgh, PA. 15220 THE PREPARATION OF THIS
DOCUMENT HAS BEEN FINANCED IN
PART THROUGH A GRANT FROM THE
FEDERAL TRANSIT ADMINISTRATION,
U.S. DEPARTMENT OF
TRANSPORTATION, UNDER THE
URBAN MASS TRANSPORTATION ACT
OF 1964, AS AMENDED, FOR THE
PORT AUTHORITY OF ALLEGHENY
COUNTY, PENNSYLVANIA.

(NOT FOR CONSTRUCTION)

DESIGNED	TCG	
DRAWN	<u>TCG</u>	
CHECKED	KCF	
IN CHARGE	GEC	
DATE	05/01/24	
SCALE		
	AS SHOWN	

PORT AUTHORITY OF ALLEGHENY COUNTY
PITTSBURGH PENNSYLVANIA

BUS RAPID TRANSIT UPTOWN TO OAKLAND INTERSECTION DETAILS FORBES AVE & SCHENLEY DR EXT

FORBES AVE & SCHENLEY DR EXT

Port Authority CONTRACT NO. BRT-(

Port Authority Contract No. BRT-001

DWG. NO. ID90 SHT. 266

SOUTH QUADRANT							
POINT NUMBER	BASEL INE	POINT	STATION	OFFSET	ELEVATION BOTTOM OF CURB	ELEVATION TOP OF CURB	ELEVATION BACK OF SIDEWALK
270	FORBES AVE	POT	247+29.86	20.90' RT	[895.86']	896.32′	
271	FORBES AVE	POT	247+41.03	21.34' RT	[895.66']	896.12′	
272	FORBES AVE	POT	247+51.03	21.36′ RT	[895.50']	895.96′	
273	FORBES AVE	POT	247+61.03	21.37′ RT	[895.34']	895.80′	
274	FORBES AVE	POT	247+71.03	21.39' RT	[895.19']	895.65′	
275	FORBES AVE	POT	247+81.03	21.41′ RT	[895.01']	895.47′	
276	FORBES AVE	POT	247+91.03	21.42' RT	[894.84']	895.30′	
277	FORBES AVE	POT	248+01.03	21.44′ RT	[894.66']	895.12′	
278	FORBES AVE	PC	248+04.31	21.45′ RT	[894.59']	895.05′	
279	FORBES AVE	POC	248+05.15	21.52′ RT	[894.58']	895.04′	
280	FORBES AVE	PT	248+05.96	21.73′ RT	[894.56']	895.02'	
281	FORBES AVE	PC	248+07.15	22.15′ RT	[894.52']	894.98′	
282	FORBES AVE	POC	248+07.81	23.23' RT	[894.48']	894.94′	
283	FORBES AVE	PT	248+06.88	24.09' RT	[894.48']	894.94′	
284	FORBES AVE	POT	247+98.90	24.62' RT	[895.10']	895.69′	
285	FORBES AVE	POT	248+25.99	28.50' RT	[893.86']	[894.75′]	
286	FORBES AVE	POT	248+16.44	28.47′ RT	[894.12']	[894.85′]	
287	FORBES AVE	POT	248+07.81	29.04' RT	894.58′	[895.01']	
288	FORBES AVE	POT	247+99.19	29.61' RT	895.17′	[895.17′]	
289	FORBES AVE	POT	247+89.19	30.27' RT			[895.37']
290	FORBES AVE	POT	247+79.22	30.93' RT			[895.54']
291	FORBES AVE	POT	247+69.24	31.59' RT			[895.70′]
292	FORBES AVE	POT	247+59.25	32.26′ RT			[895.87′]
293	FORBES AVE	POT	247+48.80	32.95′ RT			[896.05']
294	FORBES AVE	POT	247+42.99	32.94′ RT			[896.17′]
295	FORBES AVE	POT	247+32.99	32.92' RT			[896.32']

NOTE:

\* TOP OF CURB ELEVATION TO BE DETERMINED PER ITEM # 01900.001-DESIGN OF CURB RAMPS

[] MATCH EXISTING ELEVATION

**AECOM** Gulf Tower 707 Grant Street 5th Floor Pittsburgh, PA 15219


GANNETT FLEMING
GANNETT FLEMING, INC.
Foster Plaza 8
Suite 400
730 Holiday Drive
Pittsburgh, PA. 15220

THE PREPARATION OF THIS

DOCUMENT HAS BEEN FINANCED IN
PART THROUGH A GRANT FROM THE
FEDERAL TRANSIT ADMINISTRATION,
U.S. DEPARTMENT OF
TRANSPORTATION, UNDER THE
URBAN MASS TRANSPORTATION ACT
OF 1964, AS AMENDED, FOR THE
PORT AUTHORITY OF ALLEGHENY
COUNTY, PENNSYLVANIA. NO. DATE DESCRIPTION REVISIONS

(NOT FOR CONSTRUCTION)

DESIGNED	TCG	PORT AUTHOR	ITY OF AL	LEGHENY COL	JNT	7
DRAWN	TCG	PITTSBURGH		PENNS	SYLVANI	Α
CHECKED	KCF	BUS RAPID TRANSIT UPTOWN TO OAKLAND				
IN CHARGE	<u>GEC</u>	INTERSECTION DETAILS				
DATE	05/01/24	FORBES	AVE & SCHE	NLEY DR EXT		
SCALE	AS SHOWN	<b>Port Authority</b>	CONTR	ACT NO. BRT-00	)1	
	AOOHOWN	connecting people to life	DWG. NO.	ID91	SHT.	267

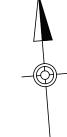

FIFTH AVE 436 437 S 85°18′29<sub>°</sub>" E 438 S 86°02′41" E FIFTH AVE CONSTR & LEGAL R/W LINE LEGAL R/W LINE PI STA 436+25.28 13.67' RT PI STA 436+25.26 10.00' RT DIAMOND ST CONSTR B 18' DRIVEWAY ♠ STA 435+96.97 10.32' RT PT STA 435+41.20 PI STA 435+85.73 34.12' RT PI STA 435+46.51 34.51′ RT PI STA 48+29.43 37.72' RT PC STA 48+07.29 14.33' RT MATCH LINE SEE SHEET 293

> SCALE 0 20 40 FEET

**AECOM** 

Gulf Tower 707 Grant Street 5th Floor Pittsburgh, PA 15219 THE PREPARATION OF THIS
DOCUMENT HAS BEEN FINANCED IN
PART THROUGH A GRANT FROM THE
FEDERAL TRANSIT ADMINISTRATION,
U.S. DEPARTMENT OF
TRANSPORTATION, UNDER THE
URBAN MASS TRANSPORTATION ACT
OF 1964, AS AMENDED, FOR THE
NO. DATE
DESCRIPTION
REVISIONS

THE PREPARATION OF THIS
DOCUMENT HAS BEEN FINANCED IN
PART THROUGH A GRANT FROM THE
URBAN MASS TRANSPORTATION ACT
OF 1964, AS AMENDED, FOR THE
PORT AUTHORITY OF ALLEGHENY
COUNTY, PENNSYLVANIA.

(NOT FOR CONSTRUCTION)

ESIGNED	SDS	
RAWN	<u>JMS</u>	
HECKED	BFS	
CHARGE	LAR	
ATE	05/01/24	
CALE		
	AS SHOWN	

FOR ROADWAY PLAN SEE SHEET 357

PORT AUTHORITY OF ALLEGHENY COUNTY
PITTSBURGH

PLAN DARID TRANSIT LIDTOWALTO CALCAND


BUS RAPID TRANSIT UPTOWN TO OAKLAND CIVIL LAYOUT PLANS FIFTH AVE - STA 433+50 TO STA 438+50

FIFTH AVE - STA 433+50 TO STA 438+50

Port Authority CONTRACT NO. BRT-001

Port Authority CONTRACT NO. BRT-001

DWG. NO. CL1 SHT. 268

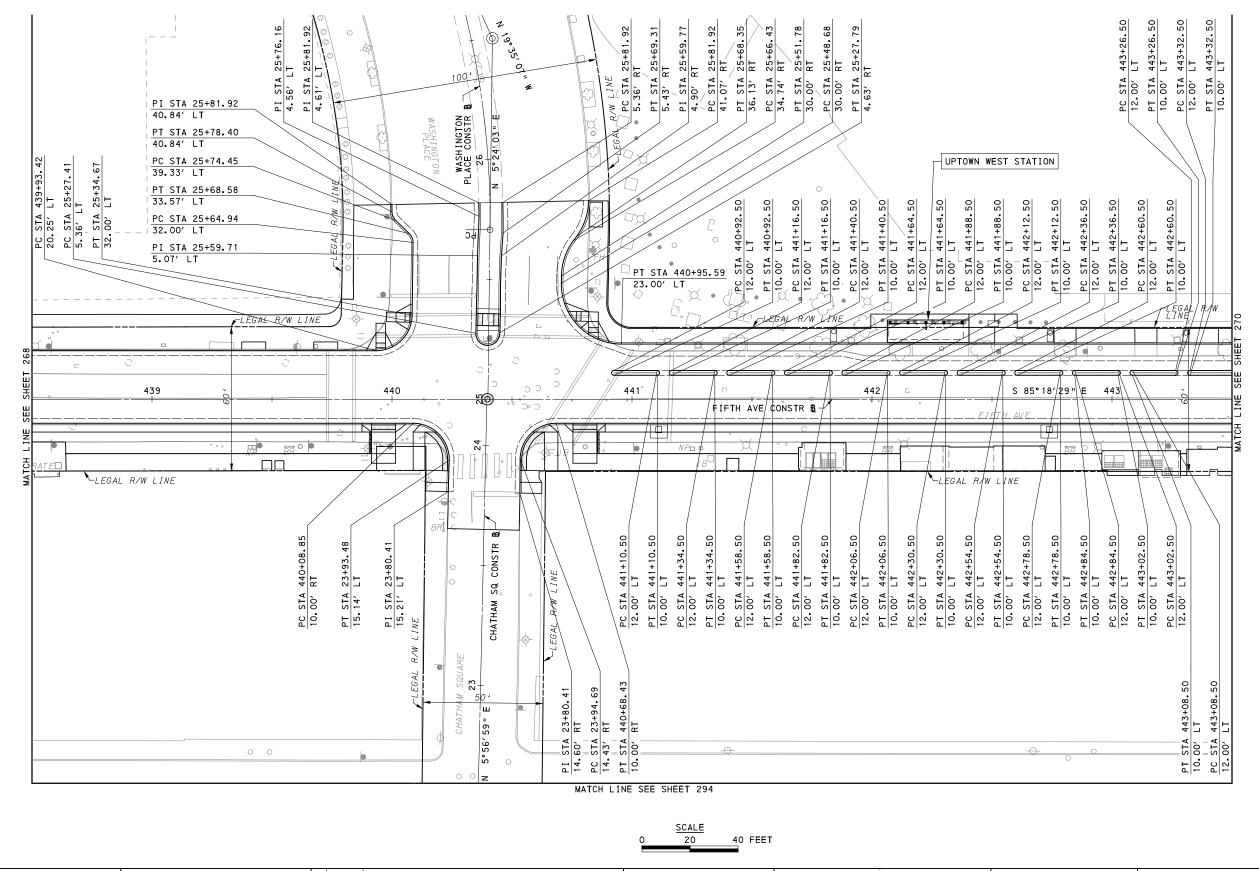

FOR ROADWAY PLAN SEE SHEET 358

**AECOM Gulf Tower** 

707 Grant Street 5th Floor Pittsburgh, PA 15219

THE PREPARATION OF THIS
DOCUMENT HAS BEEN FINANCED IN
PART THROUGH A GRANT FROM THE
FEDERAL TRANSIT ADMINISTRATION PEDERAL TRANSIT ADMINISTRATION,
U.S. DEPARTMENT OF
TRANSPORTATION, UNDER THE
URBAN MASS TRANSPORTATION ACT
OF 1964, AS AMENDED, FOR THE
PORT AUTHORITY OF ALLEGHENY
COUNTY, PENNSYLVANIA. NO. DATE DESCRIPTION REVISIONS


(NOT FOR CONSTRUCTION)

DESIGNED	SDS	
DRAWN	<u>JMS</u>	
CHECKED	BFS	
IN CHARGE	LAR	
DATE	05/01/24	
SCALE		
	AS SHOWN	

PORT AUTHORITY OF ALLEGHENY COUNTY PENNSYLVANIA BUS RAPID TRANSIT UPTOWN TO OAKLAND CIVIL LAYOUT PLANS FIFTH AVE - STA 438+50 TO STA 443+50

CONTRACT NO. BRT-001 **Port Authority** 

DWG. NO. CL2 sнт. 269

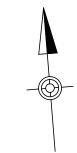

PI STA 448+20.00 21.00' LT

PT STA 448+16.01 10.00' RT

PI STA 448+19.54 10.00' RT

448

PI STA 448+30.00 28.86' LT

PI STA 448+21.01 13.71' RT

PC STA 36+50.24

Gulf Tower 707 Grant Street 5th Floor Pittsburgh, PA 15219

THE PREPARATION OF THIS
DOCUMENT HAS BEEN FINANCED IN
PART THROUGH A GRANT FROM THE
FEDERAL TRANSIT ADMINISTRATION,
U.S. DEPARTMENT OF
TRANSPORTATION, UNDER THE
URBAN MASS TRANSPORTATION ACT
OF 1964, AS AMENDED, FOR THE
PORT AUTHORITY OF ALLEGHENY
COUNTY, PENNSYLVANIA. NO. DATE DESCRIPTION REVISIONS

(NOT FOR CONSTRUCTION)

ESIGNED	<u>SDS</u>	
RAWN	<u>JMS</u>	
HECKED	BFS	
CHARGE	LAR	
ATE	05/01/24	
CALE		
	AS SHOWN	

CONSTR

ST

O MAGEE :


PI STA 36+35, 22WE


Ø

FOR ROADWAY PLAN SEE SHEET 359 PORT AUTHORITY OF ALLEGHENY COUNTY PENNSYLVANIA

BUS RAPID TRANSIT UPTOWN TO OAKLAND
CIVIL LAYOUT PLANS
FIFTH AVE - STA 443+50 TO STA 448+50

CONTRACT NO. BRT-001 **Port Authority** CL3 DWG. NO. sнт. 270

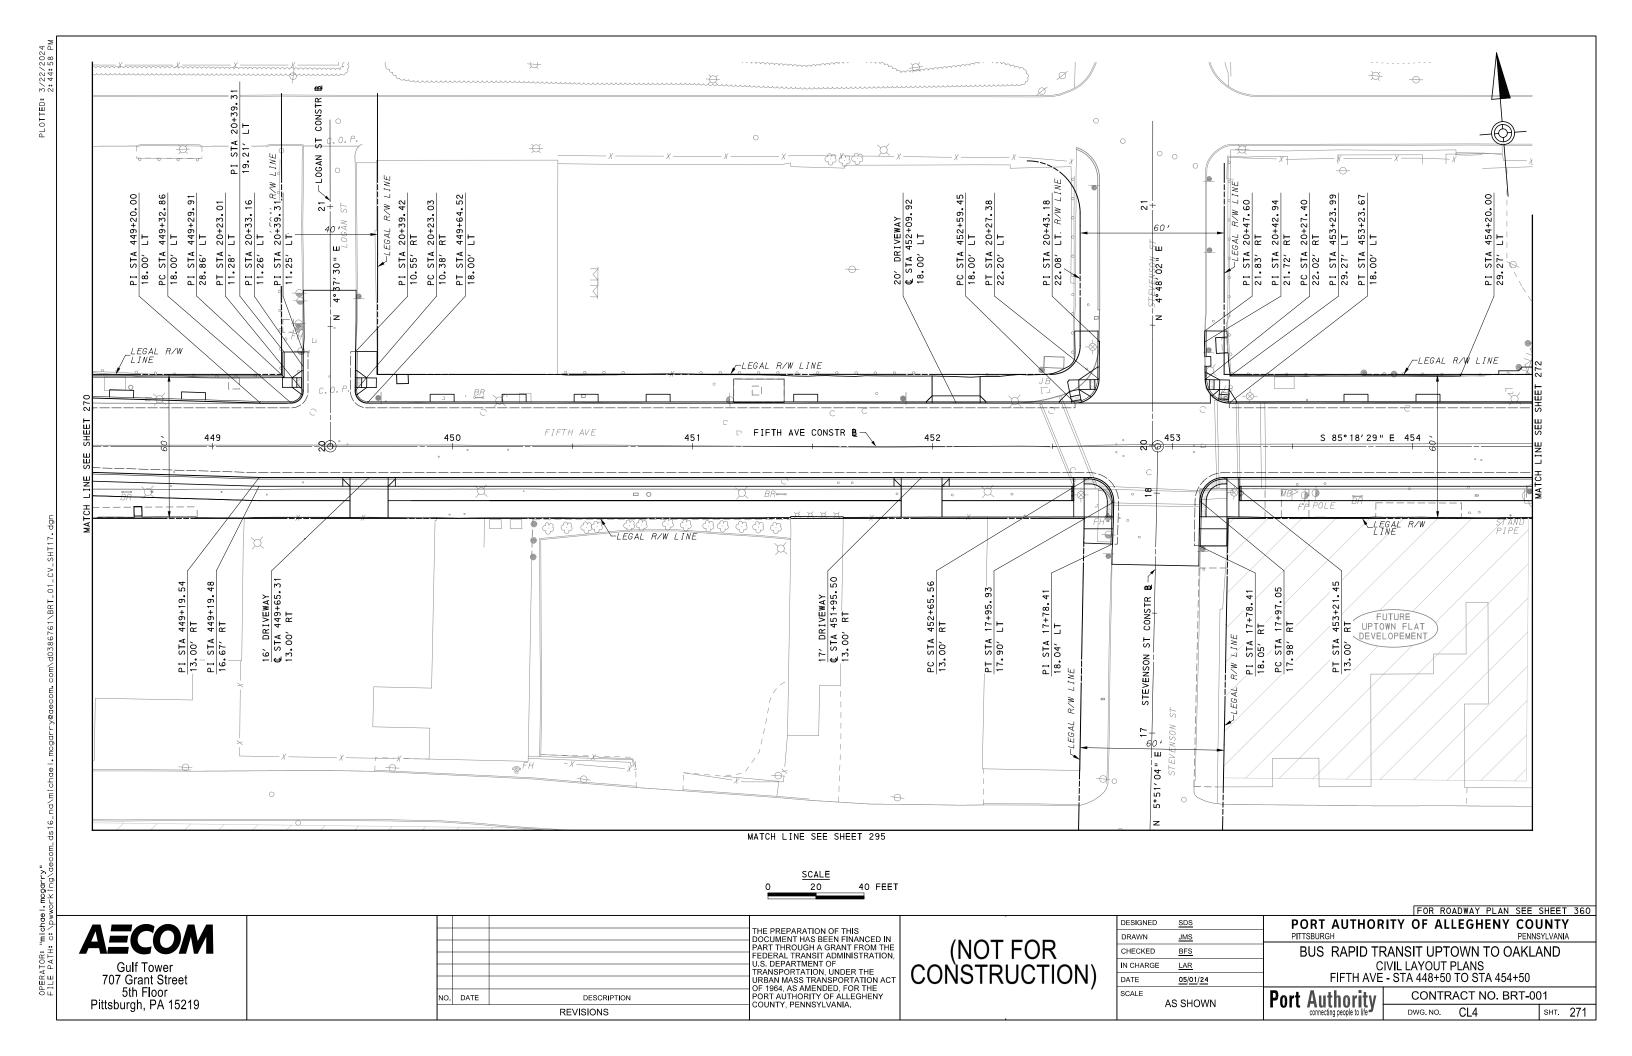

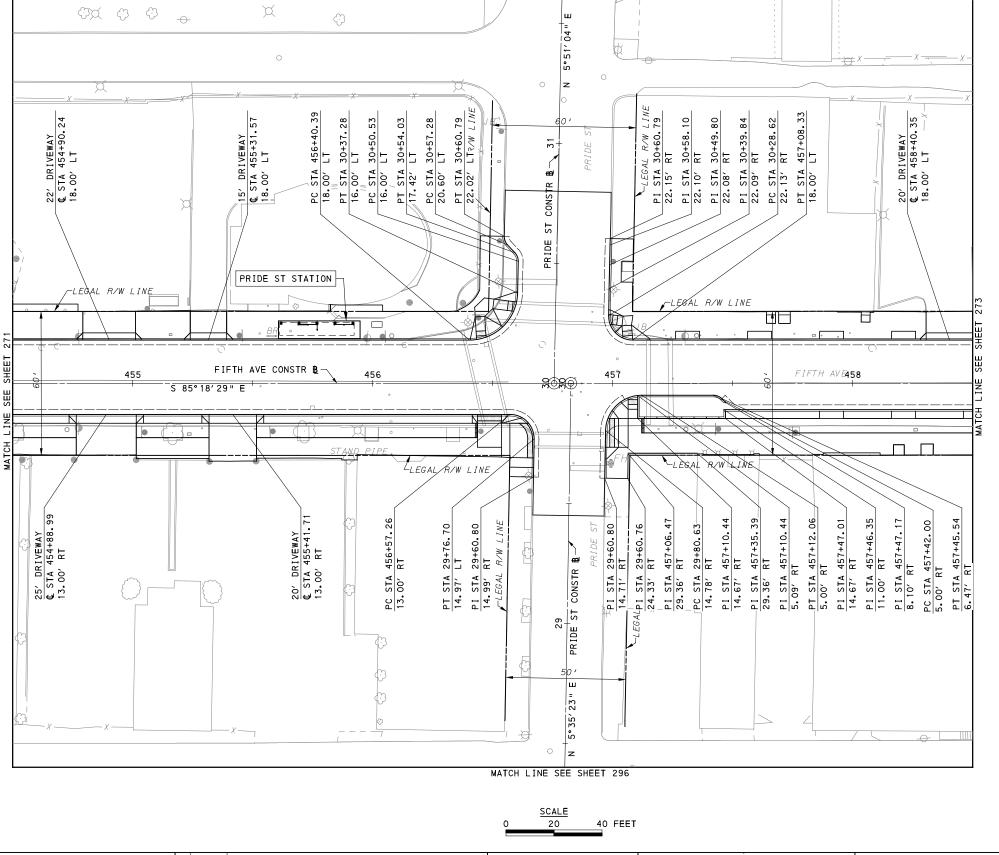

FOR ROADWAY PLAN SEE SHEET 361

**AECOM** 

Gulf Tower 707 Grant Street 5th Floor Pittsburgh, PA 15219 THE PREPARATION OF THIS
DOCUMENT HAS BEEN FINANCED IN
PART THROUGH A GRANT FROM THE
FEDERAL TRANSIT ADMINISTRATION,
U.S. DEPARTMENT OF
TRANSPORTATION, UNDER THE
URBAN MASS TRANSPORTATION ACT
OF 1964, AS AMENDED, FOR THE
PORT AUTHORITY OF ALLEGHENY
COUNTY, PENNSYLVANIA.

(NOT FOR CONSTRUCTION)

DESIGNED	SDS	
DRAWN	<u>JMS</u>	
CHECKED	<u>BFS</u>	
IN CHARGE	LAR	
DATE	05/01/24	
SCALE		
	AS SHOWN	

PORT AUTHORITY OF ALLEGHENY COUNTY
PITTSBURGH PENNSYLVANIA

BLIS RAPID TRANSIT LIPTOWN TO OAKLAND


BUS RAPID TRANSIT UPTOWN TO OAKLAND CIVIL LAYOUT PLANS FIFTH AVE - STA 454+50 TO STA 458+50


FIFTH AVE - STA 454+50 TO STA 458+50

Port Authority CONTRACT NO. BRT-001

Port Authority CONTRACT NO. BRT-001

DWG. NO. CL5 SHT. 272

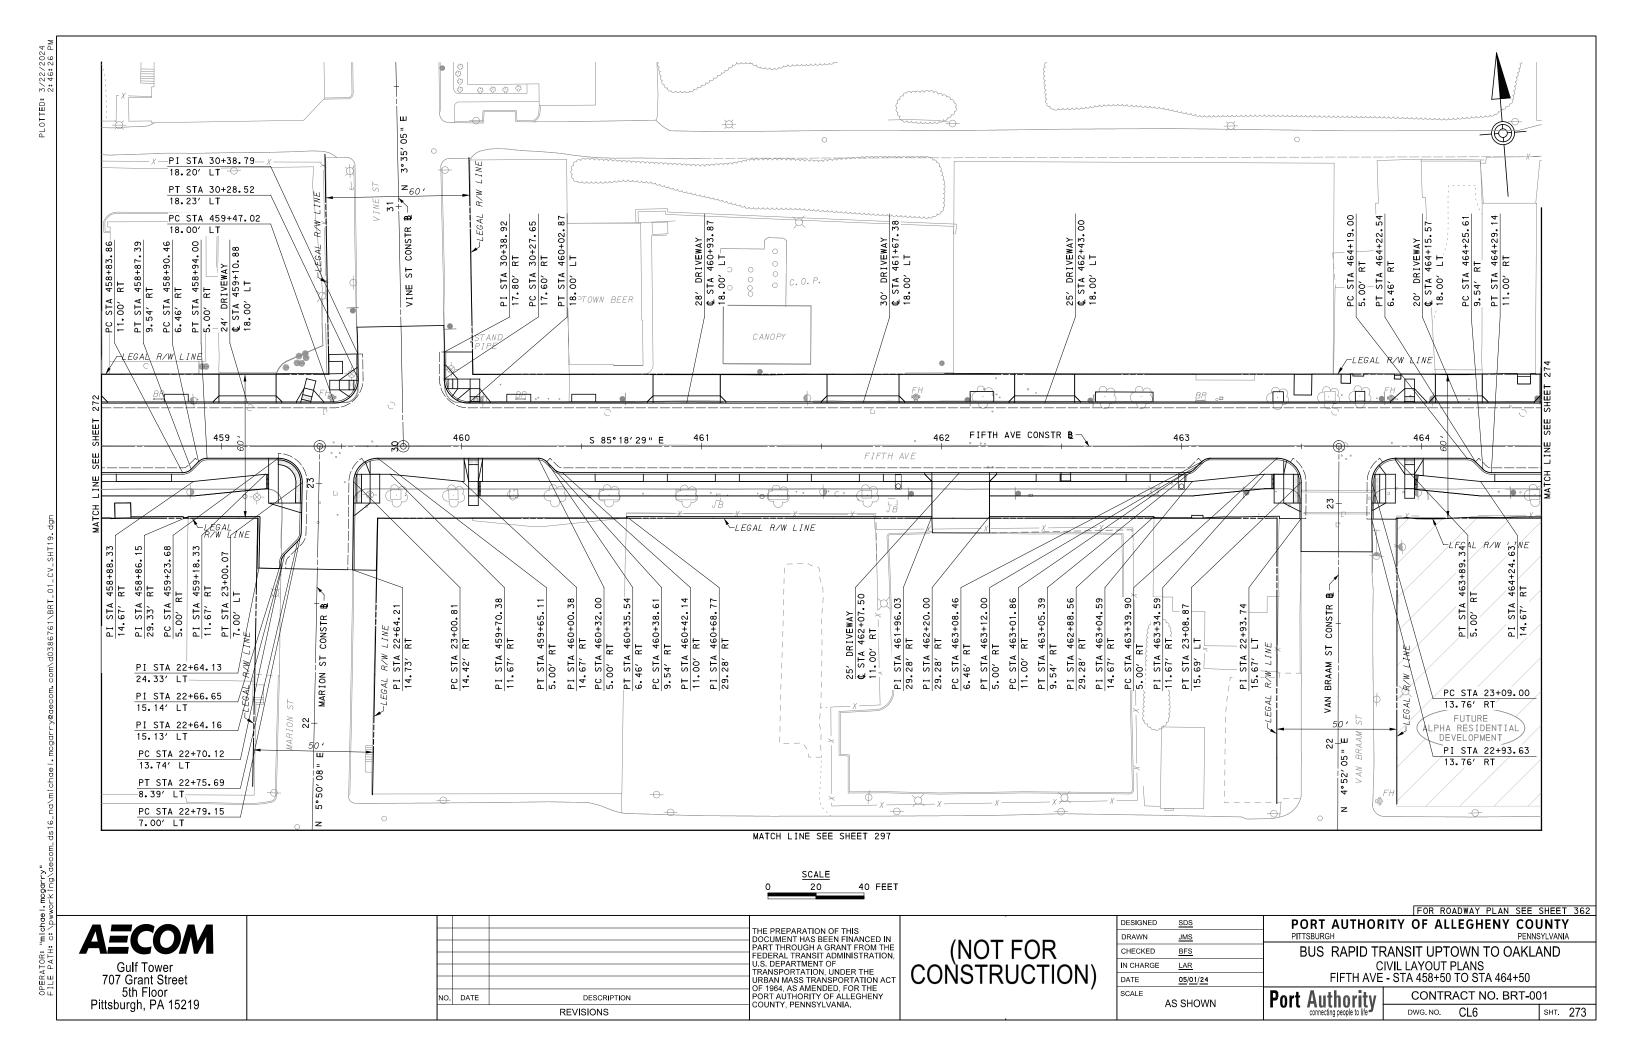

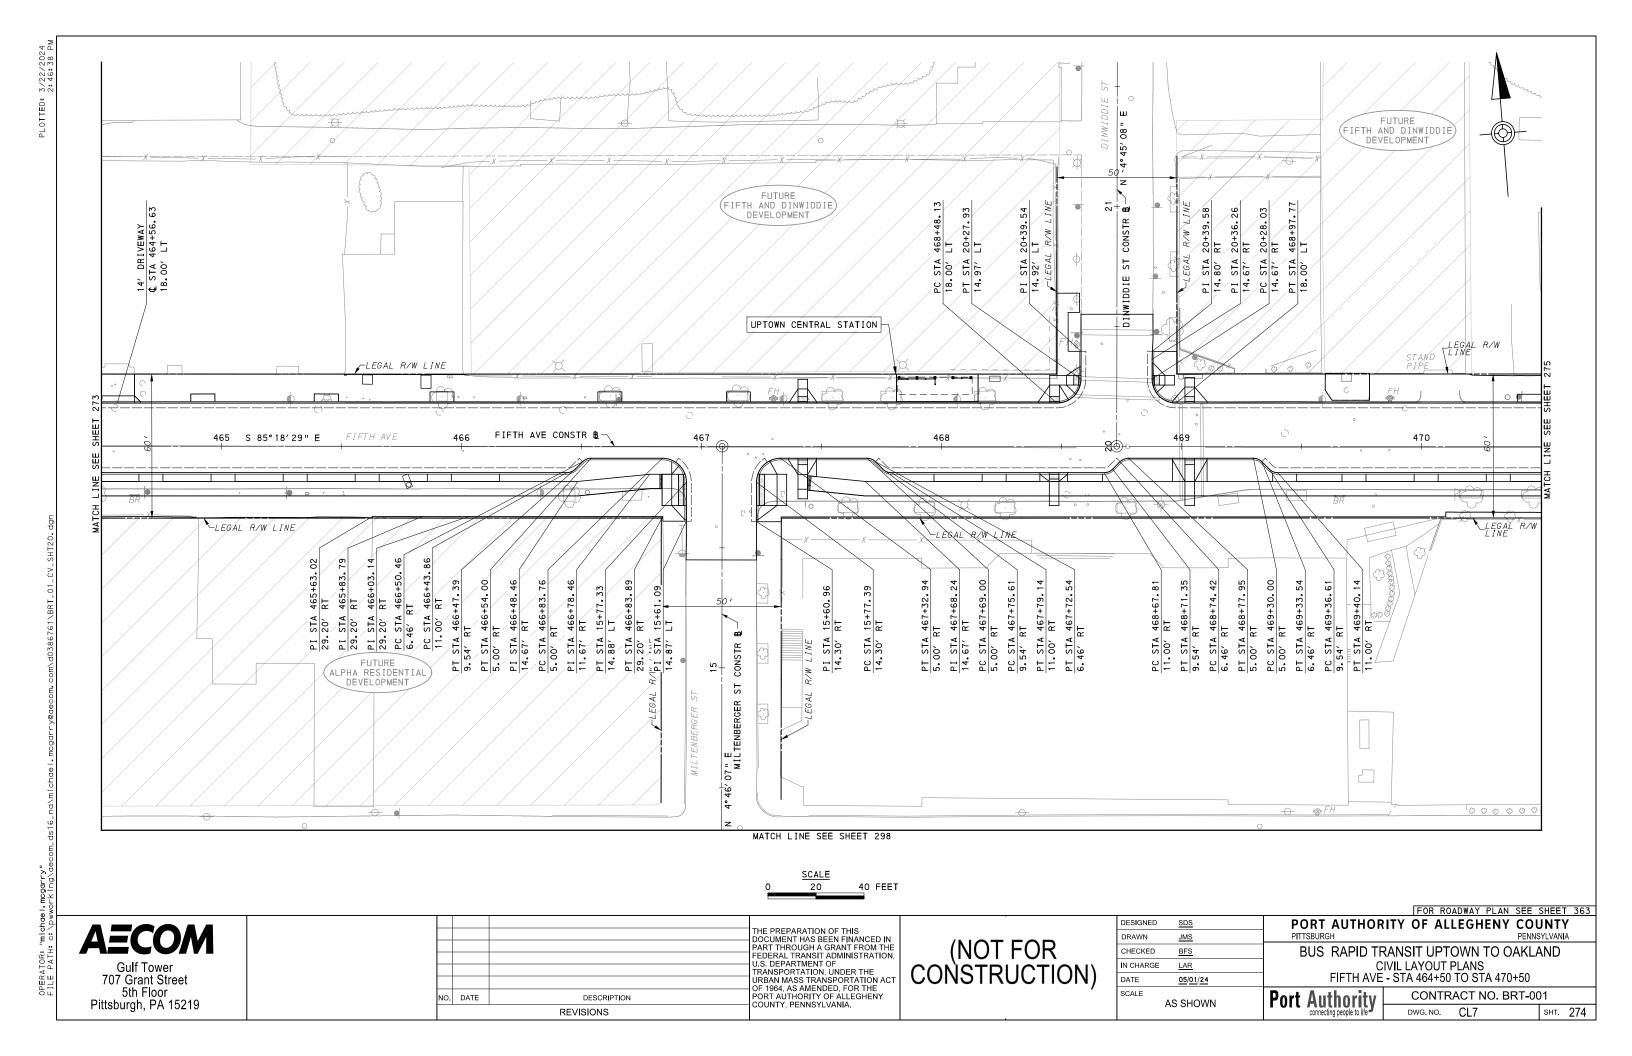

**AECOM** 

Gulf Tower 707 Grant Street 5th Floor Pittsburgh, PA 15219

THE PREPARATION OF THIS
DOCUMENT HAS BEEN FINANCED IN
PART THROUGH A GRANT FROM THE
FEDERAL TRANSIT ADMINISTRATION,
U.S. DEPARTMENT OF
TRANSPORTATION, UNDER THE
URBAN MASS TRANSPORTATION ACT
OF 1964, AS AMENDED, FOR THE
PORT AUTHORITY OF ALLEGHENY
COUNTY, PENNSYLVANIA. NO. DATE DESCRIPTION REVISIONS

(NOT FOR CONSTRUCTION)

DESIGNED	SDS	
DRAWN	<u>JMS</u>	
CHECKED	BFS	
IN CHARGE	LAR	
DATE	05/01/24	
SCALE		
	AS SHOWN	

FOR ROADWAY PLAN SEE SHEET 364 PORT AUTHORITY OF ALLEGHENY COUNTY


BUS RAPID TRANSIT UPTOWN TO OAKLAND CIVIL LAYOUT PLANS FIFTH AVE - STA 470+50 TO STA 475+50

CONTRACT NO. BRT-001

Port Authority CL8 DWG. NO.

sнт. 275



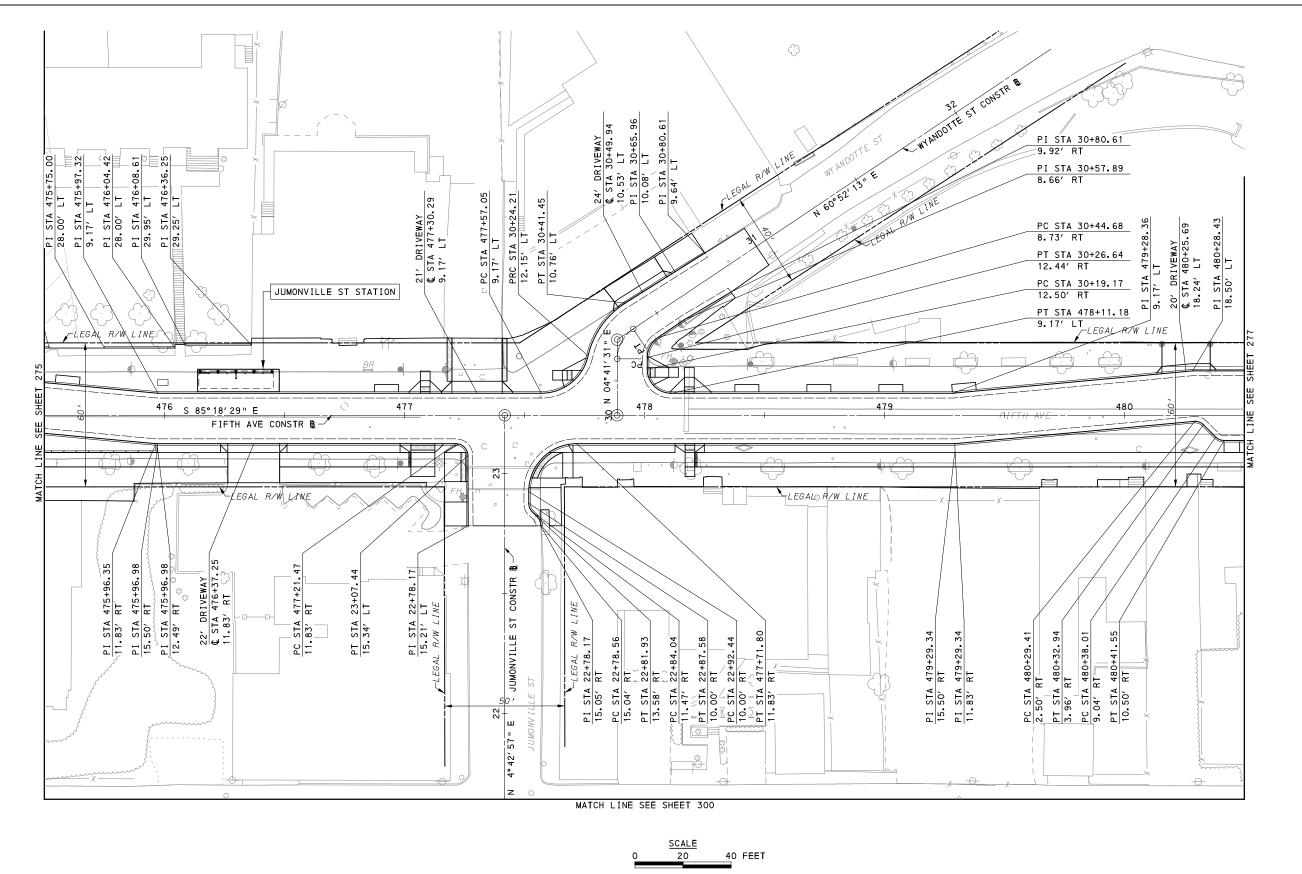

**AECOM** 

Gulf Tower 707 Grant Street 5th Floor Pittsburgh, PA 15219

THE PREPARATION OF THIS
DOCUMENT HAS BEEN FINANCED IN
PART THROUGH A GRANT FROM THE
FEDERAL TRANSIT ADMINISTRATION,
U.S. DEPARTMENT OF
TRANSPORTATION, UNDER THE
URBAN MASS TRANSPORTATION ACT
OF 1964, AS AMENDED, FOR THE
PORT AUTHORITY OF ALLEGHENY
COUNTY, PENNSYLVANIA. NO. DATE DESCRIPTION REVISIONS


(NOT FOR CONSTRUCTION)


DESIGNED	<u>SDS</u>	
DRAWN	<u>JMS</u>	
CHECKED	<u>BFS</u>	
IN CHARGE	<u>LAR</u>	
DATE	05/01/24	
SCALE		
	AS SHOWN	


FOR ROADWAY PLAN SEE SHEET 365 PORT AUTHORITY OF ALLEGHENY COUNTY PENNSYLVANIA BUS RAPID TRANSIT UPTOWN TO OAKLAND CIVIL LAYOUT PLANS FIFTH AVE - STA 475+50 TO STA 480+50


sнт. 276


Port Authority connecting people to life CONTRACT NO. BRT-001 CL9 DWG. NO.

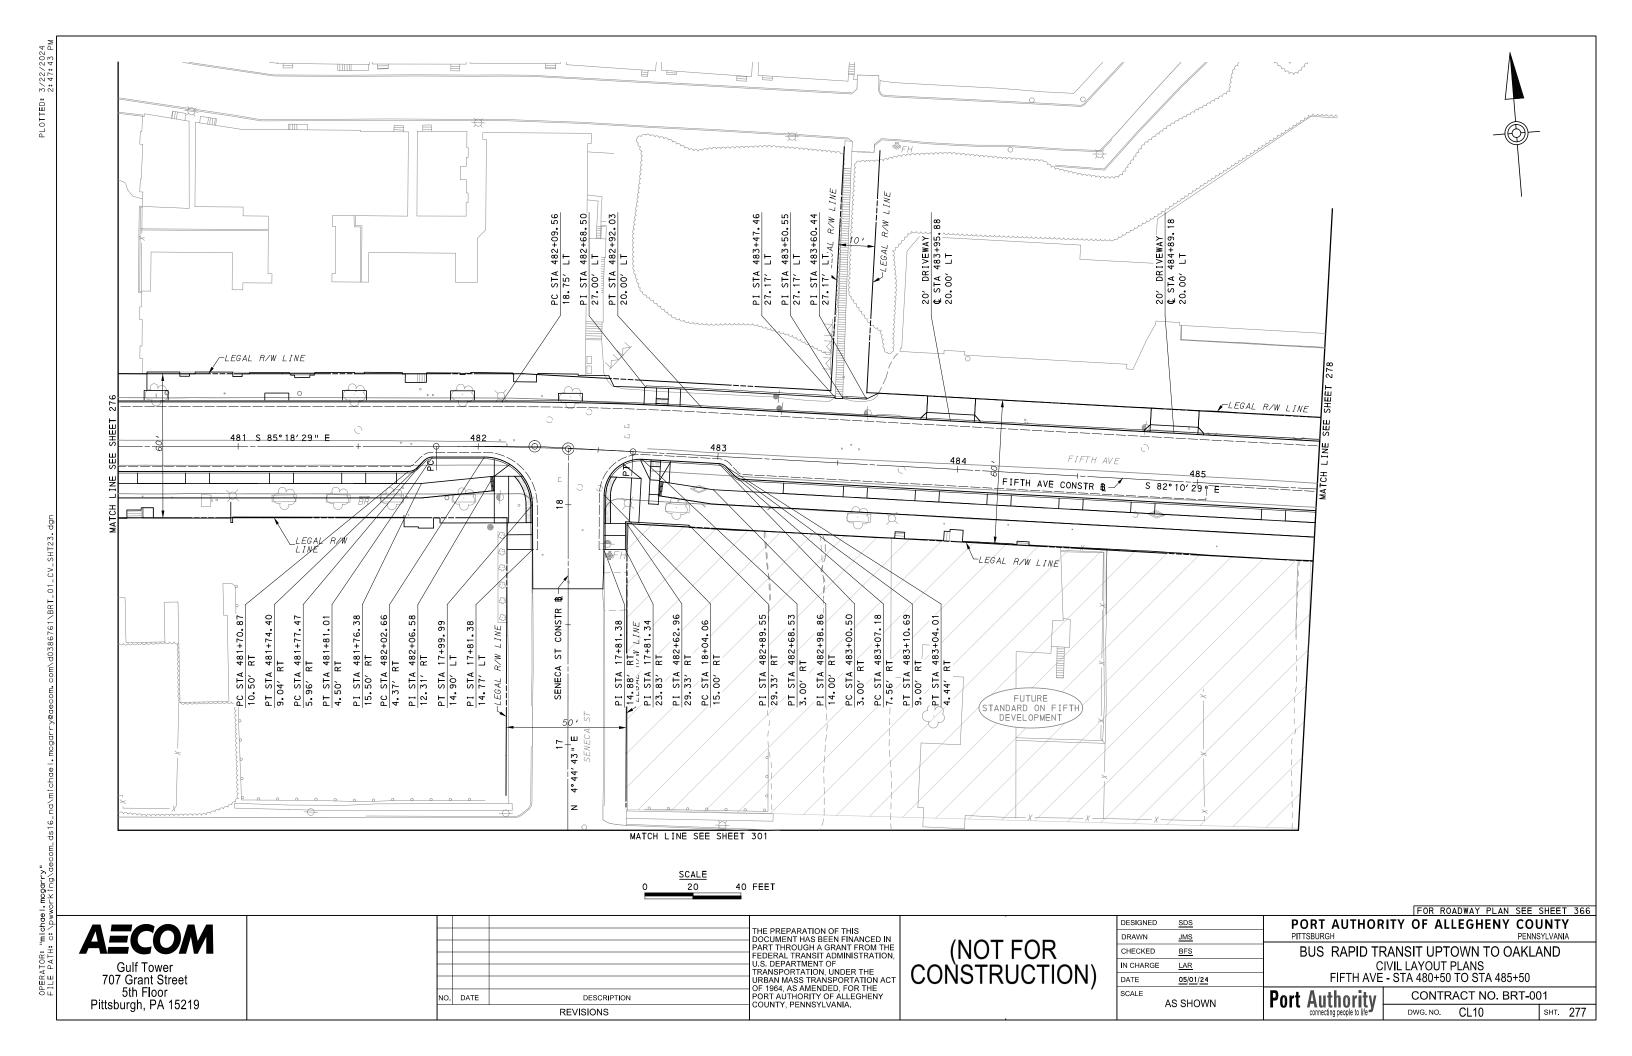


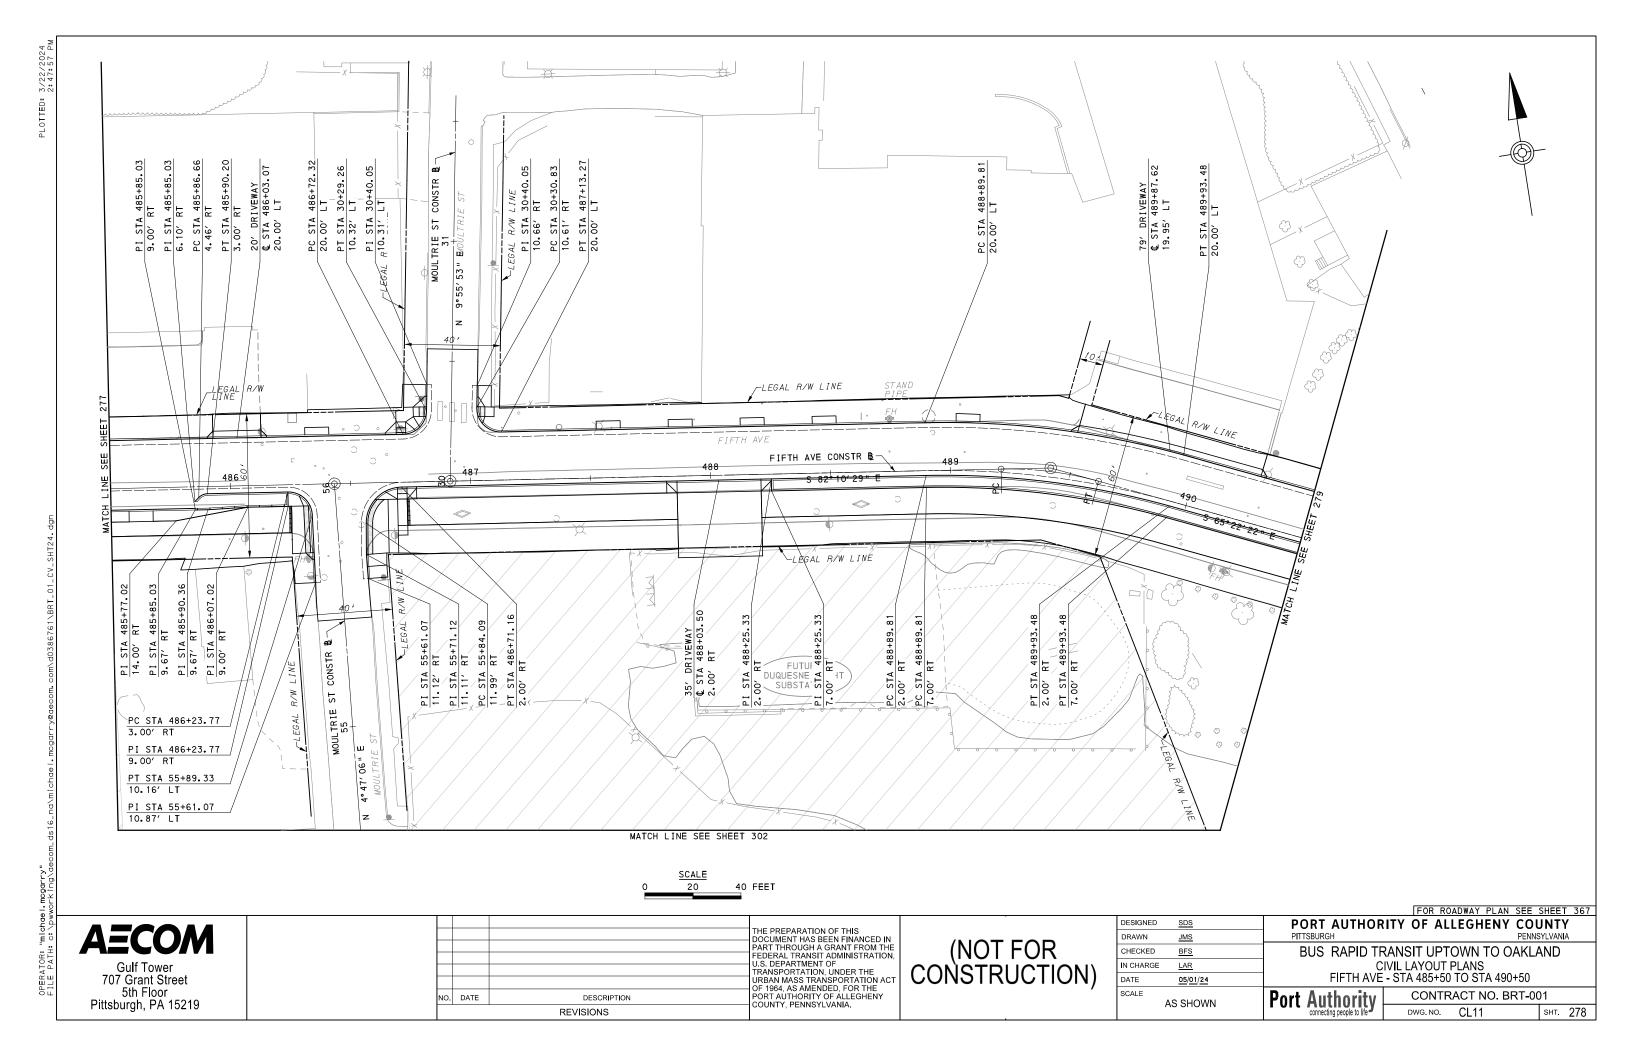


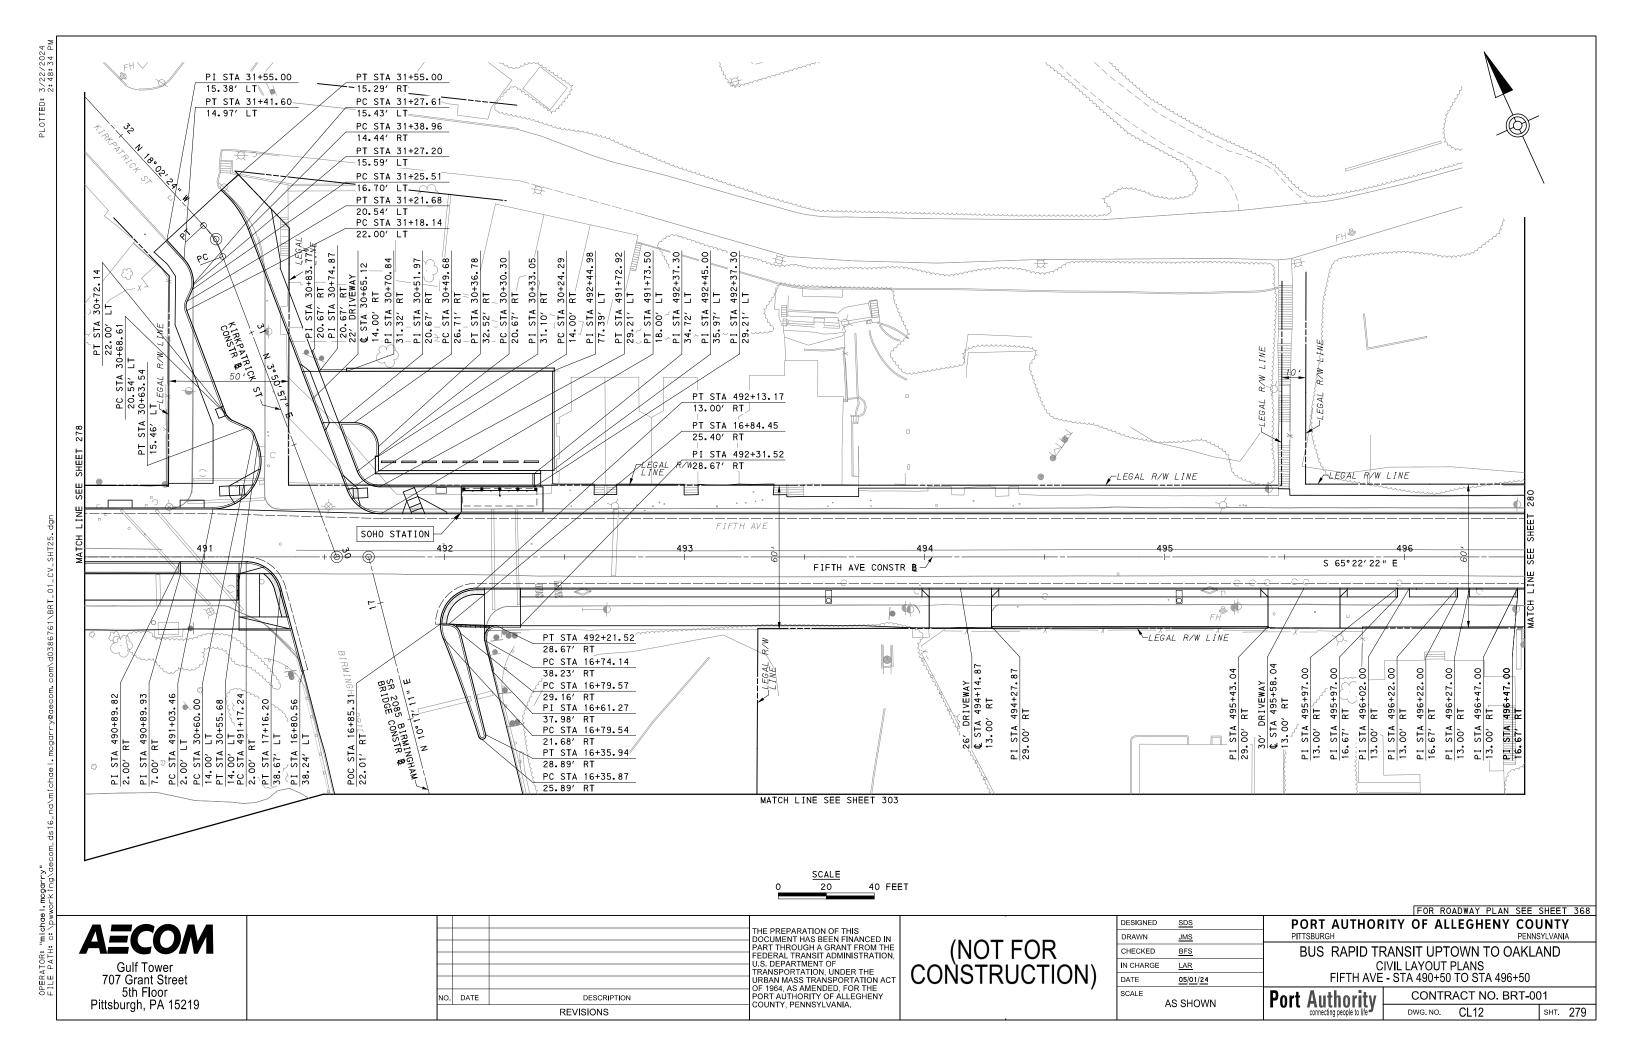


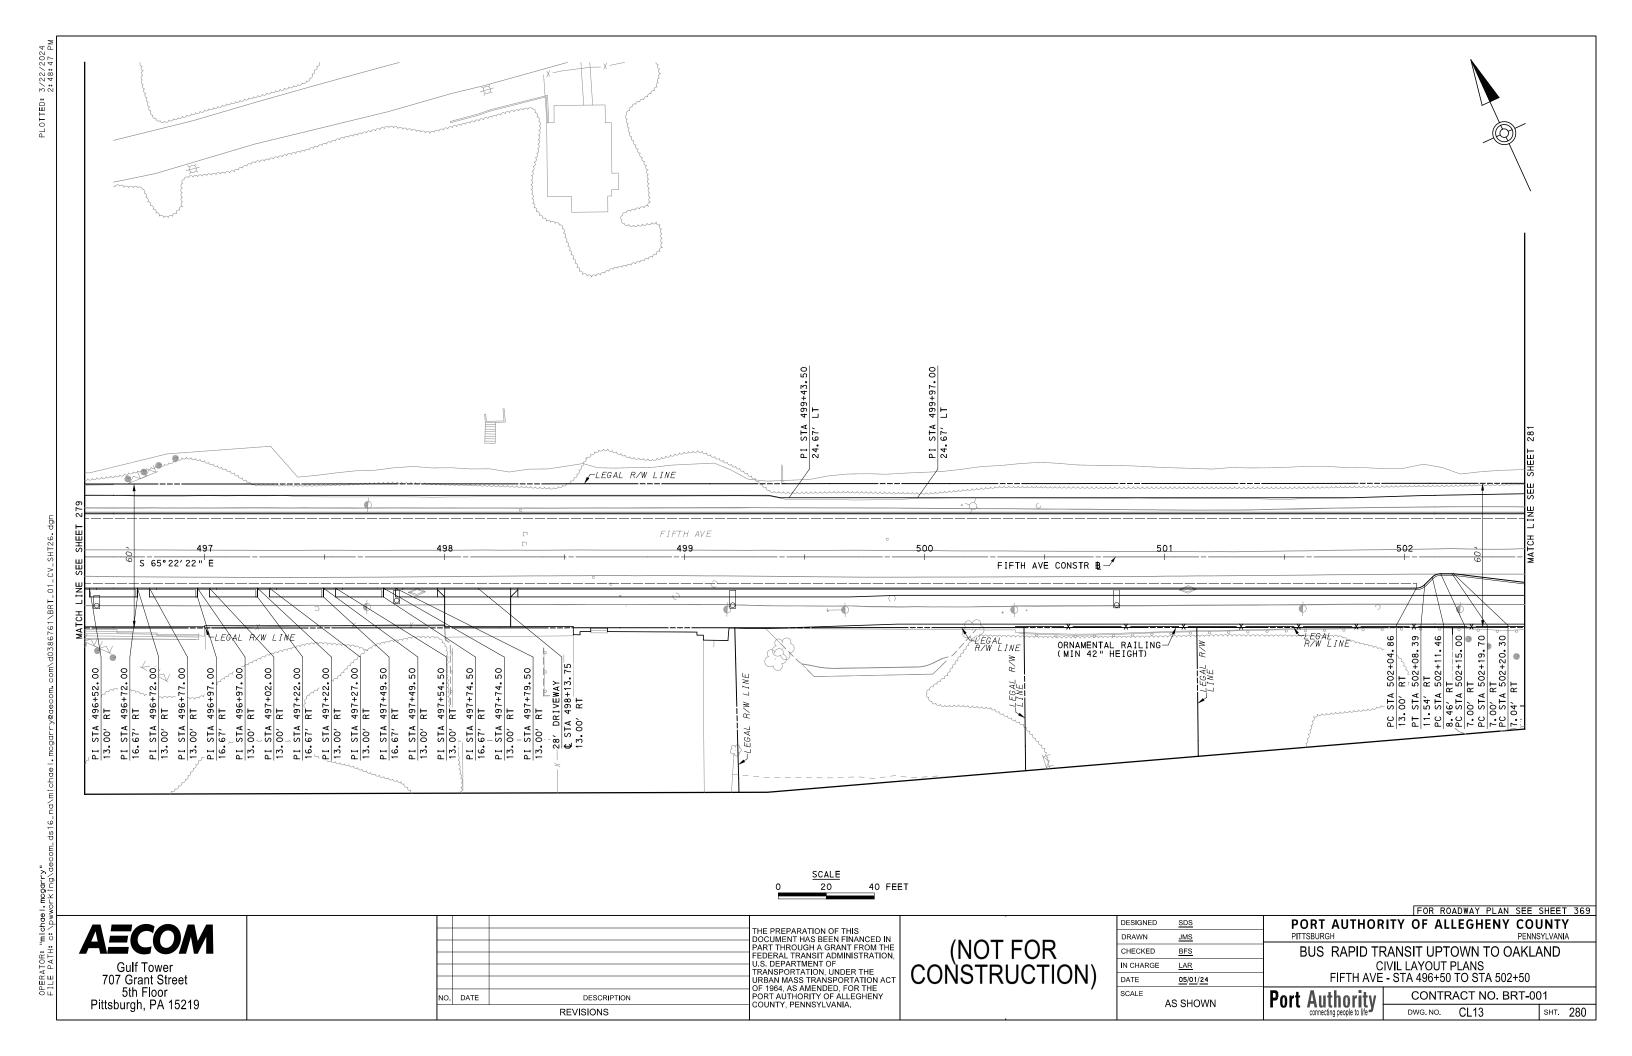


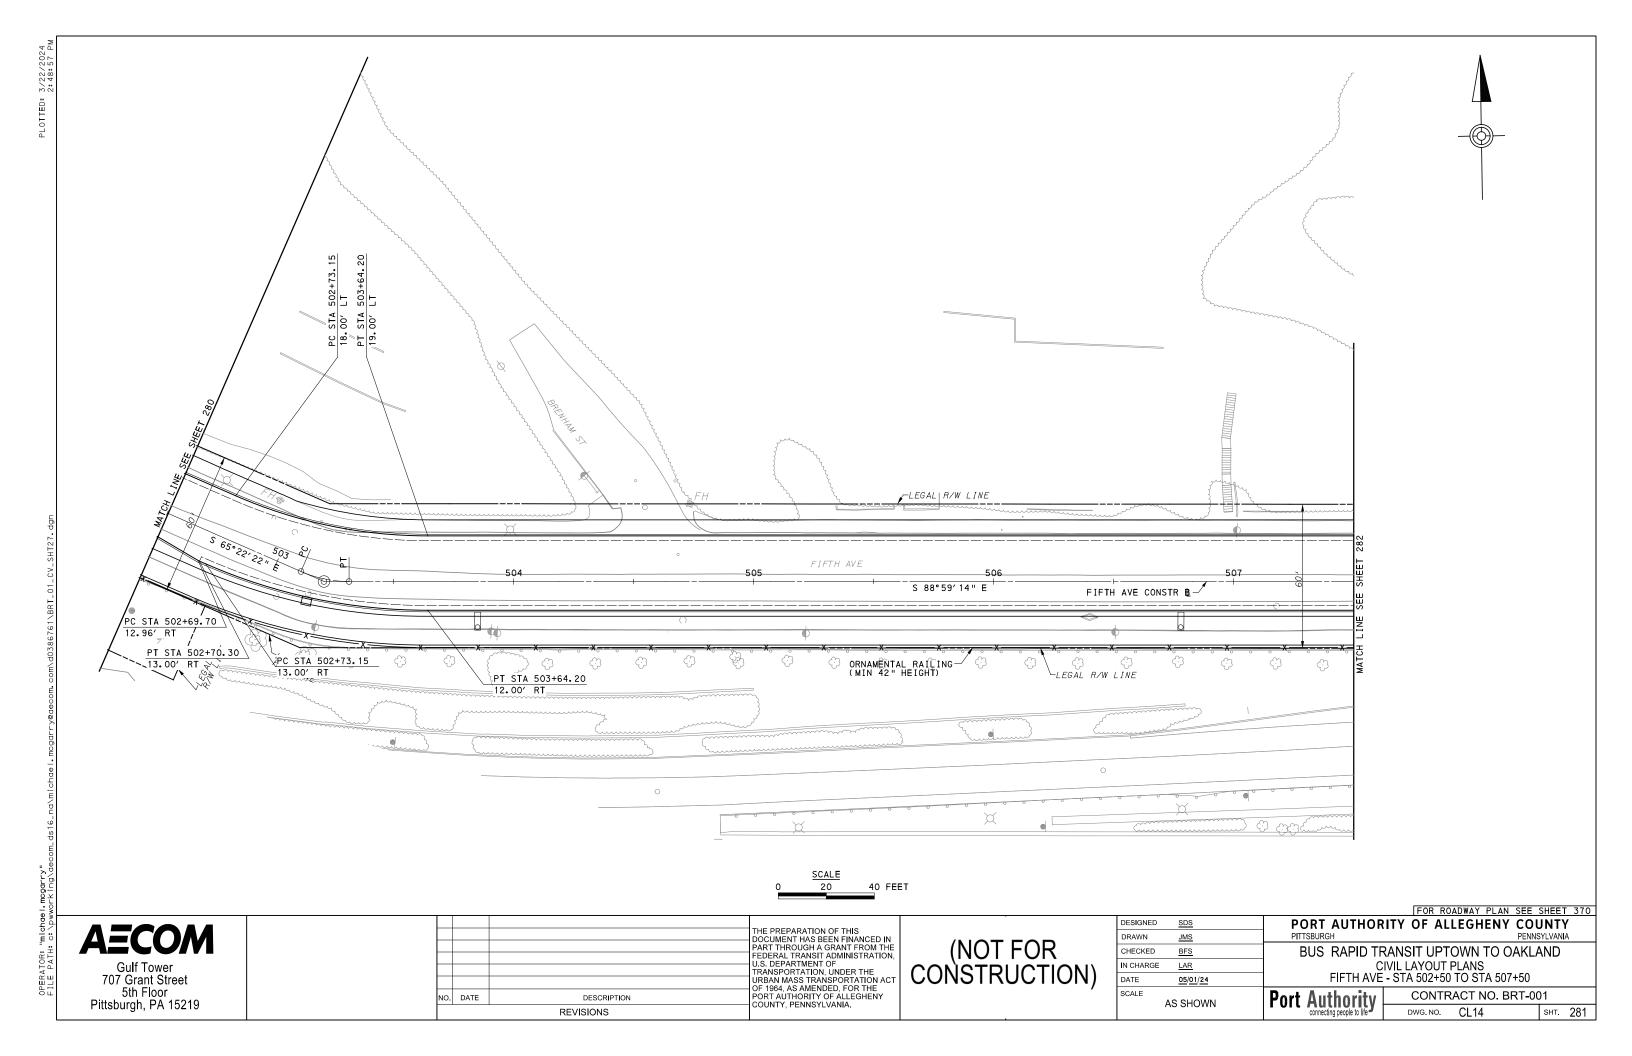


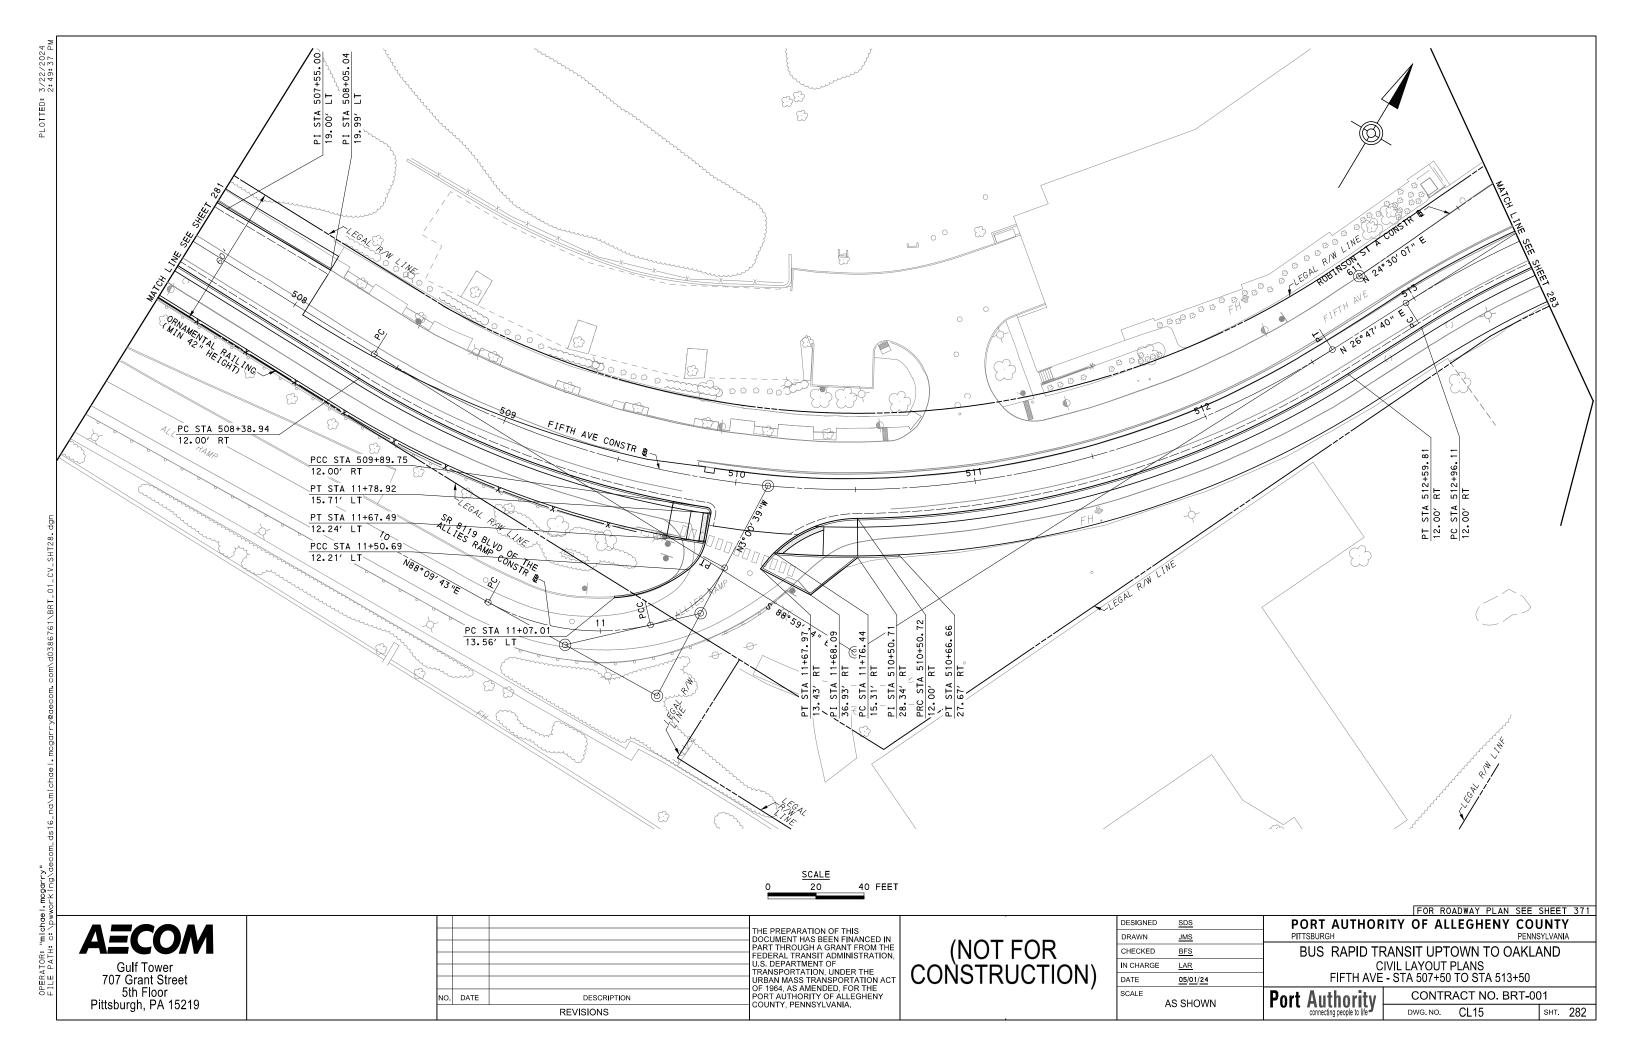


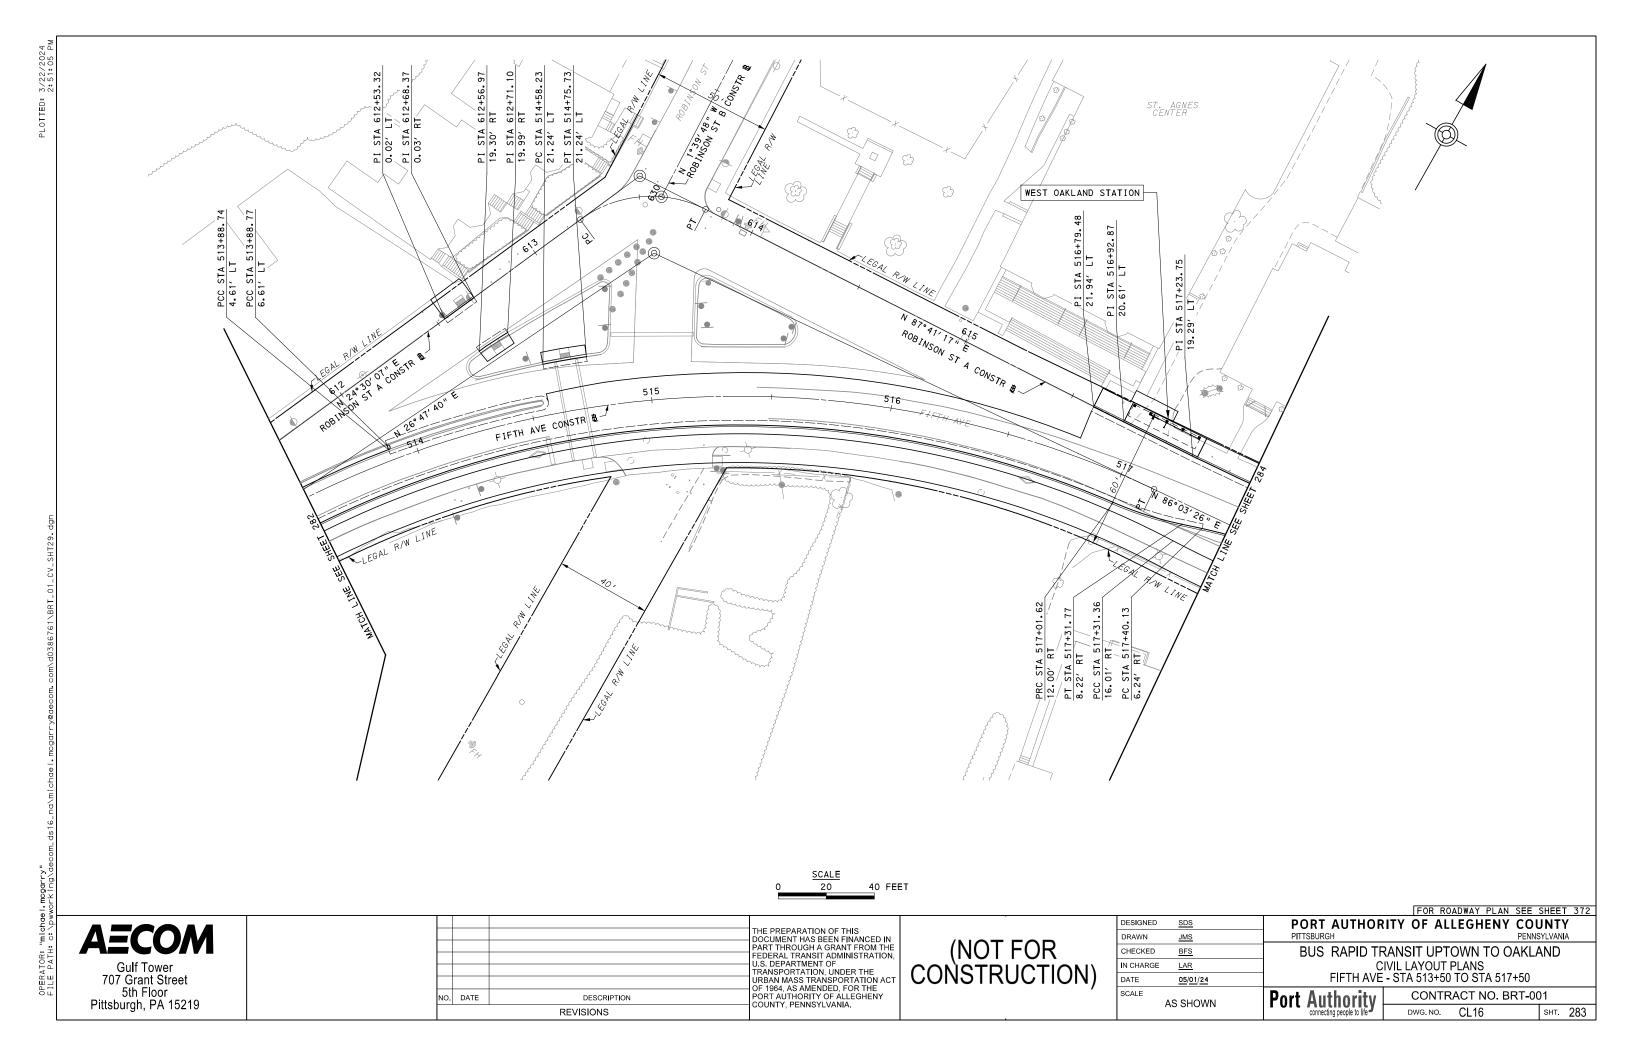


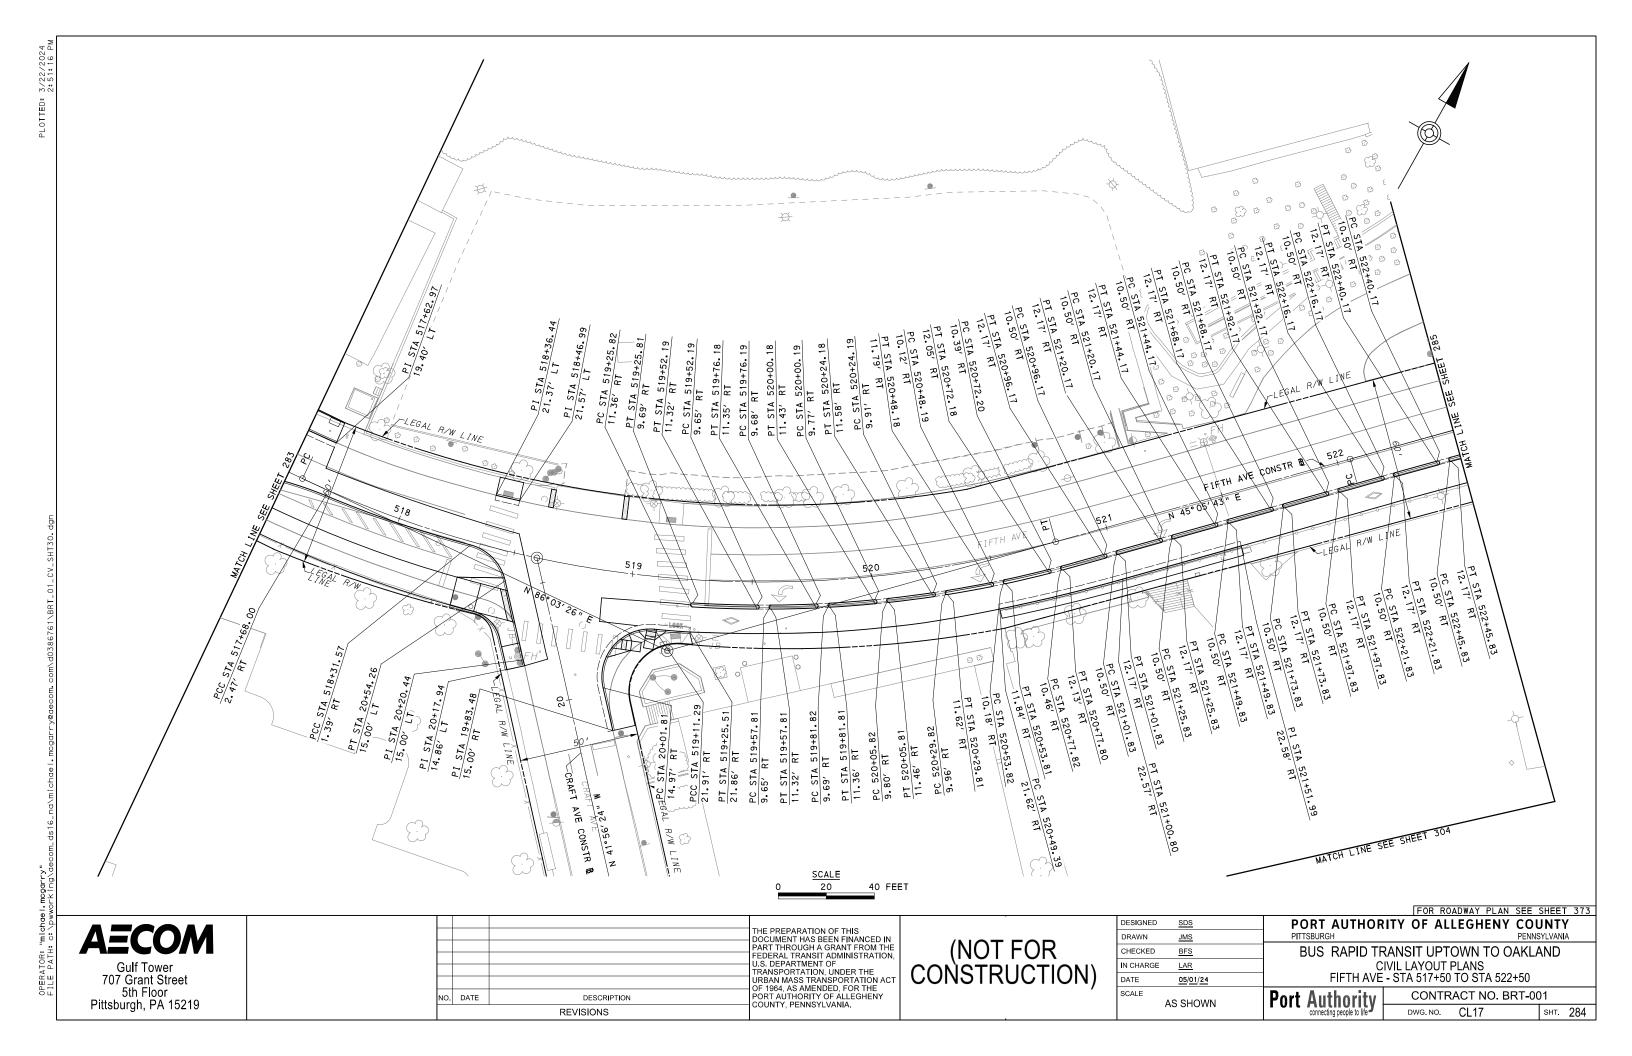


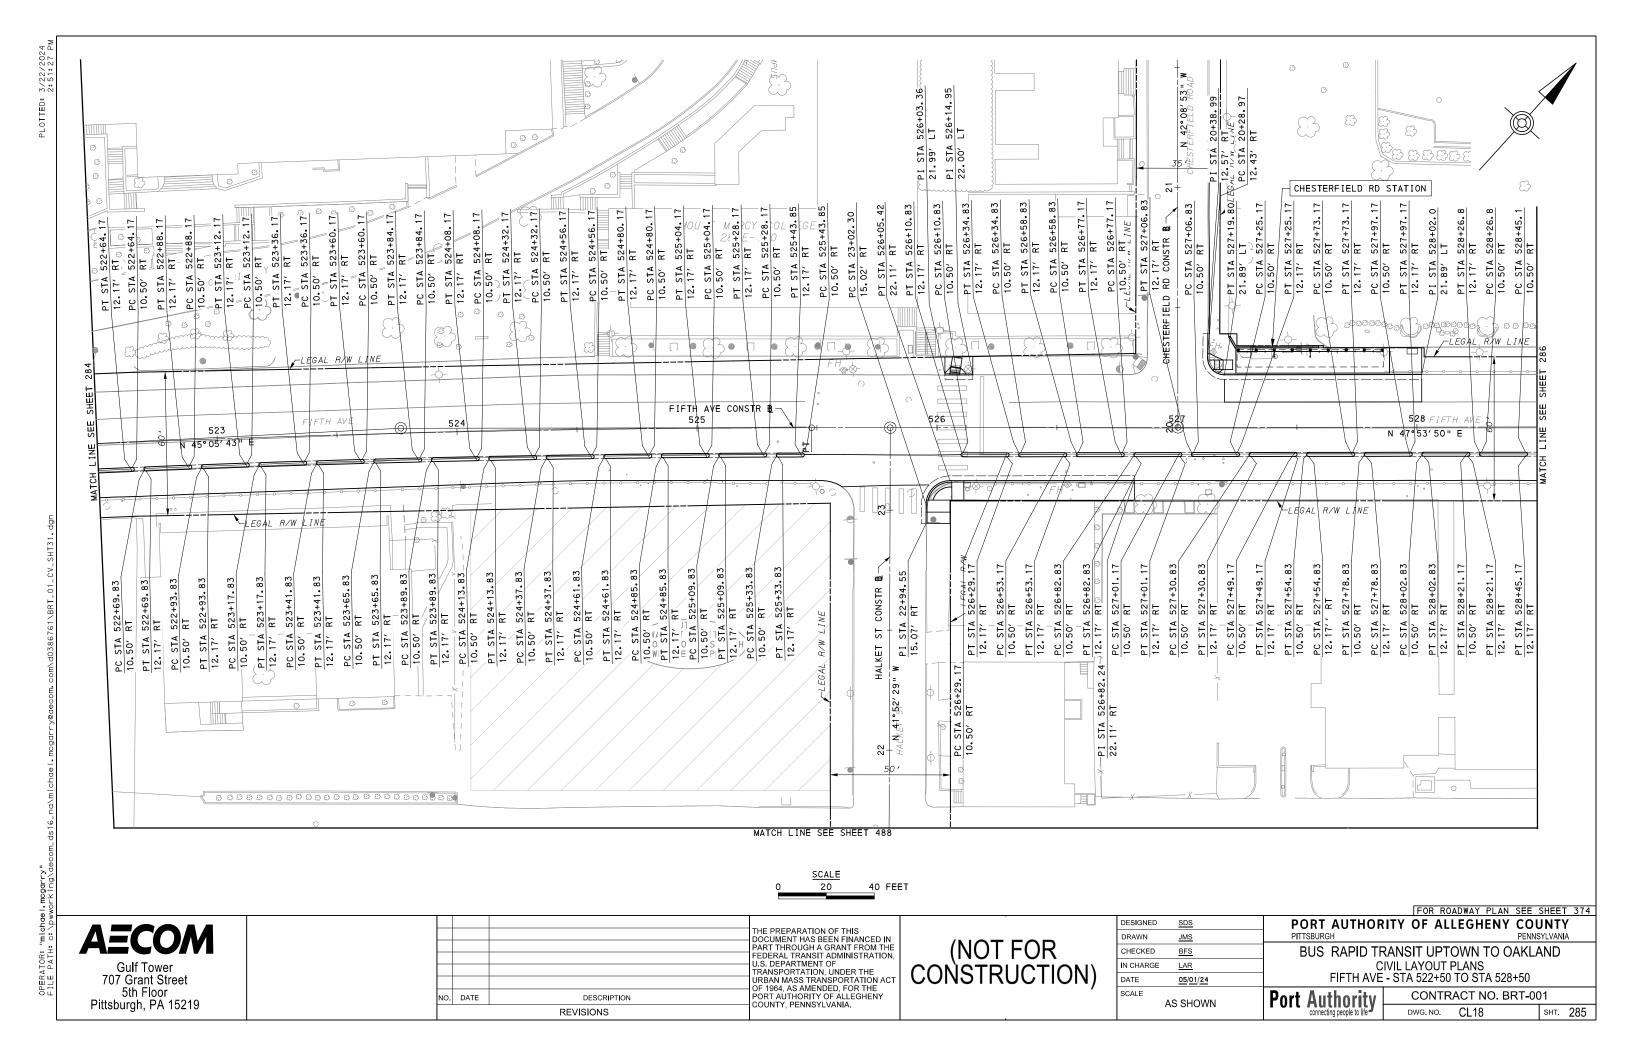


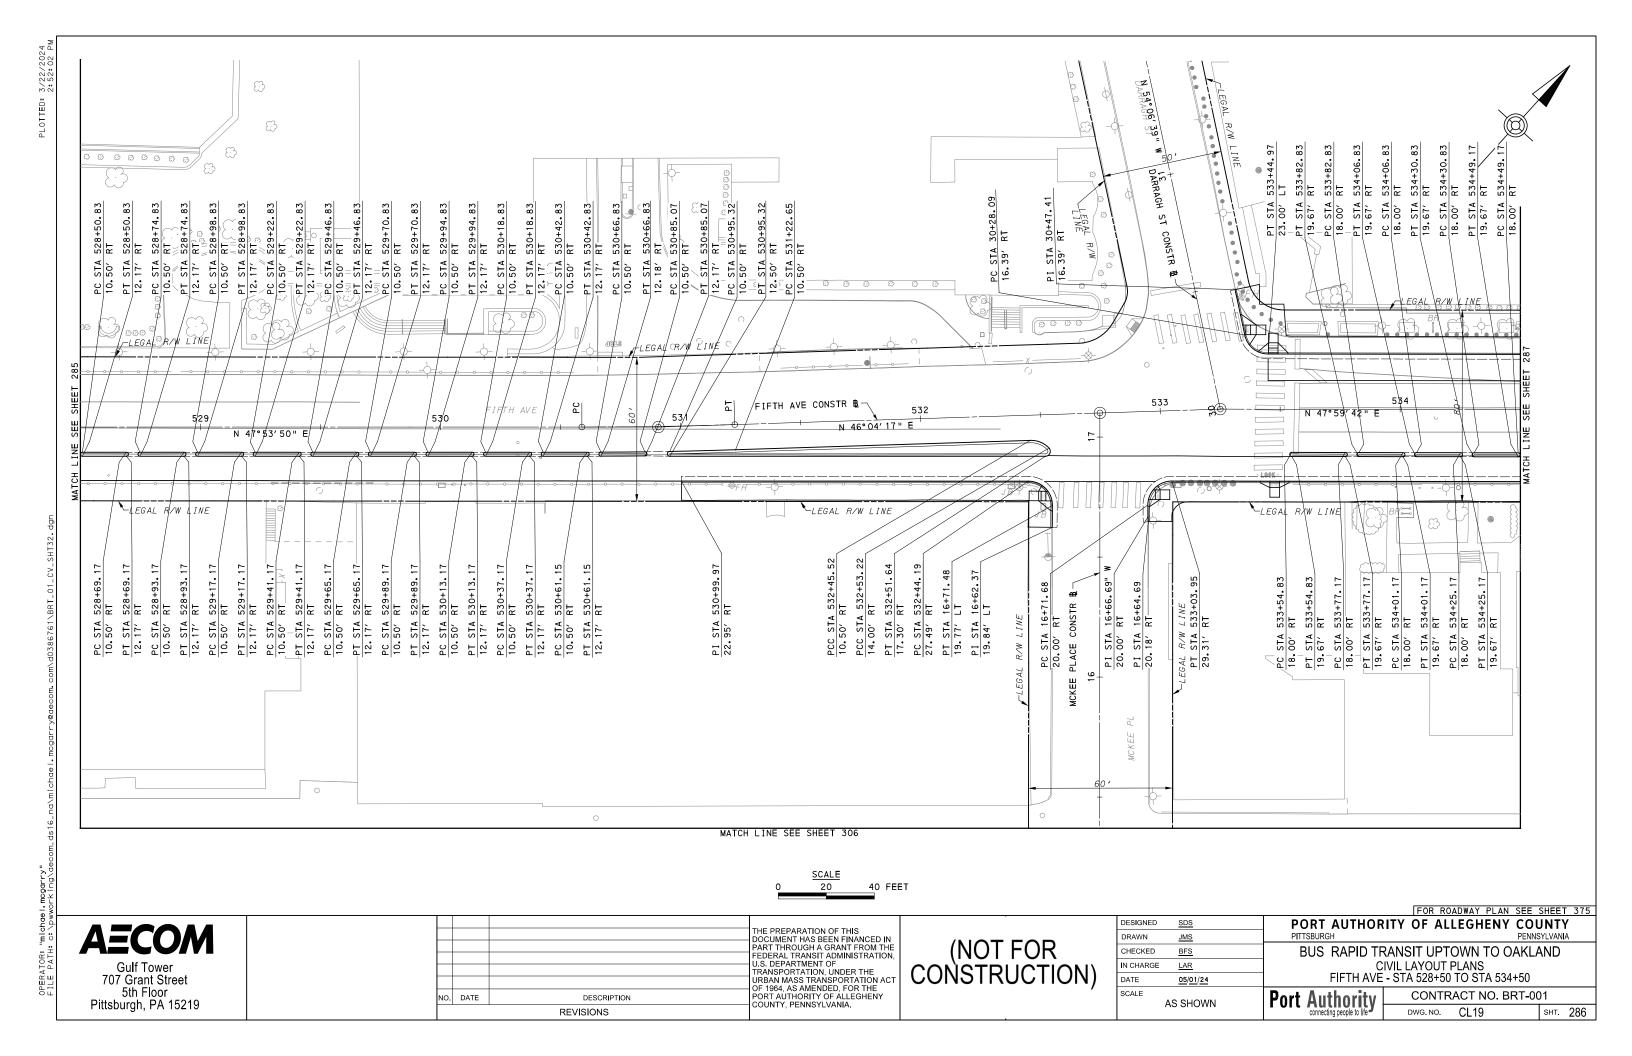

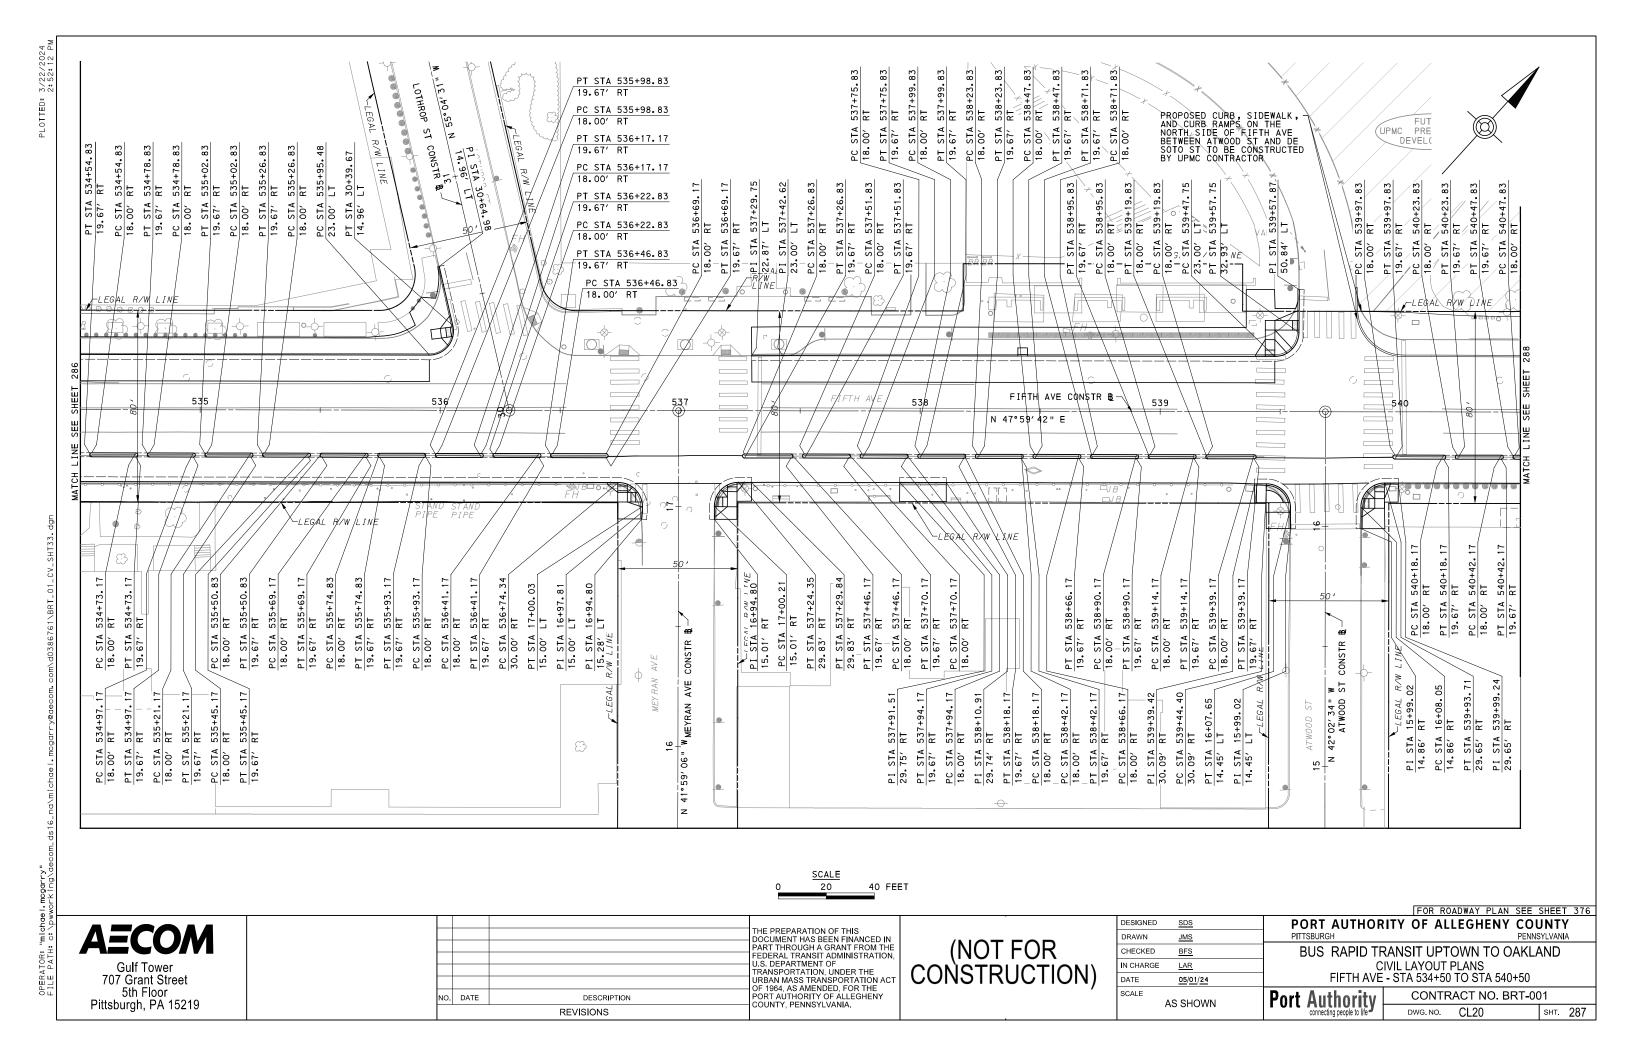

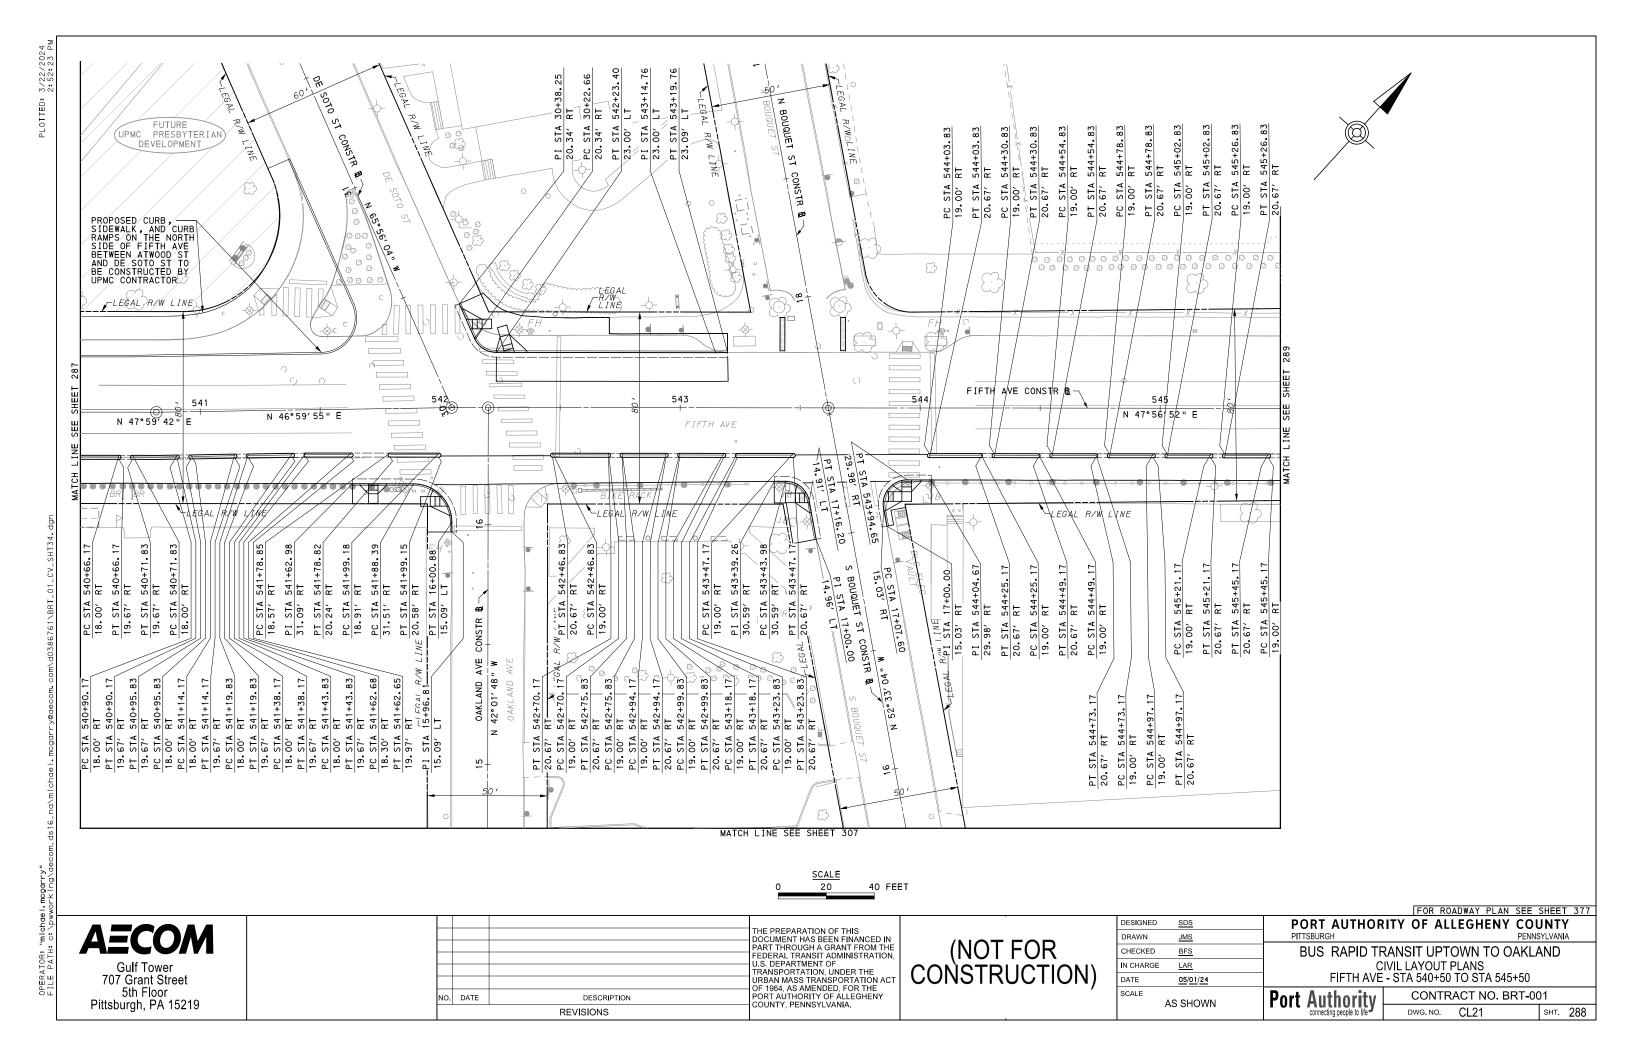

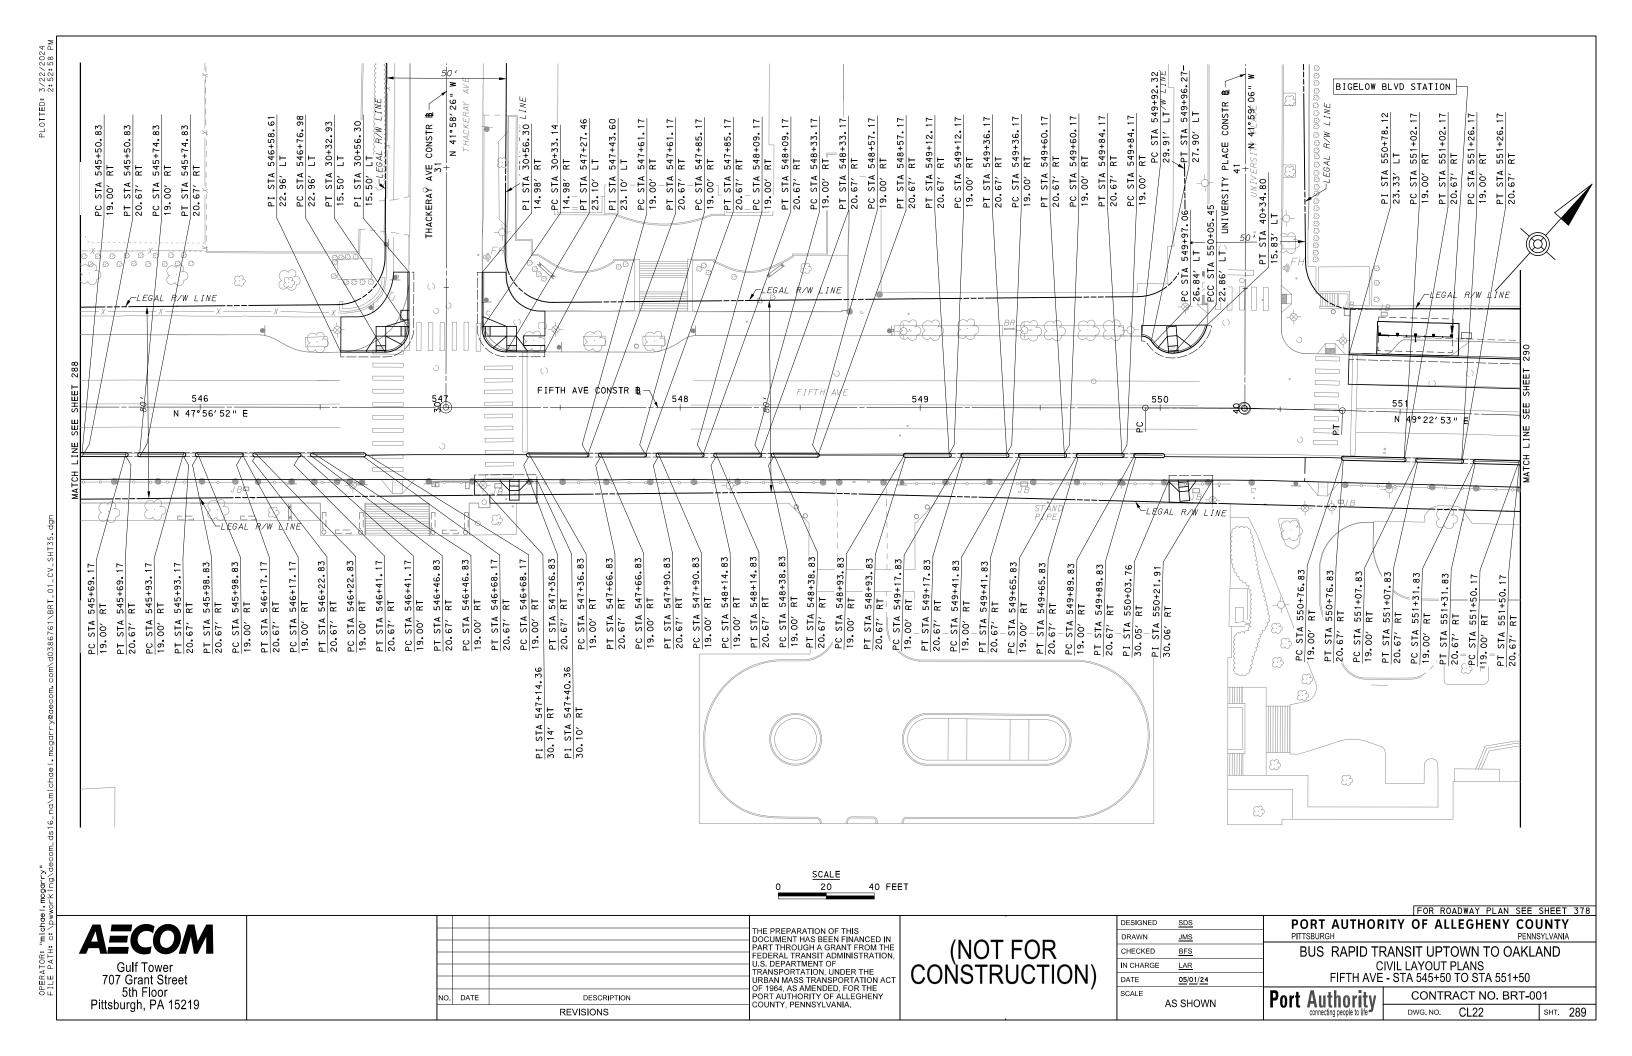

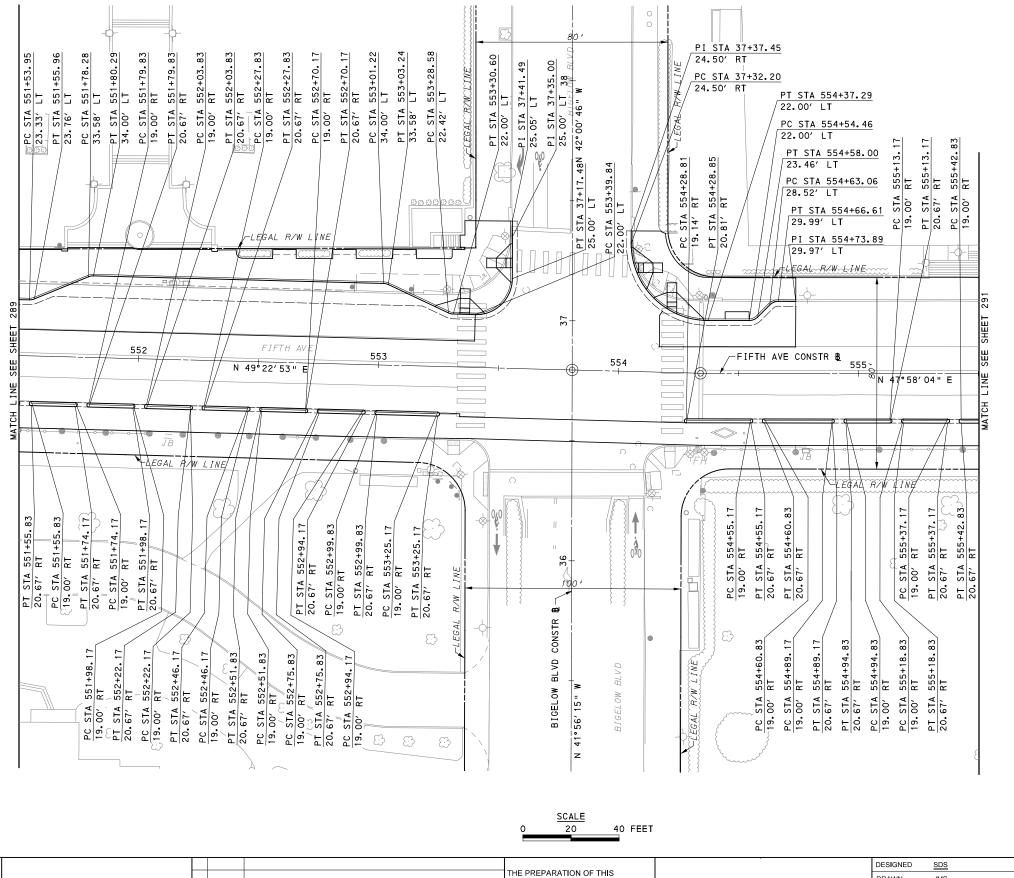

FOR ROADWAY PLAN SEE SHEET 379

**AECOM** 

Gulf Tower 707 Grant Street 5th Floor Pittsburgh, PA 15219 THE PREPARATION OF THIS
DOCUMENT HAS BEEN FINANCED IN
PART THROUGH A GRANT FROM THE
FEDERAL TRANSIT ADMINISTRATION,
U.S. DEPARTMENT OF
TRANSPORTATION, UNDER THE
URBAN MASS TRANSPORTATION ACT
OF 1964, AS AMENDED, FOR THE
NO. DATE
DESCRIPTION
REVISIONS

THE PREPARATION OF THIS
PART THE PORTAL TRANSPORTATION ACT
OF 1964, AS AMENDED, FOR THE
PORT AUTHORITY OF ALLEGHENY
COUNTY, PENNSYLVANIA.

(NOT FOR CONSTRUCTION)


DESIGNED	SDS	
DRAWN	<u>JMS</u>	
CHECKED	<u>BFS</u>	
N CHARGE	LAR	
DATE	05/01/24	
SCALE		I
	AS SHOWN	


PORT AUTHORITY OF ALLEGHENY COUNTY
PITTSBURGH


BUS RAPID TRANSIT UPTOWN TO OAKLAND
CIVIL LAYOUT PLANS
FIFTH AVE - STA 551+50 TO STA 555+50

Port Authority CONTRACT NO. BRT-001

DWG. NO. CL23 SHT. 290

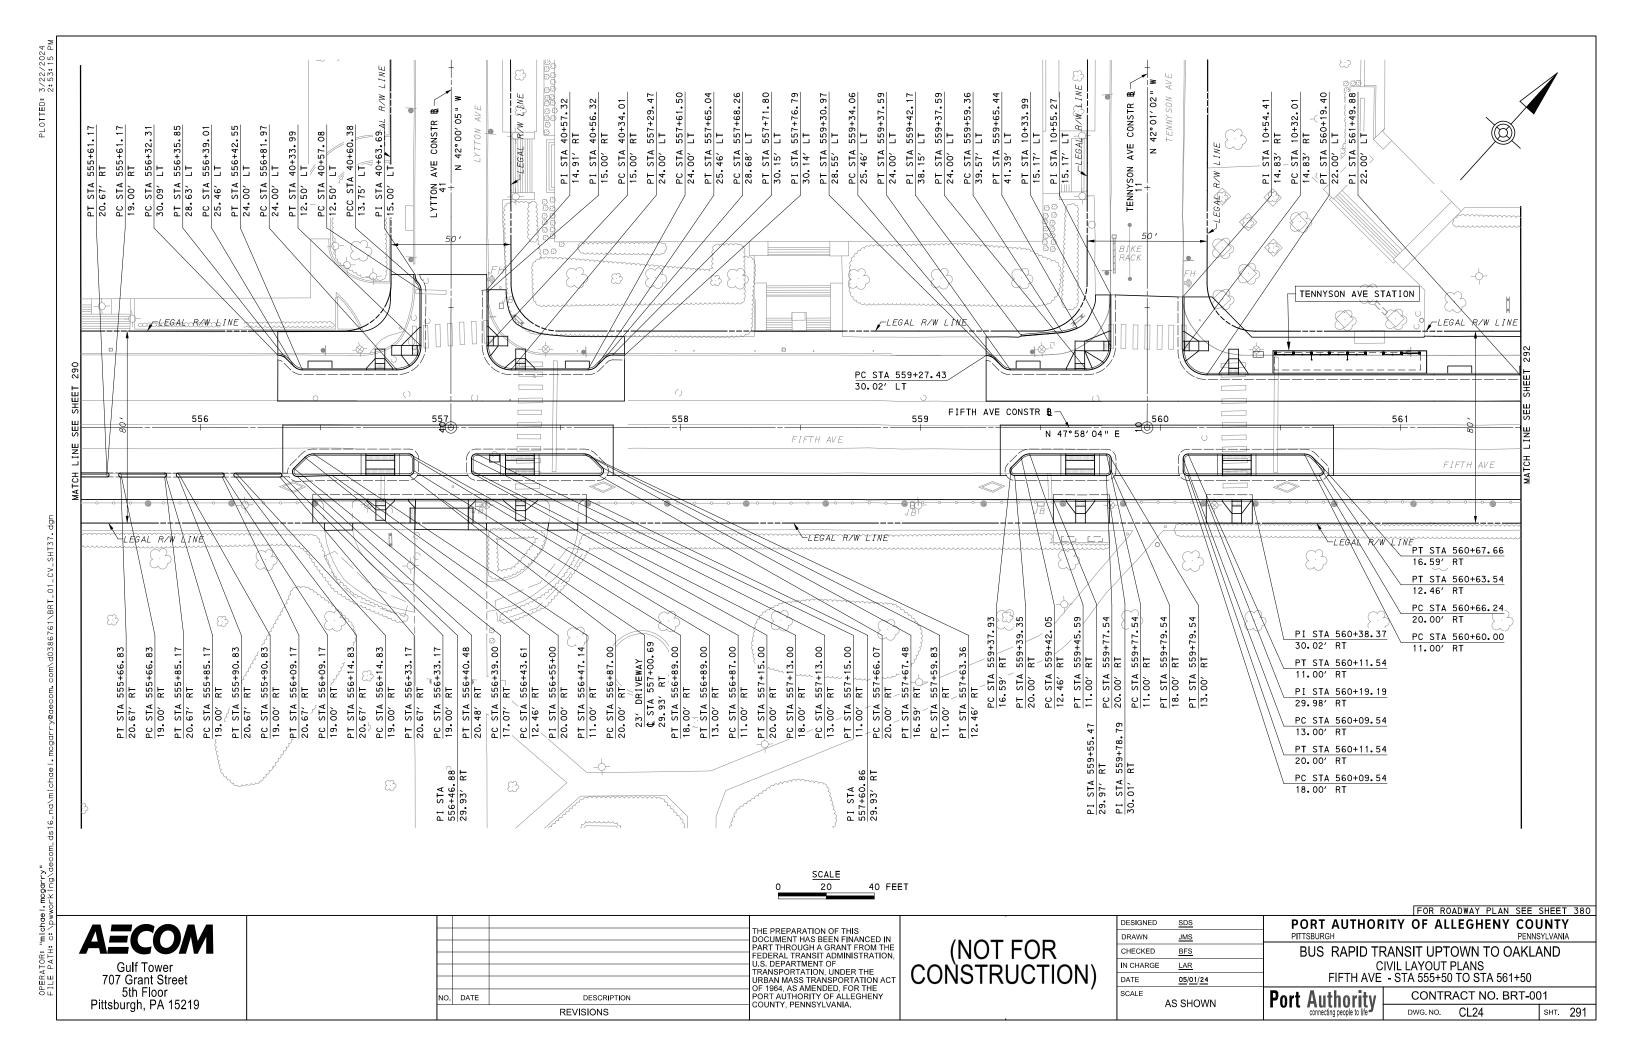

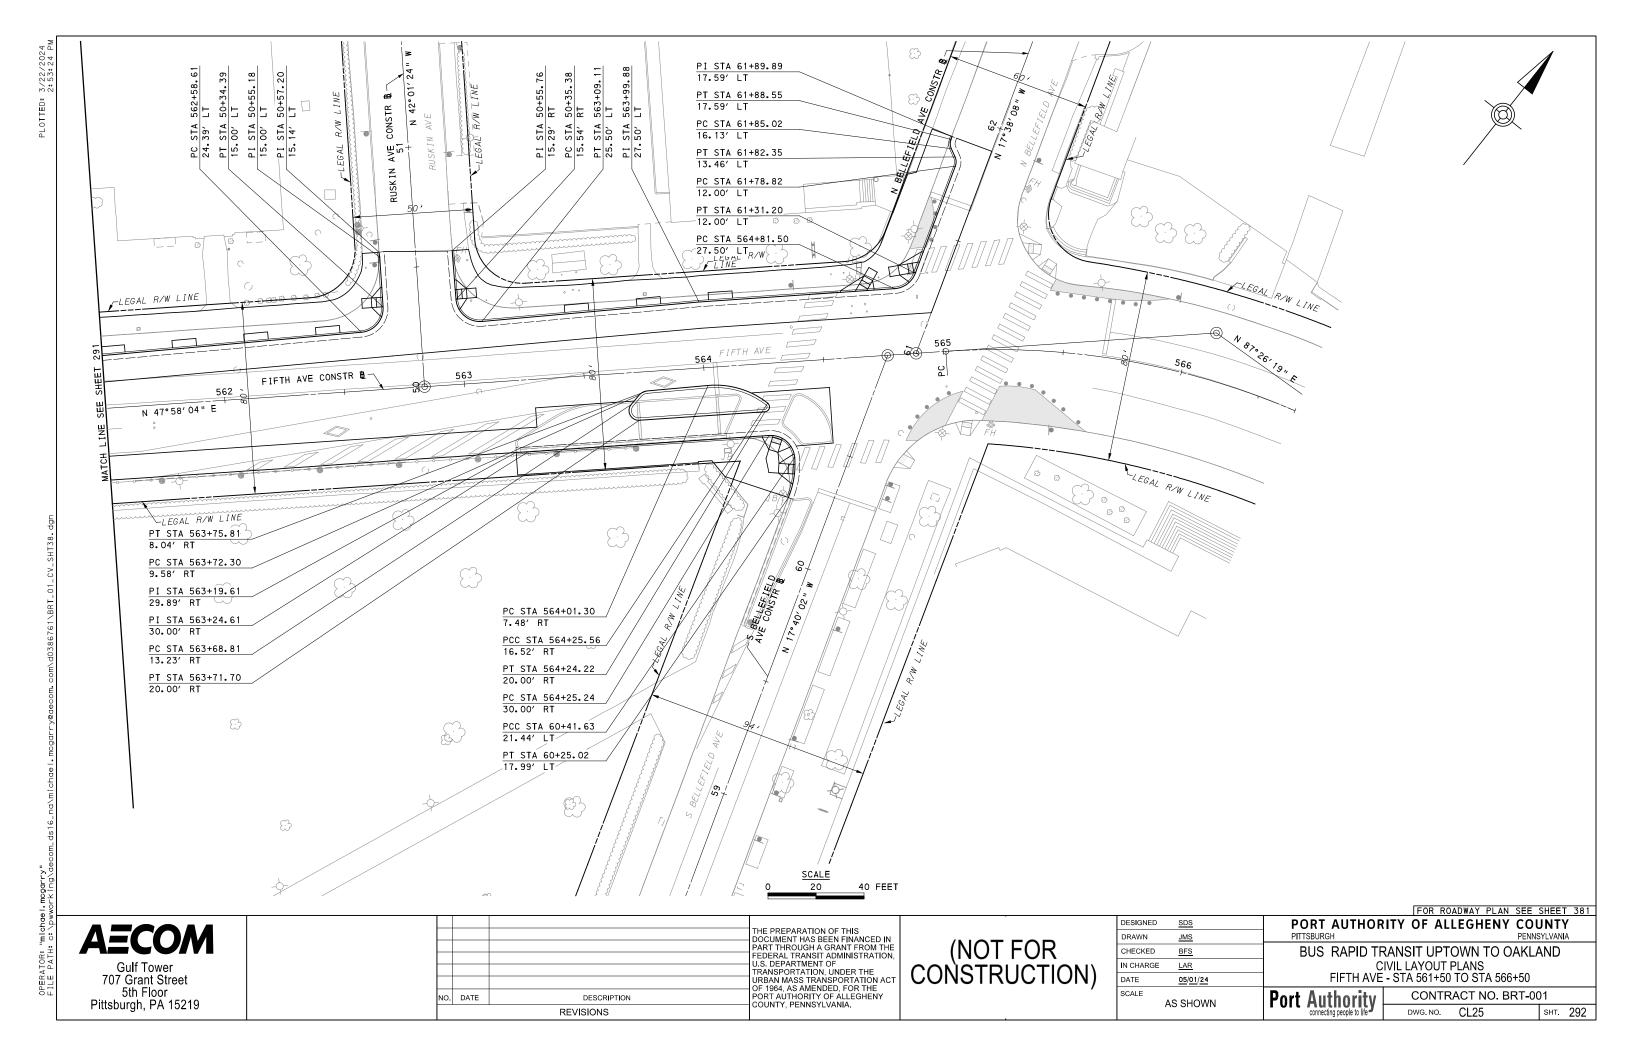

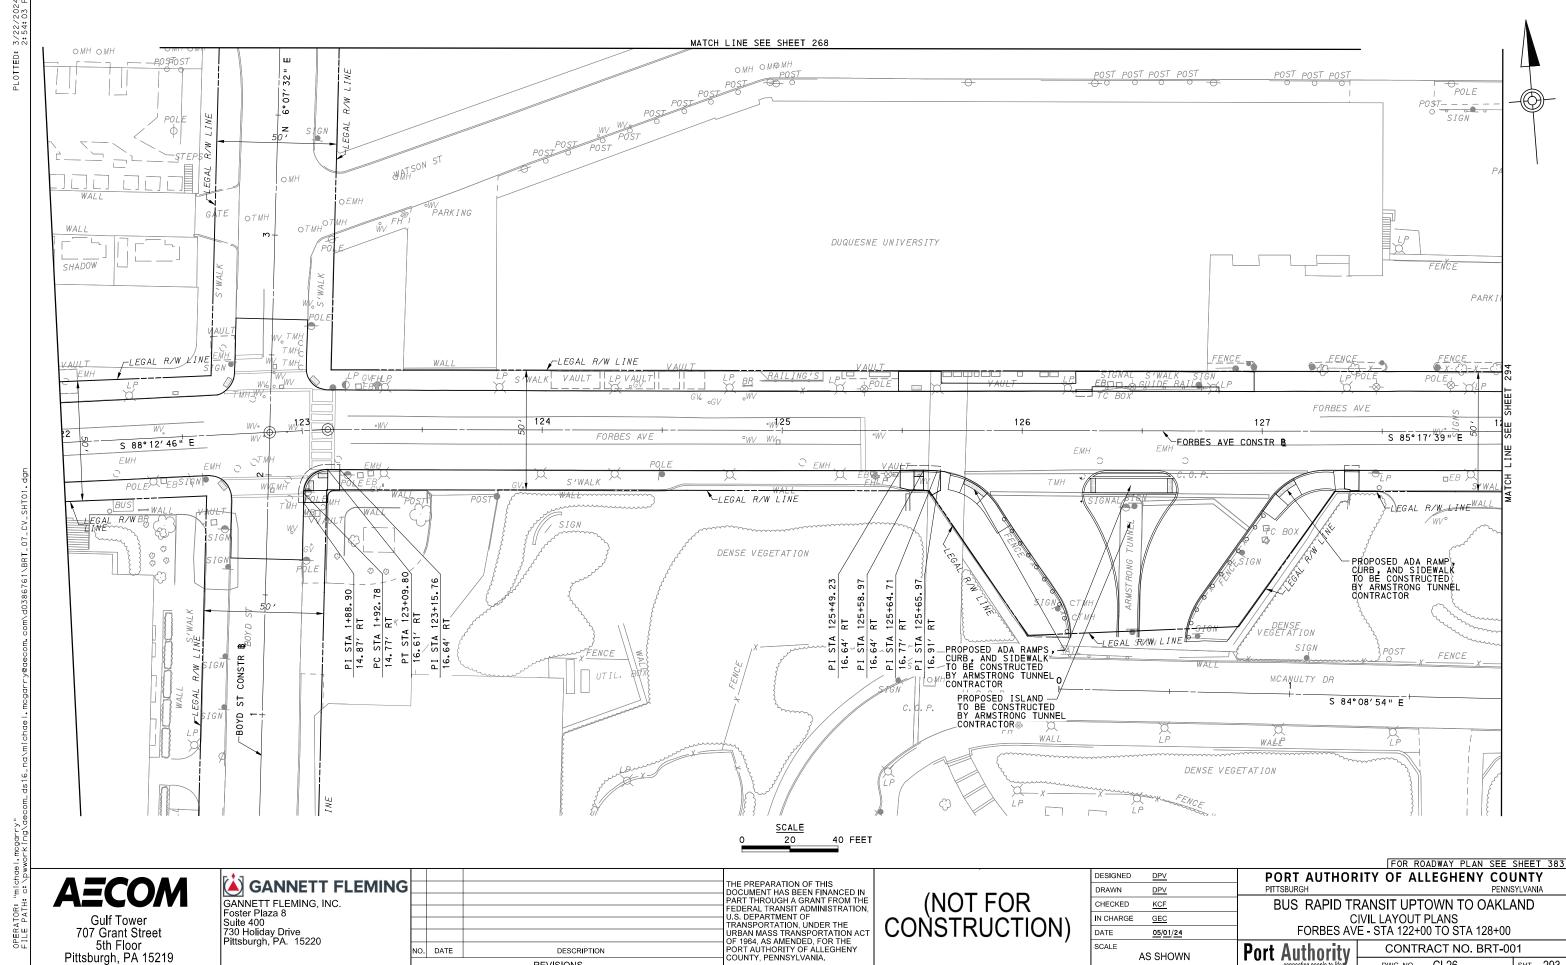

DATE

SCALE

05/01/24

AS SHOWN

**Port Authority** 

CONTRACT NO. BRT-001

sнт. 293

CL26

DWG. NO.

707 Grant Street

5th Floor

Pittsburgh, PA 15219

NO. DATE

DESCRIPTION

TMP


Foster Plaza 8 Suite 400

730 Holiday Drive Pittsburgh, PA. 15220

NO. DATE

DESCRIPTION

REVISIONS

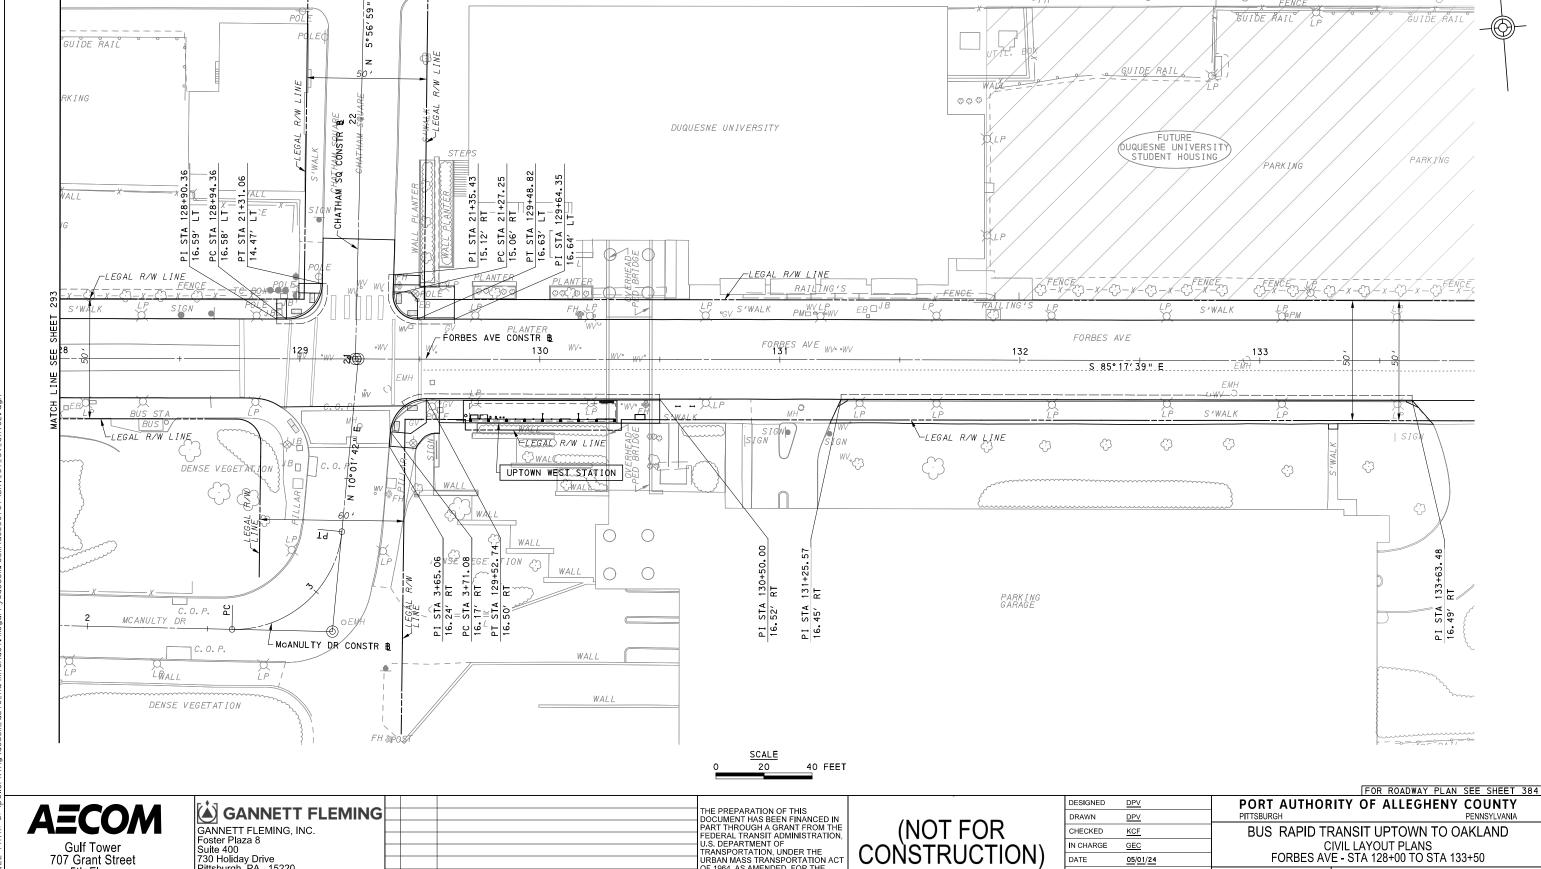

PEDERAL TRANSIT ADMINISTRATION,
U.S. DEPARTMENT OF
TRANSPORTATION, UNDER THE
URBAN MASS TRANSPORTATION ACT
OF 1964, AS AMENDED, FOR THE
PORT AUTHORITY OF ALLEGHENY
COUNTY, PENNSYLVANIA.

CIVIL LAYOUT PLANS

FORBES AVE - STA 128+00 TO STA 133+50

DWG. NO.

**Port Authority** 

CONTRACT NO. BRT-001

sнт. 294

CL27

N CHARGE

DATE

SCALE

GEC

05/01/24

AS SHOWN


MATCH LINE SEE SHEET 269

**Gulf Tower** 

707 Grant Street

5th Floor

Pittsburgh, PA 15219

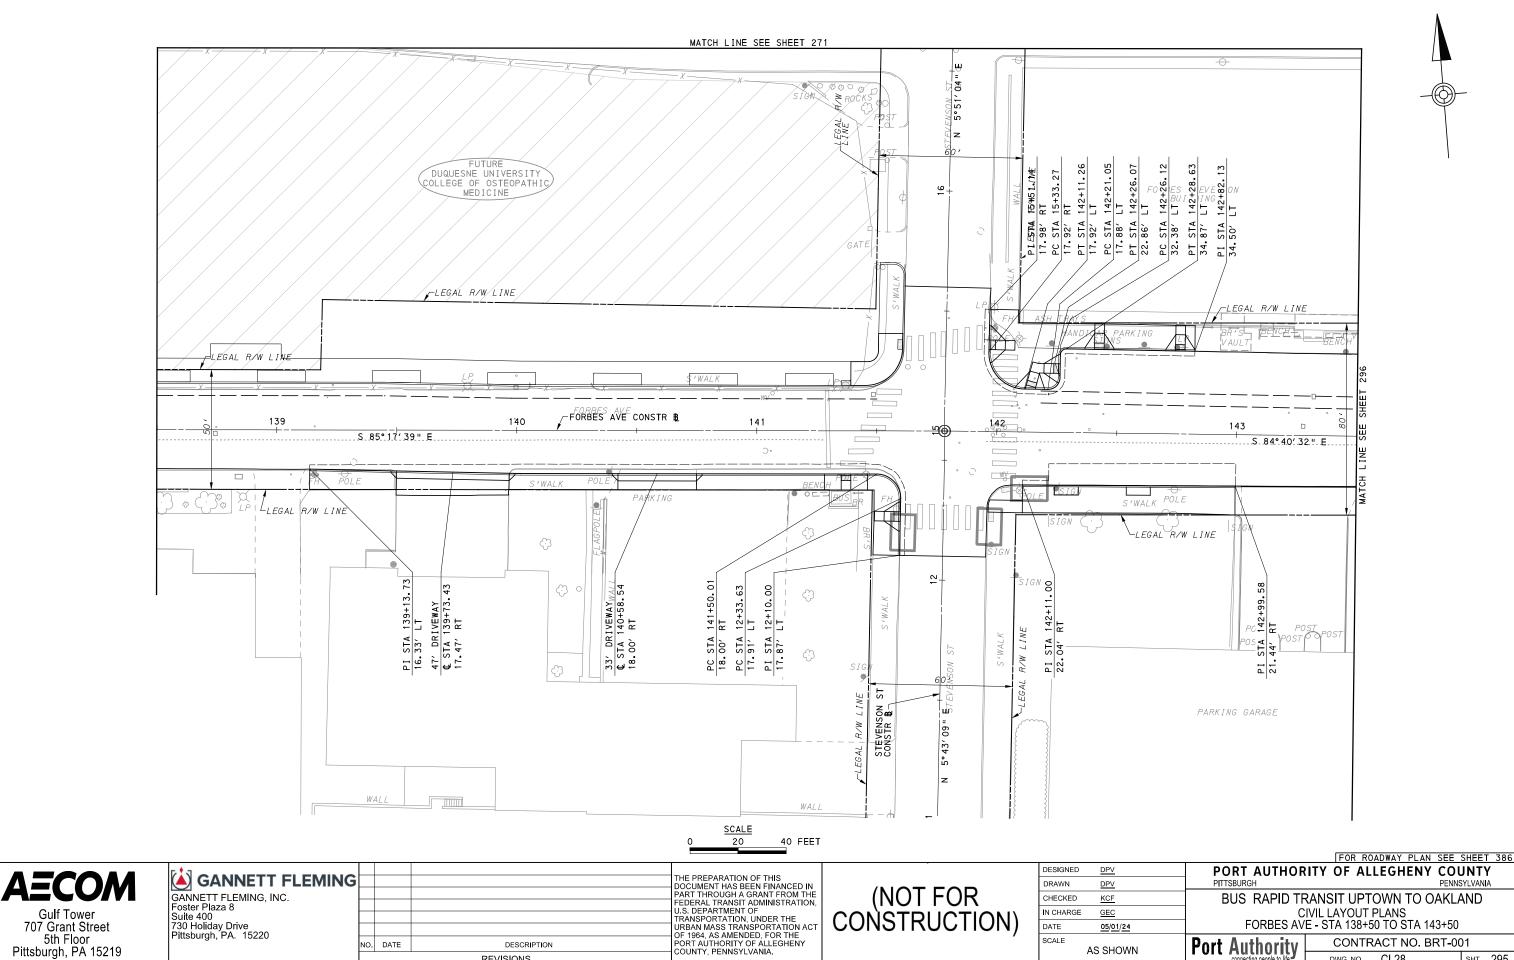

SCALE

AS SHOWN

CONTRACT NO. BRT-001

sнт. 295

CL28


DWG. NO.

**Port Authority** 

5th Floor Pittsburgh, PA 15219

NO. DATE

DESCRIPTION

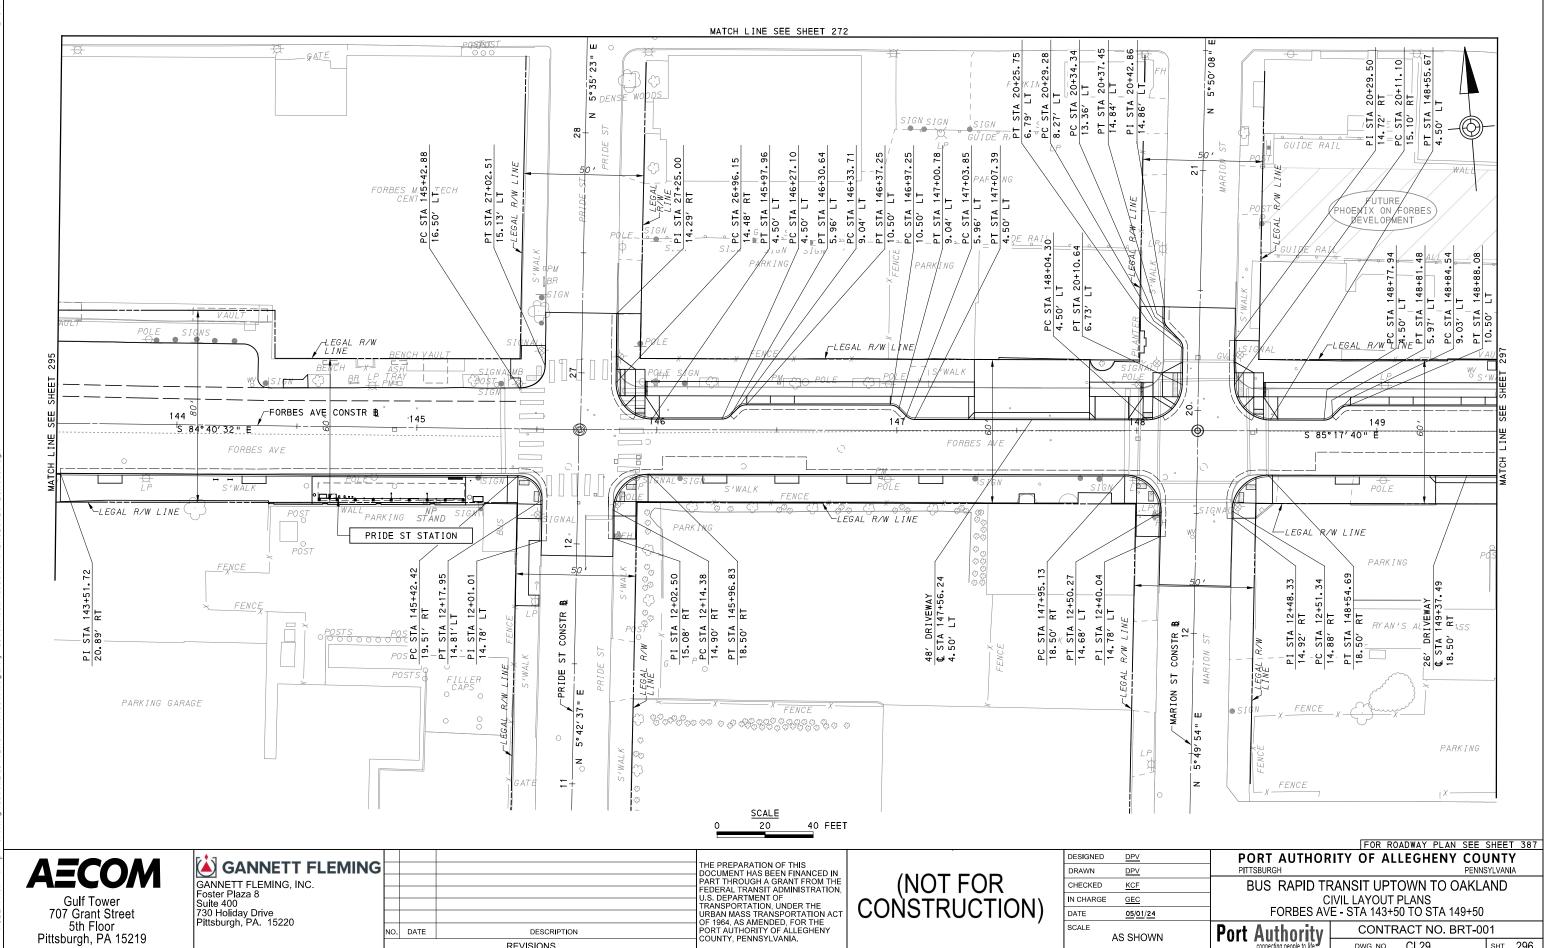

SCALE

AS SHOWN

CONTRACT NO. BRT-001

sнт. 296


CL29

DWG. NO.

**Port Authority** 

NO. DATE

DESCRIPTION

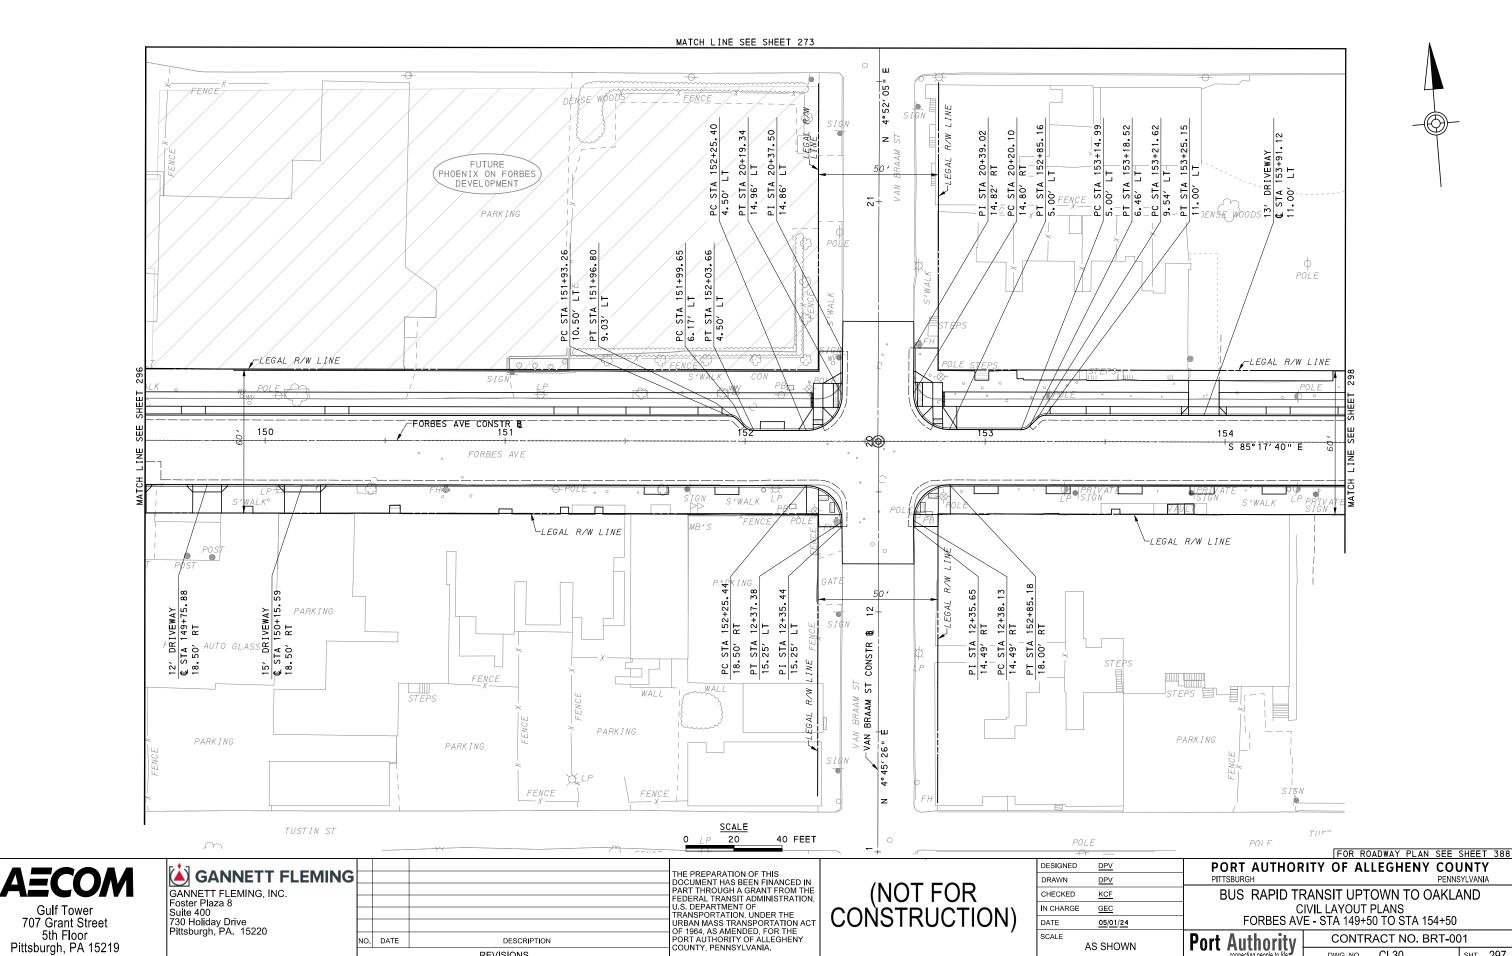

SCALE

AS SHOWN

CONTRACT NO. BRT-001

sнт. 297

CL30

DWG. NO.

**Port Authority** 

5th Floor Pittsburgh, PA 15219

NO. DATE

DESCRIPTION

MATCH LINE SEE SHEET 274

AECOM

**Gulf Tower** 707 Grant Street 5th Floor Pittsburgh, PA 15219 Foster Plaza 8 Suite 400 730 Holiday Drive Pittsburgh, PA. 15220

THE PREPARATION OF THIS
DOCUMENT HAS BEEN FINANCED IN
PART THROUGH A GRANT FROM THE
FEDERAL TRANSIT ADMINISTRATION, PEDERAL TRANSIT ADMINISTRATION,
U.S. DEPARTMENT OF
TRANSPORTATION, UNDER THE
URBAN MASS TRANSPORTATION ACT
OF 1964, AS AMENDED, FOR THE
PORT AUTHORITY OF ALLEGHENY
COUNTY, PENNSYLVANIA. NO. DATE DESCRIPTION REVISIONS

(NOT FOR CONSTRUCTION)

DESIGNED	DPV	
DRAWN	DPV	
CHECKED	KCF	
IN CHARGE	GEC	
DATE	05/01/24	
SCALE		
	AS SHOWN	

FOR ROADWAY PLAN SEE SHEET 389 PORT AUTHORITY OF ALLEGHENY COUNTY PENNSYLVANIA

BUS RAPID TRANSIT UPTOWN TO OAKLAND CIVIL LAYOUT PLANS FORBES AVE - STA 154+50 TO STA 159+50

Port Authority CONTRACT NO. BRT-001 DWG. NO.


CL31 sнт. 298 SHADOV




NO. DATE

DESCRIPTION

REVISIONS

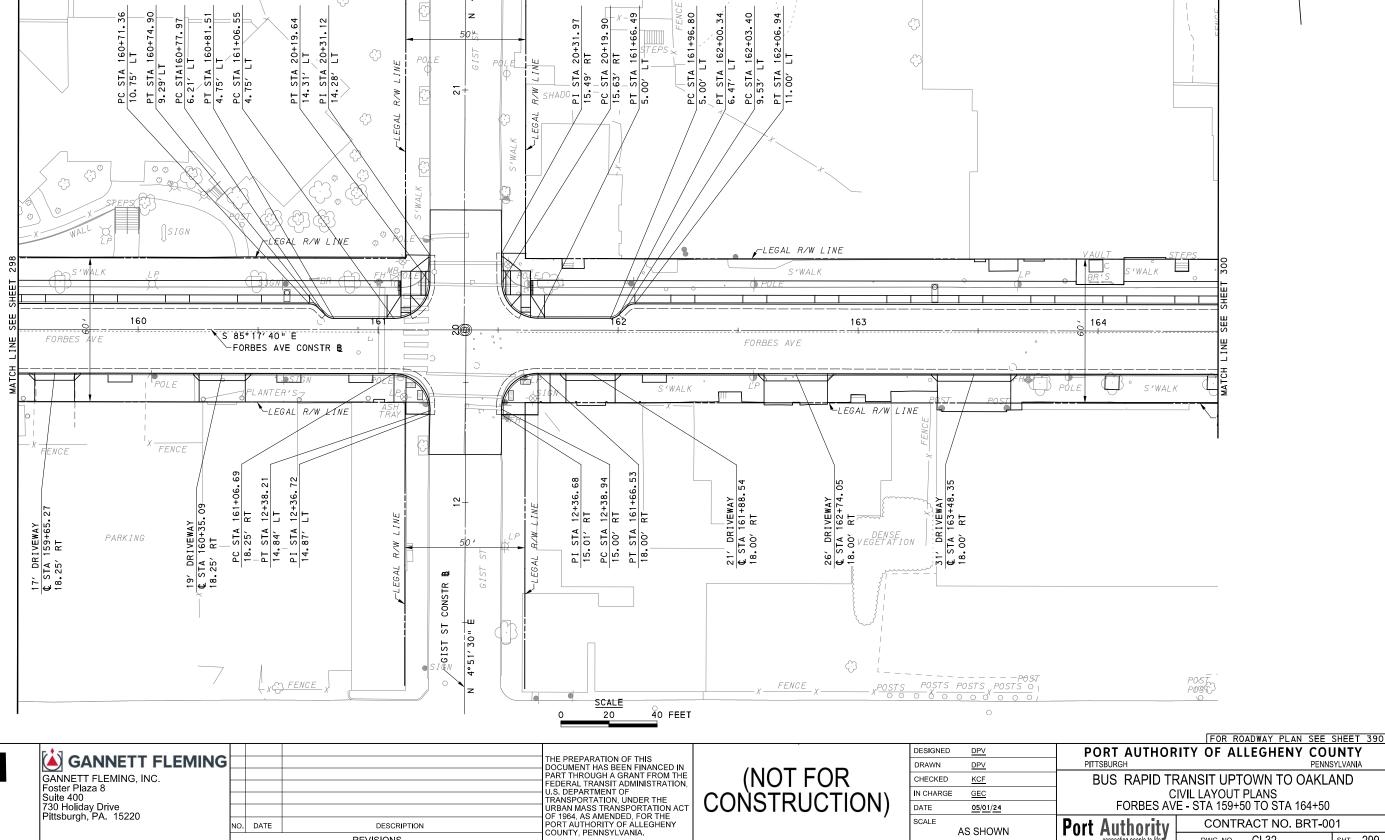

MATCH LINE SEE SHEET 275

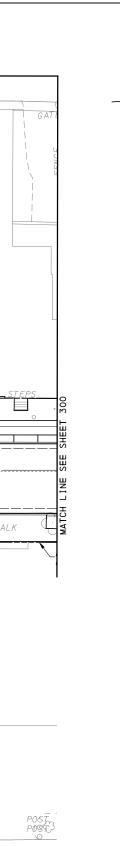

CONTRACT NO. BRT-001

sнт. 299

CL32

DWG. NO.

N CHARGE

DATE

SCALE


GEC

05/01/24

AS SHOWN

**Port Authority** 



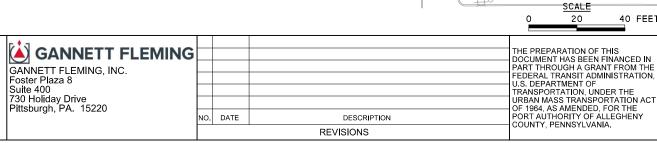

(NOT FOR CONSTRUCTION)

PT STA 166+89,000

PC STA 166+92.08 9.79' LT

DENSE VEGETATIO

PC STA 166+85.47 5.25' LT

DESIGNED	DPV	
DRAWN	DPV	
CHECKED	KCF	
IN CHARGE	<u>GEC</u>	
DATE	05/01/24	
SCALE		ı
	AS SHOWN	

FOR ROADWAY PLAN SEE SHEET 391 PORT AUTHORITY OF ALLEGHENY COUNTY PENNSYLVANIA BUS RAPID TRANSIT UPTOWN TO OAKLAND CIVIL LAYOUT PLANS FORBES AVE - STA 164+50 TO STA 169+50

DWG. NO.

sнт. 300

Port Authority
connecting people to life CONTRACT NO. BRT-001 CL33

\_LEGAL R/W LINE FORBES AVE CONSTR 1 165 167 168 S 85°17′40" E FORBES AVE FORBES AVE CONSTR & EGAL R/W LEGAL R/W LINE Ŕ JUMONVILLE ST STATION ENCE PI STA 12+03.96 14.77' LT PT STA 12+05.65 14.78' LT PC STA 12+05.9 PT STA 7 SHADOW FENĈE FENCE 8 PARKING

40 FEET

MATCH LINE SEE SHEET 276

PT STA 20+48.75 8.34′, RT

PC STA 20+52.29 9.81′ RT

PT STA 166+55.67 5.25′ LT

PC STA 20+20.27

4° 42′ 57 "

WALL

PC STA 165+68.74 6.46' LT

PT STA 165+72.28 5.00′ LT

-LÈGAL AXW LINE

PT STA 20+19.96 15.14' LT


PI STA 20+40.37 15.09' LT

PT STA 165+65.66 9.54' LT

© STA 165+15.31 11.00′ LT PC STA 165+62.13 71.00′ LT 11.00′ LT 11.00′ LT

FENCE O O POST FENCE

■ WALL

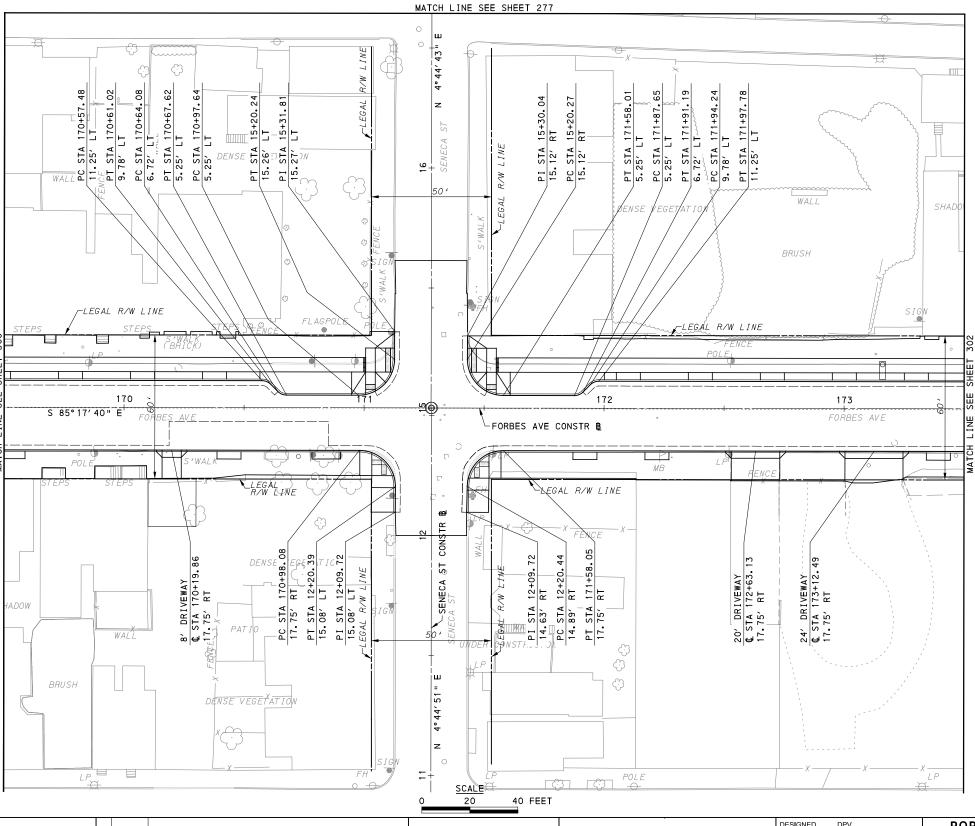

FOR ROADWAY PLAN SEE SHEET 392

**AECOM** 

Gulf Tower 707 Grant Street 5th Floor Pittsburgh, PA 15219 GANNETT FLEMING
GANNETT FLEMING, INC.
Foster Plaza 8
Suite 400
730 Holiday Drive
Pittsburgh, PA. 15220

THE PREPARATION OF THIS
DOCUMENT HAS BEEN FINANCED IN
PART THROUGH A GRANT FROM THE
FEDERAL TRANSIT ADMINISTRATION,
U.S. DEPARTMENT OF
TRANSPORTATION, UNDER THE
URBAN MASS TRANSPORTATION ACT
OF 1964, AS AMENDED, FOR THE
PORT AUTHORITY OF ALLEGHENY
COUNTY, PENNSYLVANIA.

REVISIONS

(NOT FOR CONSTRUCTION)


DESIGNED	DPV	
DRAWN	<u>DPV</u>	
CHECKED	KCF	
IN CHARGE	GEC	
DATE	05/01/24	
SCALE		
	AS SHOWN	

PORT AUTHORITY OF ALLEGHENY COUNTY
PITTSBURGH
PENNSYLVANIA

BUS RAPID TRANSIT UPTOWN TO OAKLAND CIVIL LAYOUT PLANS FORBES AVE - STA 169+50 TO STA 173+50

Port Authority CONTRACT NO. BRT-001

DWG. NO. CL34 SHT. 301

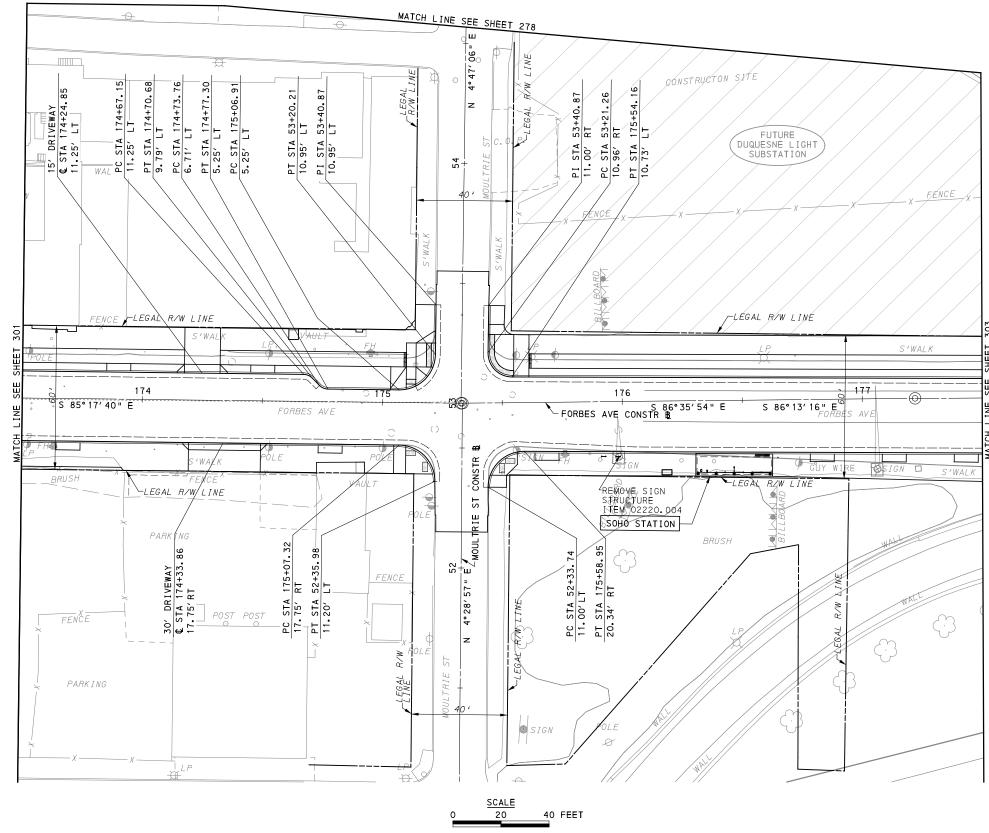

**AECOM** 

Gulf Tower 707 Grant Street 5th Floor Pittsburgh, PA 15219 GANNETT FLEMING
GANNETT FLEMING, INC.
Foster Plaza 8
Suite 400
730 Holiday Drive
Pittsburgh, PA. 15220

THE PREPARATION OF THIS
DOCUMENT HAS BEEN FINANCED IN
PART THROUGH A GRANT FROM THE
FEDERAL TRANSIT ADMINISTRATION,
U.S. DEPARTMENT OF
TRANSPORTATION, UNDER THE
URBAN MASS TRANSPORTATION ACT
OF 1964, AS AMENDED, FOR THE
PORT AUTHORITY OF ALLEGHENY
COUNTY, PENNSYLVANIA.

(NOT FOR CONSTRUCTION)

DESIGNED	DPV	
DRAWN	DPV	L
CHECKED	KCF	
IN CHARGE	<u>GEC</u>	
DATE	05/01/24	
SCALE		Ī
	AS SHOWN	

PORT AUTHORITY OF ALLEGHENY COUNTY
PITTSBURGH
PLIS DADID TRANSIT LIDTOWN TO OAKLAND


BUS RAPID TRANSIT UPTOWN TO OAKLAND CIVIL LAYOUT PLANS FORBES AVE - STA 173+50 TO STA 177+50

Port Authority CONTRACT NO. BRT-001
DWG. NO. CL35 SHT. 302







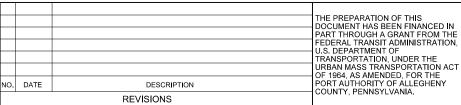

(NOT FOR CONSTRUCTION)

DESIGNED	<u>DPV</u>	
DRAWN	<u>DPV</u>	
CHECKED	KCF	
IN CHARGE	<u>GEC</u>	
DATE	05/01/24	
SCALE		
	AS SHOWN	


### FOR ROADWAY PLAN SEE SHEET 394 PORT AUTHORITY OF ALLEGHENY COUNTY BUS RAPID TRANSIT UPTOWN TO OAKLAND CIVIL LAYOUT PLANS FORBES AVE - STA 177+50 TO STA 182+50

sнт. 303

Port Authority connecting people to life CONTRACT NO. BRT-001 DWG. NO. CL36

MATCH LINE SEE SHEET 103 MATCH LINE SEE SHEET 103 FLEGAL R/W LINE DENSE VEGETATION POLE DUQUESNE LIGHT SUBSTATION AT ION DENSE VES BILLBOARD -SIGNAL S'WALK S 66°02′16" E PC STA 177+86.43 7.84' LT -LEGAL R/W LINE - LEARBES AVE CONSTR. B SIGN 5 86° 13′ 16" E FORBES AVE DENSE VEGETAT PL STA 178+30.97 PC STA 178+40.54 32.56' RT 32.56' RT 32.11' RT 32.11' RT 91 STA 178+63.87 PI STA 178+63.87 PI STA 178+63.87 PC STA 177+69.84
23.03' RT
PT STA 177+99.59
51.88' RT
PT STA 177+99.62 STA 178+85± SEGMENT 0010 OFFSET 0000 SR 2308 BEGINS WALL N 10°17'11" E 40 FEET



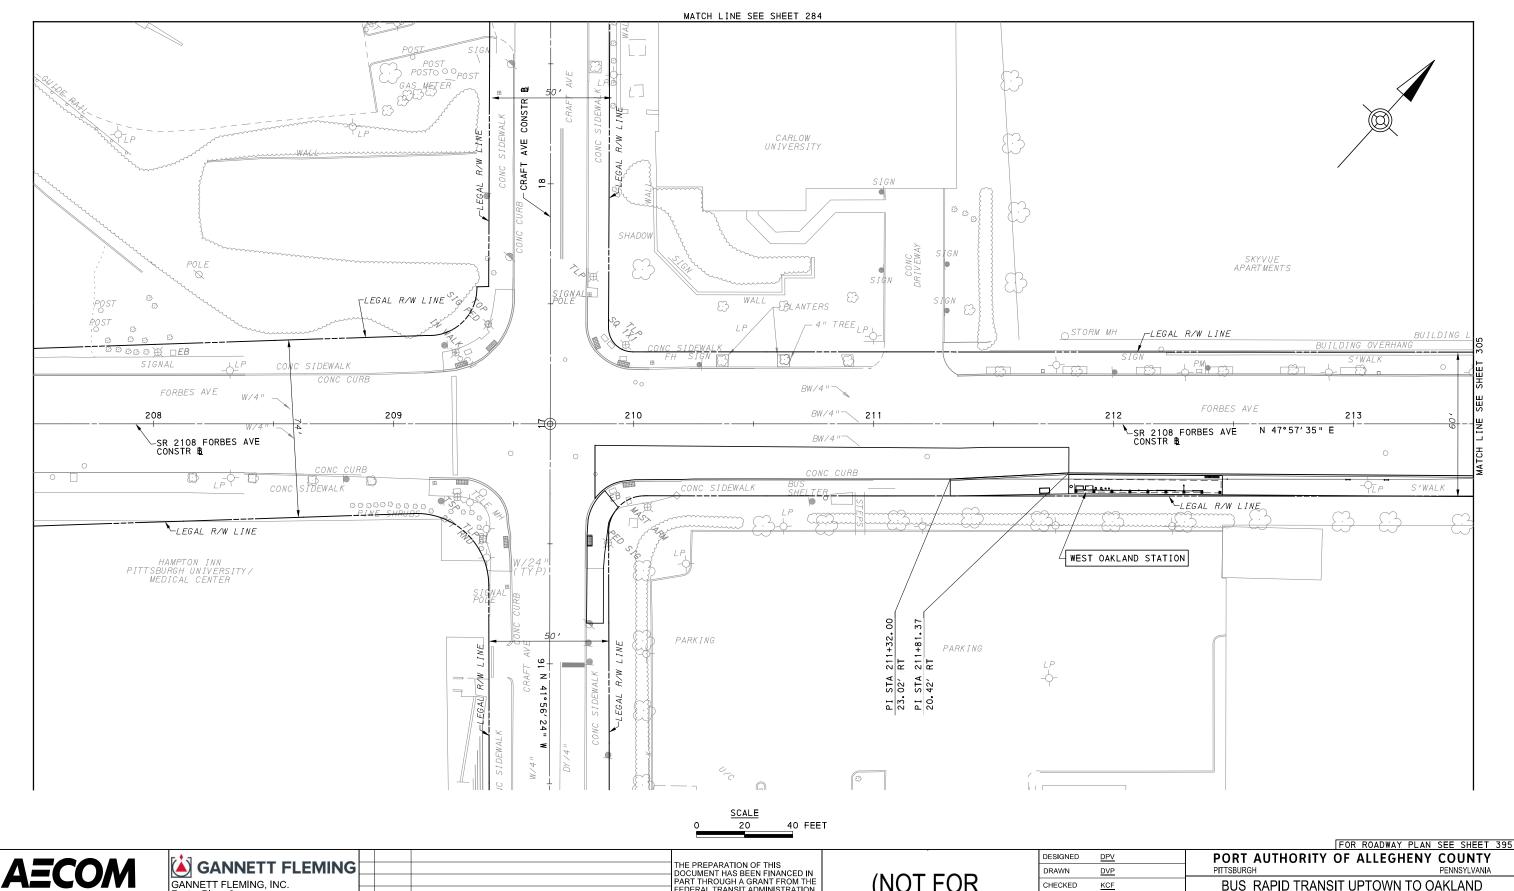

Gulf Tower 707 Grant Street 5th Floor Pittsburgh, PA 15219 GANNETT FLEMING, INC. Foster Plaza 8 Suite 400 730 Holiday Drive Pittsburgh, PA. 15220 THE PREPARATION OF THIS
DOCUMENT HAS BEEN FINANCED IN
PART THROUGH A GRANT FROM THE
FEDERAL TRANSIT ADMINISTRATION,
U.S. DEPARTMENT OF
TRANSPORTATION, UNDER THE
URBAN MASS TRANSPORTATION ACT
OF 1964, AS AMENDED, FOR THE
PORT AUTHORITY OF ALLEGHENY
COUNTY, PENNSYLVANIA.

(NOT FOR CONSTRUCTION)

 DESIGNED
 DPV

 DRAWN
 DVP

 CHECKED
 KCF

 IN CHARGE
 GEC

 DATE
 05/01/24

 SCALE
 AS SHOWN

PORT AUTHORITY OF ALLEGHENY COUNTY
PITTSBURGH


BUS RAPID TRANSIT UPTOWN TO OAKLAND
CIVIL LAYOUT PLANS
FORBES AVE - STA 207+50 TO STA 213+50

Port Authority

CONTRACT NO. BRT-001

DWG. NO. CL37

sнт. 304

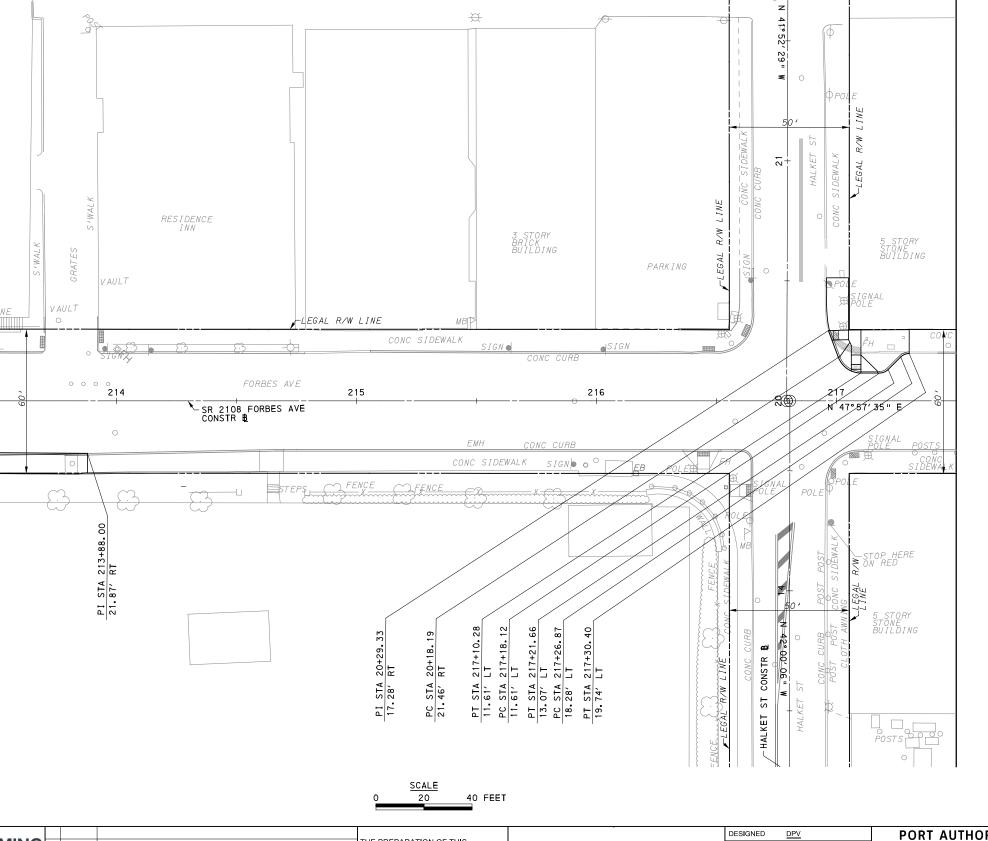

MATCH LINE SEE SHEET 285

PERATOR: "michael.mcgarry" ILE PATH: c:\pwworking\aecom\_ds16\_n \_\_\_\_\_

Gulf Tower 707 Grant Street 5th Floor Pittsburgh, PA 15219 GANNETT FLEMING
GANNETT FLEMING, INC.
Foster Plaza 8
Suite 400
730 Holiday Drive
Pittsburgh, PA. 15220

THE PREPARATION OF THIS
DOCUMENT HAS BEEN FINANCED IN
PART THROUGH A GRANT FROM THE
FEDERAL TRANSIT ADMINISTRATION,
U.S. DEPARTMENT OF
TRANSPORTATION, UNDER THE
URBAN MASS TRANSPORTATION ACT
OF 1984, AS AMENDED, FOR THE
PORT AUTHORITY OF ALLEGHENY
COUNTY, PENNSYLVANIA.

(NOT FOR CONSTRUCTION)

DESIGNED	DPV	
DRAWN	DVP	
CHECKED	KCF	
IN CHARGE	GEC	
DATE	05/01/24	
SCALE		
	AS SHOWN	


PORT AUTHORITY OF ALLEGHENY COUNTY
PITTSBURGH

BUS RAPID TRANSIT UPTOWN TO OAKLAND

BUS RAPID TRANSIT UPTOWN TO OAKLAND CIVIL LAYOUT PLANS FORBES AVE - STA 213+50 TO STA 217+50

Port Authority CONTRACT NO. BRT-001


DWG. NO. CL38 SHT. 305

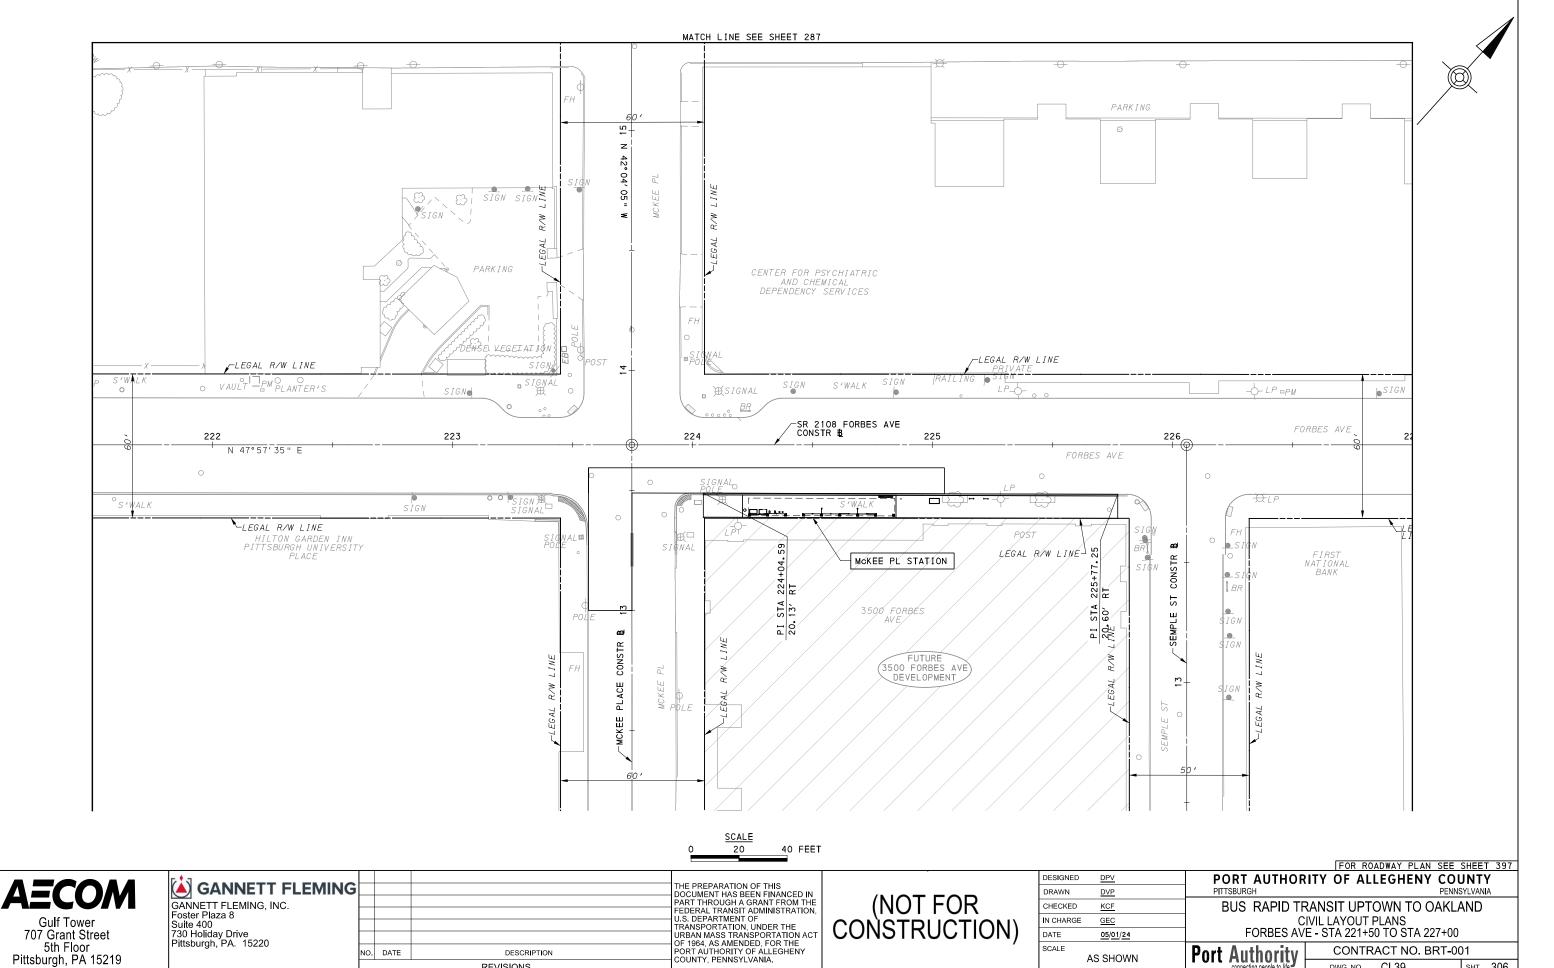

REVISIONS

DWG. NO. CL39

sнт. 306

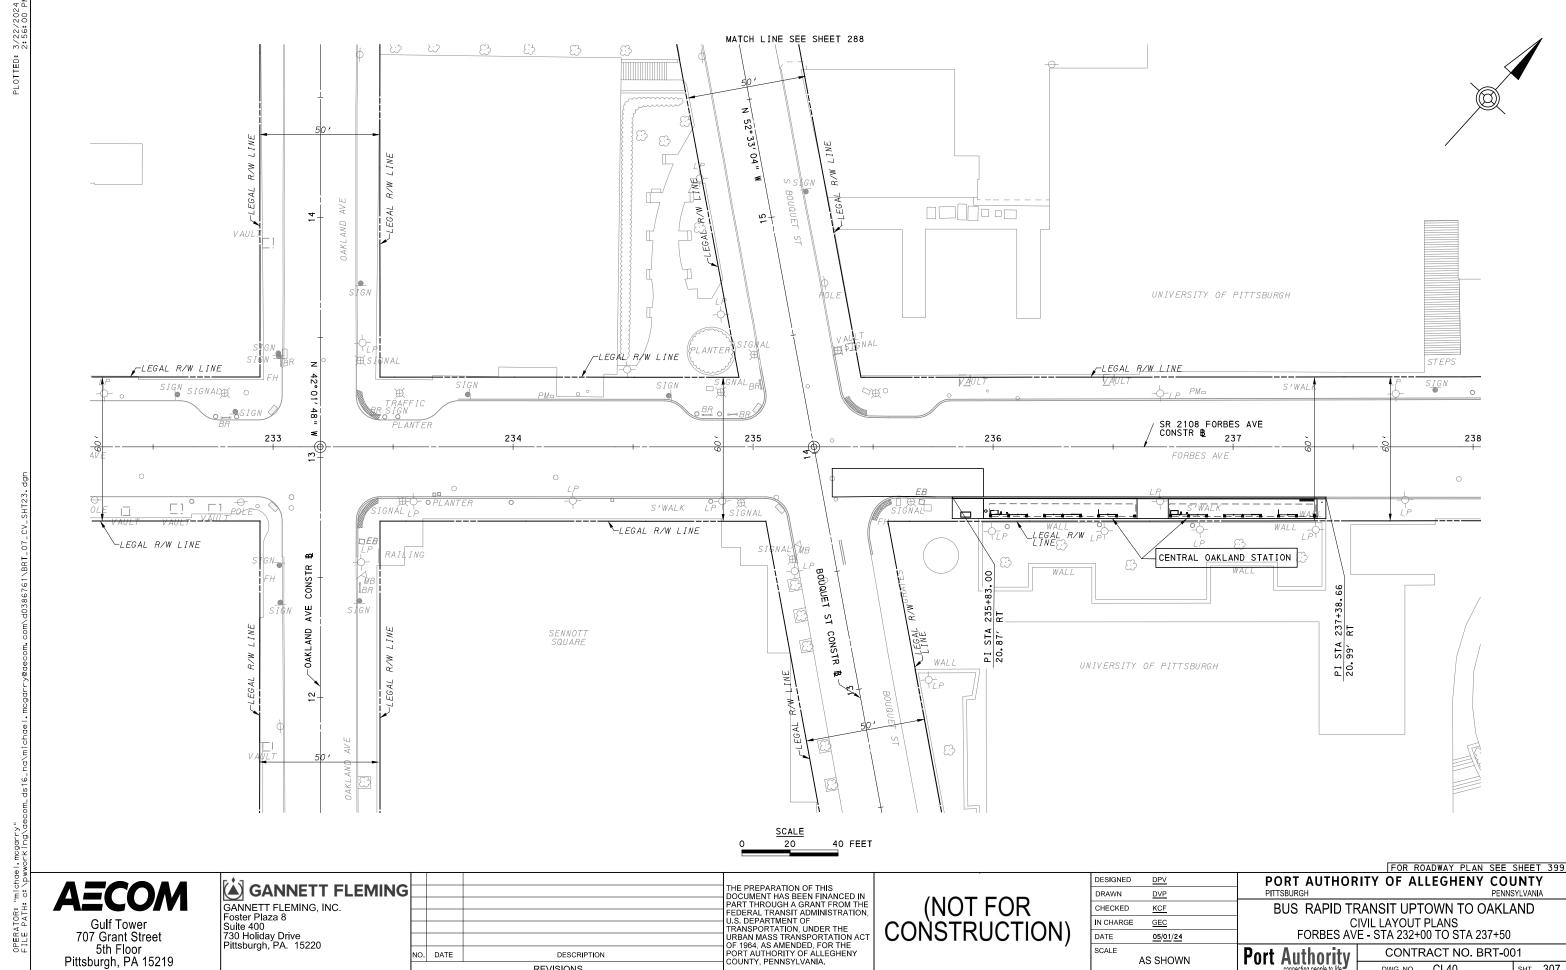

DATE

SCALE

<u>05/01/24</u>

AS SHOWN

**Port Authority** 

CONTRACT NO. BRT-001

sнт. 307


DWG. NO. CL40

707 Grant Street


5th Floor Pittsburgh, PA 15219

NO. DATE

DESCRIPTION

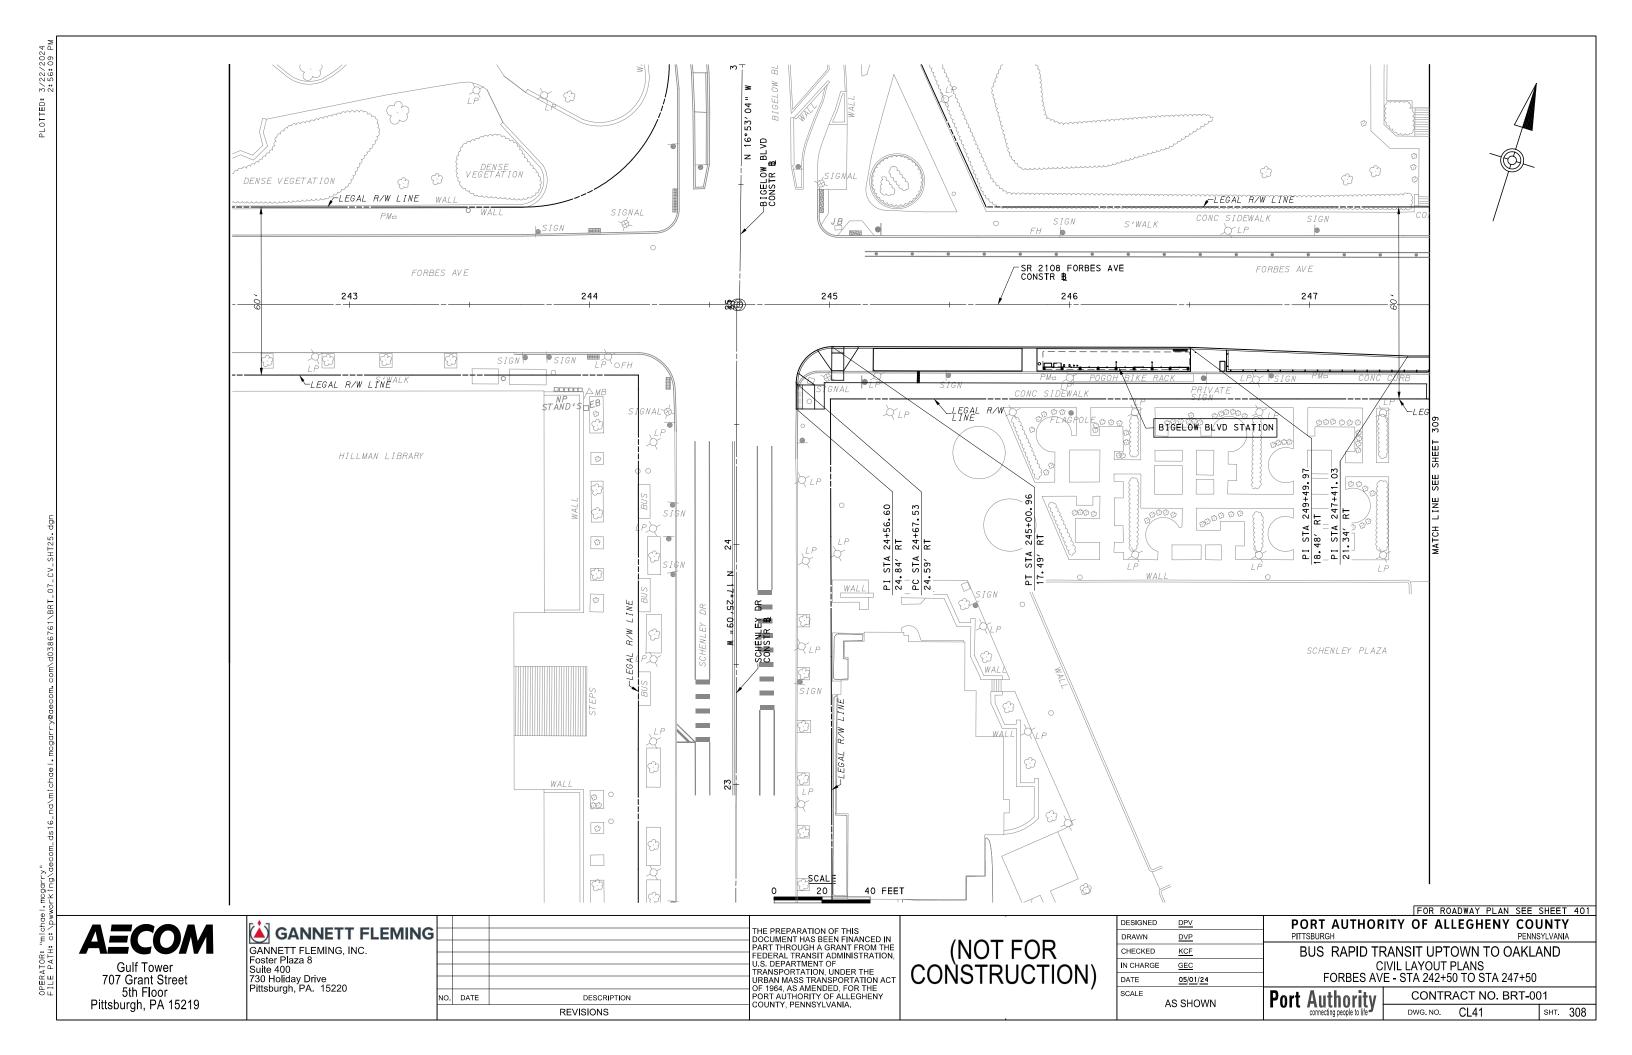



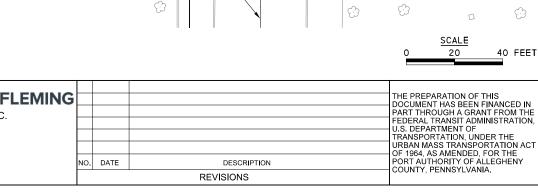


(NOT FOR CONSTRUCTION)

DESIGNED	DPV	
DRAWN	DVP	
CHECKED	KCF	
IN CHARGE	GEC	
DATE	05/01/24	
SCALE		
	AS SHOWN	

FOR ROADWAY PLAN SEE SHEET 402 PORT AUTHORITY OF ALLEGHENY COUNTY BUS RAPID TRANSIT UPTOWN TO OAKLAND

CIVIL LAYOUT PLANS FORBES AVE - STA 247+50 TO STA 251+50

Port Authority connecting people to life CONTRACT NO. BRT-001 DWG. NO. CL42 sнт. 309

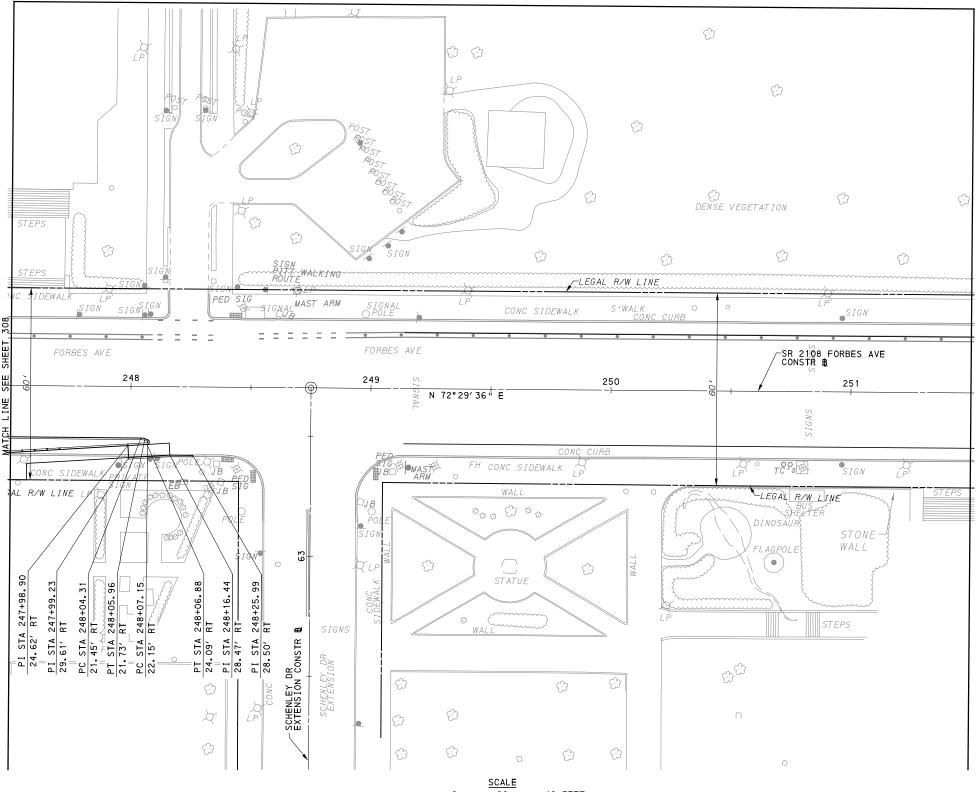

**AECOM** Gulf Tower 707 Grant Street 5th Floor Pittsburgh, PA 15219

GANNETT FLEMING Foster Plaza 8 Suite 400 730 Holiday Drive Pittsburgh, PA. 15220

THE PREPARATION OF THIS DOCUMENT HAS BEEN FINANCED IN PART THROUGH A GRANT FROM THE FEDERAL TRANSIT ADMINISTRATION U.S. DEPARTMENT OF TRANSPORTATION, UNDER THE URBAN MASS TRANSPORTATION ACT OF 1964, AS AMENDED, FOR THE PORT AUTHORITY OF ALLEGHENY COUNTY, PENNSYLVANIA. DESCRIPTION NO. DATE REVISIONS

(NOT FOR CONSTRUCTION)

DESIGNED	SDS	
DRAWN	<u>JMS</u>	
CHECKED	<u>BFS</u>	
IN CHARGE	<u>LAR</u>	
DATE	05/01/24	
SCALE		
	AS SHOWN	

### PORT AUTHORITY OF ALLEGHENY COUNTY

SIGNS\_\_\_\_\_\_\_SEE SIGNING & PAVEMENT MARKING PLANS
DRAINAGE STRUCTURES\_\_\_\_\_SEE ROADWAY PLANS

BUS RAPID TRANSIT UPTOWN TO OAKLAND REMOVAL & ADJUSTMENTS PLANS LEGEND

Port	Auth connecting pe	ority	
	connecting pe	opic to inc	

rt	Authority	CONT
,,,	connecting people to life	DWG. NO.

FOR REMOVAL AND ADJUSTMENTS OF: MANHOLES \_\_\_ \_ \_ \_ \_ \_ \_ \_ \_ SEE UTILITY PLANS UTILITY POLES \_\_\_ \_ \_ \_ \_ \_ \_ SEE UTILITY PLANS UTILITY VALVES\_\_\_ \_\_ SEE UTILITY PLANS FIRE HYDRANTS\_\_\_ \_\_ \_\_SEE UTILITY PLANS TREES\_\_\_ \_\_ \_ \_ \_ \_ \_ \_ \_ \_ SEE LANDSCAPING PLANS LIGHT POLES\_\_\_ \_\_ SEE LIGHTING PLANS SIGNAL POLES\_\_\_ \_\_ \_SEE SIGNAL PLANS

> RACT NO. BRT-001 RA1 sнт. 310

707 Grant Street 5th Floor Pittsburgh, PA 15219

DRAWING NO.	ITEM	QUANITITY	UNIT	BASEL I NE	STA	END STA	OFFSET (LT/RT)	NOTES
ITEM NOT ON SHEET	SPM-1	1	EA	DIAMOND ST	42+26		LT	
	BR-1	1	EA	FIFTH AVE	435+44		LT	
	RBR-1	1	EA	DIAMOND ST	48+26		RT	
	RBR-2	1	EA	FIFTH AVE	437+05		RT	
	RBR-3	1	EA	FIFTH AVE	437+40		LT	
	RMB-1	1	EA	DIAMOND ST	48+17		RT	
	RTC-1	1	EA	FIFTH AVE	434+63		RT	
	RTC-2	1	EA	DIAMOND ST	48+00		LŤ	
	RTC-3	1	EA	FIFTH AVE	436+26		RT	
RA9	RTC-4	1	EΑ	FIFTH AVE	436+04		LT	
	RWR-1	47	LF	FIFTH AVE	435+43	435+90	RT	
	RWR-2	50	LF	FIFTH AVE	436+06	436+56	RT	
	SBS-1	1	EA	FIFTH AVE	435+98		LŤ	
	SPM-1	1	EA	DIAMOND ST	48+18		RT	
	SPM-2	1	EA	FIFTH AVE	438+38		RT	
	SPR-1	1	EA	FIFTH AVE	435+18		LT	
	SPR-2	1	EA	FIFTH AVE	435+45		LT	
	VRR-1	1	EA	FIFTH AVE	436+17		LT	
	APX-1	1	EA	FIFTH AVE	441+33		RT	
	PWR-1	23	LF	WASHINGTON PL	25+40	25+80	LT	
	RBR-1	1	EA	FIFTH AVE	439+57		RT	
	RBR-2	1	EA	FIFTH AVE	442+06		RT	
	RBR-3	1	EA	FIFTH AVE	442+82		RT	
	RMB-1	1	EA	FIFTH AVE	443+18		RT	
	RNM-1	1	EA	FIFTH AVE	439+43		RT	
RA10	RNM-2	1	EA	FIFTH AVE	439+45		RT	
	RNM-3	1	EA	FIFTH AVE	441+25		RT	
	RTC-1	1	EA	FIFTH AVE	439+62		RT	
	RTC-2	1	EA	FIFTH AVE	440+80		RT	
	RTC-3	1	EA	FIFTH AVE	442+70		RT	
	RTC-4	1	EA	FIFTH AVE	439+68		LŤ	
	RTC-5	1	EA	FIFTH AVE	442+29		LT	
	RTC-6	1	EA	FIFTH AVE	442+95		LT	

DRAWING NO.	ITEM	QUANITITY	UNIT	BASEL INE	STA	END STA	OFFSET(LT/RT)	NOTES
	SBP-1	1	EA	FIFTH AVE	442+04		LT	
	SBP-2	1	EA	FIFTH AVE	442+10		LŤ	
	SBP-3	1	EA	FIFTH AVE	442+18		LT	
	SBP-4	1	EA	FIFTH AVE	442+25		LT	
	SBP-5	1	EA	FIFTH AVE	442+32		LT	
	SBP-6	1	EA	FIFTH AVE	442+38		LT	
RA10 CONT.	SBP-7	1	EA	FIFTH AVE	442+45		LT	
KATO CONT.	SBP-8	1	EA	FIFTH AVE	442+53		LT	
	SBP-9	1	EA	FIFTH AVE	442+60		LT	
	SPR-1	1	EA	FIFTH AVE	439+94		RT	
	SPM-1	1	EA	FIFTH AVE	441+33		RT	
	SPM-2	1	EΑ	FIFTH AVE	443+36		RT	
	SPM-3	1	EΑ	FIFTH AVE	439+05		LT	
	SPM-4	1	EΑ	FIFTH AVE	443+29		LT	
	APX-1	1	EA	FIFTH AVE	446+58		RT	
	GRR-1	14	LF	FIFTH AVE	446+95	447+09	LT	
	GRR-2	36	LF	FIFTH AVE	447+40	447+76	LT	
	GRR-3	13	LF	FIFTH AVE	447+96	448+11	LŤ	
	GRR-4	22	LF	FIFTH AVE	448+28	448+50	LT	
	RBR-1	1	EA	FIFTH AVE	443+88		RT	
	RBR-2	1	EΑ	FIFTH AVE	447+04		RT	
	RMB-1	1	EΑ	FIFTH AVE	444+52		RT	
	RMB-2	1	EΑ	FIFTH AVE	448+30		LT	
5.44	RTC-1	1	EA	FIFTH AVE	444+52		RT	
RA11	RTC-2	1	EΑ	FIFTH AVE	447+21		RT	
	RTC-3	1	EA	FIFTH AVE	448+33		RT	
	RTC-4	1	EA	FIFTH AVE	443+66		LT	
	RTC-5	1	EA	FIFTH AVE	444+34		LŤ	
	RTC-6	1	EA	FIFTH AVE	445+02		LT	
	RTC-7	1	EA	FIFTH AVE	445+70		LŤ	
	RTC-8	1	EA	FIFTH AVE	446+09		LŤ	
	RTC-9	1	EA	FIFTH AVE	446+38		LT	
	SPM-1	1	EΑ	FIFTH AVE	446+39		RT	
	SPM-2	1	EΑ	FIFTH AVE	445+80		LT	
	BBR-1	1	EΑ	FIFTH AVE	454+50		LT	
	BBR-1	1	EA	FIFTH AVE	454+50		LŤ	
	BBR-2	1	EA	FIFTH AVE	450+34		RT	
5.4-	FR-1	80	LF	FIFTH AVE	449+13	449+93	RT	
RA12	FR-2	20	LF	FIFTH AVE	451+63	451+83	RT	
	FR-3	16	LF	FIFTH AVE	452+07	452+23	RT	
	GRR-1	26	LF	FIFTH AVE	448+50	448+76	LT	
	GRR-2	33	LF	FIFTH AVE	450+45	450+78	LT	

**AECOM** 

		THE PREPARATION OF THIS DOCUMENT HAS BEEN FINANCED IN
		PART THROUGH A GRANT FROM TH
		FEDERAL TRANSIT ADMINISTRATION U.S. DEPARTMENT OF
		TRANSPORTATION, UNDER THE
		URBAN MASS TRANSPORTATION AC OF 1964, AS AMENDED, FOR THE
DATE	DESCRIPTION	PORT AUTHORITY OF ALLEGHENY COUNTY, PENNSYLVANIA.
	REVISIONS	COUNTY, PENNSTEVANIA.

(NOT FOR CONSTRUCTION)

DESIGNED	SDS	
DRAWN	<u>JMS</u>	
CHECKED	BFS	
IN CHARGE	LAR	
DATE	05/01/24	
SCALE		
	AS SHOWN	

PORT AUTHORITY OF ALLEGHENY COUNTY BUS RAPID TRANSIT UPTOWN TO OAKLAND

REMOVAL & ADJUSTMENTS PLANS TABULATIONS

Port Authority connecting people to life

CONTRACT NO. BRT-001 DWG. NO. RA2 sнт. 311

DRAWING NO.	ITEM	QUANITITY	UNIT	BASELINE	STA	END STA	OFFSET(LT/RT)	NOTES
	GRR-3	96	LF	FIFTH AVE	451+02	451+98	LT	
	GRR-4	7	LF	FIFTH AVE	452+21	452+28	LT	
	GRR-5	13	LF	STEVENSON ST	20+37	20+50	LT	
	GRR-6	21	LF	STEVENSON ST	20+30	20+50	RT	
	RBR-1	1	EA	FIFTH AVE	448+64		RT	
	RBR-2	1	EA	FIFTH AVE	451+37		RT	
	RBR-3	1	EA	FIFTH AVE	453+77		RT	
	RBR-4	1	ΕA	FIFTH AVE	450+11		LT	
	RFP-1	1	EA	FIFTH AVE	453+55		RT	
	RG-1	68	LF	FIFTH AVE	448+76	449+29	LT	
	RG-2	52	LF	FIFTH AVE	453+78	454+30	LT	
	RG-3	12	LF	FIFTH AVE	454+37	454+50	LT	
RA12 CONT.	RG-4	34	LF	FIFTH AVE	453+24	453+59	LT	
	RMB-1	1	ΕA	FIFTH AVE	453+50		RT	
	RTC-1	1	ΕA	FIFTH AVE	448+66		LT	
	RTC-2	1	ΕA	FIFTH AVE	453+22		LT	
	RTC-3	1	EA	FIFTH AVE	450+82		RT	
	RTC-4	1	ΕA	FIFTH AVE	453+29		RT	
	SBS-1	1	EA	FIFTH AVE	448+59		LT	
	SBS-2	1	ΕA	FIFTH AVE	453+47		LT	
	SPM-1	1	ΕA	FIFTH AVE	448+75		RT	
	SPM-2	1	EA	FIFTH AVE	450+76		RT	
	SPM-3	1	ΕA	FIFTH AVE	454+27		RT	
	SPM-4	1	EA	FIFTH AVE	450+55		LT	
	SPR-1	1	EA	FIFTH AVE	454+41		RT	
	BR-1	1	EA	FIFTH AVE	454+75		RT	
	BR-2	1	EA	FIFTH AVE	455+01		RT	
	BR-3	1	EA	FIFTH AVE	455+32		RT	
	BR-4	1	EA	FIFTH AVE	455+51		RT	
	CBR-1	9	LF	FIFTH AVE	455+40	455+48	LT	
	CBR-2	21	LF	FIFTH AVE	455+61	455+82	LT	
	FR-1	25	LF	PRIDE ST	30+38	30+63	LT	
	FR-2	20	LF	FIFTH AVE	464+05	464+25	LT	
	GRR-1	8	LF	FIFTH AVE	455+02	455+10	LT	
	RBR-1	1	EA	FIFTH AVE	455+58	100 110	LT	
	RG-1	27	LF	FIFTH AVE	454+50	454+77	LT	
	RMR-1	5	LF	FIFTH AVE	455+81	455+85	LT	
	RMR-2	23	LF	FIFTH AVE	455+84	456+05	LT	
RA13	RPM-1	1	EA	FIFTH AVE	458+26	100.00	RT	
	RTC-1	1	EA	FIFTH AVE	454+73		RT	
	RTC-2	1	EA	FIFTH AVE	457+31		RT	
	RTC-3	1	EA	FIFTH AVE	456+08		LT	
	RTC-4	1	EA	FIFTH AVE	457+35		LT	
	RWR-1	38	LF	PRIDE ST	30+29	30+63	LT	
	RWR-2	22	LF	FIFTH AVE	458+09	458+31	LT	
}	RWR-3	30	LF	FIFTH AVE	455+02	455+32	RT	
}	RWR-4	35	LF	FIFTH AVE	455+52	455+87	RT	
	SPM-1	1	EA	FIFTH AVE	455+24	755761	RT	
-	SPM-1	1			455+24		LT	
-	SPM-2 SPM-3	1	EA EA	FIFTH AVE	455+16		LT	
	SPM-3 SPR-1	1	EA	FIFTH AVE	457+84		RT	
	31 17-1	İ	LA	I II III AVE	130703	<u> </u>	IV I	

DRAWING NO.	ITEM	QUANITITY	UNIT	BASEL INE	STA	END STA	OFFSET(LT/RT)	NOTES
	BR-1	1	EA	FIFTH AVE	458+92		LT	
	BR-2	1	EA	FIFTH AVE	458+94		LŤ	
	BR-3	1	EA	FIFTH AVE	459+27		LT	
	CBR-1	30	LF	FIFTH AVE	461+14	461+44	LT	
	FR-1	26	LF	FIFTH AVE	461+95	462+21	RT	
	FR-2	20	LF	FIFTH AVE	464+05	464+25	LT	
	RBR-1	1	EA	FIFTH AVE	458+74		LŤ	
	RBR-2	1	EA	FIFTH AVE	460+25		LT	
	RBR-3	1	EA	FIFTH AVE	463+08		LT	
	RPM-1	1	EA	FIFTH AVE	460+53		RT	
RA14	RPM-2	1	EA	FIFTH AVE	462+37		RT	
	RRG-1	1	EA	FIFTH AVE	463+90		LT	
	RTC-1	1	EA	FIFTH AVE	459+09		RT	
	RTC-2	1	EA	FIFTH AVE	460+06		LT	
	RTC-3	1	EA	FIFTH AVE	464+49		LŤ	
	RTC-4	1	EA	FIFTH AVE	461+25		RT	
	SF-1	106	LF	FIFTH AVE	460+69	461+72	RT	
	SF-2	10	LF	FIFTH AVE	463+89	463+99	RT	
	SF-3	26	LF	FIFTH AVE	464+24	464+50	RT	
	SPM-1	1	EA	FIFTH AVE	463+17		LŤ	
	TDR-1	1	EA	FIFTH AVE	459+10		LT	
	CBR-1	40	LF	FIFTH AVE	470+10	470+50	RT	
-	FR-1	11	LF	DINWIDDIE ST	20+31	20+42	RT	
	RB-1	1	EA	FIFTH AVE	469+05		LT	
	RBR-1	1	EA	FIFTH AVE	464+64		RT	
	RBR-2	1	EA	FIFTH AVE	469+66		RT	
	RMB-1	1	EA	FIFTH AVE	470+14		RT	
	RPM-1	1	EA	FIFTH AVE	465+36		RT	
	RTC-1	1	EA	FIFTH AVE	466+63		RT	
	RTC-2	1	EA	FIFTH AVE	465+28		RT	
RA15	RTC-3	1	EA	FIFTH AVE	467+46		RT	
	RTC-4	1	EA	FIFTH AVE	468+94		LT	
	RTC-5	1	EA	FIFTH AVE	470+36		LŤ	
	RWR-1	11	LF	FIFTH AVE	470+39	470+50	LT	
	SF-1	40	LF	FIFTH AVE	464+50	464+90	RT	
	SF-2	78	LF	FIFTH AVE	466+01	466+79	LŤ	
	SF-3	140	LF	FIFTH AVE	467+08	468+48	LT	
	SPM-1	1	EA	FIFTH AVE	466+26		LT	
	SPR-1	1	EA	FIFTH AVE	469+99		LT	
	BBR-1	1	EA	FIFTH AVE	473+50		LT	
	BBR-2	1	EA	FIFTH AVE	474+35		LŤ	
	CBR-1	15	LF	FIFTH AVE	470+50	470+65	RT	
	CBR-2	17	LF	FIFTH AVE	470+91	471+08	RT	
ŀ	FR-1	12	LF	FIFTH AVE	471+09	471+21	RT	
RA16	FR-2	107	LF	FIFTH AVE	473+76	474+83	RT	
}	FR-3	228	LF	FIFTH AVE	473+53	475+17	LT	
	RD-1	1	EA	FIFTH AVE	472+28	1	LT	CLOTHING DONATION BO
ŀ	RD-2	1	EA	FIFTH AVE	472+39		LT	220111110 00111111111111111111111111111
ŀ	RP-1			FIFTH AVE				PROPERTY OWNER TO
	KF-1	1	EA	LILIH AVE	473+03	<u> </u>	RT	REMOVE/RESET

**AECOM** 

THE PREPARATION OF THIS
DOCUMENT HAS BEEN FINANCED IN
PART THROUGH A GRANT FROM THE
FEDERAL TRANSIT ADMINISTRATION,
U.S. DEPARTMENT OF
TRANSPORTATION, UNDER THE
URBAN MASS TRANSPORTATION ACT
OF 1964, AS AMENDED, FOR THE
PORT AUTHORITY OF ALLEGHENY
COUNTY, PENNSYLVANIA. NO. DATE DESCRIPTION REVISIONS

(NOT FOR CONSTRUCTION)

DESIGNED	SDS	
DRAWN	<u>JMS</u>	
CHECKED	BFS	
IN CHARGE	LAR	
DATE	05/01/24	
SCALE		
	AS SHOWN	

#### PORT AUTHORITY OF ALLEGHENY COUNTY PENNSYLVANIA BUS RAPID TRANSIT UPTOWN TO OAKLAND

REMOVAL & ADJUSTMENTS PLANS TABULATIONS

Port Authority connecting people to life

CONTRACT NO. BRT-001 DWG. NO. RA3 sнт. 312

Gulf Tower 707 Grant Street 5th Floor Pittsburgh, PA 15219

DRAWING NO.	ITEM	QUANITITY	UNIT	BASELINE	STA	END STA	OFFSET( LT/RT)	NOTES
	RP-2	1	EA	FIFTH AVE	473+11		RT	PROPERTY OWNER TO REMOVE/RESET
	RP-3	1	EΑ	FIFTH AVE	473+18		RT	PROPERTY OWNER TO REMOVE/RESET
	RP-4	1	EA	FIFTH AVE	473+26		RT	PROPERTY OWNER TO REMOVE/RESET
	RP-5	1	EA	FIFTH AVE	473+42		RT	PROPERTY OWNER TO REMOVE/RESET
	RP-6	1	EA	FIFTH AVE	473+48		RT	PROPERTY OWNER TO REMOVE/RESET
RA16 CONT.	RP-7	1	EA	FIFTH AVE	473+56		RT	PROPERTY OWNER TO REMOVE/RESET
	RP-8	1	EA	FIFTH AVE	473+65		RT	PROPERTY OWNER TO
	RTC-1	1	EA	FIFTH AVE	472+17		RT	REMOVE/RESET
	RWR-1	33	LF	FIFTH AVE	470+50	470+83	LT	
	RWR-2	29	LF	FIFTH AVE	473+16	473+45	LT	
	VRR-1	1	EA	FIFTH AVE	472+85		LT	
	FR-1	66	LF	FIFTH AVE	475+66	476+25	RT	
	FR-2	61	LF	FIFTH AVE	476+48	477+09	RT	
	FR-3	58	LF	FIFTH AVE	478+36	478+94	LT	
	RBR-1	1	EA	FIFTH AVE	476+89	,,,,,,,,,,,,,,,,,,,,,,,,,,,,,,,,,,,,,,,	LT	
	RMB-1	1	EA	FIFTH AVE	476+91		LT	
RA17	RMB-2	1 1	EA	FIFTH AVE	476+93		LT	
NATT	RRB-1	1	EA	FIFTH AVE	480+16		LT	
	RRB-2	1	EA	FIFTH AVE	480+36		LT	
	RTC-1	1	EA	FIFTH AVE	477+48		LT	
-	RTC-2	1	EA	FIFTH AVE	478+19		LŤ	
	TDR-1	1	EA	FIFTH AVE	477+30		LT	
	FR-1	20	LF	FIFTH AVE	484+45	484+65	RT	
	RBR-1	1	EA	FIFTH AVE	481+53	404103	RT	
	RCL-1	1	EA	FIFTH AVE	482+05		RT	
RA18	RTC-1	1	EA	FIFTH AVE	481+87		RT	
	RTC-2	1	EA	FIFTH AVE	480+70		LT	
	RTC-3	1	EA	FIFTH AVE	481+26		LT	
	FR-1	226	LF	FIFTH AVE	487+65	489+91	RT	
	FR-2	31	LF	FIFTH AVE	487+10	487+33	LT	
	FR-3	20	LF	FIFTH AVE	487+76	487+96	LT	
RA19	RMB-1	1	EA	FIFTH AVE	486+69	401136	LT	
-	RTC-1	1	EA	FIFTH AVE	487+37		LT	
	SPR-1	1 1	EA	FIFTH AVE	488+72		LT	
	FR-1	174	LF	FIFTH AVE	494+08	495+82	RT	
	GRR-1	68	LF	BIRMINGHAM BRIDGE	16+22	16+90	LT	
	GRR-2	52	LF	BIRMINGHAM BRIDGE	16+17	16+69	RT	
	RC-1	94	LF	FIFTH AVE	494+41	495+35	RT	
	RTC-1	1	EA	FIFTH AVE	490+79	133.33	RT	
RA20	RWR-1	99	LF	KIRKPATRICK ST	30+52	31+45	LT	
	RWR-2	11	LF	FIFTH AVE	496+39	496+50	LŤ	
	SBS-1	1	EA	FIFTH AVE	490+85	430+30	RT	
	SPS-1	1	EA	KIRKPATRICK ST	30+81		RT	WESTERN PA CONSERVANCY TO SALVAGE
	SPF-1	1	EA	FIFTH AVE	491+34	491+61	LT	WESTERN PA CONSERVANC TO SALVAGE
	FR-1	54	LF	FIFTH AVE	497+00	497+54	RT	
5.6.	RF-1	46	LF	FIFTH AVE	497+54	498+00	RT	
RA21	RG-1	211	LF	FIFTH AVE	500+39	502+50	RT	
F	RWR-1	13	LF	FIFTH AVE	496+50	496+63	LT	

DRAWING NO.	ITEM	QUANITITY	UNIT	BASELINE	STA	END STA	OFFSET(LT/RT)	NOTES
	RWR-1	42	LF	FIFTH AVE	505+35	505+77	LT	
RA22	RWR-2	27	LF	FIFTH AVE	506+14	506+41	LŤ	
RAZZ	RWR-3	28	LF	FIFTH AVE	507+01	507+29	LT	
	RG-1	500	LF	FIFTH AVE	502+50	507+50	RT	
	GRR-1	80	LF	BLVD OF THE ALLIES	11+06	11+67	RT	
RA23	RG-1	183	LF	FIFTH AVE	507+50	509+26	RT	
	RWR-1	187	LF	FIFTH AVE	508+00	509+99	LT	
	FR-1	40	LF	FIFTH AVE	517+10	517+50	RT	
	RDS-1	8	SF	ROBINSON ST A	612+64		LT	
RA24	RDS-2	8	SF	ROBINSON ST A	612+64		RT	
	RDS-3	8	SF	FIFTH AVE	514+68		LT	
	RWR-1	12	LF	FIFTH AVE	516+81	516+93	LT	
	FR-1	132	LF	FIFTH AVE	517+50	518+54	RŤ	
	PWR-1	61	LF	FIFTH AVE	520+50	521+08	RT	
	RBP-1	1	EΑ	CRAFT	20+25		LT	
5.6-	RBP-2	1	ΕA	CRAFT	20+19		LT	
RA25	RDS-1	8	SF	FIFTH AVE	518+42		LT	
	RMR-1	198	LF	FIFTH AVE	520+52	522+50	RT	
	RTC-1	1	EA	FIFTH AVE	518+38		RT	
	RWR-1	11	LF	FIFTH AVE	518+36	518+47	LT	
	APX-1	1	EA	FIFTH AVE	526+13		RT	
	APX-2	1	EA	FIFTH AVE	526+60		RT	
	RMB-1	1	ΕA	FIFTH AVE	527+54		LŤ	
	RMR-1	298	LF	FIFTH AVE	522+50	525+48	RT	
	RTC-1	1	EA	FIFTH AVE	526+13		RT	
RA26	RTC-2	1	EA	FIFTH AVE	527+41		LT	
-	SBS-1	1	EA	FIFTH AVE	527+35		LT	
	SRB-1	32	LF	FIFTH AVE	526+18	526+50	RT	OWNED BY CHILDREN'S HOSPITAL OF UPMC
	SRB-2	192	LF	FIFTH AVE	526+58	528+50	RT	OWNED BY CHILDREN'S HOSPITAL OF UPMC
	SRB-3	63	LF	FIFTH AVE	527+87	528+50	LT	OWNED BY UPMC
	APX-1	1	EA	FIFTH AVE	532+37		RT	
	APX-2	1	ΕA	FIFTH AVE	532+49		RT	
	APX-3	1	EA	FIFTH AVE	533+06		RT	
	BR-1	1	EA	DARRAGH ST	30+46		RT	
	BR-2	1	EA	DARRAGH ST	30+42		RT	
-	BR-3	1	EA	DARRAGH ST	30+39		RT	
	BR-4	1	ΕA	DARRAGH ST	30+35		RT	
	BR-5	1	EA	FIFTH AVE	533+46		LT	
RA27	BR-6	1	EΑ	FIFTH AVE	533+50		LT	
	BR-7	1	EA	FIFTH AVE	533+70		LT	
	BR-8	1	EA	FIFTH AVE	533+95		LT	
	BR-9	1	EA	FIFTH AVE	533+99		LT	
	BR-10	1	EA	FIFTH AVE	534+03		LT	
	BR-11	1	EA	FIFTH AVE	534+07		LT	
	BR-12	1	EA	FIFTH AVE	534+11		LT	
	BR-13	1	EA	FIFTH AVE	534+15		LT	

**AECOM** 

THE PREPARATION OF THIS

DOCUMENT HAS BEEN FINANCED IN
PART THROUGH A GRANT FROM THE
FEDERAL TRANSIT ADMINISTRATION,
U.S. DEPARTMENT OF
TRANSPORTATION, UNDER THE
URBAN MASS TRANSPORTATION ACT
OF 1964, AS AMENDED, FOR THE
PORT AUTHORITY OF ALLEGHENY
COUNTY, PENNSYLVANIA. NO. DATE DESCRIPTION REVISIONS

(NOT FOR CONSTRUCTION)

DESIGNED	<u>SDS</u>	
DRAWN	<u>JMS</u>	L
CHECKED	<u>BFS</u>	
IN CHARGE	LAR	
DATE	05/01/24	
SCALE		Ī
	AS SHOWN	

#### PORT AUTHORITY OF ALLEGHENY COUNTY PENNSYLVANIA BUS RAPID TRANSIT UPTOWN TO OAKLAND

REMOVAL & ADJUSTMENTS PLANS TABULATIONS

Port Authority connecting people to life

CONTRACT NO. BRT-001 DWG. NO. RA4 sнт. 313

Gulf Tower 707 Grant Street 5th Floor Pittsburgh, PA 15219

DRAWING NO.	ITEM	QUANITITY U	NIT	BASELINE	STA	END STA	OFFSET(LT/RT)	NOTES
	BR-14	1	EΑ	FIFTH AVE	534+19		LT	
	BR-15	1	EΑ	FIFTH AVE	534+24		LŤ	
	BR-16	1	EΑ	FIFTH AVE	534+28		LT	
	BR-17	1	ΕA	FIFTH AVE	534+32		LT	
	BR-18	1	EΑ	FIFTH AVE	534+36		LT	
	BR-19	1	EΑ	FIFTH AVE	534+40		LT	
	BR-20	1	EΑ	FIFTH AVE	534+44		LŤ	
	BR-21	1	EΑ	FIFTH AVE	534+48		LT	
	PWR-1	14	LF	FIFTH AVE	533+52	533+66	LT	
	PWR-2	16	LF	FIFTH AVE	533+74	533+90	LT	
	RBP-1	1	ΕA	FIFTH AVE	533+04		RT	
	RBP-2	1	EΑ	FIFTH AVE	533+08		RT	
DAGZ CONT	RBP-3	1	ΕA	FIFTH AVE	533+12		RT	
RA27 CONT.	RBP-4	1	EΑ	FIFTH AVE	533+16		RT	
	RBP-5	1	EΑ	FIFTH AVE	533+19		RT	
	RBP-6	1	ΕA	FIFTH AVE	533+22		RT	
	RBP-7	1	EA	FIFTH AVE	533+27		RT	
	RBP-8	1	ΕA	FIFTH AVE	533+30		RT	
	RMR-1	54	LF	FIFTH AVE	533+55	534+09	RT	
	RMR-2	32	LF	FIFTH AVE	534+18	534+50	RT	
	RTC-1	1	EΑ	FIFTH AVE	533+19		RT	
	RTC-2	1	EA	FIFTH AVE	534+24		RT	
	SRB-1	268	LF	FIFTH AVE	528+50	531+17	RT	OWNED BY CHILDREN'S HOSPITAL OF UPMC
	SRB-2	122	LF	FIFTH AVE	531+26	532+48	RT	OWNED BY CHILDREN'S HOSPITAL OF UPMC
	SRB-3	38	LF	FIFTH AVE	528+50	528+88	LT	OWNED BY UPMC
	APX-1	1	ΕA	FIFTH AVE	539+96		RT	
	BR-1	1	EA	FIFTH AVE	534+53		LŤ	
	BR-2	1	EA	FIFTH AVE	534+57		LT	
	BR-3	1	EA	FIFTH AVE	534+61		LŤ	
	BR-4	1	EA	FIFTH AVE	534+65		LT	
	BR-5	1	EΑ	FIFTH AVE	534+69		LT	
	BR-6	1	EA	FIFTH AVE	534+73		LŤ	
	BR-7	1	ΕA	FIFTH AVE	534+77		LT	
	BR-8	1	EA	FIFTH AVE	534+81		LT	
	BR-9	1	ΕA	FIFTH AVE	534+85		LT	
	BR-10	1	EΑ	FIFTH AVE	534+90		LT	
RA28	BR-11	1	EΑ	FIFTH AVE	534+94		LŤ	
	BR-12		EΑ	FIFTH AVE	534+98		LT	
	BR-13	1	EΑ	FIFTH AVE	534+03		LT	
	BR-14	1	ΕA	FIFTH AVE	534+07		LT	
	BR-15	1	EΑ	FIFTH AVE	534+11		LT	
	BR-16	1	EΑ	FIFTH AVE	534+15		LT	
	BR-17	1	EΑ	FIFTH AVE	534+19		LŤ	
	BR-18	1	EΑ	FIFTH AVE	535+48		LT	
	BR-19	1	ΕA	FIFTH AVE	535+89		LŤ	
	BR-20	1	ΕA	FIFTH AVE	535+91		LT	
	PWR-1	18	LF	FIFTH AVE	535+24	535+42	LT	
	PWR-2	17	LF	FIFTH AVE	535+52	535+69	LT	

	ITEM	QUANITITY	UNIT	BASELINE	STA	END STA	OFFSET( LT/RT)	NOTES
	PWR-3	15	LF	FIFTH AVE	535+75	535+90	LT	
	PWR-4	13	LF	LOTHROP ST	30+52	30+65	LŤ	
	RBP-1	1	EA	FIFTH AVE	540+03		RT	
	RBP-2	1	EA	FIFTH AVE	540+07		RT	
	RBP-3	1	EA	FIFTH AVE	540+11		RT	
	RBP-4	1	EA	FIFTH AVE	540+15		RT	
	RBP-5	1	EA	FIFTH AVE	540+19		RT	
	RBP-6	1	EA	FIFTH AVE	540+23		RT	
	RBP-7	1	EA	FIFTH AVE	540+27		RT	
	RBP-8	1	EA	FIFTH AVE	540+31		RT	
	RBP-9	1	EA	FIFTH AVE	540+35		RT	
RA28 CONT.	RBP-10	1	EA	FIFTH AVE	540+39		RT	
	RBP-11	1	EA	FIFTH AVE	540+43		RT	
	RBP-12	1	EA	FIFTH AVE	540+47		RT	
	RDS-1	213	SF	FIFTH AVE	538+29	539+39	LT	
	RMR-1	200	LF	FIFTH AVE	534+50	536+50	RT	
	RMR-2	200	LF	FIFTH AVE	537+30	539+30	RT	
	RP-1	1	EA	FIFTH AVE	537+41		LT	
	RTC-1	1	EA	FIFTH AVE	536+66		RT	
	SPR-1	1	EA	FIFTH AVE	535+96		RT	
	SPR-2	1	EA	FIFTH AVE	536+10		RT	
	STG-1	1	EA	FIFTH AVE	537+41		LT	
	APX-1	1	EA	FIFTH AVE	541+88		RT	
	APX-2	1	EA	FIFTH AVE	543+45		RT	
	APX-3	1	EA	FIFTH AVE	542+14		LT	
	RBP-1	1	EA	FIFTH AVE	540+51		RT	
	RBP-2	1	EA	FIFTH AVE	540+55		RT	
	RBP-3	1	EA	FIFTH AVE	540+59		RT	
	RBP-4	1	EA	FIFTH AVE	540+63		RT	
	RBP-5	1	EA	FIFTH AVE	540+68		RT	
	RBP-6	1	EA	FIFTH AVE	540+72		RT	
	RBP-7	1	EA	FIFTH AVE	540+75		RT	
	RBP-8	1	EA	FIFTH AVE	540+79		RT	
	RBP-9	1	EA	FIFTH AVE	540+83		RT	
	RBP-10	1	EA	FIFTH AVE	540+87		RT	
RA29	RBP-11	1	EA	FIFTH AVE	540+91		RT	
	RBP-12	1	EA	FIFTH AVE	540+95		RT	
	RBP-13	1	EA	FIFTH AVE	540+99		RT	
	RBP-14	1	EA	FIFTH AVE	541+03		RT	
	RBP-15	1	EA	FIFTH AVE	541+07		RT	
	RBP-16	1	EA	FIFTH AVE	541+11		RT	
	RBP-17	1	EA	FIFTH AVE	541+15		RT	
	RBP-18	1	EA	FIFTH AVE	541+19		RT	
	RBP-19	1	EA	FIFTH AVE	541+23		RT	
	RBP-20	1	EA	FIFTH AVE	541+27		RT	
+	RBP-21	1	EA	FIFTH AVE	541+31		RT	
	RBP-22	1	EA	FIFTH AVE	541+35		RT	
	RBP-23	1	EA	FIFTH AVE	541+39		RT	
	RBP-24	1	EA	FIFTH AVE	541+43		RT	

Gulf Tower 707 Grant Street 5th Floor Pittsburgh, PA 15219

		THE PREPARATION OF THIS
		DOCUMENT HAS BEEN FINANCED IN PART THROUGH A GRANT FROM TH
		FEDERAL TRANSIT ADMINISTRATIO
		U.S. DEPARTMENT OF TRANSPORTATION, UNDER THE
		URBAN MASS TRANSPORTATION AC
DATE		OF 1964, AS AMENDED, FOR THE PORT AUTHORITY OF ALLEGHENY COUNTY, PENNSYLVANIA.
	DEVICIONS	COUNTY, PENNSTLVANIA.

(NOT FOR CONSTRUCTION)

DESIGNED	SDS	
DRAWN	<u>JMS</u>	
CHECKED	<u>BFS</u>	
IN CHARGE	LAR	
DATE	05/01/24	
SCALE	A C CLIOVA/NI	P
	AS SHOWN	

# PORT AUTHORITY OF ALLEGHENY COUNTY PENNSYLVANIA BUS RAPID TRANSIT UPTOWN TO OAKLAND

RAPID TRANSIT UPTOWN TO OAKLAND REMOVAL & ADJUSTMENTS PLANS TABULATIONS

Port Authority connecting people to life

CONTRACT NO. BRT-001

DWG. NO. RA5 SHT. 314

	ITEM	QUANITITY	UNIT	BASELINE	STA	END STA	OFFSET(LT/RT)	NOTES
	RBP-25	1	EΑ	FIFTH AVE	541+47		RT	
	RBP-26	1	EΑ	FIFTH AVE	541+51		RŤ	
	RBP-27	1	EA	FIFTH AVE	541+55		RT	
	RBP-28	1	EA	FIFTH AVE	541+59		RT	
	RBP-29	1	EA	FIFTH AVE	541+63		RT	
	RBP-30	1	EA	FIFTH AVE	541+71		RT	
B400 0011T	RBP-31	1	EA	FIFTH AVE	541+78		RT	
RA29 CONT.	RNM-1	1	EA	FIFTH AVE	541+89		RT	
_	RNM-2	1	EA	FIFTH AVE	541+92		RT	
	RTC-1	1	EA	FIFTH AVE	541+80		RT	
	RTC-2	1	EA	FIFTH AVE	541+83		RT	AWNED BY INTVERSITY
-	SRB-1	73	LF	FIFTH AVE	542+56	543+29	RT	OWNED BY UNIVERSITY OF PITTSBURGH OWNED BY UNIVERSITY
	SRB-2	145	LF	FIFTH AVE	544+05	545+50	RT	OF PITTSBURGH
	VRR-1	1	EA	S BOUQUET ST	16+97		RT	
	APX-1	1	EA	FIFTH AVE	547+24		RT	
	APX-2	1	EΑ	FIFTH AVE	550+92		LT	
	APX-3	1	EA	FIFTH AVE	550+15		RT	
	PWR-1	14	LF	FIFTH AVE	547+18	547+32	RT	
	RWR-1	26	LF	THACKERAY AVE	30+40	30+56	RT	
	RWR-2	75	LF	FIFTH AVE	550+75	551+50	LT	
	SRB-1	64	LF	FIFTH AVE	545+50	546+14	RT	OWNED BY UNIVERSITY OF PITTSBURGH
RA30	SRB-2	13	LF	FIFTH AVE	546+25	546+38	RT	OWNED BY UNIVERSITY OF PITTSBURGH
	SRB-3	9	LF	FIFTH AVE	546+48	546+57	RT	OWNED BY UNIVERSITY OF PITTSBURGH
	SRB-4	6	LF	FIFTH AVE	546+62	546+68	RT	OWNED BY UNIVERSITY OF PITTSBURGH
	SRB-5	16	LF	FIFTH AVE	546+97	547+13	RT	OWNED BY UNIVERSITY OF PITTSBURGH
	SRB-6	123	LF	FIFTH AVE	547+37	548+60	RT	OWNED BY UNIVERSITY OF PITTSBURGH
	SRB-7	141	LF	FIFTH AVE	548+92	550+38	RT	OWNED BY UNIVERSITY OF PITTSBURGH
	SRB-8	73	LF	FIFTH AVE	550+78	551+50	RT	OWNED BY UNIVERSITY OF PITTSBURGH
	APX-1	1	EA	FIFTH AVE	552+14		LT	
	APX-2	1	EΑ	FIFTH AVE	552+19		LT	
	APX-3	1	EA	BIGELOW BLVD	37+32		LT	
	APX-4	1	EA	FIFTH AVE	554+15		LT	
	PWR-1	16	LF	FIFTH AVE	552+39	552+55	LT	
	PWR-2	15	LF	FIFTH AVE	552+65	552+80	LT	
	PWR-3	15	LF	FIFTH AVE	552+90	553+05	LT	
RA31	PWR-4	15	LF	FIFTH AVE	553+15	553+30	LT	
	RB-1	1	EA	FIFTH AVE	552+59		LT	
	RB-2	1	EA	FIFTH AVE	552+85		LT	
	RB-3	1	EA	FIFTH AVE	553+10		LT D*	
-	RGB-1	1	EA	FIFTH AVE	554+39		RT	
-	RGB-2	1	EA	FIFTH AVE	554+74		RT	
-	RGB-3	1	EA	FIFTH AVE	555+09		RT	
	RGB-4	1	EA	FIFTH AVE	555+44	FFF : 50	RT	
	RMR-1	111	LF	FIFTH AVE	554+39	555+50	RT	

	ITEM	QUANITITY	UNIT	BASEL INE	STA	END STA	OFFSET(LT/RT)	NOTES
	RPM-1	1	EΑ	FIFTH AVE	552+10		LT	
	RTC-1	1	EΑ	FIFTH AVE	554+36		LŤ	
RA31 CONT.	RTC-2	1	EΑ	FIFTH AVE	554+38		LT	
	RWR-1	184	LF	FIFTH AVE	551+50	553+34	LT	
	SRB-1	152	LF	FIFTH AVE	551+50	553+02	RT	
	APX-1	1	EA	FIFTH AVE	557+16		RT	
	RC-1	24	LF	FIFTH AVE	559+42	559+65	LŤ	
,	RGB-1	1	EΑ	FIFTH AVE	555+78		RT	
	RGB-2	1	EΑ	FIFTH AVE	556+13		RT	
	RGB-3	1	EA	FIFTH AVE	556+48		RT	
	RGB-4	1	EΑ	FIFTH AVE	557+61		RT	
	RGB-5	1	EΑ	FIFTH AVE	557+95		RT	
	RGB-6	1	ΕA	FIFTH AVE	558+27		RT	
	RGB-7	1	ΕA	FIFTH AVE	558+61		RT	
	RGB-8	1	EΑ	FIFTH AVE	558+93		RT	
	RGB-9	1	ΕA	FIFTH AVE	558+93		RT	
	RGB-10	1	EA	FIFTH AVE	559+26		RT	
RA32	RGB-11	1	ΕA	FIFTH AVE	559+59		RT	
	RGB-12	1	EA	FIFTH AVE	559+85		RT	
	RGB-13	1	ΕA	FIFTH AVE	560+18		RT	
	RGB-14	1	EA	FIFTH AVE	560+40		RT	
	RGB-15	1	EA	FIFTH AVE	560+73		RT	
	RGB-16	1	ΕA	FIFTH AVE	561+06		RT	
	RGB-17	1	EA	FIFTH AVE	561+39		RT	
	RMR-1	98	LF	FIFTH AVE	555+50	556+48	RT	
	RMR-2	198	LF	FIFTH AVE	557+61	559+59	RT	
	RMR-3	31	LF	FIFTH AVE	559+86	560+17	RT	
	RMR-4	110	LF	FIFTH AVE	560+40	561+50	RT	
	SBS-1	1	EA	FIFTH AVE	560+87		LT	
	APX-1	1	EA	FIFTH AVE	564+08		RT	
	APX-2	1	ΕA	FIFTH AVE	564+68		LT	
	PWR-1	30	LF	FIFTH AVE	563+95	564+15	RT	
	RDG-1	86	LF	FIFTH AVE	563+21	564+07	RT	
	RGB-1	1	EA	FIFTH AVE	561+72		RT	
	RGB-2	1	EA	FIFTH AVE	562+05		RT	
	RGB-3	1	EA	FIFTH AVE	562+38		RT	
	RGB-4	1	EA	FIFTH AVE	562+71		RT	
	RGB-5	1	EA	FIFTH AVE	563+04		RT	
RA33	RGB-6	1	EA	FIFTH AVE	563+36		RT	
	RGB-7	1	EA	FIFTH AVE	563+70		RT	
	RMR-1	220	LF	FIFTH AVE	561+50	563+70	RT	
	RPM-1	1	EA	FIFTH AVE	561+66		LT	
	RPM-2	1	EA	FIFTH AVE	563+78		LT	
	RQK-1	1	EA	N BELLEFIELD AVE	61+46		LT	
	RQK-2	1	EA	N BELLEFIELD AVE	61+52		LT	
	RQK-3	1	EA	N BELLEFIELD AVE	61+57		LŤ	
	RQK-4	1	EA	N BELLEFIELD AVE	61+62		LT	
	RWR-1	13	LF	N BELLEFIELD AVE	61+38	61+51	LT	
	1111			DEELE, ILLD AVE	01.00	1 31.31	1	L

Gulf Tower 707 Grant Street 5th Floor Pittsburgh, PA 15219 THE PREPARATION OF THIS

DOCUMENT HAS BEEN FINANCED IN
PART THROUGH A GRANT FROM THE
FEDERAL TRANSIT ADMINISTRATION,
U.S. DEPARTMENT OF
TRANSPORTATION, UNDER THE
URBAN MASS TRANSPORTATION ACT
OF 1964, AS AMENDED, FOR THE
NO. DATE

DESCRIPTION
REVISIONS

THE PREPARATION OF THIS
PORT AUTHORITY OF ALLEGHENY
COUNTY, PENNSYLVANIA.

(NOT FOR CONSTRUCTION)

DESIGNED	SDS	
DRAWN	<u>JMS</u>	
CHECKED	<u>BFS</u>	
IN CHARGE	<u>LAR</u>	
DATE	05/01/24	
SCALE		
	AS SHOWN	

PORT AUTHORITY OF ALLEGHENY COUNTY
PITTSBURGH

BUS RAPID TRANSIT UPTOWN TO OAKLAND

BUS RAPID TRANSIT UPTOWN TO OAKLAND REMOVAL & ADJUSTMENTS PLANS TABULATIONS

Port Authority connecting people to life

CONTRACT NO. BRT-001

DWG. NO. RA6 SHT. 315

DRAWING NO.	ITEM	QUANITITY	UNIT	BASELINE	STA	END STA	OFFSET(LT/RT)	NOTES
RA34	SBS-1	1	EA	FORBES AVE	122+24		RT	
	SBS-1	1	EA	FORBES AVE	128+34		RT	
RA35	APX-1	1	EΑ	FORBES AVE	128+91		LT	
KASS	APX-2	1	EΑ	FORBES AVE	128+91		LT	
	RWR-1	79	LF	FORBES AVE	129+74	130+53	RT	
	RTC-1	1	EΑ	FORBES AVE	141 +21		RT	
	RB-1	1	EΑ	FORBES AVE	141+27		RT	
RA36	RWR-1	13	LF	FORBES AVE	141+29	141+42	RT	
•	SBS-1	1	EA	FORBES AVE	141+35		RT	
	RBR-1	1	EA	FORBES AVE	141+42		RT	
	RWR-1	86	LF	FORBES AVE	144+39	145+25	RT	
	RNM-1	1	EA	FORBES AVE	145+04		RT	
	RNM-2	1	EA	FORBES AVE	145+06		RT	
	RNM-3	1	EA	FORBES AVE	145+09		RT	
	RTC-1	1	EA	FORBES AVE	145+22		RT	
RA37	RPM-2	1	EA	FORBES AVE	146+50		LT	
	SF-1	136	LF	FORBES AVE	146+01	147+38	RT	
	RPM-3	1	EA	FORBES AVE	146+92		LŤ	
•	PWR-1	1	EA	FORBES AVE	147+85		LT	
	RP-1	1	EA	FORBES AVE	148+01		LT	
	SF-2	37	LF	FORBES AVE	148+85	149+22	LT	
	RMB-1	1	ΕA	FORBES AVE	151+78		RT	
	RMB-2	1	EA	FORBES AVE	151+81		RT	
•	RTC-1	1	EA	FORBES AVE	152+08		RT	
	APX-1	1	EΑ	FORBES AVE	152+19		LT	
5.70	APX-2	1	ΕA	FORBES AVE	152+20		RT	
RA38	APX-3	1	EA	FORBES AVE	152+77		RT	
	RPS-1	1	EA	FORBES AVE	153+37		RT	
	RPS-2	1	EA	FORBES AVE	153+85		RT	
	RTC-2	1	EA	FORBES AVE	154+26		RT	
	RPS-3	1	ΕA	FORBES AVE	154+38		RŤ	

DRAWING NO.	ITEM	QUANITITY	UNIT	BASELINE	STA	END STA	OFFSET( LT/RT)	NOTES
	RTC-1	1	EA	FORBES AVE	155+70		RT	
	RPS-1	1	EΑ	FORBES AVE	156+29		RT	
	RMB-1	1	EA	FORBES AVE	156+37		RT	
	RTC-2	1	EA	FORBES AVE	156+50		LT	
	SF-2	19	LF	FORBES AVE	157+04	157+23	RT	
RA39	RBR-1	1	EA	FORBES AVE	157+21		LT	
	RWR-1	179	LF	FORBES AVE	157+30	159+09	LŤ	
	SF-1	164	LF	FORBES AVE	157+33	158+97	LT	
	RP-1	1	EA	FORBES AVE	158+98		RT	
	RP-2	1	EΑ	FORBES AVE	159+17		RT	
	RP-3	1	EA	FORBES AVE	159+35		RT	
	RP-1	1	EA	FORBES AVE	159+53		RT	
	RP-2	1	EΑ	FORBES AVE	160+27		RT	
	RP-3	1	EA	FORBES AVE	160+43		RT	
	RP-4	1	EA	FORBES AVE	160+67		RT	
	SF-1	22	LF	FORBES AVE	160+66	160+88	RT	
	RBR-1	1	EA	FORBES AVE	160+73		LT	
	RTC-1	1	EΑ	FORBES AVE	160+96		RT	
	RAT-1	1	EA	FORBES AVE	161+04		RT	
RA40	RMB-1	1	EA	FORBES AVE	161+06		LŤ	
RA4U	SF-2	19	LF	FORBES AVE	162+11	162+30	RT	
	RBP-1	1	EA	FORBES AVE	163+35		RT	
	RBP-2	1	EΑ	FORBES AVE	163+62		RT	
	RTC-2	1	EA	FORBES AVE	163+86		LT	
	STG-1	1	EA	FORBES AVE	163+75		RT	
	RBR-2	1	EA	FORBES AVE	163+98		LT	
	RBR-3	1	EA	FORBES AVE	164+04		LT	
	STG-2	1	EA	FORBES AVE	164+06		RT	
	STG-3	1	EA	FORBES AVE	164+48		RT	

Gulf Tower 707 Grant Street

5th Floor Pittsburgh, PA 15219 GANNETT FLEMING
GANNETT FLEMING, INC.
Foster Plaza 8
Suite 400
730 Holiday Drive
Pittsburgh, PA. 15220

THE PREPARATION OF THIS
DOCUMENT HAS BEEN FINANCED IN
PART THROUGH A GRANT FROM THE
FEDERAL TRANSIT ADMINISTRATION,
U.S. DEPARTMENT OF
TRANSPORTATION, UNDER THE
URBAN MASS TRANSPORTATION ACT
OF 1964, AS AMENDED, FOR THE
PORT AUTHORITY OF ALLEGHENY
COUNTY, PENNSYLVANIA.

(NOT FOR CONSTRUCTION)

DESIGNED	<u>KMH</u>	
DRAWN	<u>KMH</u>	
CHECKED	MRK	
IN CHARGE	<u>GEC</u>	
DATE	05/01/24	
SCALE	4.0.01101441	
1	AS SHOWN	

## PORT AUTHORITY OF ALLEGHENY COUNTY PITTSBURGH PENNSYLVANIA

BUS RAPID TRANSIT UPTOWN TO OAKLAND REMOVAL & ADJUSTMENTS PLANS TABULATIONS

Port Authority connecting people to life

CONTRACT NO. BRT-001

DWG. NO. RA7 SHT. 316

OPERATOR: \$USER\$ FILE PATH: \$FILEL\$

DRAWING NO.	ITEM	QUANITITY	UNIT	BASEL INE	STA	END STA	OFFSET(LT/RT)	NOTES
	SF-1	153	LF	FORBES AVE	164+54	166+07	LT	
	RBP-1	1	EA	FORBES AVE	164+97		RT	
	RBP-2	1	EΑ	FORBES AVE	165+23		RT	
	STG-1	1	EA	FORBES AVE	165+30		RT	
R41	RBR-1	1	EA	FORBES AVE	165+54		RT	
K41	SF-2	109	LF	FORBES AVE	164+97	166+06	RT	
	STG-2	1	EA	FORBES AVE	165+60		RT	
	RTC-1	1	EΑ	FORBES AVE	165+85		RT	
	STG-3	1	EA	FORBES AVE	165+92		RT	
	RMB-1	1	EA	FORBES AVE	166+16		RT	
	STG-1	1	EA	FORBES AVE	170+63		RT	
	RTC-1	1	EΑ	FORBES AVE	170+73		RT	
RA42	RWR-1	35	LF	FORBES AVE	171+88	172+23	LT	
	SF-1	87	LF	FORBES AVE	172+45	173+33	LT	
	RMB-1	1	EΑ	FORBES AVE	172+23		RT	
RA43	SF-1	122	LF	FORBES AVE	173+51	174+73	RT	
DA44	SBS-1	1	EA	FORBES AVE	210+87		RT	
RA44	SPM-1	1	EA	FORBES AVE	212+36		LT	
DA 45	SPM-1	1	EA	FORBES AVE	214+78		RT	
RA45	APX-1	1	EA	FORBES AVE	217+23		LT	
	SBS-1	1	EΑ	FORBES AVE	243+56		RT	
	SBS-2	1	EΑ	FORBES AVE	243+74		RT	
RA46	SPM-1	1	EA	FORBES AVE	245+93		RT	
	RPS-1	1	EΑ	FORBES AVE	246+55		RT	
	SPM-2	1	EA	FORBES AVE	247+07		RT	

**AECOM** 

Gulf Tower 707 Grant Street 5th Floor Pittsburgh, PA 15219

GANNETT FLEMING
GANNETT FLEMING, INC.
Foster Plaza 8
Suite 400
730 Holiday Drive
Pittsburgh, PA. 15220

		THE PREPARATION OF THIS DOCUMENT HAS BEEN FINANCED IN
		PART THROUGH A GRANT FROM THE
		FEDERAL TRANSIT ADMINISTRATION,
		U.S. DEPARTMENT OF TRANSPORTATION. UNDER THE
		URBAN MASS TRANSPORTATION ACT
		OF 1964, AS AMENDED, FOR THE
DATE	DESCRIPTION	PORT AUTHORITY OF ALLEGHENY COUNTY, PENNSYLVANIA.
	REVISIONS	COUNTY, FEMINSTEVANIA.


(NOT FOR CONSTRUCTION)

DESIGNED	<u>кмн</u>	PORT AUTHOR	ITY
DRAWN	<u>KMH</u>	PITTSBURGH	
CHECKED	MRK	BUS RAPID TF	RANS
IN CHARGE	<u>GEC</u>	REMOV.	AL &
DATE	<u>05/01/24</u>		T,
SCALE	AS SHOWN	Port Authority	
	710 0110 1111	T VI C / LOCKII VII LY	

OF ALLEGHENY COUNTY PENNSYLVANIA NSIT UPTOWN TO OAKLAND & ADJUSTMENTS PLANS TABULATIONS

PORT Authority connecting people to life

CONTRACT NO. BRT-001 DWG. NO. RA8 sнт. 317

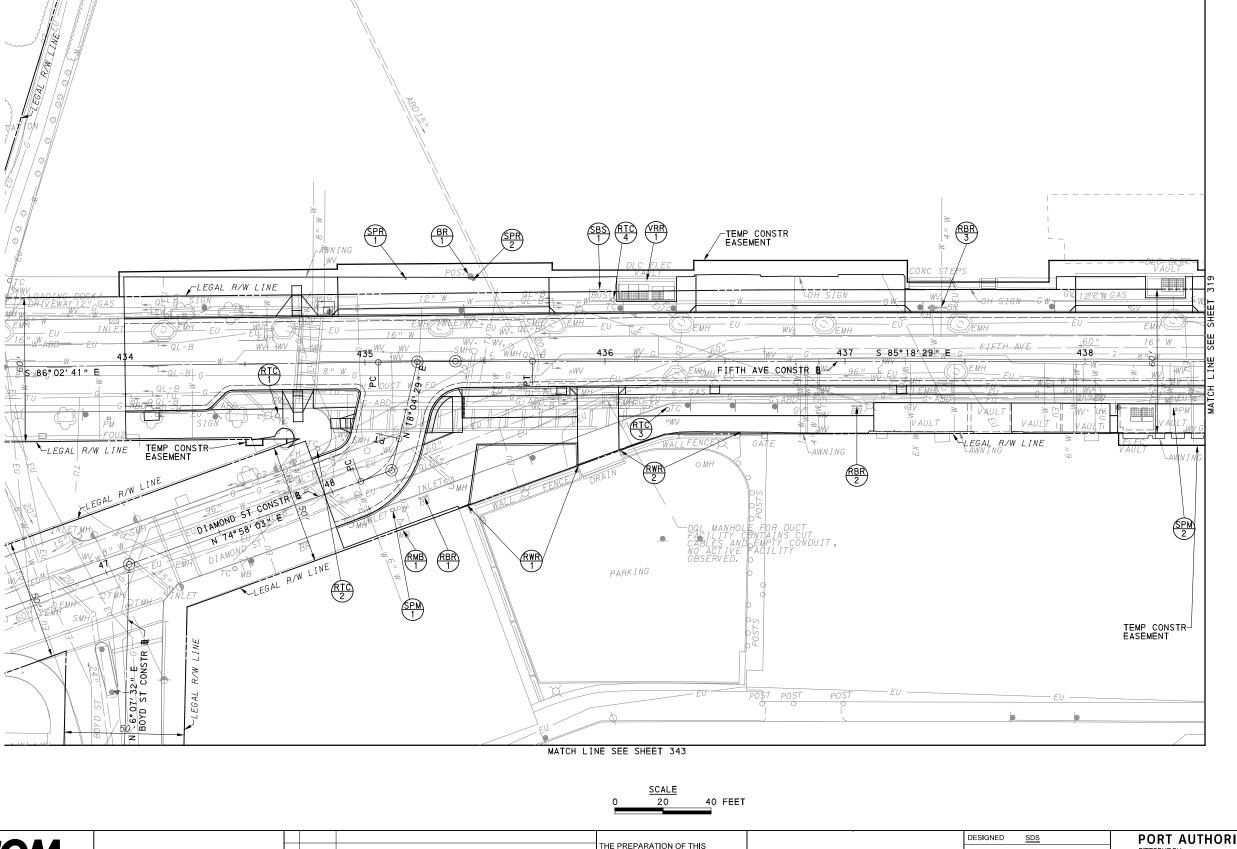

FOR ROADWAY PLAN SEE SHEET 357

**AECOM** 

Gulf Tower 707 Grant Street 5th Floor Pittsburgh, PA 15219

THE PREPARATION OF THIS
DOCUMENT HAS BEEN FINANCED IN
PART THROUGH A GRANT FROM THE
FEDERAL TRANSIT ADMINISTRATION,
U.S. DEPARTMENT OF
TRANSPORTATION, UNDER THE
URBAN MASS TRANSPORTATION ACT
OF 1964, AS AMENDED, FOR THE
PORT AUTHORITY OF ALLEGHENY
COUNTY, PENNSYLVANIA. NO. DATE DESCRIPTION REVISIONS

(NOT FOR CONSTRUCTION)


DESIGNED	SDS	
DRAWN	<u>JMS</u>	
CHECKED	BFS	
IN CHARGE	LAR	
DATE	05/01/24	
SCALE		
	AS SHOWN	

PORT AUTHORITY OF ALLEGHENY COUNTY BUS RAPID TRANSIT UPTOWN TO OAKLAND

REMOVAL & ADJUSTMENTS PLANS FIFTH AVE - STA 433+50 TO STA 438+50

Port Authority connecting people to life

CONTRACT NO. BRT-001 DWG. NO. RA9 sнт. 318

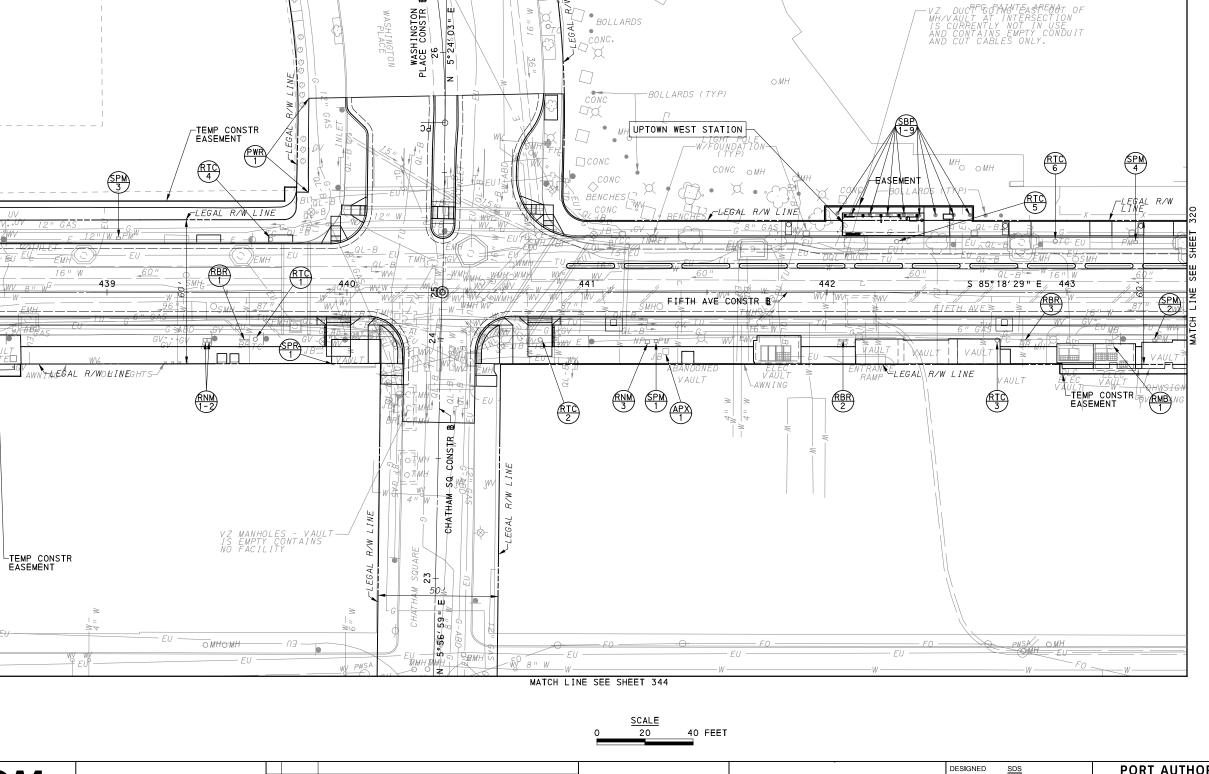

FOR ROADWAY PLAN SEE SHEET 358

**AECOM** 

Gulf Tower 707 Grant Street 5th Floor Pittsburgh, PA 15219 THE PREPARATION OF THIS
DOCUMENT HAS BEEN FINANCED IN
PART THROUGH A GRANT FROM THE
FEDERAL TRANSIT ADMINISTRATION,
U.S. DEPARTMENT OF
TRANSPORTATION, UNDER THE
URBAN MASS TRANSPORTATION ACT
OF 1964, AS AMENDED, FOR THE
PORT AUTHORITY OF ALLEGHENY
COUNTY, PENNSYLVANIA.

(NOT FOR CONSTRUCTION)

DESIGNED	SDS	
DRAWN	<u>JMS</u>	
CHECKED	<u>BFS</u>	
IN CHARGE	LAR	
DATE	05/01/24	
SCALE		
	AS SHOWN	

PORT AUTHORITY OF ALLEGHENY COUNTY
PITTSBURGH


BUS RAPID TRANSIT UPTOWN TO OAKLAND

S RAPID TRANSIT UPTOWN TO OAKLAND REMOVAL & ADJUSTMENTS PLANS FIFTH AVE - STA 438+50 TO STA 443+50

Port Authority \_\_\_\_

CONTRACT NO. BRT-001

DWG. NO. RA10 SHT. 319

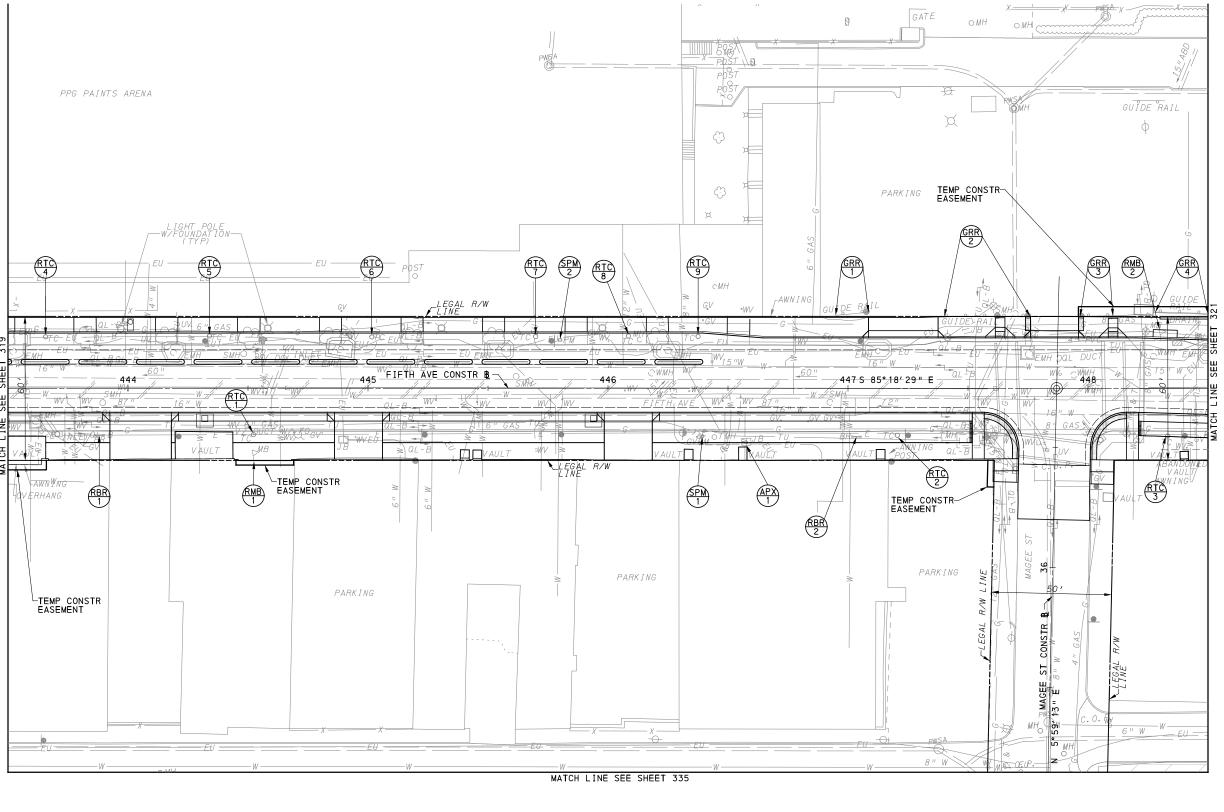

40 FEET

**AECOM** Gulf Tower 707 Grant Street 5th Floor Pittsburgh, PA 15219

THE PREPARATION OF THIS
DOCUMENT HAS BEEN FINANCED IN
PART THROUGH A GRANT FROM THE
FEDERAL TRANSIT ADMINISTRATION, PEDERAL TRANSIT ADMINISTRATION,
U.S. DEPARTMENT OF
TRANSPORTATION, UNDER THE
URBAN MASS TRANSPORTATION ACT
OF 1964, AS AMENDED, FOR THE
PORT AUTHORITY OF ALLEGHENY
COUNTY, PENNSYLVANIA. NO. DATE DESCRIPTION REVISIONS

(NOT FOR CONSTRUCTION)

DESIGNED	SDS	
DRAWN	<u>JMS</u>	
CHECKED	<u>BFS</u>	
IN CHARGE	LAR	
DATE	05/01/24	
SCALE	-	
	AS SHOWN	


FOR ROADWAY PLAN SEE SHEET 359 PORT AUTHORITY OF ALLEGHENY COUNTY

BUS RAPID TRANSIT UPTOWN TO OAKLAND REMOVAL & ADJUSTMENTS PLANS FIFTH AVE - STA 443+50 TO STA 448+50

Port Authority

CONTRACT NO. BRT-001 DWG. NO.

RA11 sнт. 320

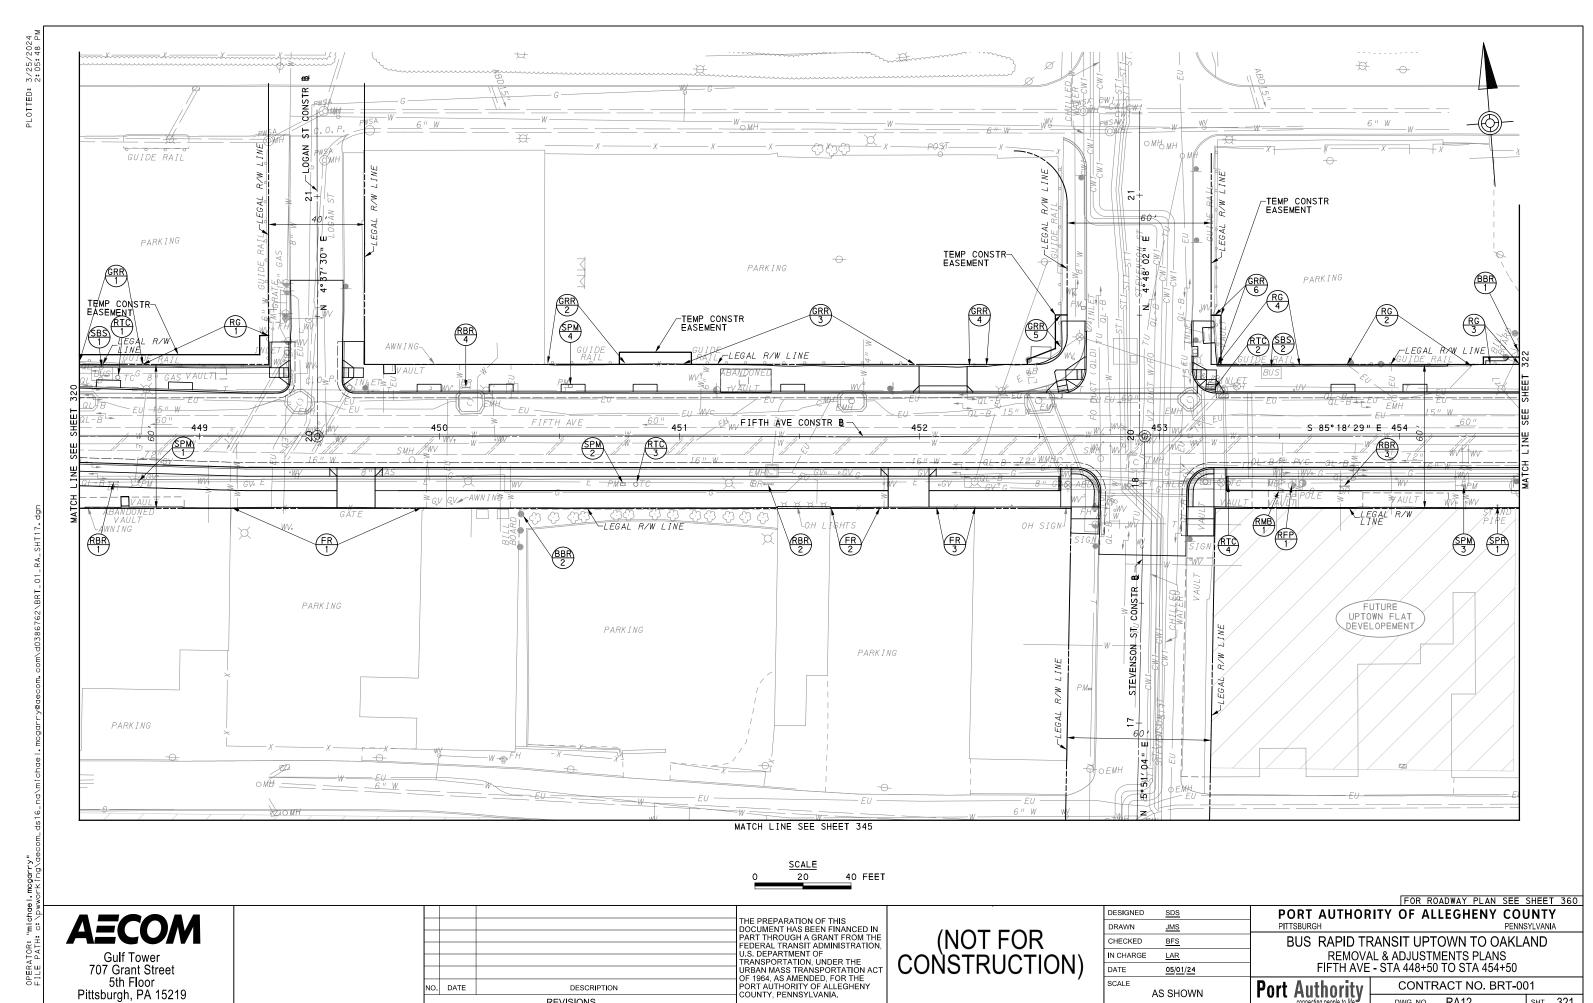

DATE

SCALE

05/01/24

AS SHOWN

**Port Authority** 

CONTRACT NO. BRT-001

sнт. 321

RA12

DWG. NO.

707 Grant Street

5th Floor

Pittsburgh, PA 15219

NO. DATE

DESCRIPTION

LEGAL R/W LINE

RIC

GATE

TEMP CONSTR-EASEMENT


PRIDE ST STATION

455 GO AL-B FIFTH AVE CONSTR B-/<sub>W</sub>S 85%18'29" E


RWR 3


BR 3

TEMP CONSTR

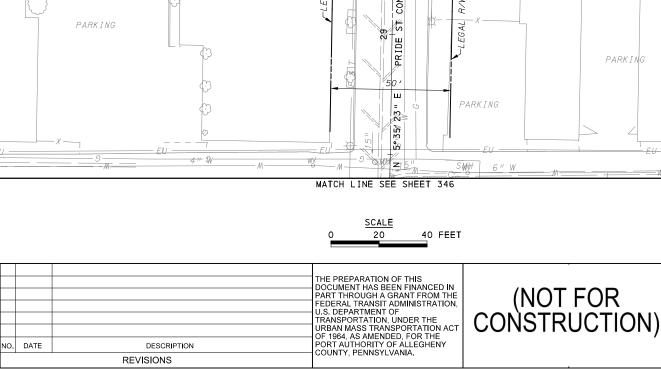

5 STY BRICK

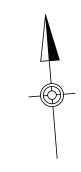

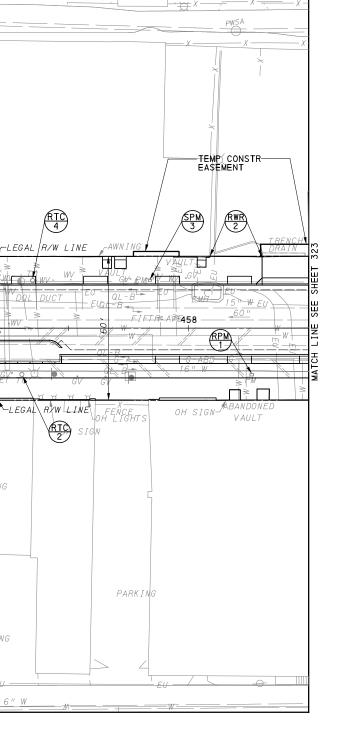

DESIGNED

CHECKED

N CHARGE

DATE

SCALE

DRAWN

SDS

<u>JMS</u>

BFS

LAR

05/01/24

AS SHOWN

PARKING

FOR ROADWAY PLAN SEE SHEET 361

PORT AUTHORITY OF ALLEGHENY COUNTY


BUS RAPID TRANSIT UPTOWN TO OAKLAND REMOVAL & ADJUSTMENTS PLANS FIFTH AVE - STA 454+50 TO STA 458+50

Port Authority

CONTRACT NO. BRT-001 DWG. NO. RA13 sнт. 322

**AECOM Gulf Tower** 707 Grant Street 5th Floor Pittsburgh, PA 15219

PARKING

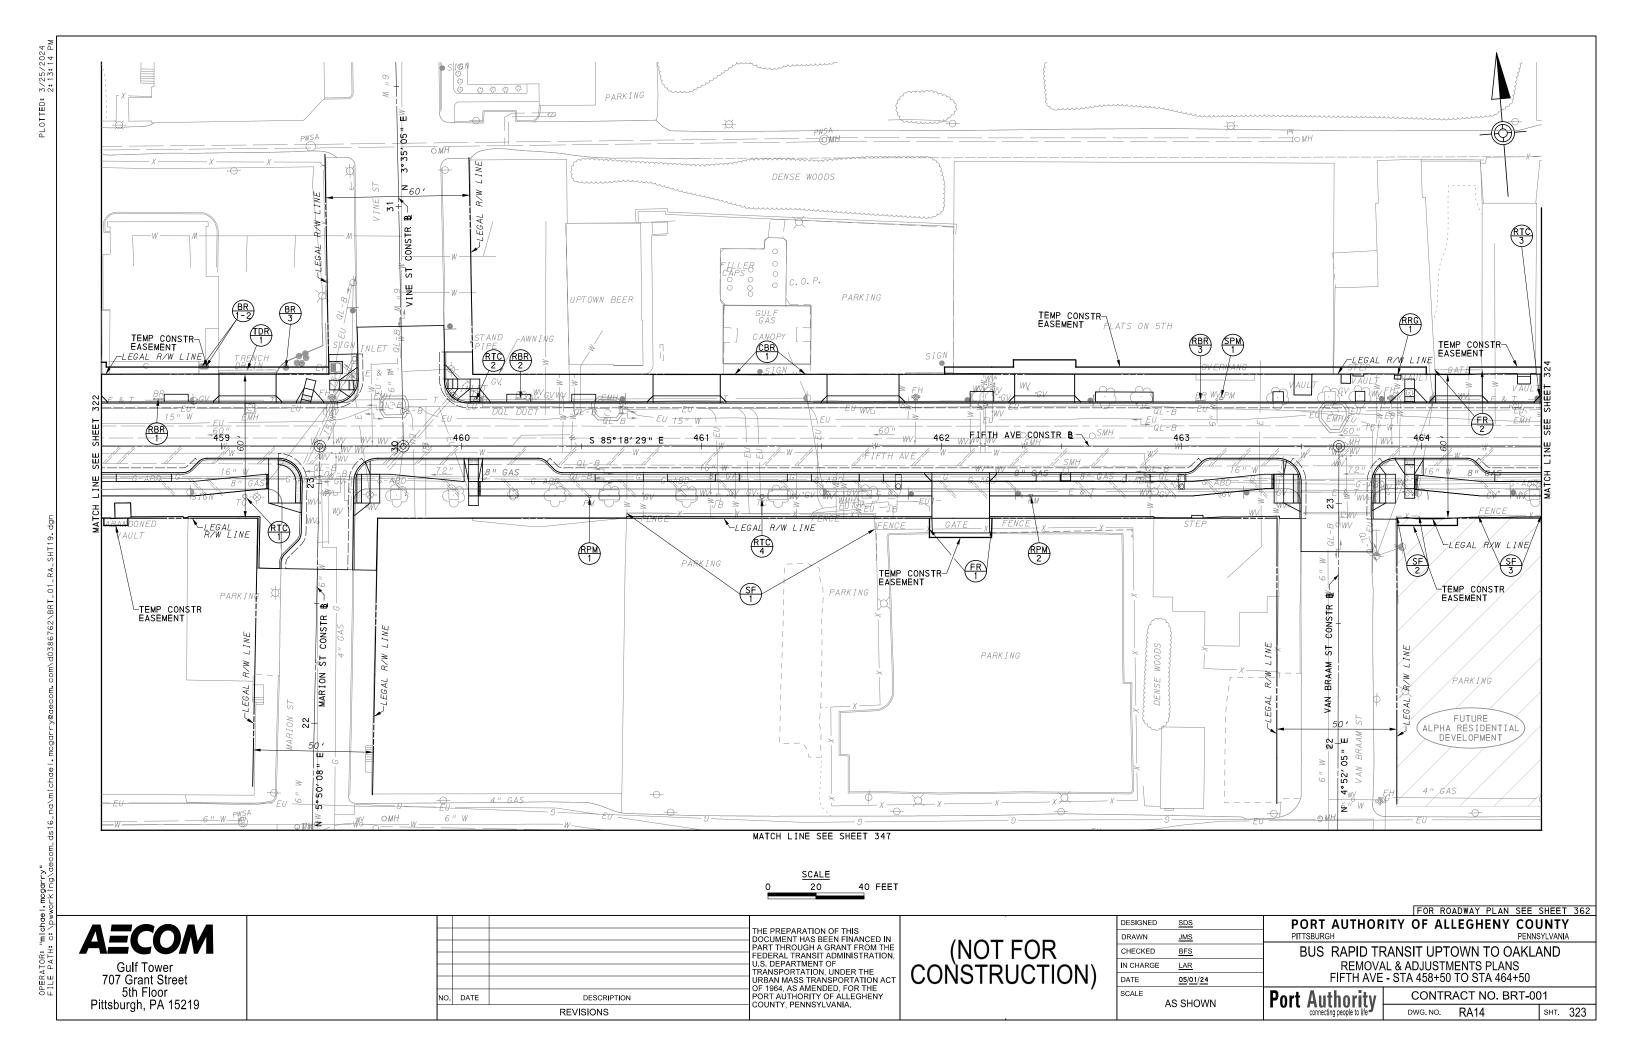

FUTURE ALARM TENBERGER ST CONS

WILTENBERGER ST CONS

WAS A WILTENBERGER ST CONS

WILTENBERGER ST CONS

WILTENBERGER ST CONS

WILTENBERG ST CONS

WILTENBERGER ST CONS

WILTENBERGER ST CONS

WILTENBERG ST CONS

WILTENBERGER ST CONS

WILTENBERGER ST CONS

WILTENBERG

SCALE 0 20 40 FEET

MATCH LINE SEE SHEET 348

**AECOM** 

PARKING

Gulf Tower 707 Grant Street 5th Floor Pittsburgh, PA 15219 THE PREPARATION OF THIS
DOCUMENT HAS BEEN FINANCED IN
PART THROUGH A GRANT FROM THE
FEDERAL TRANSIT ADMINISTRATION,
U.S. DEPARTMENT OF
TRANSPORTATION, UNDER THE
URBAN MASS TRANSPORTATION ACT
OF 1964, AS AMENDED, FOR THE
NO. DATE
DESCRIPTION
REVISIONS
THE PREPARATION OF THIS
FEDERAL TRANSPORTATION, UNDER THE
URBAN MASS TRANSPORTATION ACT
OF 1964, AS AMENDED, FOR THE
PORT AUTHORITY OF ALLEGHENY
COUNTY, PENNSYLVANIA.

(NOT FOR CONSTRUCTION)

ESIGNED	<u>SDS</u>		
RAWN	<u>JMS</u>		
HECKED	BFS		
CHARGE	LAR		
ATE	05/01/24		
CALE			
AS SHOWN			

FOR ROADWAY PLAN SEE SHEET 363

PORT AUTHORITY OF ALLEGHENY PENNSYLVANIA

BUS RAPID TRANSIT UPTOWN TO OAKLAND

RAPID TRANSIT UPTOWN TO OAKLAND REMOVAL & ADJUSTMENTS PLANS FIFTH AVE - STA 464+50 TO STA 470+50

Port Authority -

CONTRACT NO. BRT-001

DWG. NO. RA15 SHT. 324

999999


OPERATOR: "michael,mogarry" FIIF PATH: c:\Dwworkind\gecom ds16 ng\michael,mog DENSE WOODS

NO. DATE

DESCRIPTION

REVISIONS

CBR 1

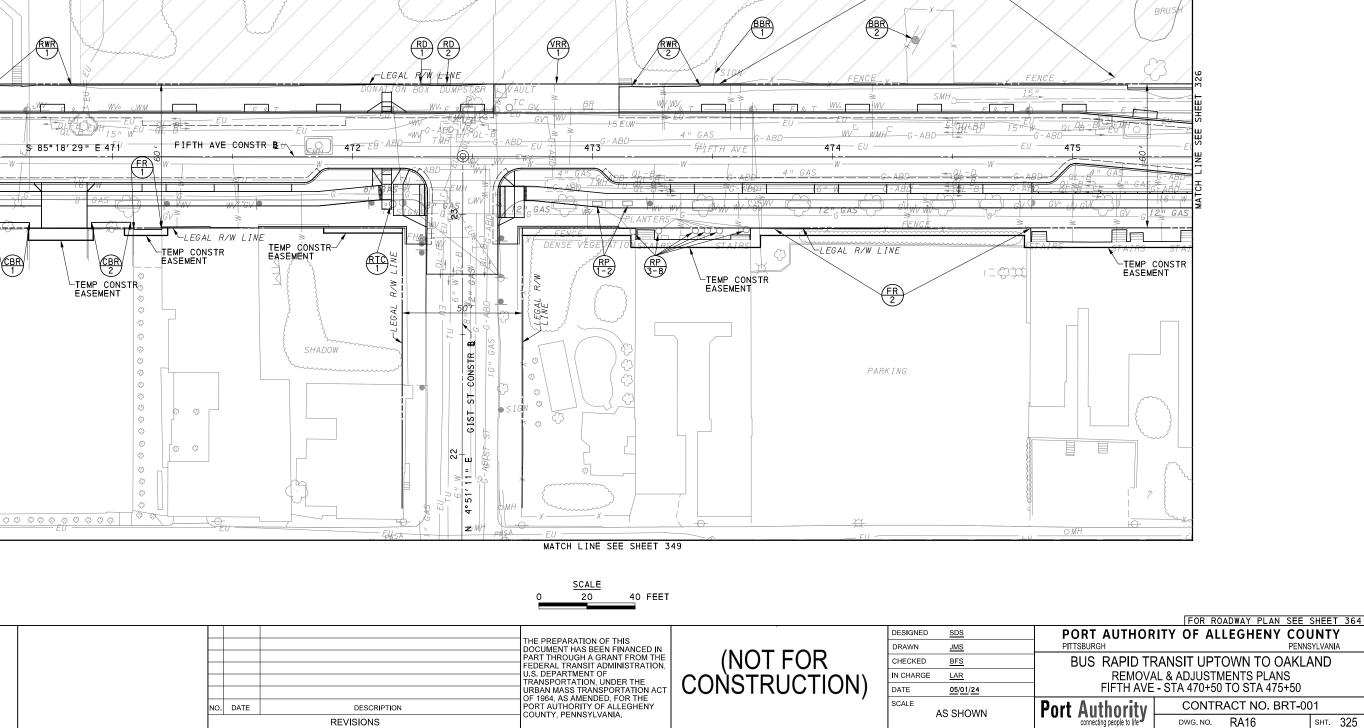

AS SHOWN

RA16

sнт. 325

DWG. NO.

FUTURE FOUNTAIN RESIDENTIAL DEVELOPMENT

**AECOM** 

**Gulf Tower** 

707 Grant Street

5th Floor Pittsburgh, PA 15219



(RRB) 2 TEMP CONSTR-EASEMENT -LEGAL R/W LIM LEGAL R/W LINE 479 480 476 <u>S 85 18'29" E</u> FIFTH AVE CONSTRUBE LEGAL R/W LINE LEGALS RIW LINE TEMP CONSTR TEMP CONSTR EASEMENT TEMP CONSTR PARKING GATE PARKING PARKING DENSE DENSE VEGETATION

MATCH LINE SEE SHEET 350

40 FEET

**AECOM** 

Gulf Tower 707 Grant Street 5th Floor Pittsburgh, PA 15219

THE PREPARATION OF THIS
DOCUMENT HAS BEEN FINANCED IN
PART THROUGH A GRANT FROM THE
FEDERAL TRANSIT ADMINISTRATION,
U.S. DEPARTMENT OF
TRANSPORTATION, UNDER THE
URBAN MASS TRANSPORTATION ACT
OF 1964, AS AMENDED, FOR THE
PORT AUTHORITY OF ALLEGHENY
COUNTY, PENNSYLVANIA. NO. DATE DESCRIPTION REVISIONS

(NOT FOR CONSTRUCTION)


DESIGNED	SDS	
DRAWN	<u>JMS</u>	
CHECKED	BFS	
IN CHARGE	LAR	
DATE	05/01/24	
SCALE	AS SHOWN	


FOR ROADWAY PLAN SEE SHEET 365 PORT AUTHORITY OF ALLEGHENY COUNTY


BUS RAPID TRANSIT UPTOWN TO OAKLAND REMOVAL & ADJUSTMENTS PLANS FIFTH AVE - STA 475+50 TO STA 480+50


Port Authority connecting people to life


CONTRACT NO. BRT-001 DWG. NO. RA17 sнт. 326

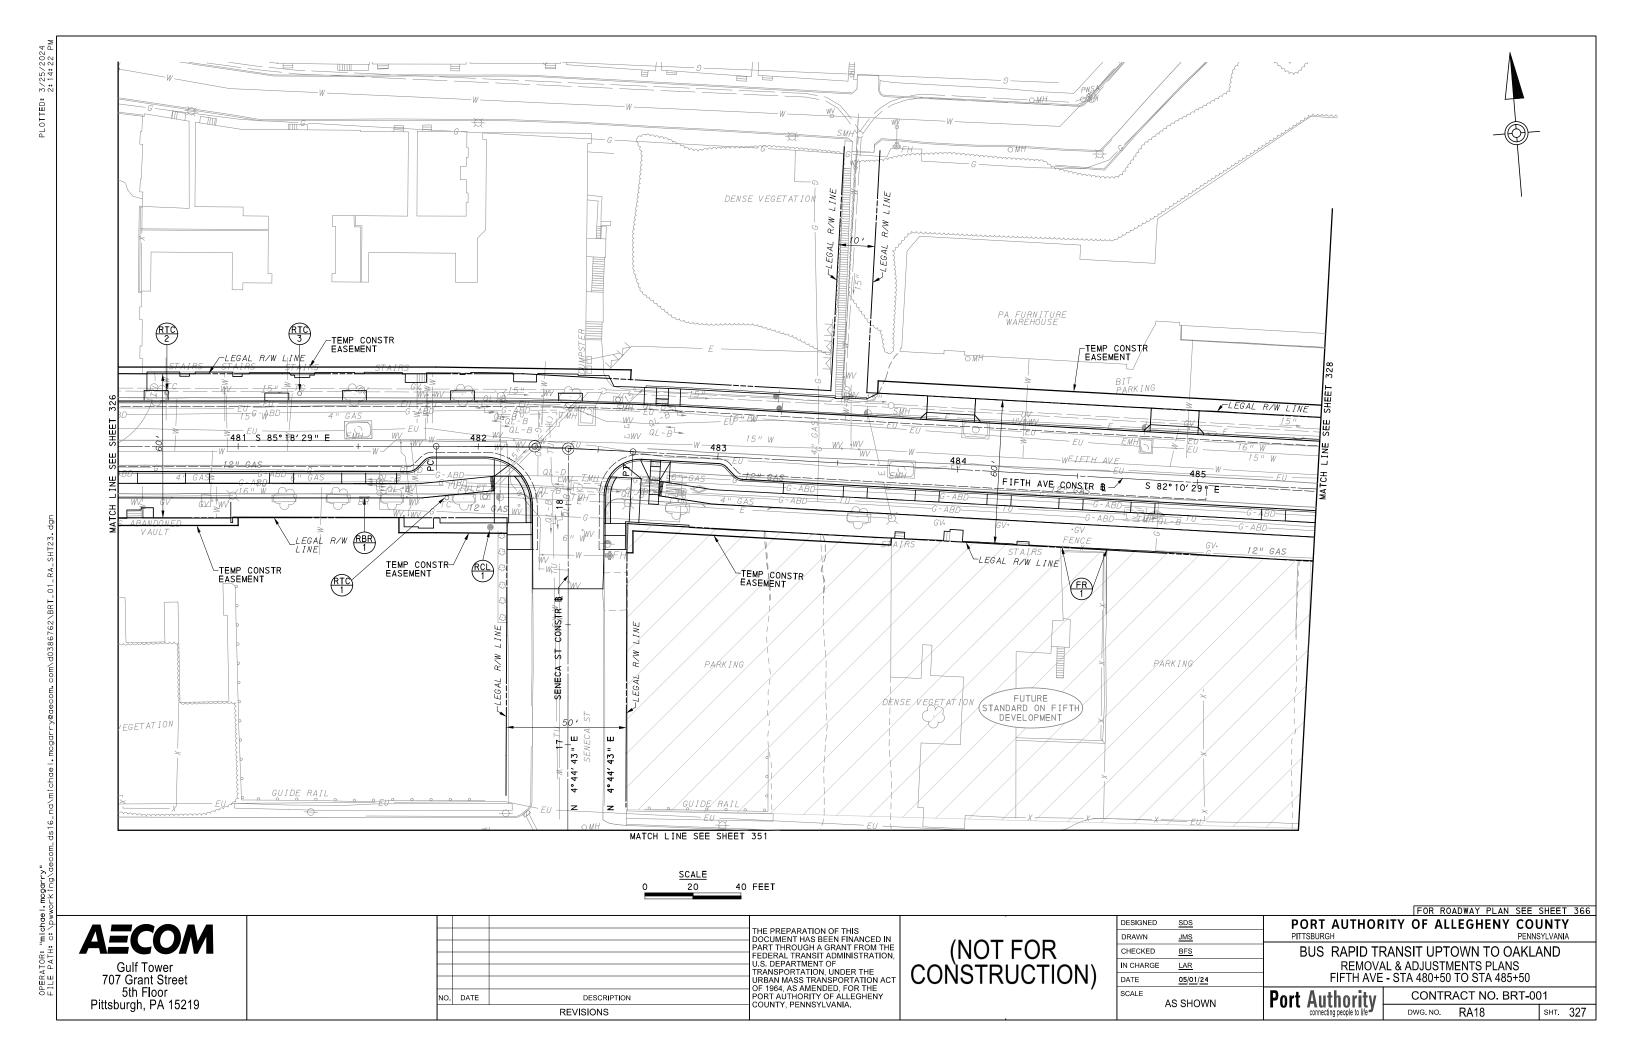


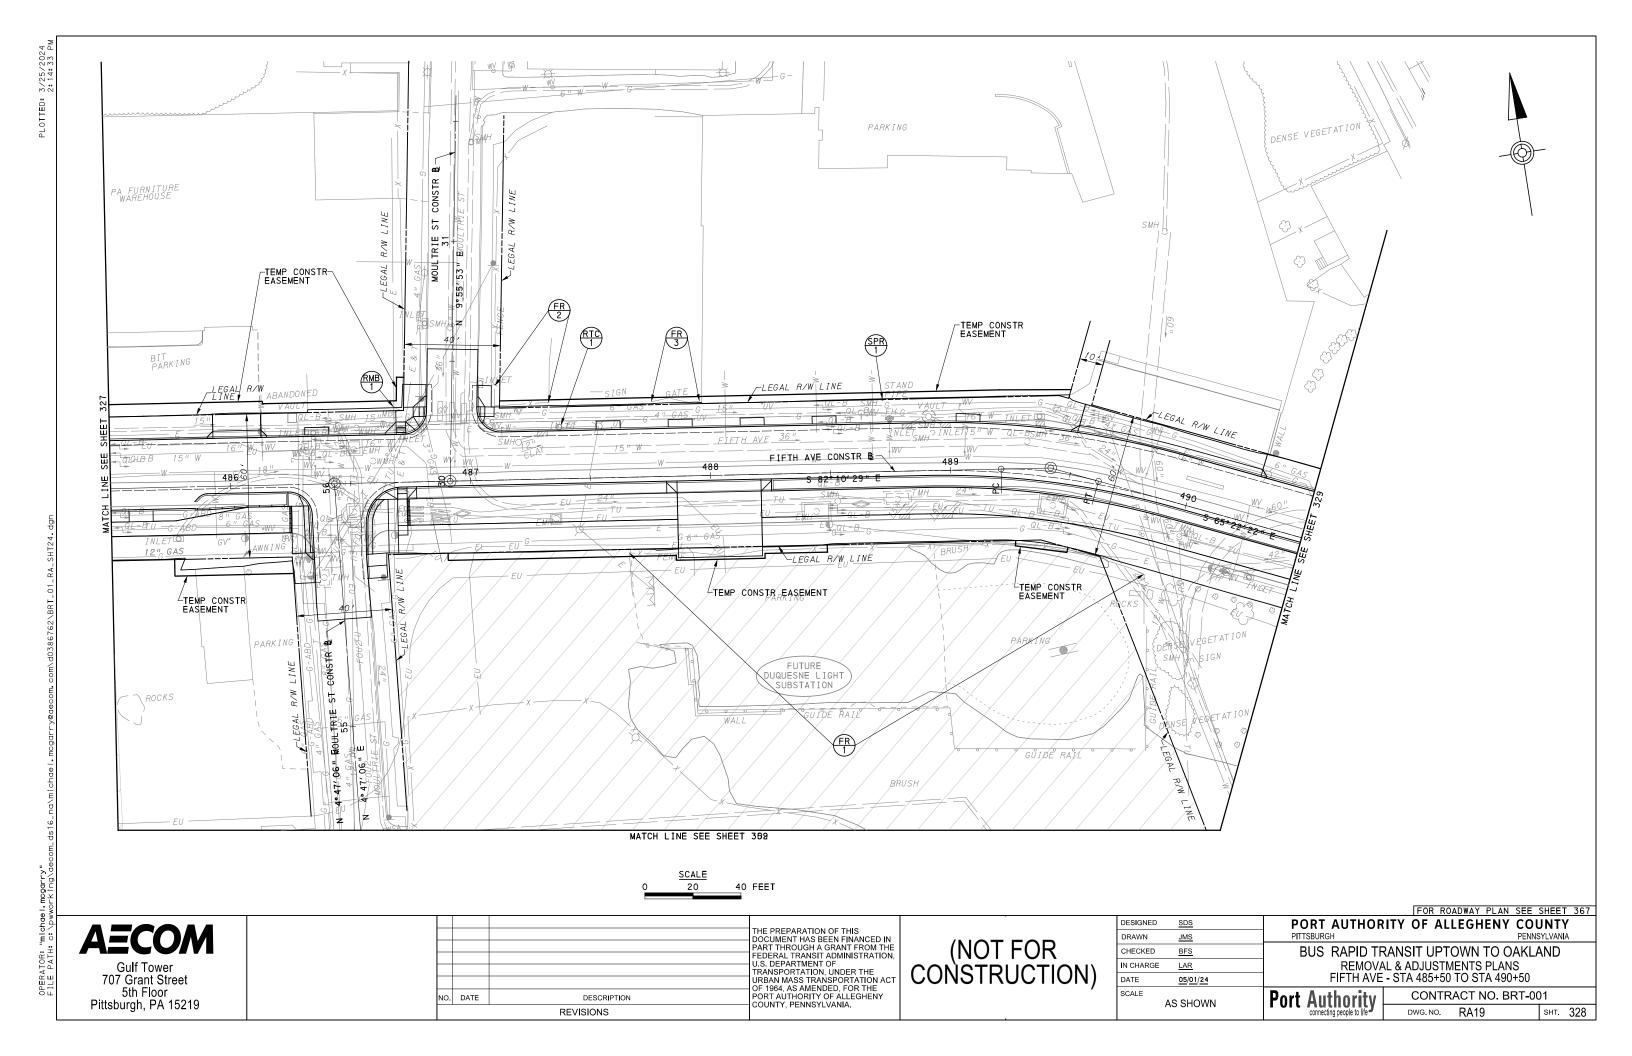


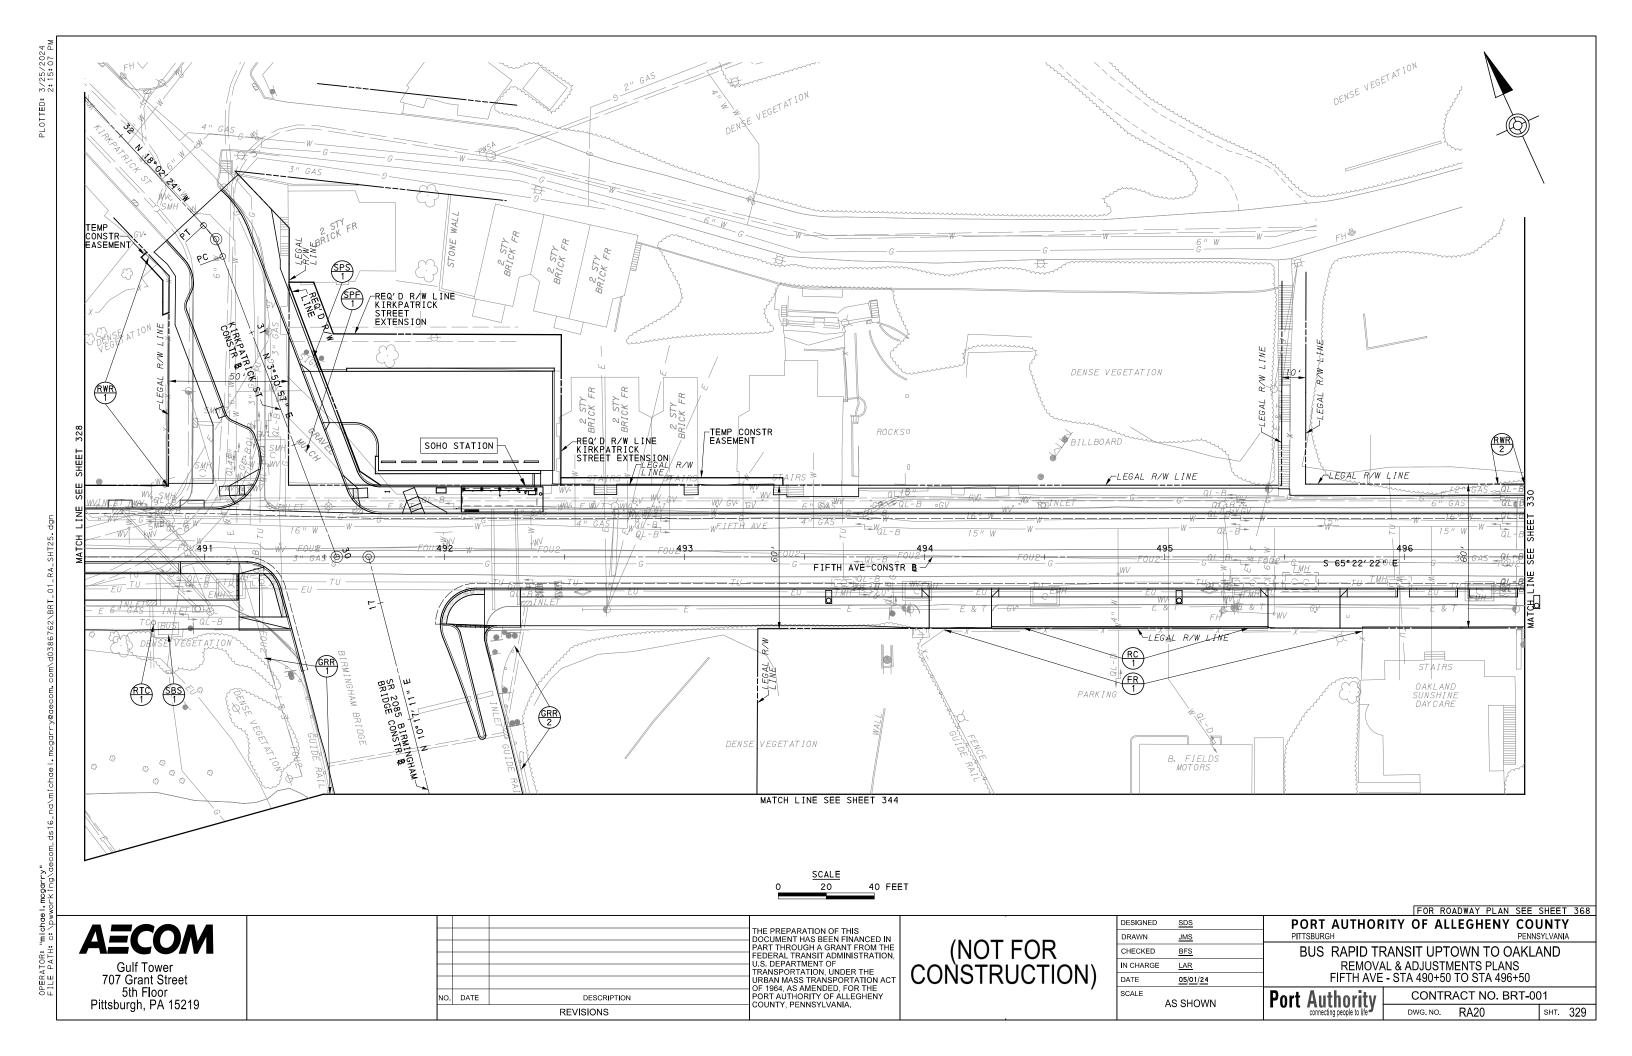


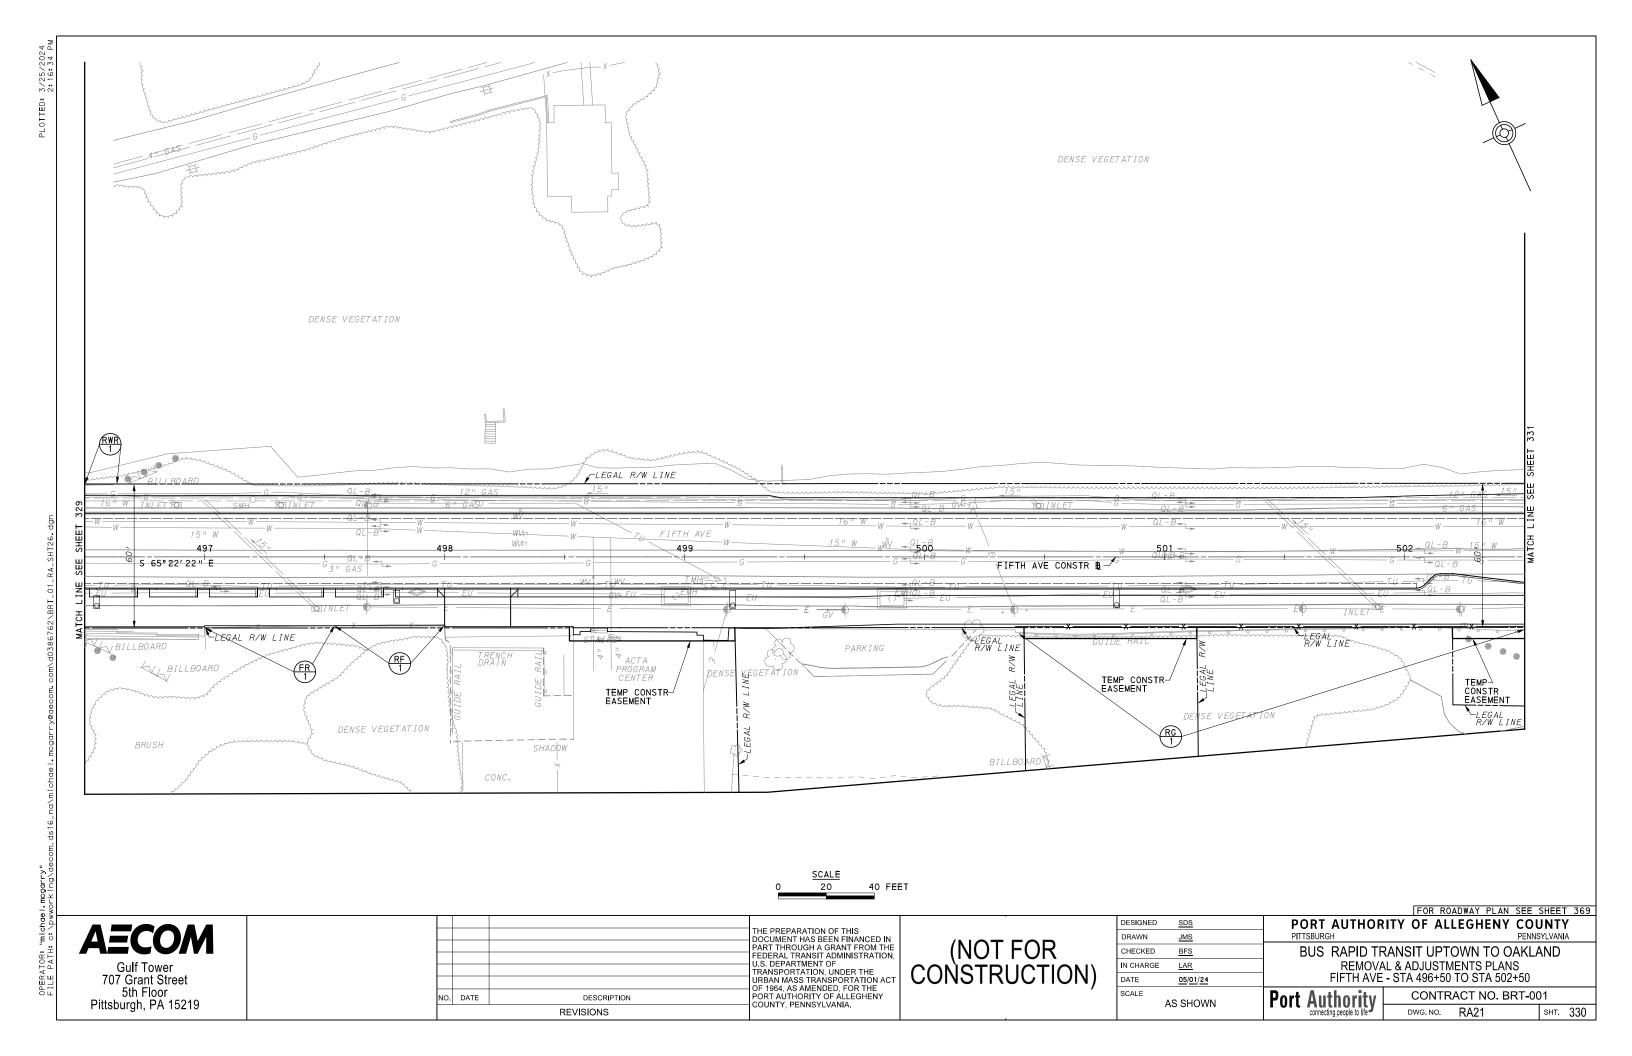


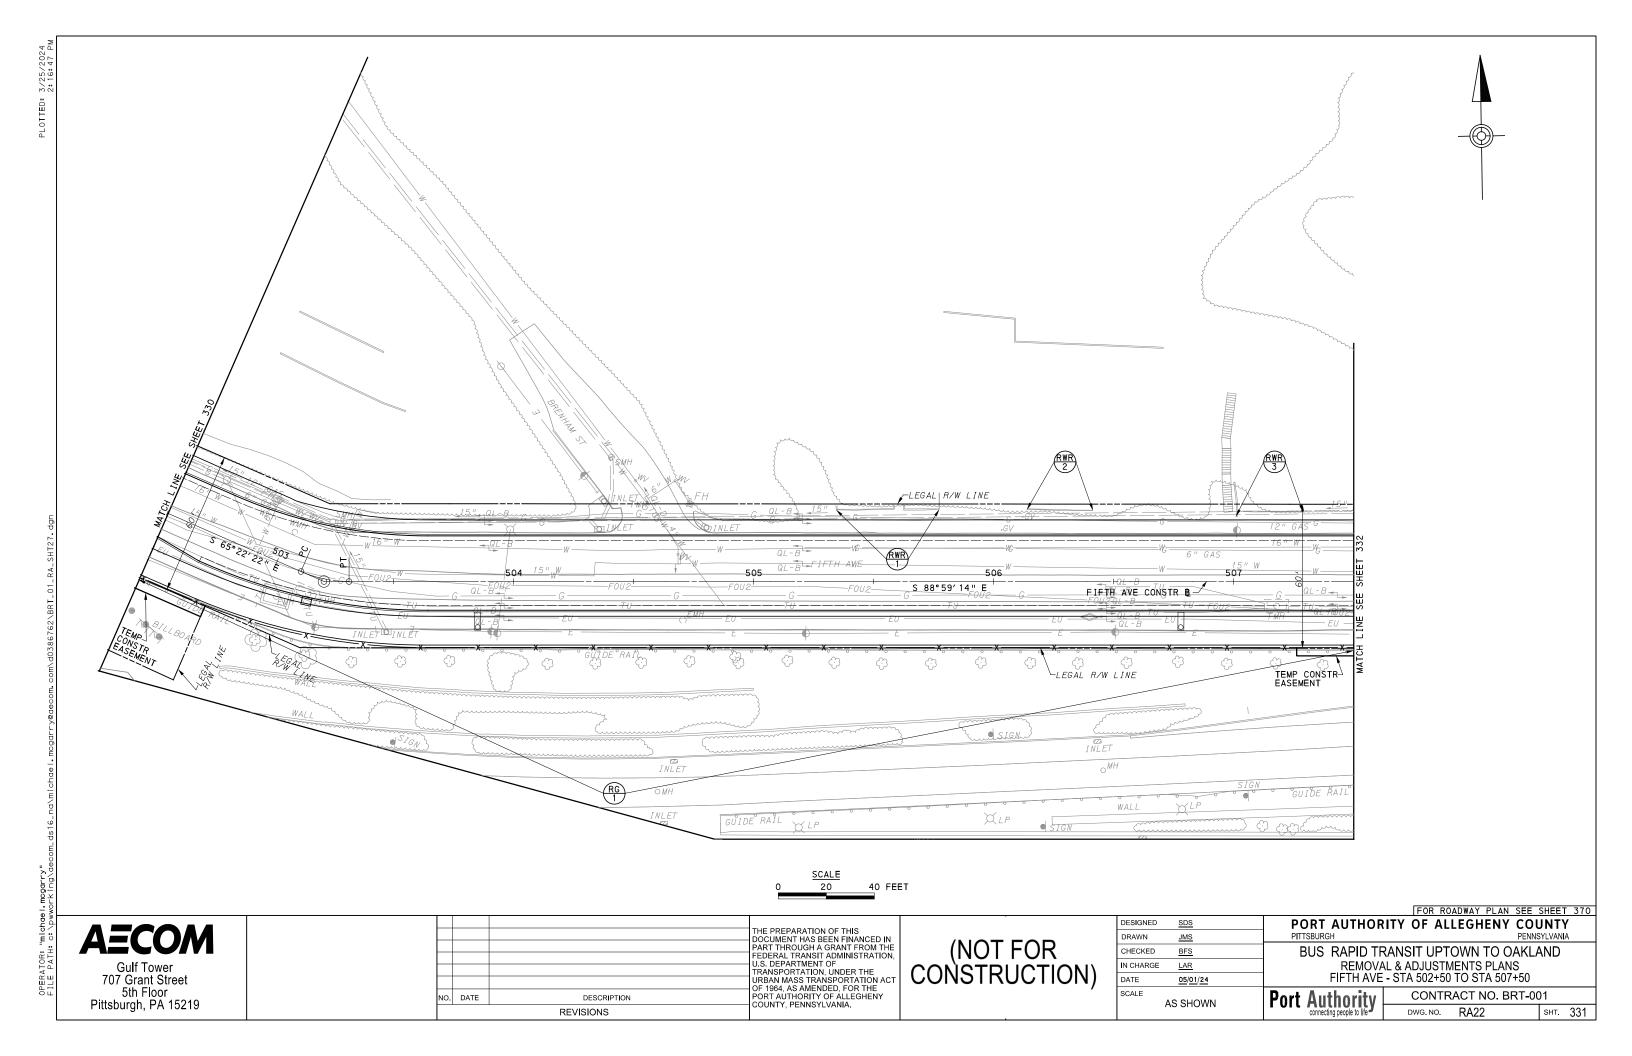


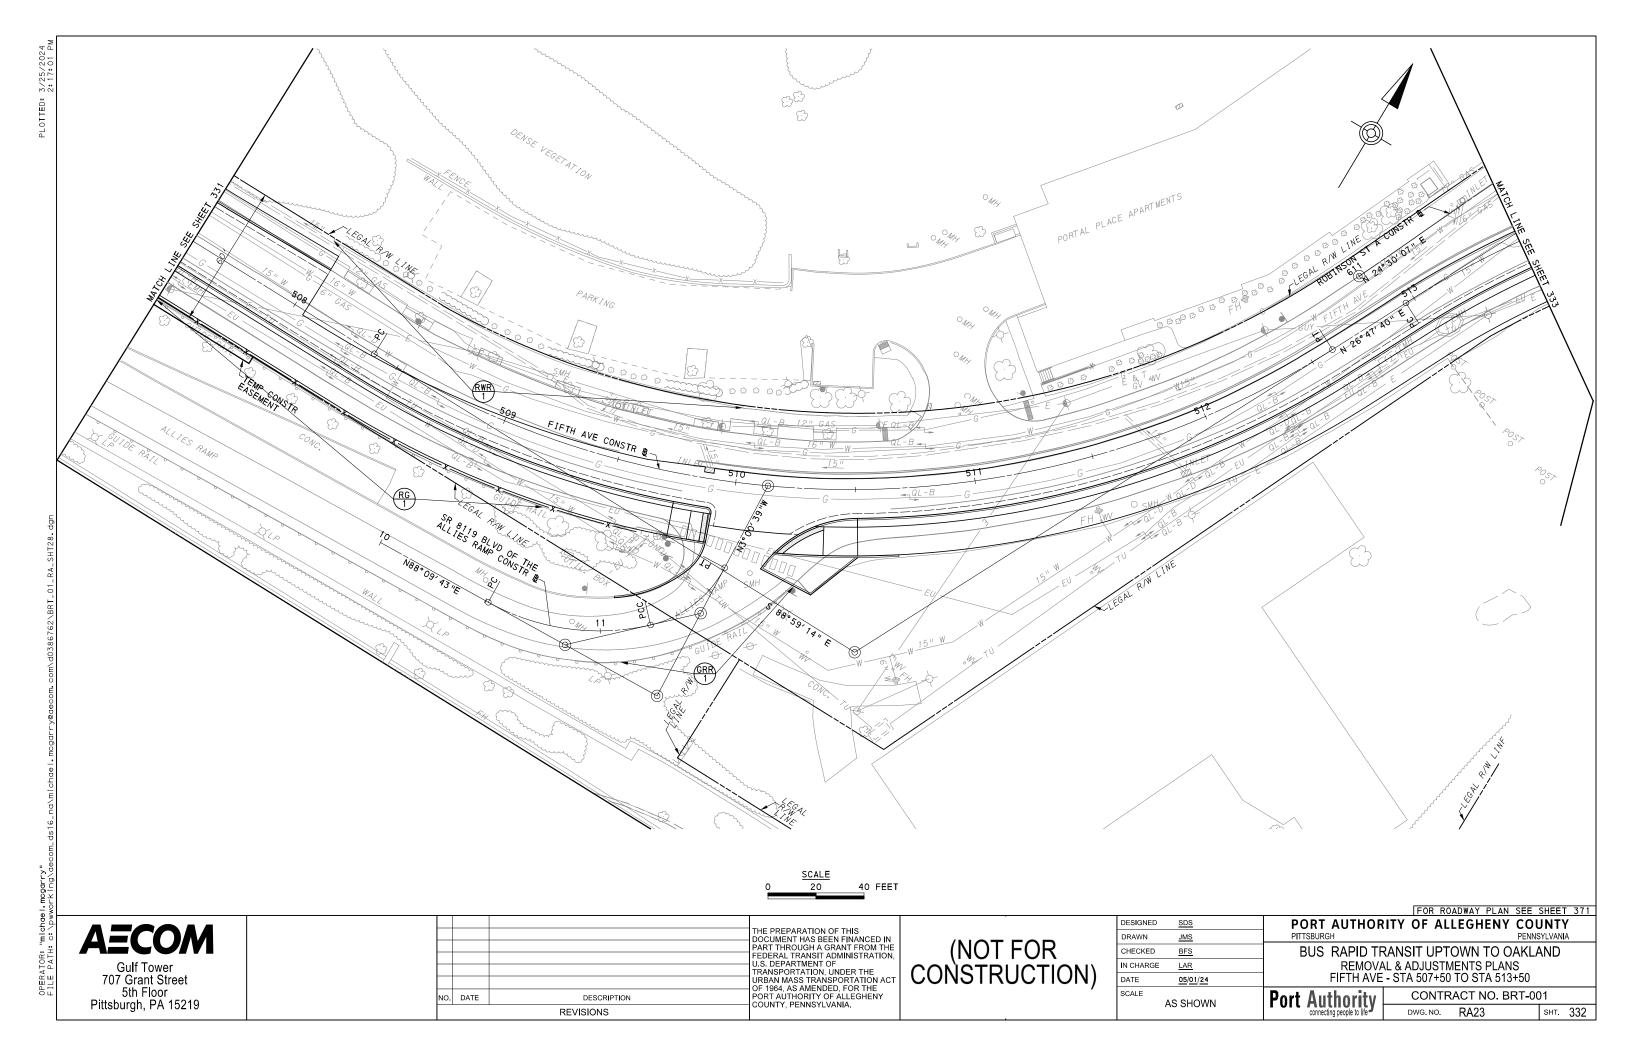


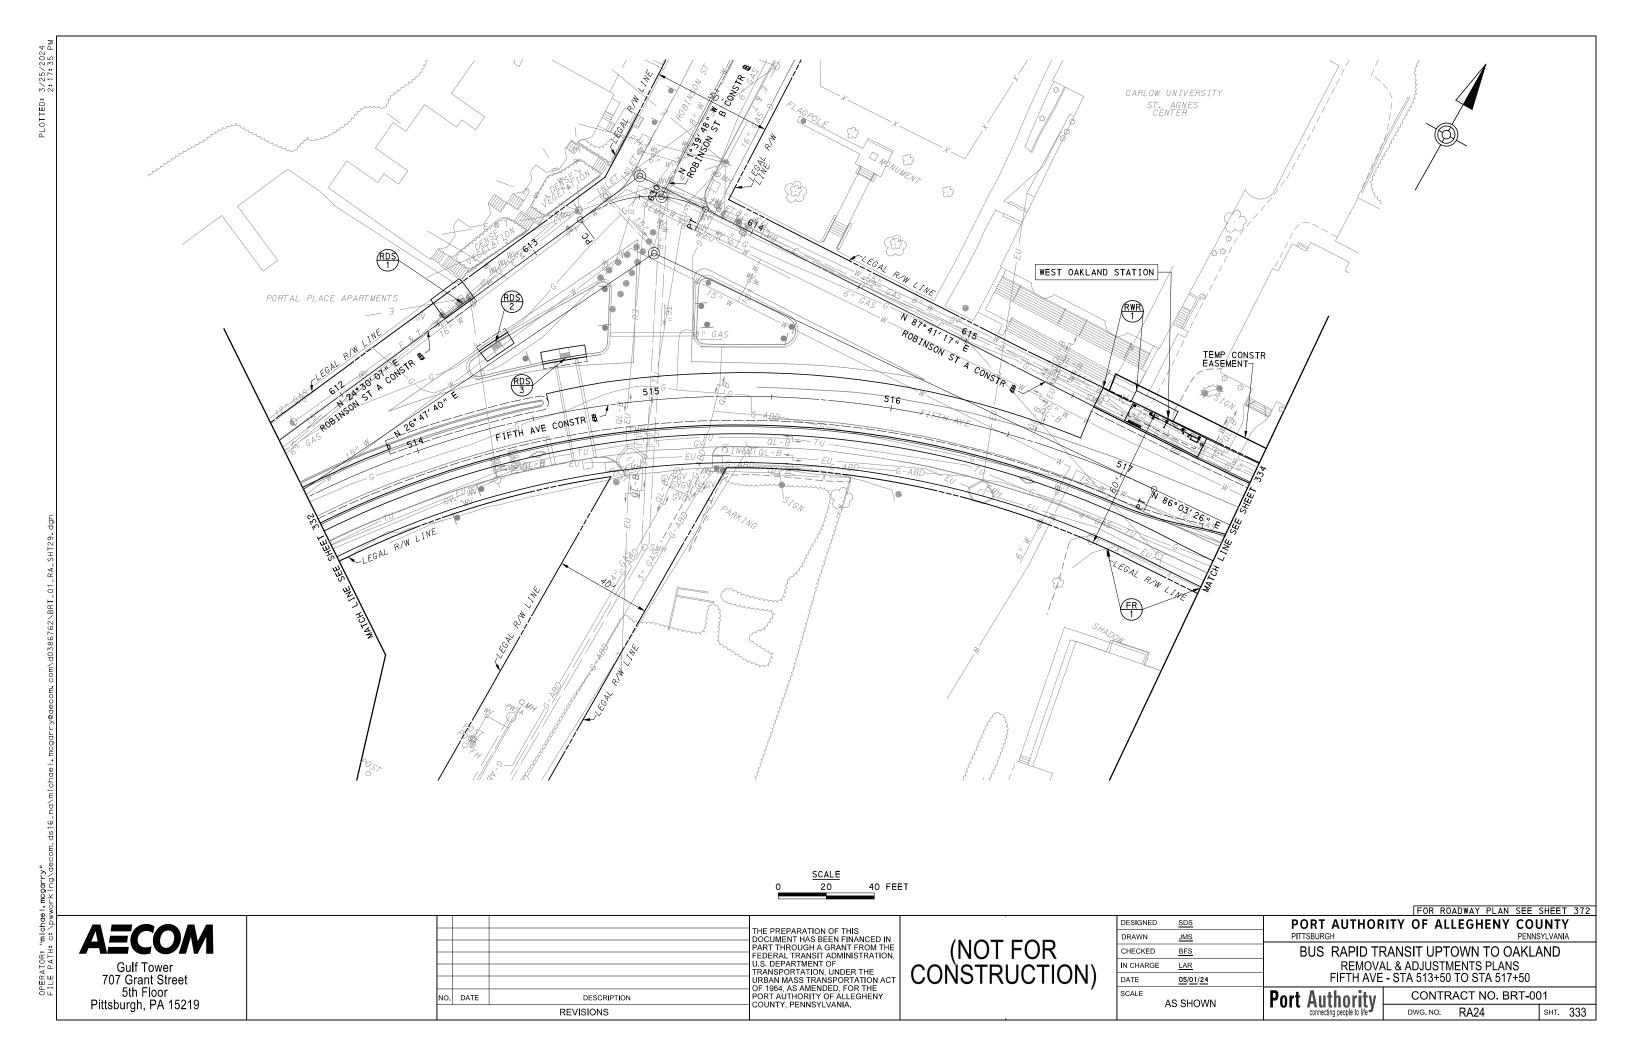


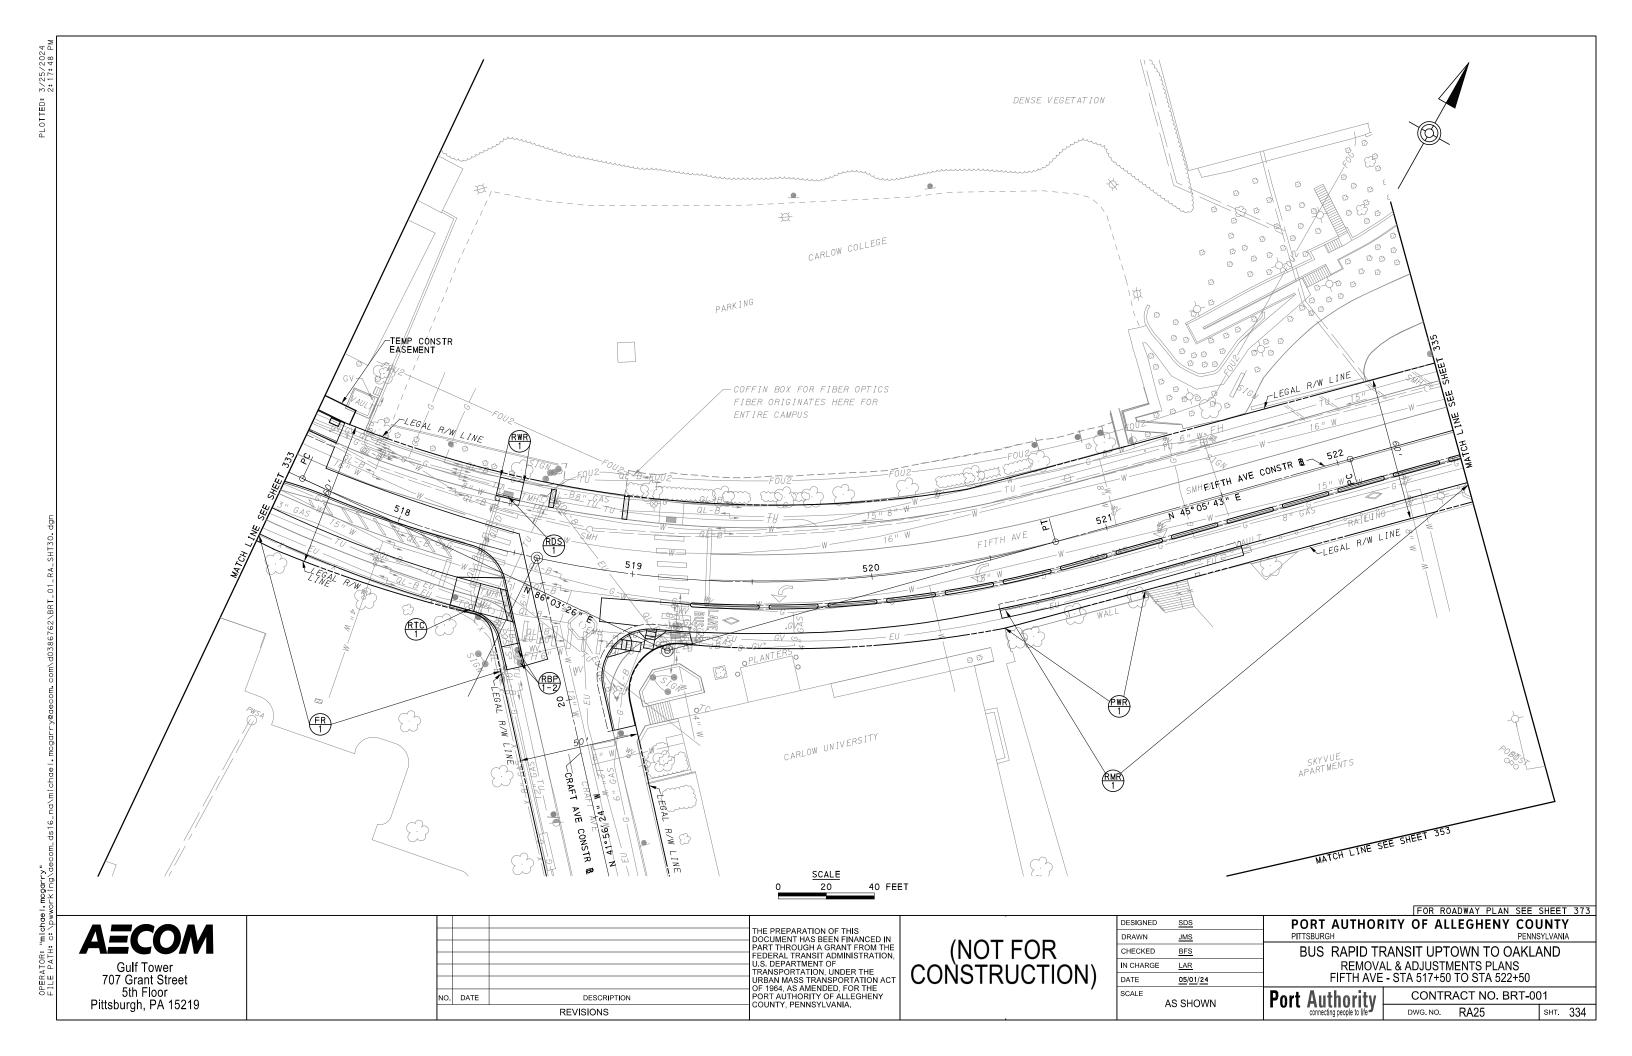


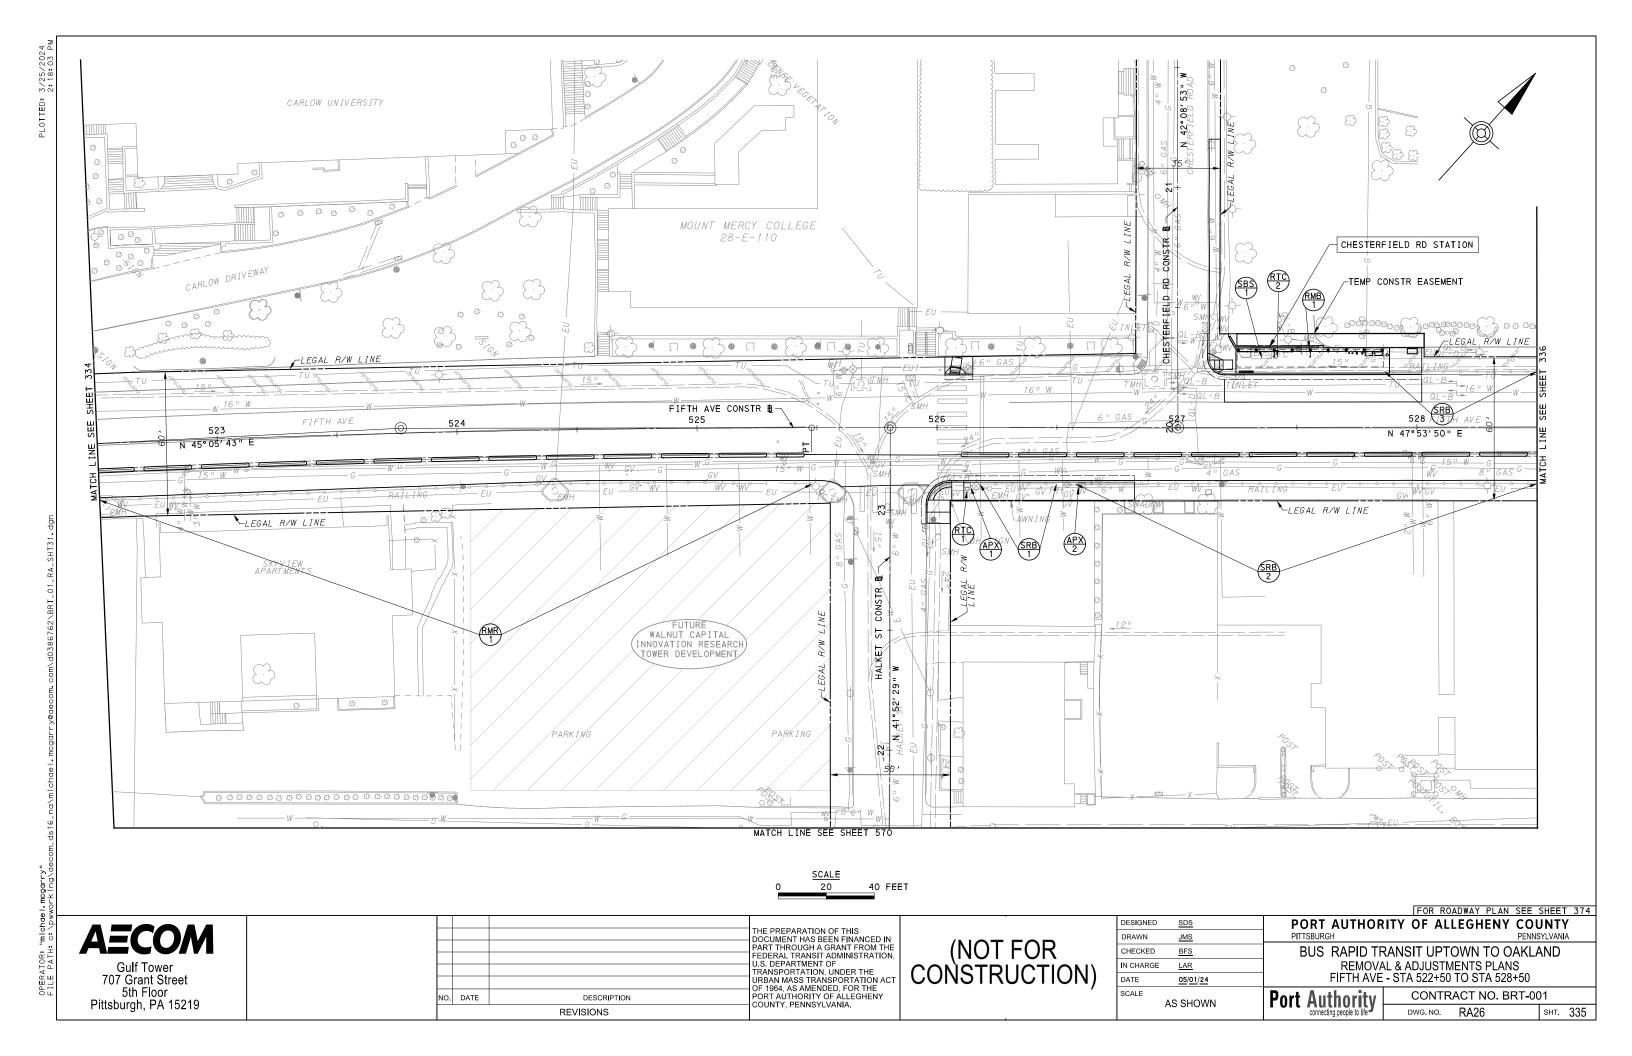


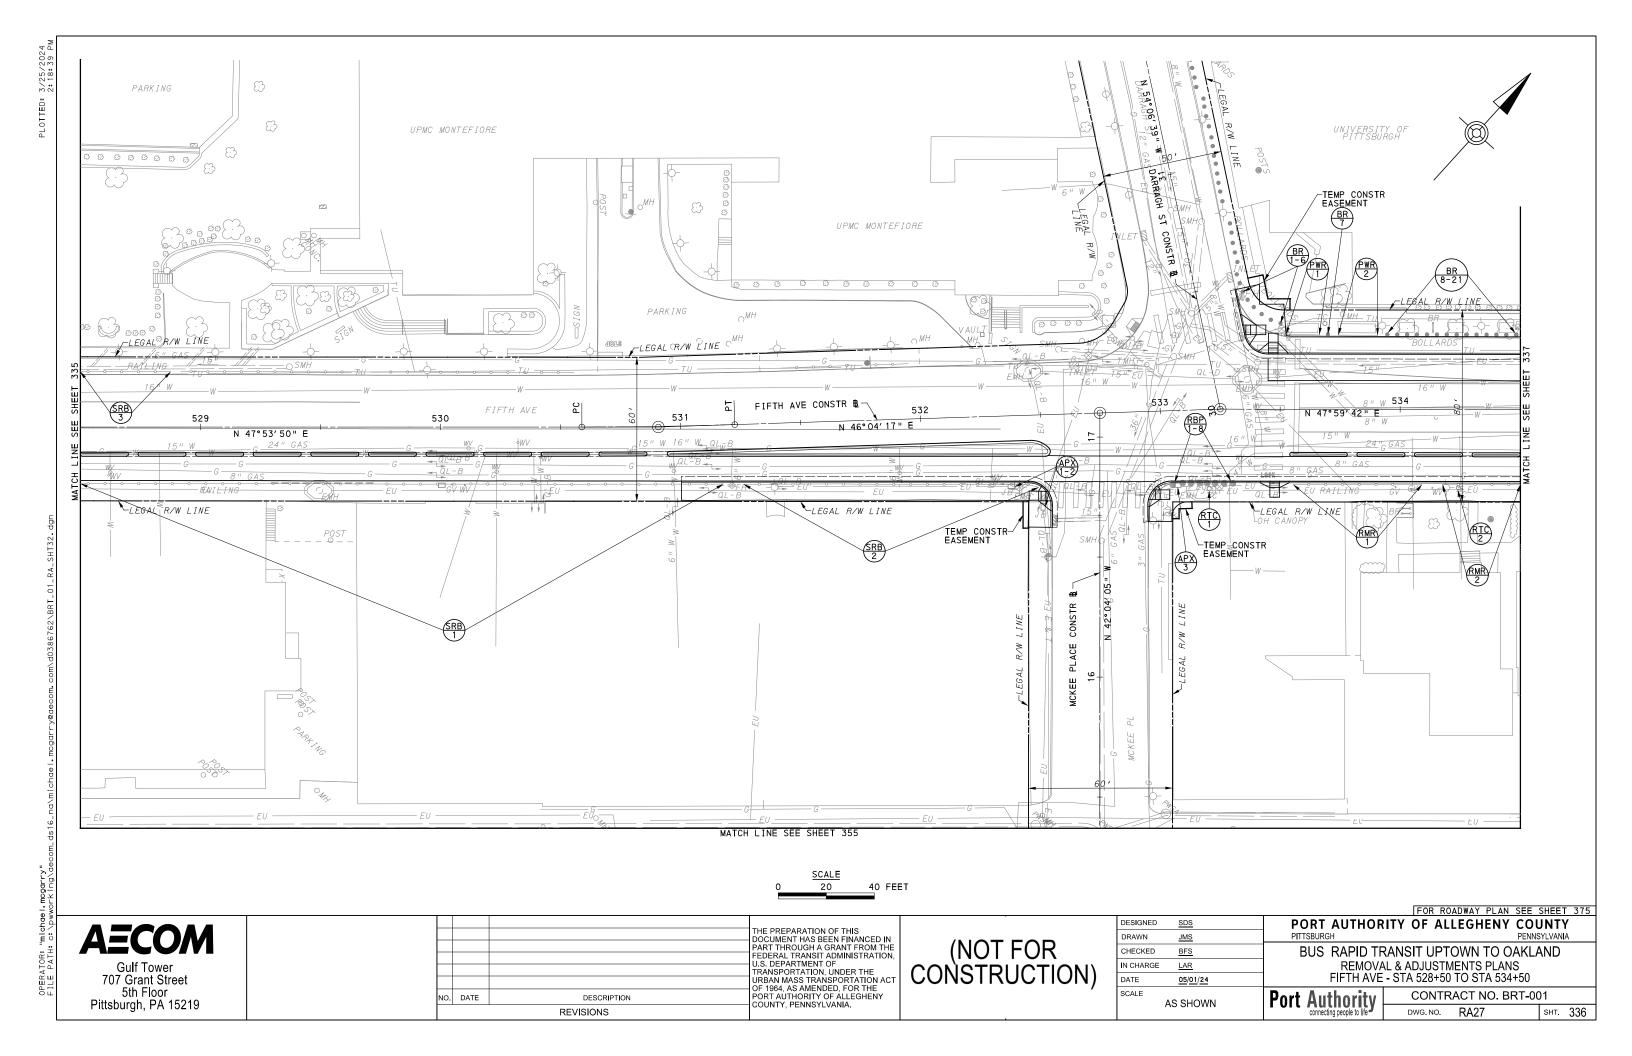

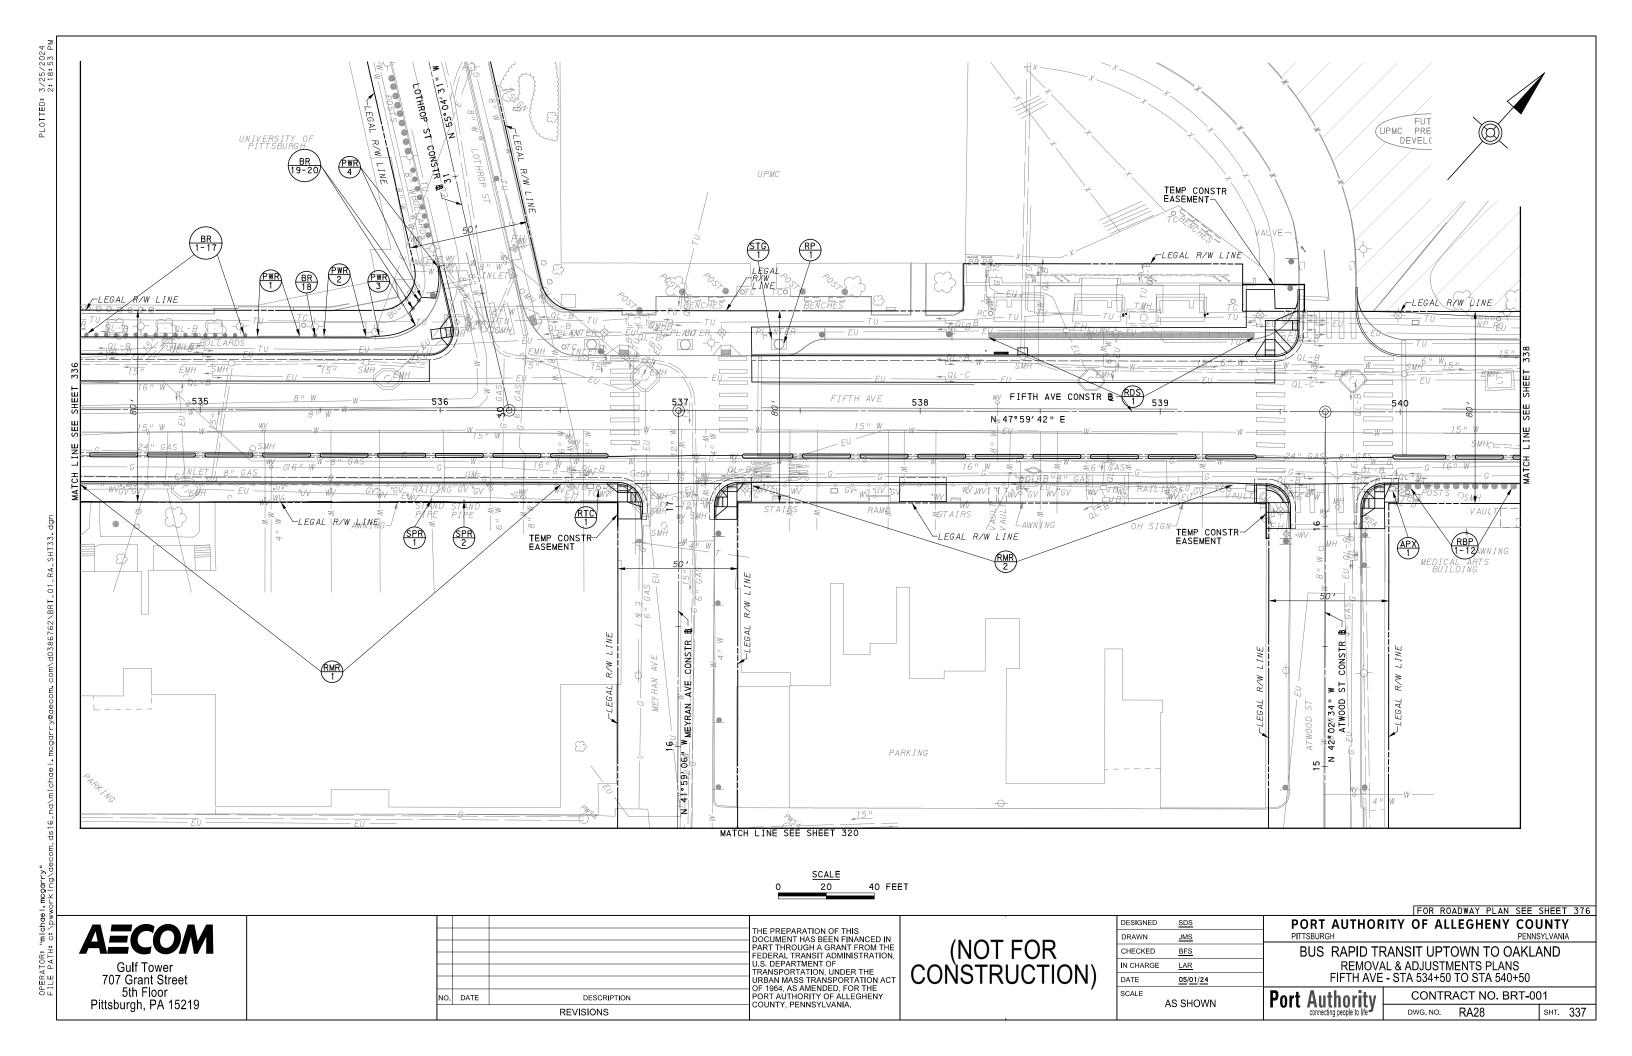

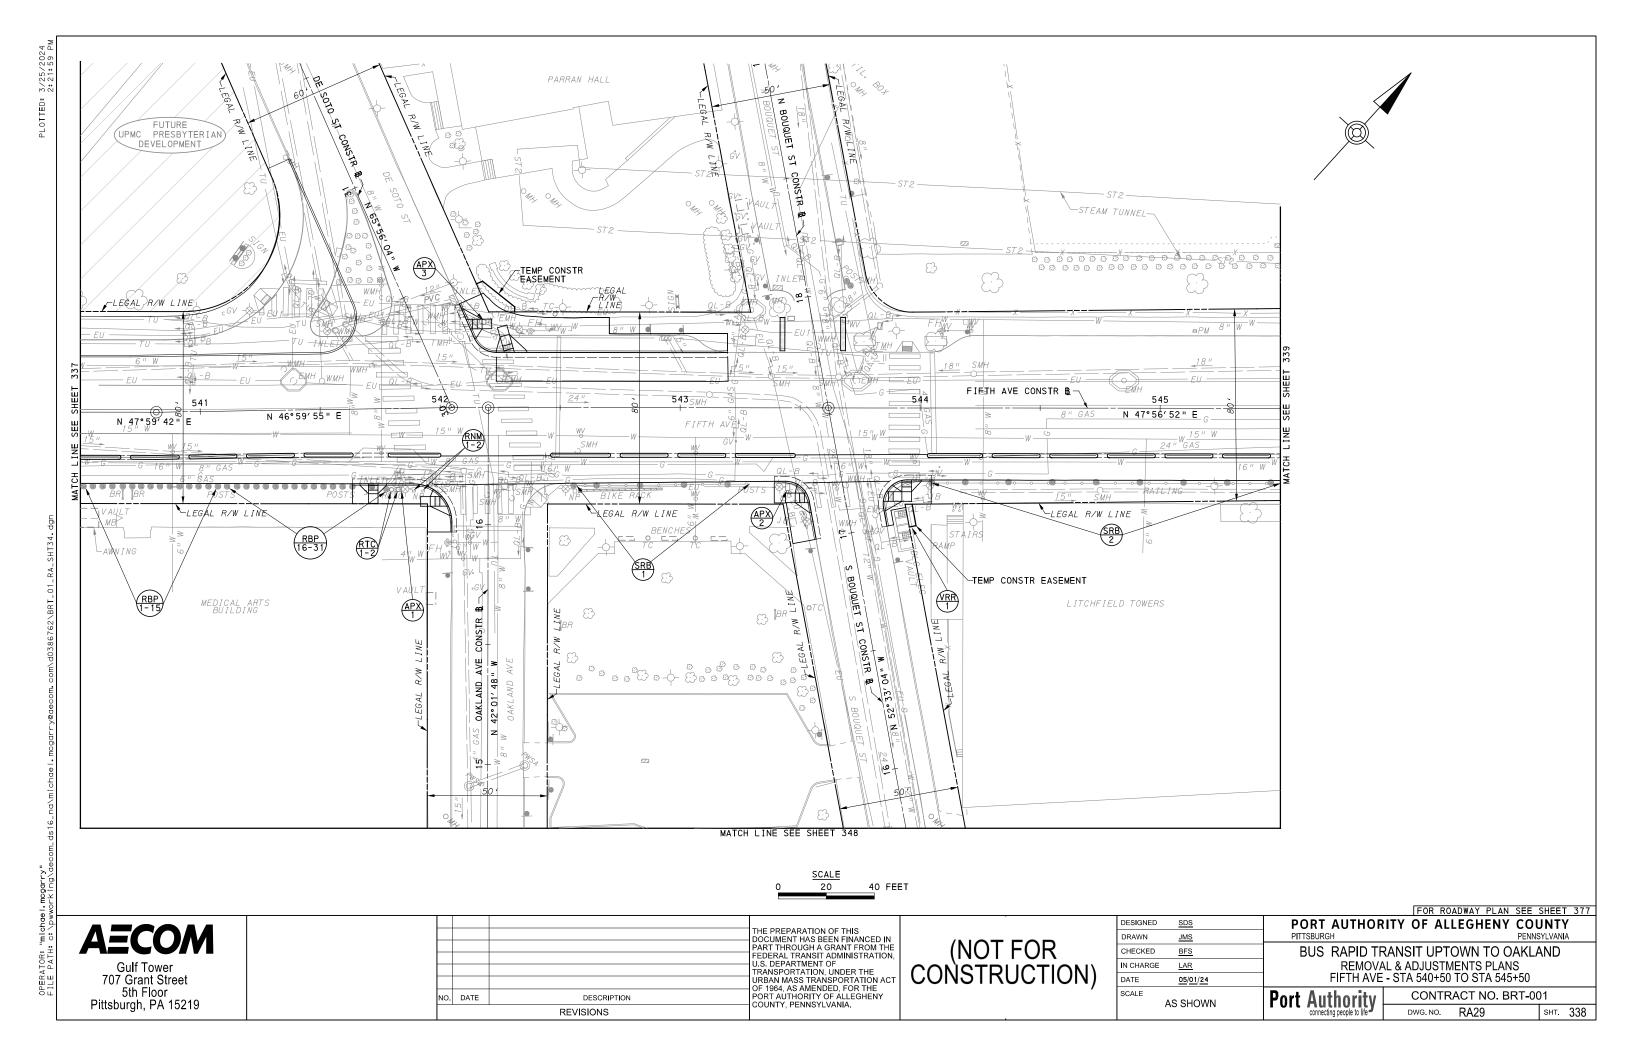

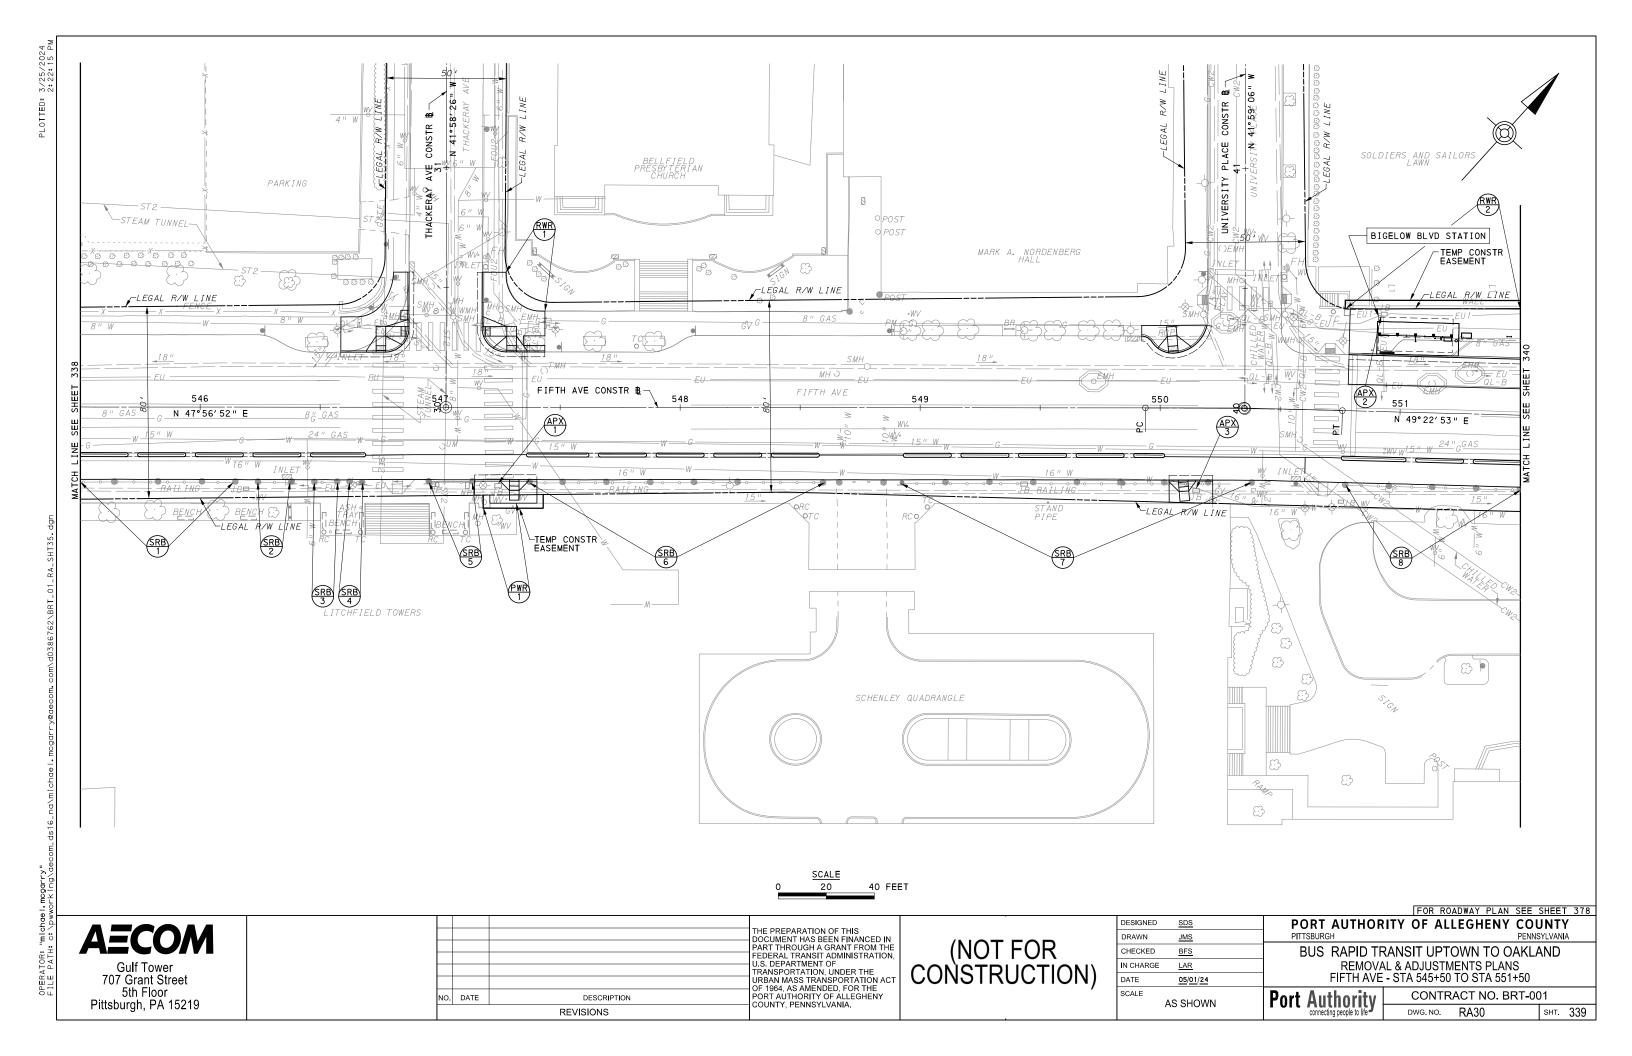

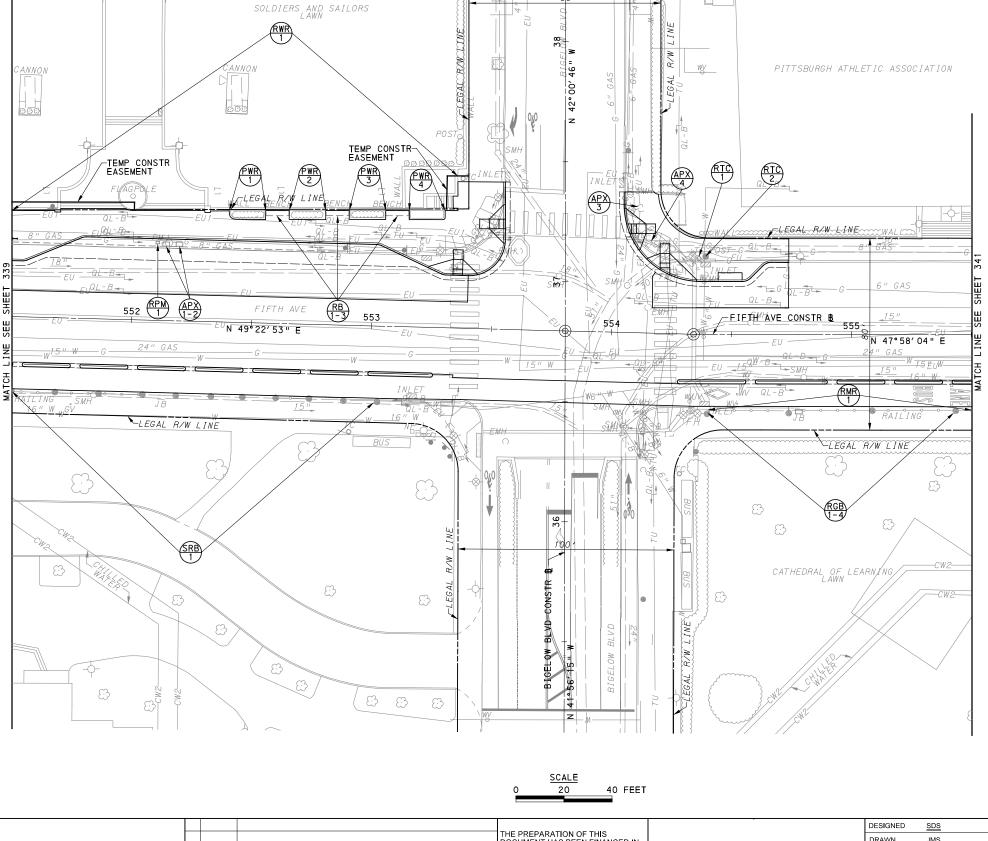

FOR ROADWAY PLAN SEE SHEET 379

**AECOM** 

Gulf Tower 707 Grant Street 5th Floor Pittsburgh, PA 15219 NO. DATE DESCRIPTION REVISIONS

THE PREPARATION OF THIS
DOCUMENT HAS BEEN FINANCED IN
PART THROUGH A GRANT FROM THE
FEDERAL TRANSIT ADMINISTRATION,
U.S. DEPARTMENT OF
TRANSPORTATION, UNDER THE
URBAN MASS TRANSPORTATION ACT
OF 1964, AS AMENDED, FOR THE
PORT AUTHORITY OF ALLEGHENY
COUNTY, PENNSYLVANIA.

(NOT FOR CONSTRUCTION)

DESIGNED	SDS	
DRAWN	<u>JMS</u>	
CHECKED	BFS	
IN CHARGE	LAR	
DATE	05/01/24	
SCALE		
	AS SHOWN	


PORT AUTHORITY OF ALLEGHENY COUNTY BUS RAPID TRANSIT UPTOWN TO OAKLAND


REMOVAL & ADJUSTMENTS PLANS FIFTH AVE - STA 551+50 TO STA 555+50


Port Authority connecting people to life

CONTRACT NO. BRT-001


DWG. NO. RA31 sнт. 340

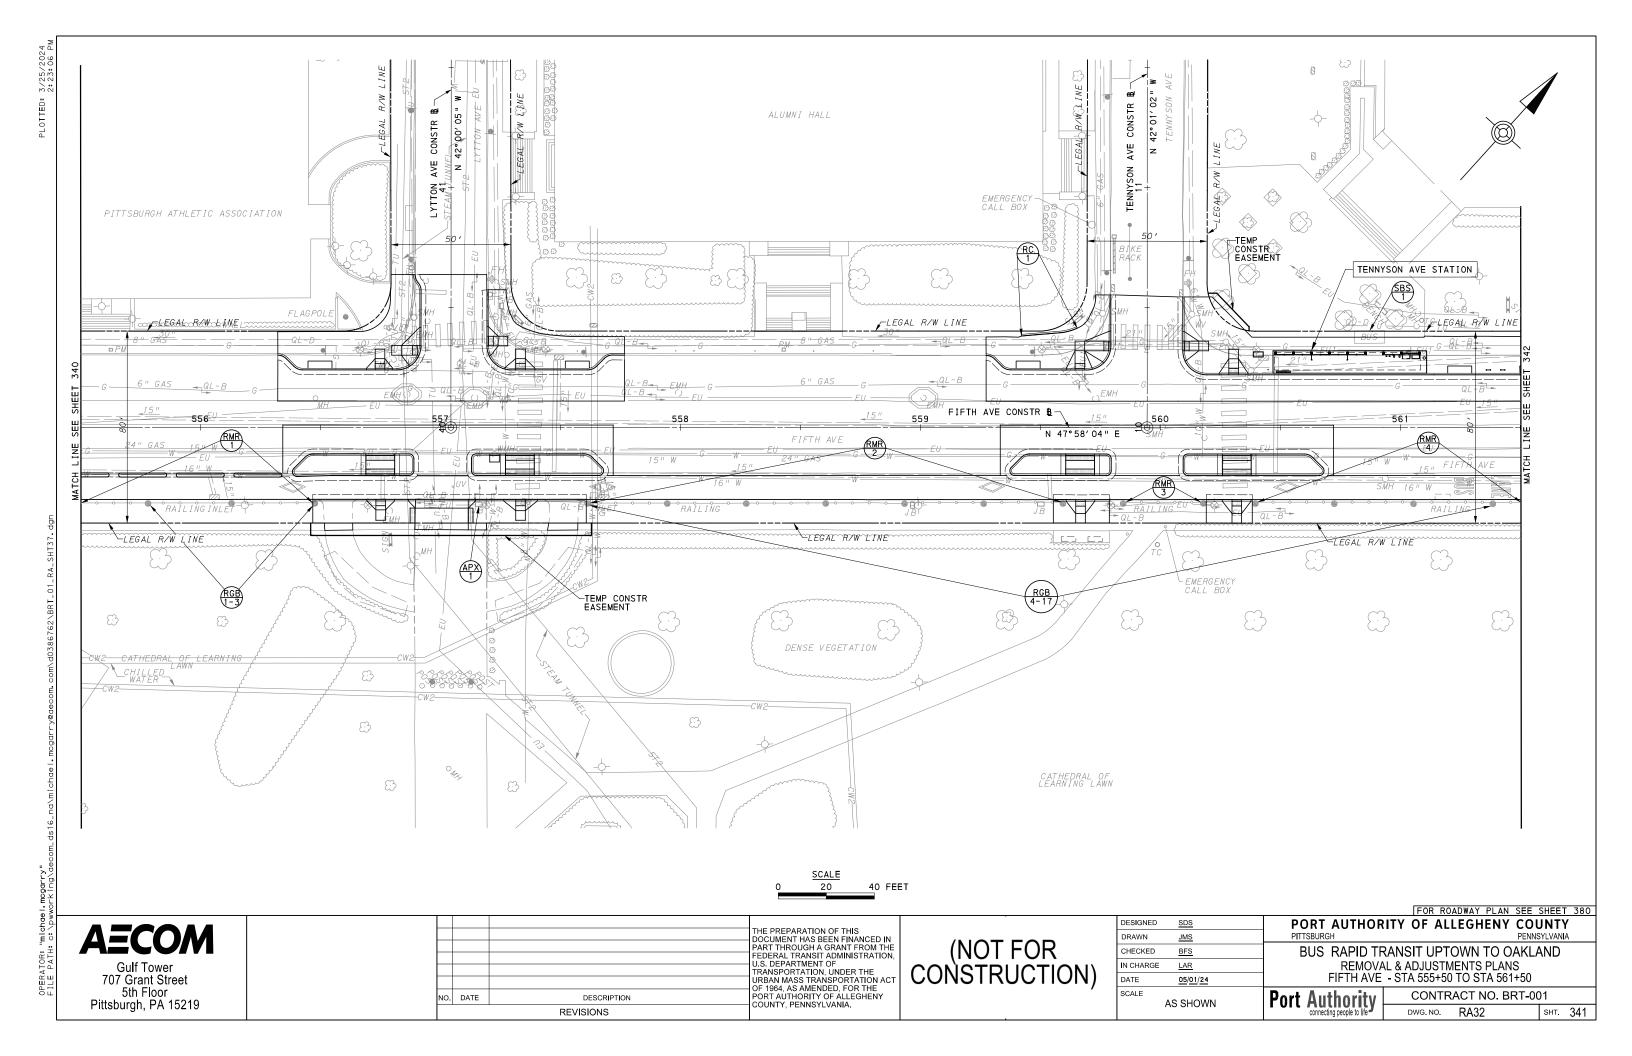

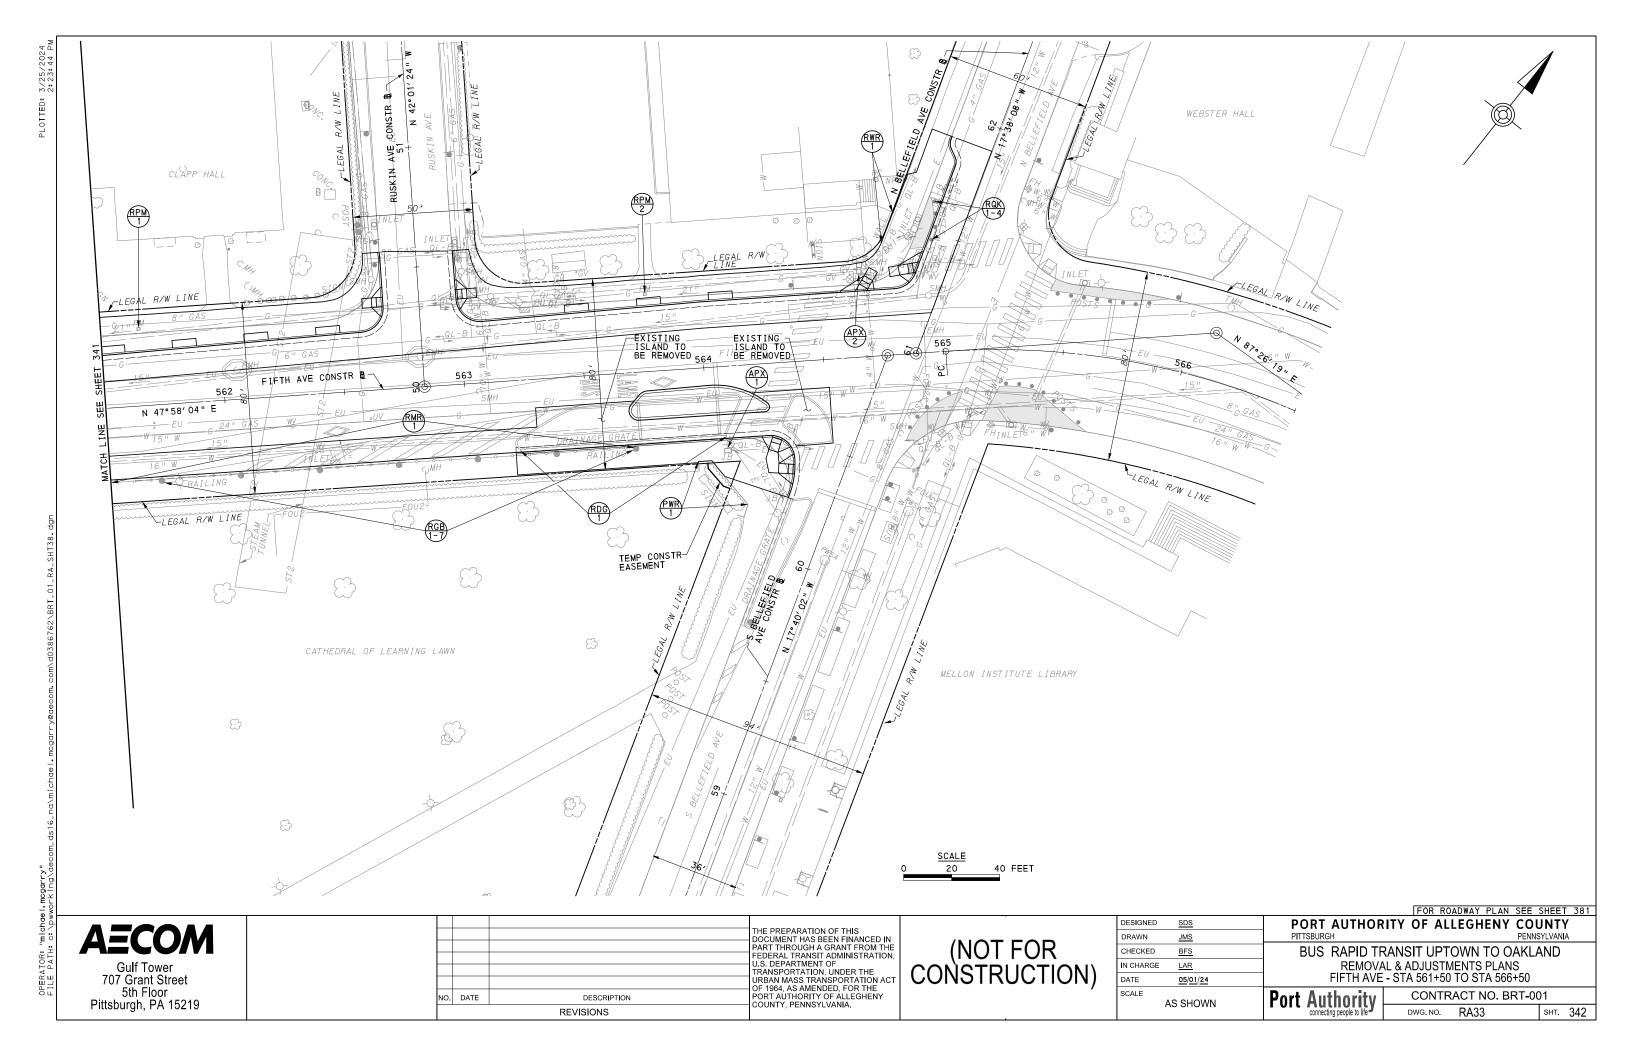

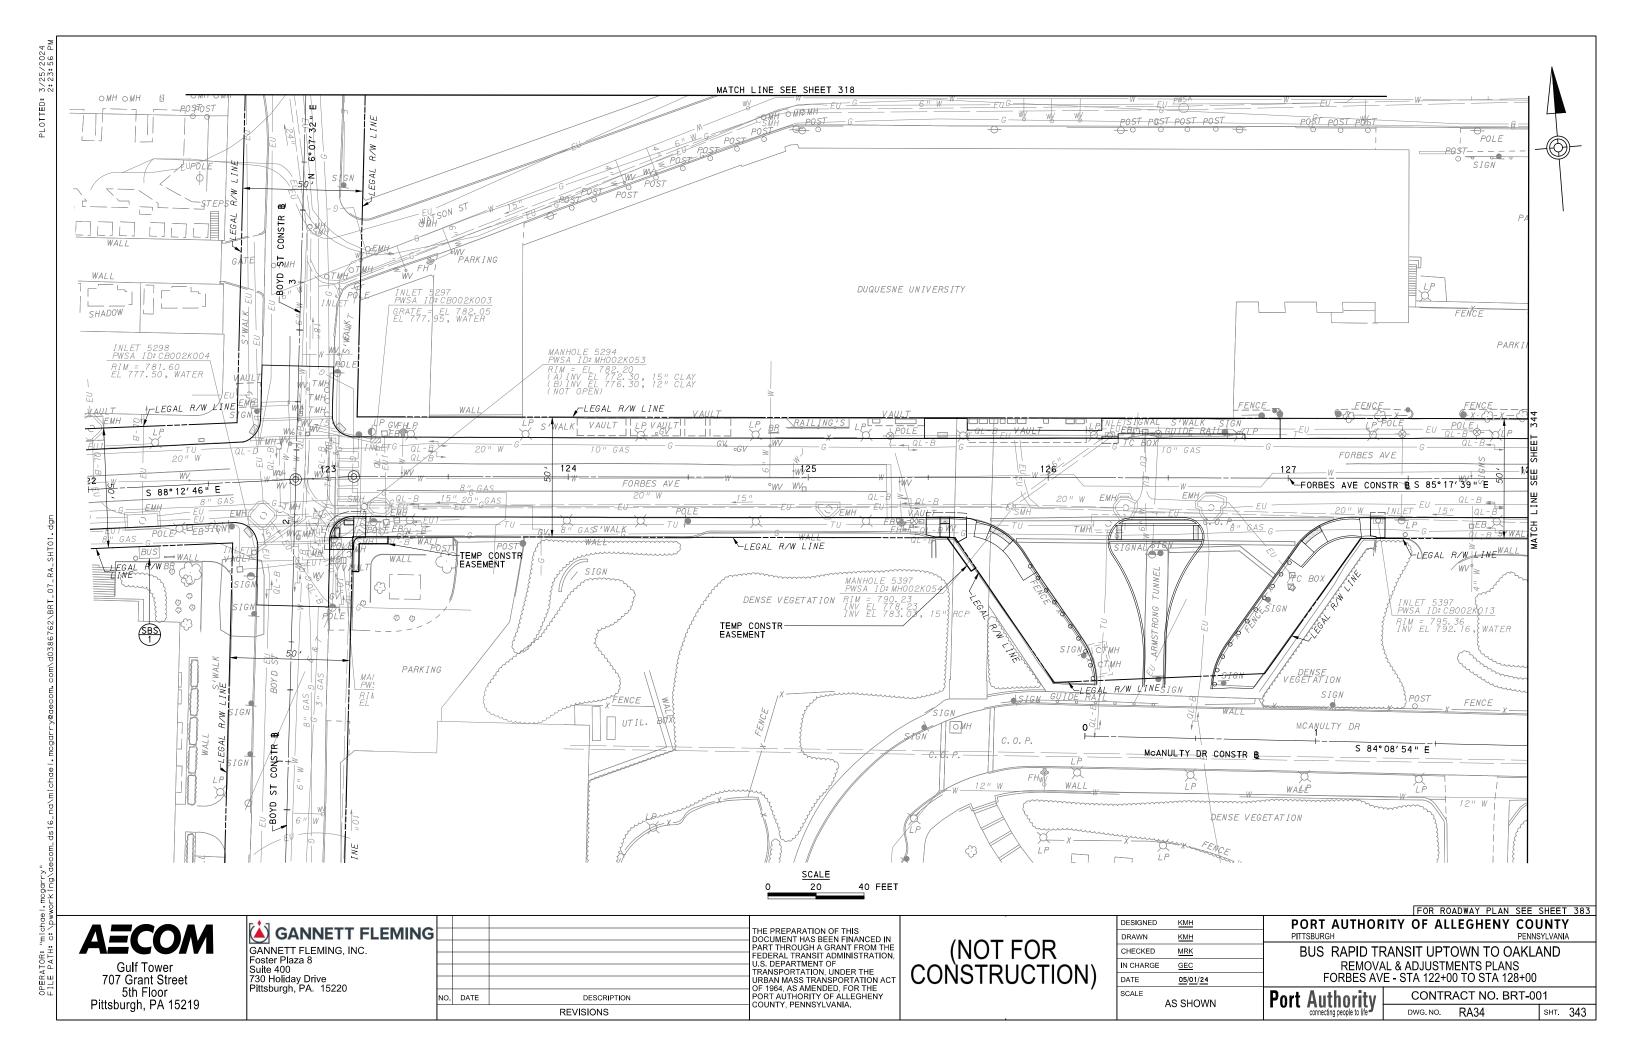



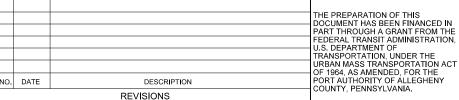


(NOT FOR CONSTRUCTION)

DESIGNED	<u>KMH</u>	
DRAWN	<u>KMH</u>	
CHECKED	MRK	
IN CHARGE	<u>GEC</u>	
DATE	05/01/24	
SCALE		П
	AS SHOWN	

## FOR ROADWAY PLAN SEE SHEET 384 PORT AUTHORITY OF ALLEGHENY COUNTY BUS RAPID TRANSIT UPTOWN TO OAKLAND


REMOVAL & ADJUSTMENTS PLANS FORBES AVE - STA 128+00 TO STA 133+50

CONTRACT NO. BRT-001 **Port Authority** DWG. NO. RA35 sнт. 344

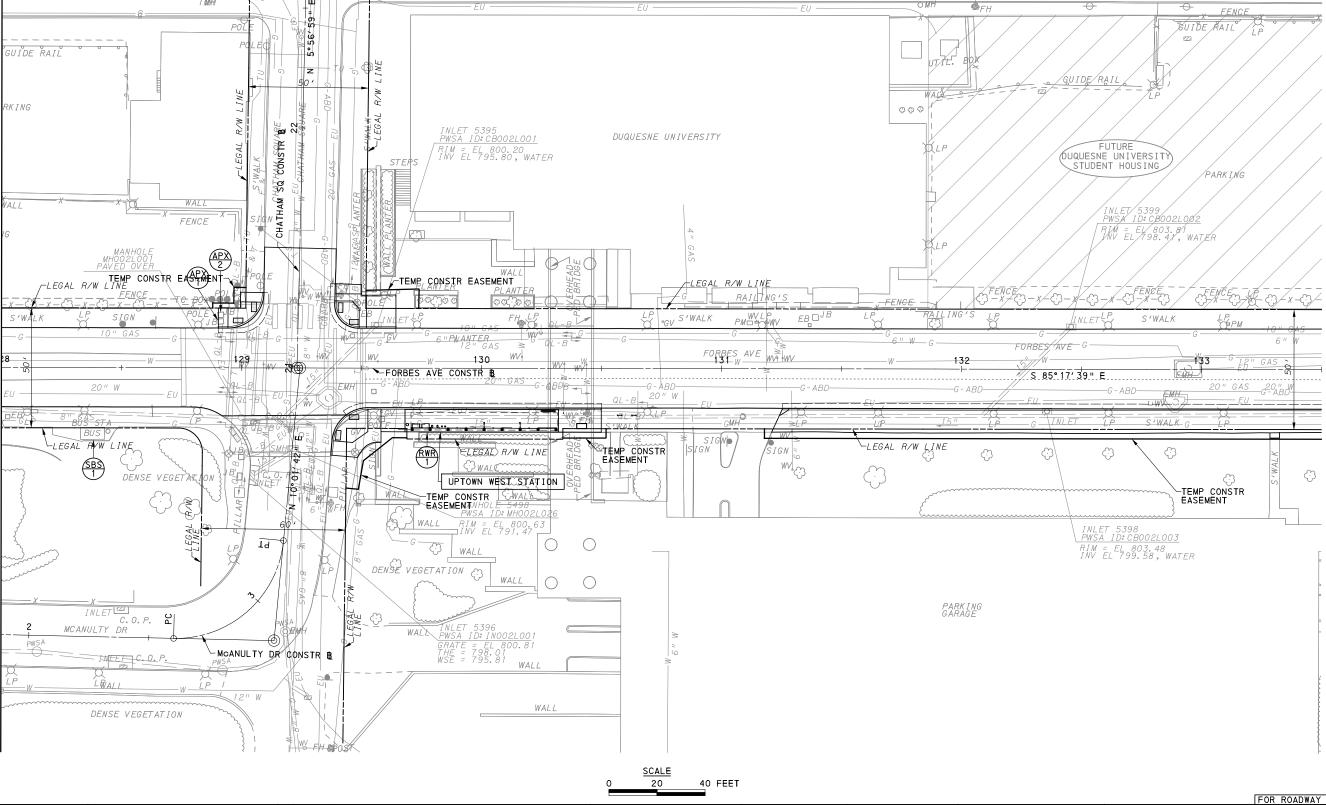

MATCH LINE SEE SHEET 319

**Gulf Tower** 707 Grant Street 5th Floor Pittsburgh, PA 15219 GANNETT FLEMING

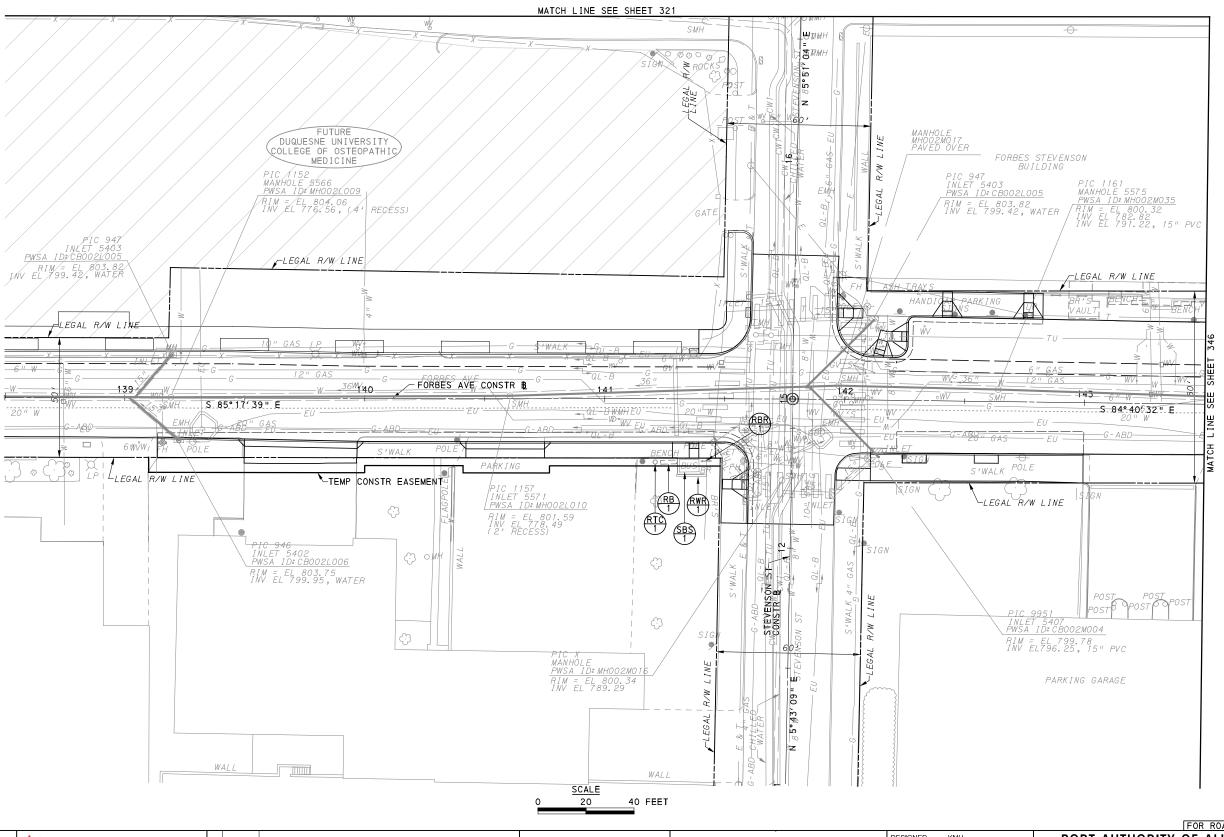



Gulf Tower 707 Grant Street 5th Floor Pittsburgh, PA 15219 GANNETT FLEMING
GANNETT FLEMING, INC.

NO. DATE

GANNETT FLEMING, INC. Foster Plaza 8 Suite 400 730 Holiday Drive Pittsburgh, PA. 15220 THE PREPARATION OF THIS
DOCUMENT HAS BEEN FINANCED IN
PART THROUGH A GRANT FROM THE
FEDERAL TRANSIT ADMINISTRATION,
U.S. DEPARTMENT OF
TRANSPORTATION, UNDER THE
URBAN MASS TRANSPORTATION ACT
OF 1964, AS AMENDED, FOR THE
DESCRIPTION
REVISIONS
THE PREPARATION OF THIS
FEDERAL TRANSIT ADMINISTRATION, U.S. DEPARTMENT OF TRANSPORTATION ACT
OF 1704 AS AMENDED, FOR THE
COUNTY, PENNSYLVANIA.

(NOT FOR CONSTRUCTION)

DESIGNED	<u>KMH</u>	
DRAWN	<u>KMH</u>	L
CHECKED	MRK	ı
IN CHARGE	GEC	ı
DATE	05/01/24	l
SCALE		Ī
	AS SHOWN	ì

FOR ROADWAY PLAN SEE SHEET 386

PORT AUTHORITY OF ALLEGHENY COUNTY
PITTSBURGH
PENNSYLVANIA


PLIC DADID TRANSIT LIDTOWN TO OAKLAND

BUS RAPID TRANSIT UPTOWN TO OAKLAND REMOVAL & ADJUSTMENTS PLANS FORBES AVE - STA 138+50 TO STA 143+50

Port Authority CO

CONTRACT NO. BRT-001

DWG. NO. RA36 SHT. 345

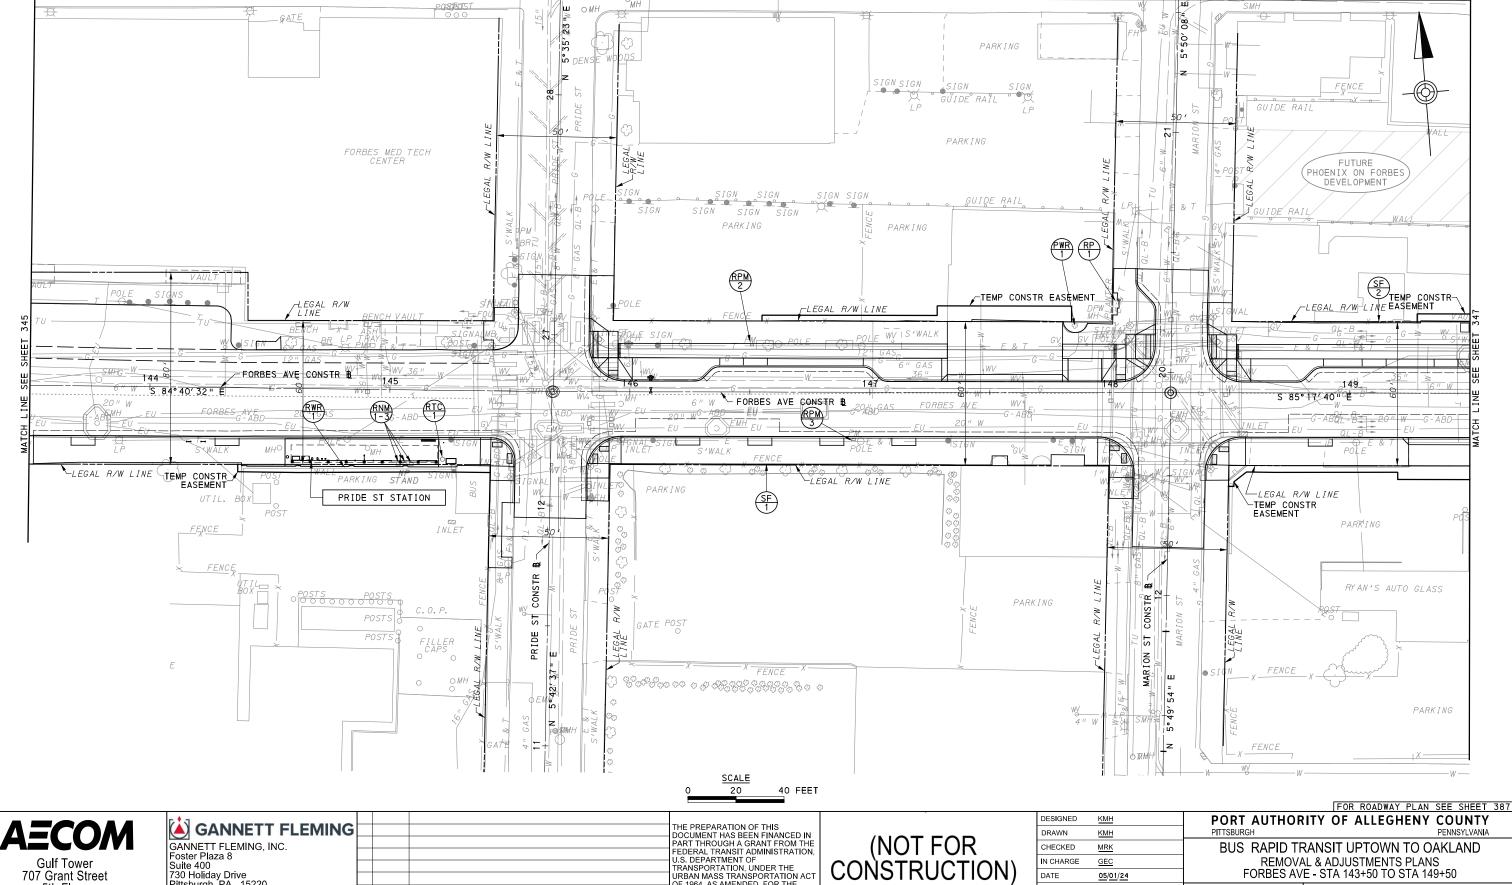

PEDERAL TRANSIT ADMINISTRATION,
U.S. DEPARTMENT OF
TRANSPORTATION, UNDER THE
URBAN MASS TRANSPORTATION ACT
OF 1964, AS AMENDED, FOR THE
PORT AUTHORITY OF ALLEGHENY
COUNTY, PENNSYLVANIA.

REMOVAL & ADJUSTMENTS PLANS

FORBES AVE - STA 143+50 TO STA 149+50

DWG. NO.

**Port Authority** 

CONTRACT NO. BRT-001

sнт. 346

RA37

N CHARGE

DATE

SCALE

GEC

05/01/24

AS SHOWN

MATCH LINE SEE SHEET 322

**Gulf Tower** 707 Grant Street 5th Floor Pittsburgh, PA 15219


Foster Plaza 8 Suite 400

730 Holiday Drive Pittsburgh, PA. 15220

NO. DATE

DESCRIPTION

REVISIONS

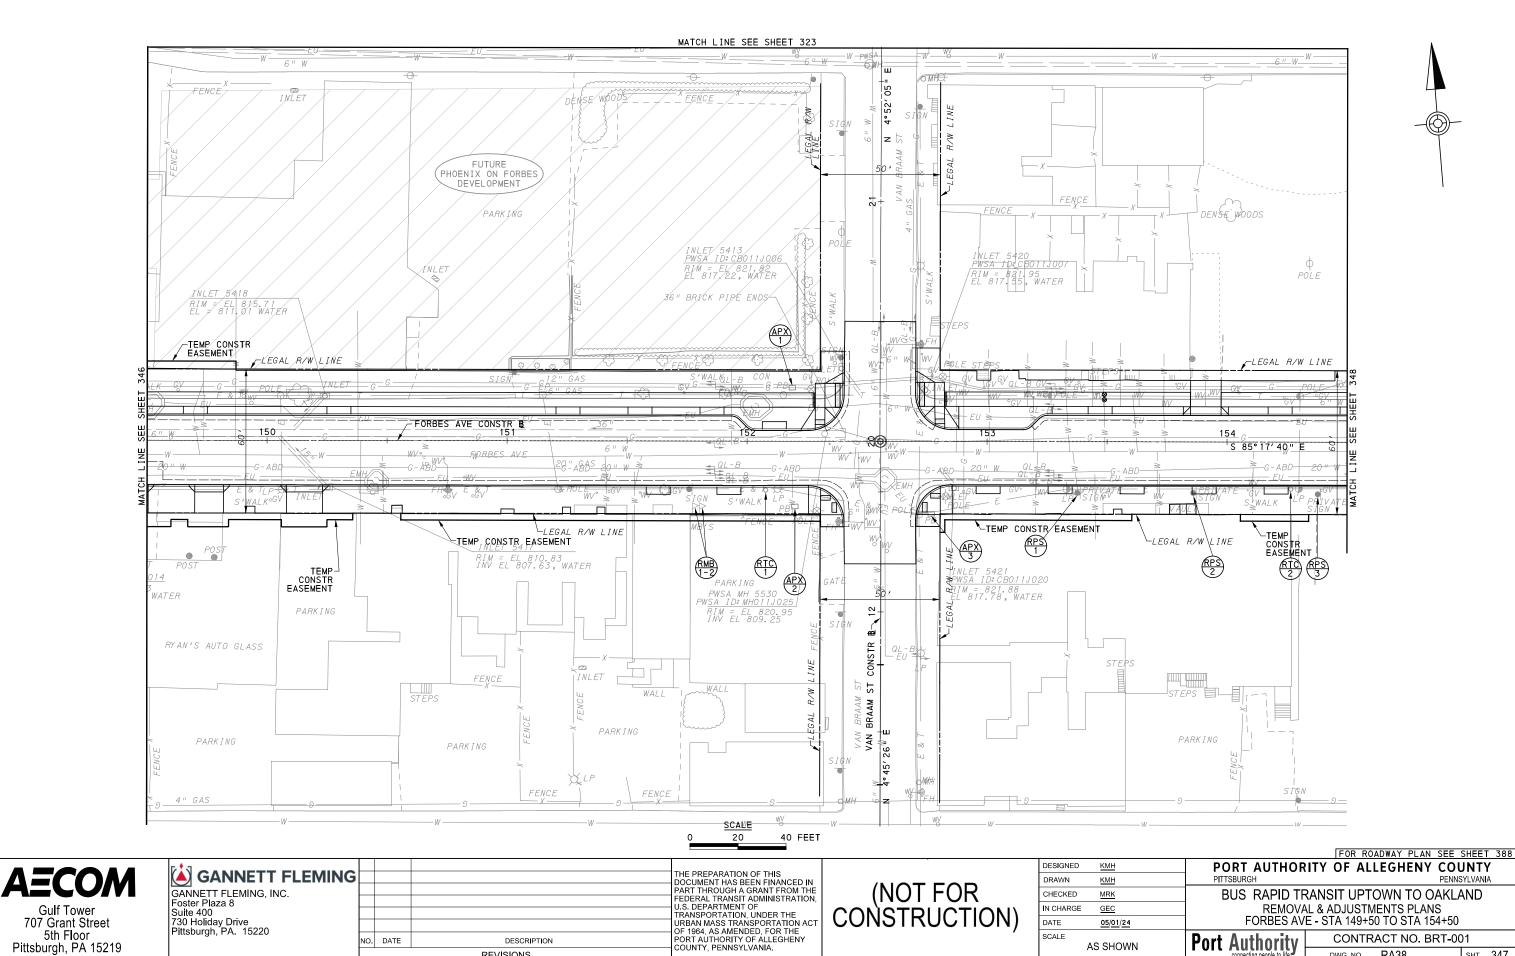

05/01/24

AS SHOWN

**Port Authority** 

CONTRACT NO. BRT-001

sнт. 347

DWG. NO. RA38

SCALE

5th Floor

Pittsburgh, PA 15219


NO. DATE

DESCRIPTION

REVISIONS





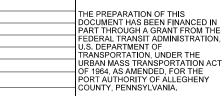

(NOT FOR CONSTRUCTION)

DESIGNED	<u>KMH</u>	
DRAWN	<u>KMH</u>	
CHECKED	MRK	
IN CHARGE	<u>GEC</u>	
DATE	05/01/24	
SCALE		
	AS SHOWN	

## FOR ROADWAY PLAN SEE SHEET 389 PORT AUTHORITY OF ALLEGHENY COUNTY

BUS RAPID TRANSIT UPTOWN TO OAKLAND REMOVAL & ADJUSTMENTS PLANS FORBES AVE - STA 154+50 TO STA 159+50

Port Authority connecting people to life

CONTRACT NO. BRT-001 DWG. NO. RA39 sнт. 348


POST POST FENCE POST PARKING X LP FENCE OMHINLET 5422 PWSA ID: CB01 RIM = EL 829.92 EL 825.02, WATER TEMP CONSTR -LEGAL R/W LINE \_LEGAL R/W LINE 155 FORBES AVE CONSTR & S'WALK LEGAL R/W LINE PLANTER'S ~VAULT SF 2 INLET 5424 PWSA ID: CB011J013 TEMP CONSTR UPTOWN CENTRAL STATION RIM = 830.22 EL 826.12, WATER KENDALL TOWING AND AUTO REPAIR PARKING FENCE DENSE WOODS FENCE WA// STEPS 40 FEET

MATCH LINE SEE SHEET 324

POST

OMH

DESCRIPTION REVISIONS

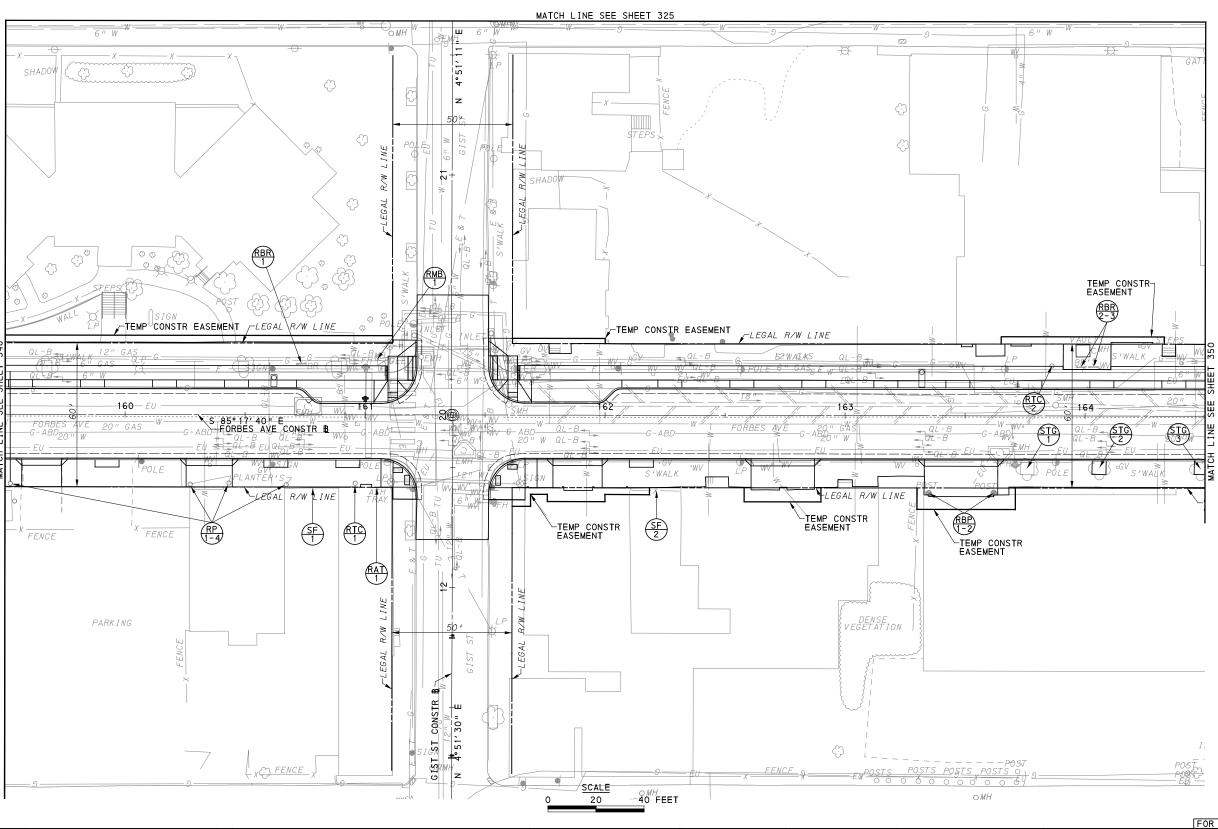

**AECOM** 

**Gulf Tower** 707 Grant Street 5th Floor Pittsburgh, PA 15219 GANNETT FLEMING
GANNETT FLEMING, INC.

NO. DATE

Foster Plaza 8 Suite 400 730 Holiday Drive Pittsburgh, PA. 15220

THE PREPARATION OF THIS
DOCUMENT HAS BEEN FINANCED IN
PART THROUGH A GRANT FROM THE
FEDERAL TRANSIT ADMINISTRATION, PEDERAL TRANSIT ADMINISTRATION,
U.S. DEPARTMENT OF
TRANSPORTATION, UNDER THE
URBAN MASS TRANSPORTATION ACT
OF 1964, AS AMENDED, FOR THE
PORT AUTHORITY OF ALLEGHENY
COUNTY, PENNSYLVANIA. DESCRIPTION REVISIONS

(NOT FOR CONSTRUCTION)

DESIGNED	<u>KMH</u>	
DRAWN	<u>KMH</u>	
CHECKED	MRK	
IN CHARGE	GEC	
DATE	05/01/24	
SCALE		
	AS SHOWN	


FOR ROADWAY PLAN SEE SHEET 390 PORT AUTHORITY OF ALLEGHENY COUNTY

BUS RAPID TRANSIT UPTOWN TO OAKLAND REMOVAL & ADJUSTMENTS PLANS FORBES AVE - STA 159+50 TO STA 164+50

Port Authority connecting people to life

CONTRACT NO. BRT-001

DWG. NO. RA40 sнт. **349** 

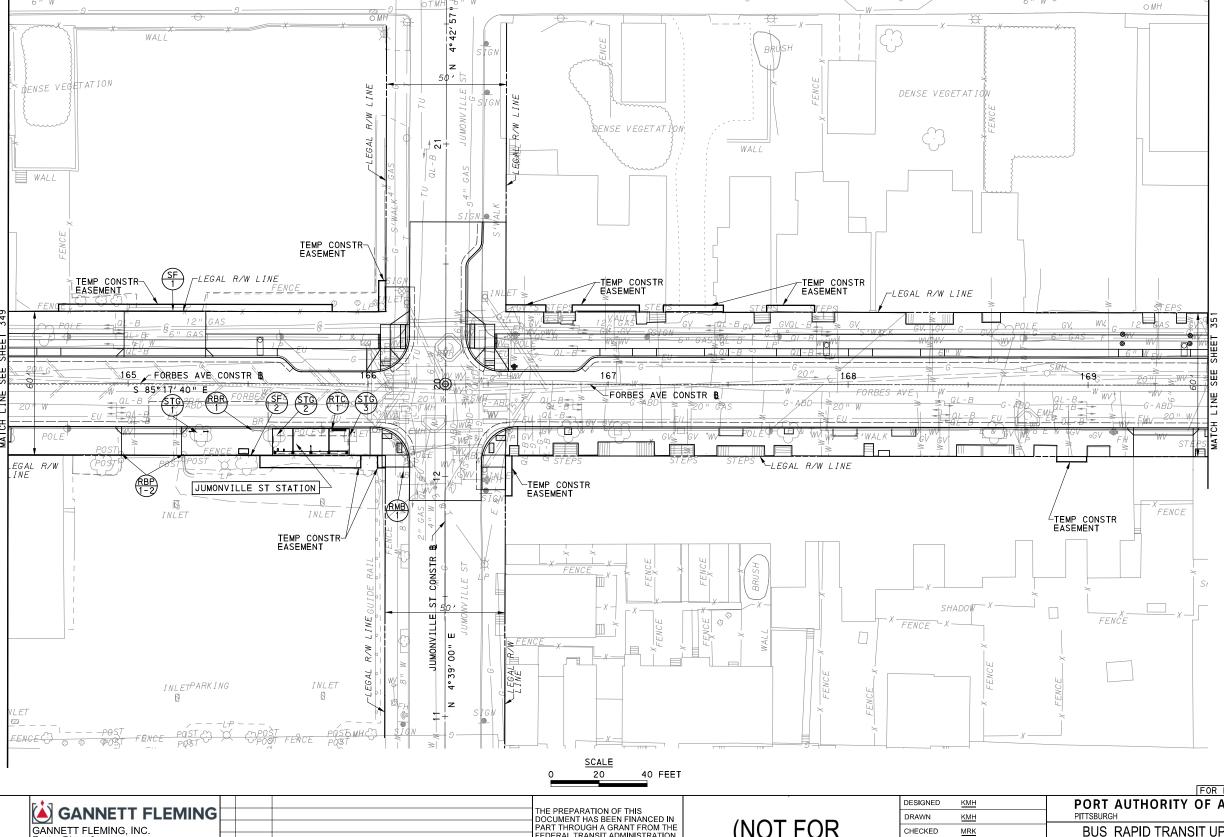

MATCH LINE SEE SHEET 326

**AECOM Gulf Tower** 

707 Grant Street 5th Floor Pittsburgh, PA 15219 Foster Plaza 8 Suite 400 730 Holiday Drive Pittsburgh, PA. 15220

THE PREPARATION OF THIS
DOCUMENT HAS BEEN FINANCED IN
PART THROUGH A GRANT FROM THE
FEDERAL TRANSIT ADMINISTRATION, PEDERAL TRANSIT ADMINISTRATION,
U.S. DEPARTMENT OF
TRANSPORTATION, UNDER THE
URBAN MASS TRANSPORTATION ACT
OF 1964, AS AMENDED, FOR THE
PORT AUTHORITY OF ALLEGHENY
COUNTY, PENNSYLVANIA. NO. DATE DESCRIPTION REVISIONS

(NOT FOR CONSTRUCTION)

DESIGNED	KMH	
DRAWN	KMH	
CHECKED	MRK	
IN CHARGE	<u>GEC</u>	
DATE	05/01/24	
SCALE		
	AS SHOWN	

FOR ROADWAY PLAN SEE SHEET 391 PORT AUTHORITY OF ALLEGHENY COUNTY


BUS RAPID TRANSIT UPTOWN TO OAKLAND REMOVAL & ADJUSTMENTS PLANS FORBES AVE - STA 164+50 TO STA 169+50

Port Authority connecting people to life

CONTRACT NO. BRT-001 RA41 DWG. NO. sнт. 350





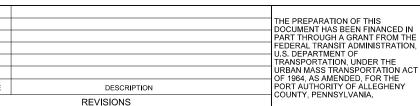

(NOT FOR CONSTRUCTION)


DESIGNED	KMH	
DRAWN	<u>KMH</u>	
CHECKED	MRK	
IN CHARGE	GEC	
DATE	05/01/24	
SCALE		
	AS SHOWN	

## FOR ROADWAY PLAN SEE SHEET 392 PORT AUTHORITY OF ALLEGHENY COUNTY

BUS RAPID TRANSIT UPTOWN TO OAKLAND REMOVAL & ADJUSTMENTS PLANS FORBES AVE - STA 169+50 TO STA 173+50

Port Authority connecting people to life

CONTRACT NO. BRT-001 DWG. NO. RA42 sнт. 351

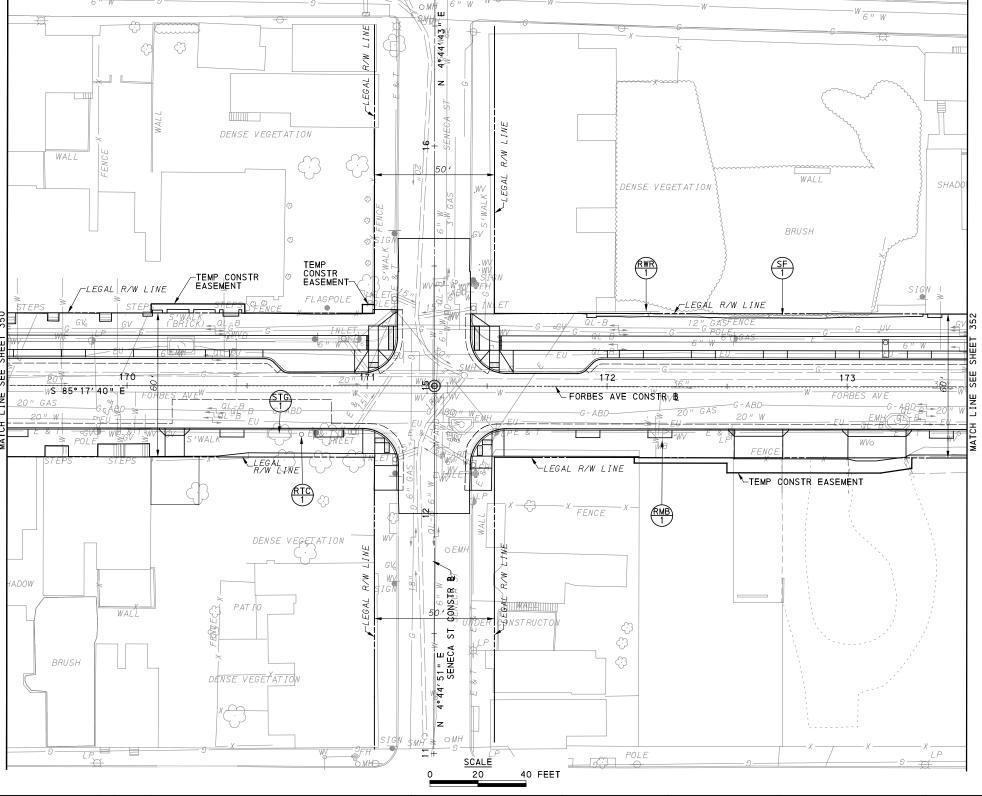

MATCH LINE SEE SHEET 327

**AECOM Gulf Tower** 




Foster Plaza 8 Suite 400

730 Holiday Drive Pittsburgh, PA. 15220

NO. DATE

DESCRIPTION


REVISIONS

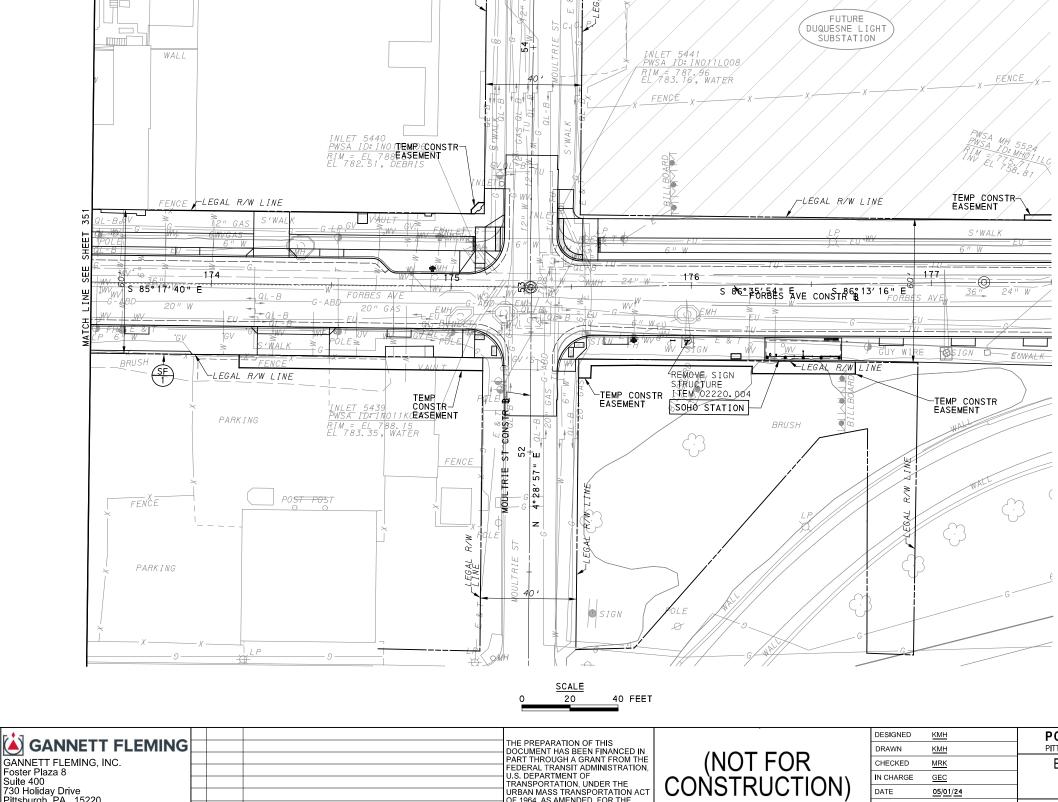

PEDERAL TRANSIT ADMINISTRATION,
U.S. DEPARTMENT OF
TRANSPORTATION, UNDER THE
URBAN MASS TRANSPORTATION ACT
OF 1964, AS AMENDED, FOR THE
PORT AUTHORITY OF ALLEGHENY
COUNTY, PENNSYLVANIA.

MATCH LINE SEE SHEET 328

CONSTRUCTON SITE

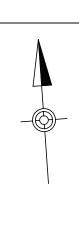

FOR ROADWAY PLAN SEE SHEET 393 PORT AUTHORITY OF ALLEGHENY COUNTY

BUS RAPID TRANSIT UPTOWN TO OAKLAND REMOVAL & ADJUSTMENTS PLANS FORBES AVE - STA 173+50 TO STA 177+50

Port Authority

N CHARGE

DATE

SCALE

GEC

05/01/24

AS SHOWN

CONTRACT NO. BRT-001 DWG. NO. RA43 sнт. 352




Pittsburgh, PA 15219

730 Holiday Drive Pittsburgh, PA. 15220

NO. DATE

DESCRIPTION

REVISIONS

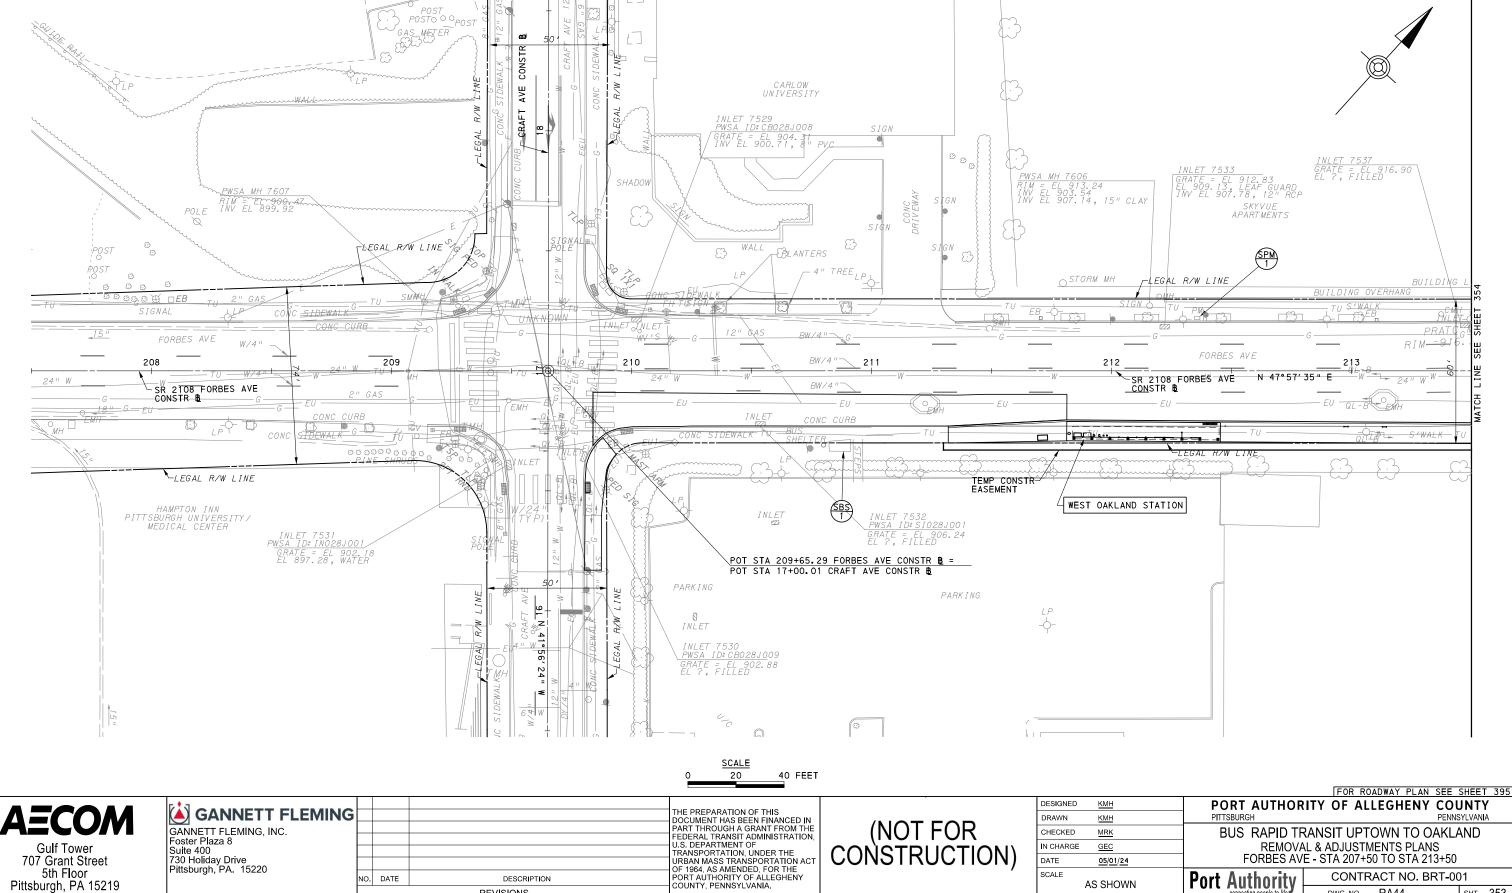

FORBES AVE - STA 207+50 TO STA 213+50

DWG. NO. RA44

**Port Authority** 

CONTRACT NO. BRT-001

sнт. 353


DATE

SCALE

05/01/24

AS SHOWN

MATCH LINE SEE SHEET 334

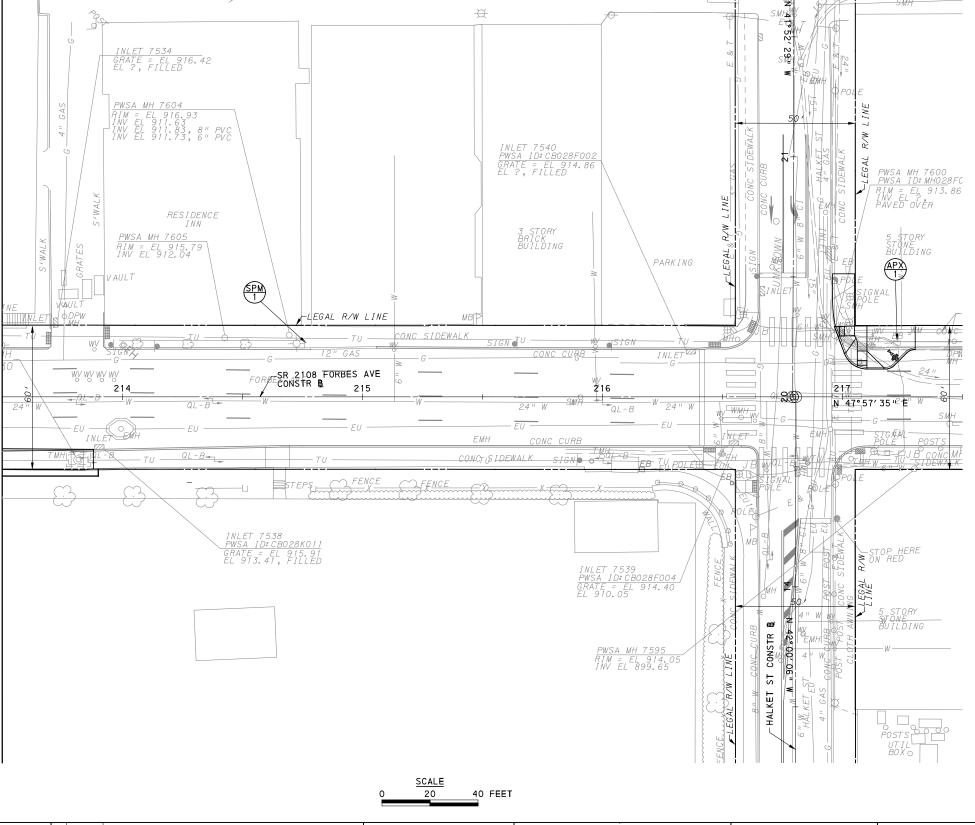

MATCH LINE SEE SHEET 335

**AECOM** 

**Gulf Tower** 707 Grant Street 5th Floor Pittsburgh, PA 15219

GANNETT FLEMING Foster Plaza 8 Suite 400 730 Holiday Drive Pittsburgh, PA. 15220

THE PREPARATION OF THIS
DOCUMENT HAS BEEN FINANCED IN
PART THROUGH A GRANT FROM THE
FEDERAL TRANSIT ADMINISTRATION, FEDERAL TRANSIT ADMINISTRATION,
U.S. DEPARTMENT OF
TRANSPORTATION, UNDER THE
URBAN MASS TRANSPORTATION ACT
OF 1964, AS AMENDED, FOR THE
PORT AUTHORITY OF ALLEGHENY
COUNTY, PENNSYLVANIA. NO. DATE DESCRIPTION REVISIONS

(NOT FOR CONSTRUCTION)

DESIGNED	<u>KMH</u>	
DRAWN	<u>KMH</u>	
CHECKED	MRK	
IN CHARGE	<u>GEC</u>	
DATE	05/01/24	
SCALE		
	AS SHOWN	


FOR ROADWAY PLAN SEE SHEET 396 PORT AUTHORITY OF ALLEGHENY COUNTY


BUS RAPID TRANSIT UPTOWN TO OAKLAND REMOVAL & ADJUSTMENTS PLANS FORBES AVE - STA 213+50 TO STA 217+50


Port Authority

CONTRACT NO. BRT-001

DWG. NO. RA45 sнт. 354

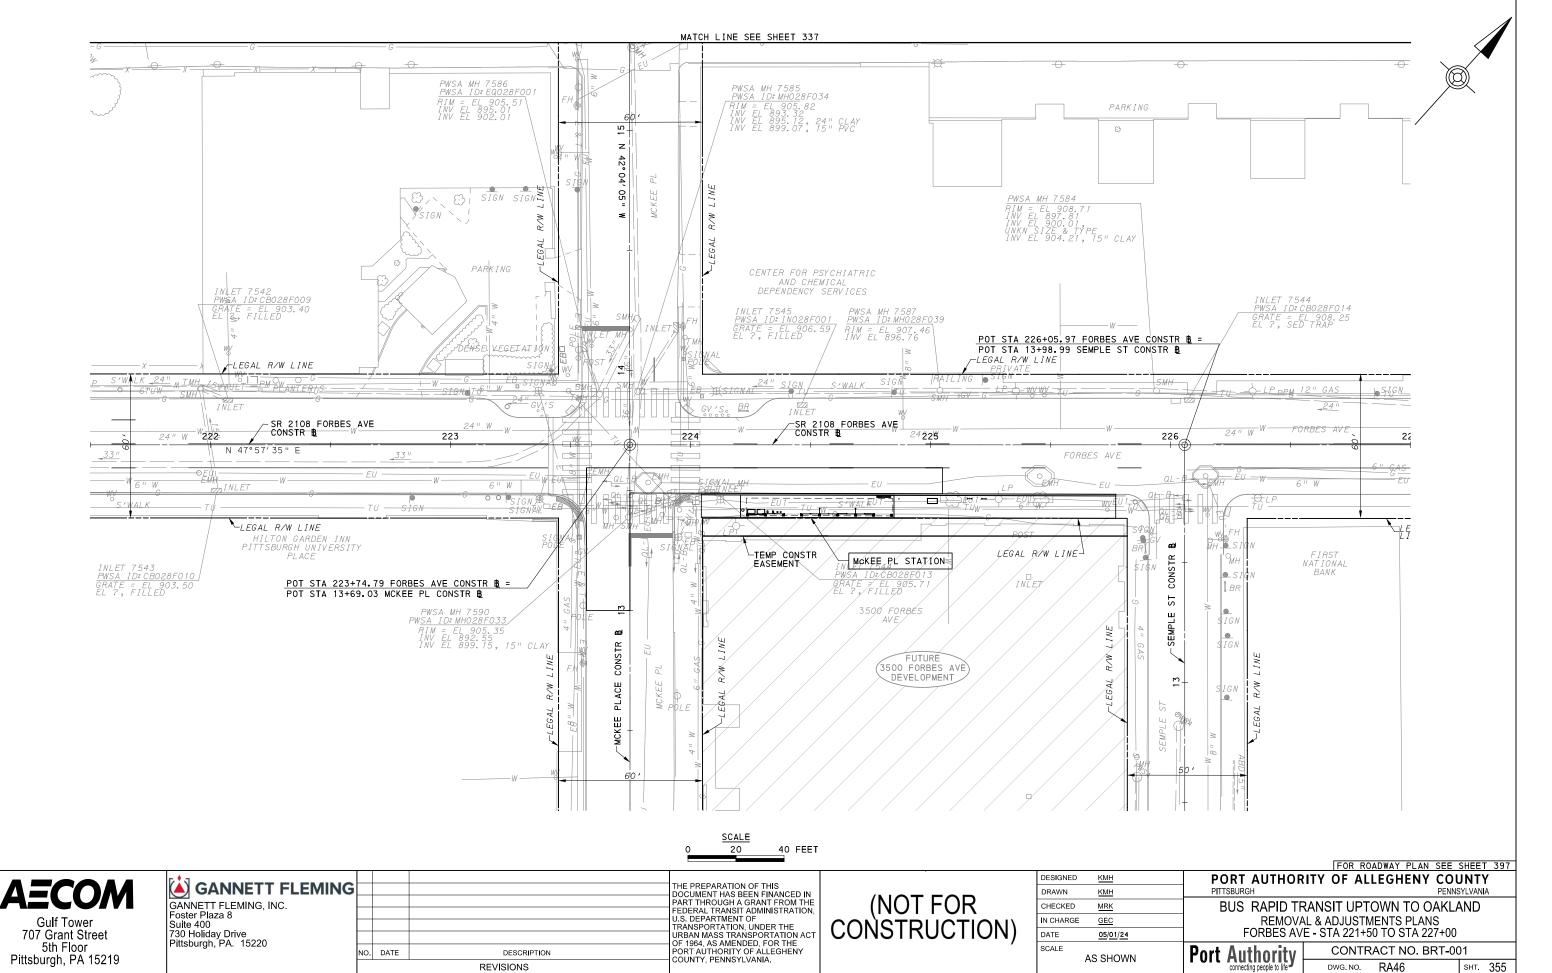

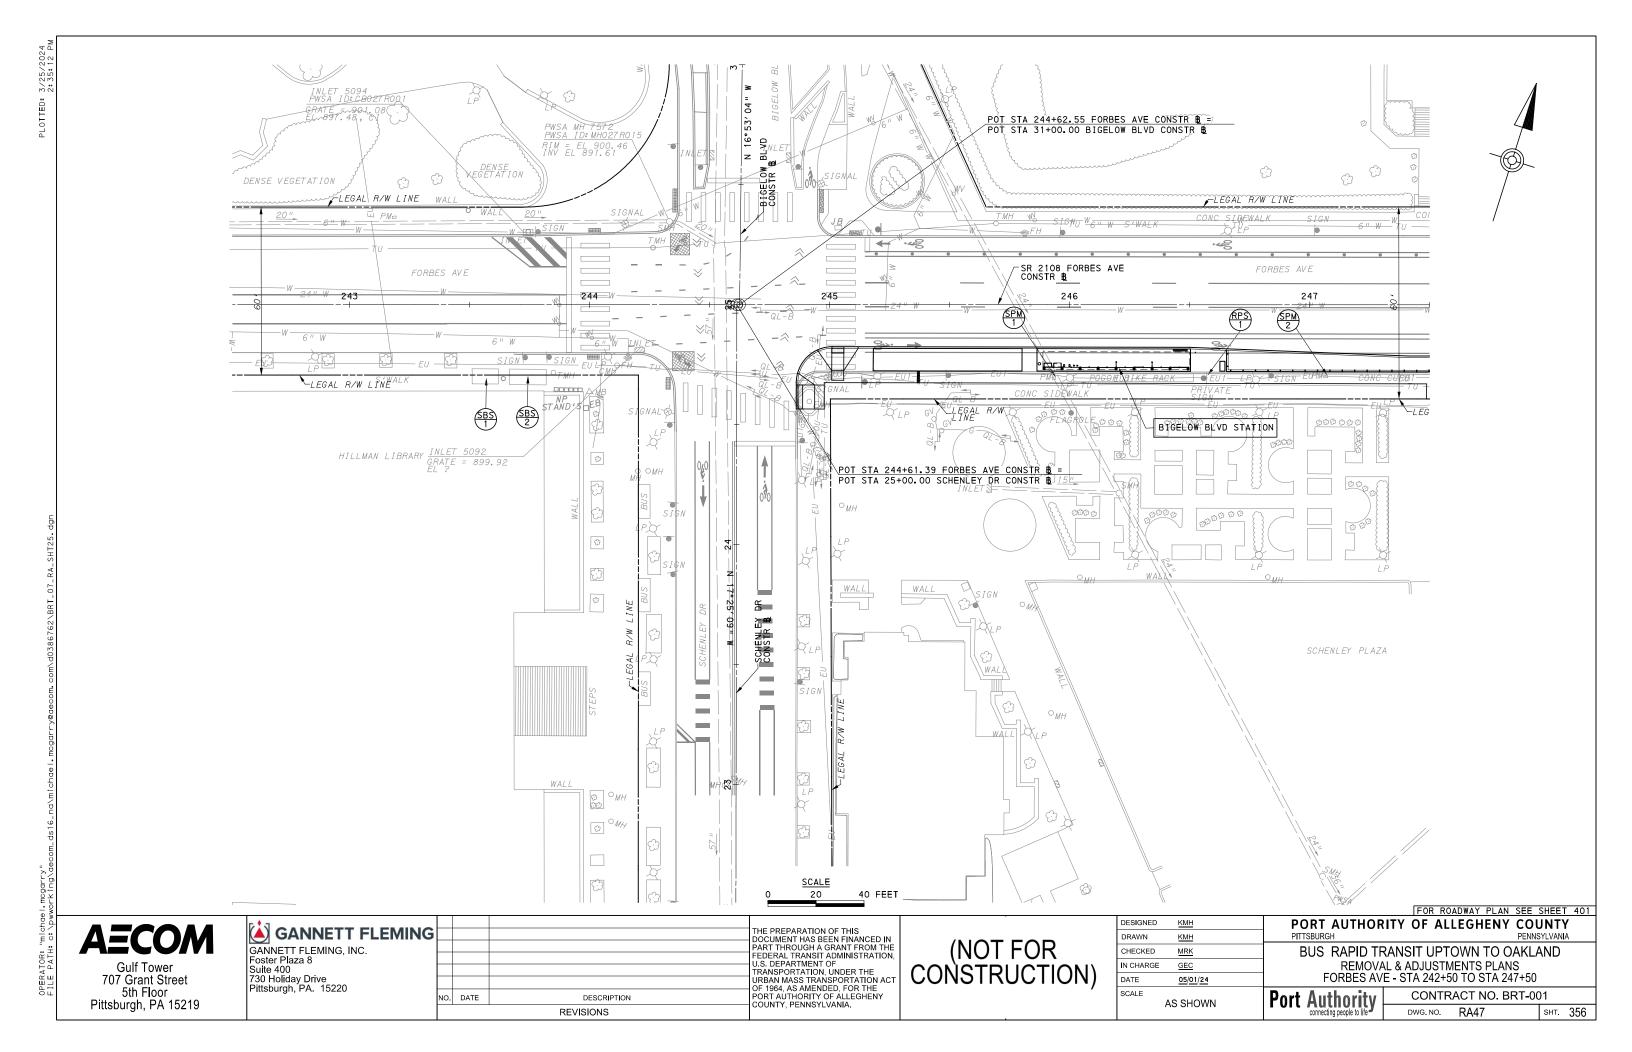

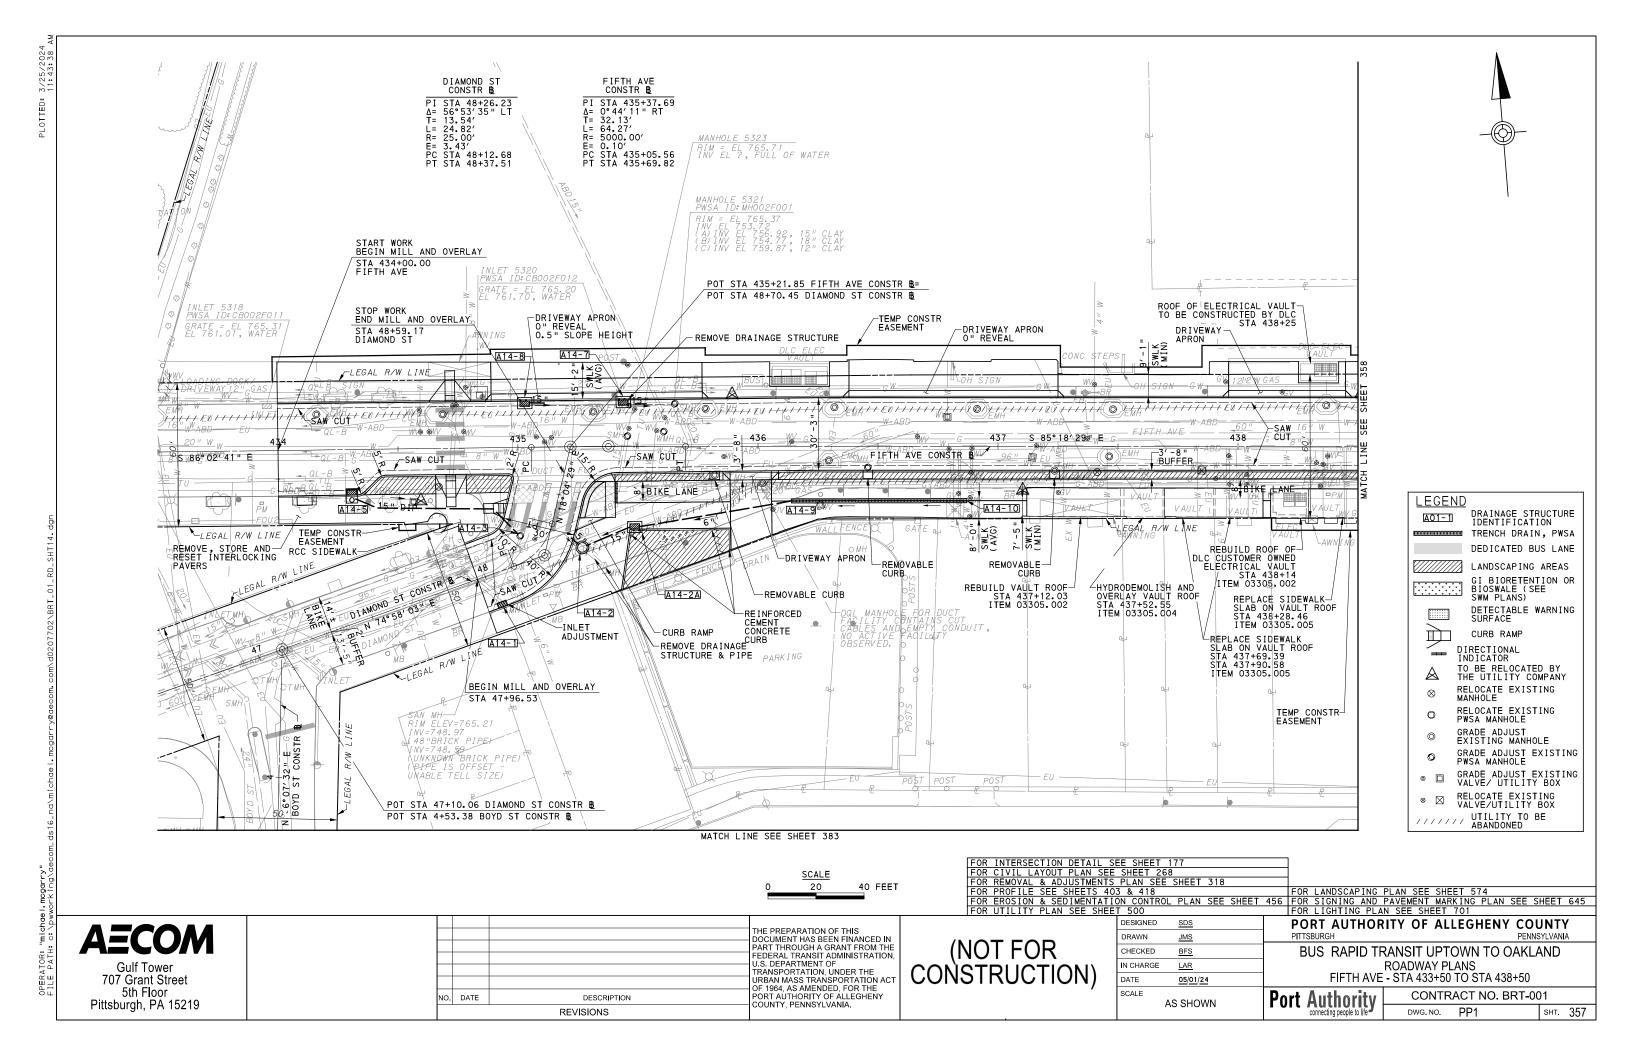

STOP WORK END MILL AND OVERLAY TEMP CONSTR EASEMENT STA 24+09.23 CHATHAM SQ POT STA 440+39.55 FIFTH AVE CONSTR B= POT STA 24+19.23 CHATHAM SQUARE CONSTR B BEGIN MILL AND OVERLAY STA 23+65.00 START WORK STA 23+02.30 CHATHAM SQ OMHOMH<sup>P</sup>

MATCH LINE SEE SHEET 384

40 FEET

FOR INTERSECTION DETAIL SEE SHEET 179
FOR CIVIL LAYOUT PLAN SEE SHEET 269
FOR REMOVAL & ADJUSTMENTS PLAN SEE SHEET 319
FOR PROFILE SEE SHEETS 404 & 418
FOR PROFILE SEE SHEETS 404 & 418
FOR DETAIL SEE SHEETS 404 & 418
FOR UTILITY PLAN SEE SHEET 501
FOR CONTROL SYSTEMS PLAN SEE SHEET 747
FOR UTILITY PLAN SEE SHEET 501
FOR CONTROL SYSTEMS PLAN SEE SHEET 880
FOR SIGNAL PLAN SEE SHEET 1071

AECOM

707 Grant Street 5th Floor Pittsburgh, PA 15219

THE PREPARATION OF THIS DOCUMENT HAS BEEN FINANCED IN PART THROUGH A GRANT FROM THE FEDERAL TRANSIT ADMINISTRATION U.S. DEPARTMENT OF TRANSPORTATION, UNDER THE URBAN MASS TRANSPORTATION ACT OF 1964 AS AMENDED FOR THE PORT AUTHORITY OF ALLEGHENY COUNTY, PENNSYLVANIA. NO. DATE DESCRIPTION REVISIONS

(NOT FOR CONSTRUCTION DESIGNED SDS <u>JMS</u> CHECKED BFS N CHARGE LAR DATE 05/01/24 SCALE AS SHOWN PORT AUTHORITY OF ALLEGHENY COUNTY

GRADE ADJUST EXISTING PWSA MANHOLE

GRADE ADJUST EXISTING VALVE/ UTILITY BOX

RELOCATE EXISTING

VALVE/UTILITY BOX


UTILITY TO BE ABANDONED

BUS RAPID TRANSIT UPTOWN TO OAKLAND ROADWAY PLANS


FIFTH AVE - STA 438+50 TO STA 443+50

⊗ ⊠

CONTRACT NO. BRT-001 **Port Authority** PP2 sнт. 358 DWG NO

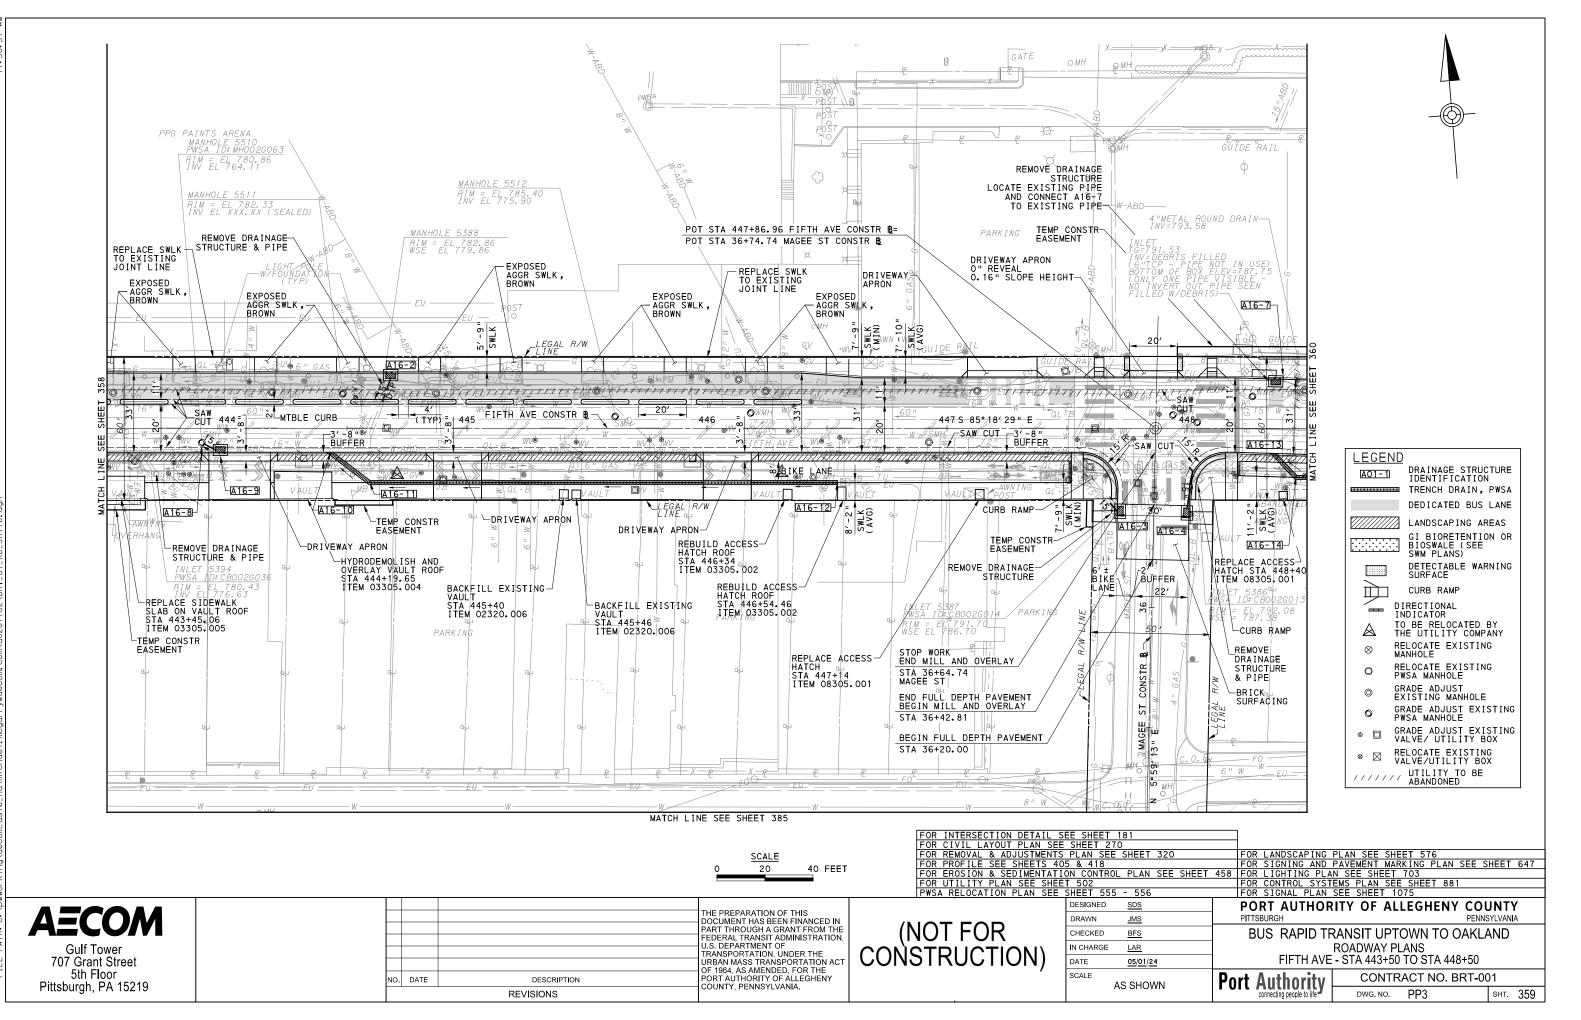

OPERATOR: "michael.mogarry"

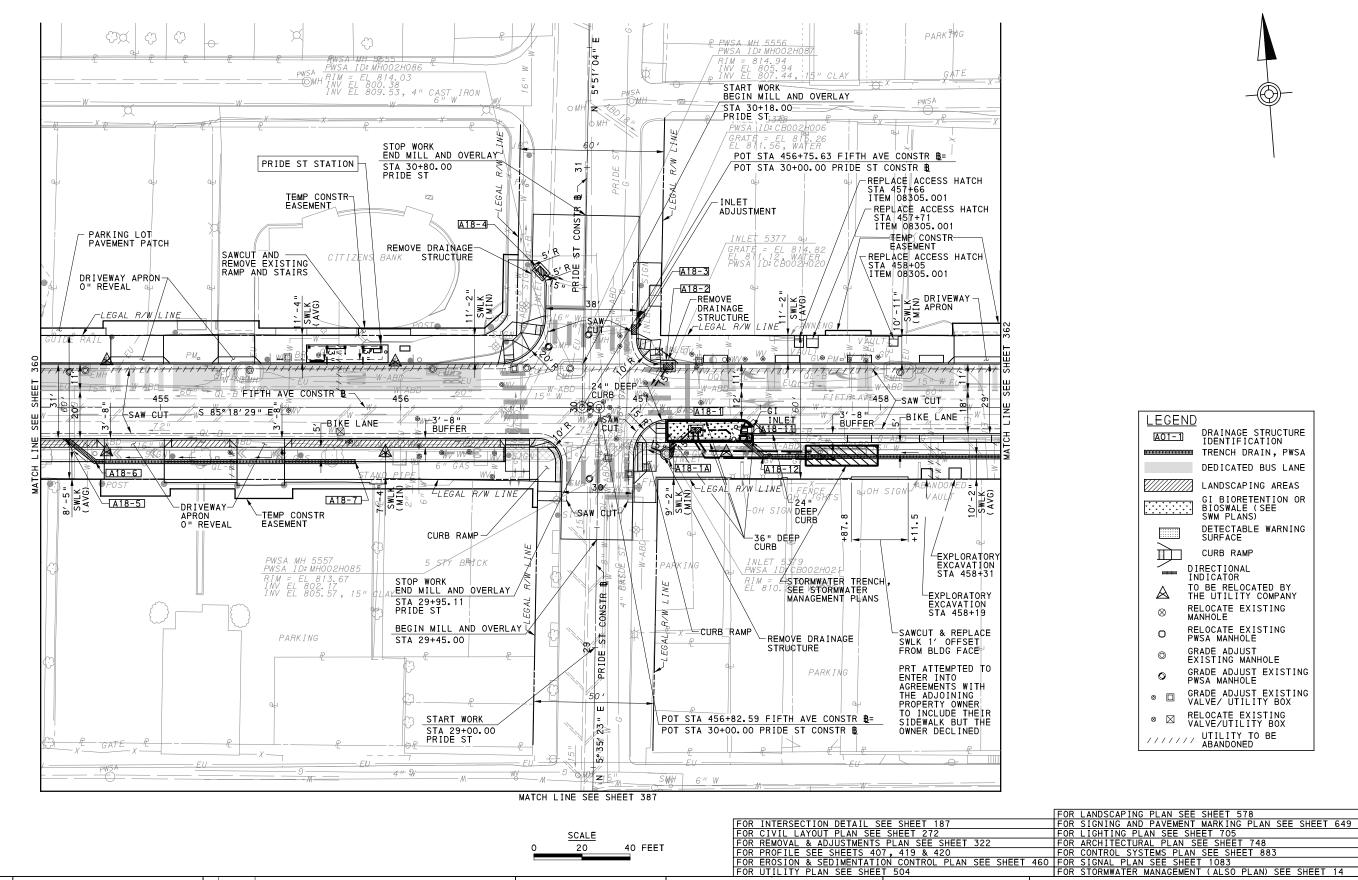

AECOM

**Gulf Tower** 707 Grant Street 5th Floor Pittsburgh, PA 15219

THE PREPARATION OF THIS DOCUMENT HAS BEEN FINANCED IN PART THROUGH A GRANT FROM THE FEDERAL TRANSIT ADMINISTRATION U.S. DEPARTMENT OF TRANSPORTATION, UNDER THE URBAN MASS TRANSPORTATION ACT OF 1964 AS AMENDED FOR THE PORT AUTHORITY OF ALLEGHENY COUNTY, PENNSYLVANIA. NO. DATE DESCRIPTION REVISIONS

(NOT FOR CONSTRUCTION)

504		
ESIGNED	SDS	
RAWN	<u>JMS</u>	
HECKED	BFS	
CHARGE	<u>LAR</u>	
ATE	05/01/24	
CALE		Г
	AS SHOWN	

## PORT AUTHORITY OF ALLEGHENY COUNTY

**LEGEND** 

□

 $\otimes$ 

DRAINAGE STRUCTURE IDENTIFICATION TRENCH DRAIN, PWSA DEDICATED BUS LANE

LANDSCAPING AREAS

GI BIORETENTION OR BIOSWALE (SEE

DETECTABLE WARNING SURFACE

CURB RAMP

TO BE RELOCATED BY THE UTILITY COMPANY

RELOCATE EXISTING MANHOLE

RELOCATE EXISTING PWSA MANHOLE

GRADE ADJUST EXISTING MANHOLE

RELOCATE EXISTING VALVE/UTILITY BOX

////// UTILITY TO BE

GRADE ADJUST EXISTING PWSA MANHOLE

GRADE ADJUST EXISTING VALVE/ UTILITY BOX

DIRECTIONAL INDICATOR

BUS RAPID TRANSIT UPTOWN TO OAKLAND ROADWAY PLANS

FIFTH AVE - STA 454+50 TO STA 458+50

CONTRACT NO. BRT-001 sнт. 361

**Port Authority** 

DWG. NO. PP5

GRADE ADJUST EXISTING MANHOLE LANDSCAPING AREAS START WORK BEGIN MILL AND OVERLAY GI BIORETENTION OR GRADE ADJUST EXISTING PWSA MANHOLE BIOSWALE (SEE SWM PLANS) GRADE ADJUST EXISTING DETECTABLE WARNING SURFACE VALVE/ UTILITY BOX RELOCATE EXISTING VALVE/UTILITY BOX CURB RAMP DIRECTIONAL INDICATOR UTILITY TO BE ABANDONED 1111111

40 FEET

MATCH LINE SEE SHEET 388

FOR INTERSECTION DETAIL SEE SHEETS 189 - 191
FOR CIVIL LAYOUT PLAN SEE SHEET 273
FOR REMOVAL & ADJUSTMENTS PLAN SEE SHEET 323
FOR PROFILE SEE SHEETS 408 & 420
FOR EROSION & SEDIMENTATION CONTROL PLAN SEE SHEET 46
FOR UTILITY PLAN SEE SHEET 505 FOR LANUSCAPING PLAN SEE SHEET 379

FOR SIGNING AND PAVEMENT MARKING PLAN SEE SHEET 650

FOR LIGHTING PLAN SEE SHEET 706

FOR CONTROL SYSTEMS PLAN SEE SHEET 884

61 FOR SIGNAL PLAN SEE SHEET 1087

FOR STORMWATER MANAGEMENT (ALSO PLAN) SEE SHEET 15

05 "

AECOM

OMH

707 Grant Street 5th Floor Pittsburgh, PA 15219

THE PREPARATION OF THIS DOCUMENT HAS BEEN FINANCED IN PART THROUGH A GRANT FROM THE FEDERAL TRANSIT ADMINISTRATION U.S. DEPARTMENT OF TRANSPORTATION, UNDER THE URBAN MASS TRANSPORTATION ACT OF 1964 AS AMENDED FOR THE PORT AUTHORITY OF ALLEGHENY COUNTY, PENNSYLVANIA. NO. DATE DESCRIPTION REVISIONS

(NOT FOR CONSTRUCTION DESIGNED SDS DRAWN <u>JMS</u> CHECKED BFS N CHARGE LAR DATE 05/01/24 SCALE AS SHOWN PORT AUTHORITY OF ALLEGHENY COUNTY

BUS RAPID TRANSIT UPTOWN TO OAKLAND ROADWAY PLANS

FIFTH AVE - STA 458+50 TO STA 464+50 CONTRACT NO. BRT-001 **Port Authority** 

PP6 sнт. 362 DWG NO

**FUTURE** 

PHA RESIDENTIAL

START WORK

STA 22+53.48

VAN BRAAM ST

EVELOPMENT

U.S. DEPARTMENT OF TRANSPORTATION, UNDER THE URBAN MASS TRANSPORTATION ACT

OF 1964, AS AMENDED, FOR THE PORT AUTHORITY OF ALLEGHENY COUNTY, PENNSYLVANIA. CONSTRUCTION

N CHARGE

DATE

SCALE

LAR

05/01/24

AS SHOWN

START WORK BEGIN MILL AND OVERLAY

**ROADWAY PLANS** 

FIFTH AVE - STA 464+50 TO STA 470+50

DWG. NO.

**Port Authority** 

CONTRACT NO. BRT-001

sнт. 363

PP7

ATOR: "michael.mogarry" PATH: s:\pwworking\gecom 4s16 ng\michael.mogarry8aecom.com\d0207702\BRI 01 RD SHT/

707 Grant Street


5th Floor

Pittsburgh, PA 15219

NO. DATE

DESCRIPTION

REVISIONS

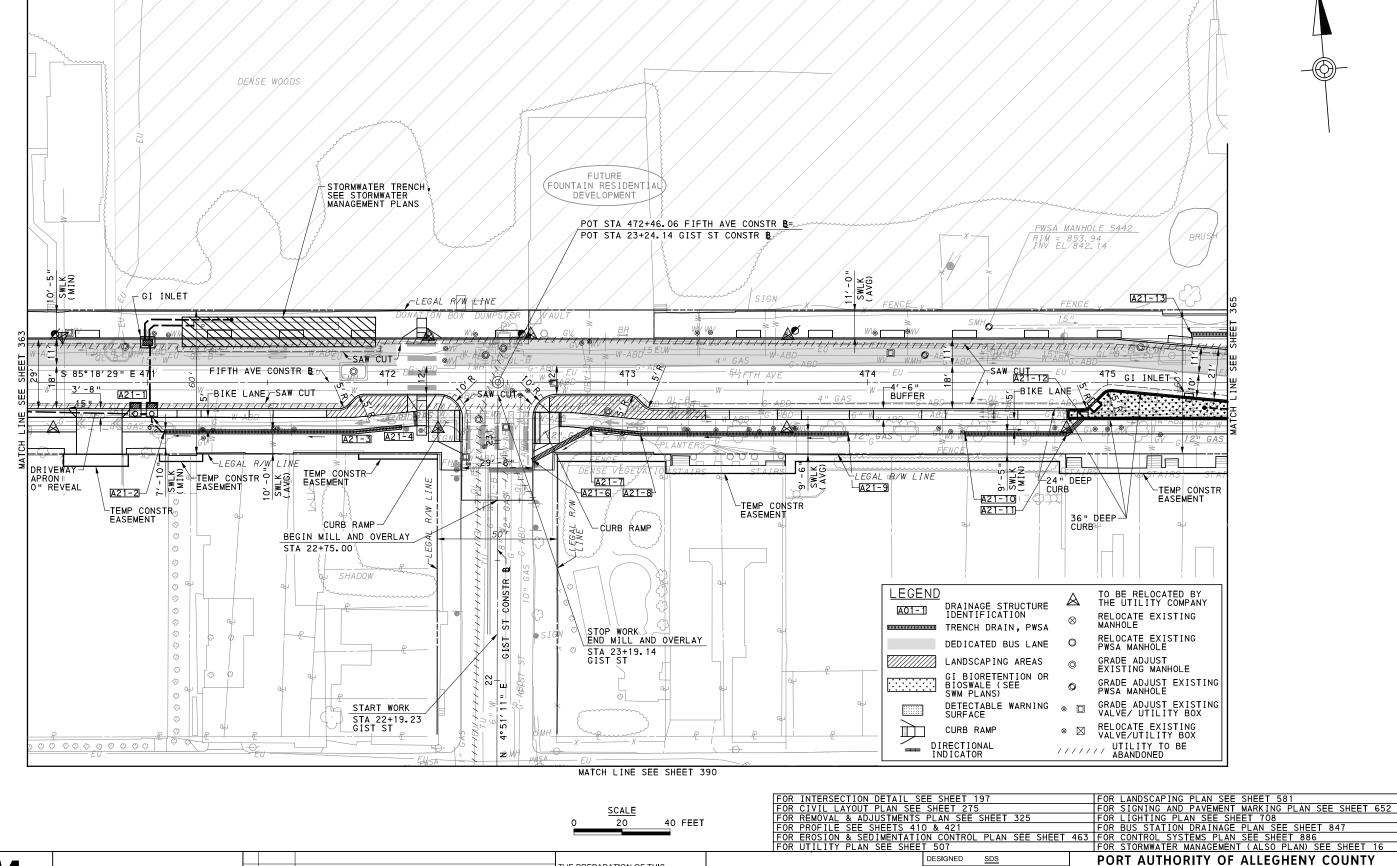

AECOM

Gulf Tower 707 Grant Street 5th Floor Pittsburgh, PA 15219

THE PREPARATION OF THIS DOCUMENT HAS BEEN FINANCED IN PART THROUGH A GRANT FROM THE FEDERAL TRANSIT ADMINISTRATION, U.S. DEPARTMENT OF TRANSPORTATION, UNDER THE URBAN MASS TRANSPORTATION ACT OF 1964, AS AMENDED, FOR THE PORT AUTHORITY OF ALLEGHENY COUNTY, PENNSYLVANIA. NO. DATE DESCRIPTION REVISIONS

(NOT FOR CONSTRUCTION)

DESIGNED	SDS		
DRAWN	<u>JMS</u>		
CHECKED	BFS		
IN CHARGE	LAR		
DATE	05/01/24		
SCALE			
AS SHOWN			


PORT AUTHORITY OF ALLEGHENY COUNTY

BUS RAPID TRANSIT UPTOWN TO OAKLAND **ROADWAY PLANS** 

FIFTH AVE - STA 470+50 TO STA 475+50

CONTRACT NO. BRT-001 **Port Authority** DWG. NO. PP8

sнт. 364

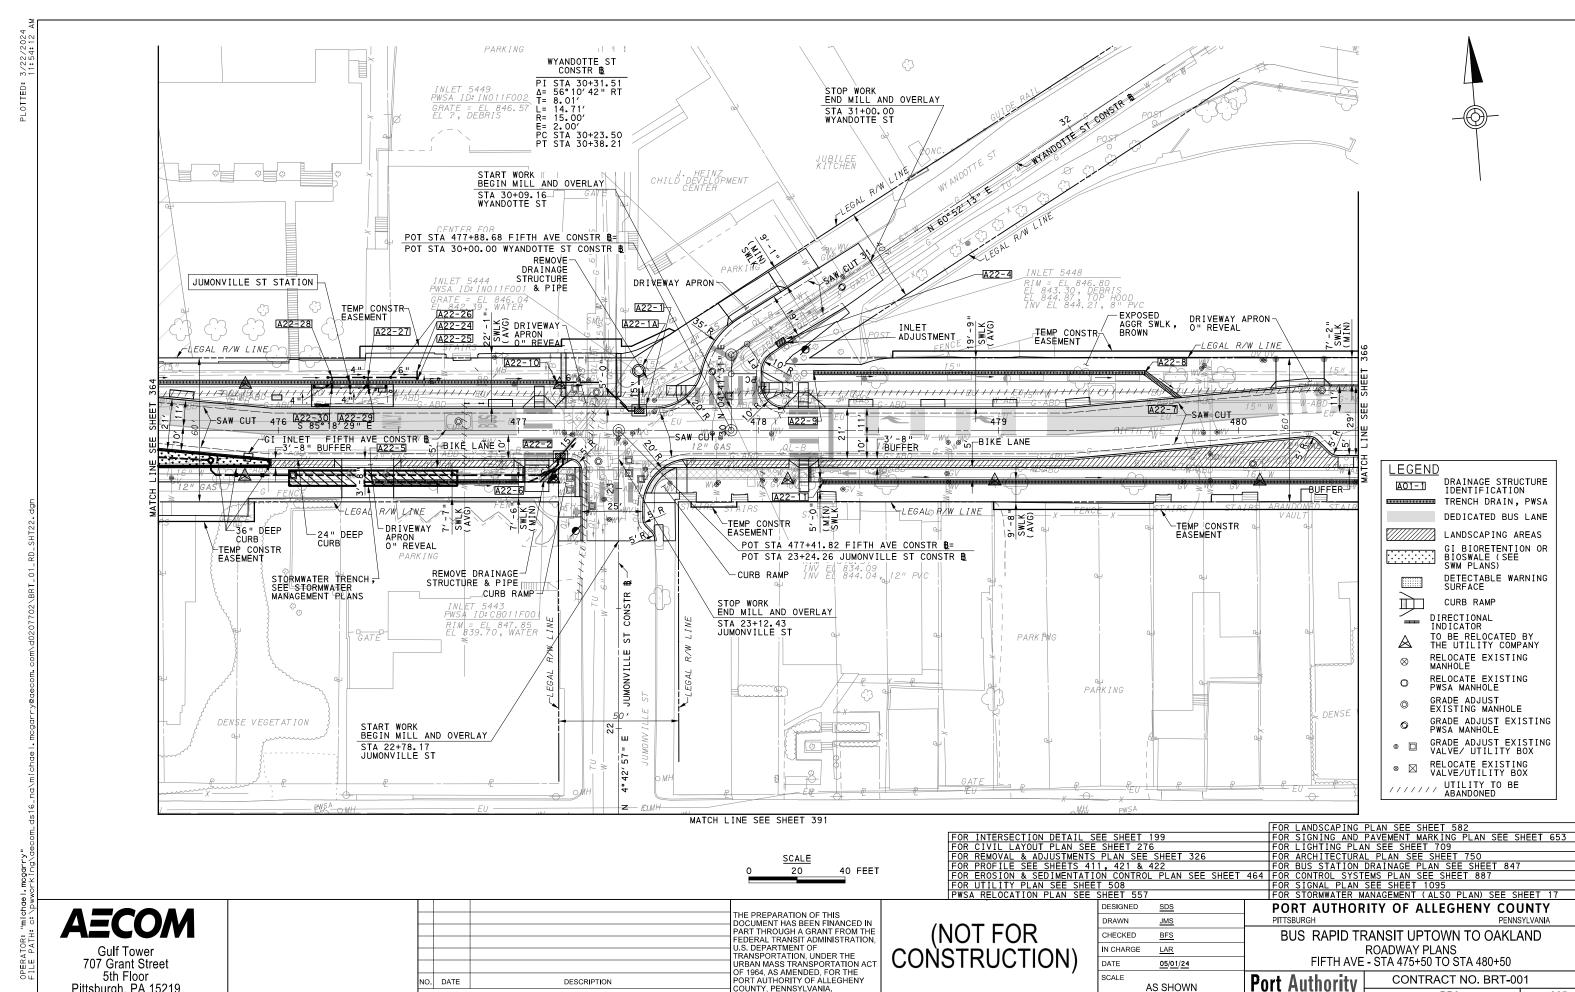


REVISIONS

AS SHOWN

DWG. NO. PP9

sнт. 365

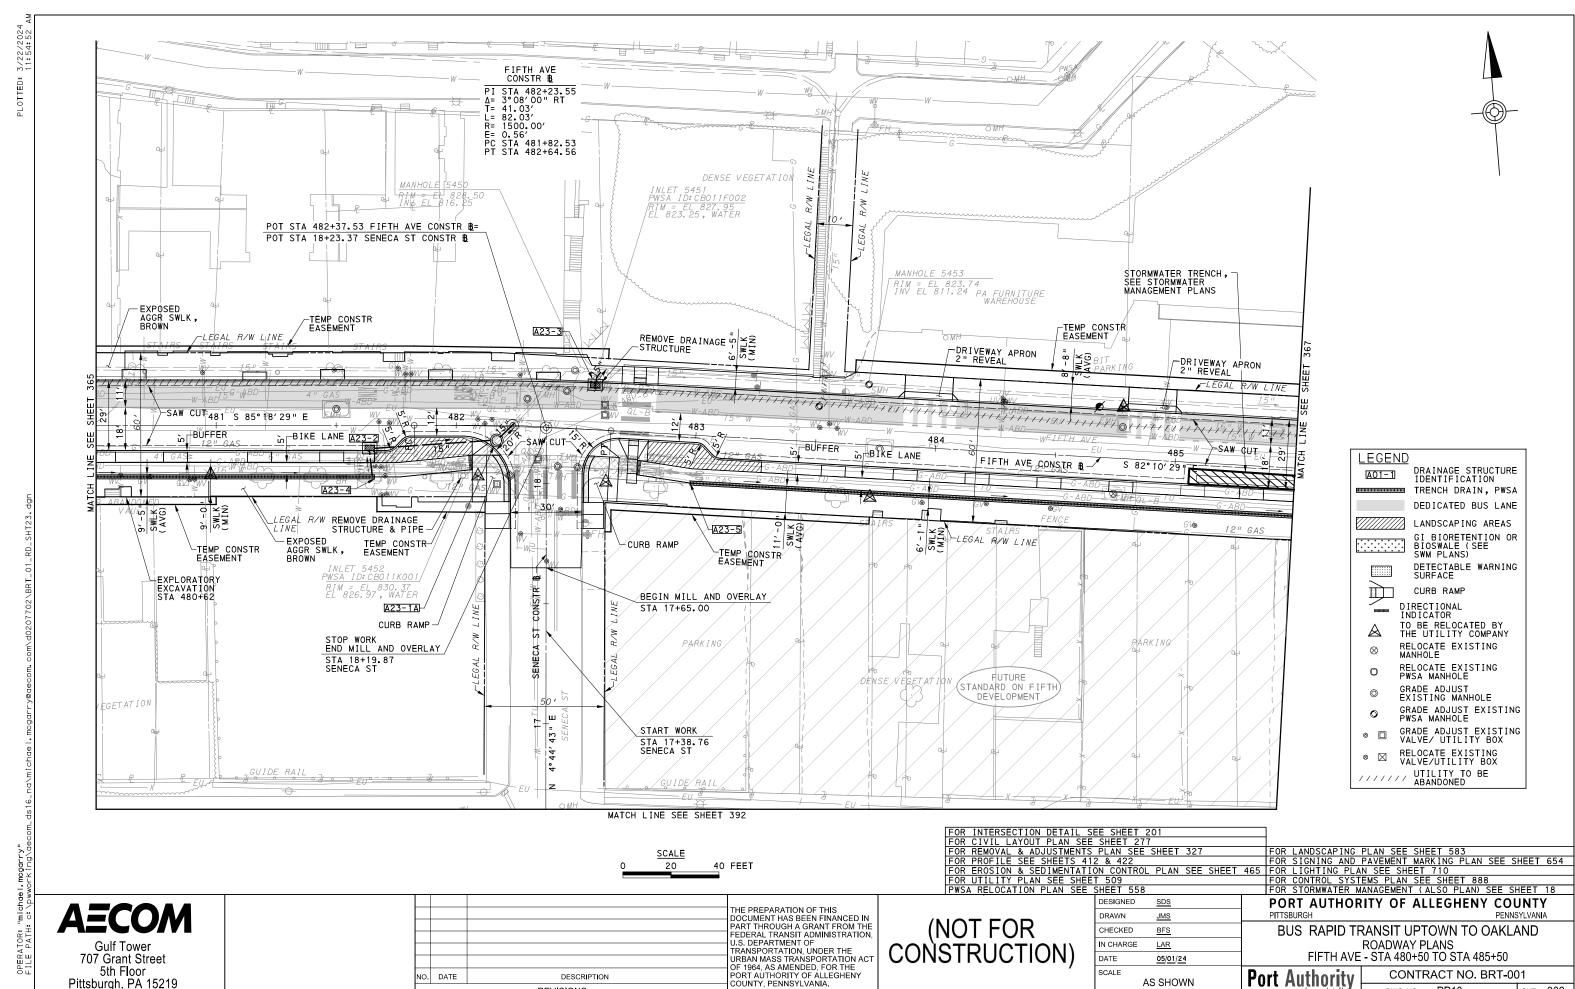

NO. DATE

DESCRIPTION

REVISIONS


**Port Authority** 

DWG. NO.

PP10

sнт. 366

AS SHOWN

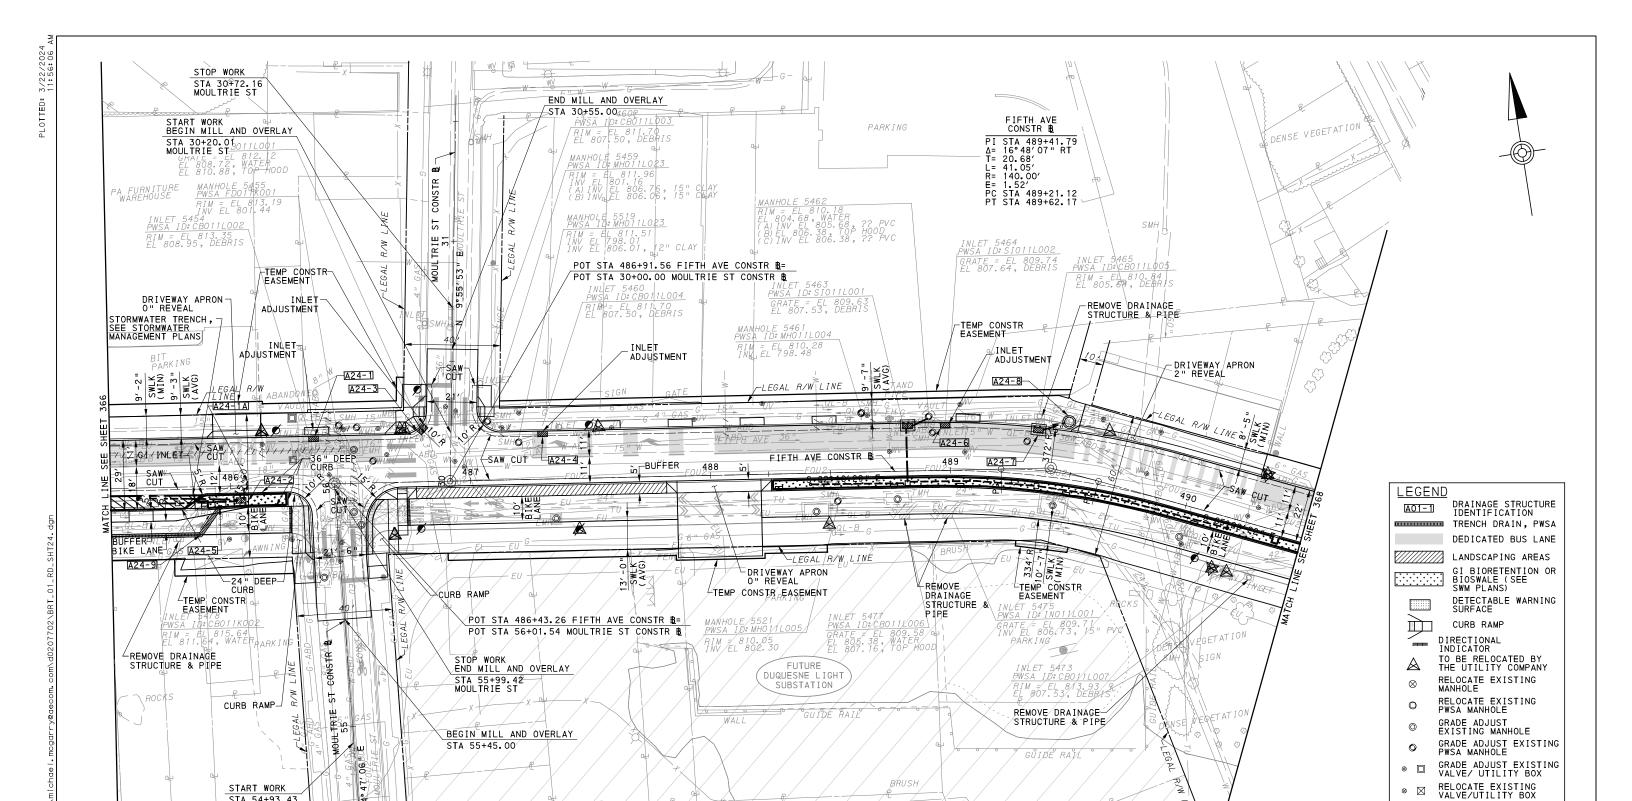

20 40 FEET THE PREPARATION OF THIS

(NOT FOR **CONSTRUCTION**  DESIGNED SDS <u>JMS</u> CHECKED BFS N CHARGE LAR DATE 05/01/24 SCALE AS SHOWN

FOR INTERSECTION DETAIL SEE SHEET 203
FOR CIVIL LAYOUT PLAN SEE SHEET 278
FOR REMOVAL & ADJUSTMENTS PLAN SEE SHEET 328
FOR PROFILE SEE SHEETS 413 & 422
FOR EROSION & SEDIMENTATION CONTROL PLAN SEE SHEET 466
FOR UTILITY PLAN SEE SHEET 510
FOR CONTROL SYSTEMS PLAN SEE SHEET 711
FOR UTILITY PLAN SEE SHEET 559
FOR STORWWATER MANAGEMENT (ALSO PLAN) SEE SHEET 19 PORT AUTHORITY OF ALLEGHENY COUNTY BUS RAPID TRANSIT UPTOWN TO OAKLAND

////// UTILITY TO BE ABANDONED

ROADWAY PLANS

FIFTH AVE - STA 485+50 TO STA 490+50

CONTRACT NO. BRT-001 **Port Authority** DWG. NO. PP11 sнт. 367


AECOM 707 Grant Street 5th Floor Pittsburgh, PA 15219


STA 54+93.43 MOULTRIE ST


NO. DATE DESCRIPTION REVISIONS


MATCH LINE SEE SHEET 393


DOCUMENT HAS BEEN FINANCED IN PART THROUGH A GRANT FROM THE FEDERAL TRANSIT ADMINISTRATION, U.S. DEPARTMENT OF TRANSPORTATION, UNDER THE URBAN MASS TRANSPORTATION ACT OF 1964, AS AMENDED, FOR THE PORT AUTHORITY OF ALLEGHENY COUNTY, PENNSYLVANIA.

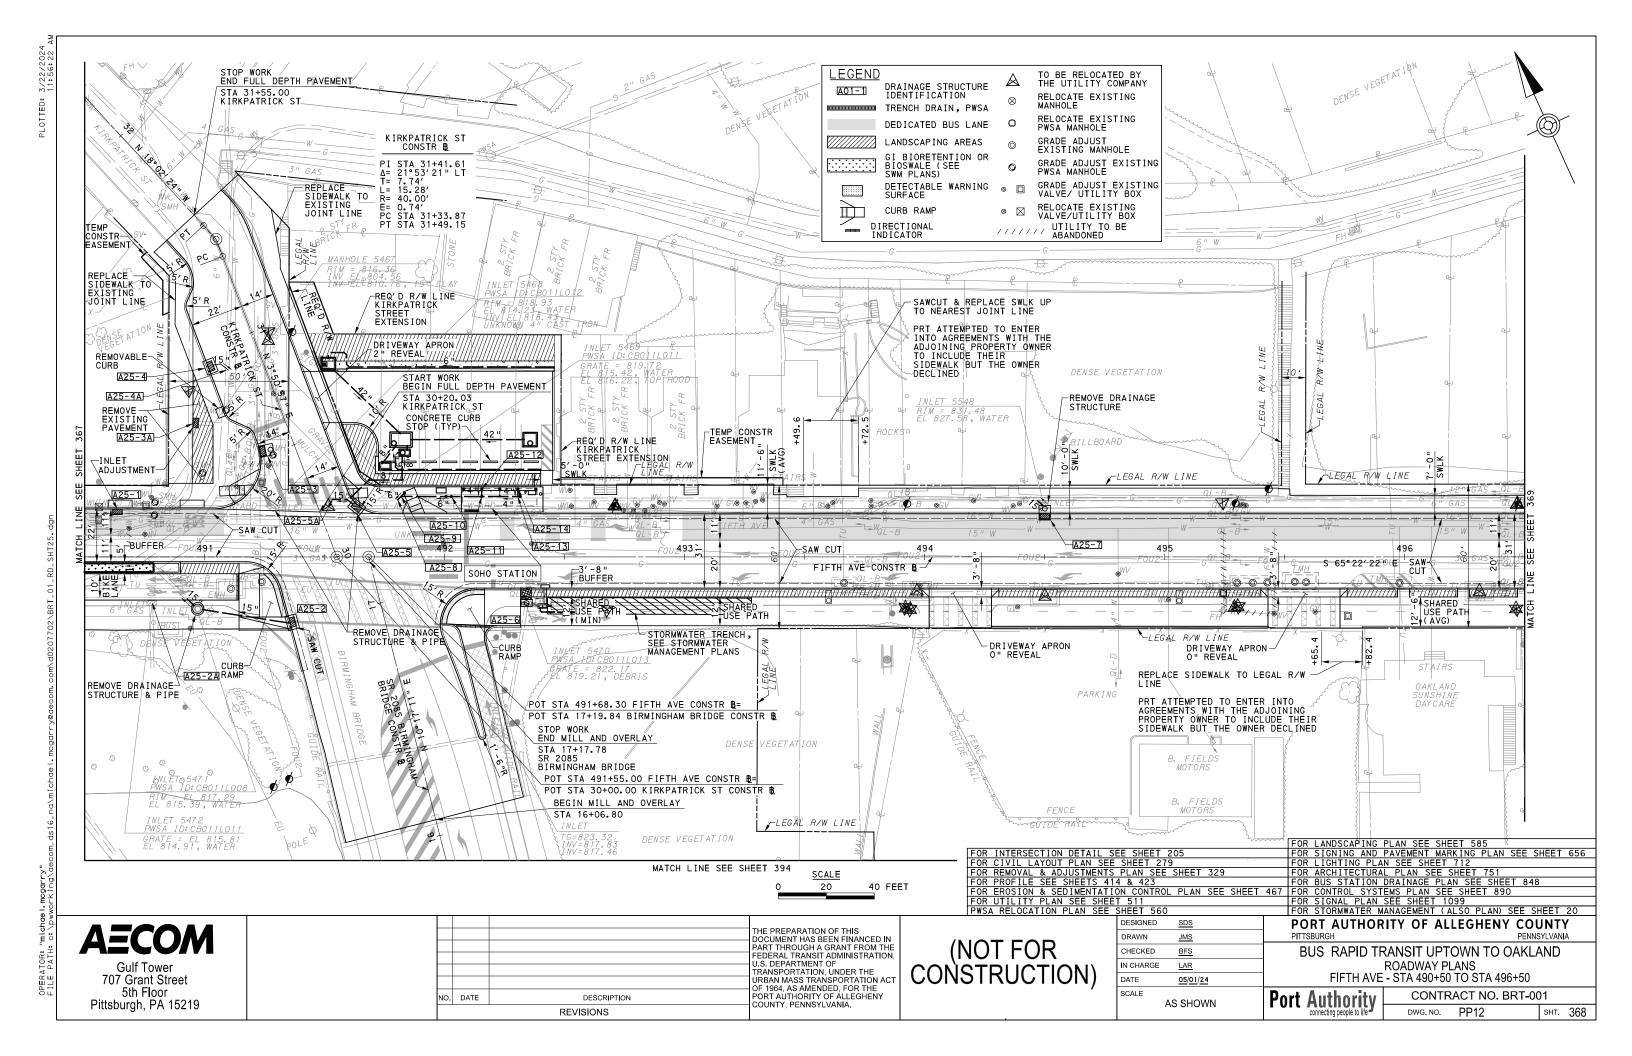


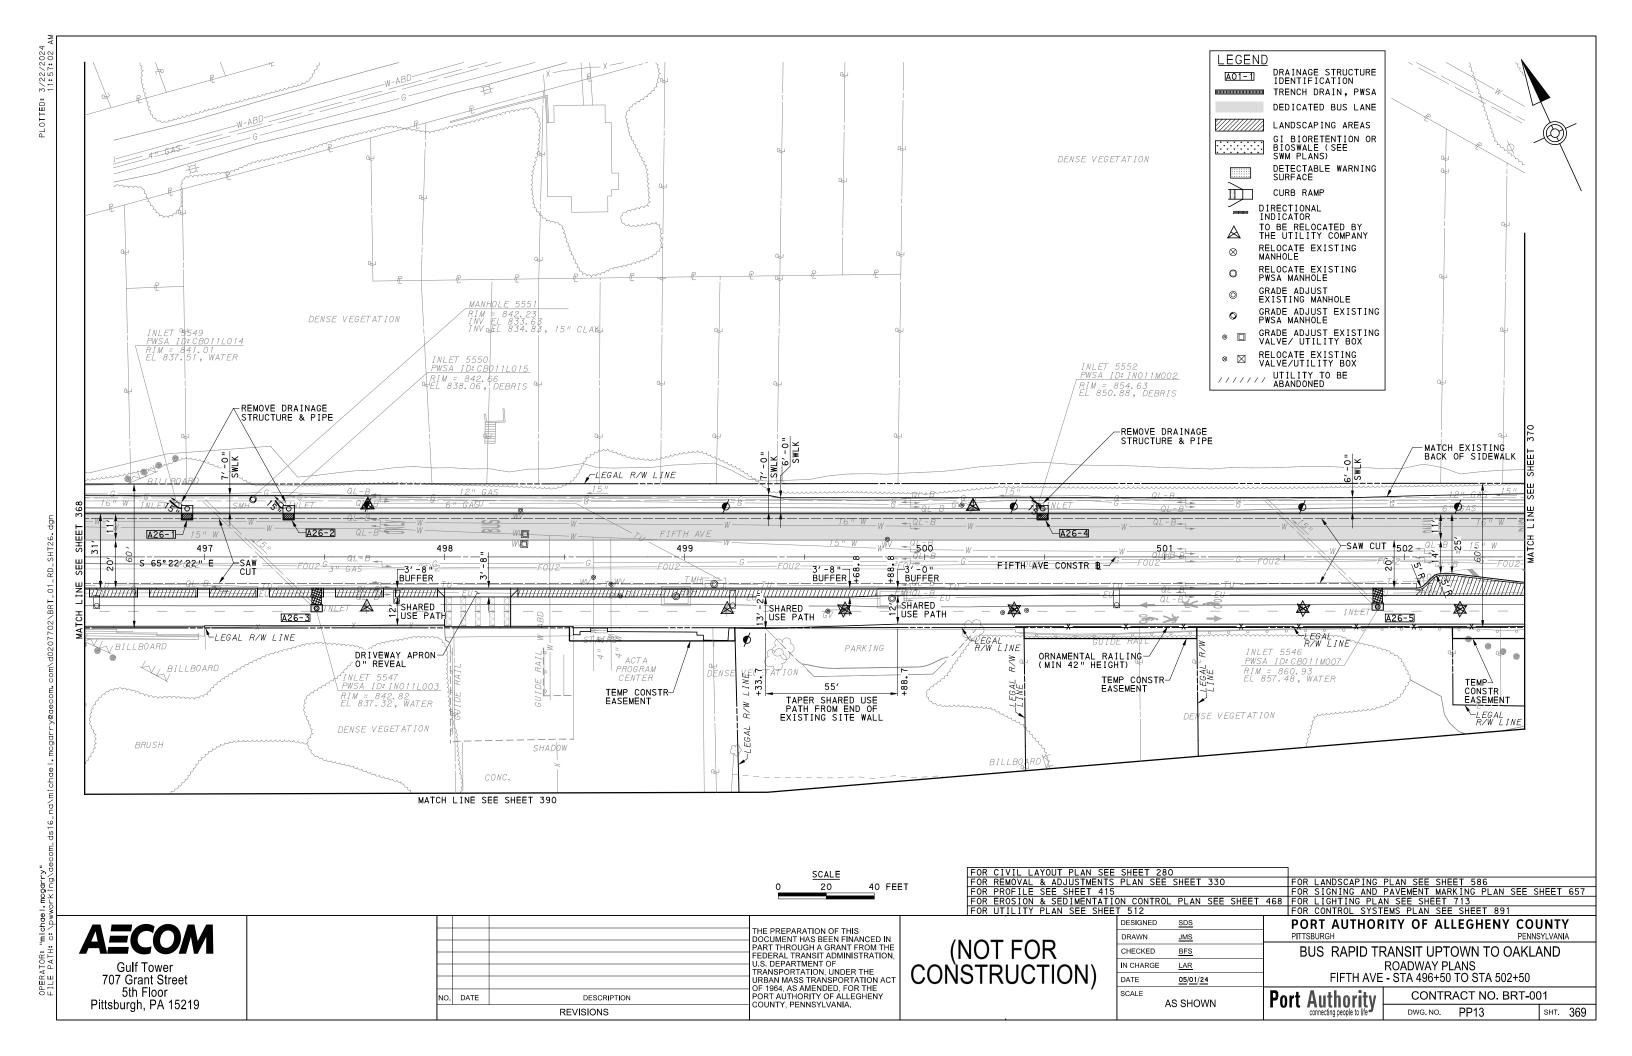


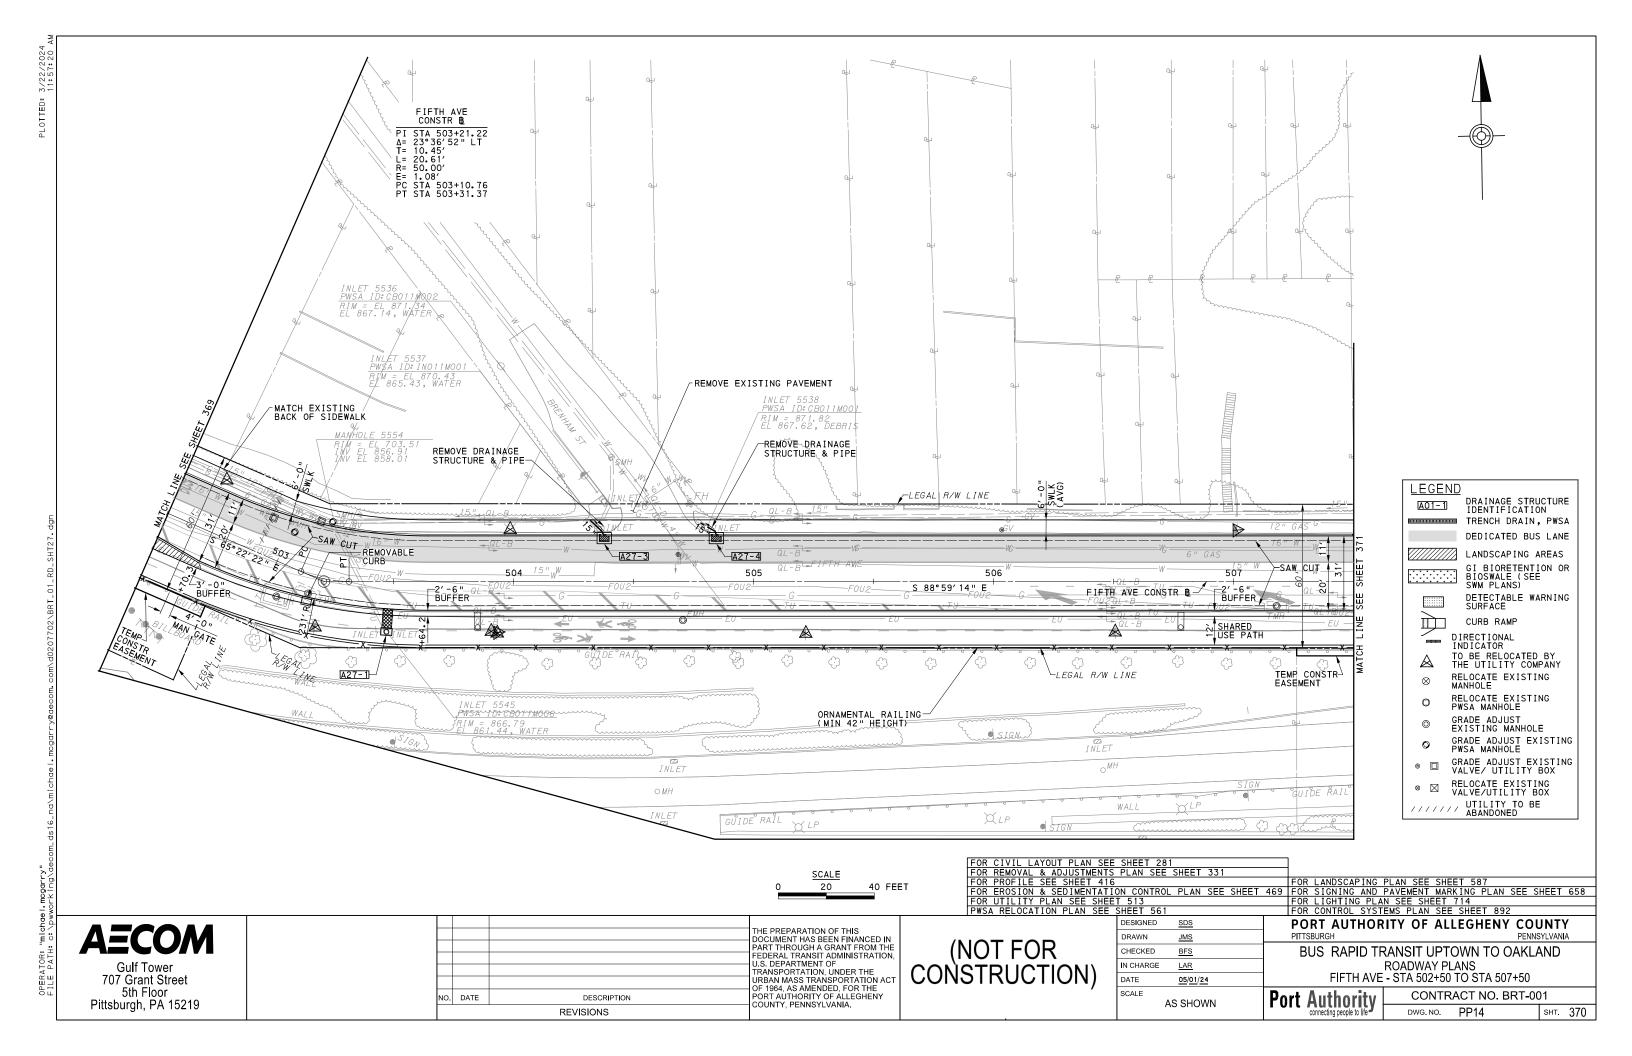


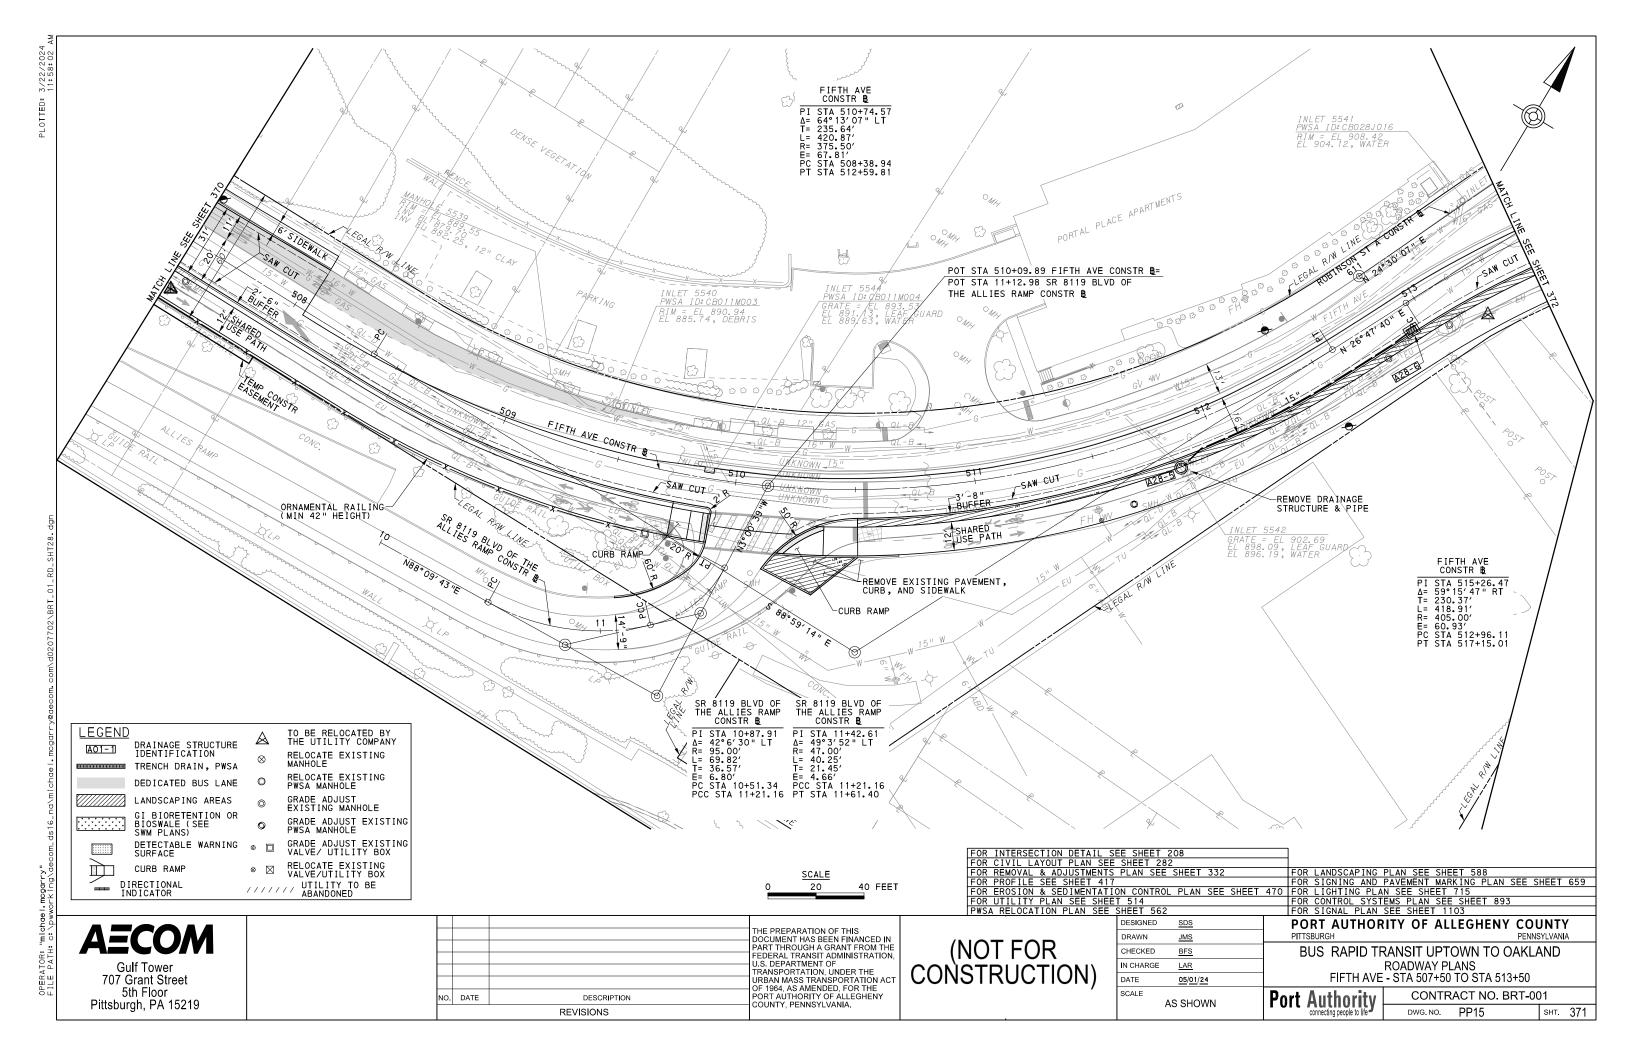


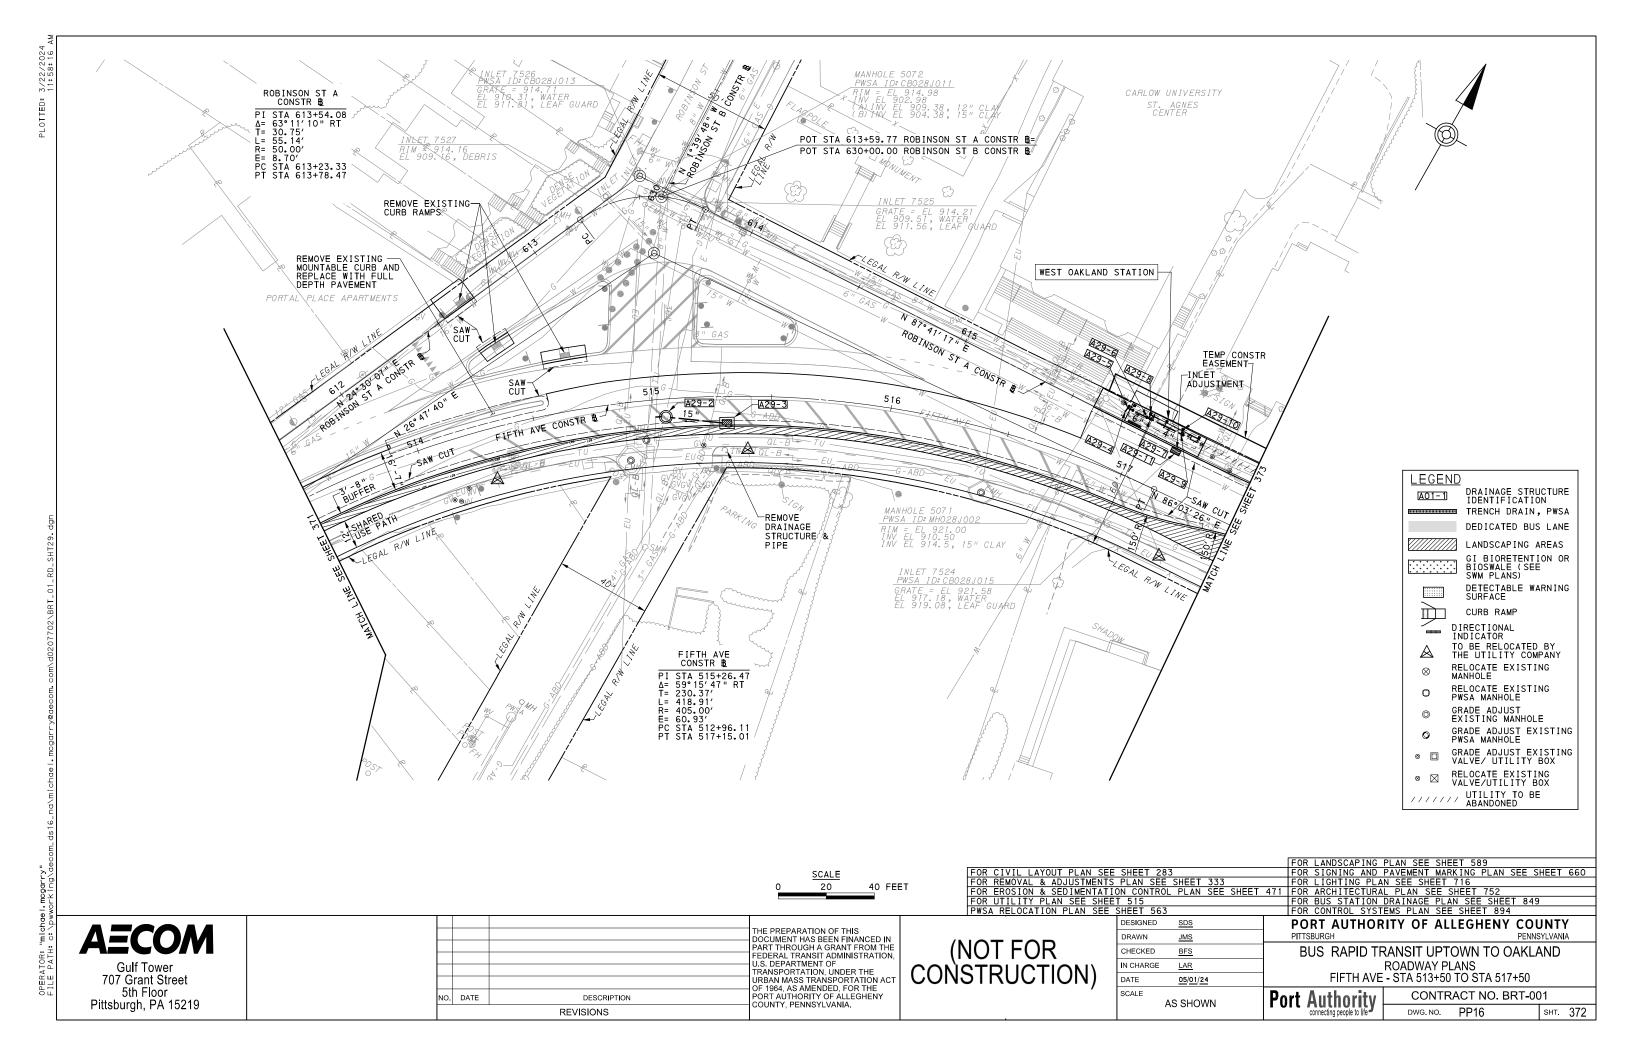


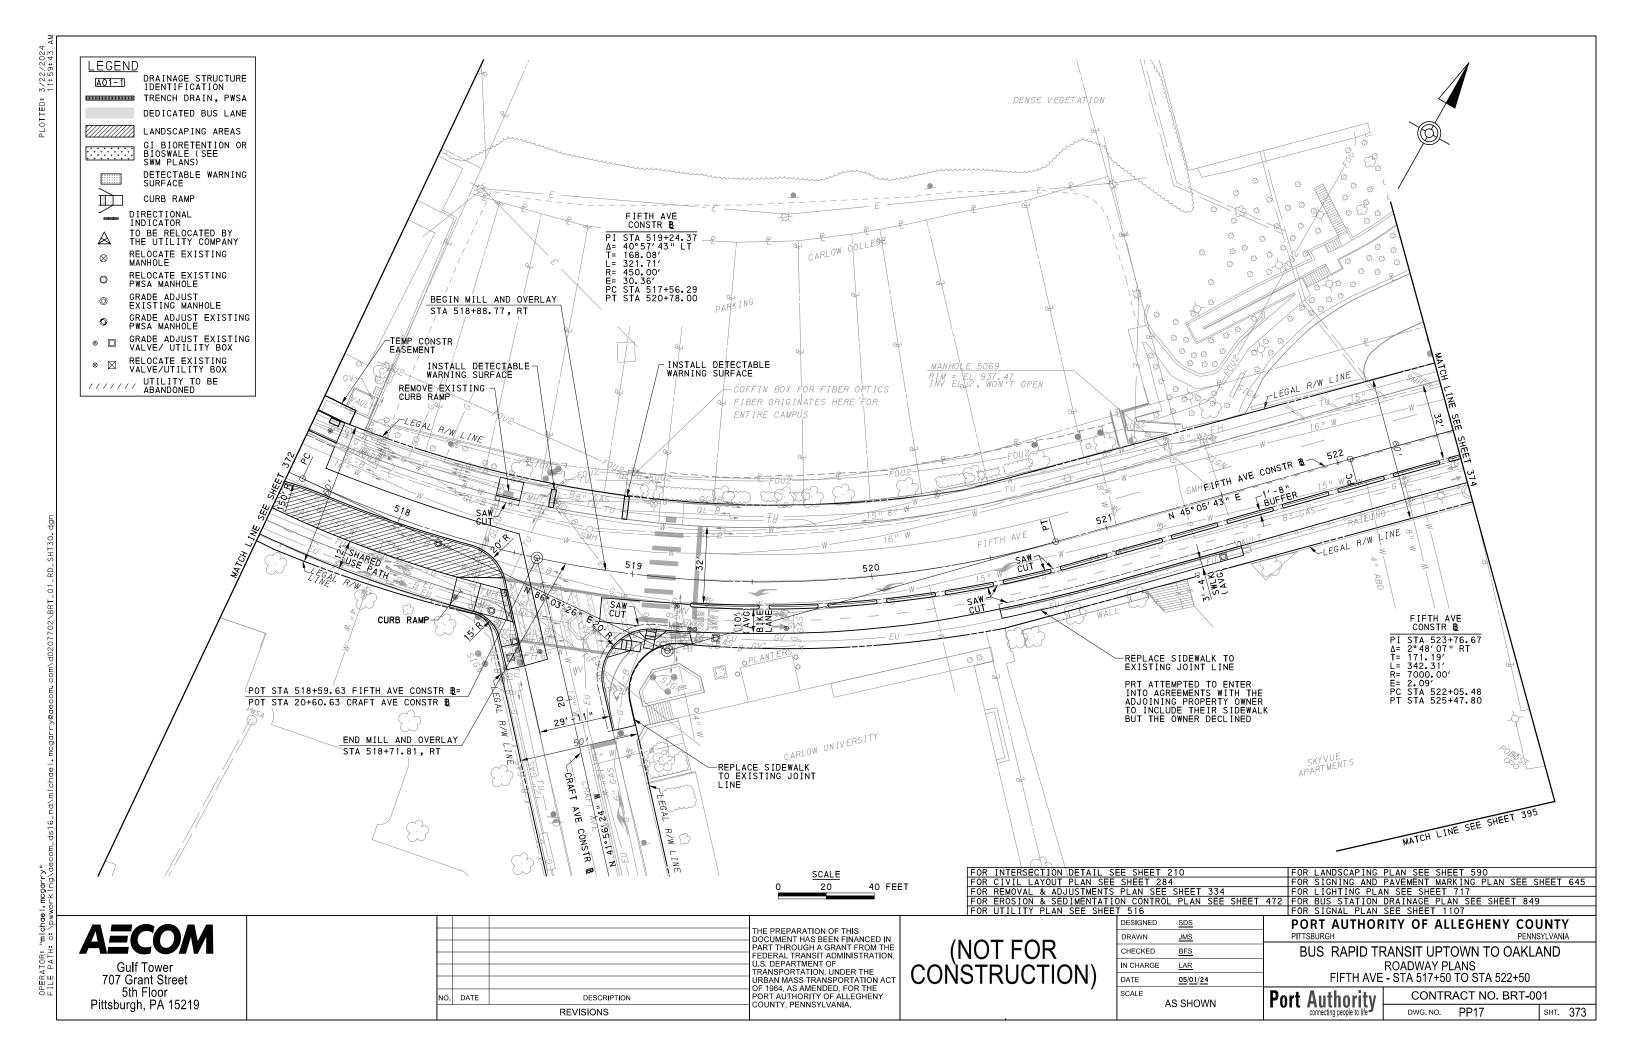


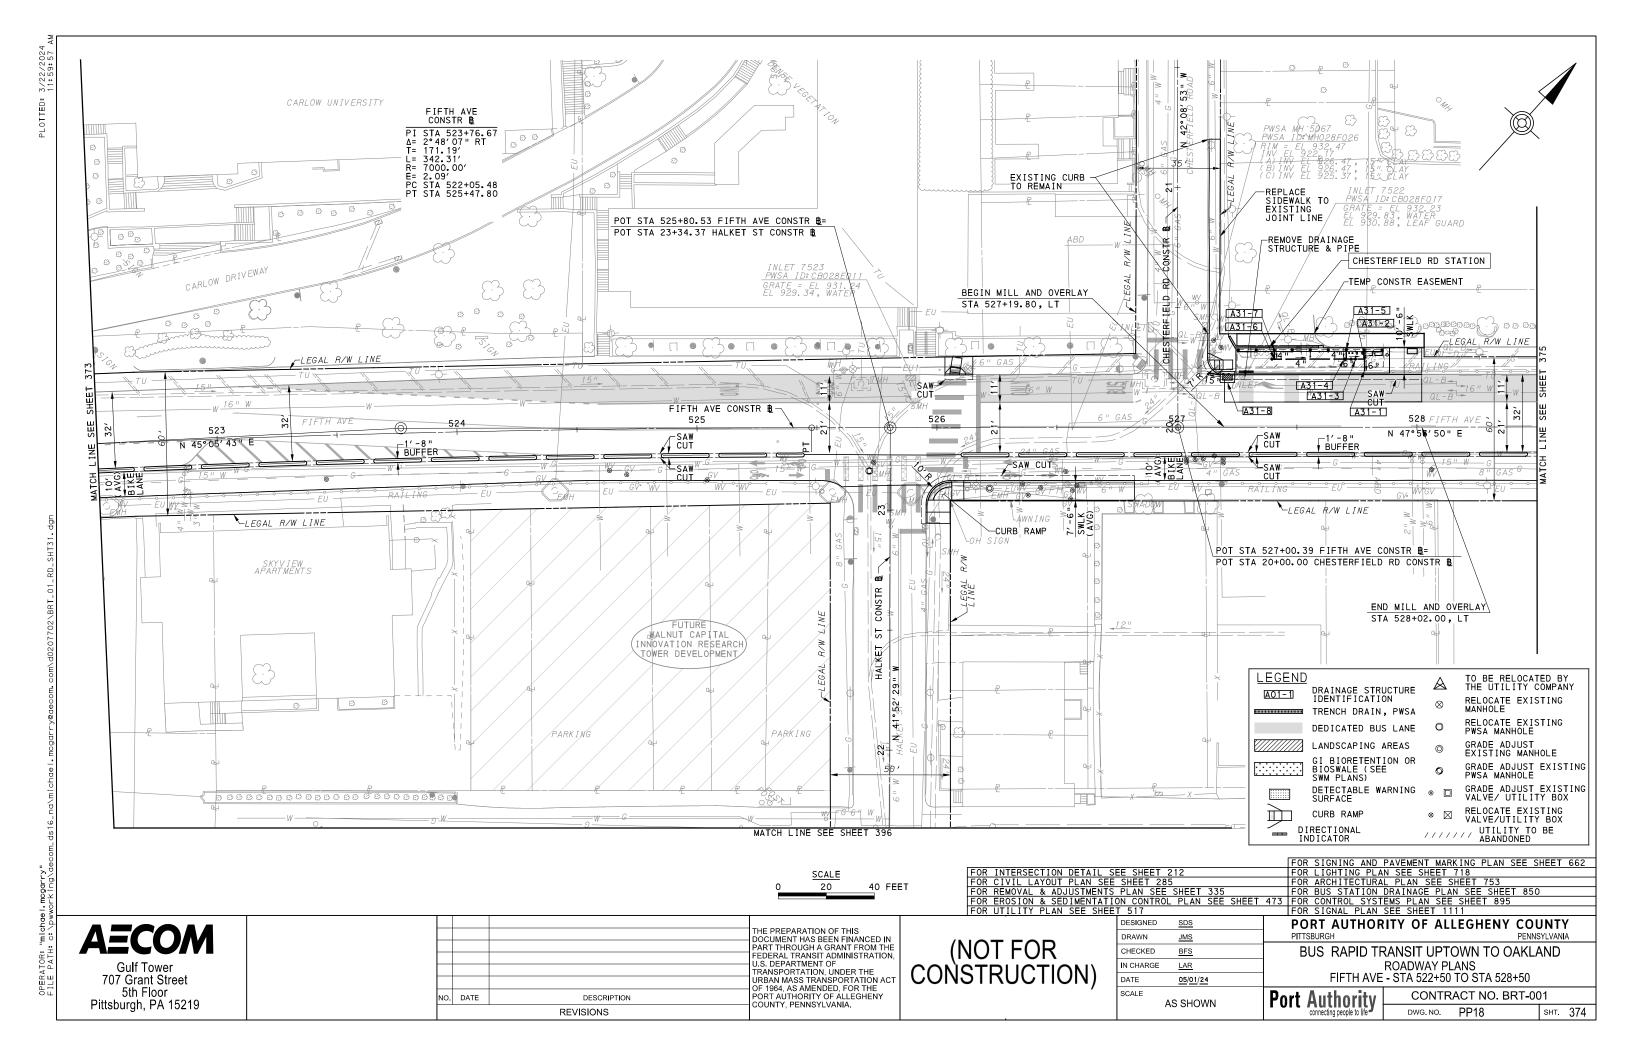


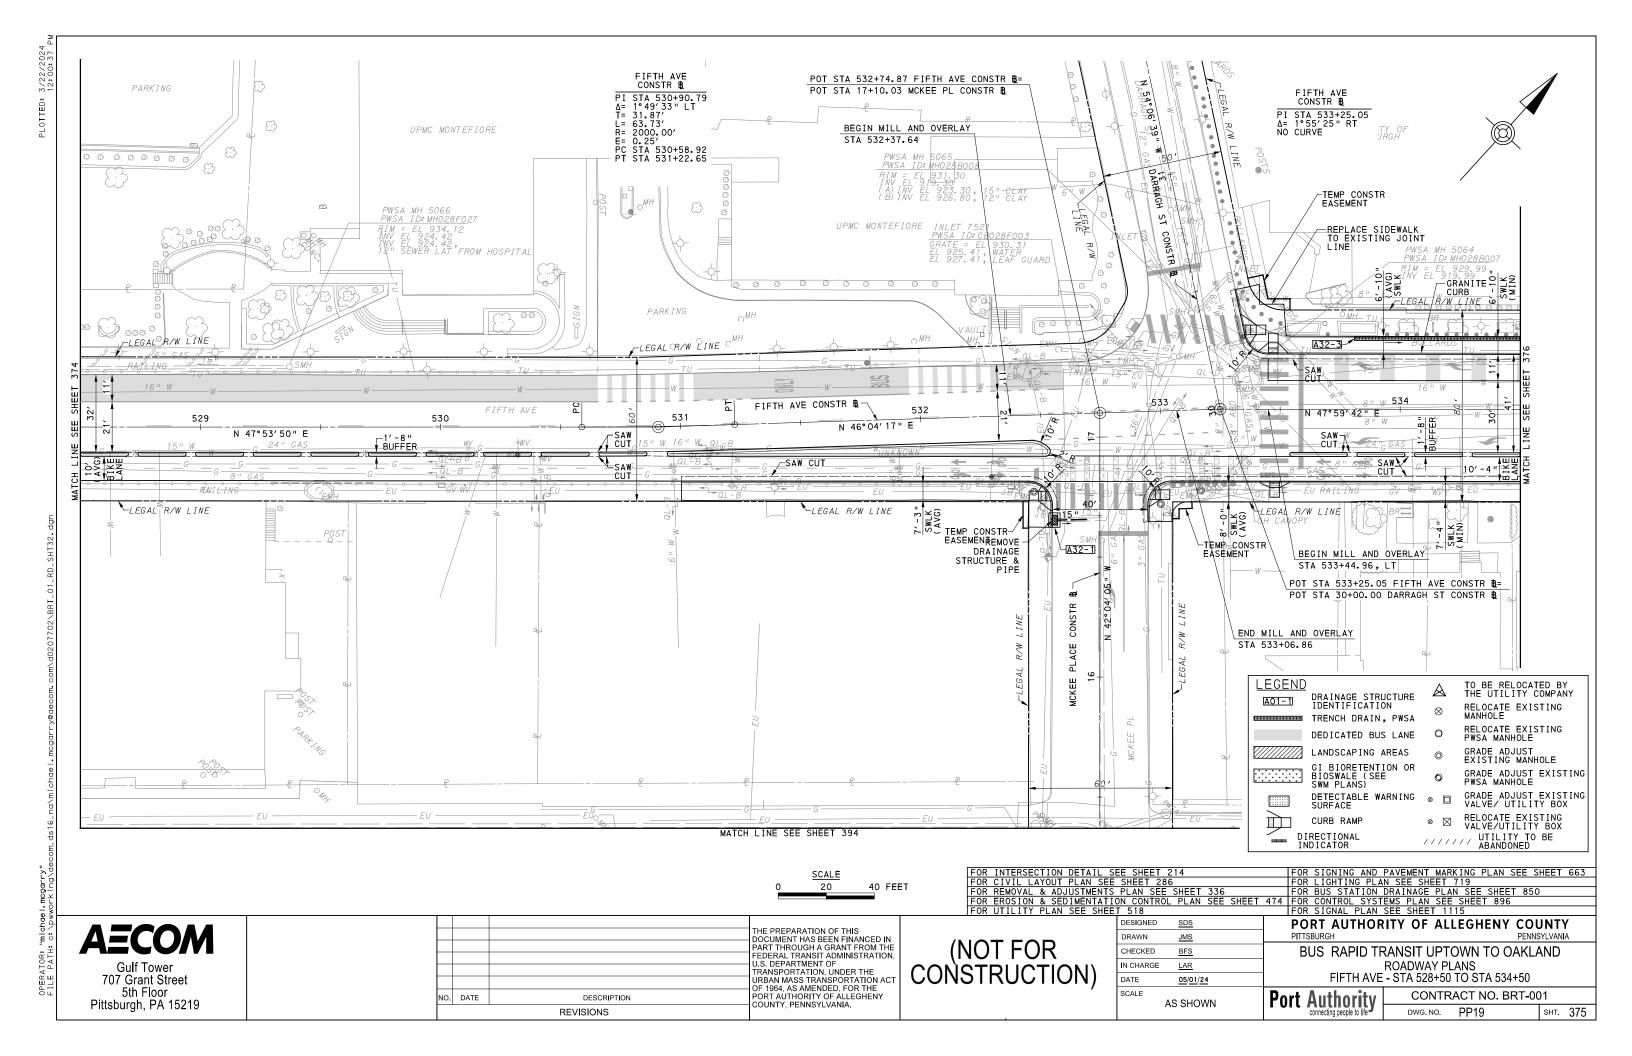

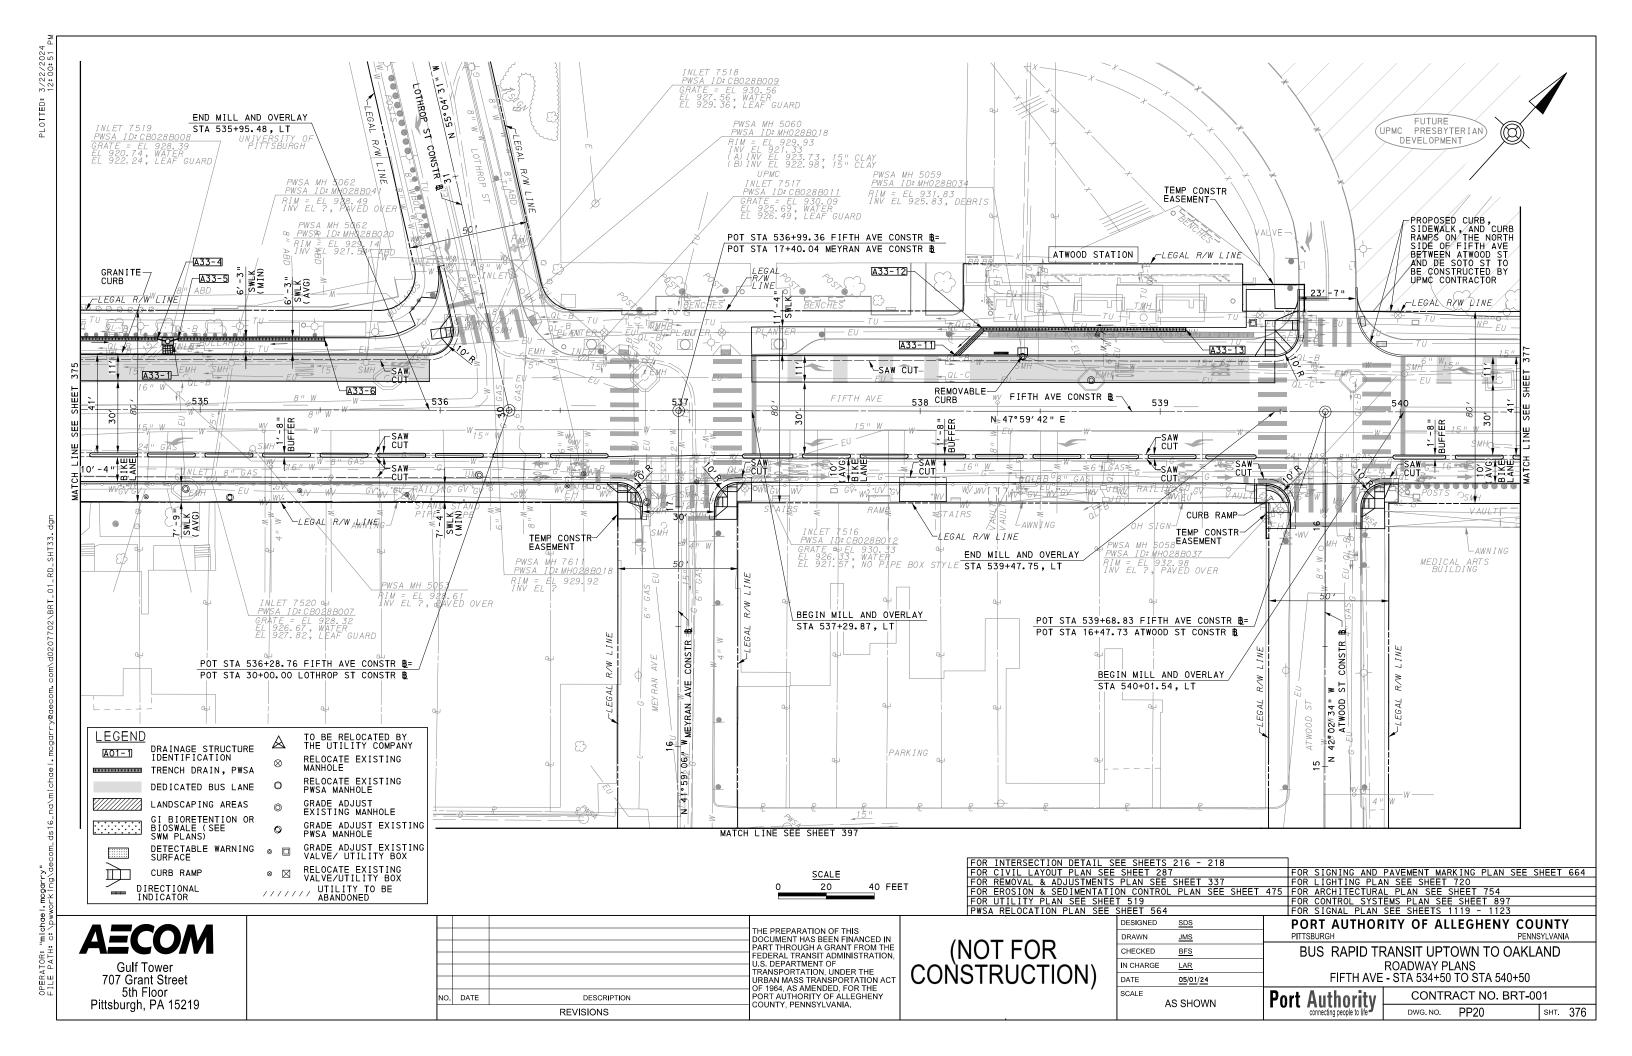


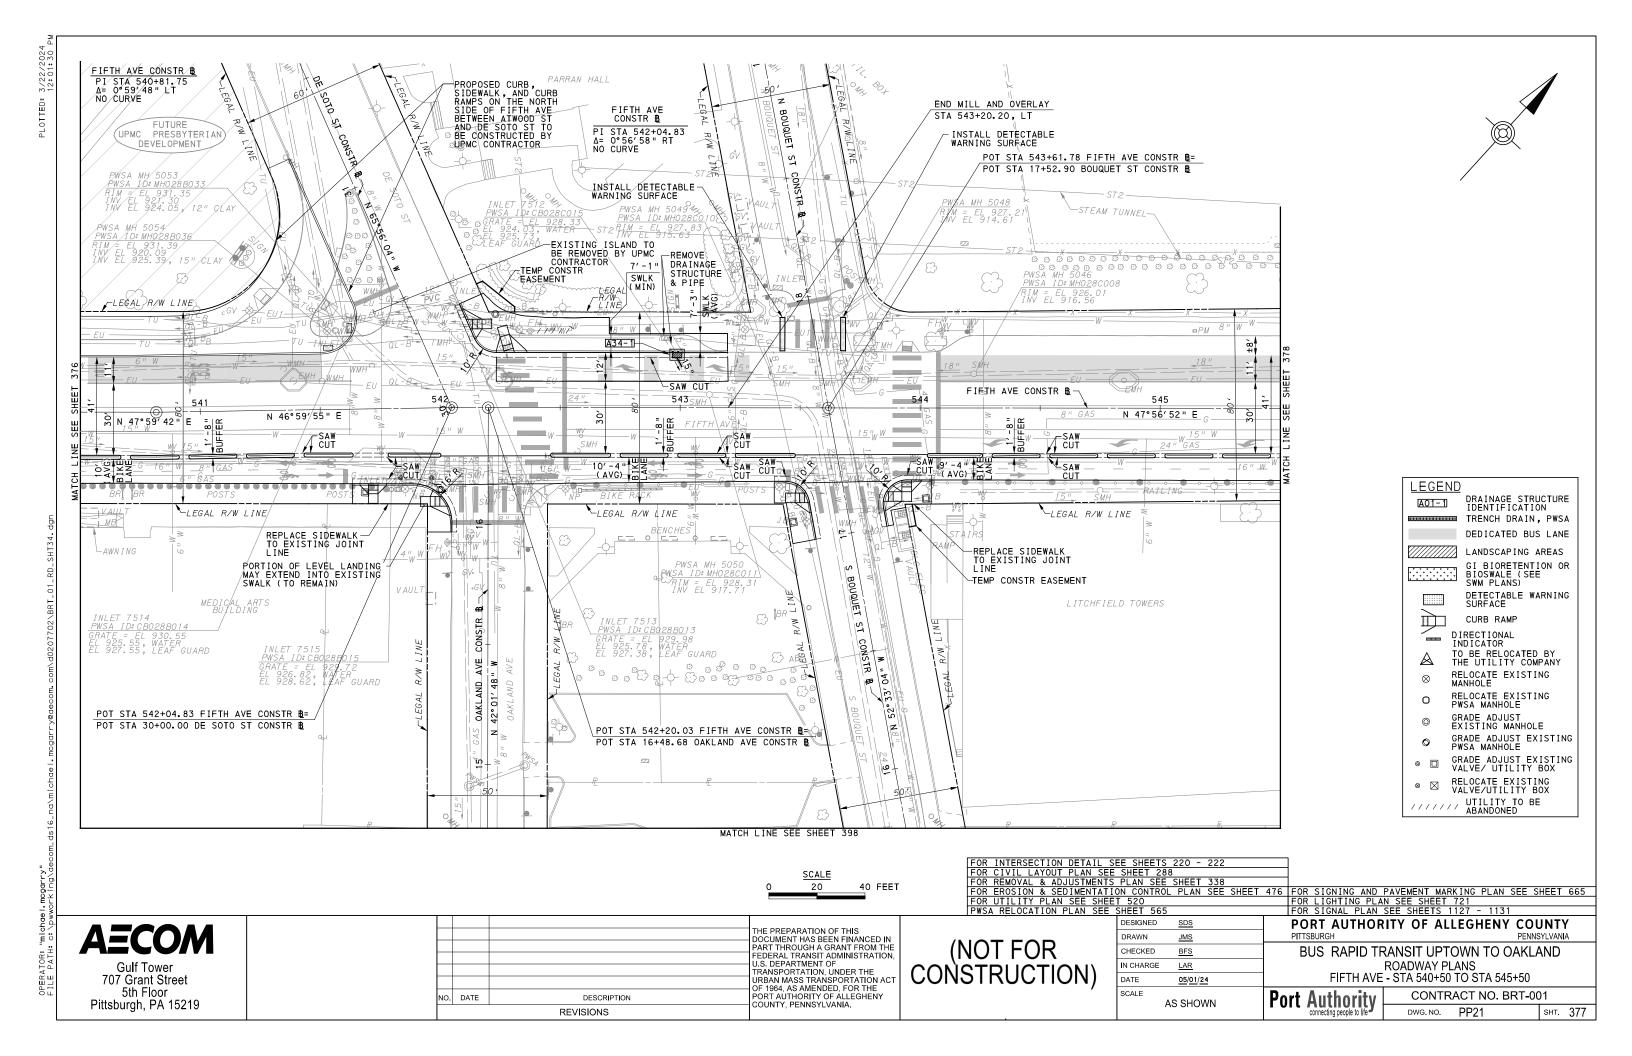


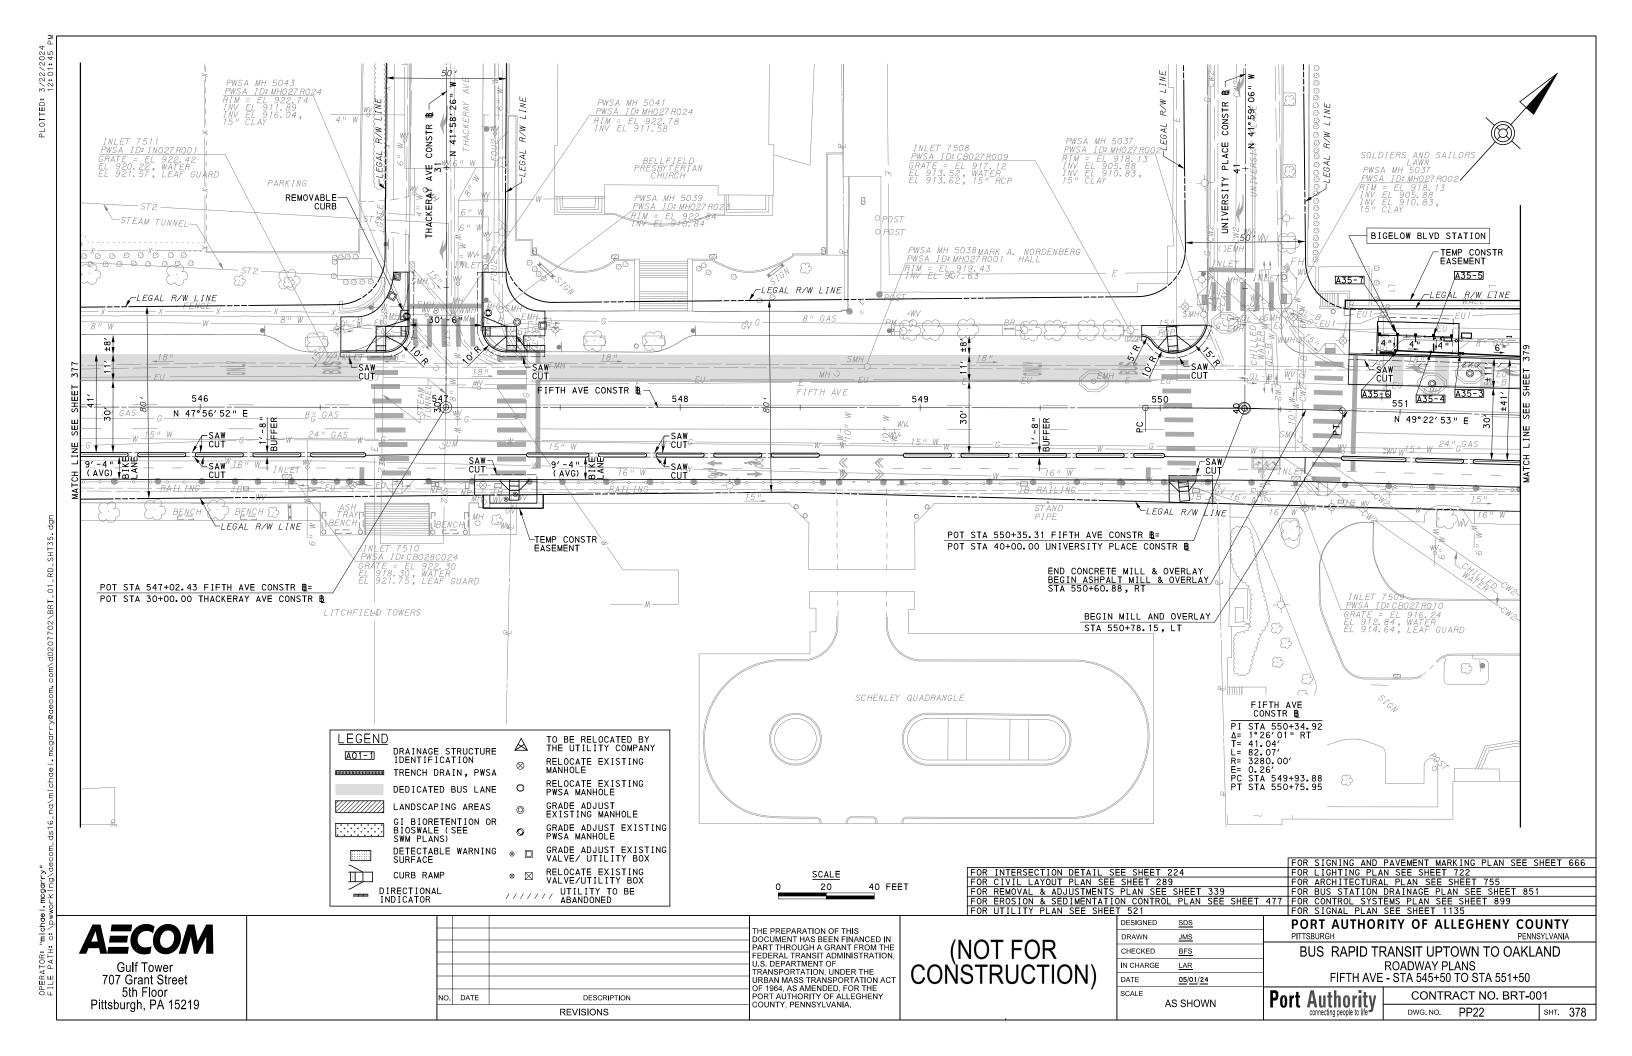


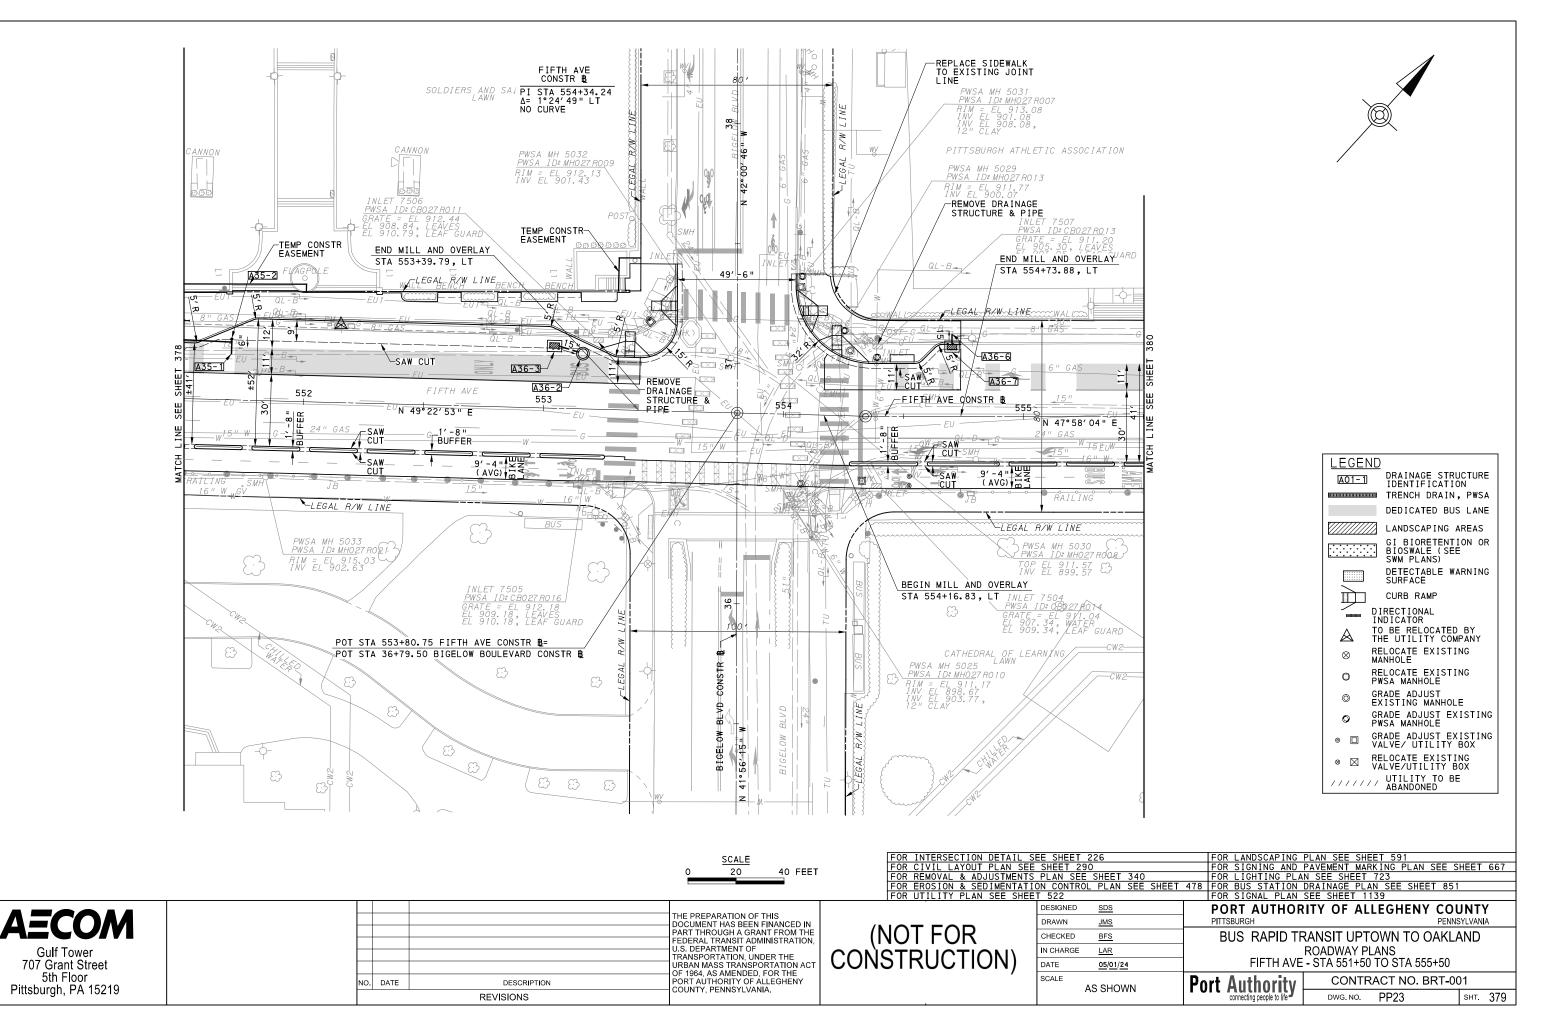

OPERATOR: "michael.mogarry" File Path: c:/bwworkjod/decam ds16 pd/michael modarry@decam o

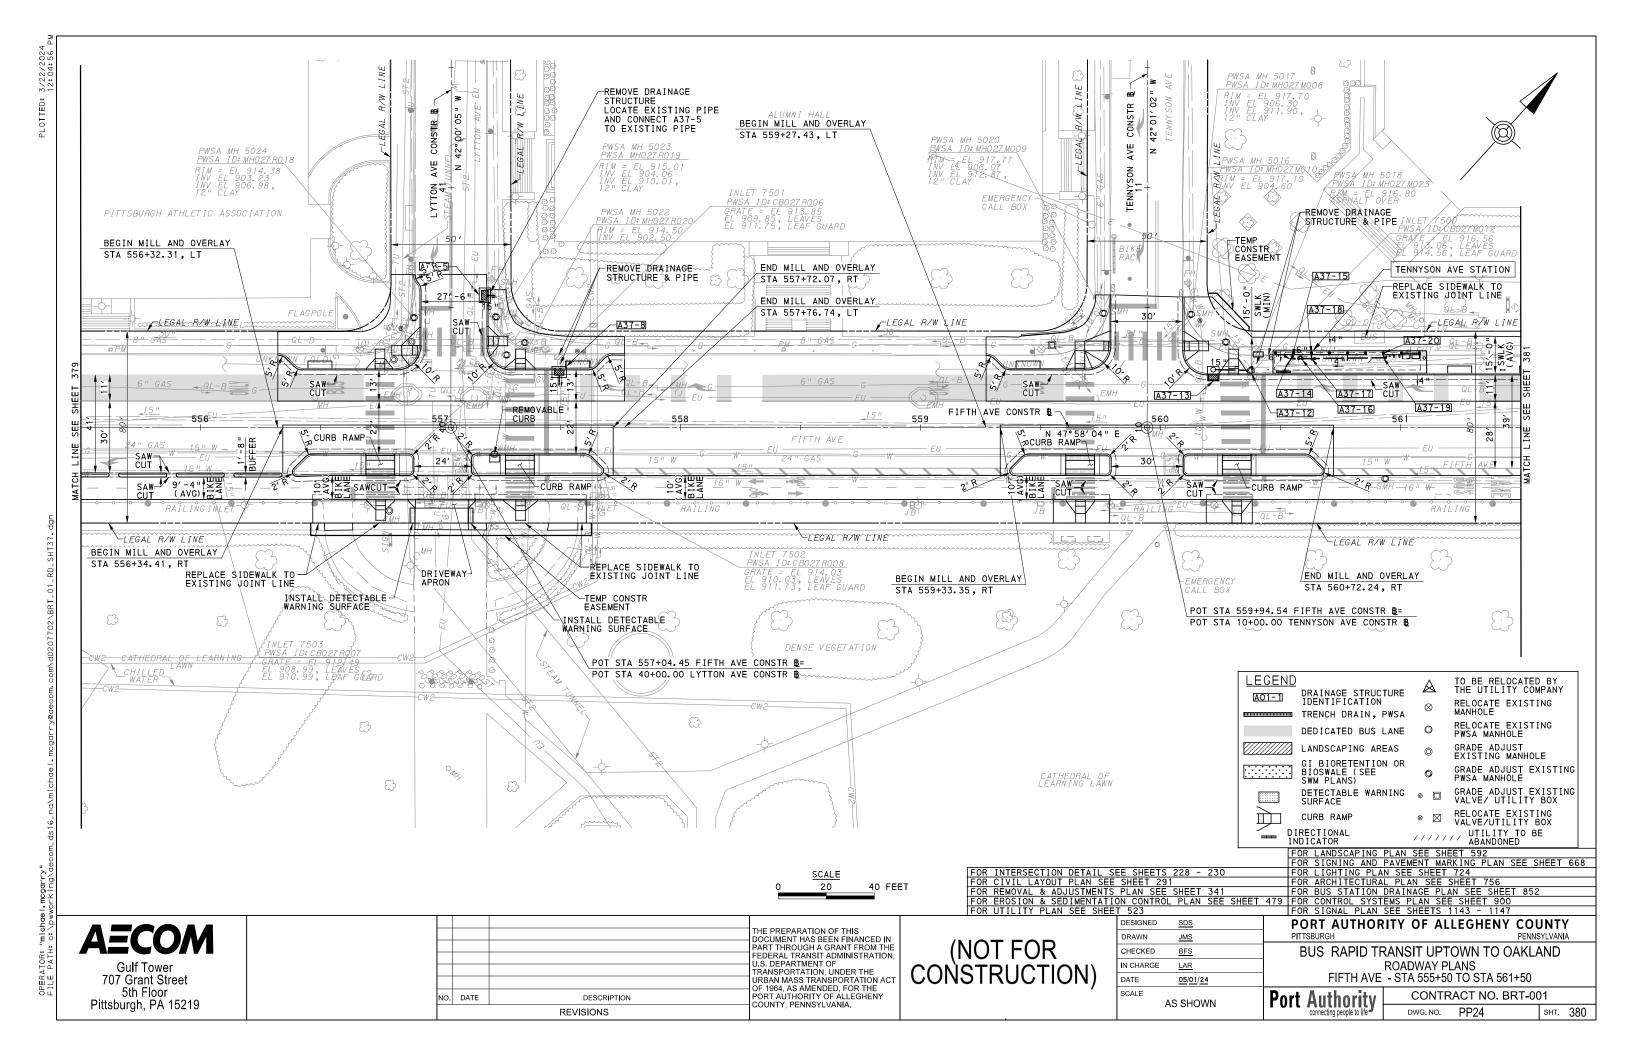

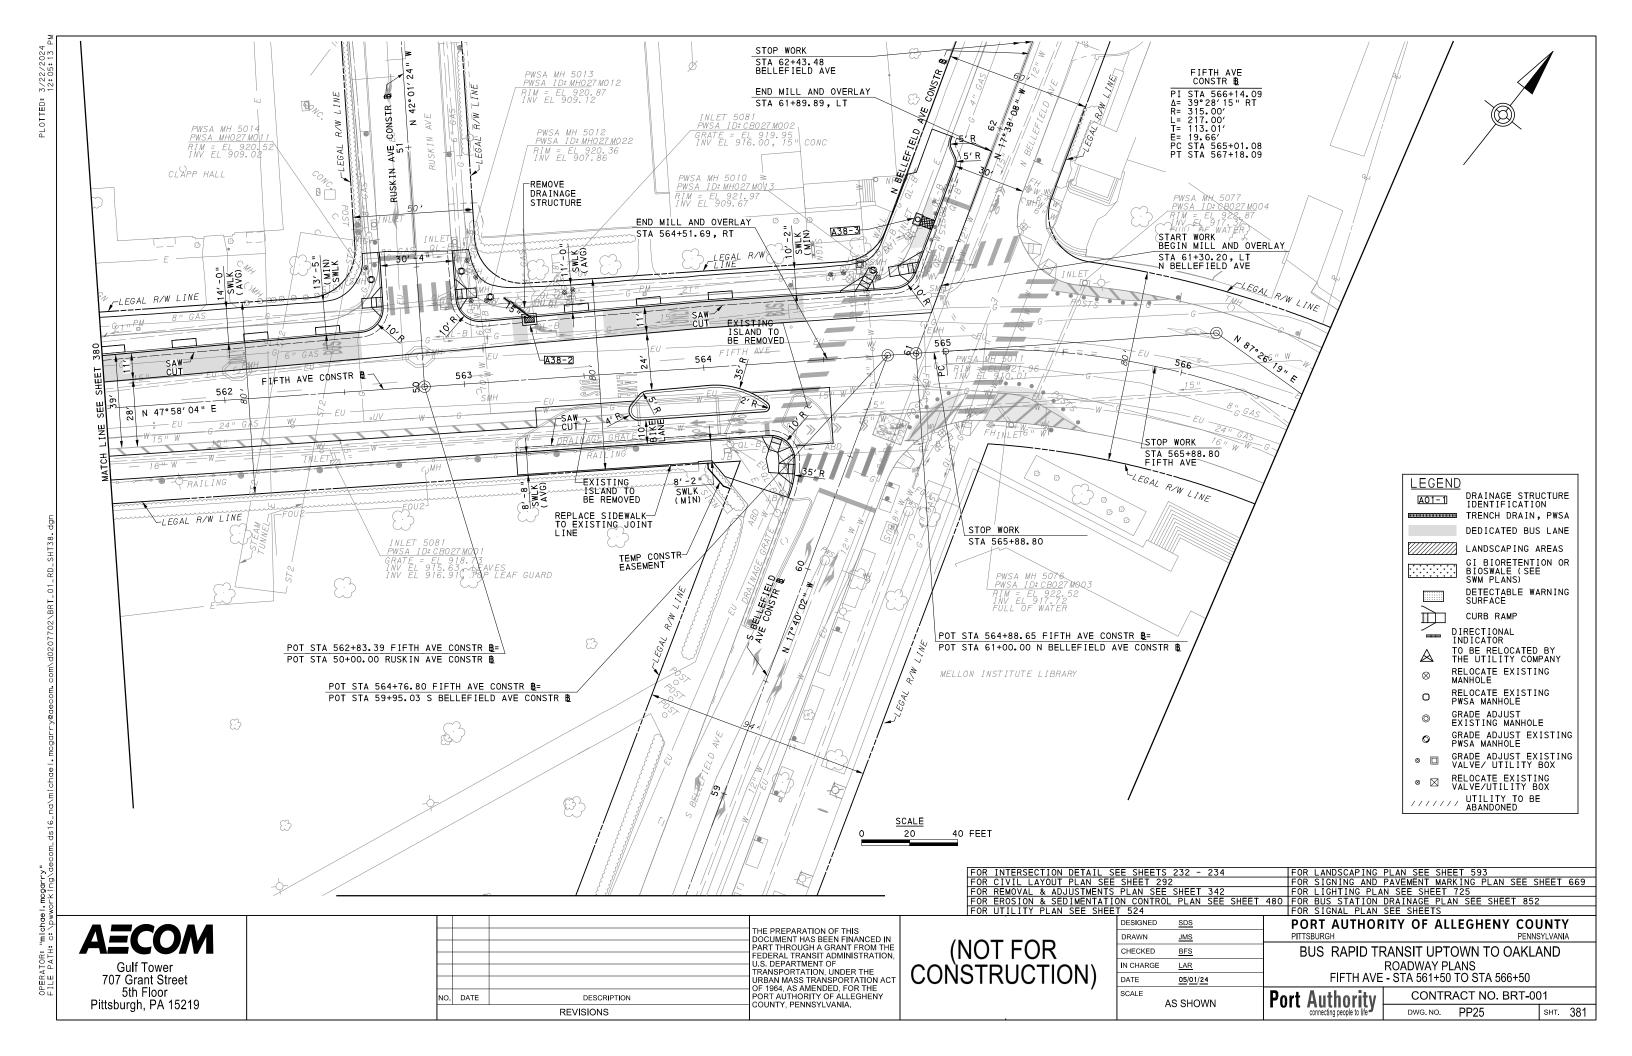

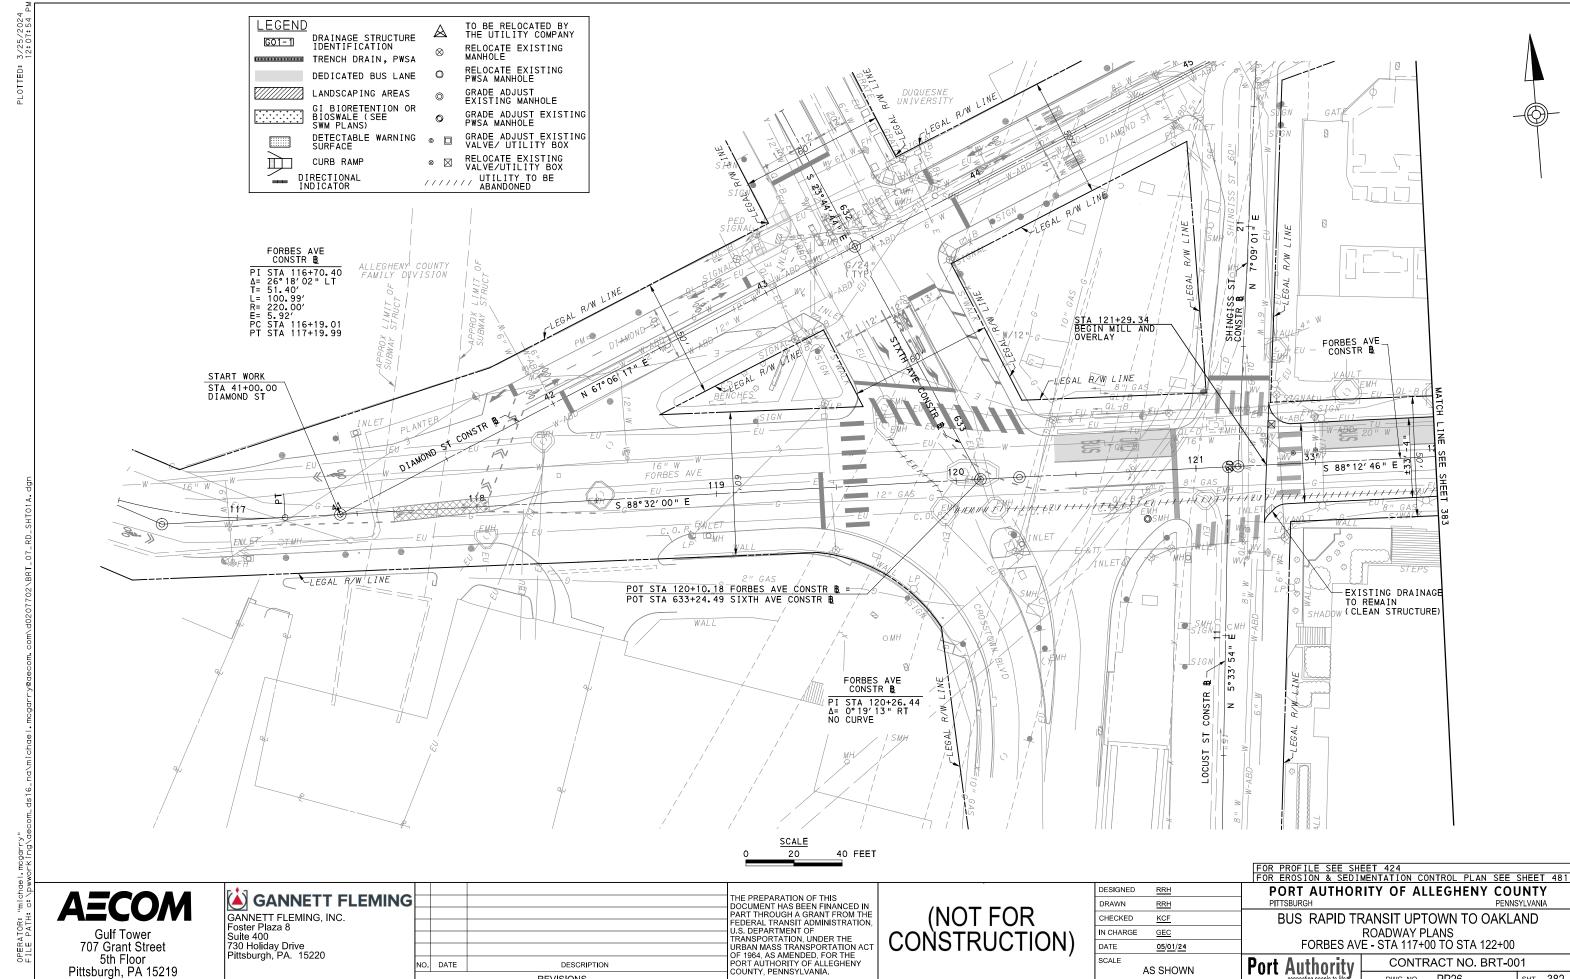

**Port Authority** 

DWG. NO.

PP26


sнт. 382

AS SHOWN


NO. DATE

DESCRIPTION

REVISIONS

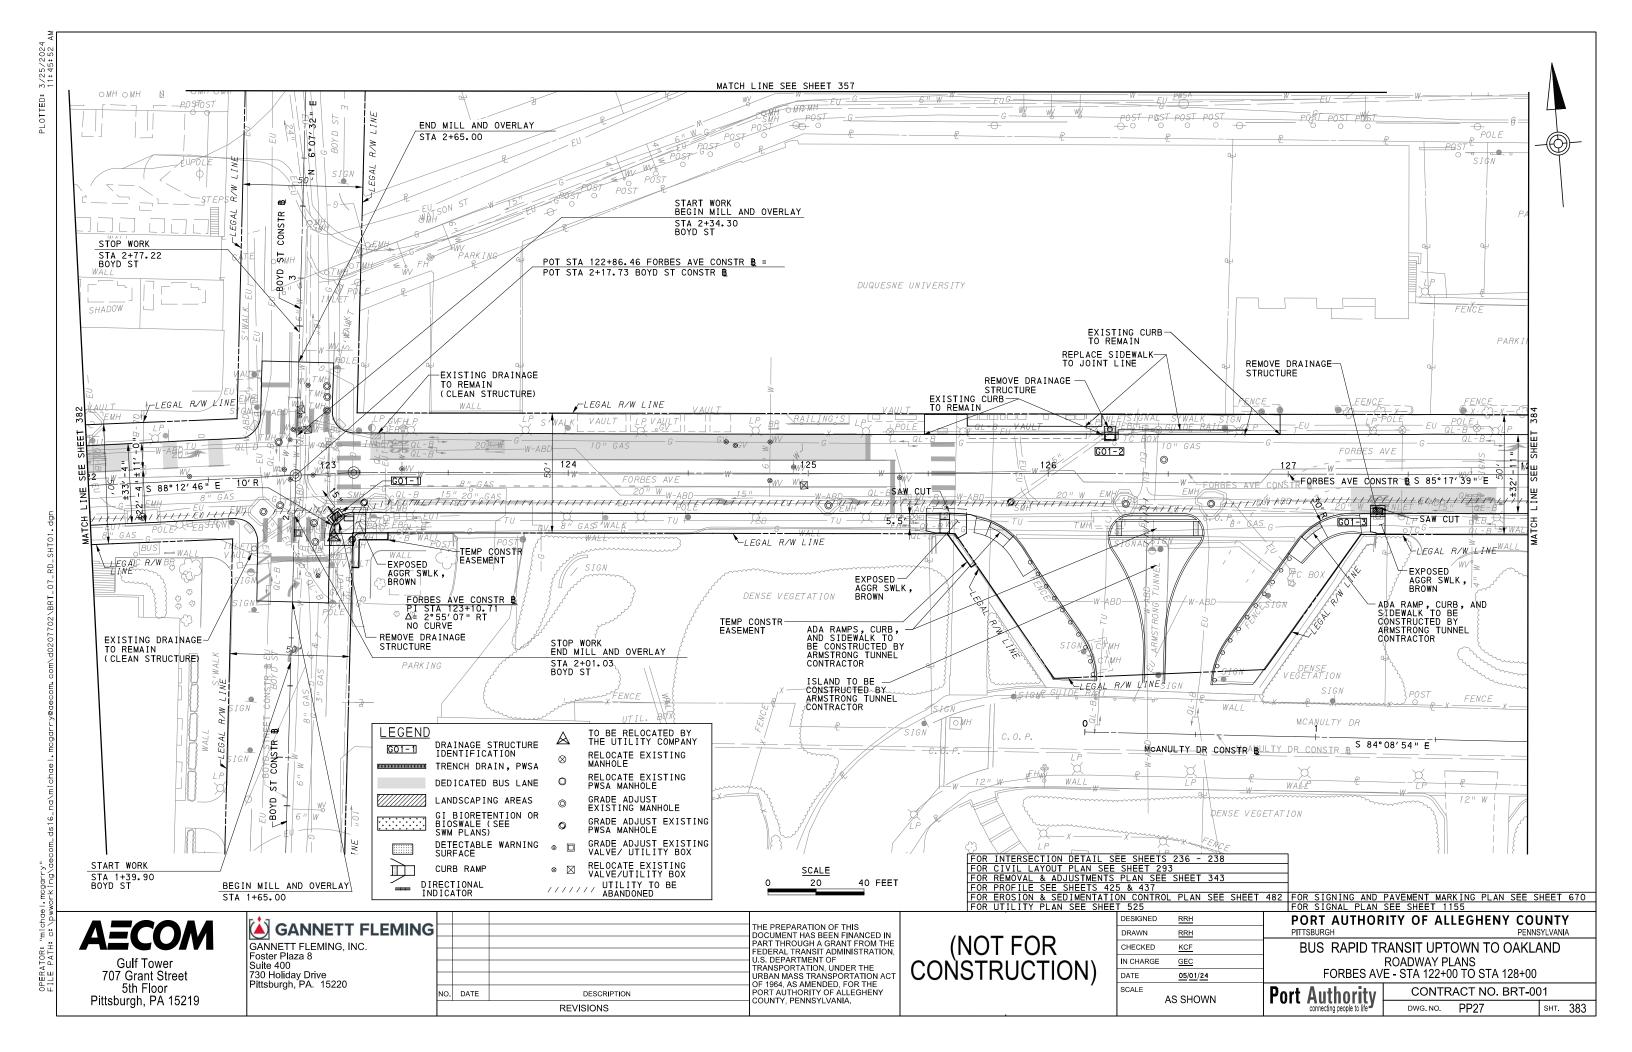

STOP WORK

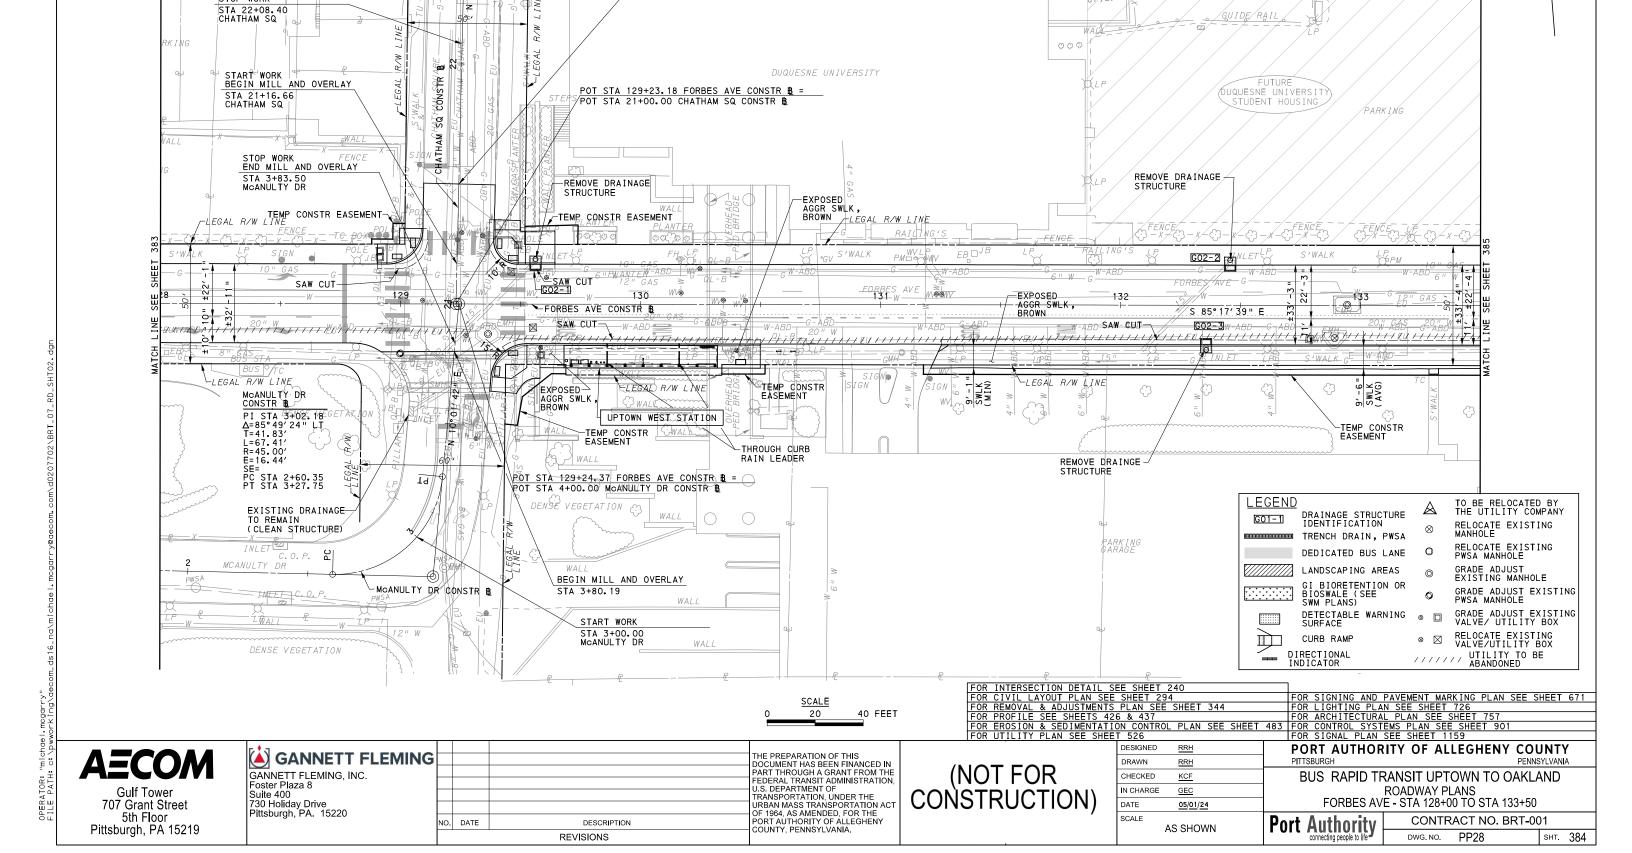


MATCH LINE SEE SHEET 358

END MILL AND OVERLAY

STA 21+50.00

GUIDE KAIL

UTIL.

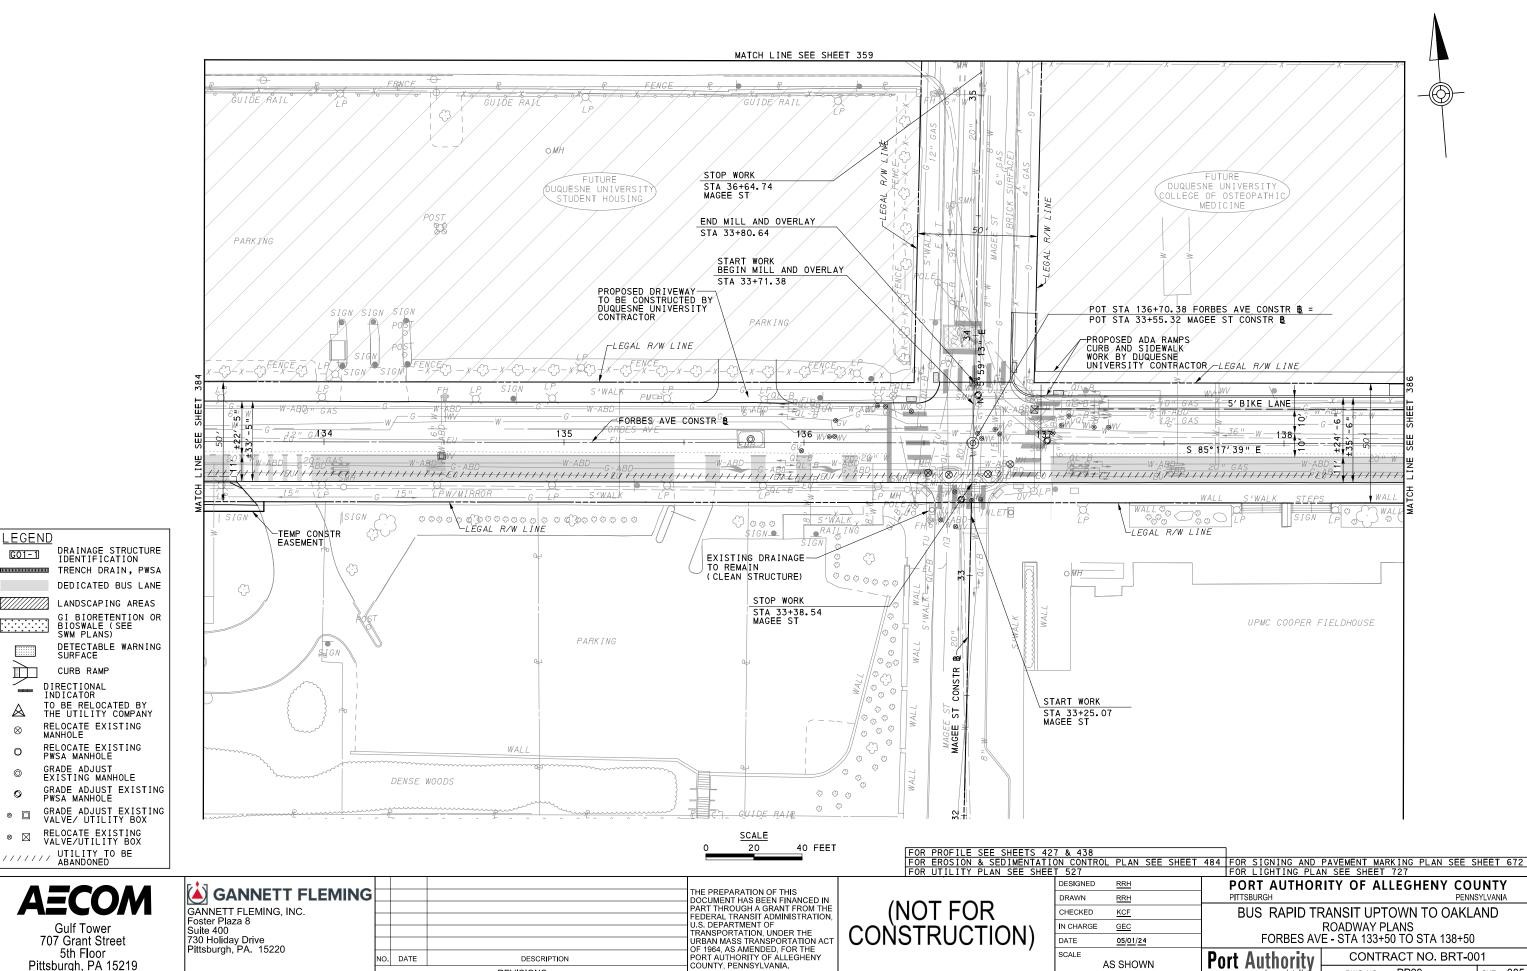

REVISIONS

AS SHOWN

PP29


DWG NO

sнт. 385

**LEGEND** 

G01-1



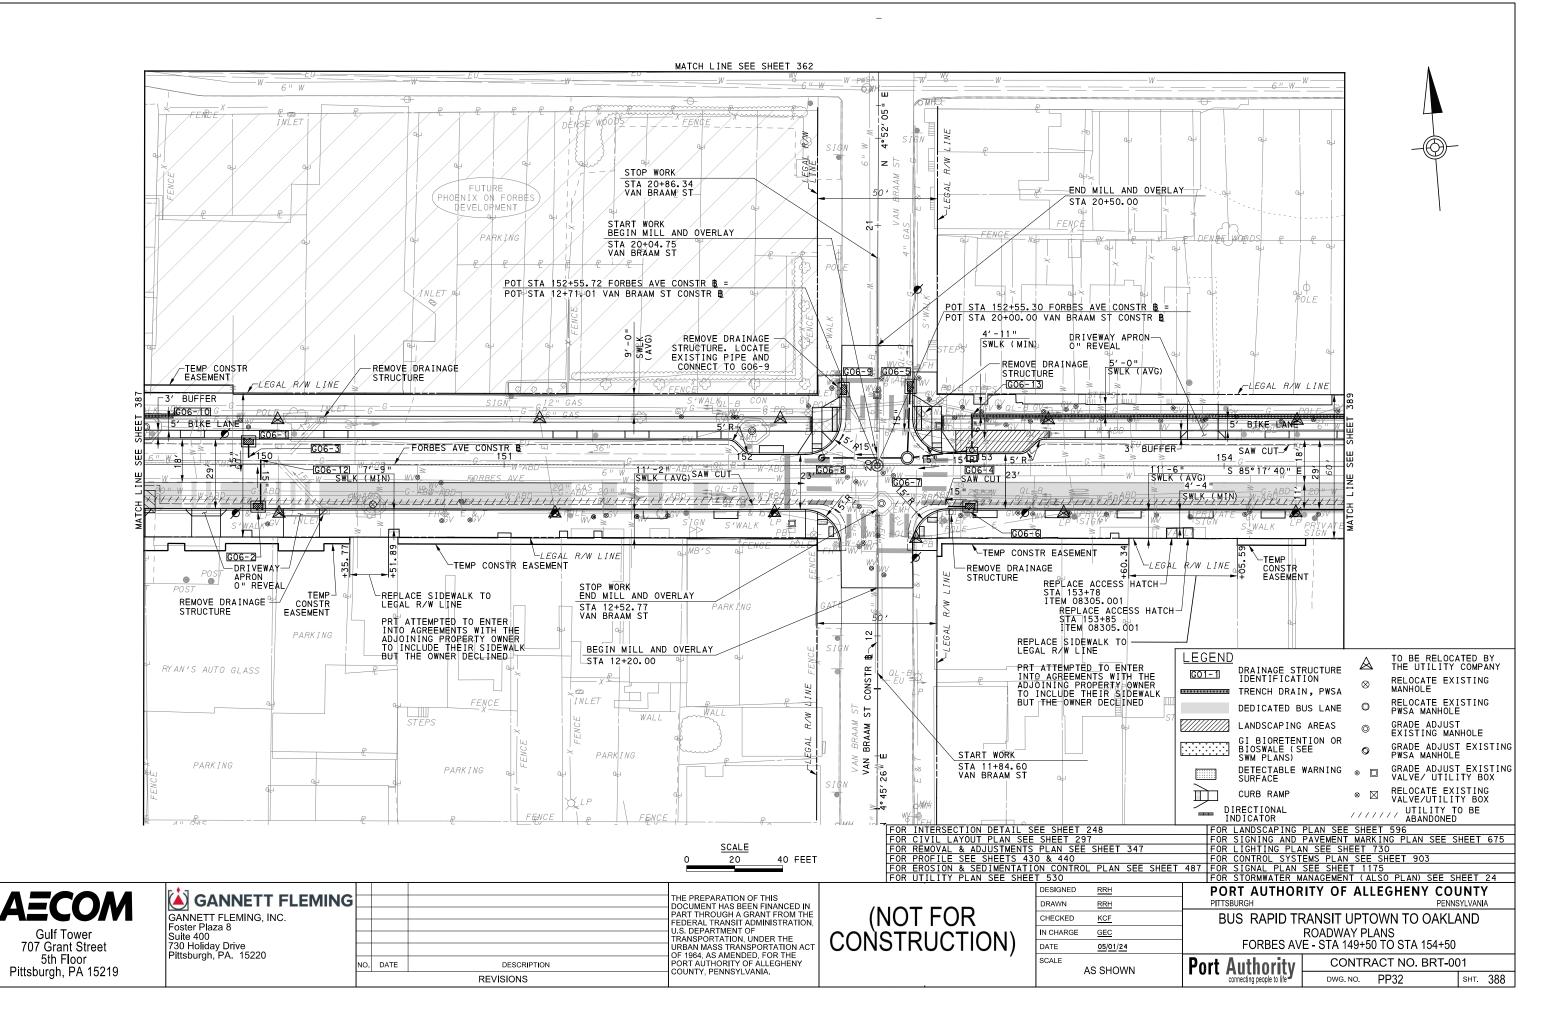


OMH

FENCE

STOP WORK

MILTENBERGER ST

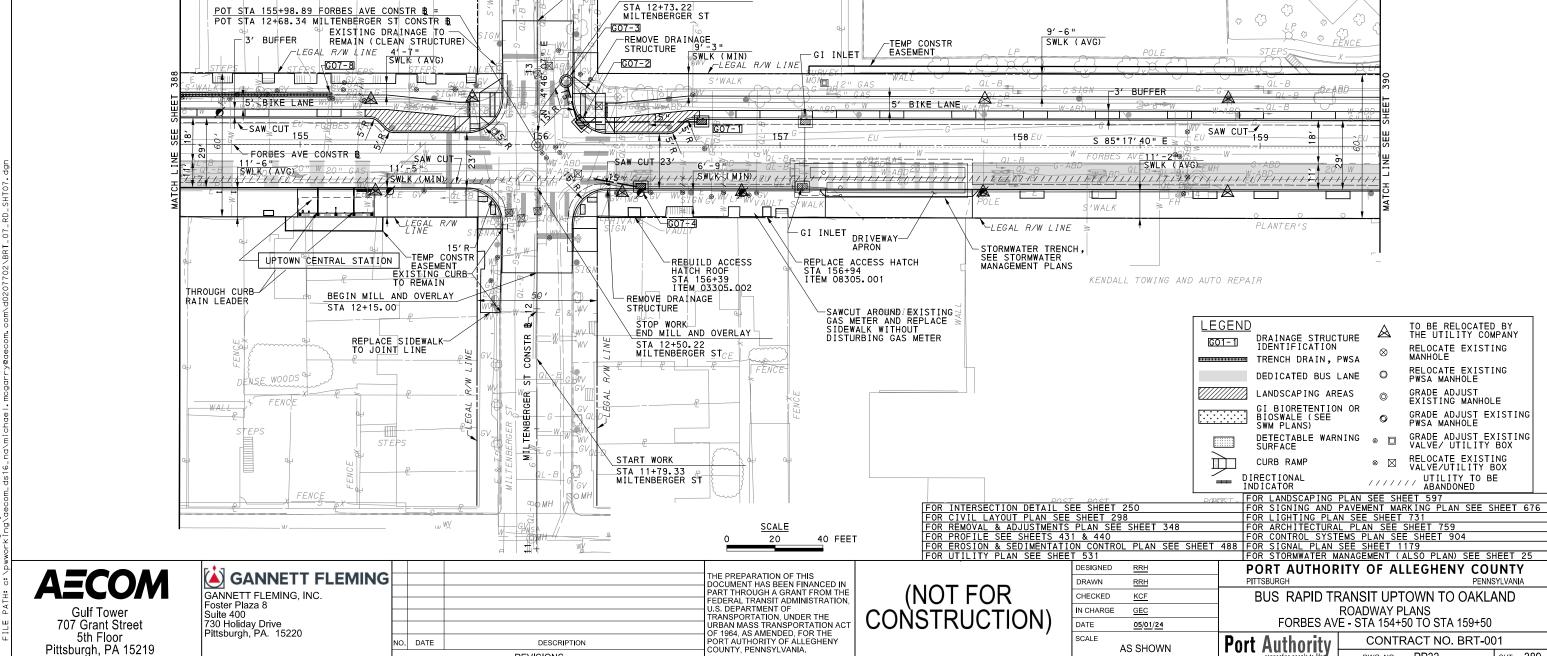

REVISIONS

MATCH LINE SEE SHEET 363

POST

LP0S7

POST POST

OMH

END MILL AND OVERLAY

START WORK BEGIN MILL AND OVERLAY

STA 13+20.00

PARKING

SAW CUT-159

<u>LEGEND</u>

PLANTER'S

DRAINAGE STRUCTURE IDENTIFICATION

TRENCH DRAIN, PWSA

DEDICATED BUS LANE

LANDSCAPING AREAS GI BIORETENTION OR BIOSWALE (SEE

DETECTABLE WARNING

SWM PLANS)

CURB RAMP

**Port Authority** 

TO BE RELOCATED BY THE UTILITY COMPANY

RELOCATE EXISTING MANHOLE

RELOCATE EXISTING PWSA MANHOLE

GRADE ADJUST EXISTING PWSA MANHOLE

GRADE ADJUST EXISTING VALVE/ UTILITY BOX

RELOCATE EXISTING VALVE/UTILITY BOX

////// UTILITY TO BE ABANDONED

CONTRACT NO. BRT-001

sнт. 389

GRADE ADJUST EXISTING MANHOLE

 $\triangle$ 

0

⊗ ⊠

PORT AUTHORITY OF ALLEGHENY COUNTY

BUS RAPID TRANSIT UPTOWN TO OAKLAND


ROADWAY PLANS


FORBES AVE - STA 154+50 TO STA 159+50

DWG. NO. PP33

X LP



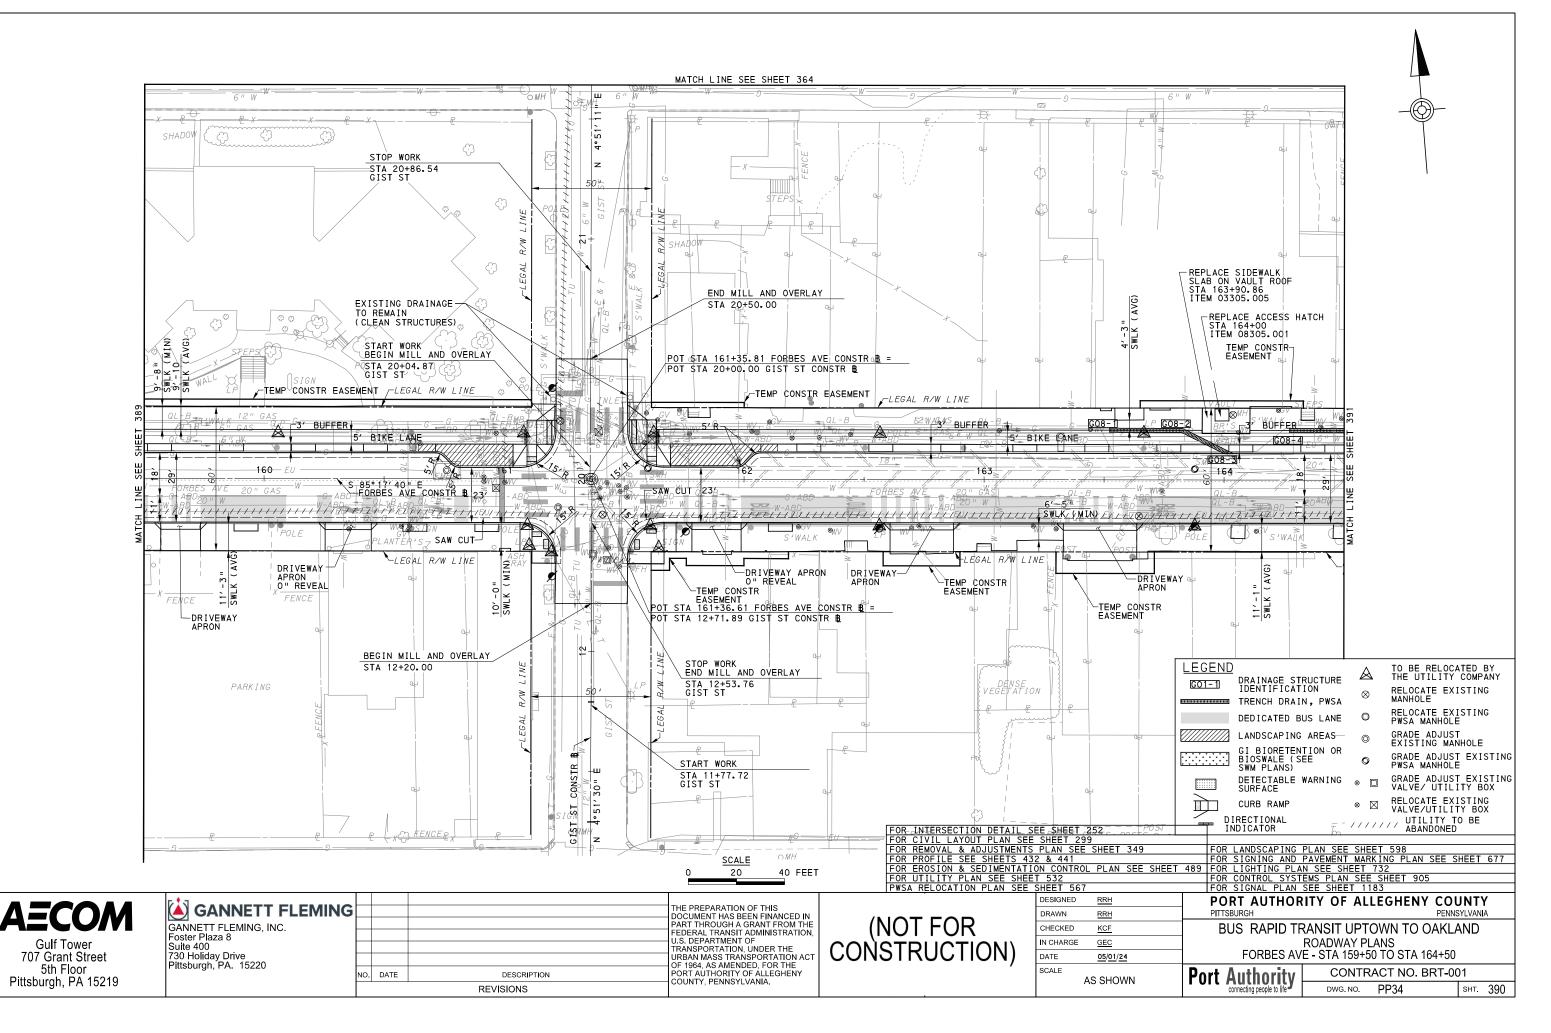

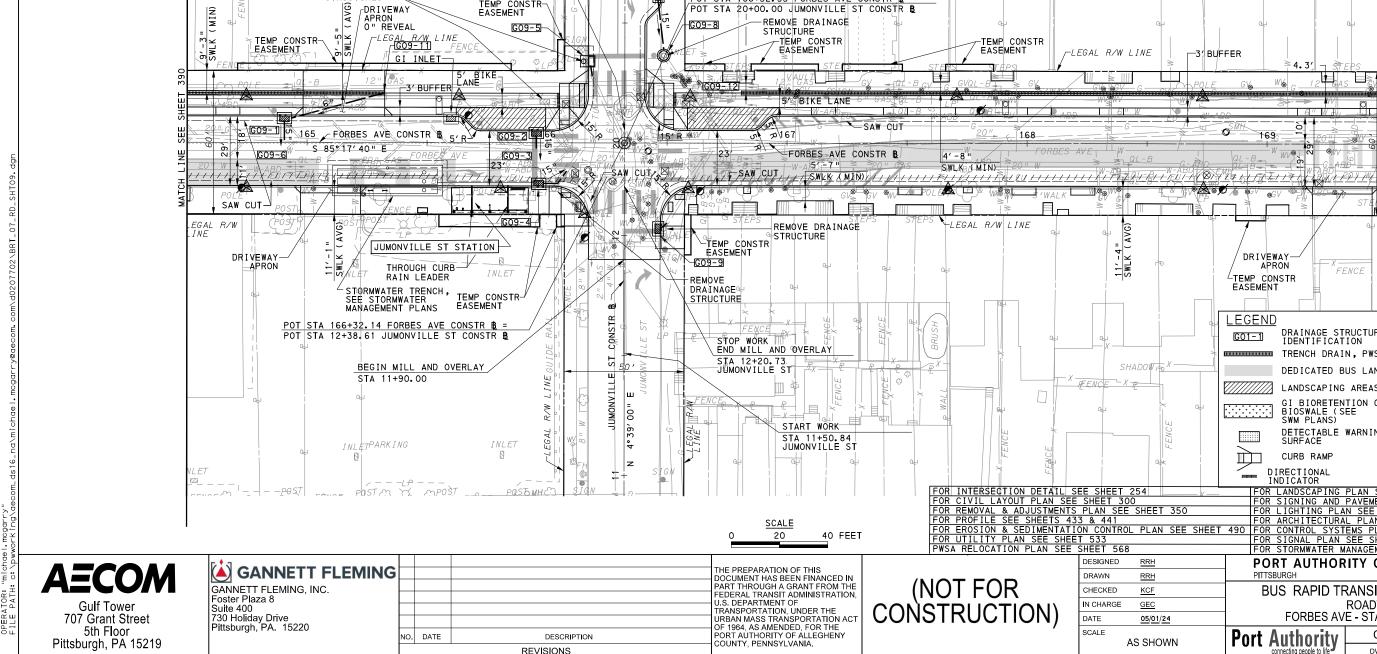

4° 42′ 57 "

G09-7

WALL

REMOVE DRAINAGE STRUCTURES

GENSE VEGETATION

₩ WAZZ

STOP WORK

STA 20+87.18 JUMONVILLE ST

STA 20+05.14 JUMONVILLE ST

START WORK BEGIN MILL AND OVERLAY

TEMP CONSTR-EASEMENT

MATCH LINE SEE SHEET 365

DENSE VEGETATION

POT STA 166+32.35 FORBES AVE CONSTR 1 =

POT STA 20+00.00 JUMONVILLE ST CONSTR &

WAI /

END MILL AND OVERLAY

SWLK (MIN)

STA 20+67.50<sup>T</sup>

TO BE RELOCATED BY THE UTILITY COMPANY RELOCATE EXISTING MANHOLE RELOCATE EXISTING PWSA MANHOLE GRADE ADJUST EXISTING MANHOLE GRADE ADJUST EXISTING PWSA MANHOLE GRADE ADJUST EXISTING VALVE/ UTILITY BOX RELOCATE EXISTING VALVE/UTILITY BOX ////// UTILITY TO BE ABANDONED

 $\circ$  MH

12 BAS

^FENCE

DRAINAGE STRUCTURE IDENTIFICATION

TRENCH DRAIN, PWSA

DEDICATED BUS LANE

LANDSCAPING AREAS GI BIORETENTION OR BIOSWALE (SEE

DETECTABLE WARNING SURFACE

SWM PLANS)

CURB RAMP

REVISIONS

AS SHOWN

DENSE VEGETATIO

-3/BUFFER

0

DRIVEWAY-

TEMP CONSTR

LEGEND

G01-1

FOR LANDSCAPING PLAN SEE SHEET 599
FOR SIGNING AND PAVEMENT MARKING PLAN SEE SHEET 678
FOR LIGHTING PLAN SEE SHEET 733
FOR ARCHITECTURAL PLAN SEE SHEET 760
FOR CONTROL SYSTEMS PLAN SEE SHEET 906
FOR SIGNAL PLAN SEE SHEET 1187
FOR STORMWATER MANAGEMENT (ALSO PLAN) SEE SHEET 26 PORT AUTHORITY OF ALLEGHENY COUNTY

BUS RAPID TRANSIT UPTOWN TO OAKLAND ROADWAY PLANS

FORBES AVE - STA 164+50 TO STA 169+50

CONTRACT NO. BRT-001 **Port Authority** DWG. NO. PP35

sнт. 391





AECOM

**Gulf Tower** 

707 Grant Street

5th Floor

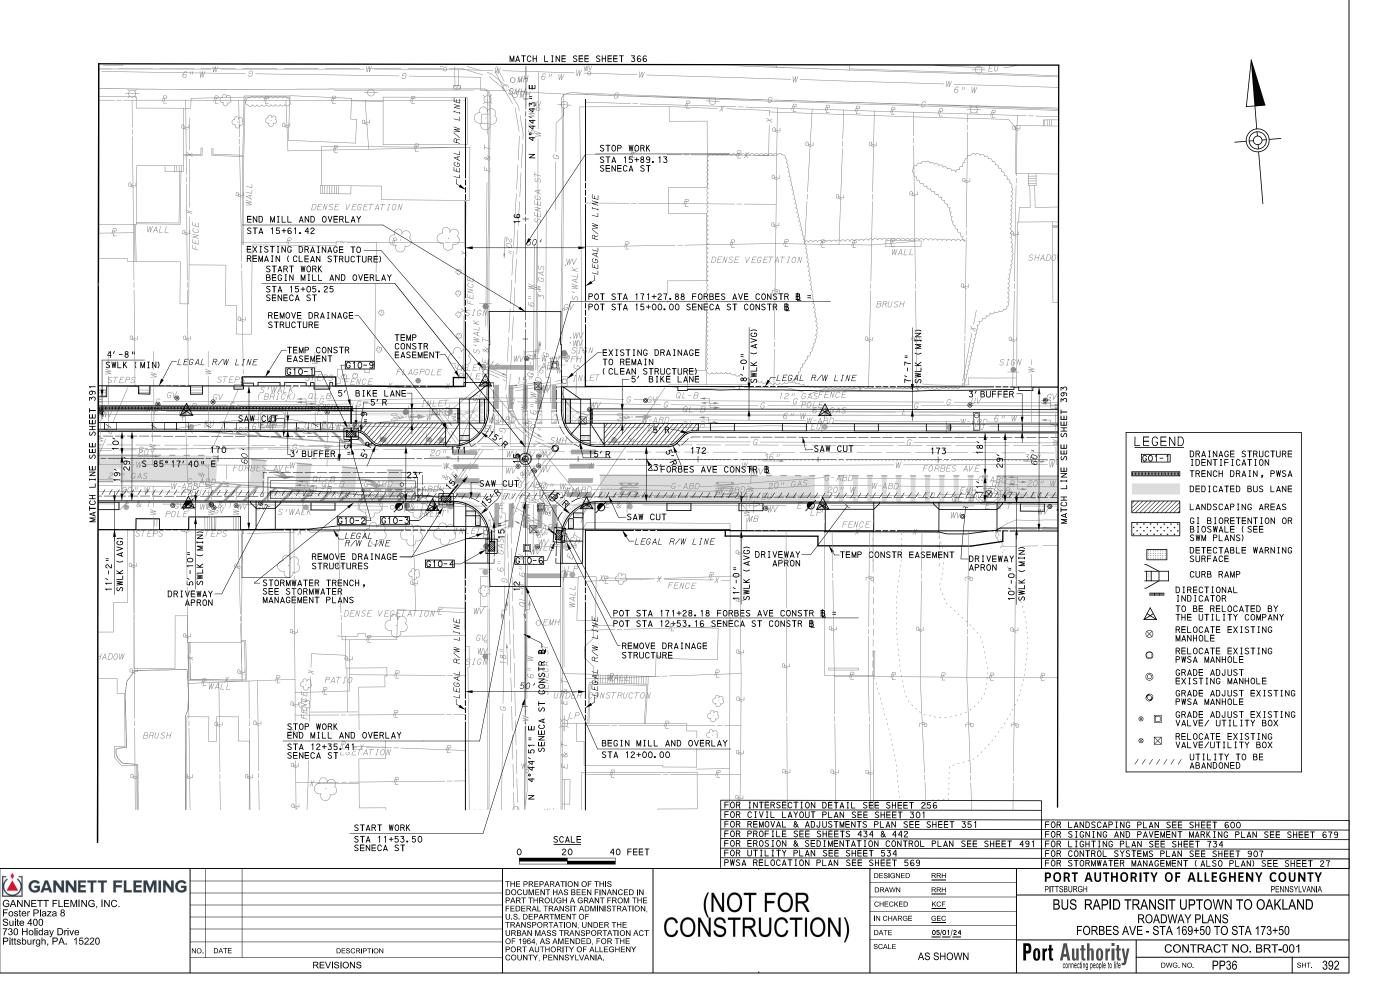


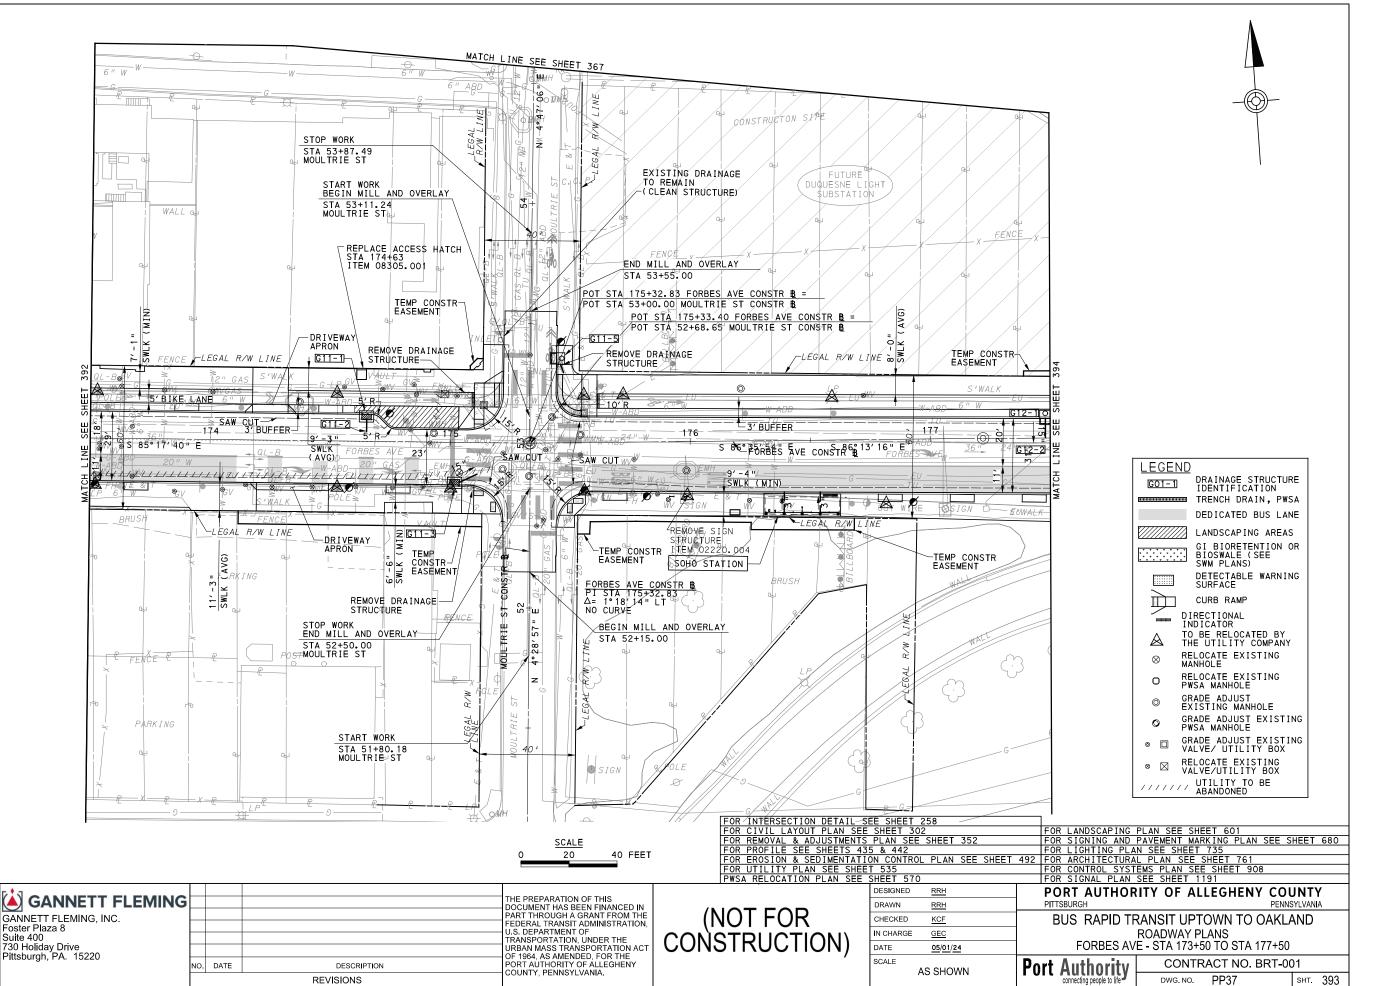





Gulf Tower 707 Grant Street 5th Floor Pittsburgh, PA 15219



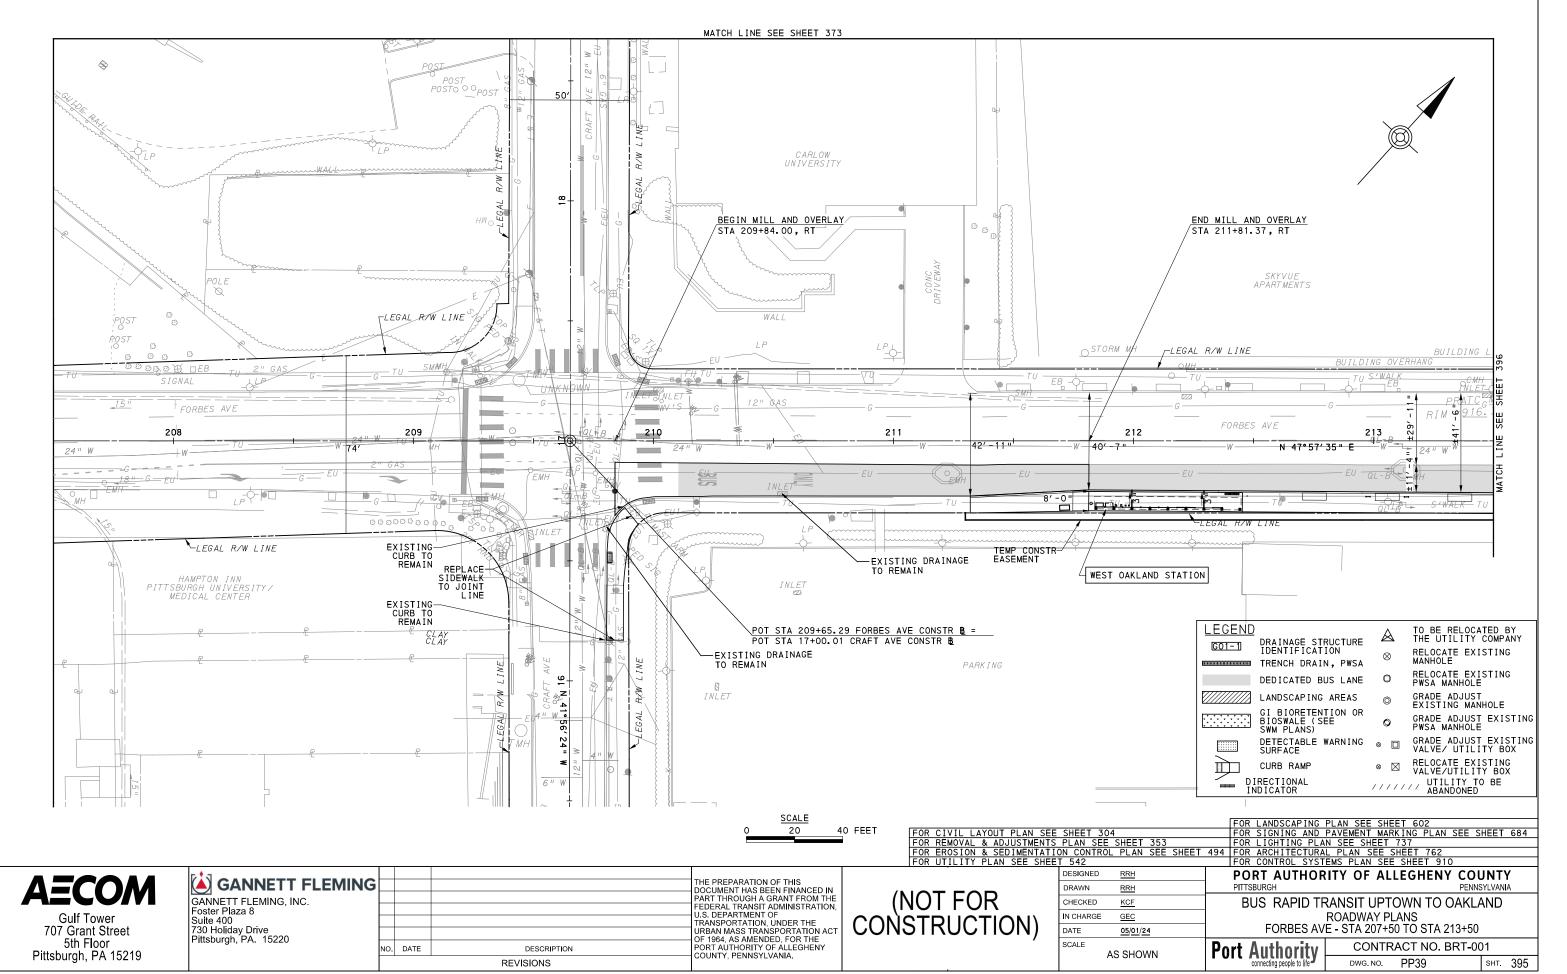

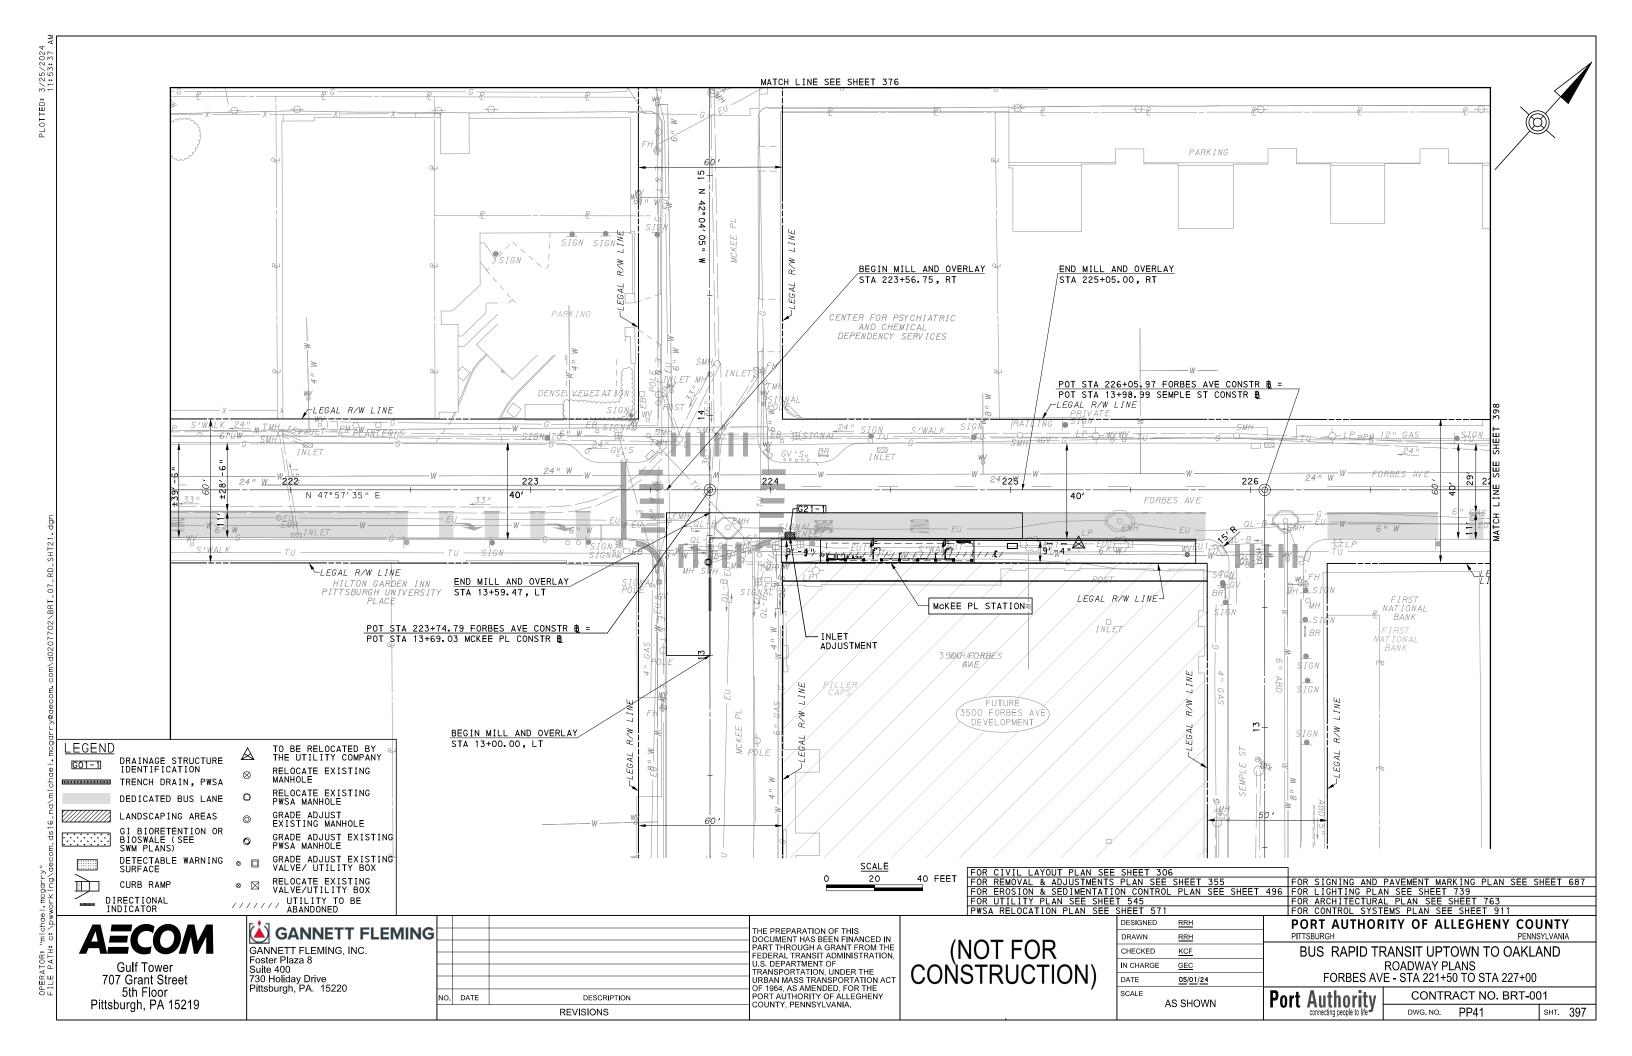



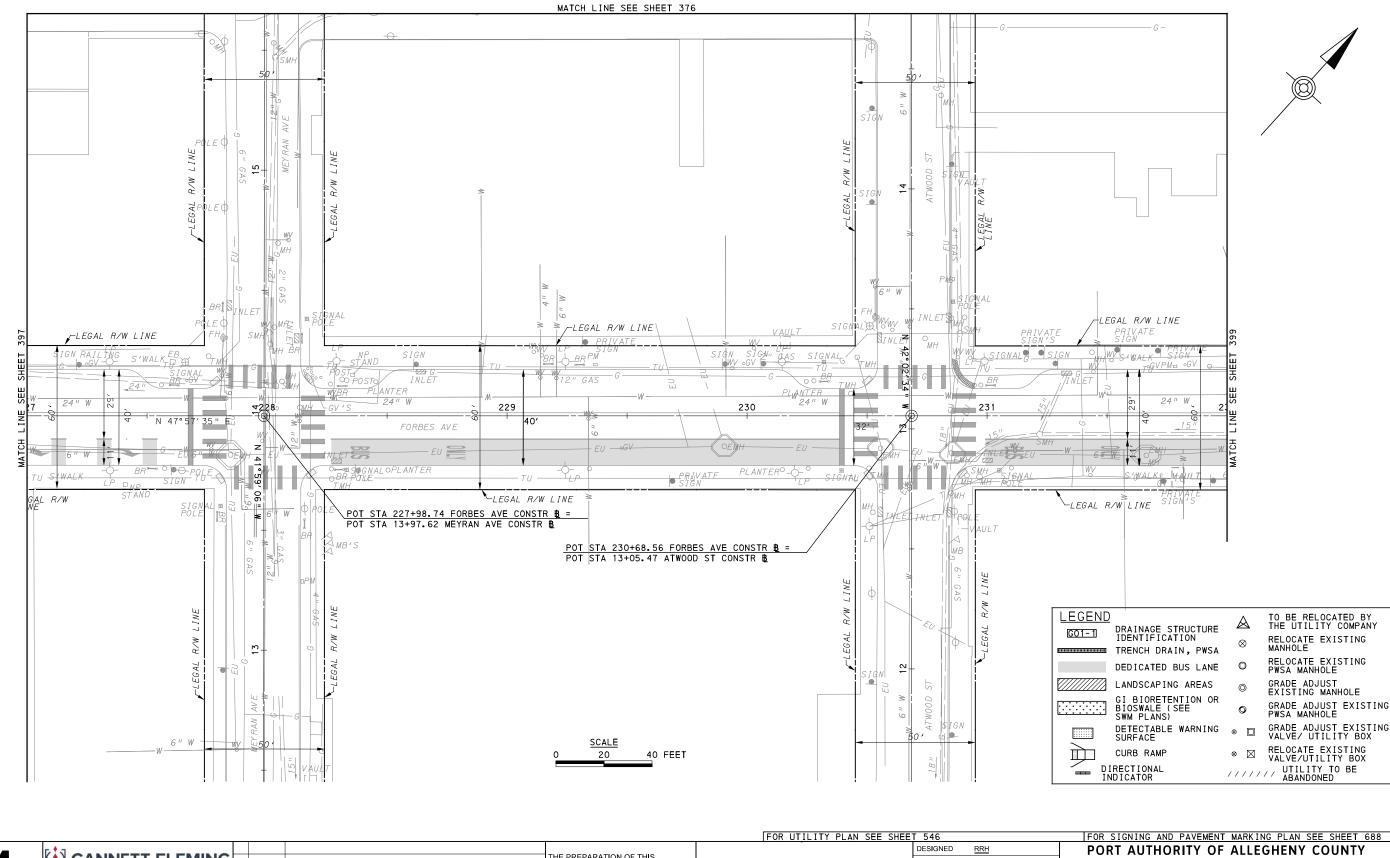

**AECOM**Gulf Tower

Gulf Tower 707 Grant Street 5th Floor Pittsburgh, PA 15219 GANNETT FLEMING
GANNETT FLEMING, INC.
Foster Plaza 8
Suite 400
730 Holiday Drive
Pittsburgh, PA. 15220

NO. DATE

DESCRIPTION
REVISIONS

THE PREPARATION OF THIS
DOCUMENT HAS BEEN FINANCED IN
PART THROUGH A GRANT FROM THE
FEDERAL TRANSIT ADMINISTRATION,
U.S. DEPARTMENT OF
TRANSPORTATION, UNDER THE
URBAN MASS TRANSPORTATION ACT
OF 1964, AS AMENDED, FOR THE
DESCRIPTION
PORT AUTHORITY OF ALLEGHENY
COUNTY, PENNSYLVANIA.

(NOT FOR CONSTRUCTION)


| DESIGNED | RRH | | DRAWN | RRH | | CHECKED | KCF | IN CHARGE | GEC | DATE | 05/01/24 | SCALE | AS SHOWN | I


FOR SIGNING AND PAVEMENT MARKING PLAN SEE SHEET 68
PORT AUTHORITY OF ALLEGHENY COUNTY
PITTSBURGH

BUS RAPID TRANSIT UPTOWN TO OAKLAND

ROADWAY PLANS FORBES AVE - STA 227+00 TO STA 232+00

Port Authority CONTRACT NO. BRT-001

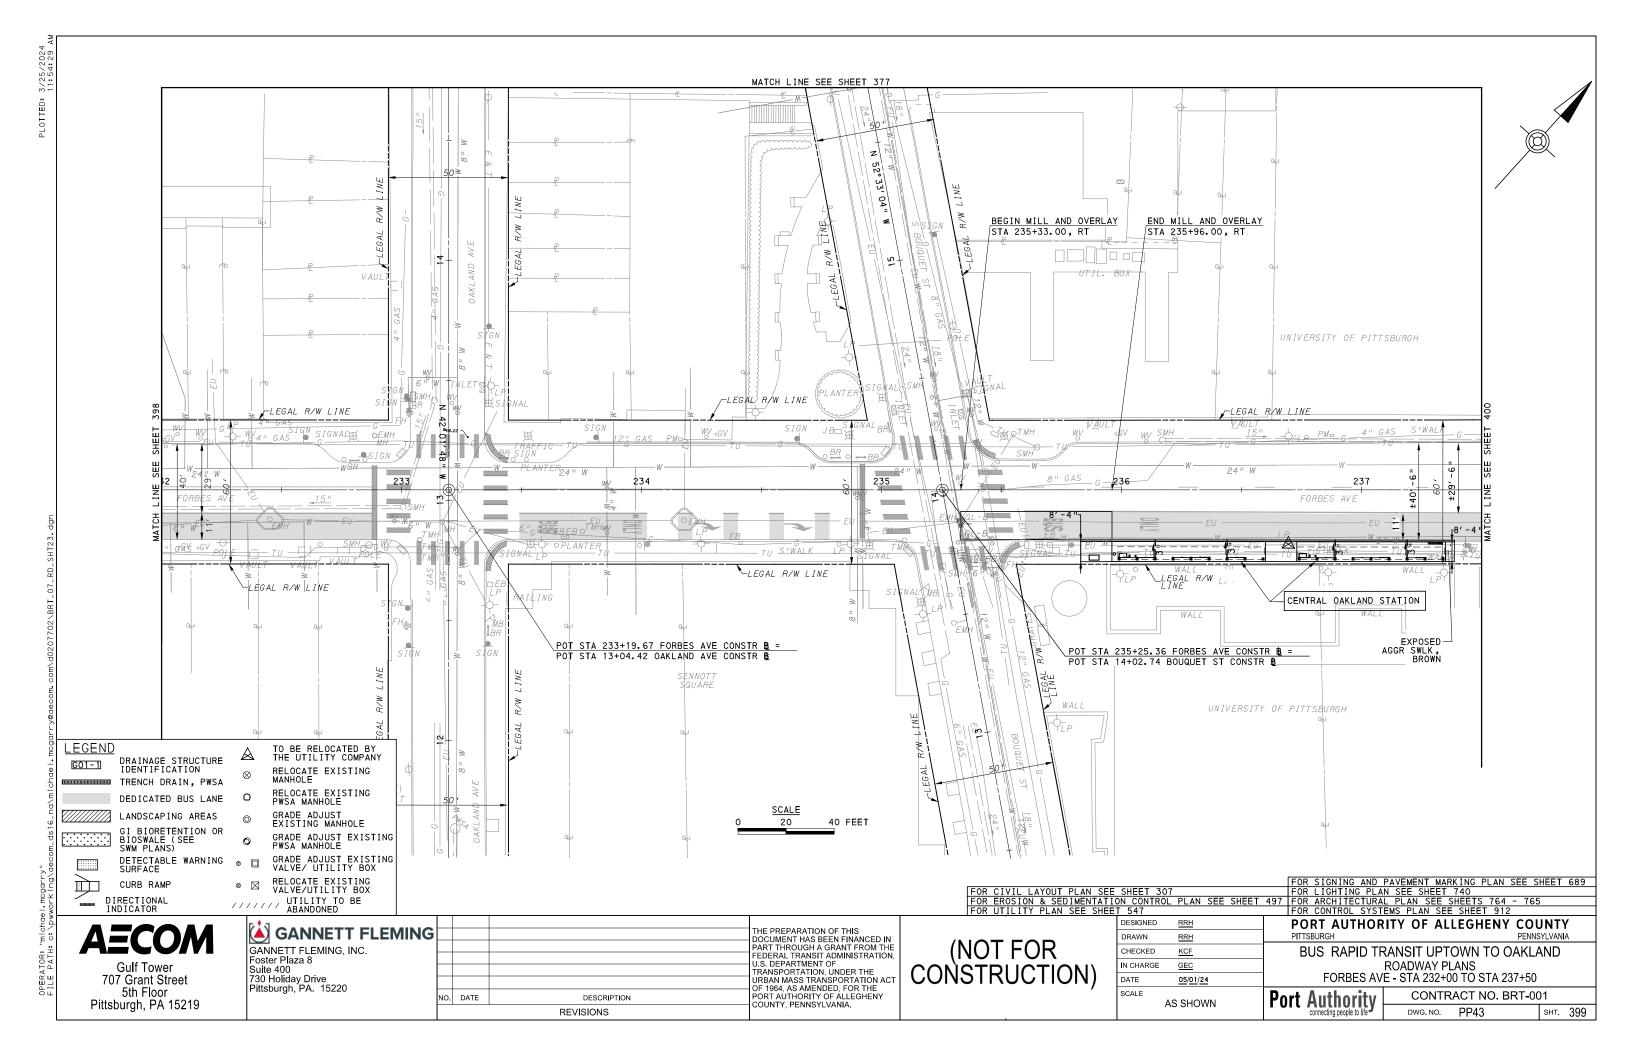

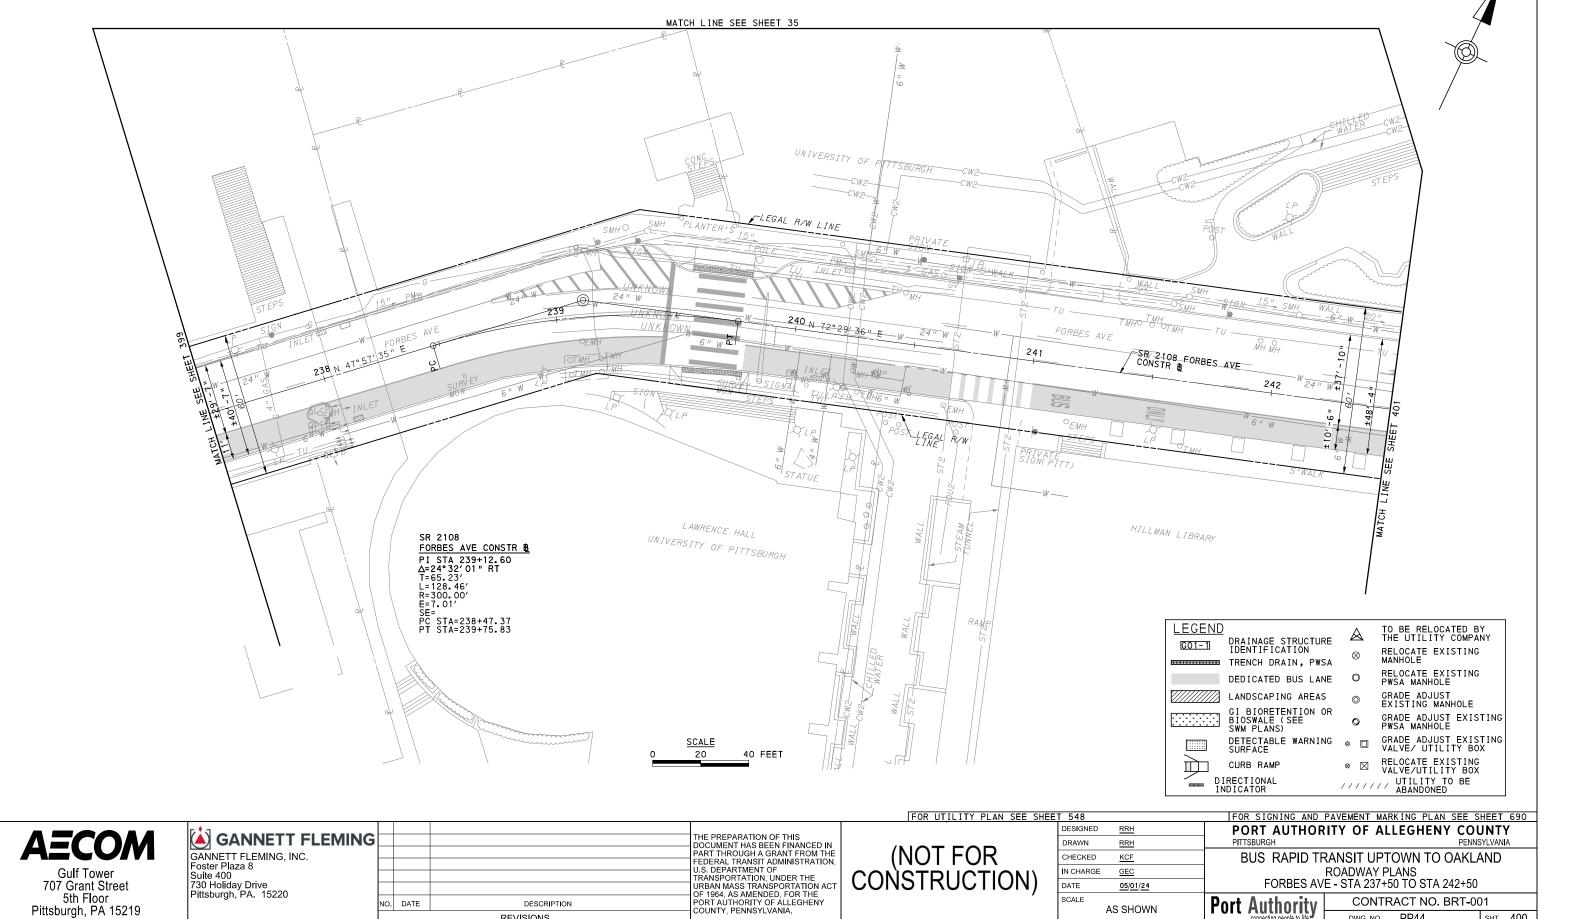

DATE

SCALE

05/01/24

AS SHOWN

**Port Authority** 

CONTRACT NO. BRT-001

sнт. 400

PP44

DWG. NO.

707 Grant Street

5th Floor


Pittsburgh, PA 15219


730 Holiday Drive Pittsburgh, PA. 15220

NO. DATE

DESCRIPTION

REVISIONS

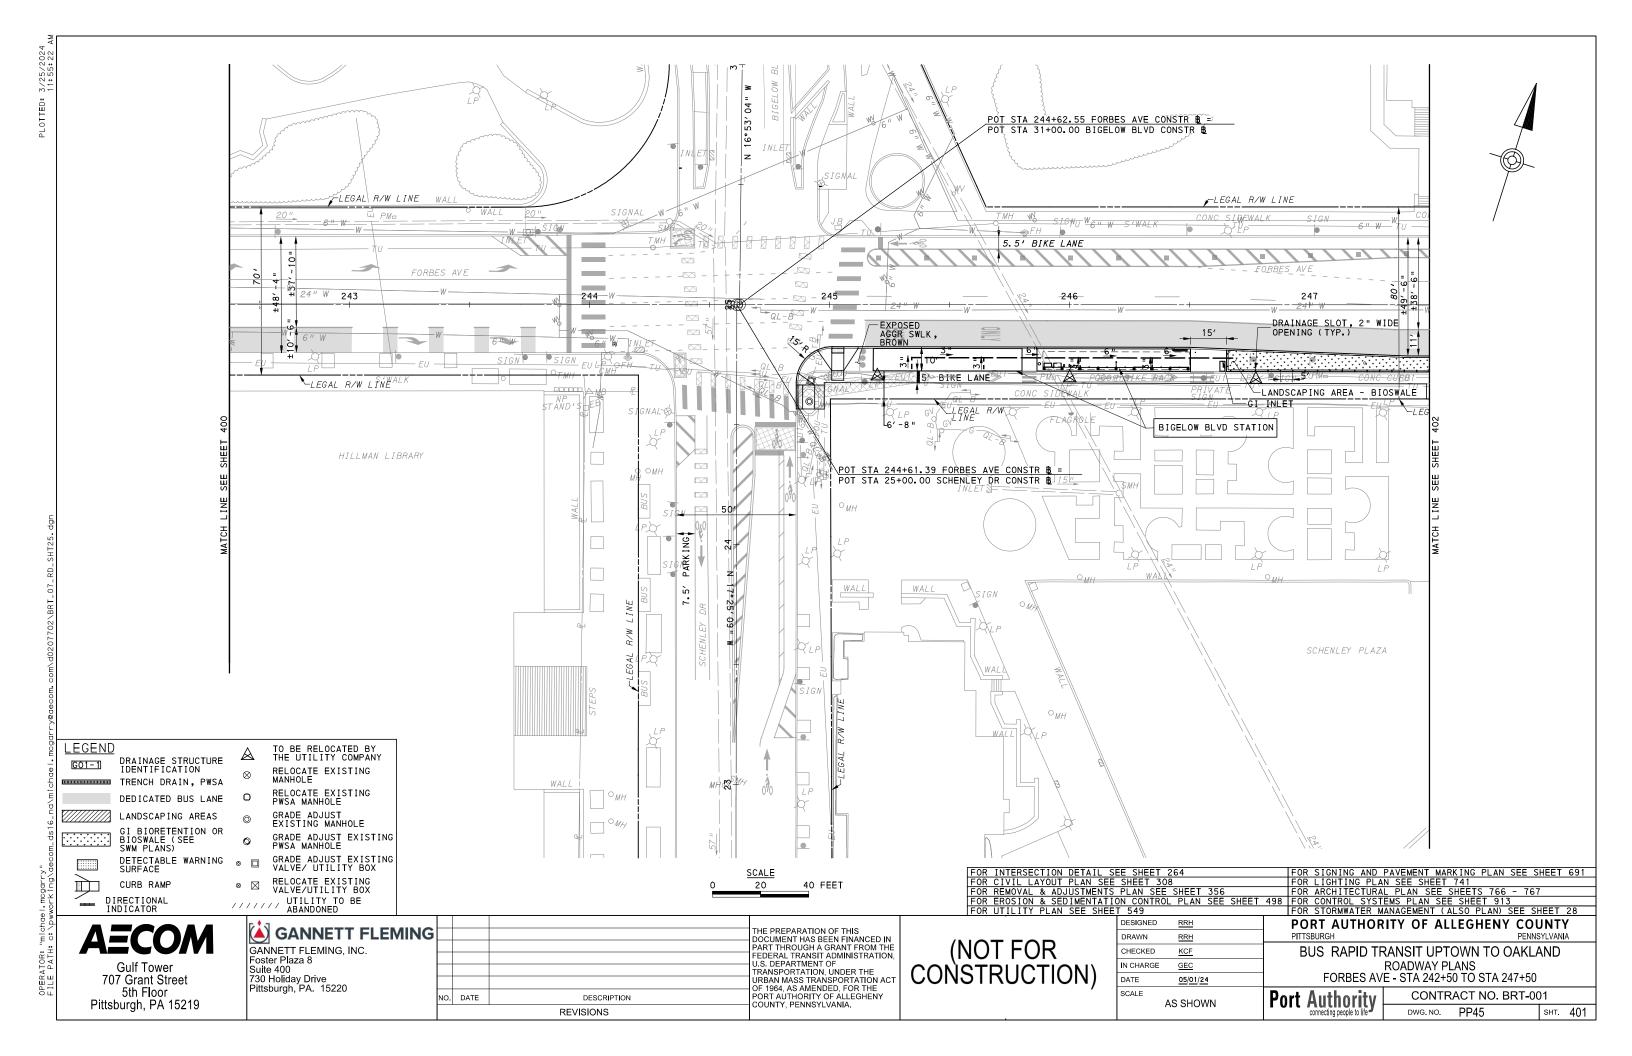

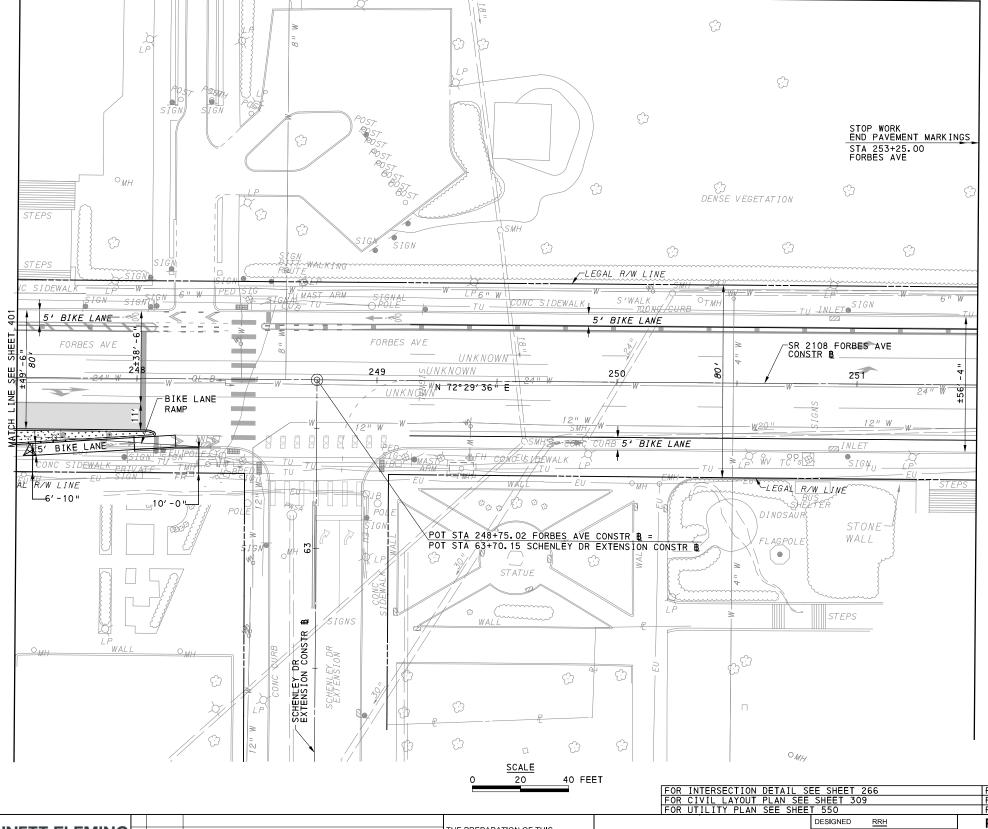

MATCH LINE SEE SHEET 103



LEGEND G01-1

DRAINAGE STRUCTURE IDENTIFICATION TRENCH DRAIN, PWSA DEDICATED BUS LANE

LANDSCAPING AREAS

GI BIORETENTION OR BIOSWALE (SEE SWM PLANS)

DETECTABLE WARNING SURFACE CURB RAMP

DIRECTIONAL INDICATOR

TO BE RELOCATED BY THE UTILITY COMPANY

RELOCATE EXISTING MANHOLE  $\otimes$ RELOCATE EXISTING PWSA MANHOLE

GRADE ADJUST

EXISTING MANHOLE GRADE ADJUST EXISTING PWSA MANHOLE

GRADE ADJUST EXISTING VALVE/ UTILITY BOX □

⊗ ⊠

UTILITY TO BE

AECOM **Gulf Tower** 707 Grant Street 5th Floor Pittsburgh, PA 15219

GANNETT FLEMING
GANNETT FLEMING, INC. Foster Plaza 8 Suite 400 730 Holiday Drive Pittsburgh, PA. 15220

THE PREPARATION OF THIS DOCUMENT HAS BEEN FINANCED IN PART THROUGH A GRANT FROM THE FEDERAL TRANSIT ADMINISTRATION, U.S. DEPARTMENT OF TRANSPORTATION, UNDER THE URBAN MASS TRANSPORTATION ACT OF 1964, AS AMENDED, FOR THE PORT AUTHORITY OF ALLEGHENY COUNTY, PENNSYLVANIA. NO. DATE DESCRIPTION REVISIONS

(NOT FOR CONSTRUCTION)

550		
DESIGNED	RRH	
DRAWN	RRH	
CHECKED	KCF	
IN CHARGE	GEC	
DATE	05/01/24	
SCALE		
	AS SHOWN	


FOR SIGNING AND PAVEMENT MARKING PLAN SEE SHEET 692
FOR LIGHTING PLAN SEE SHEET 742
FOR SIGNAL PLAN SEE SHEET 1202 PORT AUTHORITY OF ALLEGHENY COUNTY

BUS RAPID TRANSIT UPTOWN TO OAKLAND

**ROADWAY PLANS** FORBES AVE - STA 247+50 TO STA 251+50

CONTRACT NO. BRT-001 **Port Authority** 

DWG. NO. PP46 sнт. 402

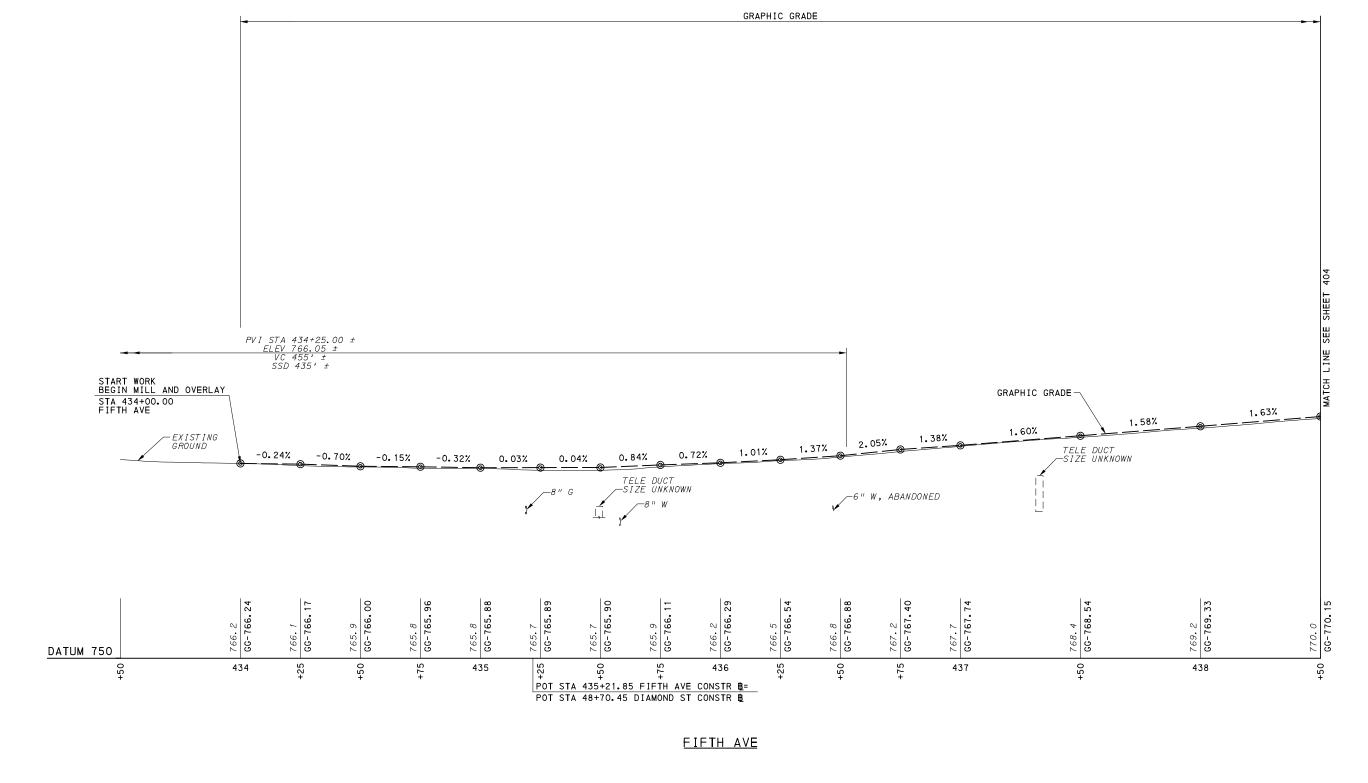




Gulf Tower 707 Grant Street 5th Floor Pittsburgh, PA 15219 THE PREPARATION OF THIS
DOCUMENT HAS BEEN FINANCED IN
PART THROUGH A GRANT FROM THE
FEDERAL TRANSIT ADMINISTRATION,
U.S. DEPARTMENT OF
TRANSPORTATION, UNDER THE
URBAN MASS TRANSPORTATION ACT
OF 1964, AS AMENDED, FOR THE
NO. DATE
DESCRIPTION
REVISIONS


THE PREPARATION OF THIS
PORTATION ACT OF 1964, AS AMENDED, FOR THE
COUNTY, PENNSYLVANIA.

(NOT FOR CONSTRUCTION)

		TEOR RO	<u>ADWAY PLAN</u>	SEE SHEET	35 I			
DESIGNED <u>SDS</u>	PORT AUTHOR	ITY OF ALI	LEGHENY	COUNTY	,			
DRAWN <u>JMS</u>	PITTSBURGH			PENNSYLVANIA	١			
CHECKED <u>BFS</u>	BUS RAPID TF	BUS RAPID TRANSIT UPTOWN TO OAKLAND						
IN CHARGE <u>LAR</u>		ROADWAY PROFILE						
DATE <u>05/01/24</u>	F <b>I</b> FTH AV	FIFTH AVE - STA 433+50 TO STA 438+50						
SCALE AS SHOWN	Port Authority	CONTRACT NO. BRT-001		RT-001				
AS SHOWN	connecting people to life	DWG NO	DD/17	SHT	103			

raton. E PATH: c:\pwworking\aecom\_ds16\_na\michael.mcgarry

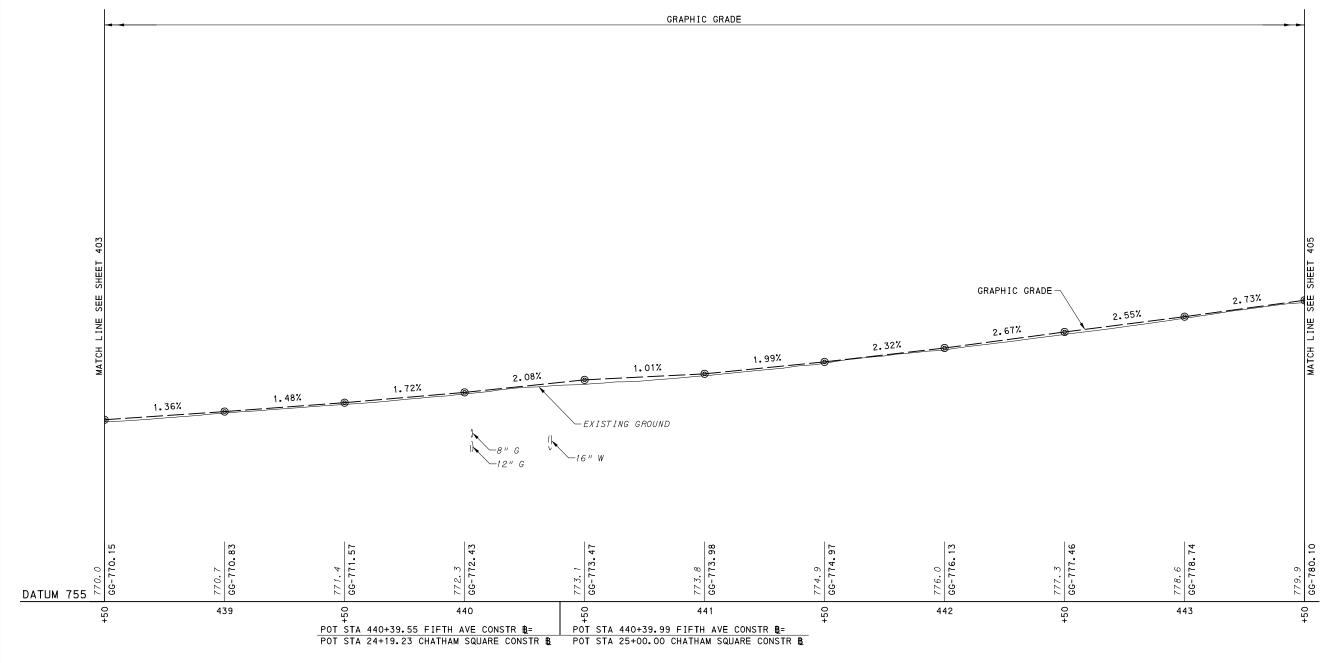

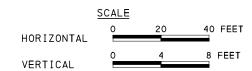


Gulf Tower 707 Grant Street 5th Floor Pittsburgh, PA 15219 THE PREPARATION OF THIS
DOCUMENT HAS BEEN FINANCED IN
PART THROUGH A GRANT FROM THE
FEDERAL TRANSIT ADMINISTRATION,
U.S. DEPARTMENT OF
TRANSPORTATION, UNDER THE
URBAN MASS TRANSPORTATION ACT
OF 1984, AS AMENDED, FOR THE
NO. DATE
DESCRIPTION
REVISIONS

THE PREPARATION OF THIS
POPARTMENT OF THIS
COUNTY, PENNSYLVANIA.


(NOT FOR CONSTRUCTION)

			I FOR RO	DADWAY PLAN	SEE SHEE	:1 358	
ESIGNED	<u>SDS</u>	PORT AUTHOR	ITY OF AL	LEGHENY	COUNT	Υ	
RAWN	<u>JMS</u>	PITTSBURGH			PENNSYLVA	NIA	
HECKED	<u>BFS</u>	BUS RAPID TRANSIT UPTOWN TO OAKLAND					
I CHARGE	<u>LAR</u>	ROADWAY PROFILE					
ATE	05/01/24	FIFTH AVE - STA 438+50 TO STA 443+50					
CALE	S SHOWN	Port Authority	CONTR	RACT NO. BI	RT-001		
^	IO OI IOVVIV	connecting people to life	DWG NO	DD/IS	SHT	404	

raluk: "michdel.mcgdrry" E PATH: c:\pwworking\decom\_ds16\_nd\michdel.m

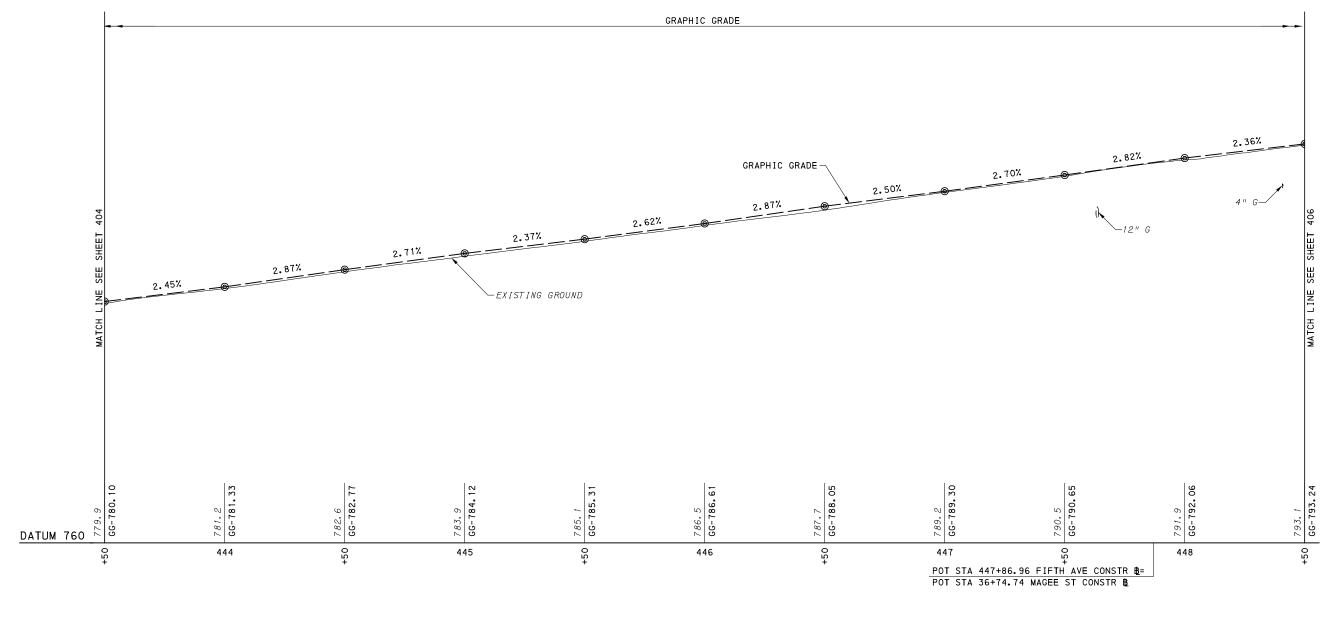

# <u>FIFTH AVE</u>

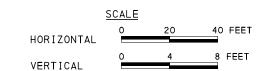

Gulf Tower
707 Grant Street
5th Floor
Pittsburgh, PA 15219

			THE PREPARATION OF THIS  OCUMENT HAS BEEN FINANCED IN	
			PART THROUGH A GRANT FROM THE	
			FEDERAL TRANSIT ADMINISTRATION, U.S. DEPARTMENT OF	
			TRANSPORTATION, UNDER THE	
			URBAN MASS TRANSPORTATION ACT OF 1964, AS AMENDED, FOR THE	
NO.	DATE	DESCRIPTION	PORT AUTHORITY OF ALLEGHENY COUNTY, PENNSYLVANIA.	
		REVISIONS	COUNTY, FERINGTEVANIA.	

(NOT FOR CONSTRUCTION)	
------------------------	--


				I FOR R	<u>OADWAY PLAN</u>	SEE SHEE	1 355	
	DESIGNED	<u>SDS</u>	PORT AUTHOR	ITY OF AL	LEGHENY	COUNT	Υ	
	DRAWN	<u>JMS</u>	PITTSBURGH			PENNSYLVAN	IIA	
	CHECKED	<u>BFS</u>	BUS RAPID TRANSIT UPTOWN TO OAKLAND					
	IN CHARGE	LAR	ROADWAY PROFILE					
	DATE	05/01/24	FIFTH AVE - STA 443+50 TO STA 448+50					
SCALE AS SHOWN		S SHOWN	Port Authority	CONTI	RACT NO. BI	RT-001		
	AS SHOWIN		connecting people to life	DWG NO	DD/IQ	SHT	405	


PERATOR: "michael.mcgarry" .LE PATH: c:\pwworking\decom\_ds16\_na\michael.mcgarry

REVISIONS

DWG. NO. PP50

sнт. 406

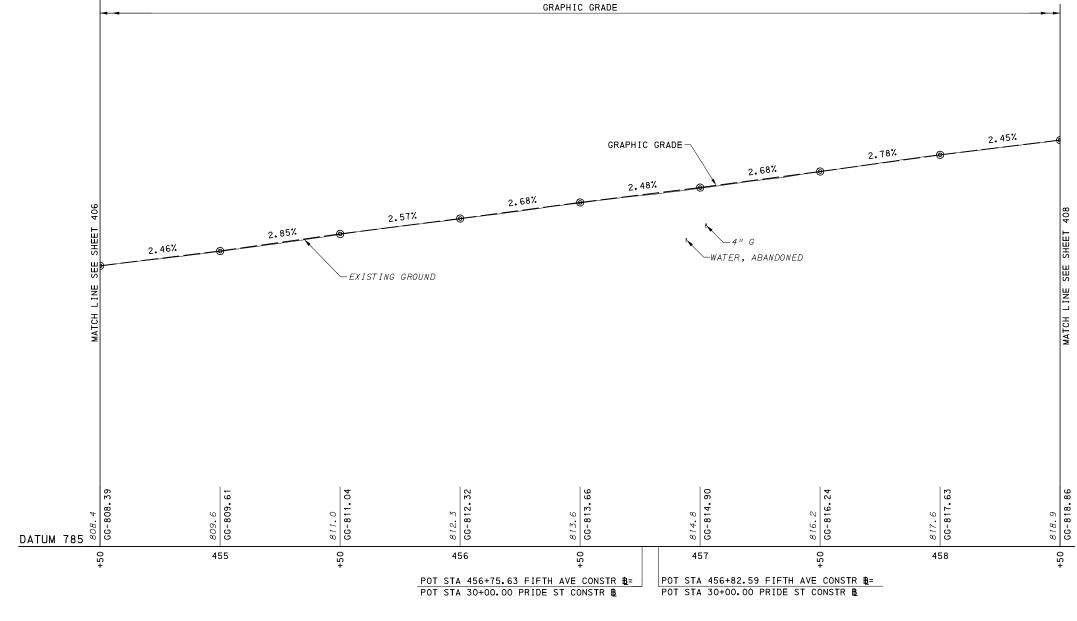

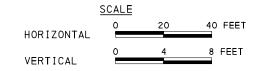



Gulf Tower 707 Grant Street 5th Floor Pittsburgh, PA 15219 THE PREPARATION OF THIS
DOCUMENT HAS BEEN FINANCED IN
PART THROUGH A GRANT FROM THE
FEDERAL TRANSIT ADMINISTRATION,
U.S. DEPARTMENT OF
TRANSPORTATION, UNDER THE
URBAN MASS TRANSPORTATION ACT
OF 1964, AS AMENDED, FOR THE
PORT AUTHORITY OF ALLEGHENY
COUNTY, PENNSYLVANIA.

(NOT FOR CONSTRUCTION)

				FOR RO	DADWAY PLAN SEE	SHEET	361	
	DESIGNED	<u>SDS</u>	PORT AUTHOR	ITY OF AL	LEGHENY CO	UNTY	,	
	DRAWN	<u>JMS</u>	PITTSBURGH		PENN	SYLVANIA	4	
	CHECKED	<u>BFS</u>	BUS RAPID TRANSIT UPTOWN TO OAKLAND					
	IN CHARGE	LAR	ROADWAY PROFILE					
	DATE	05/01/24	FIFTH AVE - STA 454+50 TO STA 458+50					
	SCALE AS SHOWN		Port Authority	RACT NO. BRT-0	01			
		AO OI IOWN	connecting people to life	DWG. NO.	PP51	SHT.	407	

RATOR: "michael.mcgarry" E PATH: c:\pwworking\aecom\_ds16\_na\michael.mcgarry@aecom.c

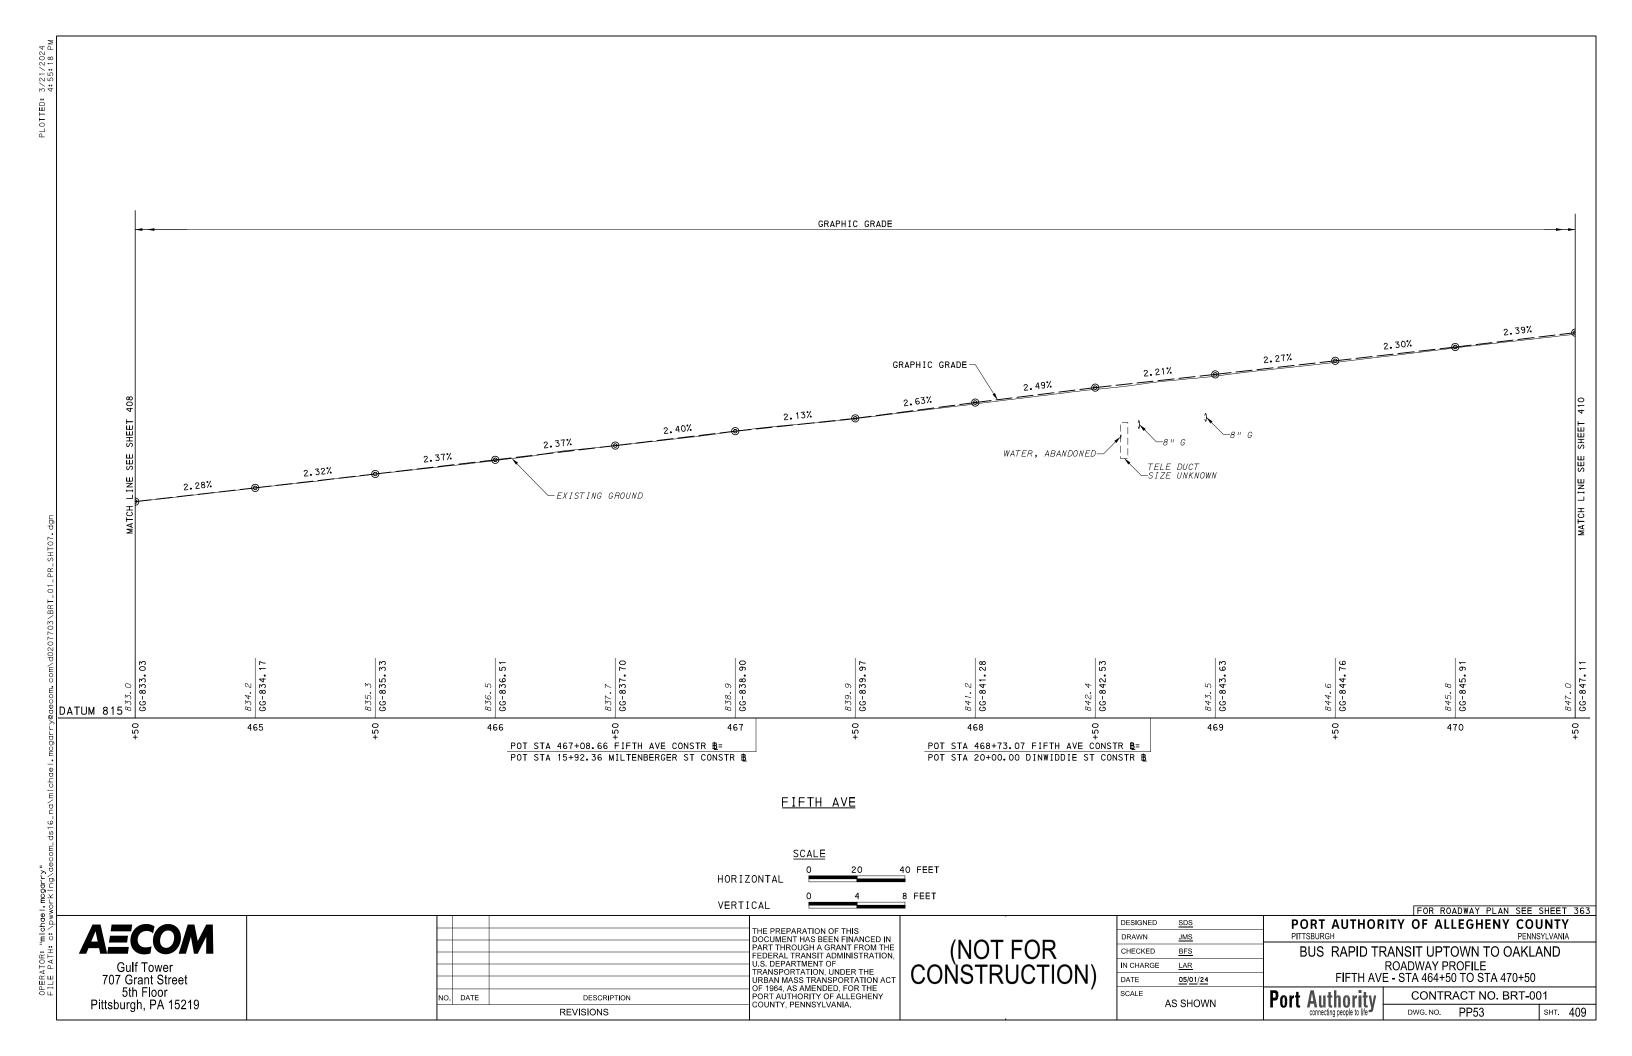

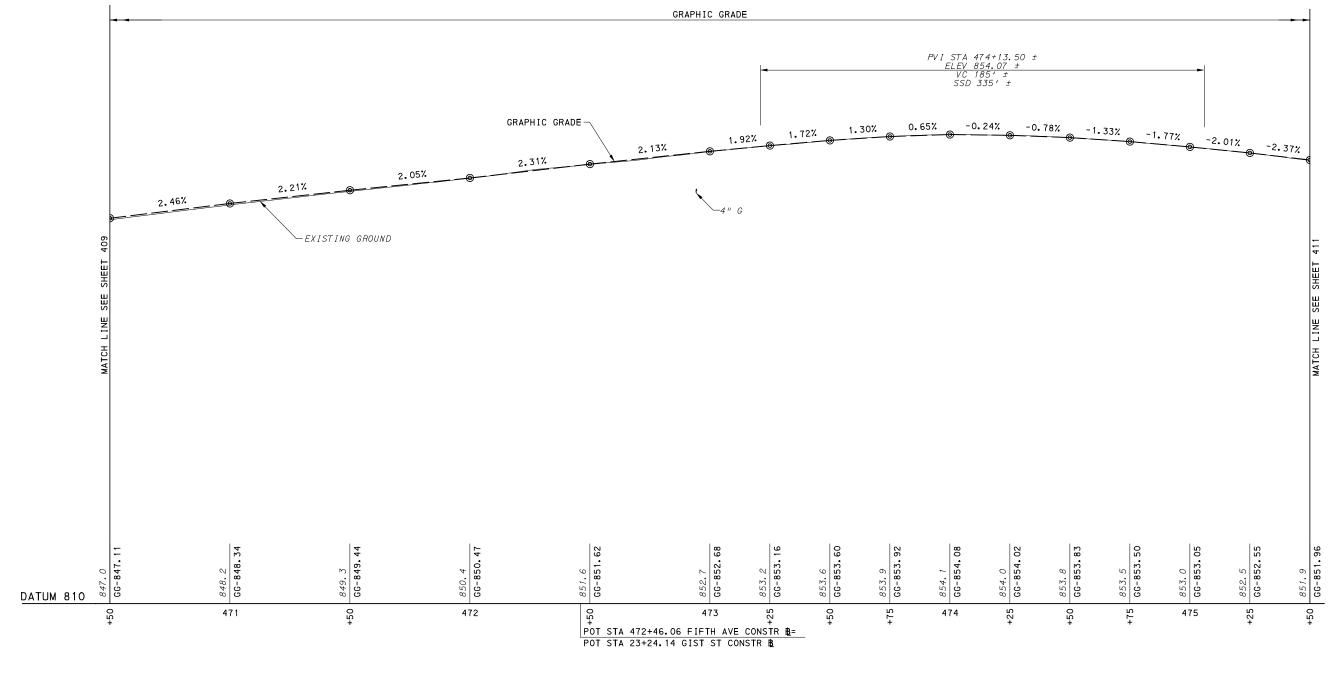





Gulf Tower
707 Grant Street
5th Floor
Pittsburgh, PA 15219

			THE PREPARATION OF THIS
			DOCUMENT HAS BEEN FINANCED IN PART THROUGH A GRANT FROM TH
			FEDERAL TRANSIT ADMINISTRATION
			U.S. DEPARTMENT OF TRANSPORTATION, UNDER THE
			URBAN MASS TRANSPORTATION AC OF 1964, AS AMENDED, FOR THE
NO.	DATE	DESCRIPTION	PORT AUTHORITY OF ALLEGHENY COUNTY, PENNSYLVANIA.
		REVISIONS	COUNTY, PENINSTEVANIA.

(NOT FOR CONSTRUCTION)

				FOR RO	DADWAY PLAN	SEE SHEE	T 364			
	DESIGNED	<u>SDS</u>	PORT AUTHOR	ITY OF AL	LEGHENY	COUNT	Υ			
	DRAWN	<u>JMS</u>	PITTSBURGH			PENNSYLVAN	IA			
	CHECKED	<u>BFS</u>	BUS RAPID TRANSIT UPTOWN TO OAKLAND							
	IN CHARGE	LAR	ROADWAY PROFILE							
	DATE	05/01/24	FIFTH AV	F <b>I</b> FTH AVE - STA 470+50 TO STA 475+50						
SCALE A C. CLIONA/NI		AS SHOWN	Port Authority	CONTR	RACT NO. BI	RT-001				
AS SHOWIN			I OIL Macinolity	DIVIO NO	DDC4		440			

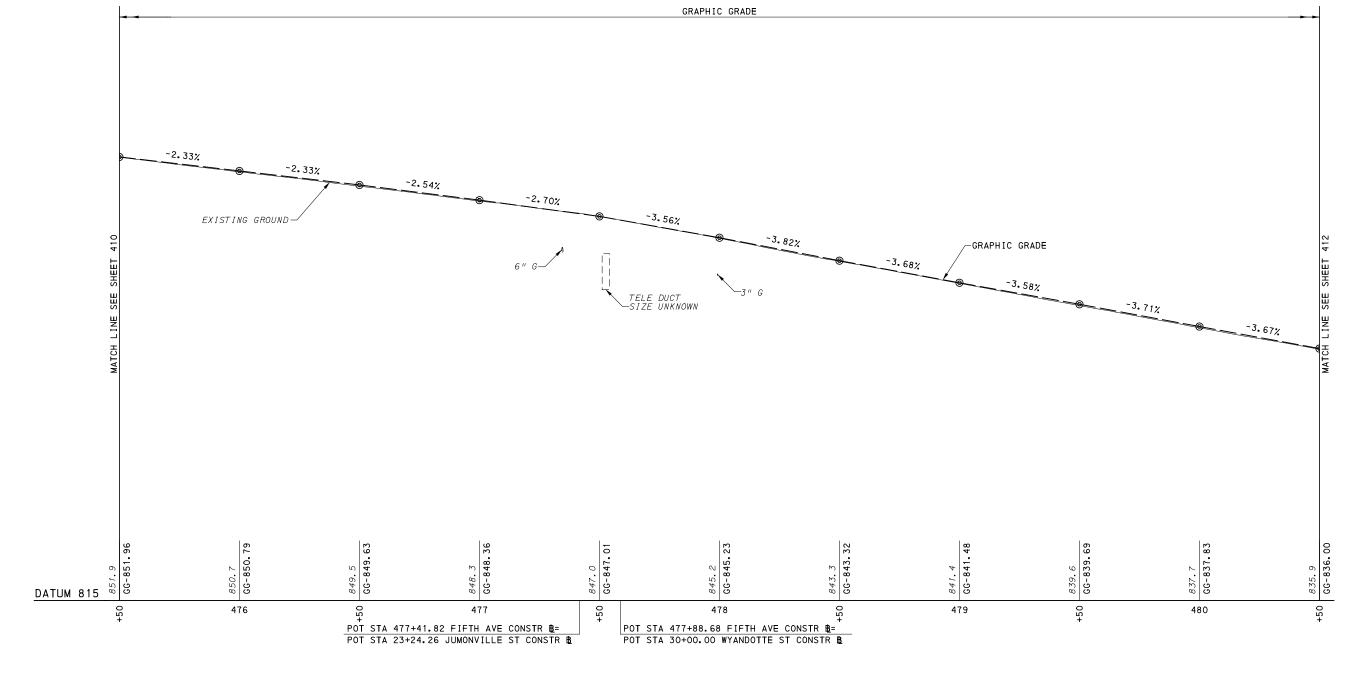

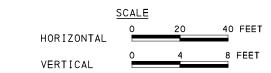


Gulf Tower
707 Grant Street
5th Floor
Pittsburgh, PA 15219

			THE PREPARATION OF THIS  DOCUMENT HAS BEEN FINANCED IN
			PART THROUGH A GRANT FROM TH
			FEDERAL TRANSIT ADMINISTRATION U.S. DEPARTMENT OF
			TRANSPORTATION, UNDER THE
			URBAN MASS TRANSPORTATION AC OF 1964, AS AMENDED, FOR THE
NO.	DATE	DESCRIPTION	PORT AUTHORITY OF ALLEGHENY COUNTY, PENNSYLVANIA.
		REVISIONS	COUNTY, PENNSTEVANIA.

(NOT FOR CONSTRUCTION)

			FOR RO	<u>ADWAY PLAN</u>	SEE SH	<u>IEET</u>	365	
ESIGNED	SDS	PORT AUTHOR	ITY OF AL	LEGHENY	COU	VTV	•	
RAWN	<u>JMS</u>	PITTSBURGH			PENNSYL	.VANIA		
HECKED	BFS	BUS RAPID TRANSIT UPTOWN TO OAKLAND						
CHARGE	LAR	ROADWAY PROFILE						
ATE	<u>05/01/24</u>	F <b>I</b> FTH AVE - STA 475+50 TO STA 480+50						
CALE AS SHOWN		Port Authority	CONTRACT NO. BRT-001					
,	AU ULIOVVIV	connecting people to life	DWG. NO.	PP55	s	HT.	411	

R: "michael.mcgarry" .TH: c:/pwworking/aecom\_ds16\_na\michael.mcgarry&aecom

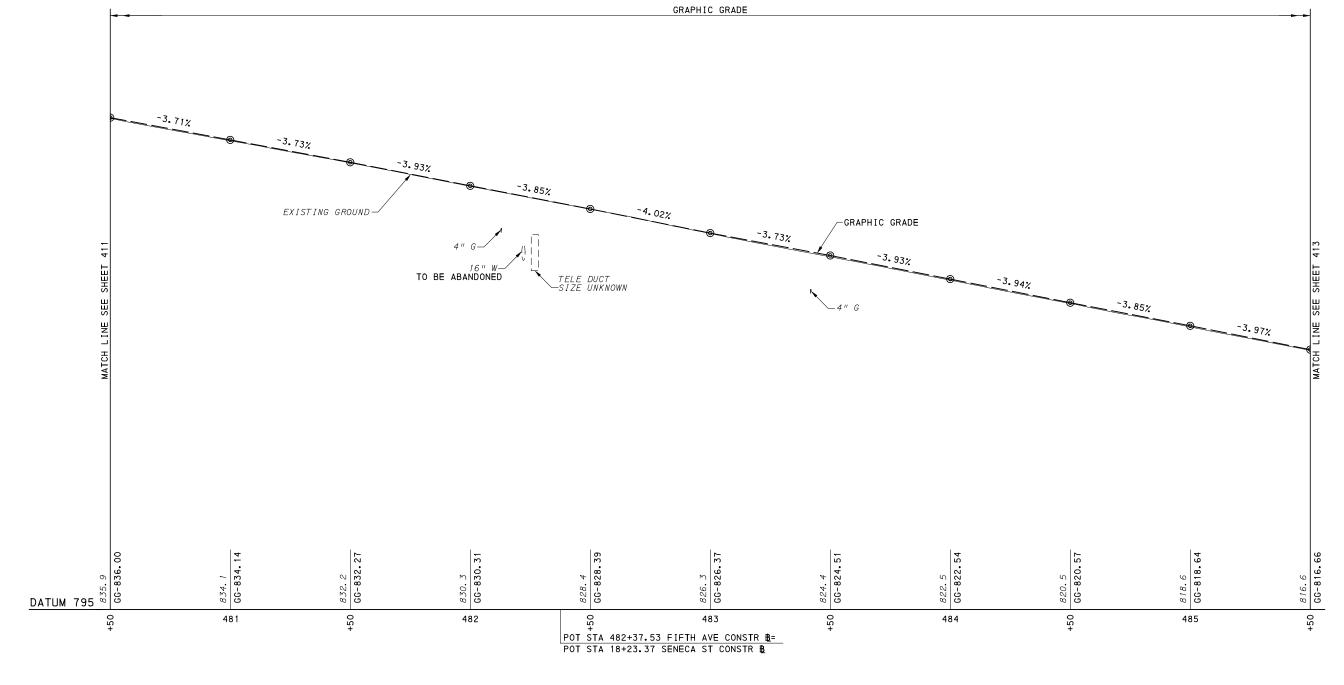

### <u>FIFTH AVE</u>



Gulf Tower
707 Grant Street
5th Floor
Pittsburgh, PA 15219


THE PREPARATION OF THIS
DOCUMENT HAS BEEN FINANCED IN
PART THROUGH A GRANT FROM THE
FEDERAL TRANSIT ADMINISTRATION,
U.S. DEPARTMENT OF
TRANSPORTATION, UNDER THE
URBAN MASS TRANSPORTATION ACT
OF 1964, AS AMENDED, FOR THE
NO. DATE
DESCRIPTION
REVISIONS

THE PREPARATION OF THIS
POPARTMENT OF THIS
PORT AUTHORITY OF ALLEGHENY
COUNTY, PENNSYLVANIA.

(NOT FOR CONSTRUCTION)


			FOR RO	ADWAY PLAN	SEE SHEET	366
ESIGNED	<u>SDS</u>	PORT AUTHOR	ITY OF AL	LEGHENY	COUNTY	,
RAWN	<u>JMS</u>	PITTSBURGH			PENNSYLVANI	4
HECKED	<u>BFS</u>	BUS RAPID TRANSIT UPTOWN TO OAKLAND				
I CHARGE	LAR	ROADWAY PROFILE				
ATE	<u>05/01/24</u>	FIFTH AVE - STA 480+50 TO STA 485+50				
AS SHOWN		Port Authority	CONTR	ACT NO. BF	RT-001	
		connecting people to life	DWG. NO.	PP56	SHT.	412

vorking\aecom\_ds16\_na\michael.mcgarry&aecom.com\d02

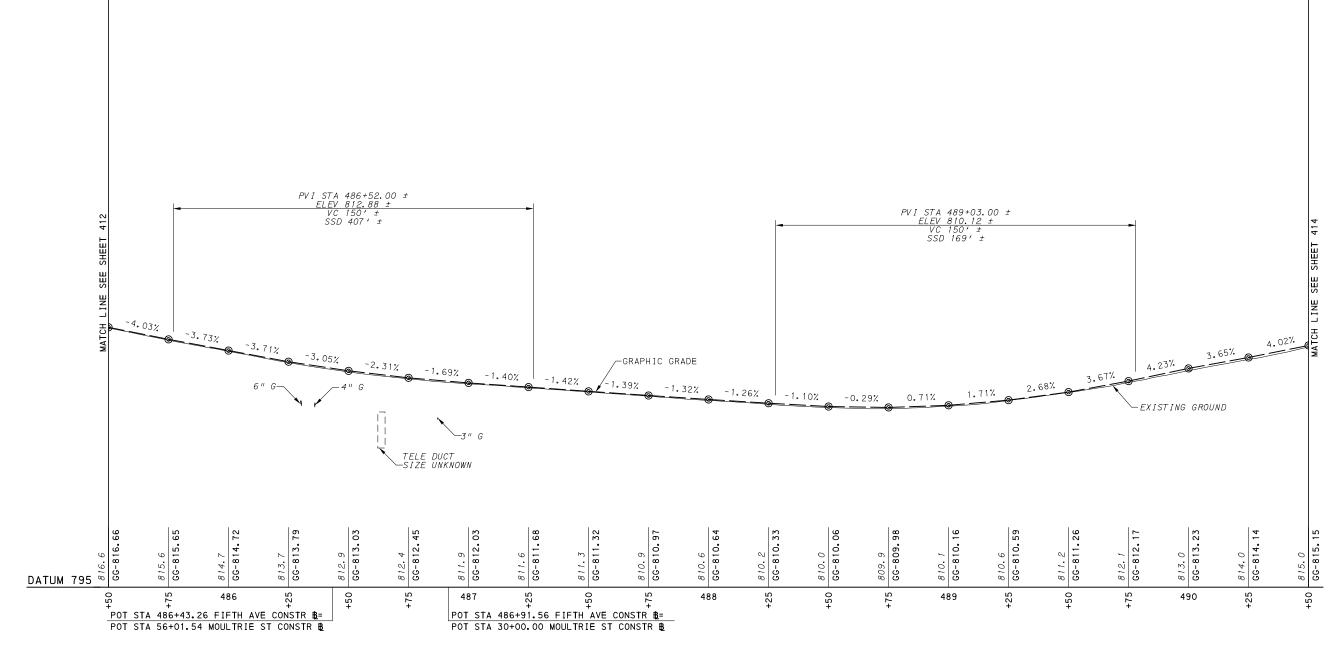

GRAPHIC GRADE

# FIFTH AVE

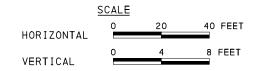


Gulf Tower
707 Grant Street
5th Floor
Pittsburgh, PA 15219


			THE PREPARATION OF THIS DOCUMENT HAS BEEN FINANCED IN PART THROUGH A GRANT FROM TH FEDERAL TRANSIT ADMINISTRATIO U.S. DEPARTMENT OF TRANSPORTATION, UNDER THE URBAN MASS TRANSPORTATION AC OF 1964 AS AMENDED FOR THE
ο.	DATE	DESCRIPTION	OF 1964, AS AMENDED, FOR THE PORT AUTHORITY OF ALLEGHENY
		REVISIONS	COUNTY, PENNSYLVANIA.


(NOT FOR CONSTRUCTION)

				FOR RO	ADWAY PLAN S	SEE SHEET	367
	DESIGNED	SDS	PORT AUTHOR	ITY OF AL	LEGHENY (	COUNTY	1
	DRAWN	<u>JMS</u>	PITTSBURGH		ĺ	PENNSYLVANIA	4
	CHECKED	BFS	BUS RAPID TE	OWN TO OA	KLAND		
	IN CHARGE	LAR	ROADWAY PROFILE				
	DATE	05/01/24 FIFTH AVE - STA 485+50 TO STA 490+50					
SCALE AS SHOWN		AS SHOWN Port Authority CONTRACT NO. BRT-				T-001	
	_ ^	AG GITOWIN	connecting people to life	DWG. NO.	PP57	SHT.	413


OPERATOR: "michael.mogarry" FILE PATH: c:\pwworking\aecom\_ds16\_na\michael.m

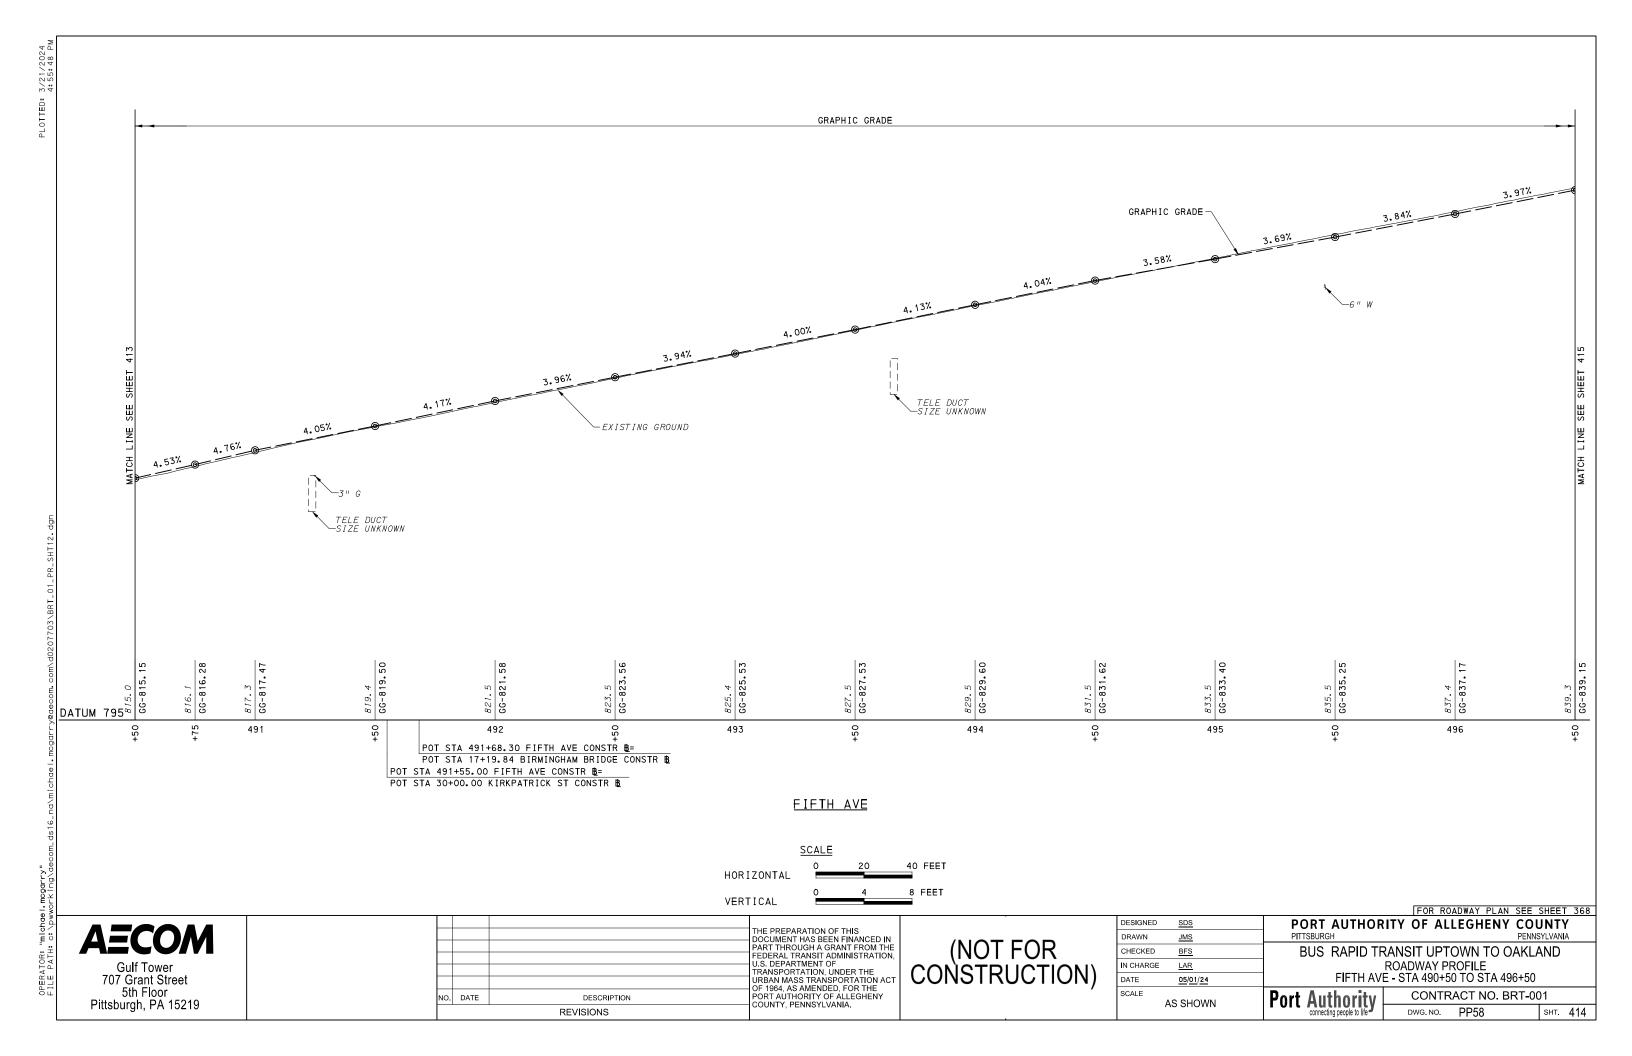

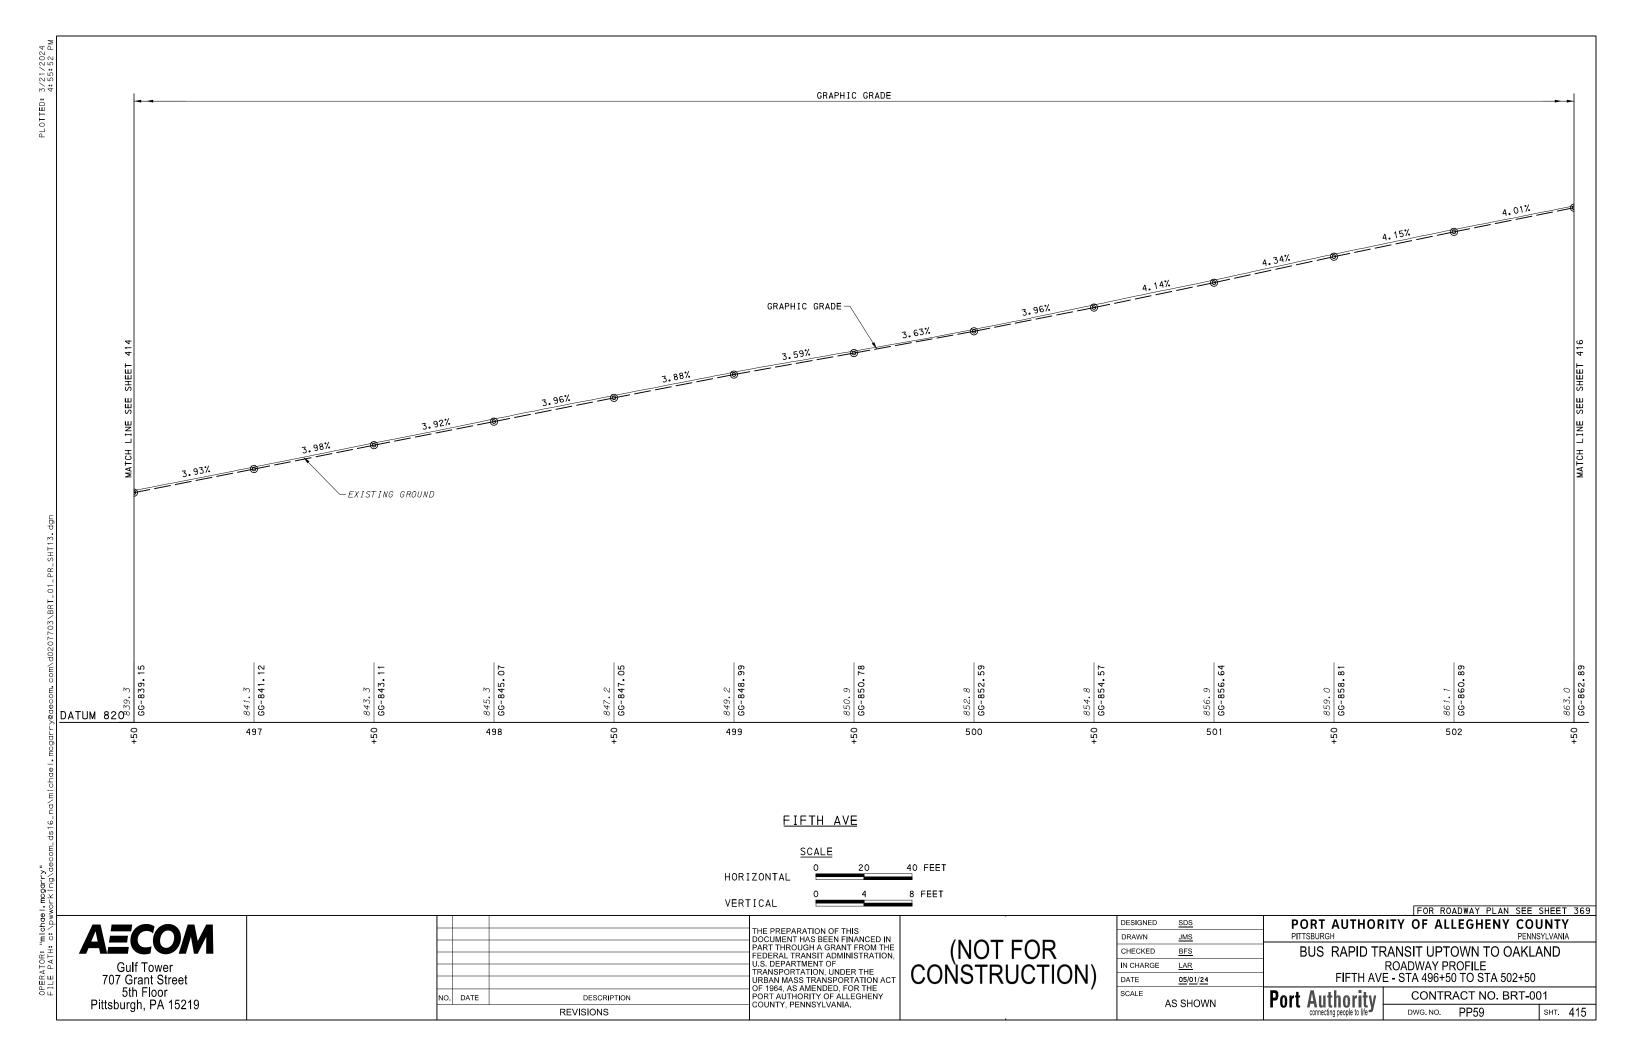

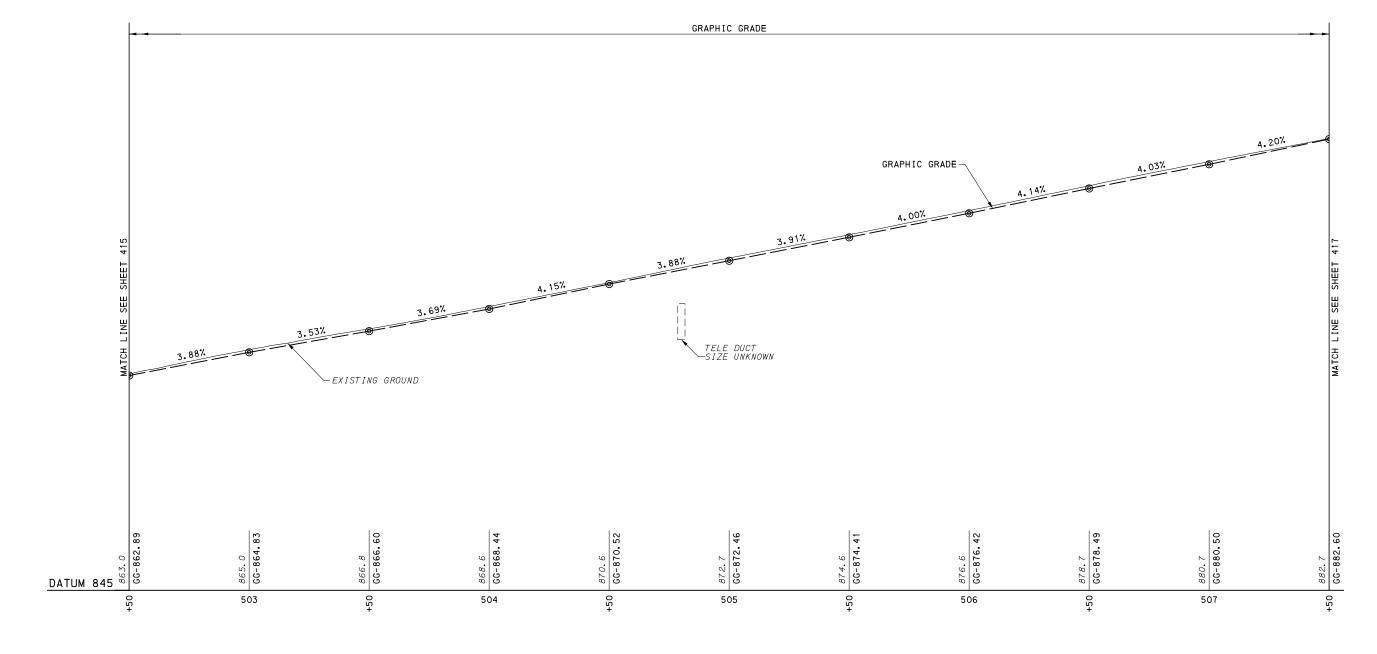

# <u>FIFTH AVE</u>

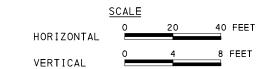


Gulf Tower
707 Grant Street
5th Floor
Pittsburgh, PA 15219


			THE DREPARATION OF THE
			THE PREPARATION OF THIS  DOCUMENT HAS BEEN FINANCED IN
			PART THROUGH A GRANT FROM THE
			FEDERAL TRANSIT ADMINISTRATION U.S. DEPARTMENT OF
			TRANSPORTATION, UNDER THE
			URBAN MASS TRANSPORTATION AC OF 1964, AS AMENDED, FOR THE
ΝΟ.	DATE	DESCRIPTION	PORT AUTHORITY OF ALLEGHENY COUNTY, PENNSYLVANIA.
		REVISIONS	COUNTY, PENNSTEVANIA.


(NOT FOR CONSTRUCTION)


			FOR RO	ADWAY PLAN	SEE SHEE	T 370
ESIGNED	SDS	PORT AUTHOR				
RAWN	<u>JMS</u>	PITTSBURGH			PENNSYLVAN	A
HECKED	BFS	BUS RAPID TRANSIT UPTOWN TO OAKLAND				
I CHARGE	LAR	ROADWAY PROFILE				
ATE	05/01/24	FIFTH AVE - STA 502+50 TO STA 507+50				
CALE AS SHOWN		Port Authority CONTRACT NO. BRT			RT-001	
		connecting people to life	DWG. NO.	PP60	SHT.	416


ERATOR: "michael.mcgarry" LE PATH: c:\pwworking\aecom\_ds16\_na\michael.mcgarr;

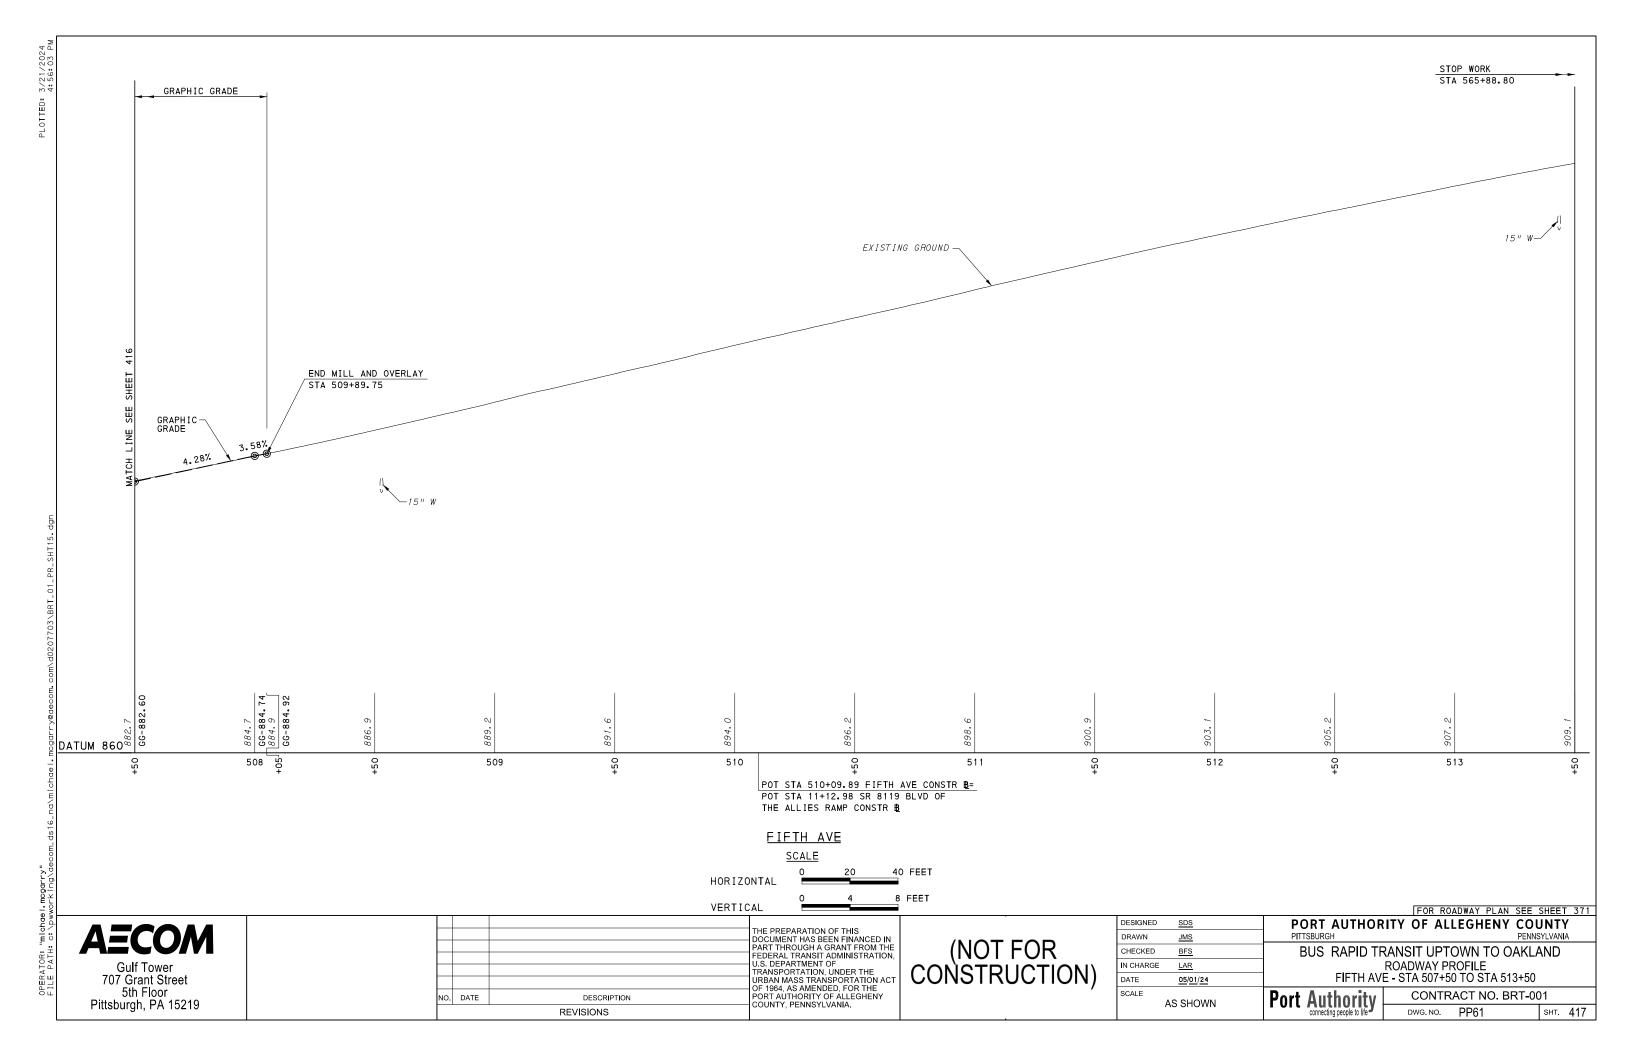


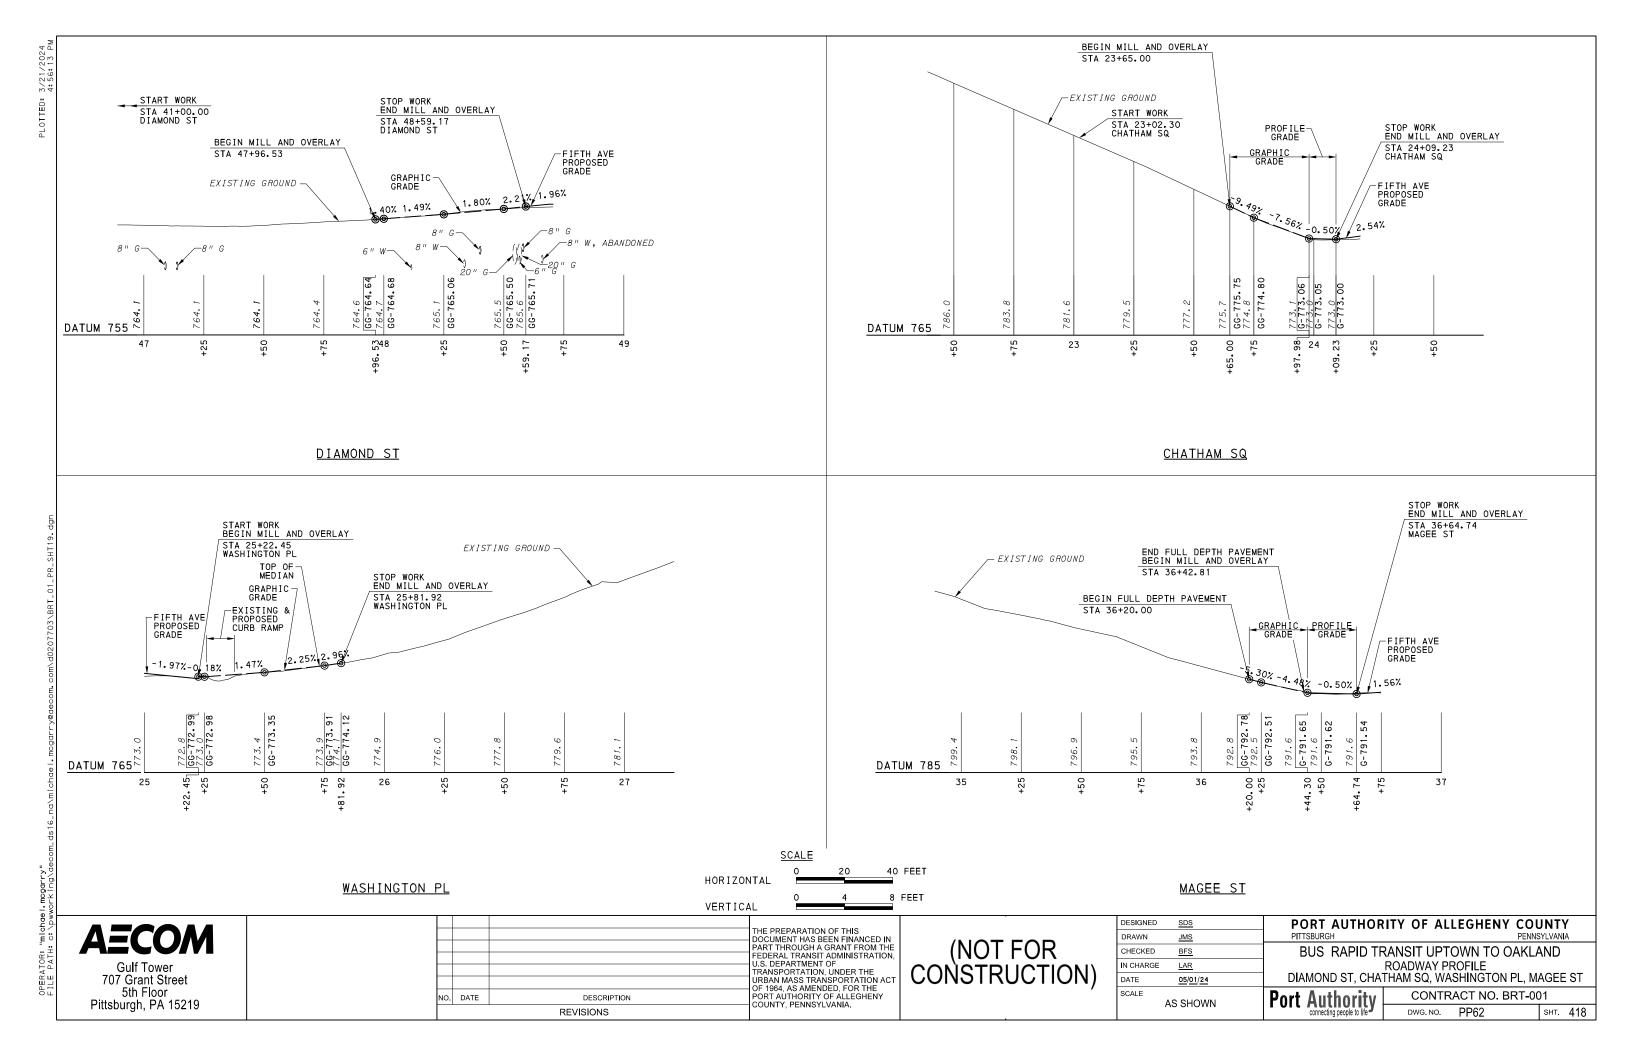


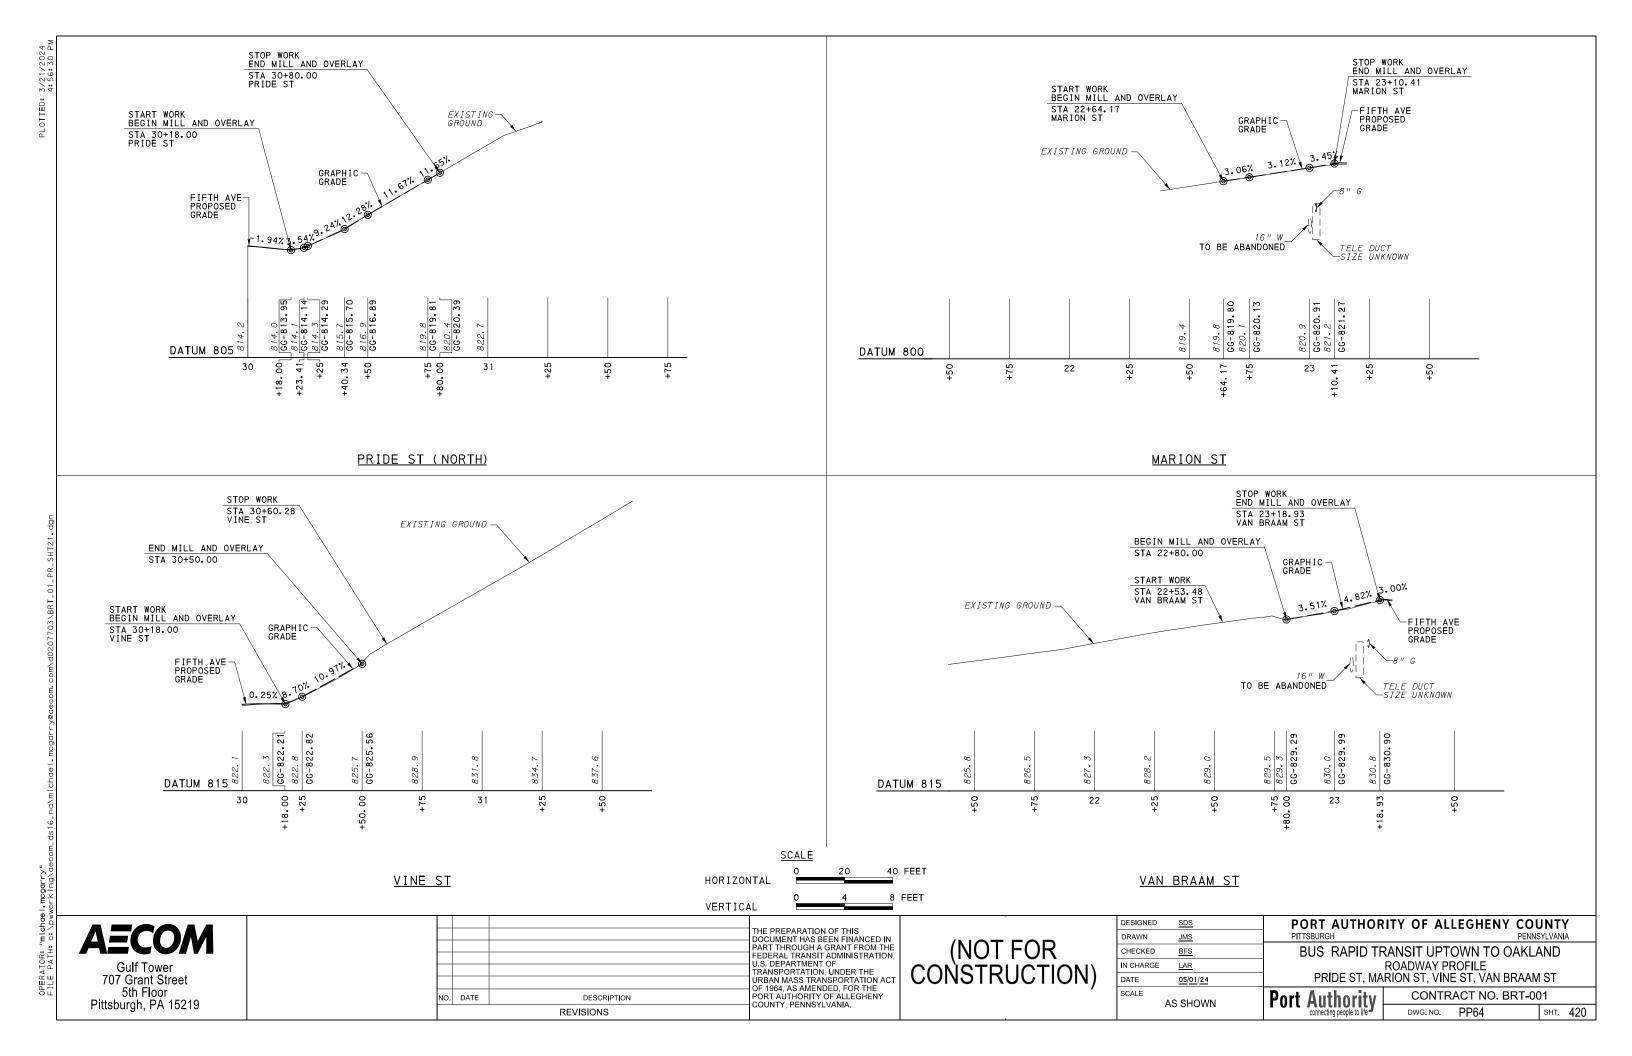

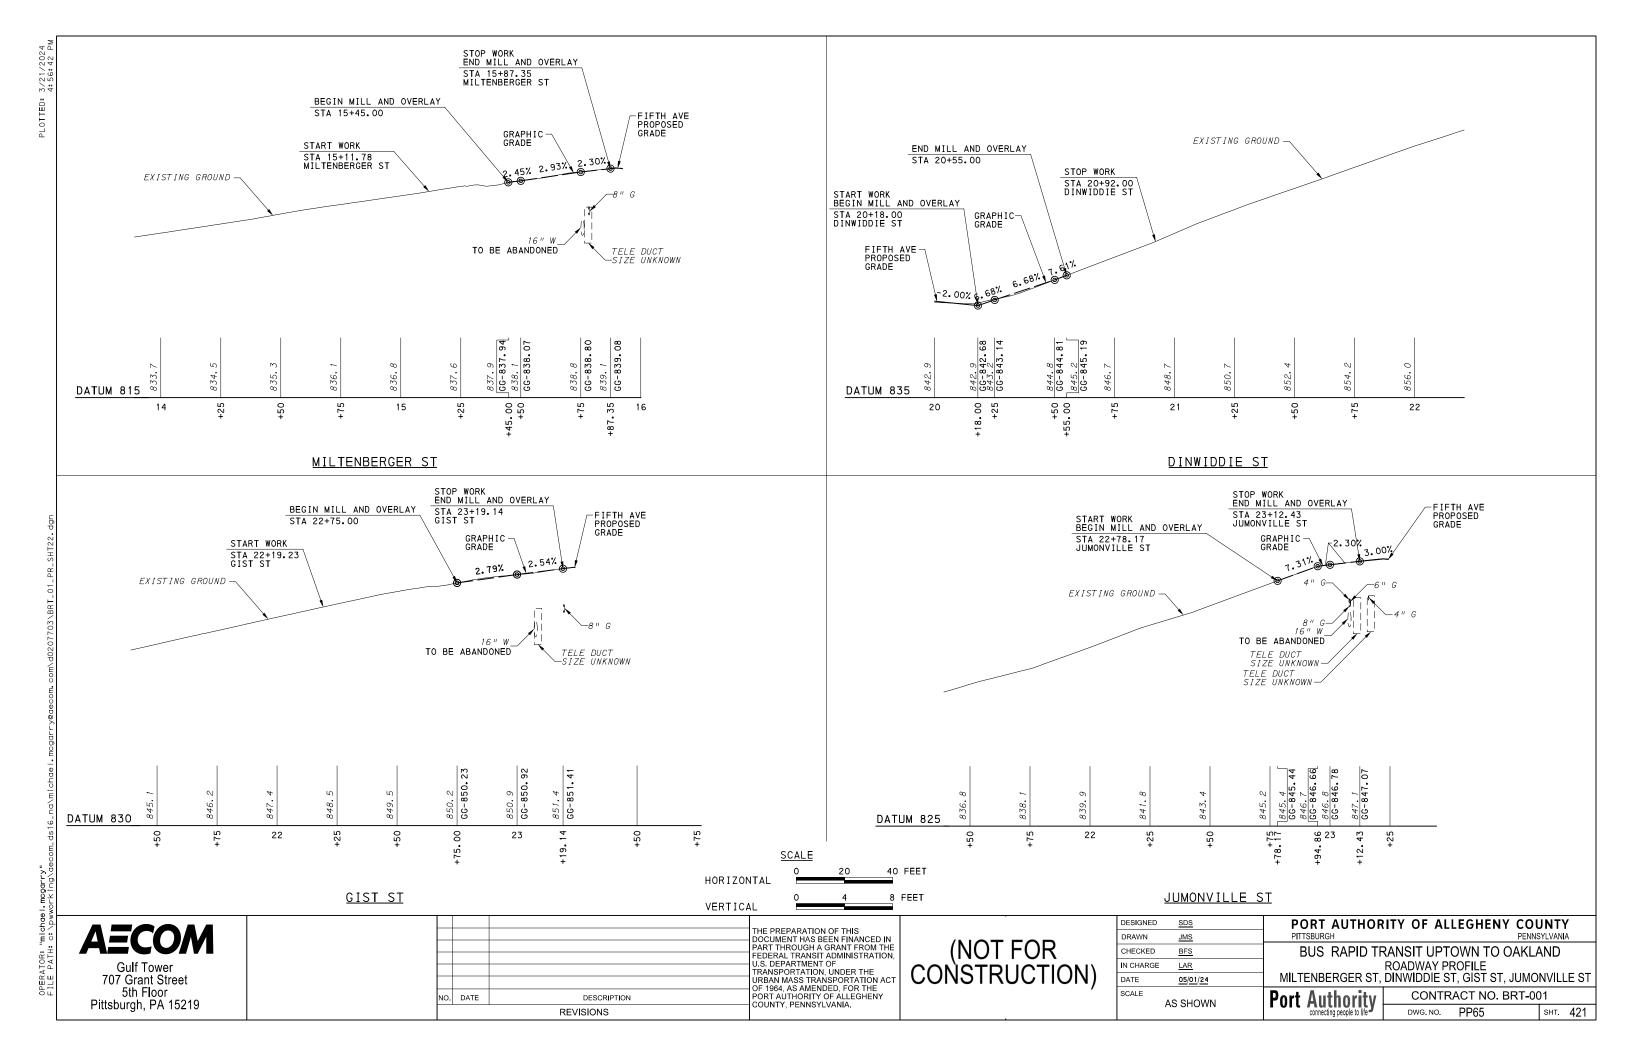

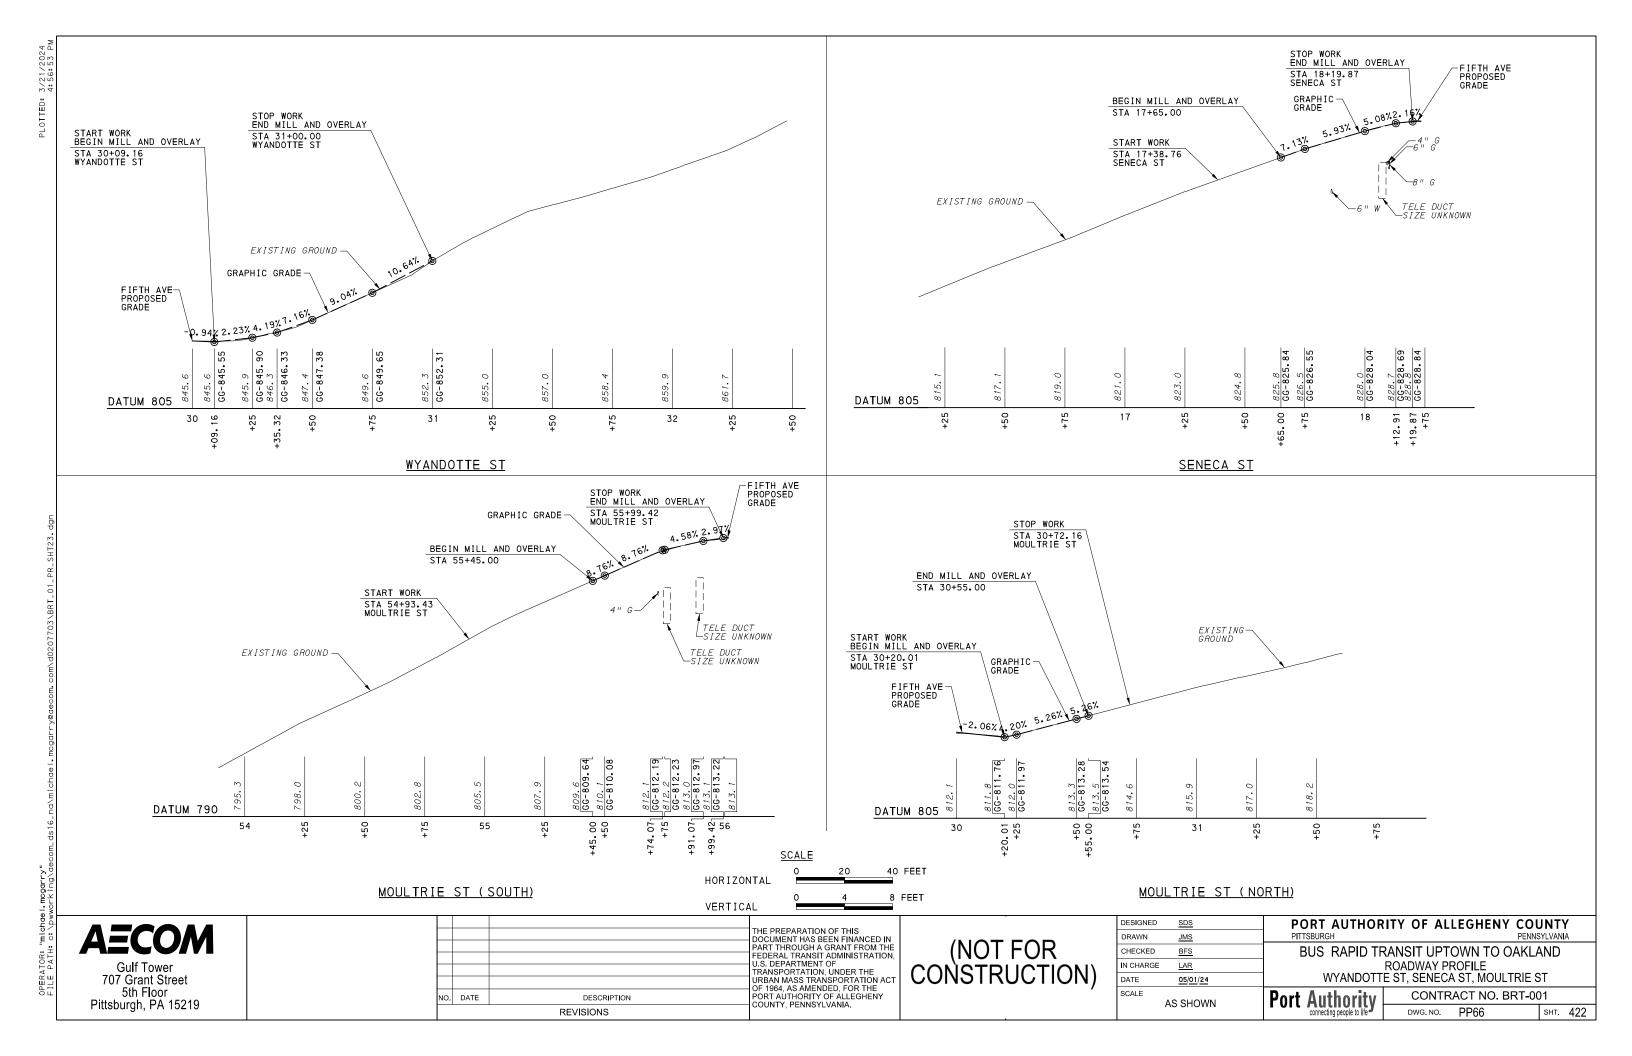

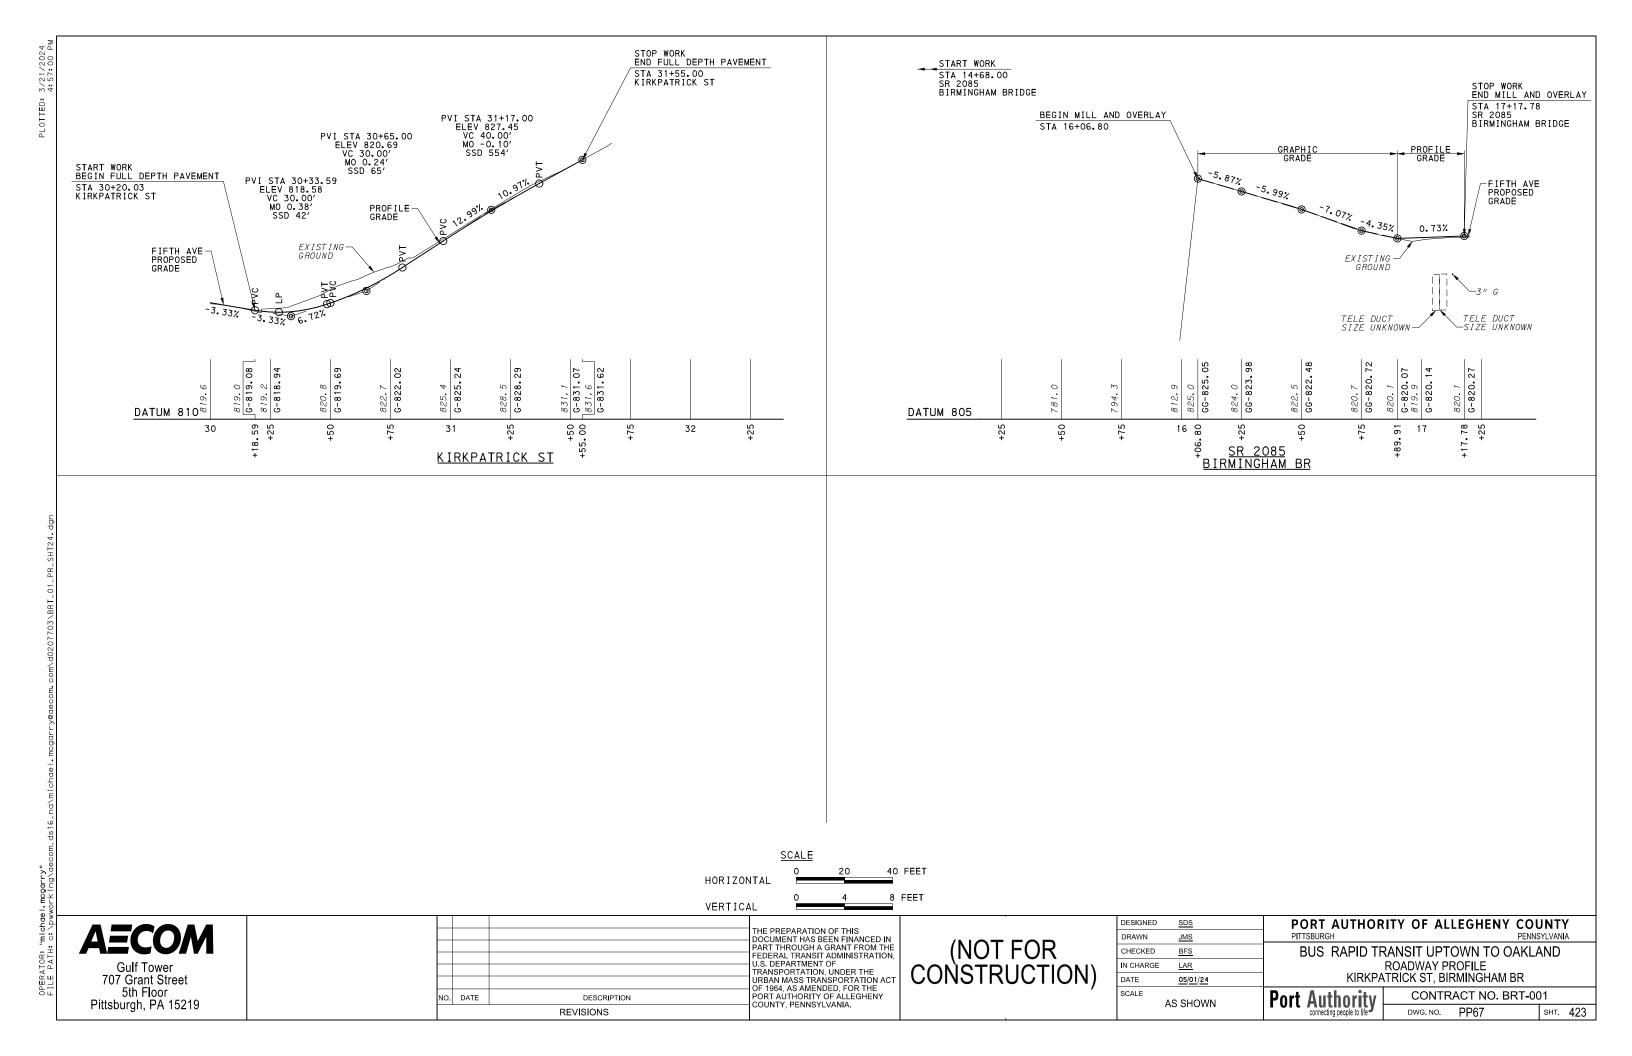

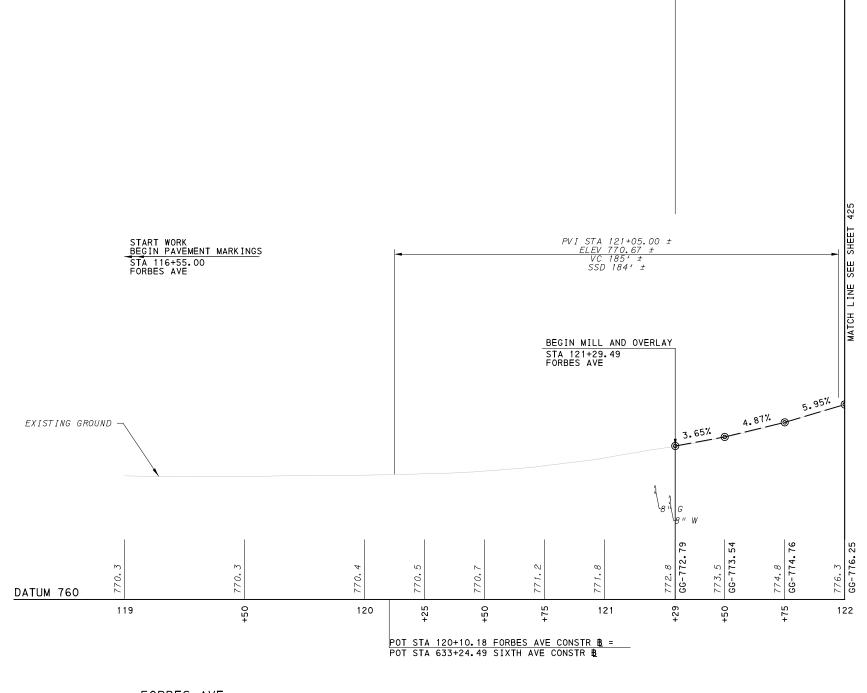

### FORBES AVE



AECOM Gulf Tower

GANNETT Foster Plaz Suite 400 730 Grant Street 5th Floor Pittsburgh, PA 15219


<b>GANNETT FLEMING</b>	ŀ
GANNETT FLEMING, INC.	ŀ
Foster Plaza 8	ŀ
Suite 400 730 Holiday Drive	ŀ
730 Holiday Drive Pittsburgh, PA. 15220	ŀ
j ,	l

			THE PREPARATION OF THIS DOCUMENT HAS BEEN FINANCED IN
			PART THROUGH A GRANT FROM THE
			FEDERAL TRANSIT ADMINISTRATION, U.S. DEPARTMENT OF
			TRANSPORTATION, UNDER THE
			URBAN MASS TRANSPORTATION ACT OF 1964, AS AMENDED, FOR THE
٥.	DATE	DESCRIPTION	PORT AUTHORITY OF ALLEGHENY COUNTY, PENNSYLVANIA.
		REVISIONS	COUNTY, FERNISTEVANIA.

(NOT FOR CONSTRUCTION)

				FOR R	DADWAY PLA	AN SEE S	HEET	382
DESIGNED	RRH	PORT	AUTHOR	ITY OF AL	LEGHEN	Y COU	NTY	,
DRAWN	RRH	PITTSBURG	SH			PENNSY	LVANIA	4
CHECKED KCF BUS RAPID TRANSIT UPTOWN TO OAKLA			OAKLA	ND				
N CHARGE <u>GEC</u>		ROADWAY PROFILE						
DATE	05/01/24	FORBES AVE - STA 119+00 TO STA 122+00						
AS SHOWN		Port Authority CONTRACT NO. BRT-001		1				
	.5 SHOWN	connect	ting people to life	DWG. NO.	PP68	:	SHT.	424

GRAPHIC GRADE

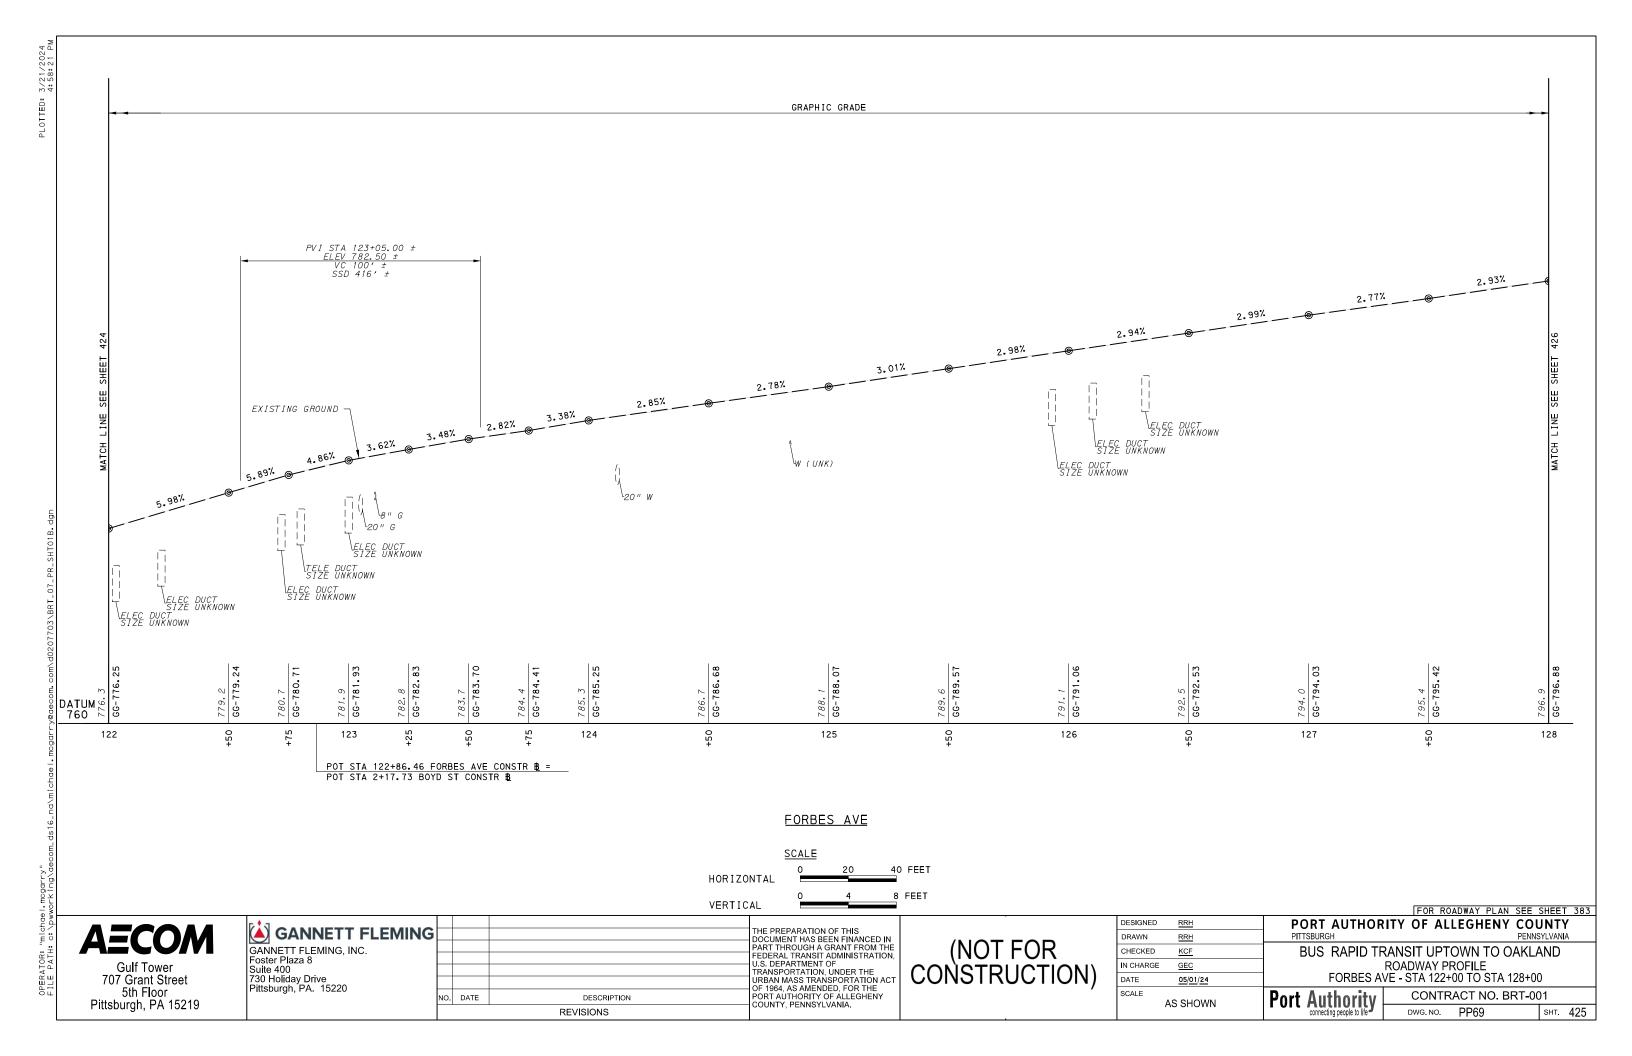



POT STA 129+23.18 FORBES AVE CONSTR & POT STA 129+24.37 FORBES AVE CONSTR & POT STA 4+00.00 McANULTY DR CONSTR &

#### FORBES AVE

131

SCALE 40 FEET HORIZONTAL VERTICAL

**AECOM** 

Gulf Tower 707 Grant Street 5th Floor Pittsburgh, PA 15219

GANNETT FLEMING
GANNETT FLEMING, INC.
Foster Plaza 8
Suite 400
730 Holiday Drive
Pittsburgh, PA. 15220

		THE PREPARATION OF THIS DOCUMENT HAS BEEN FINANCED IN
		PART THROUGH A GRANT FROM THE
		FEDERAL TRANSIT ADMINISTRATION, U.S. DEPARTMENT OF
		TRANSPORTATION, UNDER THE
		URBAN MASS TRANSPORTATION ACT OF 1964, AS AMENDED, FOR THE
DATE	DESCRIPTION	PORT AUTHORITY OF ALLEGHENY COUNTY, PENNSYLVANIA.
	REVISIONS	COUNTY, PENNSTEVANIA.

130


(NOT FOR CONSTRUCTION)


150

132

			FOR RC	DADWAY PLAN	SEE SHEET	384
DESIGNED	RRH	PORT AUTHOR	ITY OF AL	LEGHENY	COUNTY	7
DRAWN	<u>RRH</u>	PITTSBURGH			PENNSYLVANI	A
CHECKED KCF		BUS RAPID TRANSIT UPTOWN TO OAKLAND				
N CHARGE <u>GEC</u>		ROADWAY PROFILE				
DATE	05/01/24	FORBES A'	√E - STA 128+	+00 TO STA 1	33+50	
SCALE AS SHOWN		Port Authority CONTRACT NO. BRT-001		RT-001		
AS SHOWN		connecting people to life	DWG NO	DD70	SHT	126

133

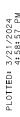

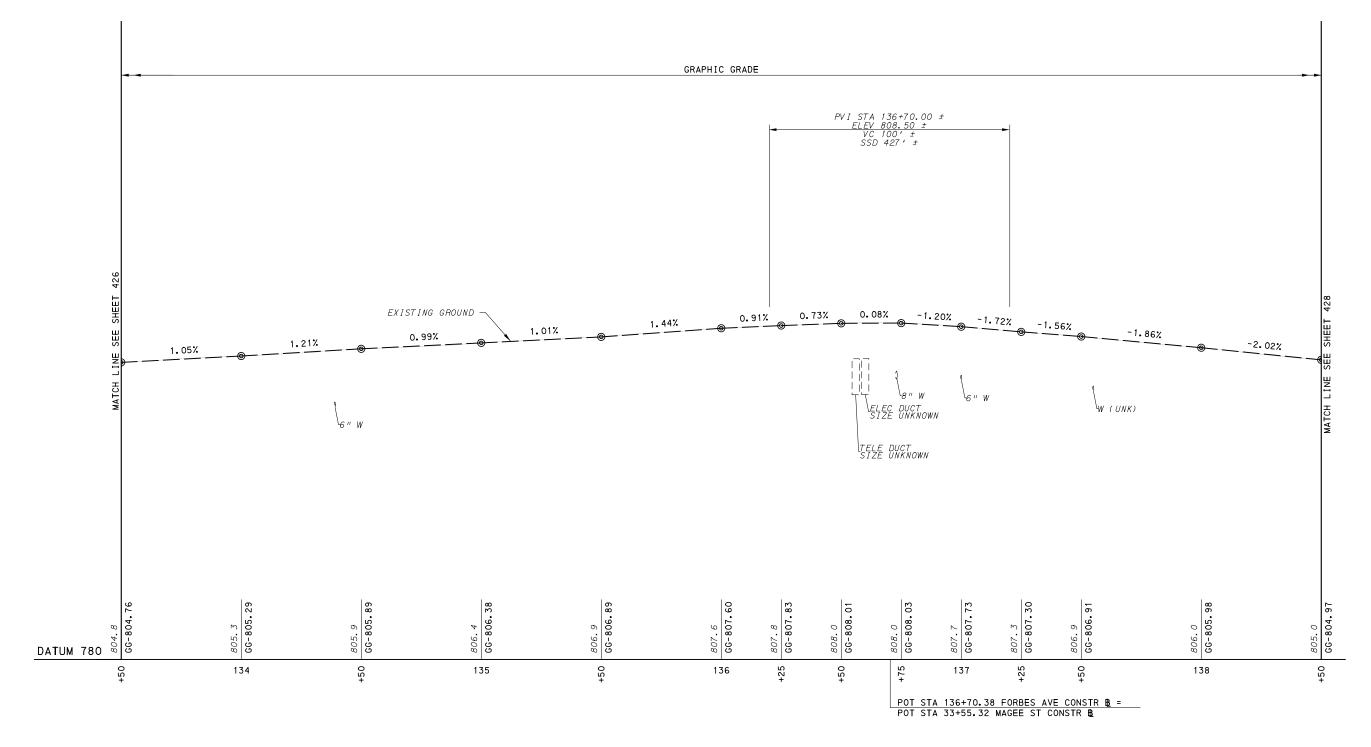

#### FORBES AVE



**AECOM**Gulf Tower


Gulf Tower 707 Grant Street 5th Floor Pittsburgh, PA 15219 GANNETT FLEMING
GANNETT FLEMING, INC.
Foster Plaza 8
Suite 400
730 Holiday Drive
Pittsburgh, PA. 15220


NO. DATE
DESCRIPTION
REVISIONS

THE PREPARATION OF THIS
DOCUMENT HAS BEEN FINANCED IN
PART THROUGH A GRANT FROM THE
FEDERAL TRANSIT ADMINISTRATION,
U.S. DEPARTMENT OF
TRANSPORTATION, UNDER THE
URBAN MASS TRANSPORTATION ACT
OF 1964, AS AMENDED, FOR THE
PORT AUTHORITY OF ALLEGHENY
COUNTY, PENNSYLVANIA.

			FOR ROAL	<u>DWAY PLAN SEE</u>	SHEET	<u> 385</u>
ESIGNED	RRH	PORT AUTHOR	ITY OF ALL	EGHENY CO	UNT	/
RAWN	RRH	PITTSBURGH		PENN	ISYLVANI	Д
HECKED	KCF	BUS RAPID TRANSIT UPTOWN TO OAKLAND				
CHARGE	GEC	ROADWAY PROFILE				
ATE	05/01/24	FORBES AVE - STA 133+50 TO STA 138+50				
CALE /	AS SHOWN	Port Authority	CONTRA	CT NO. BRT-0	01	
,	TO OLIOVVIV	connecting people to life	DWG. NO.	PP71	SHT.	427

OPERATOR: "michael.mcgarry" FILE PATH: c:\pwworking\aecom\_ds16\_na\mic

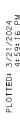

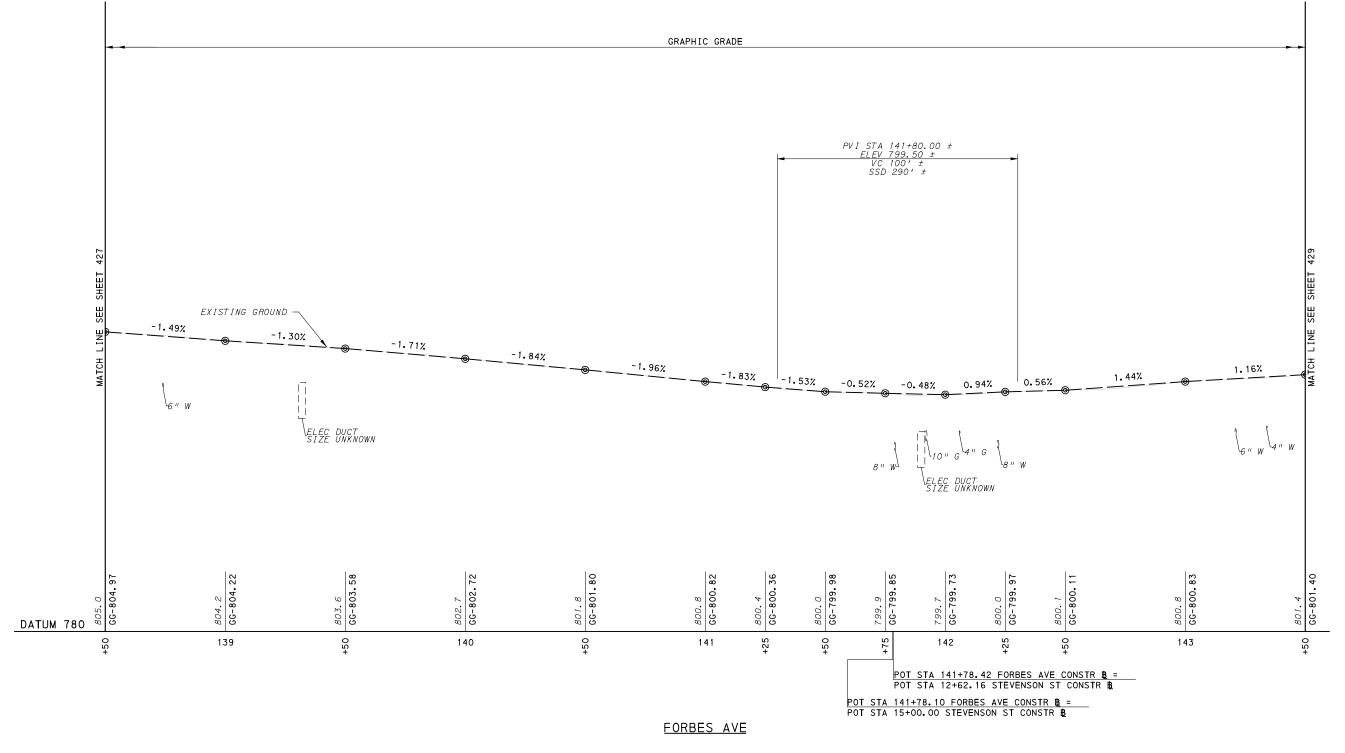



**AECOM**Gulf Tower

Gulf Tower 707 Grant Street 5th Floor Pittsburgh, PA 15219 GANNETT FLEMING

GANNETT FLEMING, INC.

Foster Plaza 8
Suite 400
730 Holiday Drive
Pittsburgh, PA. 15220


No. DATE


REVISIONS

THE PREPARATION OF THIS
DOCUMENT HAS BEEN FINANCED IN
PART THROUGH A GRANT FROM THE
FEDERAL TRANSIT ADMINISTRATION,
U.S. DEPARTMENT OF
TRANSPORTATION, UNDER THE
URBAN MASS TRANSPORTATION ACT
OF 1964, AS A MENDED, FOR THE
PORT AUTHORITY OF ALLEGHENY
COUNTY, PENNSYLVANIA.

(NOT FOR CONSTRUCTION)

		FOR ROADWAY PLAN SI	E SHEET 386	
DESIGNED RRH	PORT AUTHOR	ITY OF ALLEGHENY C	OUNTY	
DRAWN RRH	PITTSBURGH	P	ENNSYLVAN <b>I</b> A	
CHECKED KCF	BUS RAPID TE	RANSIT UPTOWN TO OAI	KLAND	
IN CHARGE GEC ROADWAY PROFILE				
DATE <u>05/01/24</u>	FORBES A	√E - STA 138+50 TO STA 143	+50	
SCALE AS SHOWN	Port Authority CONTRACT NO. BRT-00			
ASSHOWN	connecting people to life	DWG. NO. PP72	sнт. 428	

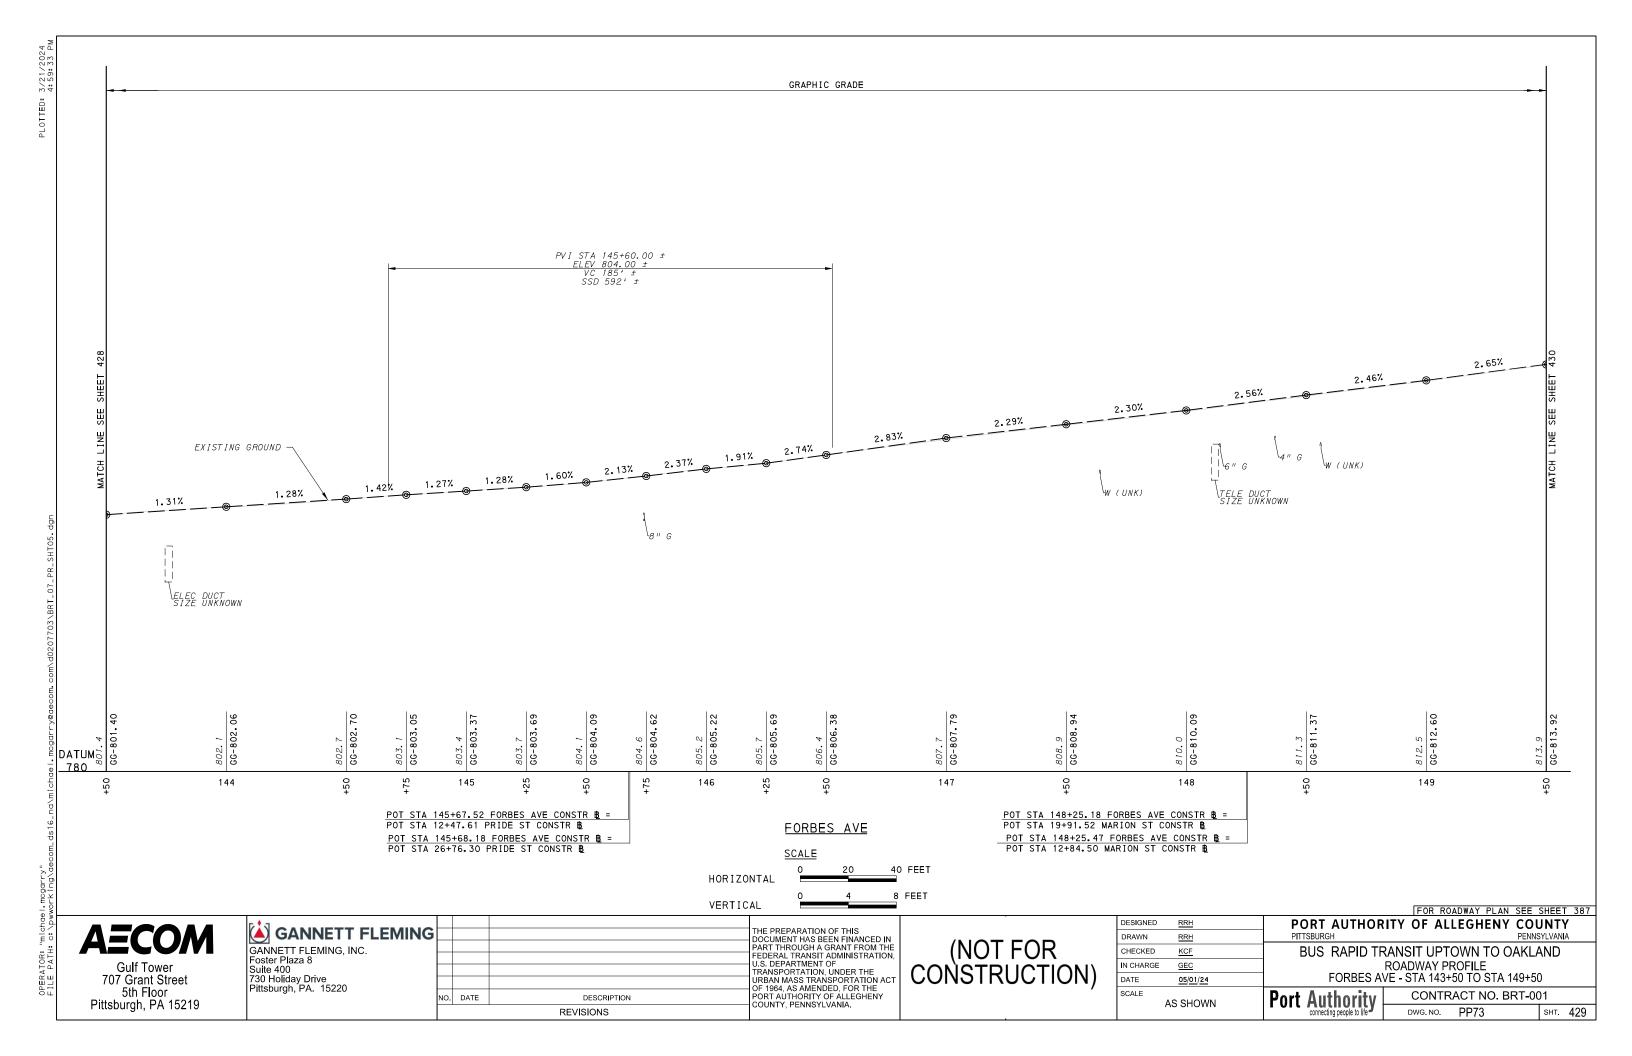

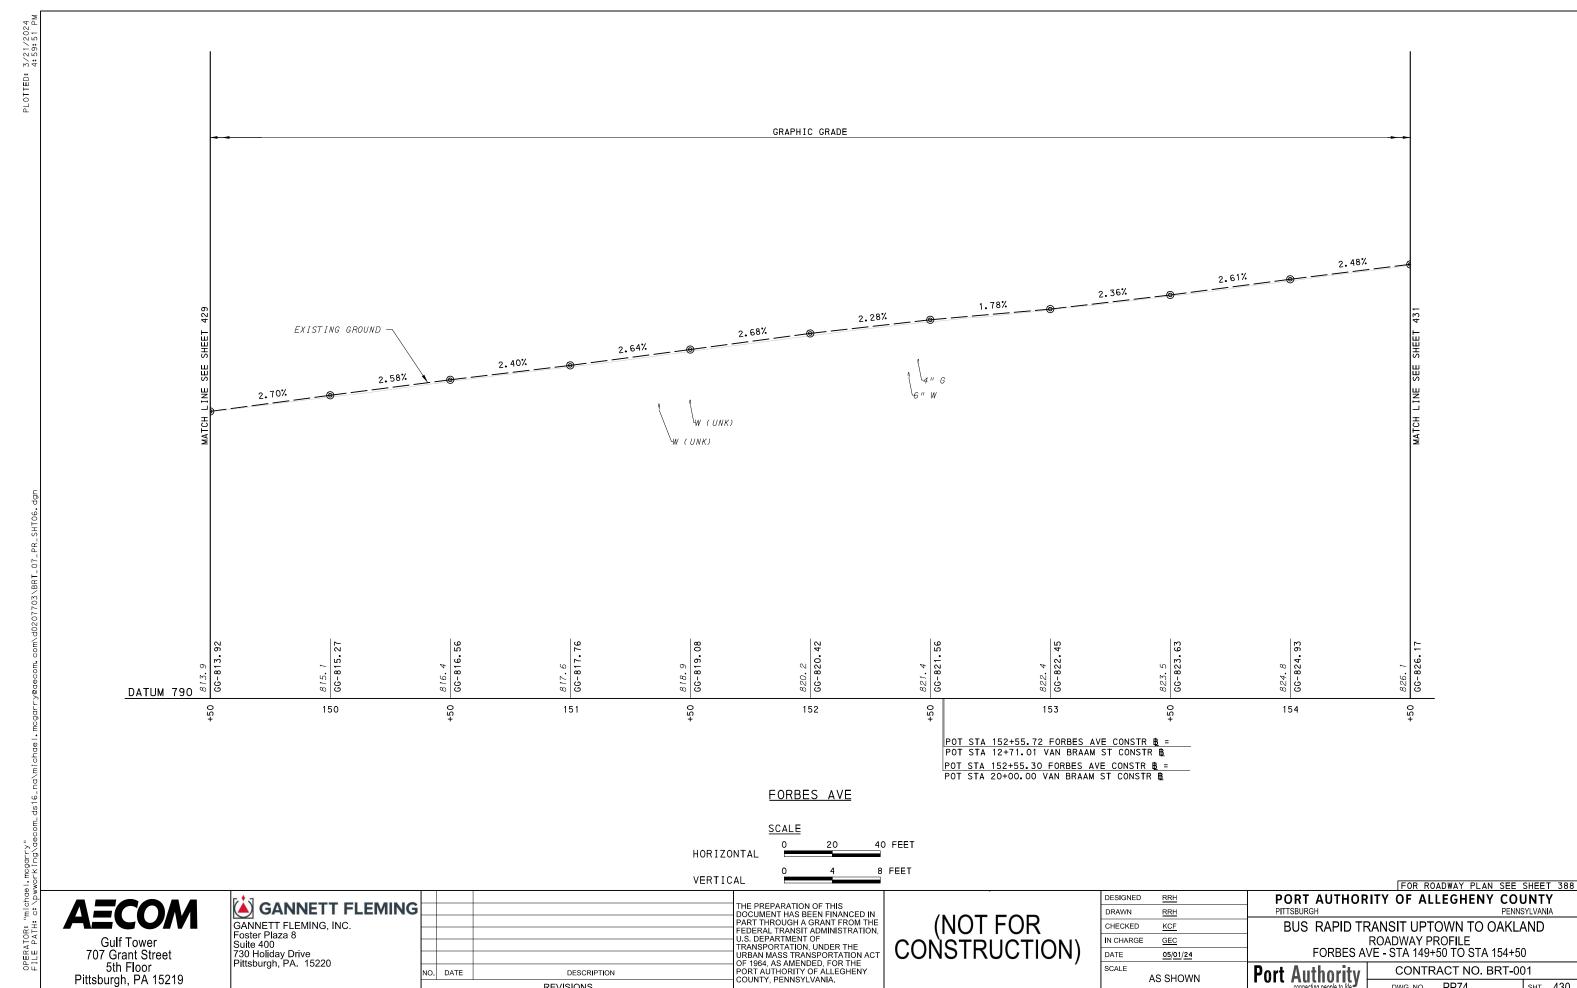

SCALE

AS SHOWN

Port Authority connecting people to life

CONTRACT NO. BRT-001

sнт. **430** 

PP74


DWG. NO.


5th Floor Pittsburgh, PA 15219

NO. DATE


DESCRIPTION

REVISIONS

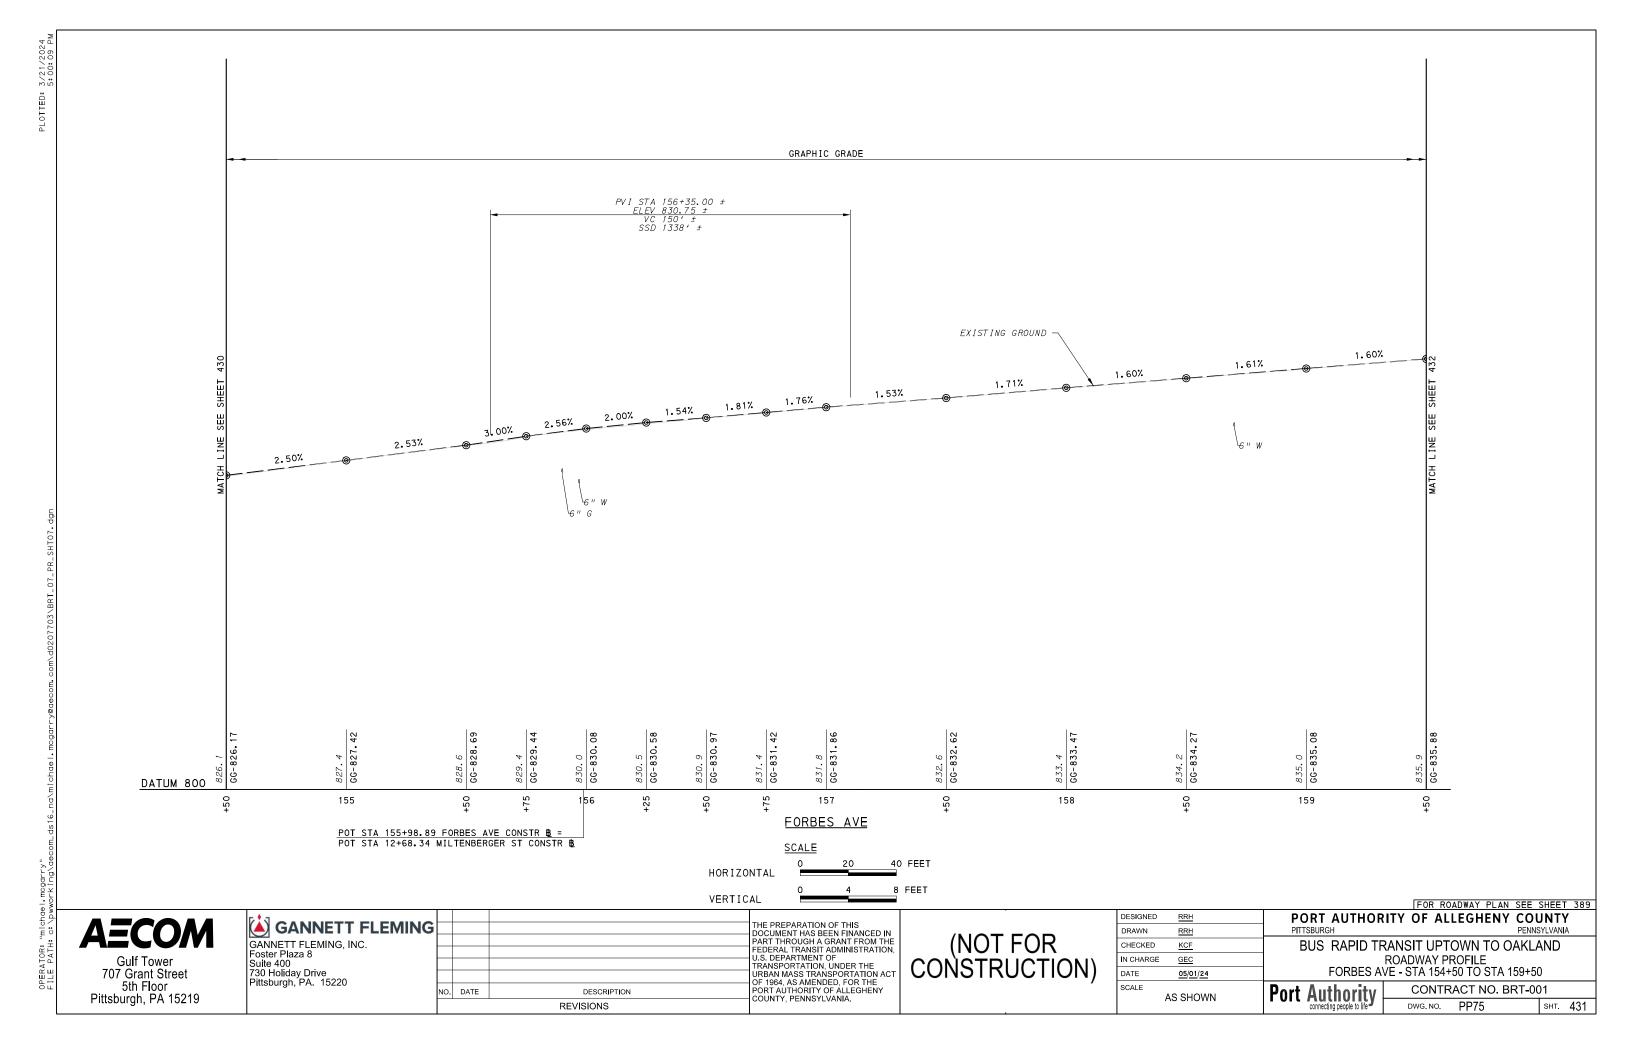

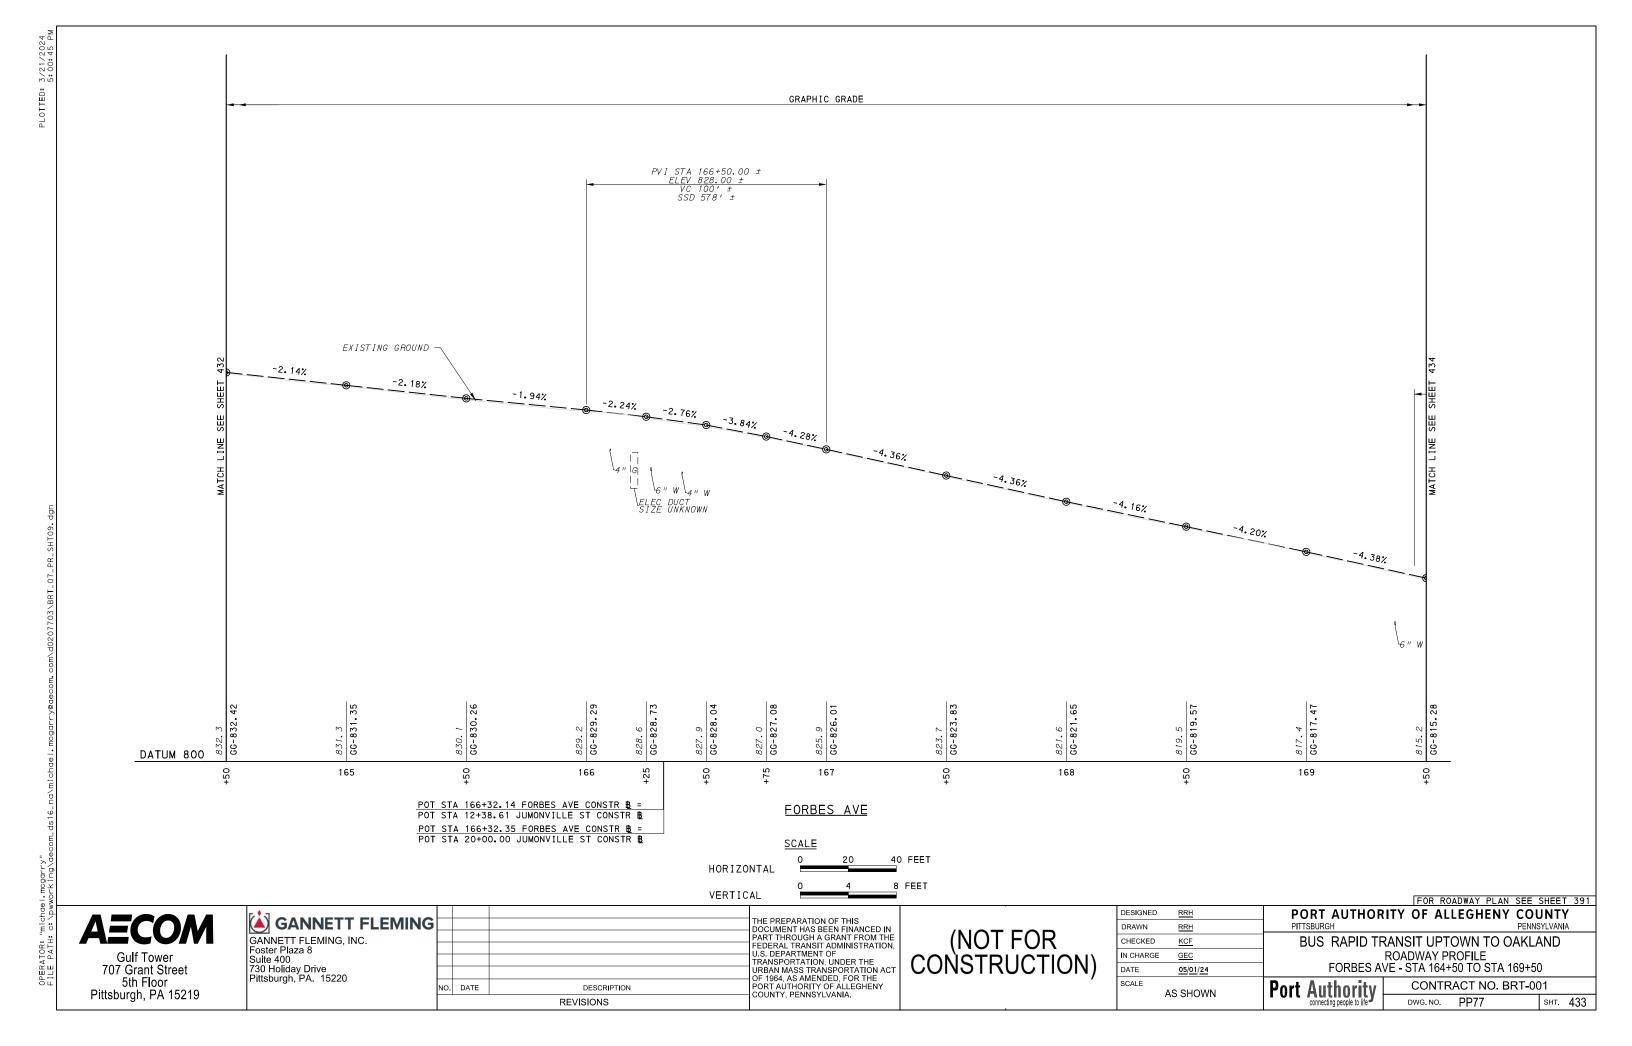



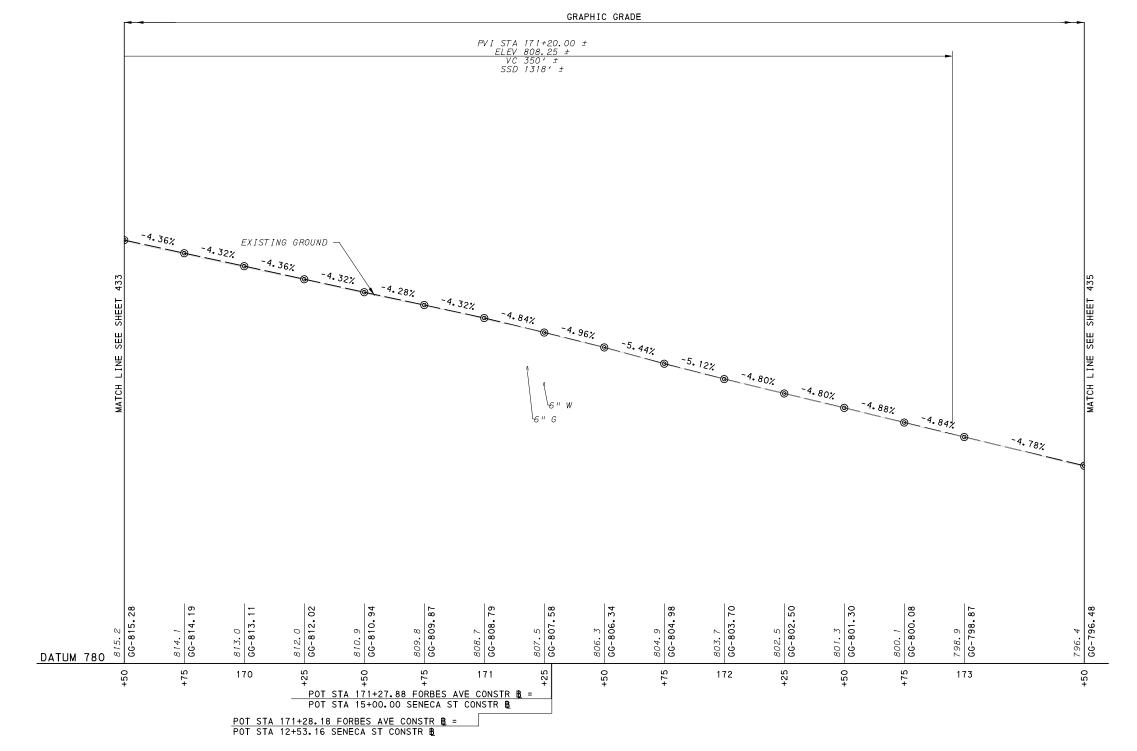

#### FORBES AVE

SCALE

O 20 40 FEET

VERTICAL


O 4 8 FEET

**AECOM**Gulf Tower

Gulf Tower 707 Grant Street 5th Floor Pittsburgh, PA 15219 GANNETT FLEMING
GANNETT FLEMING, INC.
Foster Plaza 8
Suite 400
730 Holiday Drive
Pittsburgh, PA. 15220

			THE PREPARATION OF THIS  DOCUMENT HAS BEEN FINANCED IN
			PART THROUGH A GRANT FROM TH
			FEDERAL TRANSIT ADMINISTRATION
			TRANSPORTATION, UNDER THE
			URBAN MASS TRANSPORTATION AC OF 1964. AS AMENDED. FOR THE
•	DATE	DESCRIPTION	PORT AUTHORITY OF ALLEGHENY COUNTY, PENNSYLVANIA.
		REVISIONS	COONTY, FENNSTEVANIA.

			FOR ROA	ADWAY PLAN SEE	SHEET	392
DESIGNED	RRH	PORT AUTHOR	ITY OF ALL	EGHENY COL	JNTY	
DRAWN	RRH	PITTSBURGH		PENN	SYLVANIA	
CHECKED	KCF	BUS RAPID TF	RANSIT UPTO	OWN TO OAKL	AND	
IN CHARGE	GEC		<b>ROADWAY PR</b>	OFILE		
DATE	05/01/24	FORBES A	VE - STA 169+5	50 TO STA 173+5	)	
SCALE	AS SHOWN Port Authority		CONTRA	ACT NO. BRT-00	)1	
<b>'</b>	O OHOWN	connecting people to life	DWG. NO.	PP78	SHT.	434

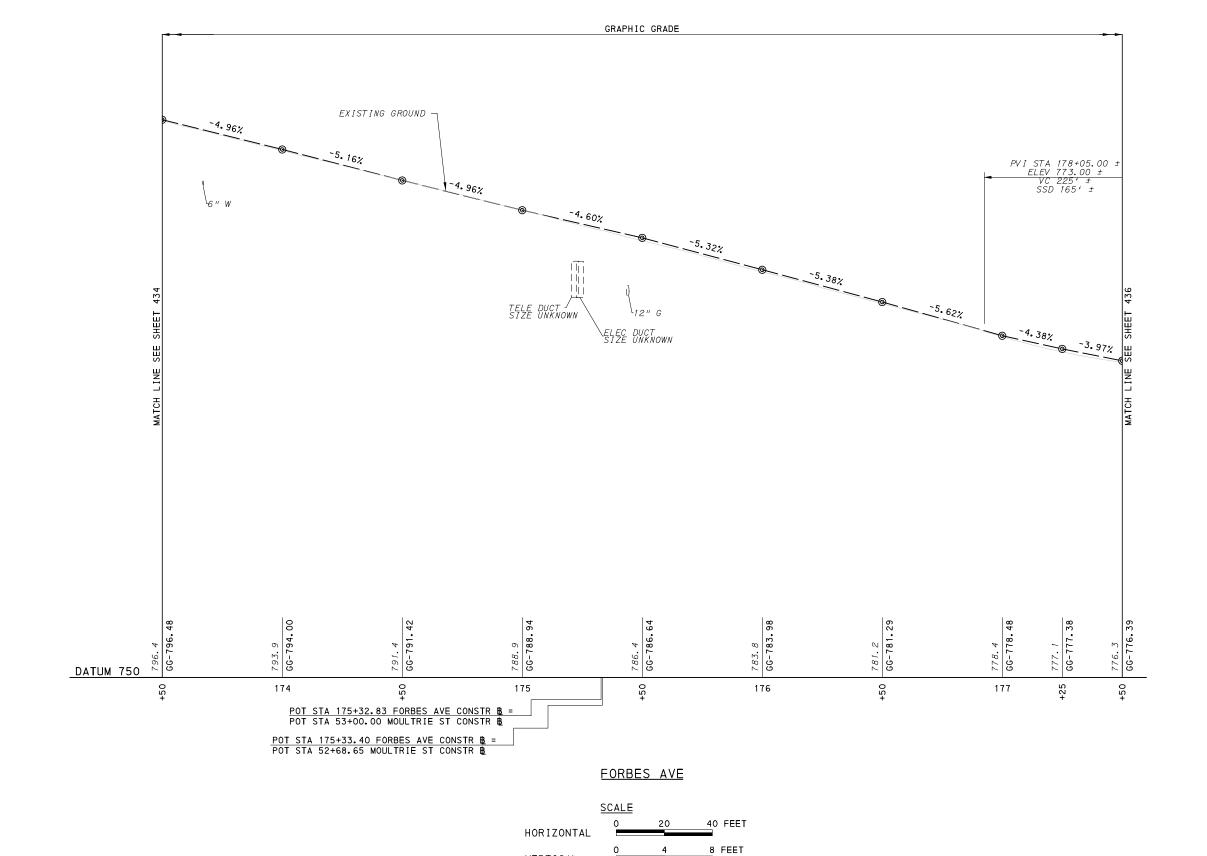


**AECOM**Gulf Tower

Gulf Tower 707 Grant Street 5th Floor Pittsburgh, PA 15219 GANNETT FLEMING
GANNETT FLEMING, INC.
Foster Plaza 8
Suite 400
730 Holiday Drive
Pittsburgh, PA. 15220


			THE PREPARATION OF THIS DOCUMENT HAS BEEN FINANCED IN
			PART THROUGH A GRANT FROM THE
			FEDERAL TRANSIT ADMINISTRATION, U.S. DEPARTMENT OF
			TRANSPORTATION, UNDER THE
			URBAN MASS TRANSPORTATION ACT OF 1964, AS AMENDED, FOR THE
ο.	DATE	DESCRIPTION	PORT AUTHORITY OF ALLEGHENY COUNTY, PENNSYLVANIA.
		REVISIONS	COONTY, FEMNOTEVANIA.

VERTICAL

		FOR ROADWAY PLAN SE	E SHEET 393
DESIGNED RRH	PORT AUTHOR	ITY OF ALLEGHENY C	OUNTY
DRAWN RRH	PITTSBURGH	PI	NNSYLVANIA
CHECKED KCF	BUS RAPID TE	RANSIT UPTOWN TO OAF	KLAND
IN CHARGE GEC		ROADWAY PROFILE	
DATE <u>05/01/24</u>	FORBES A	√E - STA 173+50 TO STA 177	+50
SCALE AS SHOWN	Port Authority	CONTRACT NO. BRT	-001
ASSHOWN	connecting people to life	DWG. NO. PP79	sнт. <b>435</b>

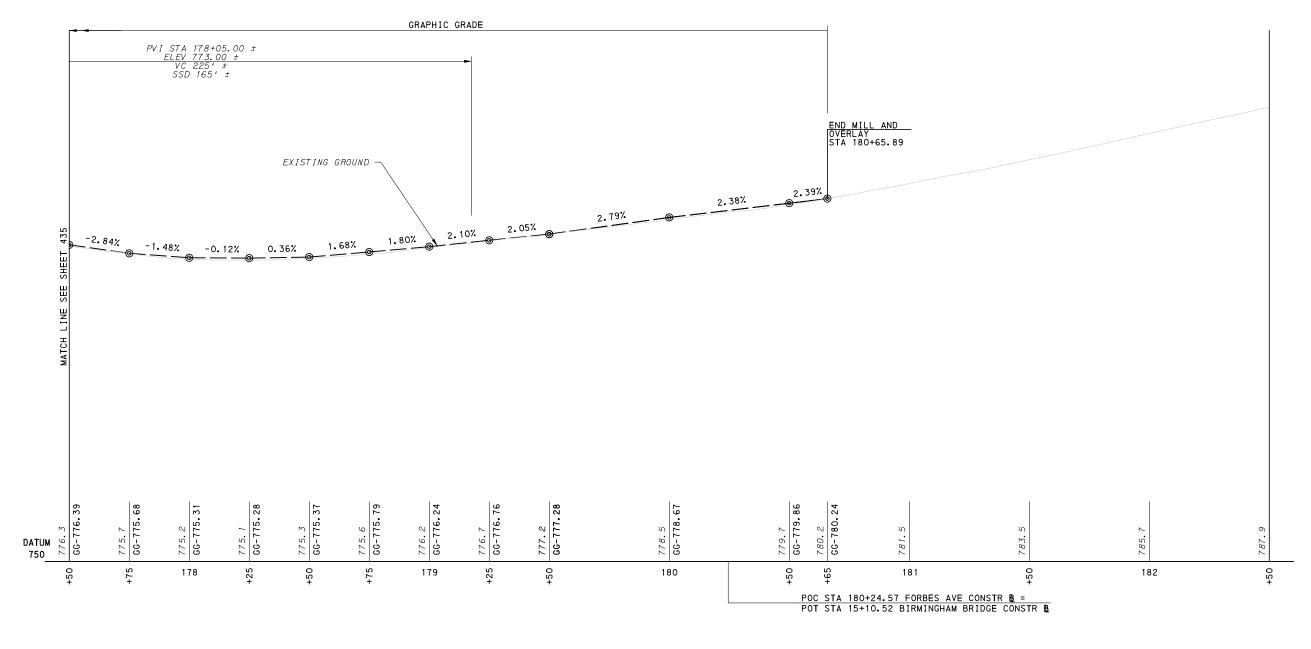

#### FORBES AVE

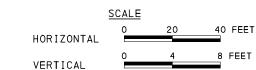

**AECOM**Gulf Tower


Gulf Tower 707 Grant Street 5th Floor Pittsburgh, PA 15219 GANNETT FLEMING
GANNETT FLEMING, INC.
Foster Plaza 8
Suite 400
730 Holiday Drive
Pittsburgh, PA. 15220

		THE PREPARATION OF THIS DOCUMENT HAS BEEN FINANCED IN PART THROUGH A GRANT FROM THE FEDERAL TRANSIT ADMINISTRATION, U.S. DEPARTMENT OF TRANSPORTATION, UNDER THE URBAN MASS TRANSPORTATION ACT OF 1964. AS AMENDED. FOR THE
DATE	DESCRIPTION	PORT AUTHORITY OF ALLEGHENY COUNTY, PENNSYLVANIA.
	REVISIONS	COUNTY, PENINSYLVANIA.


			FOR RO	ADWAY PLAN	SEE SHEET	394
ESIGNED	RRH	PORT AUTHOR	ITY OF AL	LEGHENY	COUNTY	,
RAWN	RRH	PITTSBURGH			PENNSYLVANIA	4
HECKED	<u>KCF</u>	BUS RAPID TF	RANSIT UPT	OWN TO O	AKLAND	
I CHARGE	GEC		<b>ROADWAY PI</b>	ROFILE		
ATE	05/01/24	FORBES A	√E - STA 177+	50 TO STA 18	32+50	
AS SHOWN		Port Authority	CONTR	ACT NO. BF	RT-001	
		connecting people to life	DWG NO	PP80	SHT	136


END MILL AND OVERLAY


STA 2+65.00

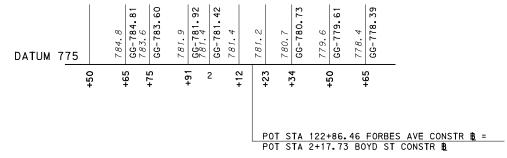

BOYD ST

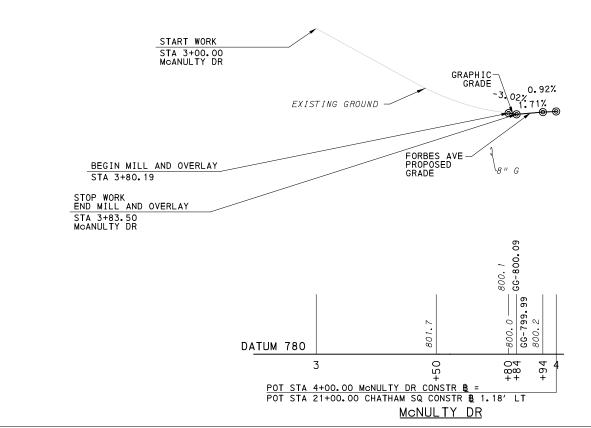

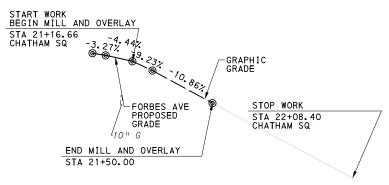

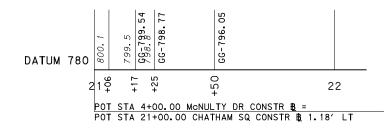

CHATHAM SQ

	<u>SCALE</u>		
HORIZONTAL	0	20	40 FEET
VERTICAL	0	4	8 FEET
VERTICAL			

**AECOM**Gulf Tower

Gulf Tower 707 Grant Street 5th Floor Pittsburgh, PA 15219 GANNETT FLEMING
GANNETT FLEMING, INC.
Foster Plaza 8
Suite 400
730 Holiday Drive
Pittsburgh, PA. 15220

		THE PREPARATION OF THIS DOCUMENT HAS BEEN FINANCED IN
		PART THROUGH A GRANT FROM THE
		FEDERAL TRANSIT ADMINISTRATION, U.S. DEPARTMENT OF
		TRANSPORTATION, UNDER THE
		URBAN MASS TRANSPORTATION ACT OF 1964, AS AMENDED, FOR THE
DATE	DESCRIPTION	PORT AUTHORITY OF ALLEGHENY COUNTY, PENNSYLVANIA.
	REVISIONS	COUNTY, PENNSTEVANIA.

(NOT FOR CONSTRUCTION)

DESIGNED	RRH	
DRAWN	RRH	
CHECKED	KCF	
IN CHARGE	GEC	
DATE	05/01/24	
SCALE	40.01101441	-
	AS SHOWN	

PORT AUTHORITY OF ALLEGHENY COUNTY
PITTSBURGH

BUS RAPID TRANSIT UPTOWN TO OAKLAND
ROADWAY PROFILE
BOYD ST, MCNULTY ST, CHATHAM SQ

BOYD ST, MCNULTY ST, CHATHAM SQ

Part Authority CONTRACT NO. BRT-001

Port Authority

DWG.NO. PP81 SHT. 437

.ds16\_na\michael.mcgarry@aecom.com\d020

OPERATOR: "michael.mogarry"
FILE PATH: C:\Dww.orking\decom As16 no

5th Floor

Pittsburgh, PA 15219

NO. DATE

DESCRIPTION

REVISIONS

05/01/24

AS SHOWN

**Port Authority** 


CONTRACT NO. BRT-001

sнт. **438** 

PP82

DWG. NO.

SCALE

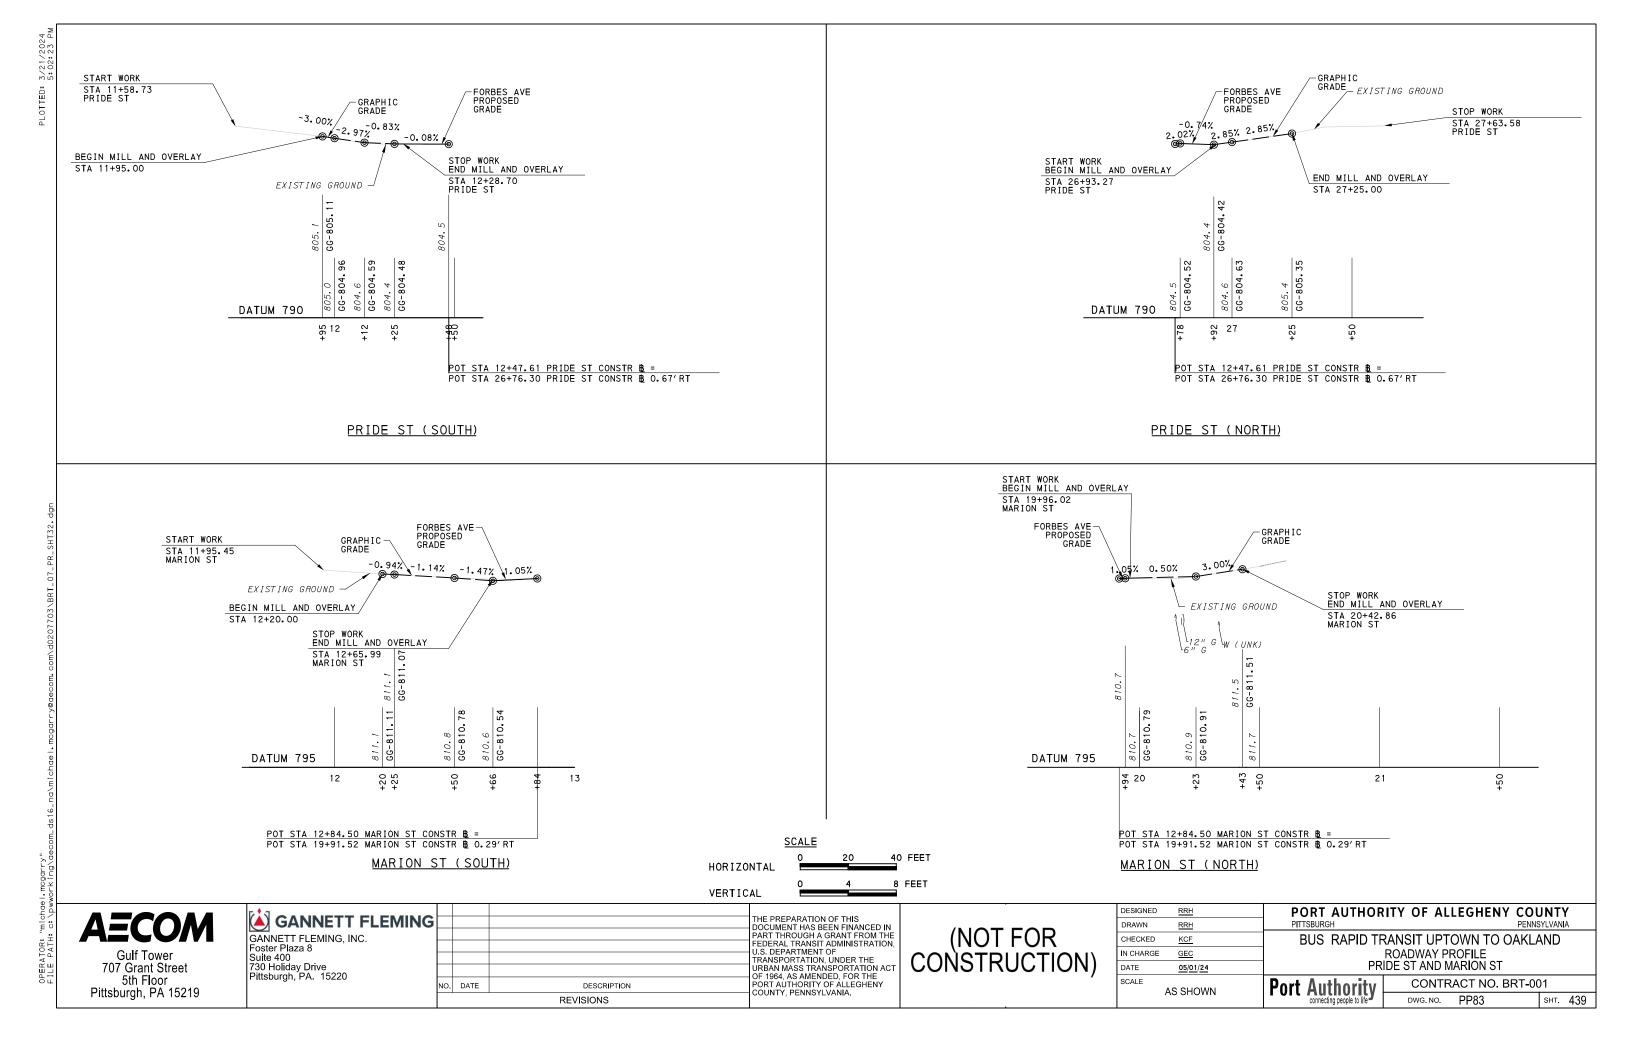

**AECOM** 

Gulf Tower 707 Grant Street 5th Floor Pittsburgh, PA 15219 GANNETT FLEMING

GANNETT FLEMING, INC.

MILTENBERGER ST

GANNETT FLEMING, INC. Foster Plaza 8 Suite 400 730 Holiday Drive Pittsburgh, PA. 15220

		THE PREPARATION OF THIS DOCUMENT HAS BEEN FINANCED IN
		PART THROUGH A GRANT FROM THE
		FEDERAL TRANSIT ADMINISTRATION, U.S. DEPARTMENT OF
		TRANSPORTATION, UNDER THE
		URBAN MASS TRANSPORTATION ACT OF 1964. AS AMENDED. FOR THE
DATE	DESCRIPTION	PORT AUTHORITY OF ALLEGHENY COUNTY, PENNSYLVANIA.
	REVISIONS	COUNTY, FEMINSTEVANIA.

HORIZONTAL

VERTICAL

(NOT FOR CONSTRUCTION)

40 FEET

8 FEET

ESIGNED	RRH	
RAWN	RRH	
HECKED	KCF	
CHARGE	<u>GEC</u>	
ATE	05/01/24	
CALE	AS SHOWN	Po


PORT AUTHORITY OF ALLEGHENY COUNTY
PITTSBURGH


BUS RAPID TRANSIT UPTOWN TO OAKLAND
ROADWAY PROFILE
VAN BRAAM ST AND MILTENBERGER ST


Port Authority \_\_\_\_


CONTRACT NO. BRT-001

DWG. NO. PP84 SHT. 440

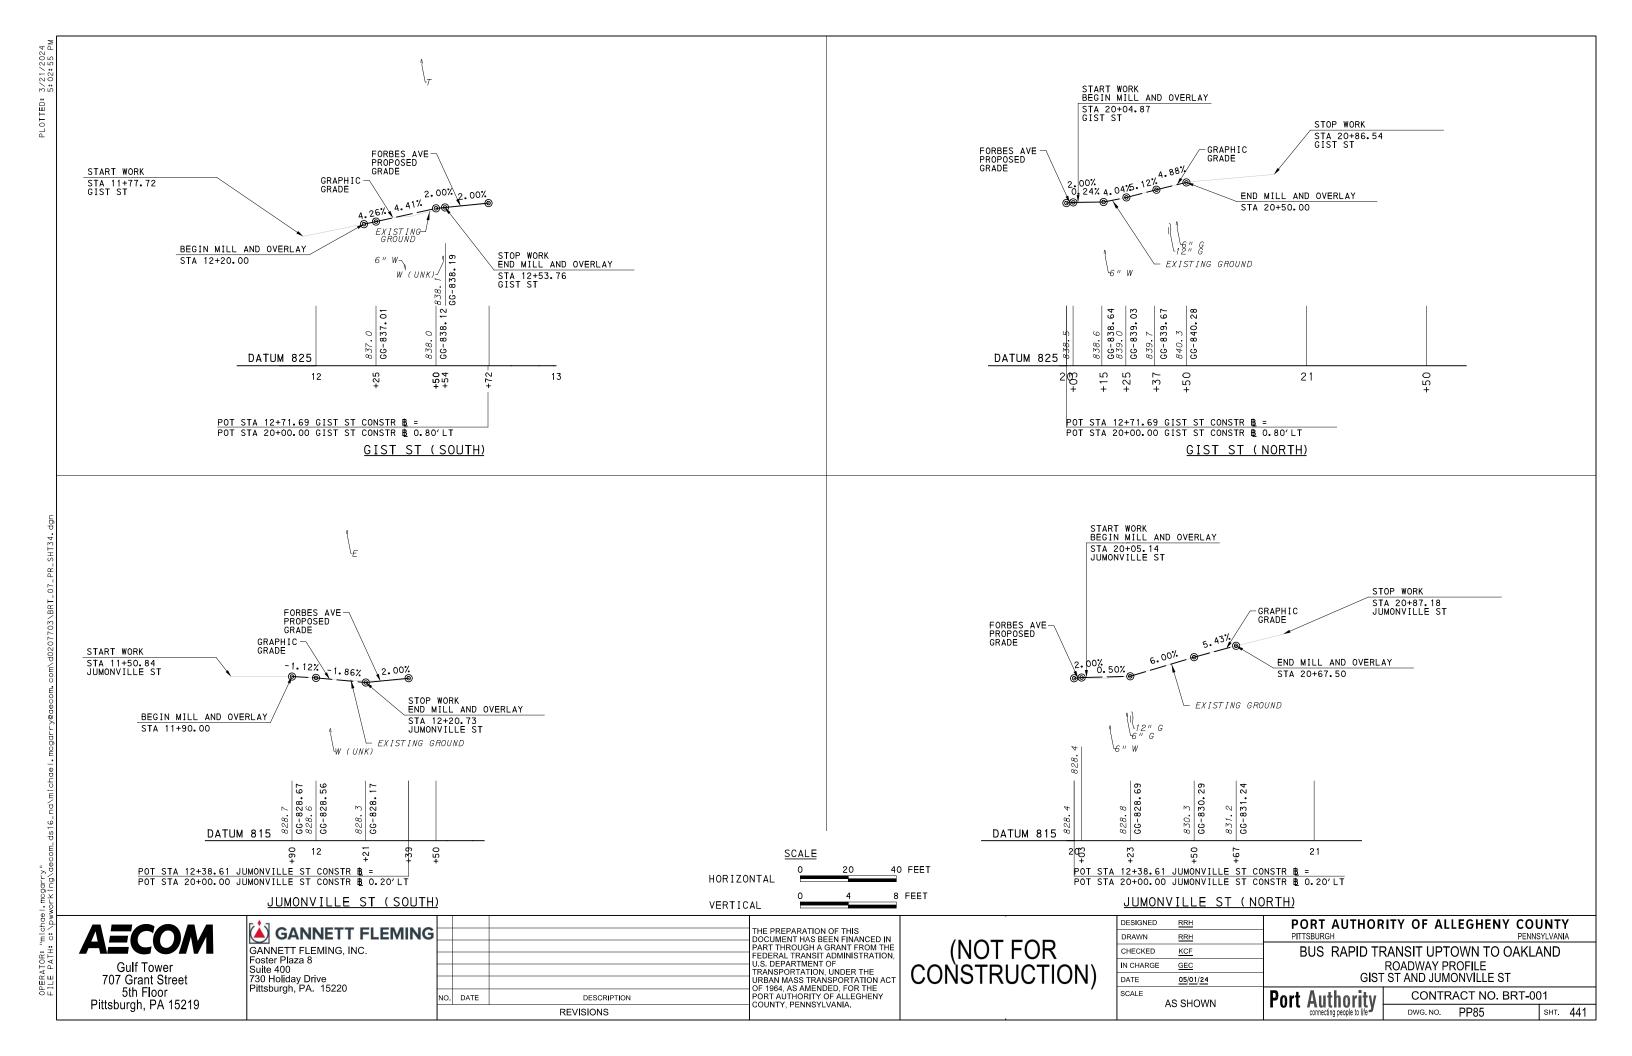

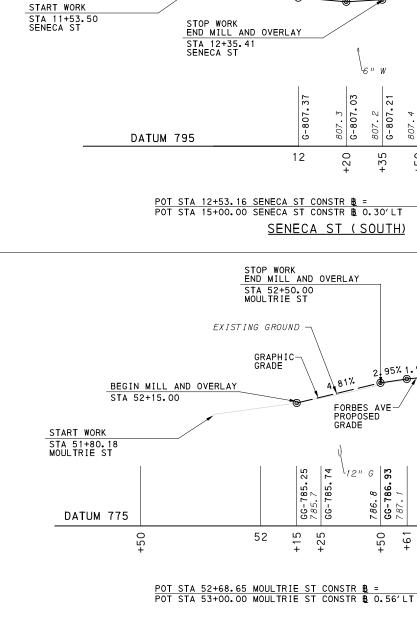

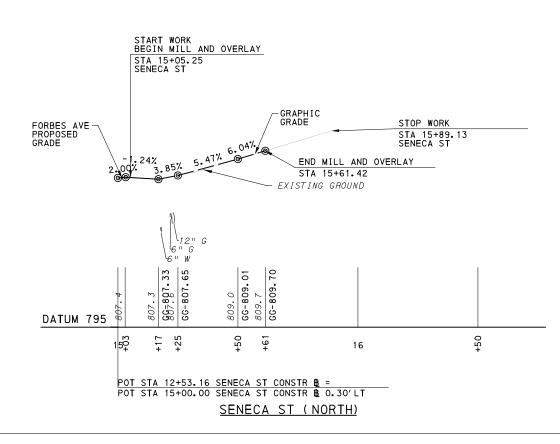

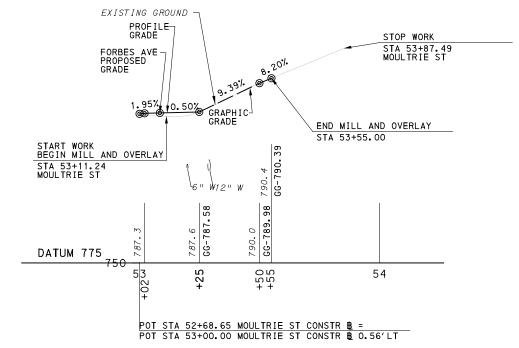

HORIZONTAL MOULTRIE ST (SOUTH) VERTICAL

> (NOT FOR CONSTRUCTION

40 FEET

8 FEET

DESIGNED RRH DRAWN RRH CHECKED KCF N CHARGE GEC DATE 05/01/24 SCALE AS SHOWN

MOULTRIE ST (NORTH)

PORT AUTHORITY OF ALLEGHENY COUNTY BUS RAPID TRANSIT UPTOWN TO OAKLAND

ROADWAY PROFILE SENECA ST AND MOULTRIE ST

**Port Authority** 

CONTRACT NO. BRT-001 DWG. NO. PP86 sнт. 442

AECOM

**Gulf Tower** 707 Grant Street 5th Floor Pittsburgh, PA 15219

GANNETT FLEMING
GANNETT FLEMING, INC. Foster Plaza 8 Suite 400 730 Holiday Drive Pittsburgh, PA. 15220

FORBES AVE-

-1.71% 1.17% 1.17%

807.3 G-807.03

20

+35

2,95% 1.95%

+61

FORBES AVE — PROPOSED GRADE

786.8 93 GG-786.93

+50

GG-785.74

+25


553


EXISTING GROUND

BEGIN MILL AND OVERLAY
STA 12+00.00

THE PREPARATION OF THIS
DOCUMENT HAS BEEN FINANCED IN
PART THROUGH A GRANT FROM THE
FEDERAL TRANSIT ADMINISTRATION, U.S. DEPARTMENT OF TRANSPORTATION, UNDER THE URBAN MASS TRANSPORTATION ACT OF 1964, AS AMENDED, FOR THE PORT AUTHORITY OF ALLEGHENY COUNTY, PENNSYLVANIA. NO. DATE DESCRIPTION REVISIONS

SCALE

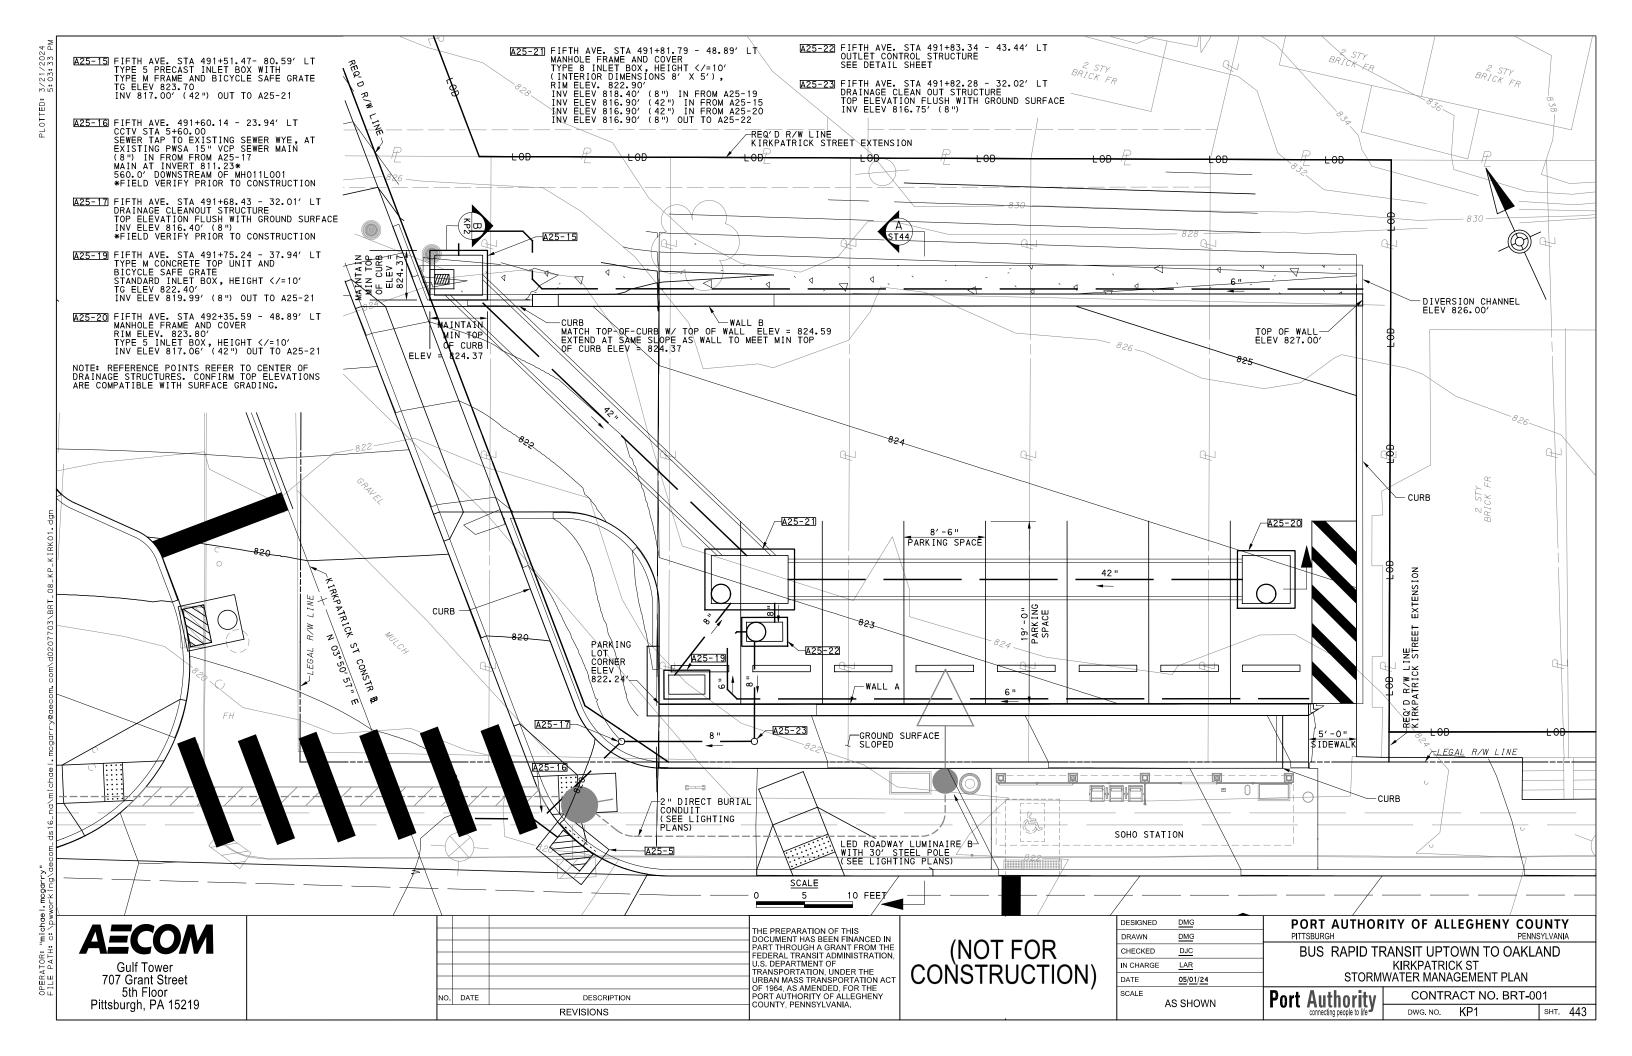

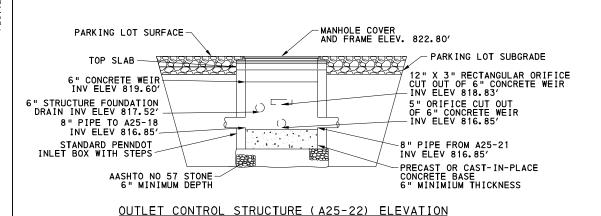

CLEANOUT AS PER ACHD PLUMBING CODE (AS DIRECTED) -FINISHED GRADE \_LEGAL STREET RIGHT OF WAY LINE −GROUND SURFACE/ ASPHALT 6"+/---INSPECTION REDUCER ( IF REQUIRED)-PROPOSED STORM-DRAIN -PWSA APPROVED CONNECTION WYF-SEWER MAIN STANDARD 90-DEGREE BEND (OR EQUAL) -PRIVATE SEWER LATERAL

1/4"/FT. SLOPE RECOMMENDED
1/8"/FT. MINIMUM SLOPE

NOIE:
CONTRACTOR MUST CONTACT PWSA AND/OR ACHD
FOR ALL REQUIRED TAP-IN PERMITS AND
TRUNK LINE SEWER CONNECTION INSPECTION
PRIOR TO BACKFILLING. ALL PIPE TO BE
BEDDED AND SURROUNDED BY FIRMLY
COMPACTED CLEAN SELECTED BACKFILL. REFER
TO CURRENT ACHD PLUMBING CODE ARTICLE XV
FOR ADDITIONAL SPECIFICATIONS.

A25-15

#### PRIVATE SEWER LATERAL RECONNECTION (SS-1) NOT TO SCALE

CIRCULAR OPENING FOR MANHOLE COVER 6" STRUCTURE FOUNDATION DRAIN INV ELEV 817.52' FLOW 6" CONCRETE WEIR TOP OF WEIR ELEV 819.60' 5" ORIFICE INV ELEV 816.85' 12" X 3" ORIFICE INV ELEV 818.83' 8" OUTFALL PIPE TYPE PER DESIGN PLANS INV ELEV 816.85'

8" PIPE FROM A25-21 INV ELEV 816.85'

OUTLET CONTROL STRUCTURE (A25-22) PLAN VIEW

NOT TO SCALE

PROVIDE PENNDOT AA CONCRETE W/

1 MAT OF 6" X 6" - W2.9 X W2.9 WWF, 2"

MIN COVER AROUND GRATE ON BOX,

APPLY CONCRETE BONDING

ADHESIVE TOP SLAB, SLOPE SURFACE

MIN 1V:6H TOWARD GRATE— NOT TO SCALE

-WALL B REBAR NOT SHOWN SEE STRUCTURE PLANS (DRAWING ST44)

825 EXISTING GRADE-820 815 810 -0+25.00

PROPOSED GRADE 6" REVEAL 42" RCP 42" RCP TWO 8" PIPES 0+50.00 0+00.00 0+25.00

> SECTION B A25-15 TO A25-20 NOT TO SCALE

A25-21

TYPICAL DIVERSION CHANNEL & WALL B

NOT TO SCALE

NOTE: ITEMS ON THIS SHEET ARE TO BE PAID AS PART OF ITEM 02640.001: STORMWATER MANAGEMENT SYSTEM FOR KIRKPATRICK PARKING LOT

707 Grant Street

5th Floor

Pittsburgh, PA 15219

CLASS I,

AASHTO #57 STONE

CHANNEL ELEVATIONS GIVEN AT THIS LOCATION

			THE PREPARATION OF THIS DOCUMENT HAS BEEN FINANCED IN PART THROUGH A GRANT FROM THE
			FEDERAL TRANSIT ADMINISTRATION, U.S. DEPARTMENT OF
			TRANSPORTATION, UNDER THE URBAN MASS TRANSPORTATION ACT OF 1964. AS AMENDED. FOR THE
NO.	DATE	DESCRIPTION	PORT AUTHORITY OF ALLEGHENY COUNTY, PENNSYLVANIA.
		REVISIONS	COUNTY, FENINSTEVANIA.

(NOT FOR CONSTRUCTION)

DESIGNED	<u>DMG</u>	
DRAWN	<u>DMG</u>	
CHECKED	DJC	
IN CHARGE	LAR	
DATE	05/01/24	
SCALE		
	AS SHOWN	

0+75.00

#### PORT AUTHORITY OF ALLEGHENY COUNTY PITTSBURGH BUS RAPID TRANSIT UPTOWN TO OAKLAND

1+00.00

KIRKPATRICK ST SPECIAL DETAILS

**Port Authority** 

QUANTITIES:

AASHTO #57

GEOTEXTILE

8" PVC PIPE

CONCRETE DIVERSION CHANNEL

6" PERFORATED PVC PIPE

ITEM 02640.001 - APPROXIMATE QUANTITIES FOR INFORMATION ONLY:

TYPE 5 INLET BOX WITH MANHOLE FRAME & COVER

TYPE 8 INLET BOX WITH MANHOLE FRAME & COVER

STANDARD PENNDOT INLET BOX WITH TYPE M CONCRETE TOP UNIT AND BICYCLE SAFE GRATE

DRAINAGE CLEAN OUT STRUCTURES

A25-20

42" RCP, 2'-7' FILL

TYPE 5 PRECAST INLET BOX WITH TYPE M FRAME AND BICYCLE SAFE GRATE

STANDARD PENNDOT INLET BOX WITH MANHOLE FRAME & COVER AND 6" CONCRETE WEIR

33 SY

173 LF

38 CY

47 SY

45 LF

EΑ

EΑ

EΑ

EΑ

EΑ

2 EA

90 LF

825

820

815

810

1+25.00

CONTRACT NO. BRT-001 KP2 sнт. **444** DWG NO

- 1. A COPY OF THESE E&SC PLAN DRAWINGS MUST BE KEPT ON-SITE AND AVAILABLE FOR REVIEW BY INSPECTORS DURING CONSTRUCTION. REVISIONS SHOULD BE REVIEWED AND APPROVED IN ADVANCE OF CONSTRUCTION AT THE ENGINEER'S DISCRETION.
- 2. NOTIFY THE PENNSYLVANIA ONE CALL SYSTEM (1-800-242-1776) AT LEAST 3 BUSINESS DAYS PRIOR TO STARTING ANY EARTH DISTURBANCE ACTIVITIES OR EXPANDING INTO AN AREA PREVIOUSLY UNMARKED. LOCATE POTENTIAL CONFLICTS AND AVOID DAMAGE OR DISRUPTION OF UTILITIES.
- PROCEED WITH ALL EARTH DISTURBANCE ACTIVITIES IN ACCORDANCE WITH THE SEQUENCE PROVIDED ON THE PLAN DRAWINGS FOR EACH WORK AREA. DEVIATION FROM THAT SEQUENCE REQUIRES WRITTEN APPROVAL FROM THE ENGINEER PRIOR
- SEDIMENT TRACKED ONTO ANY PUBLIC ROADWAY OR SIDEWALK SHALL BE RETURNED TO THE CONSTRUCTION SITE BY THE END OF EACH WORK DAY AND DISPOSED IN THE MANNER DESCRIBED IN THIS PLAN. IN NO CASE SHALL SEDIMENT BE WASHED, SHOVELED, OR SWEPT INTO ANY ROADSIDE DITCH, STORM SEWER, OR SURFACE WATER.
- LIMIT CLEARING, GRUBBING, AND TOPSOIL STRIPPING TO AREAS DESCRIBED IN EACH STAGE OF THE CONSTRUCTION SEQUENCE AND WITHIN THE LIMITS-OF-DISTURBANCE (LOD) SHOWN ON THE DRAWINGS. DO NOT COMMENCE EARTH DISTURBANCE UNTIL THE E&S BMPS SPECIFIED BY THE CONSTRUCTION SEQUENCE FOR THAT STAGE OR PHASE HAVE BEEN DEPLOYED.
- CLEARLY MARK LIMITS-OF-DISTURBANCE (LOD) WITH FENCE AND SIGNAGE OR OTHER BARRIER SUITABLE TO PREVENT INADVERTENT ENTRY BY THE PUBLIC
- STOCKPILING OF EXCAVATED MATERIAL OR AGGREGATE SHALL COMPLY WITH TYPICAL DETAILS PROVIDED IN THIS PLAN.
- UPON DISCOVERING UNFORESEEN CIRCUMSTANCES POSING POTENTIAL FOR ACCELERATED EROSION AND/OR SEDIMENT POLLUTION, THE OPERATOR SHALL IMMEDIATELY IMPLEMENT APPROPRIATE BEST MANAGEMENT PRACTICES TO MINIMIZE THE POTENTIAL FOR DAMAGE OR POLLUTION AND NOTIFY THE ENGINEER.
- REMOVE ALL BUILDING MATERIALS AND WASTES FROM THE SITE AND RECYCLE OR DISPOSE IN ACCORDANCE WITH PA DEP'S SOLID WASTE MANAGEMENT REGULATIONS AT 25 PA. CODE 260.1 ET SEQ., 271.1, AND 287.1 ET. SEQ. DO NOT BURN, BURY, DUMP, OR DISCHARGE ANY BUILDING MATERIALS, WASTES, OR UNUSED BUILDING MÁTERIALS AT THE SITE.
- 10. FOR TRANSPORTATION OF EXCAVATED MATERIAL, MATERIALS WITH SUFFICIENT WATER CONTENT OR CONTAMINATION THAT COULD LEAK SHALL BE CARRIED
- 11. ALL OFFSITE BORROW AREAS, WASTE DISPOSAL AREAS, AND/OR STORAGE AREAS SHALL HAVE AN APPROVED EROSION AND SEDIMENTATION CONTROL PLAN PRIOR TO THE START OF ANY EARTHMOVING ACTIVITIES IN THESE OFFSITE AREAS. THE CONTRACTOR, IN ITS PROPOSAL, SHALL MAKE PROVISIONS FOR THESE OFFSITE AREAS AND SHALL BE RESPONSIBLE FOR ENSURING THAT EACH OFFSITE AREA HAS AN APPROVED EROSION AND SEDIMENTATION CONTROL PLAN BY THE COUNTY CONSERVATION DISTRICT IN WHICH THE OFFSITE AREA IS LOCATED. THE CONTRACTOR SHALL FURNISH A COPY OF THE APPROVED PLAN TO THE ENGINEER PRIOR TO BEGINNING OFFSITE OPERATIONS. ANY EXPANSION OF THE LIMITS-OF-DISTURBANCE PROPOSED BY THE CONTRACTOR MUST BE APPROVED BY THE ENGINEER AND, IF NECESSARY, THE COUNTY CONSERVATION DISTRICT.
- 12. PLEASE AVOID THE INTRODUCTION OF INVASIVE SPECIES IN ORDER TO PROTECT THE INTEGRITY OF NEARBY PLANT SPECIES OF SPECIAL CONCERN. VOLUNTARY CLEANING OF EQUIPMENT/VEHICLES, USING CLEAN FILL AND MULCH, AND AVOIDING PLANTING INVASIVE SPECIES (http://www.donr.pa.gov/Conservation/WildPlants/InvasivePlants/ Pages/default.aspx) WILL HELP TO CONSERVE SENSITIVE PLANT HABITATS.
- 13. STABILIZE AS SOON AS A DISTURBED AREA IS BROUGHT TO GRADE OR FINAL EARTHMOVING HAS BEEN COMPLETED. WHERE IT IS NOT POSSIBLE TO PERMANENTLY STABILIZE A DISTURBED AREA IMMEDIATELY AFTER THE FINAL EARTHMOVING HAS BEEN COMPLETED OR WHERE THE ACTIVITY CEASES FOR MORE THAN 4 DAYS, IMPLEMENT TEMPORARY STABILIZATION MEASURES PROMPTLY.
- ENSURE CUT & FILL SLOPES CAN RESIST SLUMPING, SLIDING, OR OTHER FAILURES. ALL FILLS SHALL BE COMPACTED AS REQUIRED TO REDUCE EROSION, SLIPPAGE, SETTLEMENT, SUBSIDENCE, OR OTHER RELATED PROBLEMS. FILL INTENDED TO SUPPORT STRUCTURES, CONDUIT, OR OTHER INFRASTRUCTURE SHALL CONSIST OF SUITABLE MATERIAL COMPACTED IN ACCORDANCE WITH LOCAL REQUIREMENTS OR CODES.
- 15. ENSURE MATERIAL BROUGHT ON-SITE IS CLEAN FILL. PENNDOT FORM FP-001 MUST BE PREPARED FOR ANY FILL MATERIAL AFFECTED BY A SPILL OR RELEASE OF A REGULATED SUBSTANCE BUT QUALIFYING AS CLEAN FILL DUE TO ANALYTICAL TESTING.
- 16. IN AREAS TO BE PAVED, PLACE SUBBASE AS EARLY AS PRACTICAL TO STABILIZE THE SURFACE AGAINST EROSION.

#### EROSION AND SEDIMENTATION CONTROL GENERAL NOTES

- DO NOT ALLOW SURFACE RUNOFF AND STORM SEWER DRAINAGE TO ENTER EXCAVATED AREAS. MAINTAIN STORM SEWER FLOWS IN ACCORDANCE WITH TECHNICAL PROVISION 01510 - SEWER BYPASS PUMPING.
- WHEN PUMPING GROUNDWATER, COMPLY WITH SECTION 01825 WATER QUALITY MONITORING.
- GROUNDWATER OR STORM RUNOFF PUMPED FROM SUMPS SHALL PASS THROUGH A SEDIMENTATION TANK OR PUMPED WATER FILTER BAG PRIOR TO DISCHARGE. MONITOR DISCHARGE IN ACCORDANCE WITH TECHNICAL PROVISION 01825, WATER QUALITY MONITORING, IF CONTAMINATED, THE WATER SHALL BE RUN THROUGH A SEDIMENTATION TANK THEN DISCHARGED TO COMBINATION SEWER FOR TREATMENT BY ALCOSAN IF PERMITTED BY THE "PRETREATMENT REQULATIONS OF THE ALLEGHENY COUNTY SANITARY AUTHORITY (ALCOSAN)". ANY WATER THAT DOES NOT MEET THESE STANDARDS SHALL BE LOADED ONTO SEALED TANKER TRUCKS AND HAULED TO A PADEP APPROVED TREATMENT PLANT FOR DISPOSAL.
- ANY EROSION AND SEDIMENTATION CONTROL BMP'S REQUIRED OR NECESSARY TO PROTECT AREAS FROM EROSION DURING THE STABILIZATION PERIOD SHALL BE MAINTAINED UNTIL PERMANENT STABILIZATION OF THE CONTRIBUTING DRAINAGE AREA IS COMPLETED. UPON COMPLETION OF PERMANENT STABILIZATION, ALL UNNECESSARY OR UNUSABLE CONTROL MEASURES AND FACILITIES SHALL BE REMOVED.
- 21. MANAGE CONCRETE TRUCK WASH WATER AS INDICATED IN THE "CONCRETE WASHOUT"
- KEEP CHANNELS, GUTTERS, PIPES, AND OTHER FLOW CONVEYANCES FREE OF UNWANTED OBSTRUCTIONS.
- PLAN WORK TO MINIMIZE THE DURATION OF OPEN EXCAVATIONS WHICH INTERFERE WITH THE DESIRABLE DRAINAGE PATTERN.
- IMMEDIATELY REPAIR IN A PERMANENT MANNER ANY DAMAGE THAT OCCURS IN WHOLE OR PART BECAUSE OF TEMPORARY DRAINAGE MEASURES OR OVERSIGHTS ASSOCIATED WITH THIS PROJECT SATISFACTORY TO THE PROPERTY OWNER AND ENGINEER.
- TAKE ALL MEASURES NECESSARY TO PREVENT FLOODING OR INFILTRATION WHICH COULD ADVERSELY IMPACT THE PUBLIC, BUILDINGS, UTILITIES, OR OTHER INFRASTRUCTURE. SEEK ENGINEERS APPROVAL FOR MEASURES
- STAGE CLEARING, GRUBBING, AND EXCAVATION SO AS TO MINIMIZE THE TOTAL EXPOSURE OF ERODIBLE STOCKPILES & GROUND AT ALL TIMES TO THE EXTENT PRACTICAL. PROTECT AND PRESERVE EXISTING TREES TO THE EXTENT POSSIBLE.
- THE INTENT OF THIS PLAN IS TO INDICATE GENERAL MEANS OF COMPLIANCE WITH THE REQUIREMENTS OF THE RULES AND REGULATIONS OF CHAPTER 102, THE DEPARTMENT OF ENVIRONMENTAL PROTECTION (AS AUTHORIZED UNDER THE CLEAN STREAMS LAW). IT SHALL BE THE RESPONSIBILITY OF THE CONTRACTOR TO IMPLEMENT THESE METHODS, PLUS ADDITIONAL METHODS, AS MAY BE NECESSARY BECAUSE OF CONDITIONS CREATED BY LOCALIZED SITE CONDITIONS AND/OR CONSTRUCTION PROCEDURES IN ORDER TO ASSURE COMPLIANCE WITH APPLICABLE LAW. IT SHALL FURTHER BE THE RESPONSIBILITY OF THE CONTRACTOR TO MAINTAIN ALL EROSION AND SEDIMENTATION CONTROL FACILITIES SO THAT THEY PERFORM AS REQUIRED.
- 28. FAILURE TO CORRECTLY INSTALL BMPS, FAILURE TO PREVENT SEDIMENT-LADEN RUNOFF FROM LEAVING THE CONSTRUCTION SITE, OR FAILURE TO TAKE IMMEDIATE CORRECTIVE ACTION TO RESOLVE FAILURE OF BMPS MAY RESULT IN ADMINISTRATIVE, CIVIL, AND/OR CRIMINAL PENALTIES BEING INSTITUTED BY THE PENNSYLVANIA DEPARTMENT OF ENVIRONMENTAL PROTECTION AS DEFINED IN SECTION 602 OF THE PENNSYLVANIA CLEAN STREAMS LAW. THE CLEAN STREAMS LAW PROVIDES FOR UP TO \$10,000 PER DAY IN CIVIL PENALTIES, UP TO \$10,000 IN SUMMARY CRIMINAL PENALTIES, AND UP TO \$25,000 IN MISDEMEANOR CRIMINAL PENALTIES FOR EACH VIOLATION.
- 29. OVER-THE-ROAD VEHICLES SUPPORTING CONSTRUCTION ARE EXPECTED TO OPERATE ONLY ON PAVEMENT OR SURFACES STABILIZED WITH NON-COHESIVE CLEAN AGGREGATE. CONSTRUCTION EQUIPMENT TRACKS AND WHEELS ARE TO BE THOROUGHLY CLEANED BEFORE EXITING THE LOD. WHERE THESE PRACTICES ARE NOT POSSIBLE, INSTALL A ROCK CONSTRUCTION ENTRANCE.

#### GREEN INFRASTRUCTURE EROSION AND SEDIMENT CONTROL GENERAL NOTES:

- 1. PROTECT ALL CATCH BASINS, BIORETENTION AREAS, STORMWATER STORAGE TRENCHES, BIOSWALES, AND OTHER STORMWATER IMPROVEMENTS DURING EXCAVATION AND CONSTRUCTION. IF ANY CATCH BASINS, DRAINS, OR BMPS BECOME CLOGGED AS A RESULT OF DEMOLITION, EXCAVATION OR CONSTRUCTION, THE CONTRACTOR SHALL BE RESPONSIBLE FOR THEIR CLEANING INCLUDING DOWNSTREAM STORM DRAINS. MEASURES SHALL BE IMPLEMENTED TO PREVENT THE DISCHARGE OF WASTE MATERIALS, INCLUDING BUILDING MATERIALS, TO STORM DRAINS, STORM SEWERS OR THE RECEIVING WATERS.
- 2. EXTREME CARE MUST BE TAKEN TO PREVENT RUNOFF FROM UNSTABILIZED AREAS FROM ENTERING THE STORMWATER IMPROVEMENTS DURING CONSTRUCTION. CONTRACTOR SHALL USE COMPOST SOCK, GEOTEXTILE SAND BAGS, TEMPORARY FENCING, STABILIZATION OF THE DRAINAGE AREA, ETC. TO PREVENT SEDIMENTATION AND OTHER DAMAGE.
- UNLESS OTHERWISE NOTED, KEEP THE STORMWATER IMPROVEMENTS OFF-LINE UNTIL CONSTRUCTION IS COMPLETE. PREVENT SEDIMENT FROM ENTERING THE STORMWATER IMPROVEMENTS BY USING SUPER SILT FENCE, COIR LOGS, DIVERSION BERMS, SAND
- IF CURB CUTS OR INLETS ARE BLOCKED DURING CONSTRUCTION OF THE STORMWATER IMPROVEMENTS, UNBLOCK THESE AFTER THE DRAINAGE AREA AND BIORETENTION/BIOSWALES HAVE GOOD VEGETATIVE COVER. IT IS RECOMMENDED THAT UNBLOCKING CURB CUTS AND INLETS TAKE PLACE AFTER AT LEAST TWO TO THREE STORM EVENTS IF THE DRAINAGE AREA INCLUDES NEWLY INSTALLED ASPHALT, SINCE NEW ASPHALT TENDS TO PRODUCE FINES AND GRIT DURING THE FIRST SEVERAL STORMS. STORMWATER IMPROVEMENTS MUST BE APPROVED BY PWSA BEFORE OPENING SYSTEM TO RECEIVE STORMWATER.

PLAN PREPARER: DAVID J COOPER, AECOM, 412-463-0805 ALLEGHENY COUNTY CONSERVATION DISTRICT CONTACT: MS. MAUREEN COPELAND, 412-241-7645

Gulf Tower 707 Grant Street 5th Floor Pittsburgh, PA 15219

THE PREPARATION OF THIS DOCUMENT HAS BEEN FINANCED IN PART THROUGH A GRANT FROM THE FEDERAL TRANSIT ADMINISTRATION U.S. DEPARTMENT OF TRANSPORTATION, UNDER THE URBAN MASS TRANSPORTATION ACT OF 1964 AS AMENDED FOR THE NO. DATE DESCRIPTION COUNTY, PENNSYLVANIA. REVISIONS

(NOT FOR CONSTRUCTION)

DESIGNED	JIVIS	
DRAWN	<u>JMS</u>	
CHECKED	DJC	
IN CHARGE	LAR	
DATE	05/01/24	
SCALE	AS SHOWN	

PORT AUTHORITY OF ALLEGHENY COUNTY PENNSYLVANIA BUS RAPID TRANSIT UPTOWN TO OAKLAND

Port Authority

**EROSION & SEDIMENTATION CONTROL PLANS** GENERAL NOTES

CONTRACT NO. BRT-001 DWG. NO. ES1 sнт. **445** 

#### **MAINTENANCE**

#### 1. GENERAL

- THE CONTRACTOR SHALL BE RESPONSIBLE FOR THE CONTINUOUS MAINTENANCE OF ALL EROSION AND SEDIMENTATION CONTROL MEASURES AND DEVICES FOR THE DURATION OF THE PROJECT AND UNTIL THE AREA IS STABILIZED WITH PAVEMENT OR A MINIMUM UNIFORM 70% PERENNIAL VEGETATIVE COVER. THE CONTRACTOR SHALL INSPECT ALL DEVICES WEEKLY (MINIMUM) AND AFTER EACH RUNOFF EVENT AND PERFORM MAINTENANCE AS REQUIRED AND CORRECT DEFICIENCIES. CLEAN ANY BMP FOUND TO BE CLOGGED, DAMAGED, OR HALF-FULL. THE SOLID WASTE DISPOSAL IS THE RESPONSIBILITY OF THE CONTRACTOR.
- B. MAINTAIN ON SITE A WRITTEN RECORD OF INSPECTION DATES, INSPECTORS NAMES, DEFICIENCIES FOUND, AND THE DATE CORRECTIONS ARE COMPLETED.
- DISPOSE OF SEDIMENT REMOVED FROM BMPS BY INCORPORATING INTO TOPSOIL FOR LANDSCAPE AREAS IN A MANNER CONSISTENT WITH LANDSCAPE SPECIFICATIONS AND APPROVAL OF ENGINEER. OTHERWISE, REMOVE FROM SITE.

#### VEGETATION

- MAINTAIN GRASS AREAS WITHIN THE GRADING LIMITS OF THE PROJECT UNTIL THE ENTIRE PROJECT HAS BEEN COMPLETE. IF A SLOPE FAILURE OCCURS (AFTER THE SEEDING AND SOIL SUPPLEMENT WORK ON A SLOPE HAS BEEN SATISFACTORILY COMPLETED), THAT REQUIRES REDRESSING, EXCAVATION, OR ESTABLISHMENT OF A NEW SLOPE, REAPPLY SOIL SUPPLEMENTS, AND RESEED, AS SPECIFIED FOR THE ORIGINAL TREATMENT.
- TEMPORARY STABILIZATION TEMPORARY STABILIZATION MEASURES SHALL BE UTILIZED FOR DISTURBED AREAS TO BE INACTIVE MORE THAN
- CONTROL NOXIOUS WEED GROWTH IN THE WORK AREA BY HERBICIDE SPRAYING, CUTTING, OR REMOVAL. THESE PLANTS ARE DEFINED BY THE PENNSYLVANIA WEED CONTROL ACT OF 1982, P.L. 228, NO. 74 AND AS AMENDED BY FURTHER LEGISLATION. SUBMIT, FOR APPROVAL, A SCHEDULE OF WORK AND LIST OF HERBICIDE TO BE USED BEFORE STARTING THIS EFFORT.

#### 3. SEDIMENT INLET PROTECTION

- A. REMOVE SEDIMENT ACCUMULATIONS FROM ALL INLET PROTECTION FACILITIES AND MAKE REPAIRS OR REPLACE THE FACILITY AS NEEDED.
- THE INLET FILTER BAG SHALL BE CLEANED OR REPLACED WHEN ACCUMULATIONS FILL 1/2 OF THE BAG. THE INLET FILTER BAG SHALL BE WASHED COMPLETELY FREE OF ALL FOREIGN MATERIAL OR A NEW INLET FILTER BAG SHALL BE INSTALLED WITHIN THE INLET. IF THE BAG IS WASHED, ENSURE THAT SEDIMENT LADEN RUNOFF FROM THE WASHED MATERIAL DOES NOT LEAVE THE SITE.

#### SUMPS

A. WATER PUMPED FROM SUMPS TO DEWATER EXCAVATED AREAS SHALL PASS THROUGH A PUMPED WATER FILTER BAG OR A SEDIMENT TANK PRIOR TO DISCHARGE. MINIMIZE TURBIDITY WHILE PUMPING FROM SUMP AREAS TO THE EXTENT PRACTICAL BY ADDING CLEAN GRAVEL, GEOTEXTILE, AND/OR

#### 5. PUMPED WATER FILTER BAGS

- THE FILTER BAG SHALL BE INSPECTED BEFORE AND AFTER EACH PUMPING OPERATION. THE FILTER BAG SHALL BE REPLACED IF ANY TYPE OF DAMAGE, CLOGGING, OR LEAKAGE HAS BEEN DISCOVERED.
- MONITOR AND EVALUATE THE ENTIRE PUMPING OPERATION TO ASSURE THAT THE BAG CONTINUES TO FUNCTION PROPERLY. REPLACE THE BAG WHEN THE CONTAINED SILT REDUCES THE BAG FLOW TO APPROXIMATELY 50% OF THE RATE BEFORE REMOVING A BAG FROM THE HOSE, THE BAG SHALL BE TIED OFF BELOW THE END OF THE HOSE, ALLOWING THE BAG TO DRAIN. DRAINAGE SHALL NOT BE ALLOWED THROUGH THE INLET HOLE.
- C. IF DISCERNABLE SEDIMENT DISCHARGES FROM BAG, REDUCE FLOW RATE OR USE SEDIMENT TANK.

#### 6. SEDIMENTATION TANKS

- SEDIMENTATION TANKS SHALL BE UTILIZED TO REMOVE SEDIMENT FROM PUMPED WATER PRIOR TO DISCHARGE.
- AT ALL TIMES SUFFICIENT MEANS SHALL BE PROVIDED FOR THE ENGINEER TO INSPECT THE ENTIRE SYSTEM TO DETERMINE THE ADEQUACY OF ITS FUNCTION. THE CONTRACTOR SHALL ALSO PROVIDE SUFFICIENT MEANS FOR SAMPLING THE OUTFLOW FROM THE SEDIMENTATION SYSTEM
- SEDIMENTATION TANKS SHALL BE MAINTAINED SUCH THAT SEDIMENT DOES NOT ACCUMULATE TO MORE THAN 25% OF THE EFFECTIVE DEPTH OF THE TANKS OR AS DIRECTED BY THE ENGINEER. ALL SEDIMENT IN THE TANK SHALL BE DISPOSED OF AT AN APPROVED DISPOSAL SITE. ENSURE THAT NO LEAKAGE OR OVERFLOWING CONDITIONS PERSIST. MAINTAIN FLOW RATE LOW ENOUGH THAT DISCHARGE REMAINS CLEAR.
- ALL COMPONENTS OF THE SEDIMENTATION TANK SHALL BE MAINTAINED IN WORKING ORDER THROUGHOUT CONSTRUCTION. BREAKS OR FAILURES IN THE SYSTEM SHALL BE REPAIRED IMMEDIATELY UPON DETECTION.
- E. IF PUMPING NEEDS TO INCREASE BEYOND THE CAPACITY OF THE SEDIMENTATION TANK, ADD SEDIMENTATION TANKS TO HANDLE ADDITIONAL FLOW.

#### 7. ROCK CONSTRUCTION ENTRANCE

- A. THICKNESS SHALL BE MAINTAINED TO THE SPECIFIED DIMENSION BY ADDING ROCK, A STOCKPILE OF ROCK MATERIAL SHALL BE MAINTAINED NEARBY FOR THIS PURPOSE.
- B. AT THE END OF EACH CONSTRUCTION DAY, SEDIMENT DEPOSITED ON PUBLIC ROADWAYS SHALL BE IMMEDIATELY REMOVED AND RETURNED TO THE CONSTRUCTION SITE.
- C. IF EXCESSIVE AMOUNTS OF SEDIMENT ARE BEING DEPOSITED ON ROADWAY, ROCK CONSTRUCTION ENTRANCE SHALL BE EXTENDED BY 50 FOOT INCREMENTS UNTIL CONDITION IS ALLEVIATED OR INSTALL WASH RACK.
- D. WASHING THE ROADWAY OR SWEEPING THE DEPOSITS INTO ROADWAY DITCHES, SEWERS, CULVERTS, OR OTHER DRAINAGE COURSES IS NOT ACCEPTABLE.

#### 8. COMPOST FILTER SOCK

- A. COMPOST FILTER SOCK 8" TO 32" DIAMETER USE ON DOWNSLOPE PERIMETER
  TO HELP POND RUNOFF AND CAPTURE SEDIMENT, USE UPSLOPE TO DIVERT FLOW AROUND
  WORK AREA, USE CAUTION TO ENSURE PONDING DOES NOT EXTEND INTO TRAFFIC OR IMPACT
- B. SEDIMENT MUST BE REMOVED WHEN ACCUMULATIONS REACH 1/2 HEIGHT OF THE SOCKS.
- C. IMMEDIATELY CLOSE ANY GAPS AND INITIATE ANY REPAIRS NEEDED TO MAINTAIN PROPER FUNCTIONING.
- D. REPAIR TORN OR DAMAGED FABRIC ACCORDING TO MANUFACTURER'S SPECIFICATIONS, REPLACE COMPOST FILTER SOCK, OR REPLACE WITH A ROCK FILTER OUTLET.
- E. STACK ADDITIONAL LAYERS OF COMPOST SOCK IF "BLOWOUTS" OR OVERTOPPING OCCURS AT

#### 9. TEMPORARY COMPOST DIVERSION SOCK (OR BERM)

- A. SHALL BE MAINTAINED TO EFFECTIVELY DIVERT "CLEAN" UPLAND WATER AROUND THE CONSTRUCTION. IMMEDIATELY CLOSE ANY GAPS AND REINFORCE
- B. VERIFY DIVERSION DOES NOT PRESENT RISK OF FLOODING PROBLEMS FOR PEDESTRIANS TRAFFIC, OR PROPERTY, ADJUST DESIGN IF NEEDED IN COORDINATION WITH ENGINEER.
- C. REMOVE SIGNIFICANT SEDIMENT ACCUMULATIONS WITHIN THE FLOW PATH. REMOVE SEDIMENT AND DEBRIS WHEN CAPACITY IS IMPAIRED MORE THAN 25%.
- D. STACK ADDITIONAL LAYERS OF COMPOST SOCK IF "BLOWOUTS" OR OVERTOPPING OCCURS AT

#### 10. COMPOST SOCK CONCRETE WASHOUT

- A. THE COMPOST SOCK WASHOUT SHALL BE INSPECTED BEFORE AND AFTER EACH USE.
- B. THE COMPOST SOCK WASHOUT SHALL BE REPAIRED OR REPLACED IMMEDIATELY IF ANY TYPE OF DAMAGE OR LEAKS ARE DISCOVERED.
- C. COMPOST SOCK WASHOUT SHALL BE MAINTAINED SUCH THAT MATERIAL DOES NOT ACCUMULATE TO MORE THAN 50% OF THE EFFECTIVE DEPTH OF THE WASHOUT.

PLAN PREPARER: DAVID J COOPER, AECOM, 412-463-0805 ALLEGHENY COUNTY CONSERVATION DISTRICT CONTACT: MS. MAUREEN COPELAND, 412-241-7645

Gulf Tower 707 Grant Street 5th Floor Pittsburgh, PA 15219

THE PREPARATION OF THIS DOCUMENT HAS BEEN FINANCED IN PART THROUGH A GRANT FROM THE FEDERAL TRANSIT ADMINISTRATION U.S. DEPARTMENT OF TRANSPORTATION, UNDER THE URBAN MASS TRANSPORTATION ACT OF 1964 AS AMENDED FOR THE NO. DATE DESCRIPTION COUNTY, PENNSYLVANIA. REVISIONS

(NOT FOR CONSTRUCTION)

DESIGNED	<u>JMS</u>	
DRAWN	<u>JMS</u>	
CHECKED	DJC	
IN CHARGE	LAR	
DATE	05/01/24	
SCALE		
	AS SHOWN	

## BUS RAPID TRANSIT UPTOWN TO OAKLAND

PORT AUTHORITY OF ALLEGHENY COUNTY

**EROSION & SEDIMENTATION CONTROL PLANS** GENERAL NOTES

**Port Authority** 

CONTRACT NO. BRT-001 DWG.NO. ES2 sнт. 446

#### CONSTRUCTION SEQUENCE

#### GENERAL PRE-CONSTRUCTION STEPS

PERFORM THE FOLLOWING INITIAL STEPS AS APPROPRIATE AT ALL WORK AREAS:

- 1. VERIFY ONE CALL COMPLIANCE AND COMPLETE UTILITY COORDINATION.
- 2. PLAN CONSTRUCTION TO MINIMIZE THE EXTENT AND DURATION OF EARTH DISTURBANCE AND INTERRUPTION OF DESIRABLE DRAINAGE PATTERNS. AVOID EXCESSIVE TOPSOIL COMPACTION IN AREAS INTENDED FOR PLANT GROWTH.
- 3. MARK LIMITS OF DISTURBANCE AND ERECT FENCE, BARRIERS, AND SIGNAGE.
- 4. COORDINATE WITH ADJACENT PROPERTY OWNERS/OCCUPANTS TO IDENTIFY POTENTIALLY FLOOD SENSITIVE BUILDINGS, VAULTS, OR OTHER CONCERNS. WHERE EXCAVATION CREATES RISK OF FLOOD DAMAGE, THE CONTRACTOR SHALL TAKE ALL STEPS NECESSARY TO MINIMIZE RISK INCLUDING DESIGN & DEPLOYMENT OF TEMPORARY DIVERSION/DRAINAGE FEATURES AND EXPEDITED REMOVAL AND REPLACEMENT OF PAVEMENT. SEE GUIDANCE IN "TYPICAL UPSLOPE DIVERSION" DETAIL.
- 5. DEPLOY COMPOST FILTER SOCK, INLET PROTECTION, AND UPSTREAM DIVERSIONS.
- 6. DEPLOY DIVERSION AT SAWCUTS PER "TEMPORARY DIVERSION AT SAWCUT" DETAIL.

#### GENERAL CONSTRUCTION STEPS

- 1. WITH APPROVAL OF THE ENGINEER, LOCATE PUMPED WATER FILTER BAGS AND CONCRETE WASHOUTS WITHIN THE LOD AS NEEDED AND IN ACCORDANCE WITH DETAILS.
- CONSTRUCT MANHOLES, INLETS, STORMWATER MANAGEMENT FEATURES, AND ASSOCIATED PIPE. MANAGE SPOIL
  PILES IN ACCORDANCE WITH "TYPICAL STOCKPILE" DETAIL. INSTALL INLET SEDIMENT PROTECTION WHERE
  INDICATED. COVER OPENINGS TO PREVENT FLOW INTO STORMWATER MANAGEMENT TANKS UNTIL TRIBUTARY
  AREAS ARE STABILIZED.
- 3. RECONSTRUCT SIDEWALK, CURB, AND PAYEMENT WITHIN ZONES WHERE DIVERSION IS IN PLACE. SALVAGE AND RESTORE SOD, TOPSOIL, MULCH, PLANTS, OR OTHER MATERIALS DISTURBED AROUND FRINGE OF WORK AREA AS DIRECTED.
- 4. SEED & MULCH LAWN AREAS OR SLOPES AS INDICATED AND STABILIZE UNPAVED AREAS IMMEDIATELY WITH MULCH AS INDICATED IN LANDSCAPE PLANS.
- 5. SEE MAINTENANCE NOTE 1C FOR DISPOSAL OF SEDIMENT REMOVED FROM BMPS.

#### GENERAL FINAL STEPS

- REMOVE SEDIMENT DEPOSITS ASSOCIATED WITH CONSTRUCTION FROM DOWNSTREAM GUTTERS
  OR CATCH BASINS.
- 2. PROMPTLY REMOVE COMPOST FILTER SOCK, INLET PROTECTION, AND UPSTREAM DIVERSIONS WHEN AREA IS STABILIZED AND DRAINAGE SYSTEMS ARE READY FOR SERVICE. STABILIZATION SHALL MEAN A UNIFORM 70% VEGETATIVE COVER OR, PAVEMENT, OR OTHER PERMANENT NON-ERODIBLE SURFACE.
- CLEAN EXISTING PAVEMENT TO REMOVE CAULK, ASPHALT EMULSION, STAINS FROM CONSTRUCTION AND RESTORE TO SATISFACTORY CONDITION.
- 4. IN COORDINATION WITH THE ENGINEER, LOOSEN SOILS IN LANDSCAPE AND INFILTRATION AREAS THAT MAY HAVE BEEN INADVERTENTLY COMPACTED.

SPECIAL CONSTRUCTION SEQUENCE FOR KIRKPATRICK STREET REALIGNMENT (TRAFFIC CONTROL UPTOWN PHASE 1 STAGE C)

- CONSTRUCT INLETS A25-1, A25-4, and A25-5 AND INSTALL INLET FILTER BAG PROTECTION, IN THOSE AND ALL OTHER ACTIVE INLETS FOR A DISTANCE AT LEAST 200' DOWN 5TH AVE.
- 2. DEPLOY COMPOST DIVERSION SOCK UPSTREAM OF WORK AREA TO DIVERT FLOW INTO VACANT GRASS AREAS/5TH AVE. VERIFY DOWNSTREAM FLOW PATH IS FREE OF FLOOD VULNERABLE FEATURES. USE MULTIPLE COURSES OF SOCK WHERE NEEDED TO MAINTAIN AT LEAST 8" CONTINUOUS FLOW DEPTH
- DEPLOY 24" COMPOST FILTER SOCK ON-CONTOUR ACROSS DOWNSTREAM LIMIT OF KIRKPATRICK STREET (JUST UPSTREAM OF 5TH AVE) AS SHOWN.
- 4. DEPLOY ROCK CONSTRUCTION ENTRANCE ONLY IF VEHICLES WILL BE EXITING FROM BARE COHESIVE SOILS TO STREET PER GENERAL NOTE 29.
- 5. REALIGN KIRKPATRICK STREET AND LAY DOWN SUBBASE AND PAVEMENT AS QUICKLY AS PRACTICAL. SALVAGE TOPSOIL (& PLANTS AS DIRECTED) FOR USE IN REVEGETATING AREAS OF PERMANENT PAVEMENT REMOVAL. IF SIGNIFICANT RAINFALL IS FORECAST BEFORE FIRST PAVEMENT COURSE IS PLACED, USE TARPS TO COVER EASILY ERODIBLE AREAS IF DIRECTED BY ENGINEER. TARPS MUST BE KEYED INTO GROUND AT UPPER EDGE TO PREVENT UNDERMINING AND OVERLAPPED TO CONVEY FLOW SAFELY TO 5TH AVE. ADD TEMPORARY DIVERSON SOCK AS APPROPRIATE.
- 6. IMMEDIATELY SEED AND APPLY EROSION CONTROL BLANKET TO GRADED AREAS OUTSIDE SIDEWALKS.
- 7. REMOVE FILTER SOCK AND DIVERSION ON STREET AFTER PAVING. DIVERSION SOCK ALONG EAST CUT LINE SHOULD REMAIN UNTIL UNIFORM 70% VEGETATIVE COVER GROWS.

SPECIAL CONSTRUCTION SEQUENCE FOR GREEN INFRASTRUCTURE BIOSWALE.

- 1. USE DIVERSION SOCK TO PREVENT FLOW FROM ENTERING CURB CUT UNTIL BIOSWALE IS VEGETATED AND READY TO RECEIVE FLOW. SEE BIOSWALE DIVERSION SOCK DETAIL (ES10). (CONFIRM DIVERSION WILL NOT CAUSE A DOWNSTREAM DRAINAGE PROBLEM).
- 2. INLETS RECEIVING FLOW WITHIN BIOSWALE SHALL BE PROTECTED USING INLET PROTECTION AS SHOWN ON PLANS.
- 3. DIVERSION SOCKS AND INLET PROTECTION SHALL REMAIN IN PLACE UNTIL CONSTRUCTION OF SWALE IS COMPLETE AND VEGETATION IS ESTABLISHED.

SPECIAL CONSTRUCTION SEQUENCE FOR KIRKPATRICK STREET PARKING LOT. (TO OCCUR AFTER KIRKPATRICK REALIGNMENT IS STABILIZED)

- 1. CONSTRUCT INLET A25-15 AND STABILIZE SURROUNDING AREA.
- 2. RECONFIGURE DIVERSION SOCK AND COMPOST FILTER SOCK AS SHOWN. USE CARE TO DIRECT UPSLOPE DIVERTED RUNOFF INTO INLET A25-15.
- 3. CONSTRUCT DETENTION SYSTEM AND ASSOCIATED TAP-IN TO SEWER.
- 4. CONSTRUCT UPSLOPE DIVERSION CHANNEL AND ADJACENT RETAINING WALL. IMMEDIATELY STABILIZE UPSLOPE DISTURBED AREA WITH EROSION CONTROL BLANKET, LANDSCAPE PLANTINGS, SEED (AS DIRECTED), AND MULCH. LEAVE DIVERSION SOCK IN PLACE UNTIL VEGETATION IS WELL ESTABLISHED.
- 5. COMPLETE PARKING LOT CONSTRUCTION.
- 6. REMOVE DIVERSION AND COMPOST FILTER SOCKS AFTER ASSOCIATED AREAS ARE



DESIGNED	<u>JMS</u>	
DRAWN	<u>JMS</u>	
CHECKED	DJC	
IN CHARGE	LAR	
DATE	05/01/24	
SCALE		
	AS SHOWN	

# PORT AUTHORITY OF ALLEGHENY COUNTY PITTSBURGH BUS RAPID TRANSIT UPTOWN TO OAKLAND EROSION & SEDIMENTATION CONTROL PLANS SEQUENCE OF CONSTRUCTION


Port Authority connecting people to life

CONTRACT NO. BRT-001
DWG. NO. ES3 SHT. 447

Gulf Tower
707 Grant Street
5th Floor

Pittsburgh, PA 15219

THE PREPARATION OF THIS
DOCUMENT HAS BEEN FINANCED IN
PART THROUGH A GRANT FROM THE
FEDERAL TRANSIT ADMINISTRATION,
U.S. DEPARTMENT OF
TRANSPORTATION, UNDER THE
URBAN MASS TRANSPORTATION ACT
OF 1964, AS AMENDED, FOR THE
PORT AUTHORITY OF ALLEGHENY
COUNTY, PENNSYLVANIA.

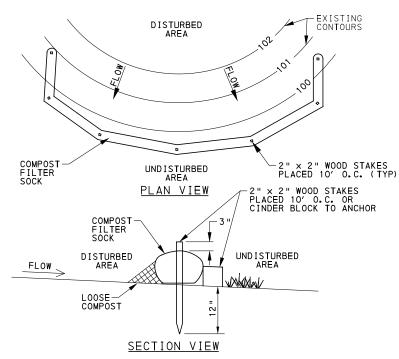

#### NOTES:

- 1. SOCK FABRIC SHALL MEET STANDARDS OF TABLE 1. COMPOST SHALL MEET STANDARDS OF TABLE 2. (PENNDOT STANDARD 867.2)
- 2. PLACE COMPOST FILTER SOCK ON LEVEL GRADE.
  EXTEND BOTH ENDS OF THE COMPOST FILTER SOCK/BERM
  AT LEAST 8 FEET UPSLOPE AT 45 DEGREES TO THE MAIN
  ALIGNMENT. MAXIMUM SLOPE LENGTH ABOVE ANY SOCK
  SHALL NOT EXCEED THAT SHOWN ON FIGURE 4.2 IN
  THE DEP E&SC MANUAL. STAKES MAY BE INSTALLED IMMEDIATELY
  DOWNSLOPE OF THE SOCK IF SO SPECIFIED BY THE MANUFACTURER.
- 3. TRAFFIC SHALL NOT BE PERMITTED TO CROSS FILTER SOCKS.
- 4. REPLACE BIODEGRADABLE FILTER SOCK AFTER
  6 MONTHS; PHOTODEGRADABLE SOCKS AFTER 12 MONTHS.
  POLYPROPYLENE SOCKS SHALL BE REPLACED ACCORDING
  TO MANUFACTURER'S RECOMMENDATIONS, OR WHEN NEEDED.
- 5. UPON STABILIZATION OF THE AREA TRIBUTARY TO THE SOCK, STAKES SHALL BE REMOVED. RE-USE OR REMOVE ENTIRE SOCK, OR IF COMPATIBLE WITH LANDSCAPE PLAN. THE SOCK MAY BE CUT OPEN AND COMPOST USED ON-SITE.
- 6. WHEN USED ON PAVEMENT, SECURE SOCK IN PLACE WITH CONCRETE BLOCKS OR OTHER HEAVY OBJECTS.

COMPOST FILTER SOCK
(FOR FILTRATION OF DIRTY WATER)
NOT TO SCALE

#### TABLE 1


PROVIDE FILTER SOCK MEETING THE COMPOST FILTER SOCK REQUIREMENTS OF THE DEP E&SC MANUAL OR PENNDOT STANDARD SPECIFICATION 867, AS SHOWN BELOW. PROVIDE MANUFACTURER'S FILTER SOCK SPECIFICATIONS, PRODUCT DATE SHEETS, AND DRAWINGS FOR APPROVAL BY THE ENGINEER.

MATERIAL TYPE	3 MIL HDPE	5 MIL HDPE	5 MIL HDPE	MULTI-FILAMENT POLYPROPYLENE (MFPP)	HEAVY DUTY MULTI-FILAMENT POLYPROPYLENE (HDMFPP)
MATERIAL CHARACTERISTICS	PHOTO- DEGRADABLE	PHOTO- DEGRADABLE	BIO- DEGRADABLE	PHOTO- DEGRADABLE	PHOTO- DEGRADABLE
SOCK DIAMETERS	12 " 18 "	12 " 18 " 24 " 32 "	12 " 18 " 24 " 32 "	12" 18" 24" 32"	12 " 18 " 24 " 32 "
MESH OPENING	3⁄6"	3⁄8 "	3/8 "	3/8 "	1/6 "
TENSILE STRENGTH		26 PSI	26 PSI	44 PSI	202 PSI
ULTRAVIOLET STABILITY % ORIGINAL STRENGTH (ASTM G-155)	23% AT 1000 HR.	23% AT 1000 HR.		100% AT 1000 HR.	100% AT 1000 HR.
MINIMUM FUNCTIONAL LONGEVITY	6 MONTHS	9 MONTHS	6 MONTHS	1 YEAR	2 YEARS
		TWO-PLY S	SYSTEMS		
			H	DPE BIAXIAL NET	
				NTINUOUSLY WOUN	
INNER CO	NTAINMENT NETT	ING		N-WELDED JUNCTL	
				" MAX. APERTURE E POLYPROPYLENE	
OUTER	FILTRATION MES	_	(WOVEN LAYER &	NON-WOVEN FLEECH VIA NEEDLE PUN	E MECHANICALLY
		<u>''</u>		MAX. APERTURE S	
SOCK FABRICS	COMPOSED OF BL	IRLAP MAY BE US	ED ON PROJECTS L	ASTING 6 MONTHS	OR LESS.

#### TABLE 2

ORGANIC MATTER CONTENT*	25% - 100% (DRY WEIGHT BASIS)
ORGANIC PORTION	FIBROUS AND ELONGATED
рН	5.5-8.5
MOISTURE CONTENT	30% - 60%
PARTICLE SIZE	30% - 50% PASS THROUGH 3/8" SCREEN
SOLUBLE SALT CONCENTRATION	5.0 dS/m MAXIMUM

\*PROVIDE WELL-DECOMPOSED, STABLE, WEED-FREE, ORGANIC COMPOST DERIVED FROM AGRICULTURE, FOOD, STUMP GRINDINGS, AND YARD OR WOOD/BARK ORGANIC MATTER SOURCES. THE COMPOST SHOULD BE AEROBICALLY COMPOSTED WITH NO OBJECTIONABLE ODDORS. THE COMPOST PRODUCT SHOULD NOT RESEMBLE THE RAW MATERIAL FROM WHICH IT WAS DERIVED. GROUND CONSTRUCTION DEBRIS OR REPROCESSED WOOD PRODUCTS ARE NOT ACCEPTABLE AS THE ORGANIC COMPONENT OF THE MIX. COMPOST MEETING PENNDOT STANDARD SPECIFICATION SECTION 867 WILL BE ACCEPTABLE. PROVIDE A WRITTEN STATEMENT BY THE SUPPLIER CERTIFYING THAT THE COMPOST MEETS THESE REQUIREMENTS. SUBMIT FOR APPROVAL BY THE ENGINEER.

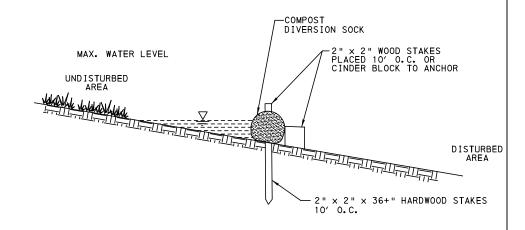

#### GROWING MEDIA SPECIFICATIONS FOR DIVERSION SOCK

ORGANIC MATTER CONTENT	25% - 100% (DRY WEIGHT BASIS)
ORGANIC PORTION	FIBROUS AND ELONGATED
рН	5.0 - 8.0
MOISTURE CONTENT	< 60%
PARTICLE SIZE	100% PASSING 2" SIEVE 99% PASSING 1" SIEVE 70% PASSING 3/4" SIEVE 60% PASSING 1/2" SIEVE 30%-75% PASSING 1/4" SIEVE
SOLUBLE SALT CONCENTRATION	5.0 dS/m (mmhos/cm) MAXIMUM

(ADAPTED FROM PADEP E&SC MANUAL TABLE 4.2 AND PENNDOT STANDARD SPECIFICATION 867)


#### NOTE

- 1. REFER TO COMPOST FILTER SOCK DETAIL FOR ADDTIONAL NOTES.
- 2. MEET "GROWING MEDIA SPECIFICATIONS FOR DIVERSION SOCK".
  THIS FINER MIX IS REQUIRED TO PROVIDE LOW-PERMEABILITY FOR
  THE PURPOSE OF WATER DIVERSION.
- 3. THE CONTRACTOR SHALL PROVIDE CERTIFICATION THAT COMPOST DIVERSION SOCK MEETS PADEP OR PENNDOT STANDARDS PRIOR TO UTILIZATION OF THE PRODUCT ON-SITE.


TEMPORARY COMPOST DIVERSION SOCK

#### COMPOST FILTER SOCK



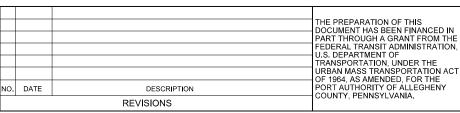

DESIGNED	<u>JMS</u>	PORT AUTHOR	ITY OF AL	LEGHENY CO	JNT	Υ
DRAWN	JMS_	PITTSBURGH		PENN	SYLVAN	IA
CHECKED	DJC	BUS RAPID TE	RANSIT UPT	OWN TO OAKL	AND	
IN CHARGE	LAR	EROSION & SE	DIMENTATIO	N CONTROL PLA	NS	
DATE	05/01/24		DETAILS	3		
SCALE	AS SHOWN	Port Authority	CONTR	RACT NO. BRT-0	01	
· ·	AO OHOWIN	connecting people to life	DWG, NO.	FS4	SHT.	448

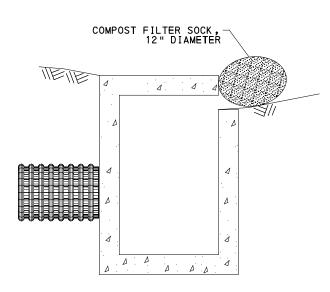


#### SIDE VIEW

#### <u>NOTES</u>

- 1. COMPOST FILTER SOCK SHALL EXTEND ALONG THE GUTTER A MINIMUM OF 12" BEYOND THE EDGE OF OPENING ON EITHER SIDE OF THE INLET.
- 2. REMOVE DEPOSITS WHEN SEDIMENT ACCUMULATION IS ONE HALF OF THE EXPOSED COMPOST FILTER SOCK.
- 3. REPLACE BIODEGRADABLE FILTER SOCK AFTER 6 MONTHS; PHOTODEGRADABLE AFTER 12 MONTHS; POLYPROPYLENE PER MANUFACTURER'S RECOMMENDATIONS.

### INLET PROTECTION FOR INLETS W/ CURB OPENING ONLY

NOT TO SCALE

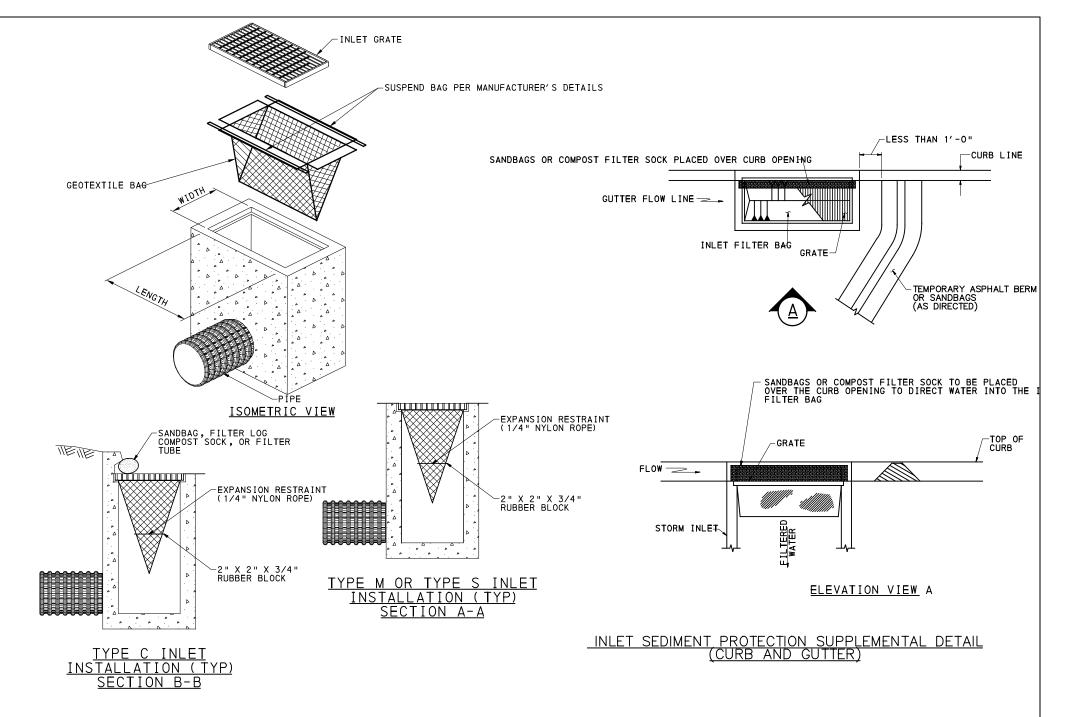

SIDE VIEW

#### NOTES

1. PROVIDE INLET PROTECTION IN ACCORDANCE WITH PENNDOT STANDARD SPECIFICATION 860 - STORM INLET PROTECTION.

#### INLET SEDIMENT PROTECTION

NOT TO SCALE



Gulf Tower 707 Grant Street 5th Floor Pittsburgh, PA 15219

		THE PREPARATION OF THIS DOCUMENT HAS BEEN FINANCED IN PART THROUGH A GRANT FROM THE FEDERAL TRANSIT ADMINISTRATION, U.S. DEPARTMENT OF TRANSPORTATION, UNDER THE
		URBAN MASS TRANSPORTATION ACT OF 1964, AS AMENDED, FOR THE
DATE	DESCRIPTION	PORT AUTHORITY OF ALLEGHENY COUNTY, PENNSYLVANIA.
	REVISIONS	COUNTY, FEININGTEVAINIA.

(NOT FOR CONSTRUCTION)

DESIGNED	<u>JMS</u>	
DRAWN	<u>JMS</u>	
CHECKED	DJC	
IN CHARGE	LAR	
DATE	05/01/24	
SCALE	AS SHOWN	
	AS SHUWIN	

# PORT AUTHORITY OF ALLEGHENY COUNTY PITTSBURGH BUS RAPID TRANSIT UPTOWN TO OAKLAND EROSION & SEDIMENTATION CONTROL PLANS DETAILS Port Authority CONTRACT NO. BRT-001

DWG.NO. ES5

#### SEEDING SCHEDULE:

- SCARIFY SUBGRADE, PROVIDE TOPSOIL (IMPORTED OR SALVAGED), APPLY SOIL SUPPLEMENTS, SEED, AND MULCH IN ACCORDANCE WITH TECHNICAL PROVISION 02923 AND AS INDICATED.
- 2. CUT SLOPES IN COMPETENT BEDROCK AND ROCK FILLS NEED NOT BE VEGETATED. SEEDED AREAS WITHIN 50 FEET OF A SURFACE WATER STEEPER THAN 3H: 1V, OR AS OTHERWISE SHOWN ON THE PLAN DRAWINGS, SHALL BE BLANKETED. WITH PENNDOT 1.D ROLLED EROSION CONTROL PRODUCT PER PENNDOT STANDARD SPECIFICATION 806.
- 3. WITHIN 4 DAYS AFTER EARTH DISTURBANCE CEASES IN ANY AREA, THE OPERATOR SHALL STABILIZE ALL DISTURBED AREAS. DURING NON-GERMINATING MONTHS, MULCH OR PROTECTIVE BLANKETING SHALL BE APPLIED AS DESCRIBED IN THE PLAN. AREAS NOT AT FINISHED GRADE, WHICH WILL BE REACTIVATED WITHIN 1 YEAR, MAY BE STABILIZED WITH FORMULA E. THOSE AREAS WHICH WILL NOT BE REACTIVATED WITHIN 1 YEAR SHALL BE STABILIZED IN ACCORDANCE WITH THE PERMANENT STABILIZATION SPECIFICATIONS.
- 4. SEED AS INCICATED BELOW AND IN TABLE A, OR AS OTHERWISE INDICATED OR DIRECTED.

SCHEDULE OF SEEDING AND SOIL SUPPLEMENTS

SEEDING AND SOIL SUPPLEMENT FORMULA FORMULA B

APPLICATION
LAWNS, AREAS OF INTENSE USE,
AND SELECTED ROADSIDE AREAS

APPLICABLE SEEDING SEASON

MARCH 15 TO JUNE 1
SEPTEMBER 1 TO OCTOBER 15

FORMULA E

TEMPORARY SEEDING

MARCH 15 TO OCTOBER 15

SEE TECHNICAL PROVISION 02923 - SEEDING AND SOIL SUPPLEMENTS. IF IN CONFLICT WITH THIS DRAWING, PROCEED AS DIRECTED BY ENGINEER.

EXTEND SEEDING DATES WHERE PROJECT CONDITIONS WARRANT. APPLY FULL TREATMENT OR APPLY ONLY 50% OF THE PERMANENT SEEDING AND SOIL SUPPLEMENTS AND APPLY THE REMAINING 50% WITHIN THE NEXT SEEDING DATES, AS DIRECTED IN WRITING.

USE TILLAGE AND SOIL SUPPLEMENTS BEFORE PERMANENT SEEDING ON TOPSOILED AREAS, WHERE TEMPORARY SEEDING OR MULCHING HAS BEEN APPLIED. THE CONTRACTOR MAY APPLY PERMANENT SEED AND/OR SOIL SUPPLEMENTS WITHOUT TILLING ON NON-TOPSOILED AREAS, WHERE TEMPORARY SEEDING OR MULCHING HAS BEEN APPLIED.

APPLICATION RATES:	PER ACRE	PER 1,000 SQ YD
AGRICULTURAL LIME	6 TONS	2,480 LB
10-20-20 FERTILIZER	1,000 LB	140.0 LB
FORMULA B SEED	203 LB	44.0 LB
FORMULA E SEED	48 LB	10.0 LB
MULCHING STRAW (TACKIFY PER TECH PROVISION 02923 OR PENNDOT STANDARD SPECIFICATION	3 TONS 805)	1,240 LB
MULCHING WOOD CHIPS (ONLY WHERE DIRECTED)	4 - 6 TONS	1,650 - 2,500 LB

TABLE A					
FORMULA AND CRECIES		% BY MINIMUM %		MAX %	SEEDING RATE LBS PER
FORMULA AND SPECIES	WEIGHT	WEIGHT PURITY GEF	GERMINATION	WEED SEED	1000 SY
FORMULA B					42.0 TOTAL
PERENNIAL RYEGRASS MIXTURE(LOLIUM PERENNE) A COMBINATION OF IMPROVED CERTIFIED VARIETIES WITH NO ONE VARIETY EXCEEDING 50% OF THE TOTAL RYEGRASS COMPONENT	20	97	90	0.1	8.5
CREEPING RED FESCUE ORCHEWINGS FESCUE (FESTUCA RUBRA OR SSP COMMUTATE)	30	97	85	0. 1	12.5
KENTUCKY BLUEGRASS MIXTURE(POA PRATENSIS) A COMBINATION OF IMPROVED CERTIFIED VARIETIES WITH NO ONE VARIETY EXCEEDING 50% OF THE TOTAL BLUEGRASS COMPONENT	50	97	80	0.15	21
FORMULA E ANNUAL RYEGRASS(LOLIUM MULTIFLORUM)	100	95	90	0.1	10.0 TOTAL

\* INCLUDES HARDSEED AND NORMAL SEEDLINGS

**AECOM** 

Gulf Tower 707 Grant Street 5th Floor Pittsburgh, PA 15219

			THE PREPARATION OF THIS DOCUMENT HAS BEEN FINANCED IN
			PART THROUGH A GRANT FROM THE FEDERAL TRANSIT ADMINISTRATIO U.S. DEPARTMENT OF TRANSPORTATION, UNDER THE URBAN MASS TRANSPORTATION ACOF 1964, AS AMENDED, FOR THE
NO.	DATE	DESCRIPTION	PORT AUTHORITY OF ALLEGHENY COUNTY, PENNSYLVANIA.
		REVISIONS	COONTY, PENNSTEVANIA.

(NOT FOR CONSTRUCTION)

DESIGNED	<u>JMS</u>	
DRAWN	<u>JMS</u>	
CHECKED	DJC	
IN CHARGE	LAR	
DATE	05/01/24	
SCALE		
	AS SHOWN	


# PORT AUTHORITY OF ALLEGHENY COUNTY PITTSBURGH BUS RAPID TRANSIT UPTOWN TO OAKLAND

EROSION & SEDIMENTATION CONTROL PLANS
DETAILS

Port Authority


CONTRACT NO. BRT-001


DWG. NO. ES6 SHT. 450

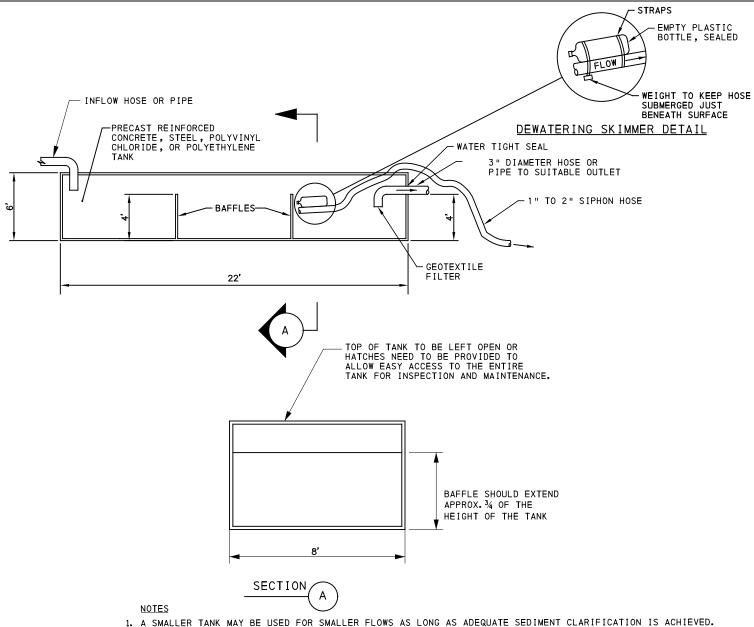

1. A SMALLER TANK MAY BE USED FOR SMALLER FLOWS AS LONG AS ADEQUATE SEDIMENT CLARIFICATION IS ACHIEVED. LIMIT PUMPING RATE SUCH THAT (TANK VOLUME) / (FLOW RATE) REMAINS AT LEAST 60 MINUTES. E.G., 600 GAL TANK / 10 GAL/MINUTE = 60 MINUTES.

SEDIMENT TANK

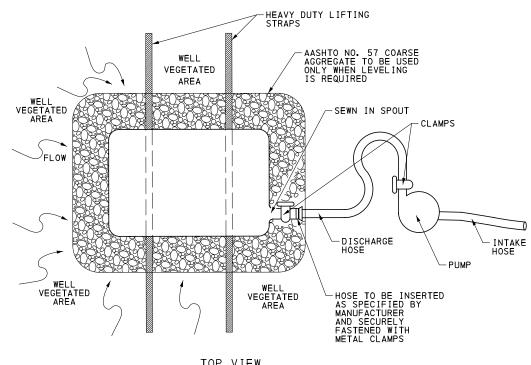

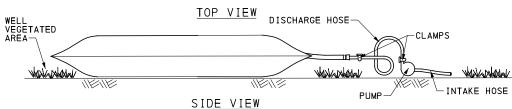


#### PUMPED WATER FILTER BAG NOT TO SCALE

#### NOTES:

- A SEDIMENT TANK MAY BE USED IN PLACE OF A PUMPED WATER FILER BAG AND MAY BE REQUIRED WHERE DIRECTED BY THE ENGINEER.
- A SUITABLE MEANS OF ACCESSING THE BAG WITH MACHINERY REQUIRED FOR DISPOSAL PURPOSES SHALL BE PROVIDED. FILTER BAGS SHALL BE REPLACED WHEN THEY BECOME 1#2 FULL OF SEDIMENT. SPARE BAGS SHALL BE KEPT AVAILABLE FOR REPLACEMENT OF THOSE THAT HAVE FAILED OR ARE FILLED. BAGS SHALL BE PLACED ON STRAPS TO FACILITATE REMOVAL UNLESS BAGS COME WITH LIFTING STRAPS ALREADY ATTACHED.
- BAGS SHALL BE LOCATED IN WELL-VEGETATED (GRASSY) AREA, AND DISCHARGE ONTO STABLE, EROSION RESISTANT AREAS. WHERE THIS IS NOT POSSIBLE, A GEOTEXTILE UNDERLAYMENT AND FLOW PATH SHALL BE PROVIDED. BAGS MAY BE PLACED ON FILTER STONE TO INCREASE DISCHARGE CAPACITY. BAGS SHALL NOT BE PLACED ON SLOPES GREATER THAN 5%. FOR SLOPES EXCEEDING 5%, CLEAN ROCK OR OTHER NON-ERODIBLE AND NON-POLLUTING MATERIAL MAY BE PLACED UNDER THE BAG TO REDUCE SLOPE STEEPNESS
- THE PUMP DISCHARGE HOSE SHALL BE INSERTED INTO THE BAGS IN THE MANNER SPECIFIED BY THE MANUFACTURER AND SECURELY CLAMPED. A PIECE OF PVC PIPE IS RECOMMENDED FOR THIS PURPOSE.
- THE PUMPING RATE SHALL BE NO GREATER THAN 750 GPM OR 1#2 THE MAXIMUM SPECIFIED BY THE MANUFACTURER, WHICHEVER IS LESS. PUMP INTAKES SHALL BE FLOATING AND SCREENED.
- FOR SMALL VOLUMES (< 50 GALLONS), A TUB MAY BE USED AS AN ALTERNATIVE TO EITHER PUMPED WATER FILTER BAG OR SEDIMENT TANK. ALLOW AT LEAST ONE HOUR FOR THE SUSPENDED SOLIDS TO SETTLE THEN DECANT CLEAN WATER
- 7. REMOVE AND DISPOSE OF SEDIMENT OR RESIDUE ON DOWNSTREAM FLOW PATH



707 Grant Street 5th Floor Pittsburgh, PA 15219

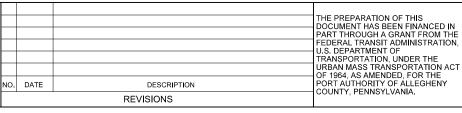

(NOT FOR CONSTRUCTION)

DESIGNED	<u>JMS</u>	
DRAWN	<u>JMS</u>	
CHECKED	DJC	
IN CHARGE	LAR	
DATE	05/01/24	
SCALE		
	AS SHOWN	


## PORT AUTHORITY OF ALLEGHENY COUNTY

BUS RAPID TRANSIT UPTOWN TO OAKLAND **EROSION & SEDIMENTATION CONTROL PLANS** DETAILS

**Port Authority** 

CONTRACT NO. BRT-001

DWG.NO. ES7 sнт. 451

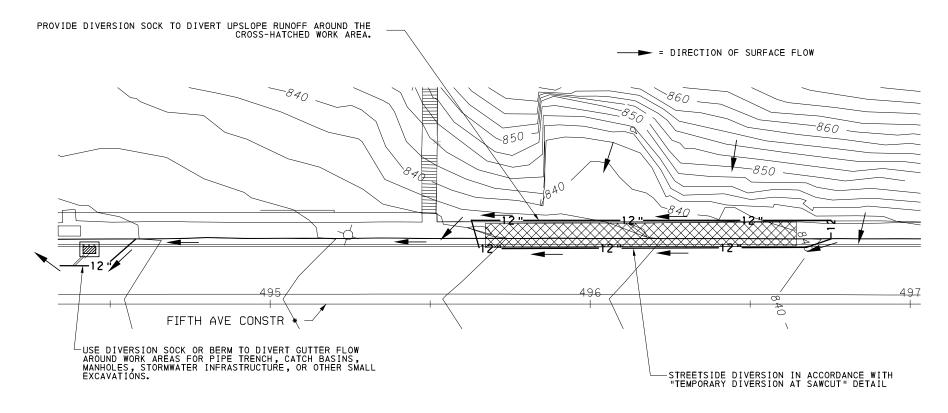

#### NOTES:

- 1. THIS PLAN VIEW ILLUSTRATES TYPICAL PRACTICES FOR WORK WHERE ADJACENT GROUND DRAINS TOWARD THE STREET. ADJUST AS APPROPRIATE FOR SPECIFIC CIRCUMSTANCES.
- 2. 12" LINESTYLE REPRESENTS 12" DIVERSION SOCK. ON IRREGULAR PAVEMENT, APPLY A BEAD OF REMOVABLE CAULK BENEATH DIVERSION SOCK AS NEEDED TO PREVENT FLOW UNDER SOCK. A 6"-HIGH TEMPORARY ASPHALT CURB OR BERM MAY BE USED IN PLACE OF SOCK.
- 3. WHERE DIVERSION SOCK OR TEMPORARY ASPHALT BERM MEET VERTICAL OR IRREGULAR SURFACES, SEAL GAPS USING PLASTIC SHEET & ROCK, ASPHALT COLD PATCH, CAULK, OR OTHER MATERIALS.
- 4. WHEN NO LONGER NEEDED, REMOVE CAULK, ASPHALT, AND OTHER MATERIALS AND RESTORE STREET, SIDEWALK, AND OTHER PROPERTY TO OWNER'S SATISFACTION.
- 5. IF A DOWNSPOUT DISCHARGES WITHIN WORK AREA, TEMPORARILY EXTEND THROUGH WORK AREA.
- 6. LIMIT SIZE OF WORK AREAS SUCH THAT DIVERSION DOES NOT OVERLOAD DOWNSTREAM DRAINAGE SYSTEM.
- 7. IF WORK OCCURS IN COLD WEATHER, PREVENT FORMATION OF ICE HAZARDS DUE TO DIVERSIONS.
- 8. DIVERSION IS NOT NECESSARY IF WORK CAN BE COMPLETED BEFORE RISK OF A RUNOFF EVENT.

TYPICAL UPSLOPE DIVERSION

Gulf Tower 707 Grant Street

5th Floor

Pittsburgh, PA 15219

THE PREPARATION OF THIS
DOCUMENT HAS BEEN FINANCED IN
PART THROUGH A GRANT FROM THE
EDERAL TRANSIT ADMINISTRATION,
U.S. DEPARTMENT OF
TRANSPORTATION, UNDER THE
URBAN MASS TRANSPORTATION ACT
OF 1964, AS AMENDED, FOR THE
PORT AUTHORITY OF ALLEGHENY
COUNTY, PENNSYLVANIA.

(NOT FOR CONSTRUCTION)

DESIGNED	<u>JMS</u>	
DRAWN	<u>JMS</u>	
CHECKED	DJC	
IN CHARGE	LAR	
DATE	05/01/24	
SCALE	AS SHOWN	

PORT AUTHORITY OF ALLEGHENY COUNTY
PITTSBURGH


BUS RAPID TRANSIT UPTOWN TO OAKLAND

EROSION & SEDIMENTATION CONTROL PLANS DETAILS


Port Authority

CONTRACT NO. BRT-001

DWG. NO. ES8 SHT. 452

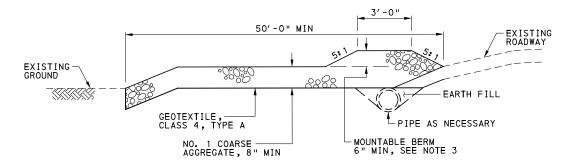


#### **PROFILE**

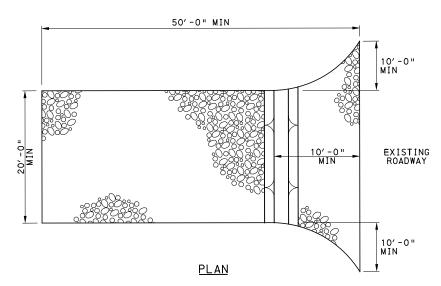

#### ROCK CONSTRUCTION ENTRANCE NOT TO SCALE

#### NOTES:

- 1. REMOVE TOPSOIL PRIOR TO INSTALLATION OF ROCK CONSTRUCTION ENTRANCE. EXTEND ROCK OVER FULL WIDTH OF ENTRANCE.
- 2. RUNOFF SHALL BE DIVERTED FROM ROADWAY TO A SUITABLE SEDIMENT REMOVAL BMP PRIOR TO ENTERING ROCK CONSTRUCTION ENTRANCE.
- MOUNTABLE BERM SHALL BE INSTALLED WHEREVER OPTIONAL CULVERT PIPE IS USED AND PROPER PIPE COVER AS SPECIFIED BY MANUFACTURER IS NOT OTHERWISE PROVIDED. PIPE SHALL BE SIZED APPROPRIATELY FOR SIZE OF DITCH BEING CROSSED.
- 4. PRE-CONSTRUCTED RUMBLE PADS (SEE PA DEP MANUAL PAGE 17 FOR EXAMPLE PHOTO) MAY BE USED INSTEAD OF ROCK CONSTRUCTION ENTRANCES PROVIDED THEY ARE INSTALLED ACCORDING TO MANUFACTURER'S RECOMMENTDATIONS AND A SUFFICIENT NUMBER OF PADS ARE INSTALLED TO PROVIDE FOR A MINIMUM OF FOUR TIRE REVOLUTIONS WHILE ON THE PAD. MORE PADS MAY BE NEEDED DEPENDING ON SITE CONDITIONS

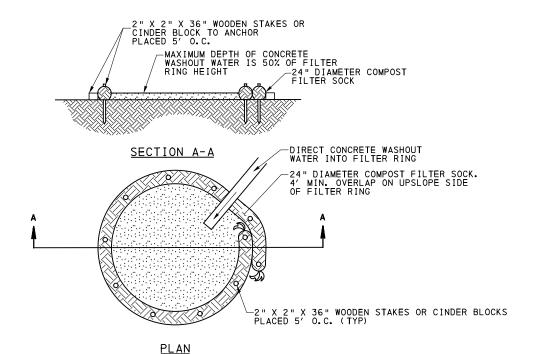

CONCRETE WASHOUT NOT TO SCALE


#### NOTES:

- 1. FOR THE PURPOSE OF RINSING CHUTES ONLY, RINSATE MAY GO INTO A SEDIMENT TANK OR A TUB. ALLOW AT LEAST 30 MINUTES FOR SEDIMENT TO SETTLE THEN DECANT CLEAR WATER AT A LOCATION DRAINING TO THE COMBINED SEWER SYSTEM. RETURN UNUSED CONCRETE AND MIXER DRUM RINSATE TO THE CONCRETE PLANT.
- 2. INSTALL ON FLAT GRADE FOR OPTIMUM PERFORMANCE.
- 3. 18" DIAMETER FILTER SOCK MAY BE STACKED ONTO DOUBLE 24" DIAMETER SOCKS IN PYRAMIDAL CONFIGURATION FOR ADDED HEIGHT.
- 4. FOR ANY PROJECT ON WHICH CONCRETE WILL BE POURED OR OTHERWISE FORMED ON SITE, A WASHOUT FACILITY MUST BE PROVIDED FOR THE CLEANING OF CHUTES, MIXERS, AND HOPPERS OF THE DELIVERY VEHICLES. UNDER NO CIRCUMSTANCES SHOULD WASH WATER FROM THESE VEHICLES BE ALLOWED TO ENTER ANY SURFACE WATERS. MAKE SURE THAT PROPER SIGNAGE IS PROVIDED TO DRIVERS SO THAT THEY ARE AWARE OF THE PRESENCE OF WASHOUT FACILITIES.
- 5. A SUITABLE IMPERVIOUS GEOMEMBRANE MUST BE PLACED AT THE LOCATION OF THE WASHOUT. COMPOST SOCKS MUST BE STAKED IN THE MANNER RECOMMENDED BY THE MANUFACTURER AROUND PERIMETER OF THE GEOMEMBRANE SO AS TO FORM A RING WITH THE ENDS OF THE SOCK LOCATED AT THE UPSLOPE CORNER. CARE MUST BE TAKEN TO ENSURE CONTINUOUS CONTACT OF THE SOCK WITH THE GEOMEMBRANE AT ALL LOCATIONS. WHERE NECESSARY, SOCKS MAY BE STACKED AND STAKED SO AS TO FORM A TRIANGULAR CROSS-SECTION.
- ALL CONCRETE WASHOUT FACILITIES MUST BE INSPECTED DAILY. DAMAGED OR LEAKING WASHOUTS MUST BE DEACTIVATED AND REPAIRED OR REPLACED IMMEDIATELY.

- 7. ACCUMULATED MATERIALS MUST BE REMOVED WHEN THEY REACH 50% CAPACITY.
- 8. PLASTIC LINERS MUST BE REPLACED WITH EACH CLEANING OF THE WASHOUT FACILITY.
- 9. IF CONTRACTOR PREFERS ANY OTHER METHOD FOR CONCRETE WASHOUT, IT MUST BE APPROVED BY THE ENGINEER.
- 10. WASHOUT FACILITIES MUST NOT BE PLACED WITHIN 50 FEET OF STORM DRAINS, OPEN DITCHES, OR SURFACE WATERS. THEY MUST BE IN A CONVENIENT LOCATION FOR THE TRUCKS, PREFERABLY NEAR THE PLACE WHERE THE CONCRETE IS BEING POURED, BUT FAR ENOUGH FROM OTHER VEHICULAR TRAFFIC TO MINIMIZE THE POTENTIAL FOR ACCIDENTAL DAMAGE OR SPILLS WHEREVER POSSIBLE, THEY MUST BE LOCATED ON SLOPES NOT EXCEEDING A 2% GRADE.
- 11. REMOVE AND DISPOSE OF SEDIMENT OR RESIDUE ON DOWNSTREAM FLOW PATH AS NEEDED.

AECOM

707 Grant Street 5th Floor Pittsburgh, PA 15219

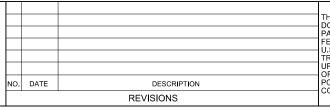

THE PREPARATION OF THIS DOCUMENT HAS BEEN FINANCED IN PART THROUGH A GRANT FROM THE FEDERAL TRANSIT ADMINISTRATION U.S. DEPARTMENT OF TRANSPORTATION, UNDER THE URBAN MASS TRANSPORTATION ACT OF 1964 AS AMENDED FOR THE COUNTY, PENNSYLVANIA.

(NOT FOR CONSTRUCTION)

DESIGNED	<u>JMS</u>	
DRAWN	<u>JMS</u>	
CHECKED	DJC	
IN CHARGE	LAR	
DATE	05/01/24	
SCALE		
	AS SHOWN	
	DRAWN CHECKED IN CHARGE DATE	DRAWN         JMS           CHECKED         DJC           IN CHARGE         LAR           DATE         05/01/24


PORT AUTHORITY OF ALLEGHENY COUNTY

BUS RAPID TRANSIT UPTOWN TO OAKLAND **EROSION & SEDIMENTATION CONTROL PLANS** DETAILS

**Port Authority** 

CONTRACT NO. BRT-001 DWG. NO. ES9

SAWCUT-

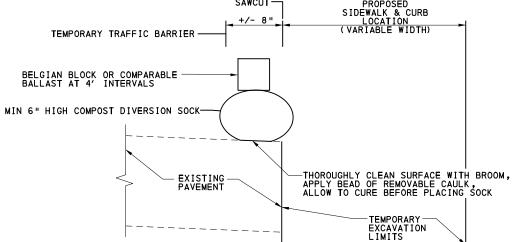


-ASPHALT BERM 6" OR AS DIRECTED -EXISTING PAVEMENT -APPLY TACK COAT OF EMULSIFIED ASPHALT

1. MAY BE USED IN PLACE OF COMPOST DIVERSION SOCK.


2. PERMANENT PAVEMENT MUST BE RESTORED TO FULLY USABLE CONDITION AFTER REMOVAL OF BERM TO THE OWNER'S SATISFACTION.

#### TEMPORARY ASPHALT BERM NOT TO SCALE

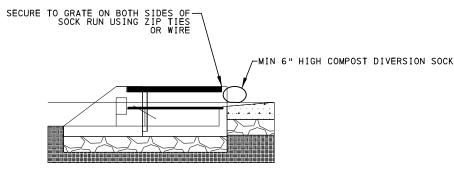

TYPICAL INTEGRATED INLET (FOXHOLE) DIVERSION SOCK NOT TO SCALE

DRAINAGE SLOTS -CINDER BLOCKS PLACED ON BOTH SIDES OF-SOCK RUN SECURED USING ZIP TIES OR WIRE -MIN 6" HIGH COMPOST DIVERSION SOCK T SIDEWALK 0 80 080 TYPICAL SIDEWALK SLOT DIVERSION SOCK NOT TO SCALE

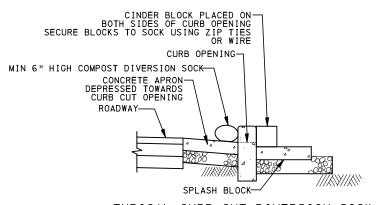

TYPICAL CURB CUT DIVERSION SOCK NOT TO SCALE

- AFTER CURB CUT OR DRAINAGE SLOT ARE IN PLACE IMMEDIATE INSTALL COMPOST FILTER SOCK AT OPENING.
- 2. FILTER SOCK SHALL REMAIN IN PLACE UNTIL ALL UPSLOPE AREAS HAVE BEEN STABILIZED AND CONSTRUCTION OF THE BIOSWALE HAS BEEN COMPLETED.

#### BIOSWALE DIVERSION SOCK NOT TO SCALE

#### TEMPORARY DIVERSION AT SAWCUT

AECOM 707 Grant Street 5th Floor

Pittsburgh, PA 15219

THE PREPARATION OF THIS DOCUMENT HAS BEEN FINANCED IN PART THROUGH A GRANT FROM THE FEDERAL TRANSIT ADMINISTRATION U.S. DEPARTMENT OF TRANSPORTATION, UNDER THE URBAN MASS TRANSPORTATION ACT OF 1964, AS AMENDED, FOR THE PORT AUTHORITY OF ALLEGHENY NO. DATE DESCRIPTION COUNTY, PENNSYLVANIA. REVISIONS

(NOT FOR CONSTRUCTION)


DESIGNED	<u>JMS</u>	
DRAWN	<u>JMS</u>	
CHECKED	DJC	
IN CHARGE	LAR	
DATE	05/01/24	
SCALE		
	AS SHOWN	

PORT AUTHORITY OF ALLEGHENY COUNTY BUS RAPID TRANSIT UPTOWN TO OAKLAND EROSION & SEDIMENTATION CONTROL PLANS DETAILS **Port Authority** CONTRACT NO. BRT-001 DWG. NO. ES10 sнт. **454** 

1. DIVERSION CURB OR SOCK IS TO PREVENT STORM RUNOFF FROM ENTERING EXCAVATIONS WHERE BASEMENT WALLS, VAULTS, OR OTHER FLOOD-SENSITIVE STRUCTURES MAY BE EXPOSED. DIVERSION MAY NOT BE NEEDED WHERE ADJACENT PAVEMENT SLOPES AWAY FROM THE EXCAVATION, WHERE THERE IS NEGLIGIBLE UPSLOPE AREA, WHERE THERE IS NO SIGNIFICANT RISK OF FLOOD DAMAGE, OR WHERE CURB WILL BE RESTORED BEFORE RISK OF PRECIPITATION.

COMPOST DIVERSION SOCK

- 2. DIVERION CURB OR SOCK SHOULD GENERALLY EXTEND TO UPSTREAM CURB FACE WITH A DURABLE WATERTIGHT CLOSURE. USE REMOVABLE CAULK, PLASTIC SHEET WITH BALLAST, OR OTHER MATERIALS FOR CLOSURE. EXTEND DIVERSION TO THE DOWNSTREAM CURB OR AS NEEDED TO PREVENT FLOW INTO THE EXCAVATION.
- 3. SEE "COMPOST FILTER SOCK" DETAIL. COMPOST DIVERSION SOCK MESH FABRIC IS TO BE THE SAME BUT COMPOST DIVERSION SOCK FILL MATERIAL IS TO BE GROWING MEDIA AS NOTED IN THE TEMPORARY COMPOST DIVERSION SOCK DETAIL.
- 4. REMOVE & DISPOSE OF SOCK, ASPHALT, CAULK WHEN FINISHED. RESTORE EXISTING PAVEMENT.
- 5. DIVERSION MAY NEED TO BE RESET WHEN WORK ACITIVIES ARE LOCATED IN CLOSE PROXIMITY OR DUE TO RESTRICTED WORK AREAS BEHIND TRAFFIC BARRIERS. RESTORE DIVERSION PRIOR TO END OF WORK DAY OR PRIOR TO

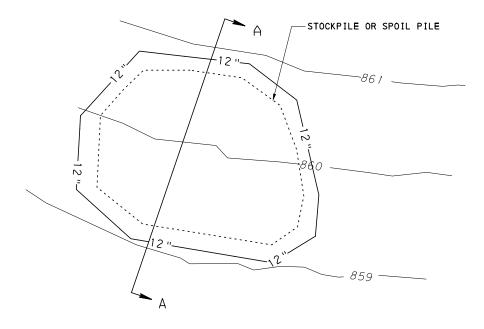


<u>PL AN</u>


#### NOTES:

- 1. PROTECT ALL ERODIBLE STOCKPILES AND SPOIL PILES DURING NON-WORKING HOURS OR WHEN RAINFALL MIGHT OCCUR WITH EITHER COMPOST SOCK OR TARP. USE COMPOST SOCK OPTION ONLY WHERE APPROVED BY ENGINEER.
- 2. PLACE GEOTEXTILE OR TARP UNDER ALL PILES. CAREFULLY ROLL UP TARP TO REMOVE ALL DIRT WHEN STOCKPILE IS REMOVED.
- 3. KEEP STOCKPILES WITHIN LIMITS-OF-DISTURBANCE SHOWN ON PLANS.

TYPICAL STOCKPILE NOT TO SCALE

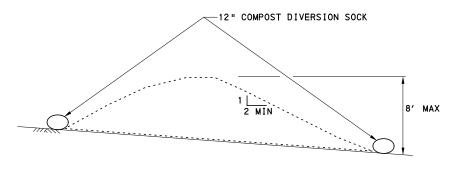

SECTION A-A - COMPOST SOCK OPTION

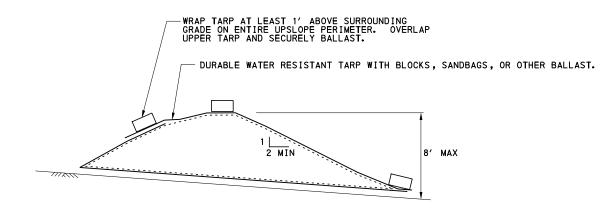

SECTION A-A - TARP OPTION

**AECOM** 

707 Grant Street 5th Floor Pittsburgh, PA 15219

THE PREPARATION OF THIS
DOCUMENT HAS BEEN FINANCED IN
PART THROUGH A GRANT FROM THE
FEDERAL TRANSIT ADMINISTRATION, FEDERAL HANSII ADMINISTRATION,
U.S. DEPARTMENT OF
TRANSPORTATION, UNDER THE
URBAN MASS TRANSPORTATION ACT
OF 1964, AS AMENDED, FOR THE
PORT AUTHORITY OF ALLEGHENY
COUNTY, PENNSYLVANIA. NO. DATE DESCRIPTION **REVISIONS** 

(NOT FOR CONSTRUCTION)


DESIGNED	<u>JMS</u>	
DRAWN	<u>JMS</u>	
CHECKED	DJC	
IN CHARGE	LAR	
DATE	05/01/24	
SCALE		
	AS SHOWN	

# PORT AUTHORITY OF ALLEGHENY COUNTY

BUS RAPID TRANSIT UPTOWN TO OAKLAND EROSION & SEDIMENTATION CONTROL PLANS DETAILS

Port Authority

CONTRACT NO. BRT-001 DWG. NO. ES11

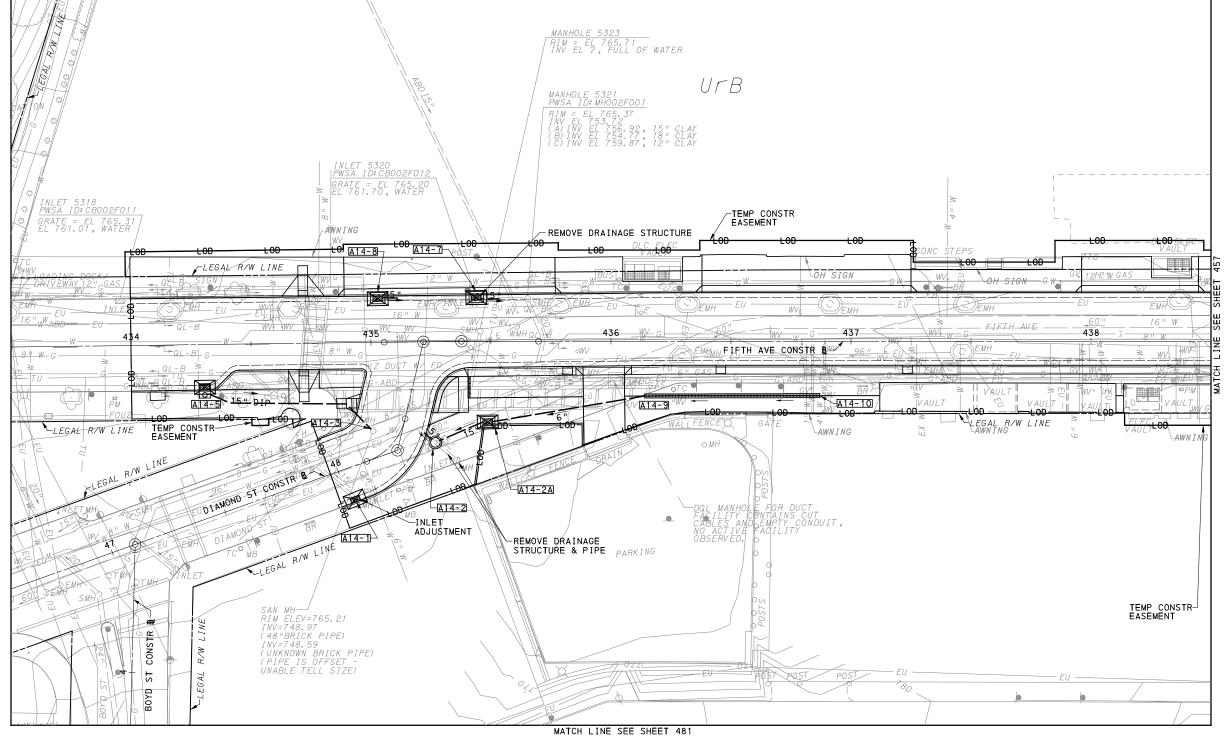

**LEGEND** 

——12"—— COMPOST DIVERSION SOCK (SIZE AS NOTED)

\_\_\_12"\_\_\_ COMPOST FILTER SOCK (SIZE AS NOTED)

RCE-1

ROCK CONSTRUCTION ENTRANCE

---- SOIL BOUNDARY

UFB SOIL UNIT NAME

EXISTING CONTOUR MINOR

EXISTING CONTOUR MAJOR

GI STORAGE TRENCH

DRAINAGE STRUCTURE

FOR ROADWAY PLAN SEE SHEET 357

AECOM

707 Grant Street 5th Floor Pittsburgh, PA 15219

THE PREPARATION OF THIS
DOCUMENT HAS BEEN FINANCED IN
PART THROUGH A GRANT FROM THE
FEDERAL TRANSIT ADMINISTRATION, PEDERAL TRANSIT ADMINISTRATION,
U.S. DEPARTMENT OF
TRANSPORTATION, UNDER THE
URBAN MASS TRANSPORTATION ACT
OF 1964, AS AMENDED, FOR THE
PORT AUTHORITY OF ALLEGHENY
COUNTY, PENNSYLVANIA. NO. DATE DESCRIPTION REVISIONS

(NOT FOR CONSTRUCTION)

40 FEET

ESIGNED	<u>JMS</u>	
RAWN	<u>JMS</u>	
HECKED	DJC	
CHARGE	LAR	
ATE	05/01/24	
CALE	AS SHOWN	


PORT AUTHORITY OF ALLEGHENY COUNTY

BUS RAPID TRANSIT UPTOWN TO OAKLAND EROSION & SEDIMENTATION CONTROL PLANS FIFTH AVE - STA 433+50 TO STA 438+50


Port Authority connecting people to life

CONTRACT NO. BRT-001 DWG. NO. ES12



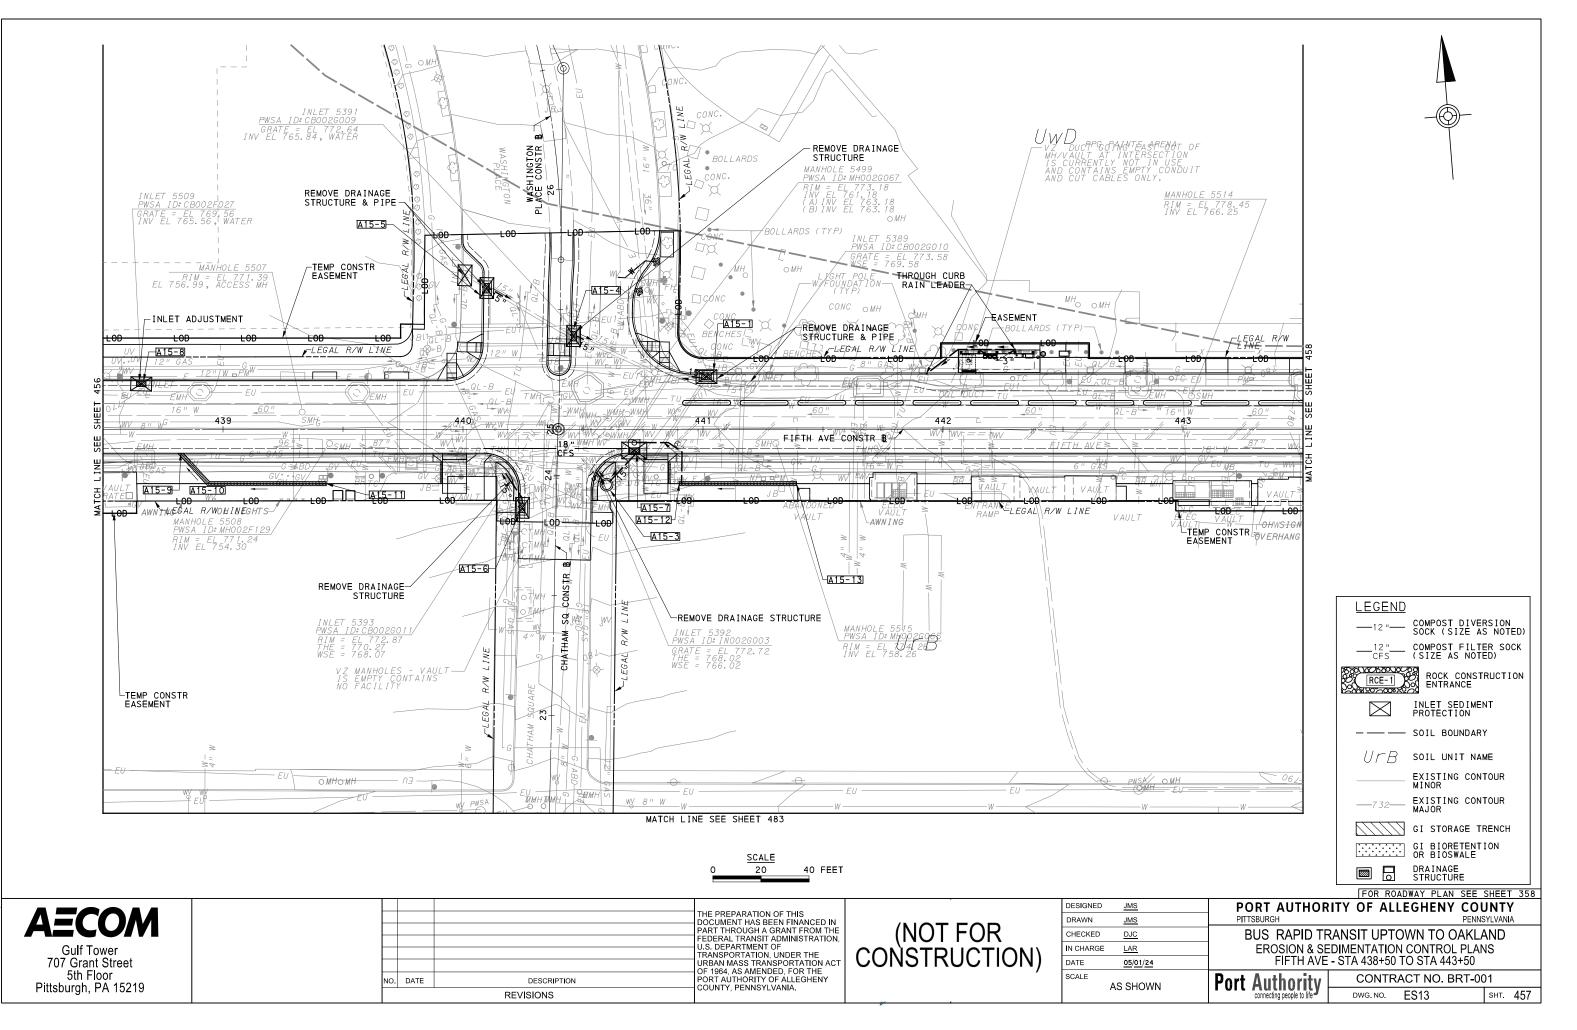

OPERATOR: "michael.mcgarry"

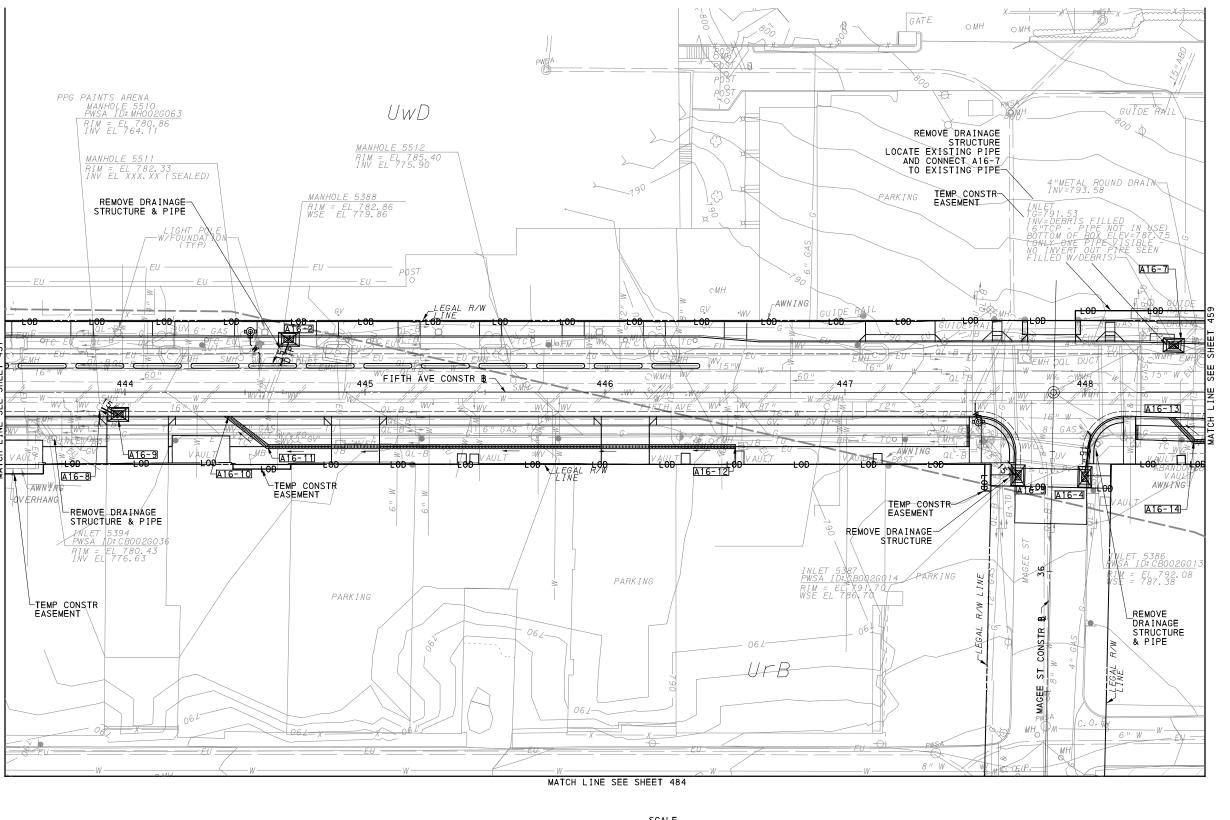

**LEGEND** 

——12"—— COMPOST DIVERSION SOCK (SIZE AS NOTED)

\_\_\_12"\_\_\_ COMPOST FILTER SOCK (SIZE AS NOTED)

RCE-1

ROCK CONSTRUCTION ENTRANCE

— SOIL BOUNDARY

UFB SOIL UNIT NAME EXISTING CONTOUR MINOR

EXISTING CONTOUR

GI STORAGE TRENCH

DRAINAGE STRUCTURE 

**AECOM** 707 Grant Street 5th Floor Pittsburgh, PA 15219

THE PREPARATION OF THIS
DOCUMENT HAS BEEN FINANCED IN
PART THROUGH A GRANT FROM THE
FEDERAL TRANSIT ADMINISTRATION, PEDERAL TRANSIT ADMINISTRATION,
U.S. DEPARTMENT OF
TRANSPORTATION, UNDER THE
URBAN MASS TRANSPORTATION ACT
OF 1964, AS AMENDED, FOR THE
PORT AUTHORITY OF ALLEGHENY
COUNTY, PENNSYLVANIA. NO. DATE DESCRIPTION REVISIONS

(NOT FOR CONSTRUCTION)

40 FEET


DESIGNED	<u>JMS</u>	
DRAWN	<u>JMS</u>	
CHECKED	DJC	
IN CHARGE	<u>LAR</u>	
DATE	05/01/24	
SCALE		
	AS SHOWN	

FOR ROADWAY PLAN SEE SHEET 359 PORT AUTHORITY OF ALLEGHENY COUNTY

BUS RAPID TRANSIT UPTOWN TO OAKLAND EROSION & SEDIMENTATION CONTROL PLANS FIFTH AVE - STA 443+50 TO STA 448+50

Port Authority connecting people to life

CONTRACT NO. BRT-001 DWG. NO. ES14

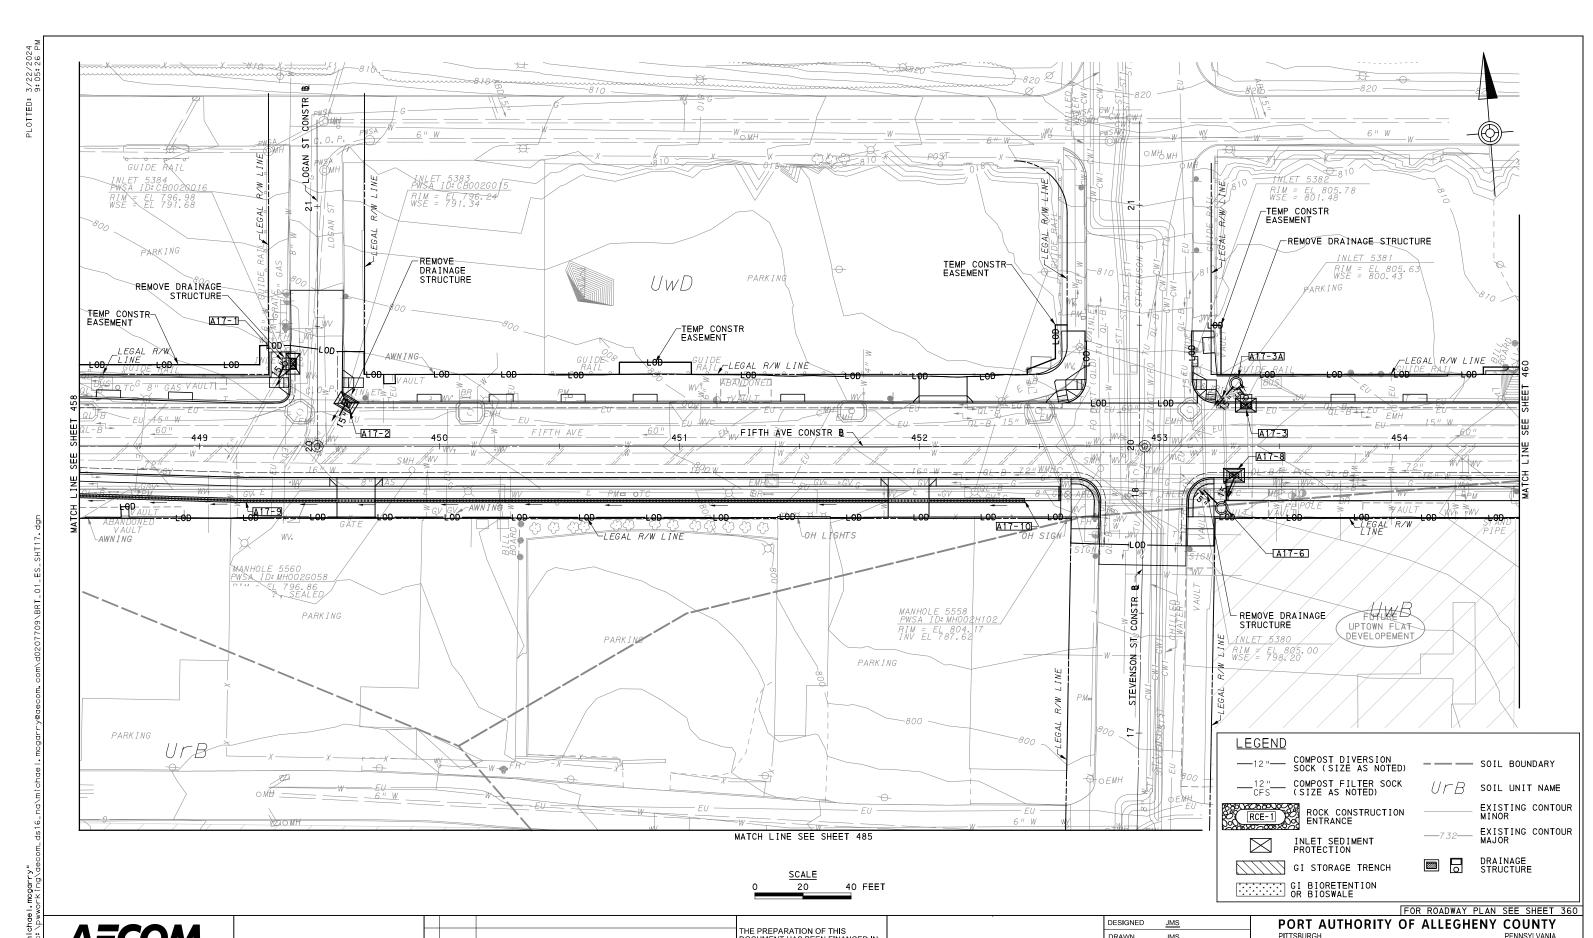

AECOM

707 Grant Street 5th Floor Pittsburgh, PA 15219

THE PREPARATION OF THIS
DOCUMENT HAS BEEN FINANCED IN
PART THROUGH A GRANT FROM THE
FEDERAL TRANSIT ADMINISTRATION, PEDERAL TRANSIT ADMINISTRATION,
U.S. DEPARTMENT OF
TRANSPORTATION, UNDER THE
URBAN MASS TRANSPORTATION ACT
OF 1964, AS AMENDED, FOR THE
PORT AUTHORITY OF ALLEGHENY
COUNTY, PENNSYLVANIA. NO. DATE DESCRIPTION REVISIONS

(NOT FOR CONSTRUCTION)


ESIGNED	<u>JMS</u>	
RAWN	<u>JMS</u>	
HECKED	DJC	
N CHARGE	LAR	
ATE	05/01/24	
CALE	AS SHOWN	

BUS RAPID TRANSIT UPTOWN TO OAKLAND EROSION & SEDIMENTATION CONTROL PLANS FIFTH AVE - STA 448+50 TO STA 454+50

Port Authority

CONTRACT NO. BRT-001 ES15 DWG. NO. sнт. **45**9



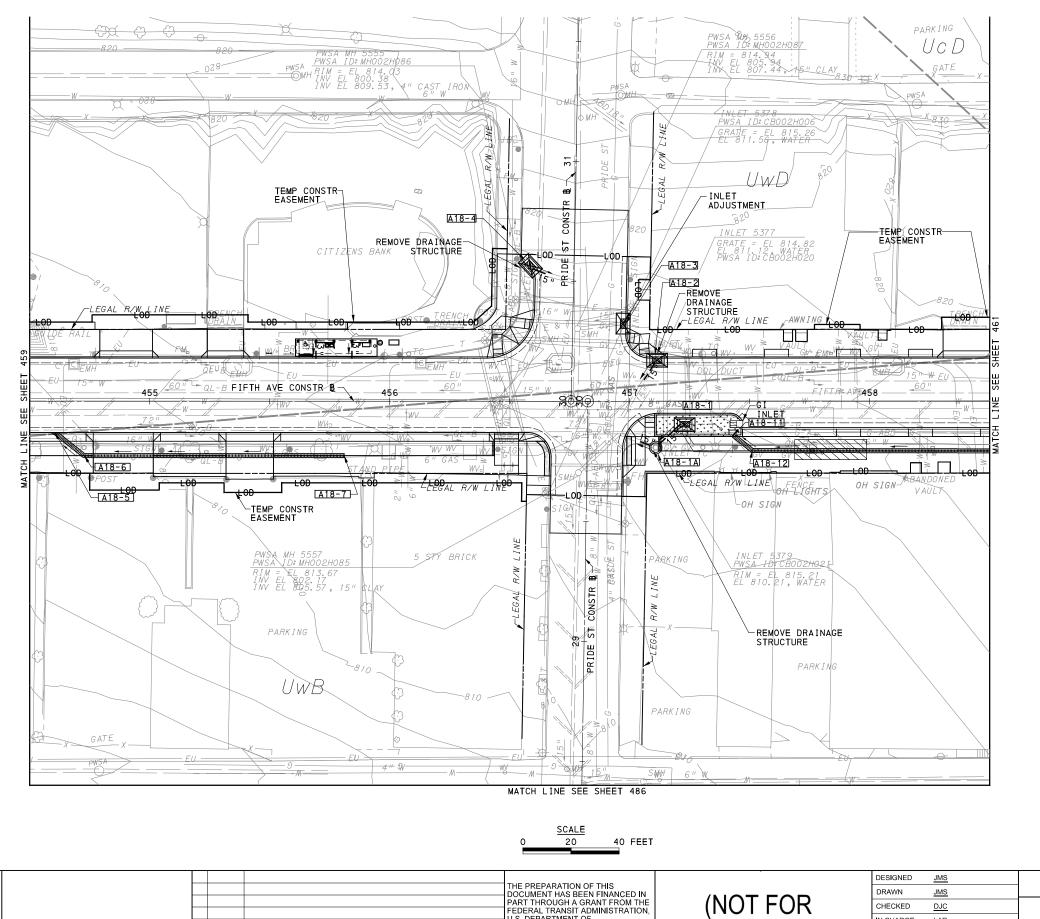

DRAINAGE STRUCTURE FOR ROADWAY PLAN SEE SHEET 361

GI STORAGE TRENCH

——12"—— COMPOST DIVERSION SOCK (SIZE AS NOTED) \_\_\_12"\_\_\_ COMPOST FILTER SOCK (SIZE AS NOTED)

ROCK CONSTRUCTION ENTRANCE

-- SOIL BOUNDARY

UFB SOIL UNIT NAME

EXISTING CONTOUR MINOR EXISTING CONTOUR MAJOR

PORT AUTHORITY OF ALLEGHENY COUNTY

BUS RAPID TRANSIT UPTOWN TO OAKLAND **EROSION & SEDIMENTATION CONTROL PLANS** FIFTH AVE - STA 454+50 TO STA 458+50

**LEGEND** 

RCE-1

Port Authority

CONTRACT NO. BRT-001

DWG. NO. ES16 sнт. 460


AECOM 707 Grant Street 5th Floor

Pittsburgh, PA 15219

PEDERAL TRANSIT ADMINISTRATION,
U.S. DEPARTMENT OF
TRANSPORTATION, UNDER THE
URBAN MASS TRANSPORTATION ACT
OF 1964, AS AMENDED, FOR THE
PORT AUTHORITY OF ALLEGHENY
COUNTY, PENNSYLVANIA. NO. DATE DESCRIPTION REVISIONS


(NOT FOR CONSTRUCTION)

IN CHARGE LAR DATE 05/01/24 SCALE AS SHOWN

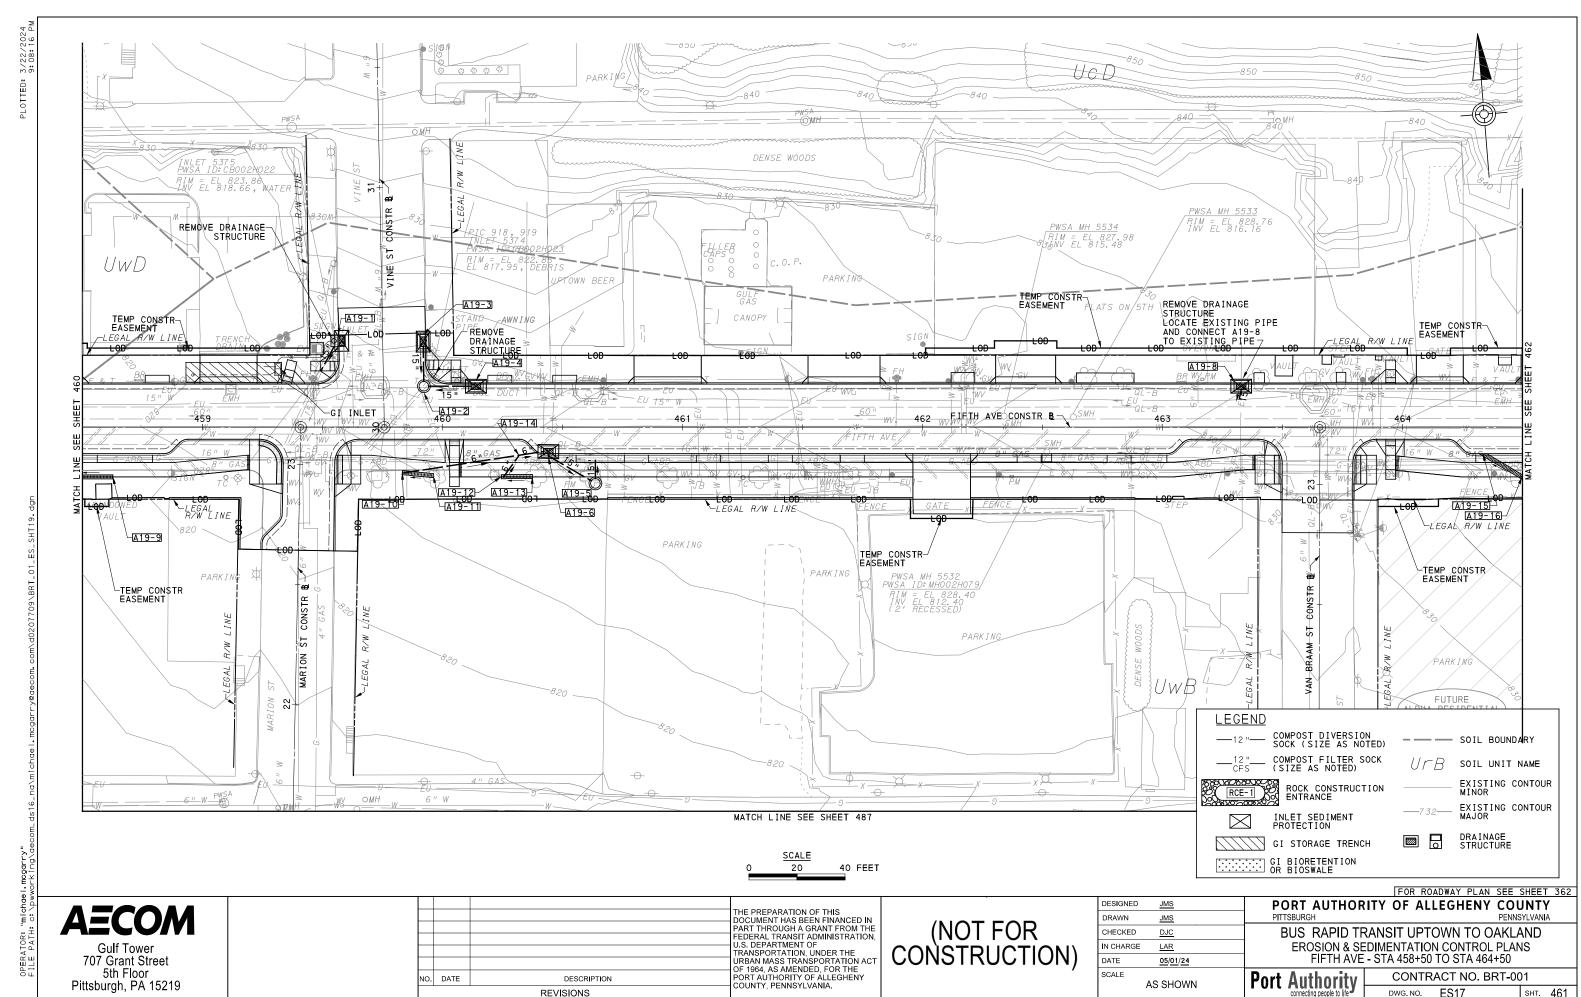

REVISIONS

DWG.NO. ES17

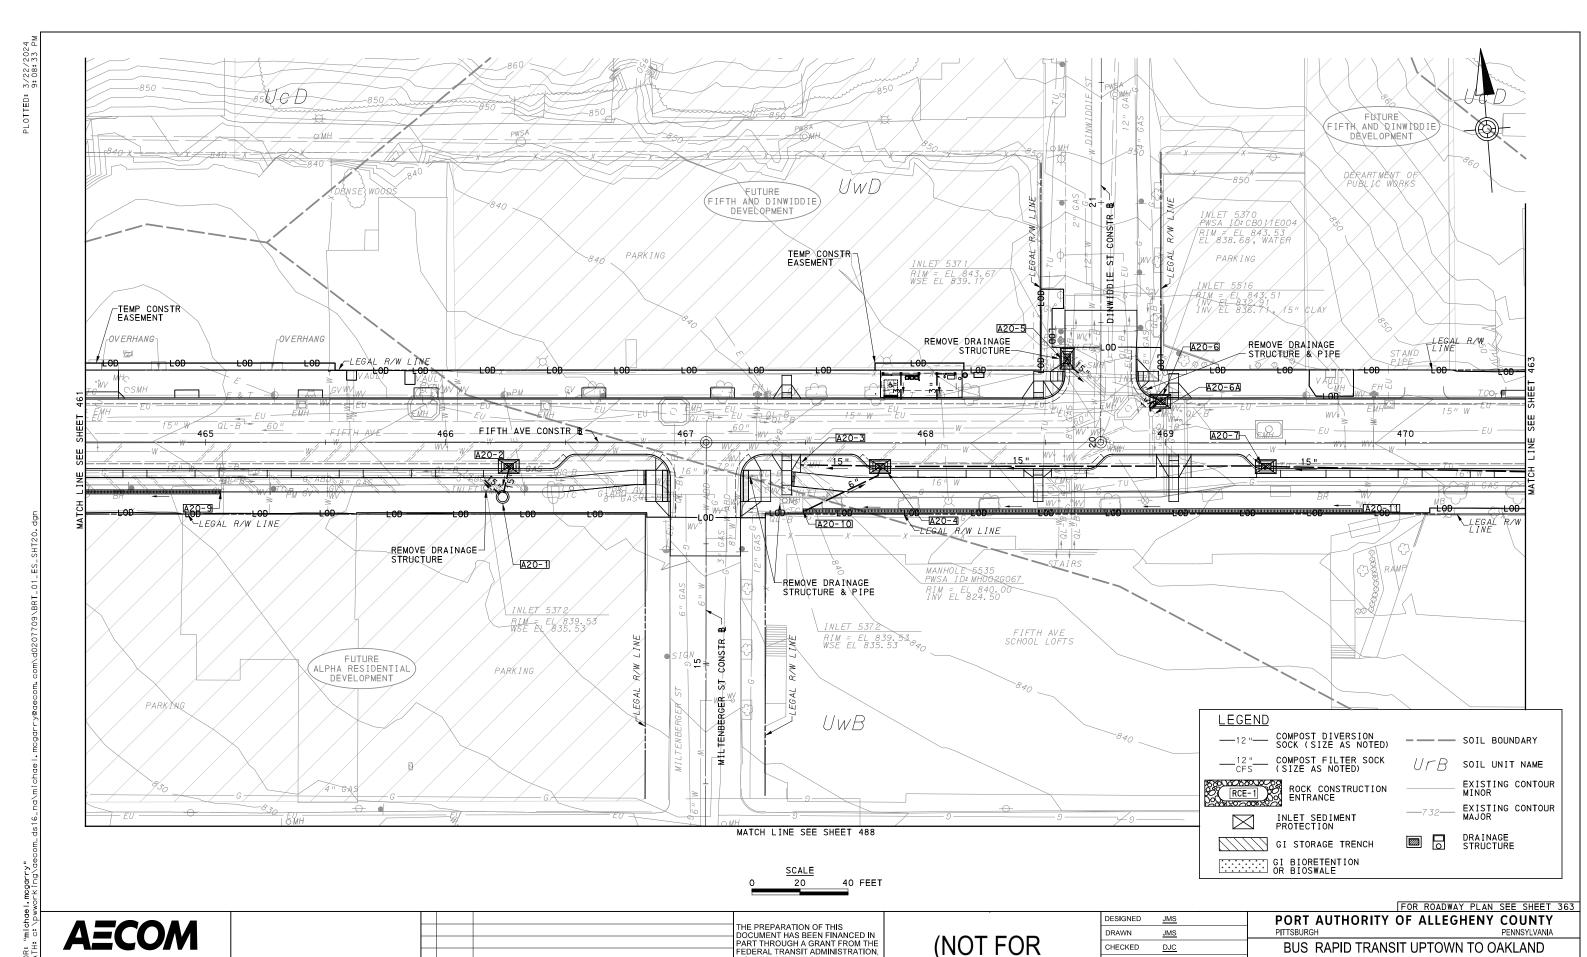

707 Grant Street 5th Floor Pittsburgh, PA 15219

PEDERAL TRANSIT ADMINISTRATION,
U.S. DEPARTMENT OF
TRANSPORTATION, UNDER THE
URBAN MASS TRANSPORTATION ACT
OF 1964, AS AMENDED, FOR THE
PORT AUTHORITY OF ALLEGHENY
COUNTY, PENNSYLVANIA. NO. DATE DESCRIPTION REVISIONS

(NOT FOR CONSTRUCTION)

DJC N CHARGE LAR DATE 05/01/24 SCALE AS SHOWN

BUS RAPID TRANSIT UPTOWN TO OAKLAND EROSION & SEDIMENTATION CONTROL PLANS FIFTH AVE - STA 464+50 TO STA 470+50

Port Authority

CONTRACT NO. BRT-001 DWG. NO. ES18 sнт. 462

AS SHOWN

DWG. NO. ES19


sнт. 463

Pittsburgh, PA 15219


NO. DATE

DESCRIPTION

REVISIONS

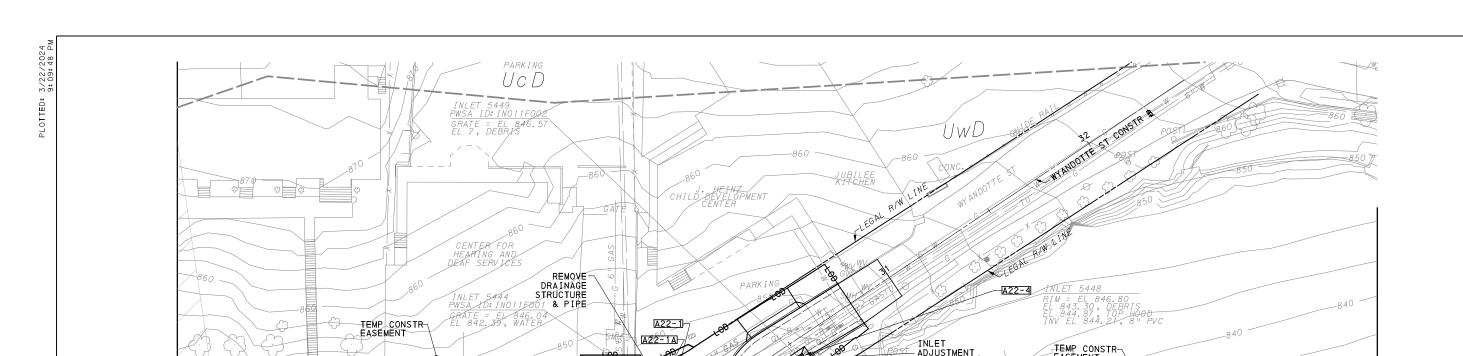



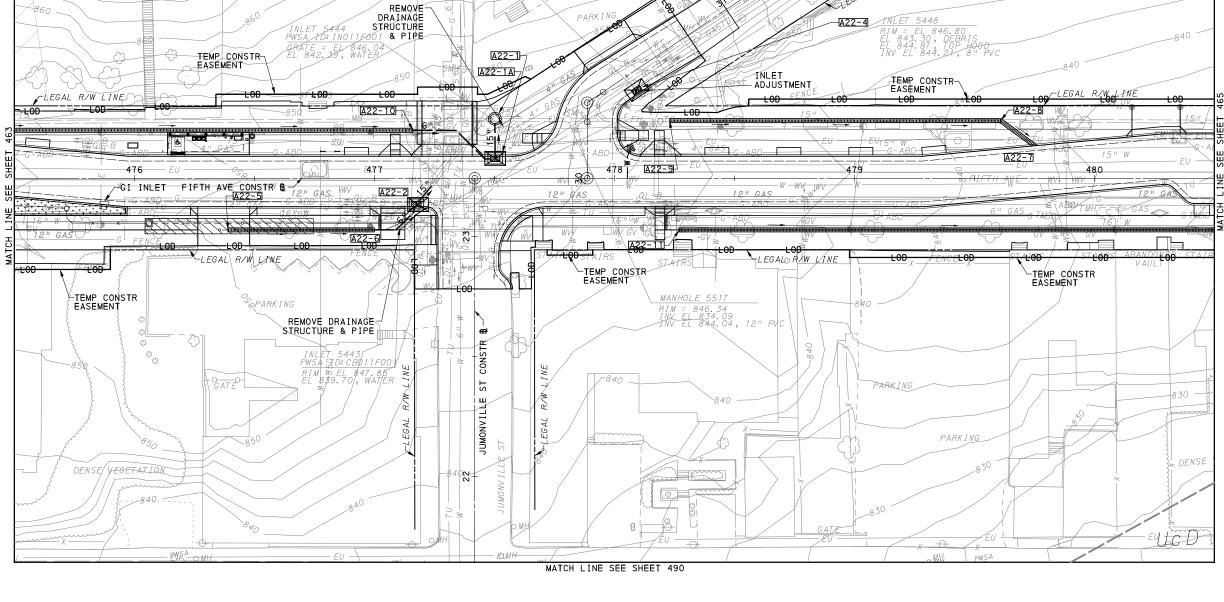

**LEGEND** 

——12"—— COMPOST DIVERSION SOCK (SIZE AS NOTED)

\_\_\_12"\_\_\_ COMPOST FILTER SOCK (SIZE AS NOTED)

RCE-1

ROCK CONSTRUCTION ENTRANCE

INLET SEDIMENT PROTECTION -- SOIL BOUNDARY

UFB SOIL UNIT NAME

EXISTING CONTOUR MINOR

EXISTING CONTOUR MAJOR

GI STORAGE TRENCH

GI BIORETENTION OR BIOSWALE

DRAINAGE STRUCTURE 

FOR ROADWAY PLAN SEE SHEET 365

**AECOM** 

707 Grant Street 5th Floor Pittsburgh, PA 15219 NO. DATE DESCRIPTION REVISIONS

THE PREPARATION OF THIS
DOCUMENT HAS BEEN FINANCED IN
PART THROUGH A GRANT FROM THE
FEDERAL TRANSIT ADMINISTRATION, PEDERAL TRANSIT ADMINISTRATION,
U.S. DEPARTMENT OF
TRANSPORTATION, UNDER THE
URBAN MASS TRANSPORTATION ACT
OF 1964, AS AMENDED, FOR THE
PORT AUTHORITY OF ALLEGHENY
COUNTY, PENNSYLVANIA.

40 FEET

(NOT FOR CONSTRUCTION)


ESIGNED	<u>JMS</u>	
RAWN	<u>JMS</u>	
HECKED	DJC	
CHARGE	LAR	
ATE	05/01/24	
CALE		
	AS SHOWN	


PORT AUTHORITY OF ALLEGHENY COUNTY


BUS RAPID TRANSIT UPTOWN TO OAKLAND EROSION & SEDIMENTATION CONTROL PLANS FIFTH AVE - STA 475+50 TO STA 480+50


Port Authority connecting people to life


CONTRACT NO. BRT-001 DWG. NO. ES20

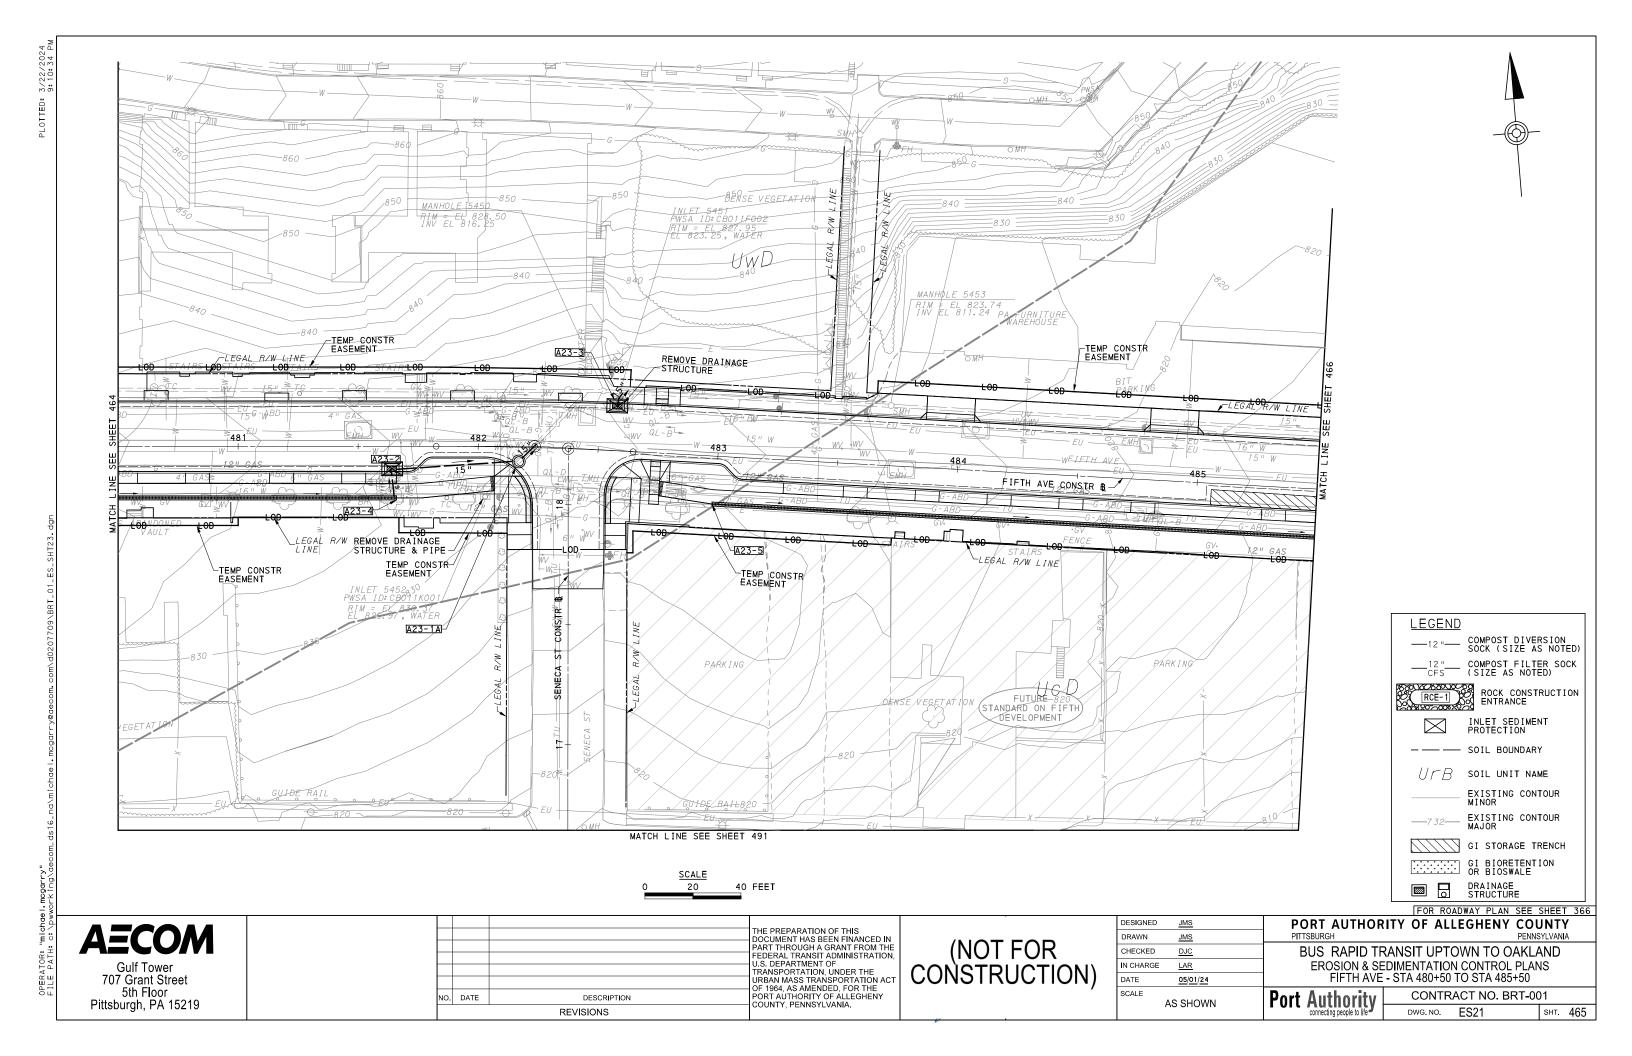


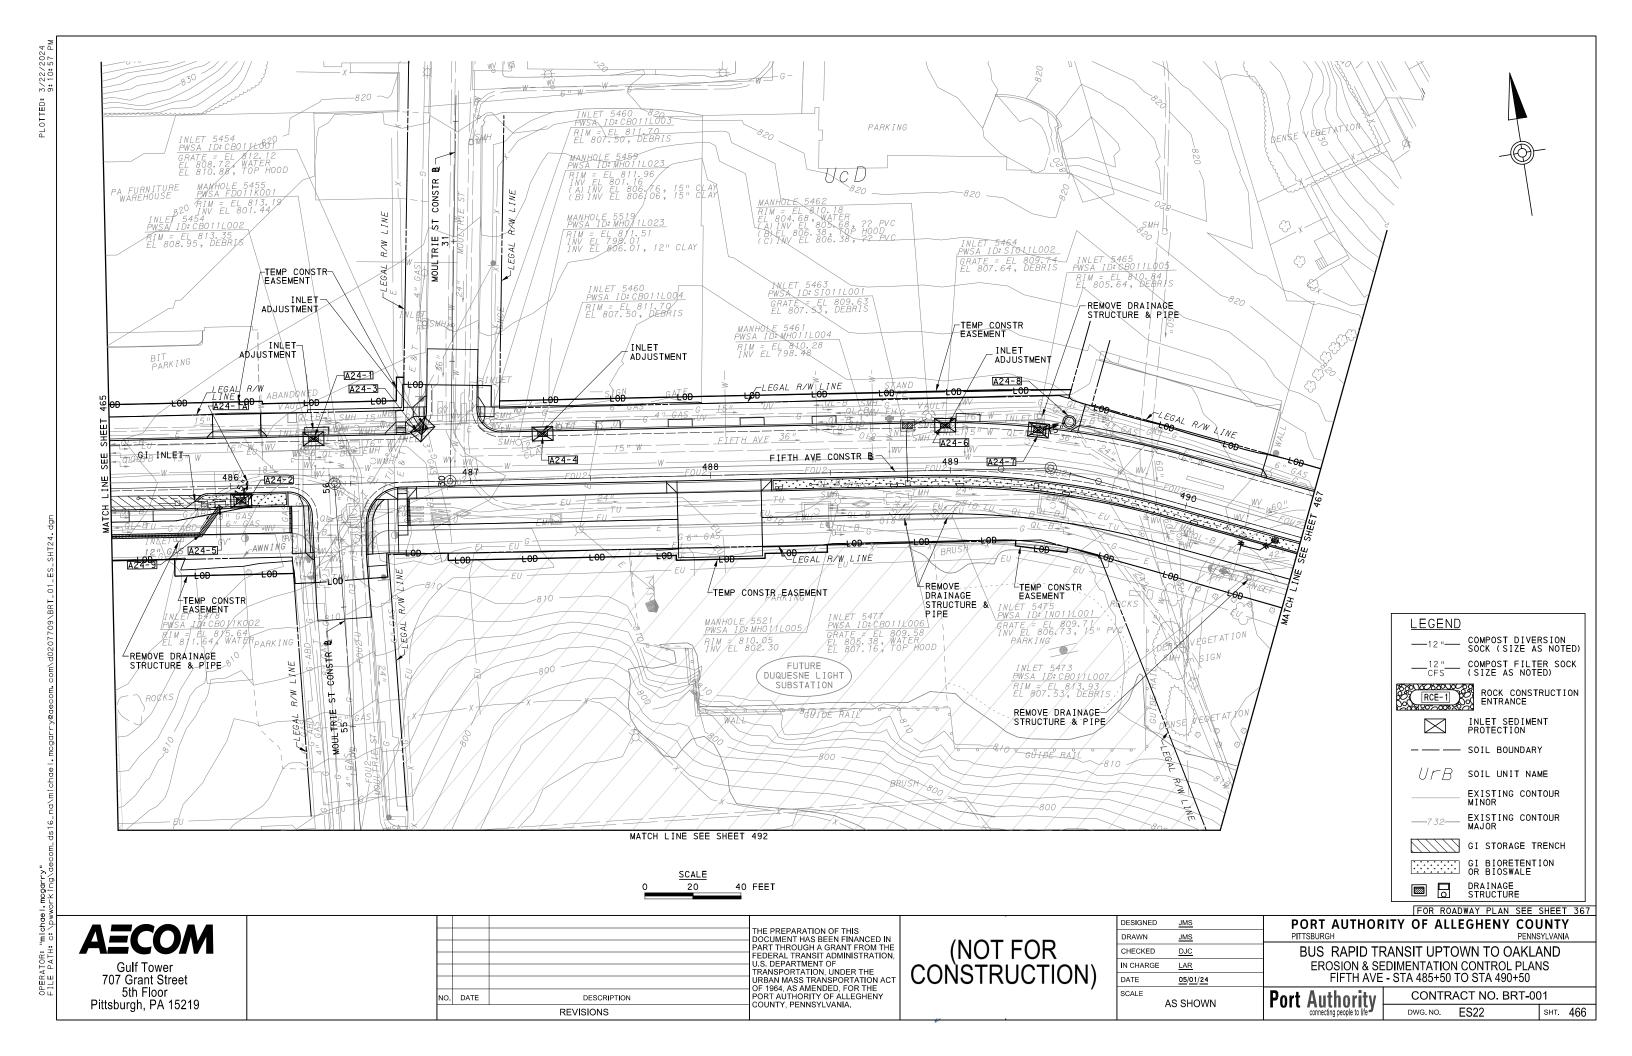


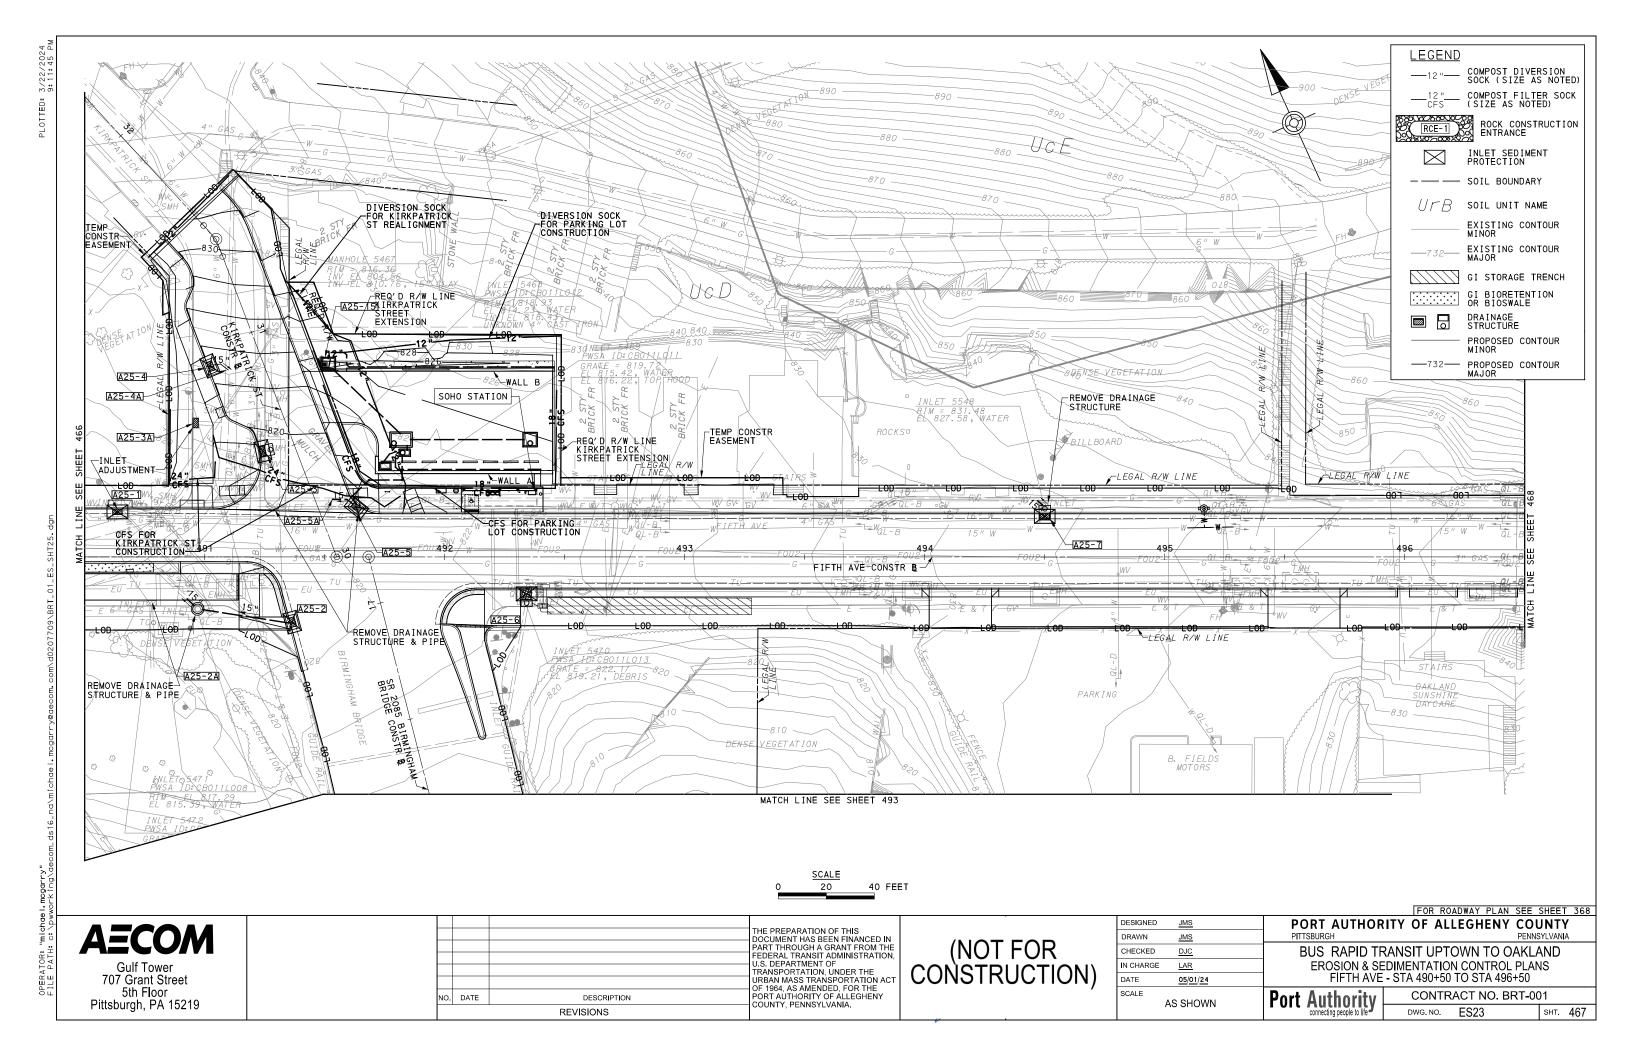


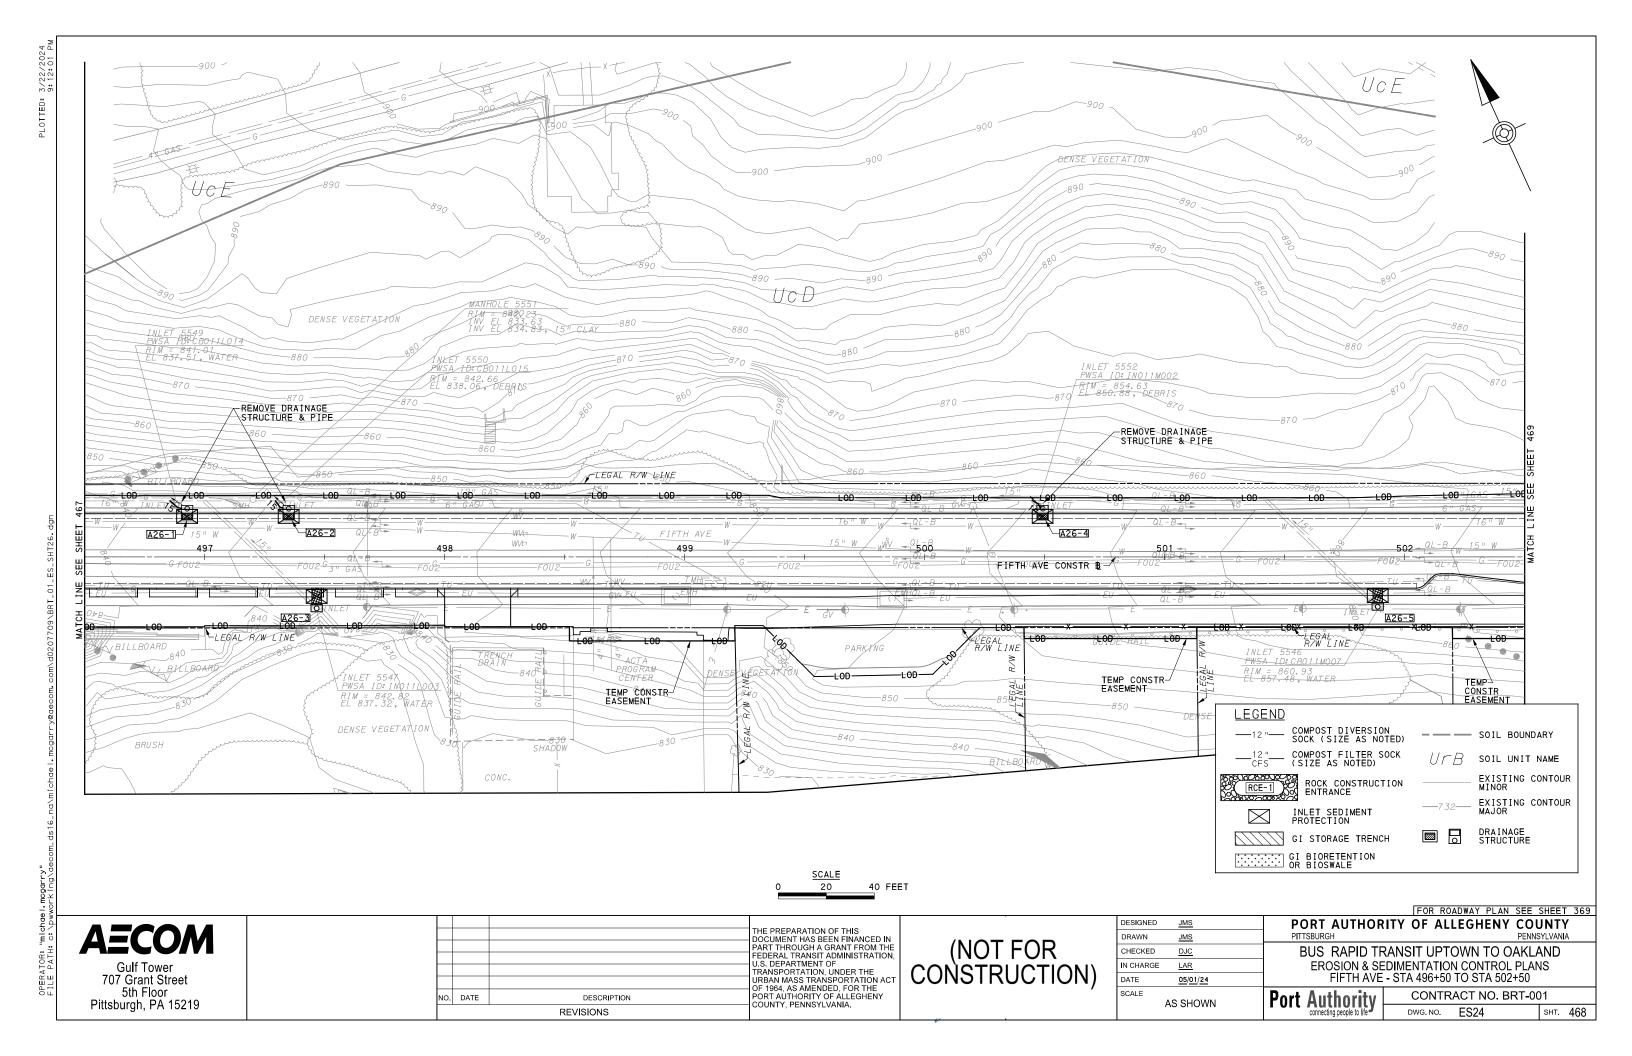


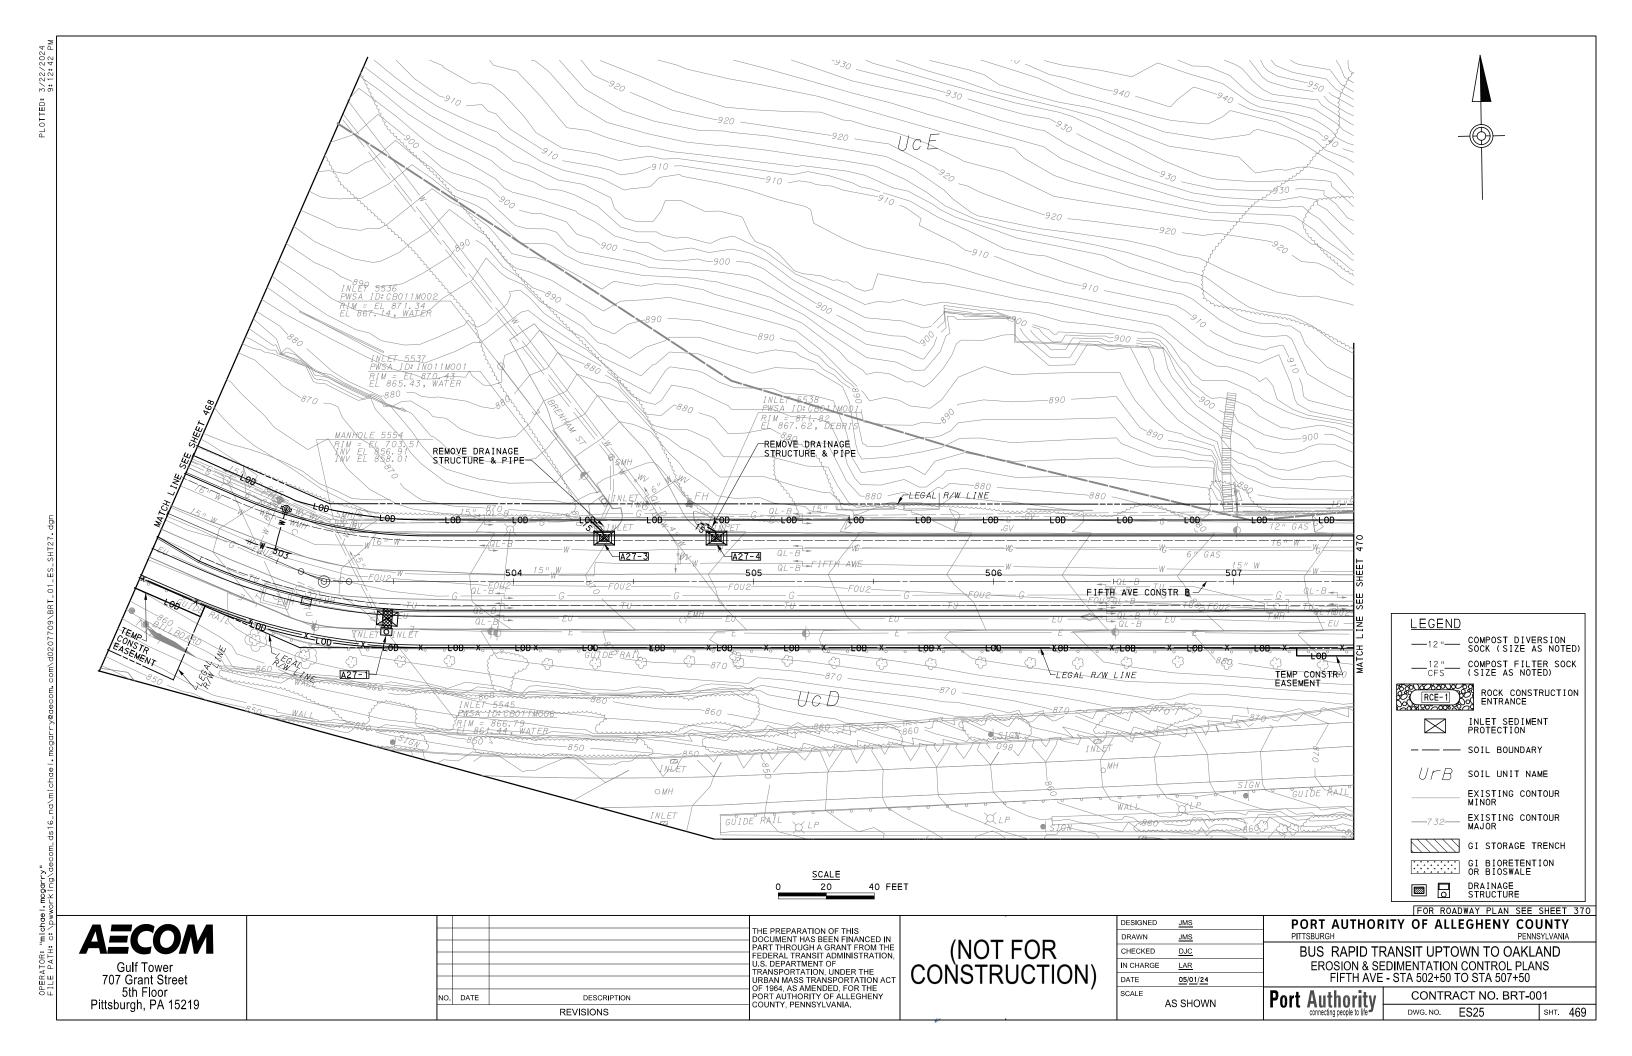


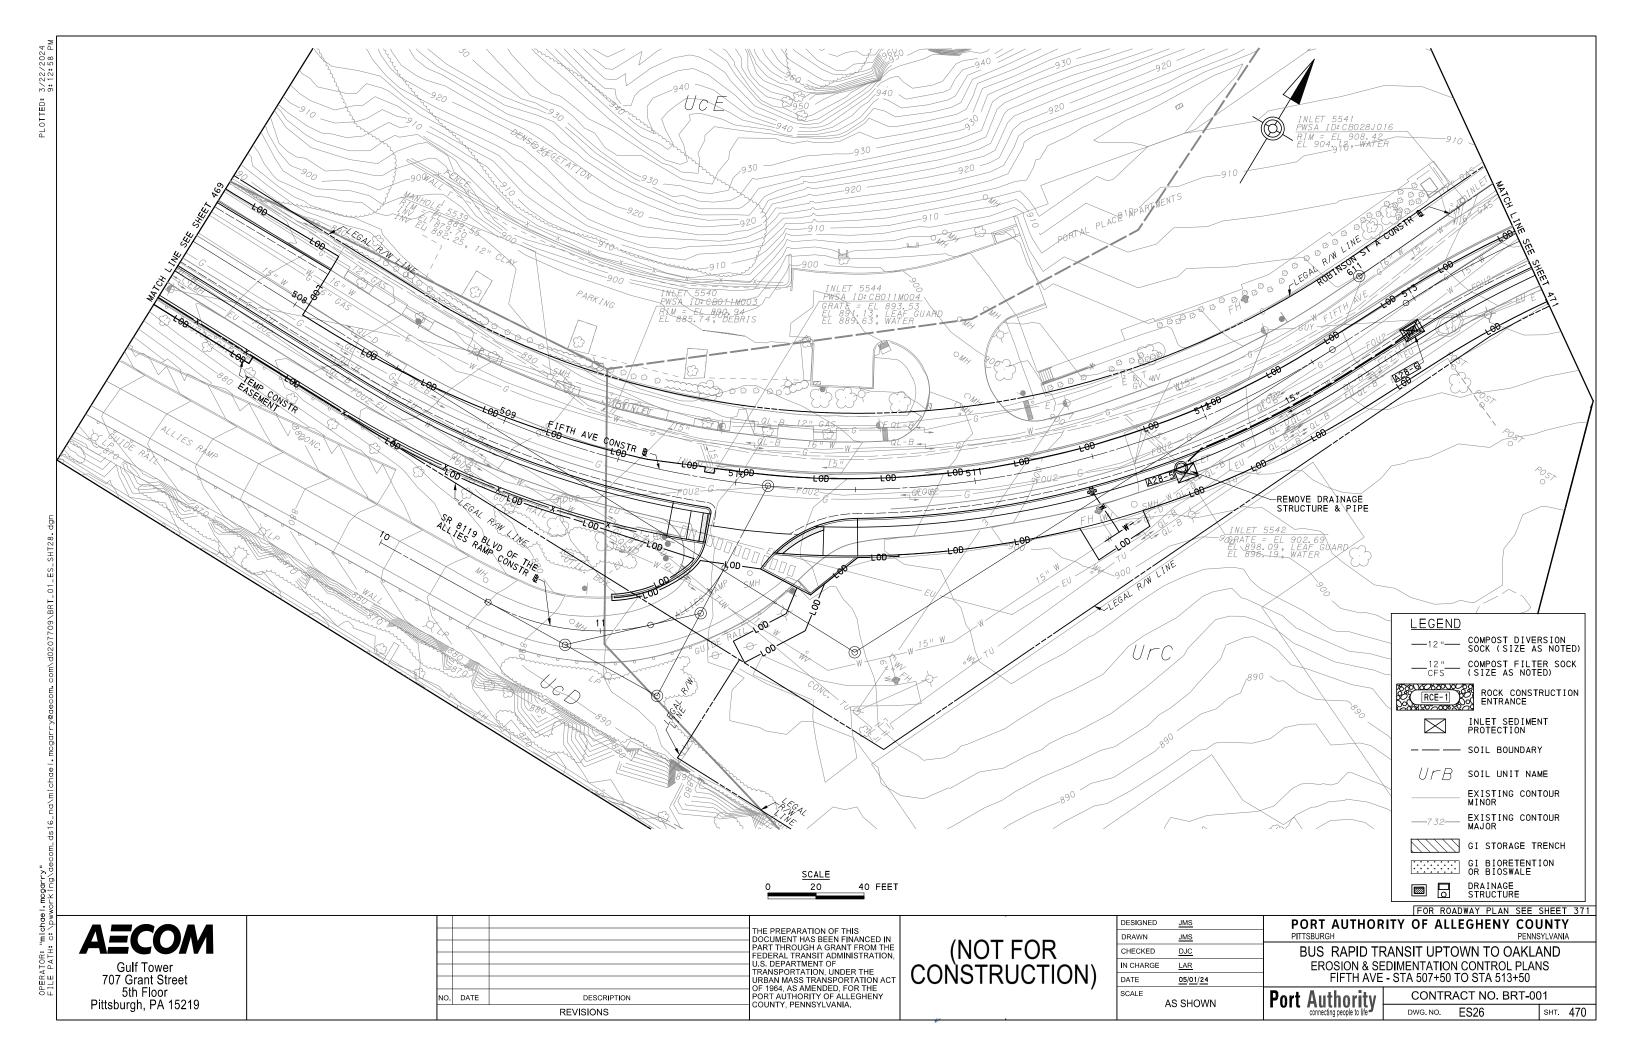


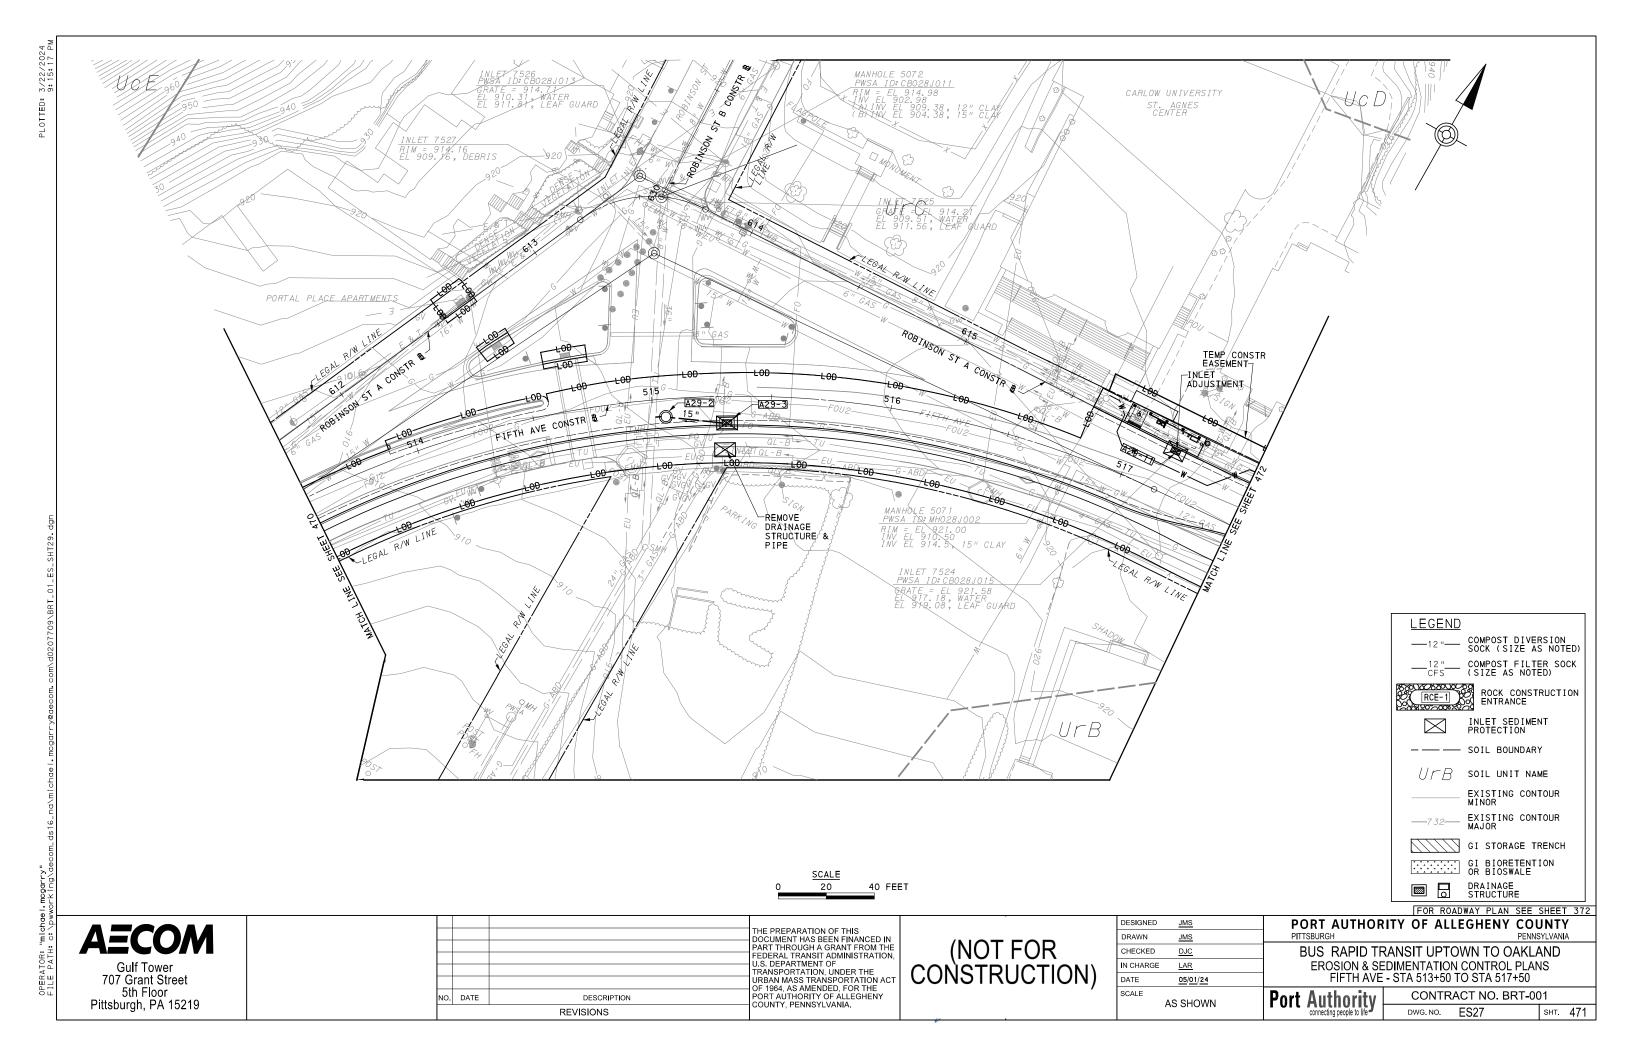


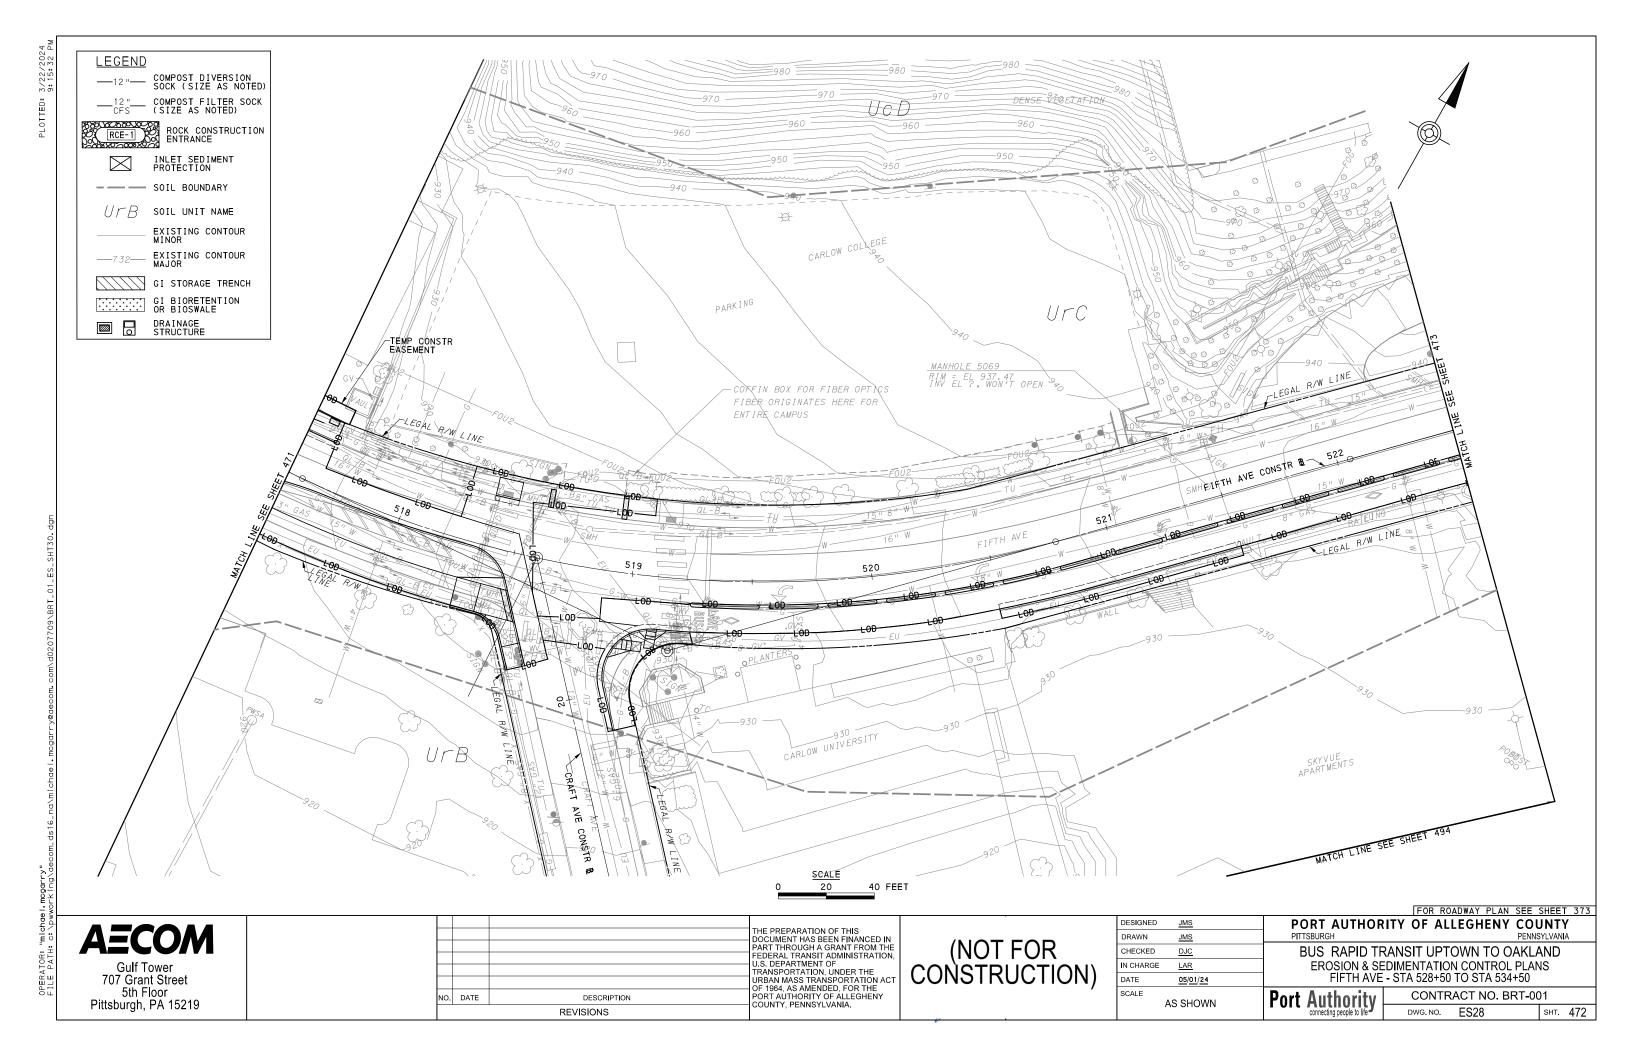


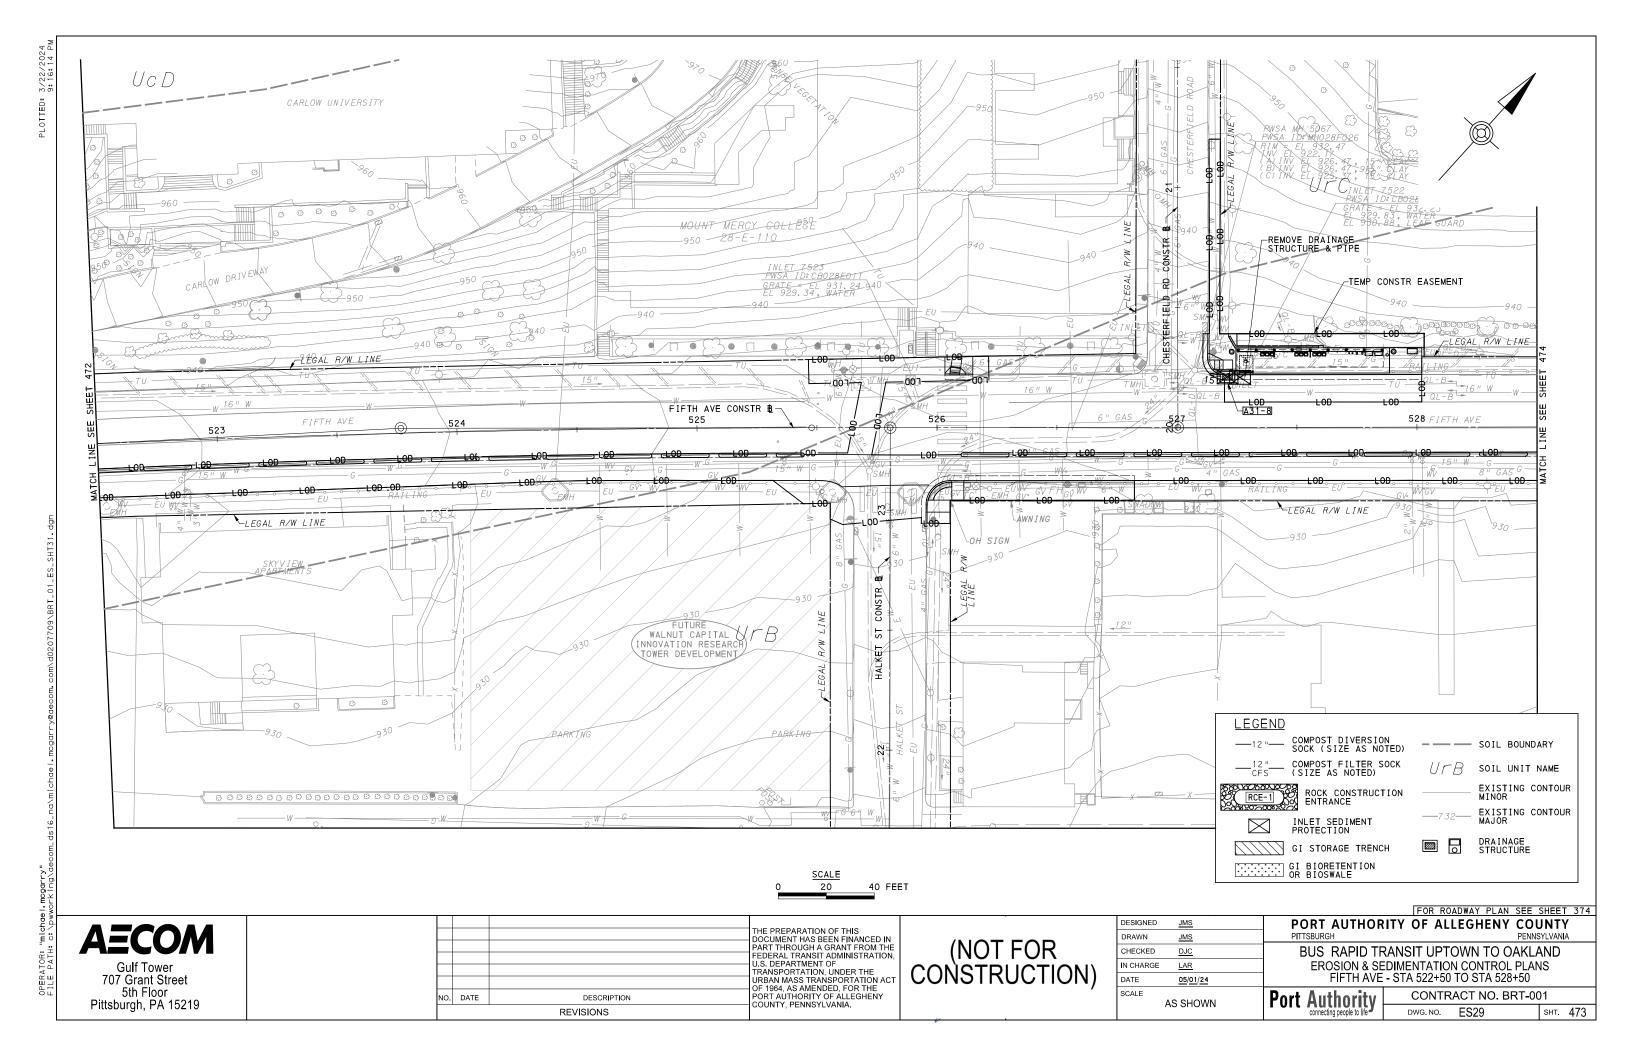


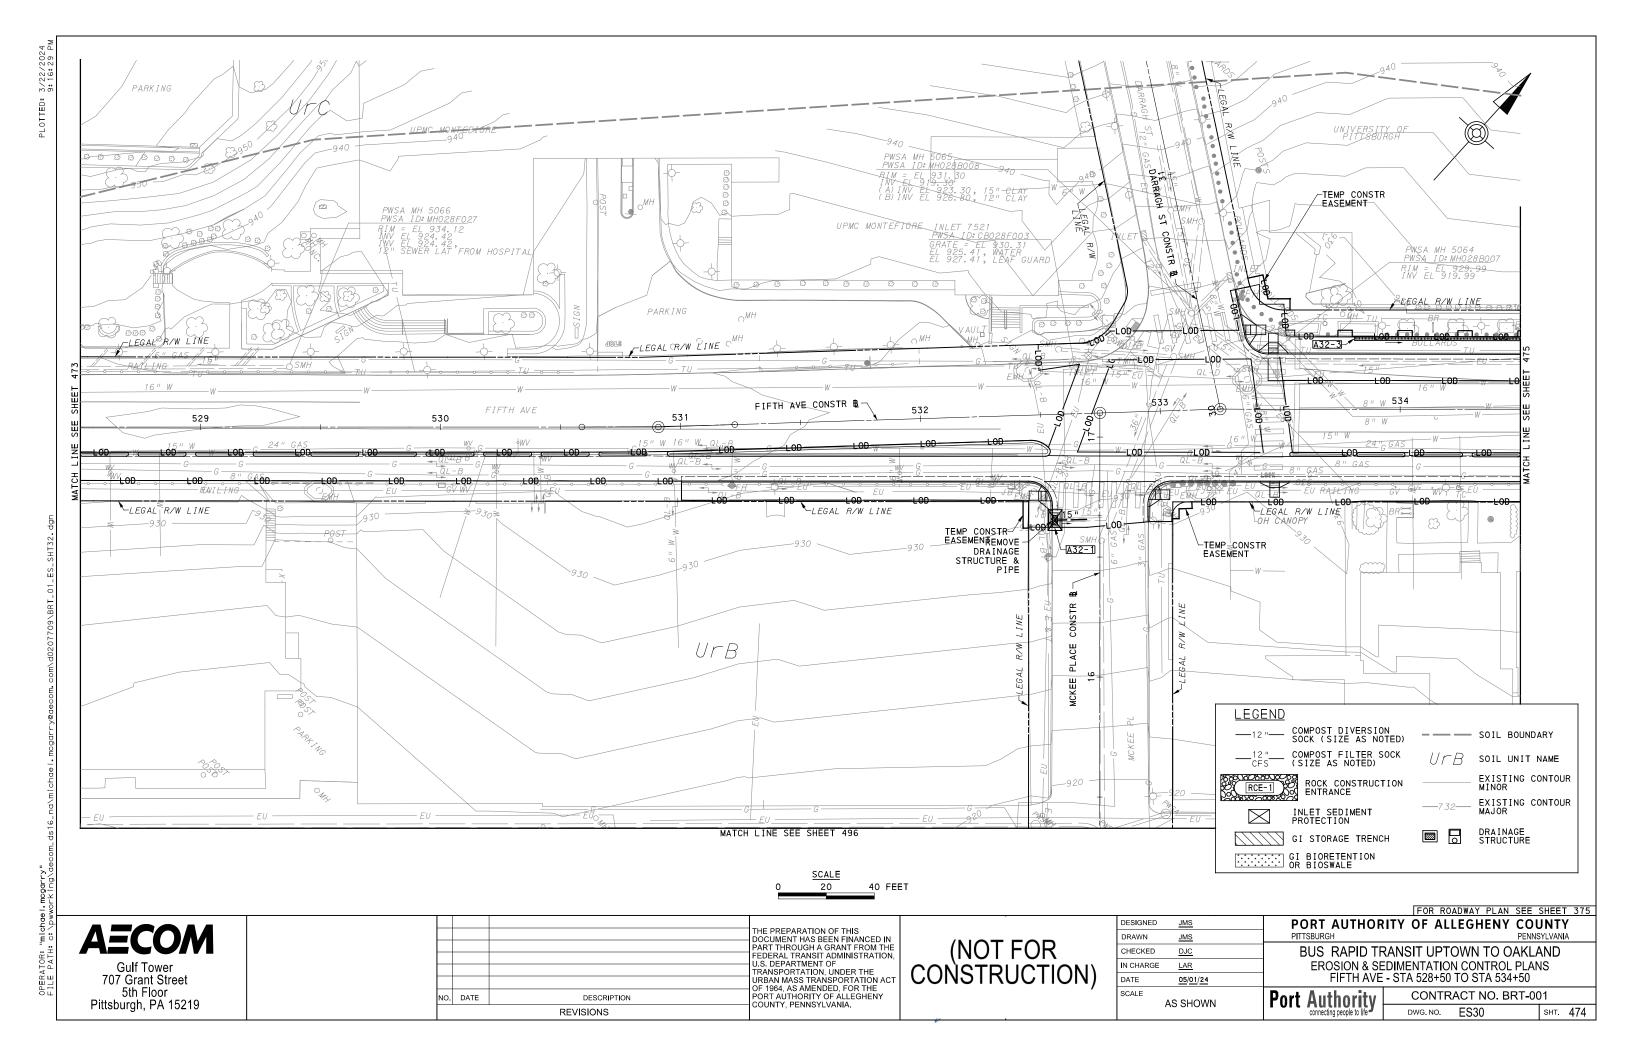


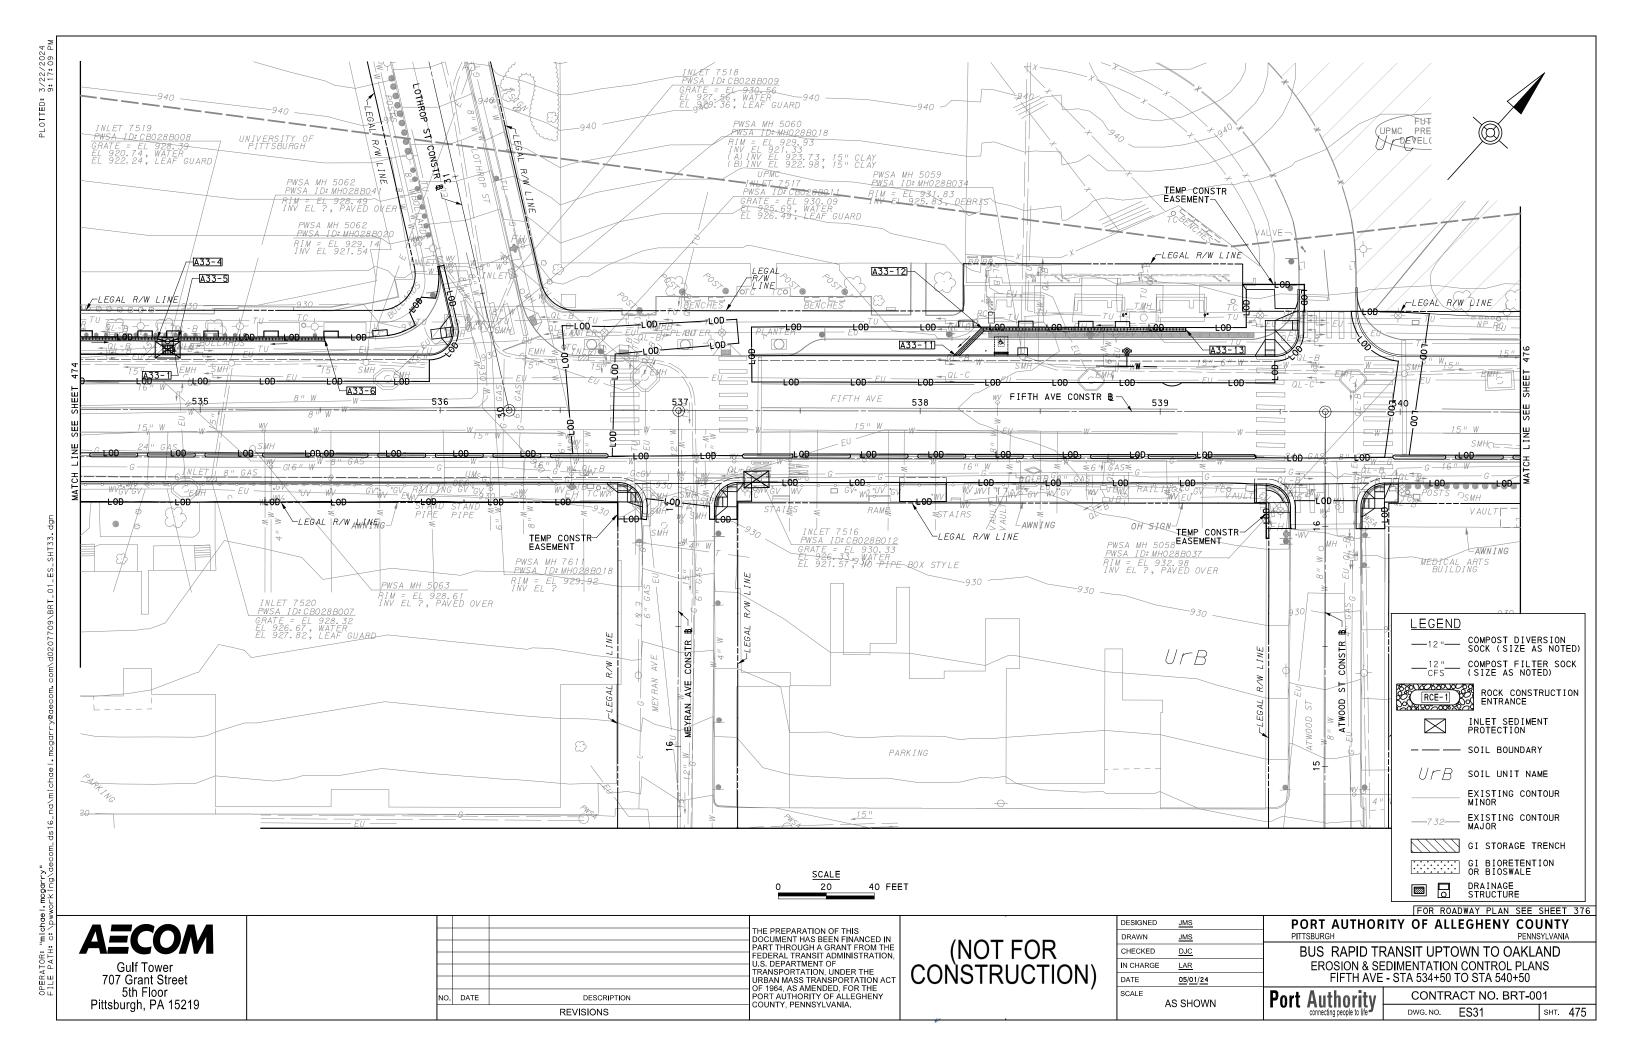

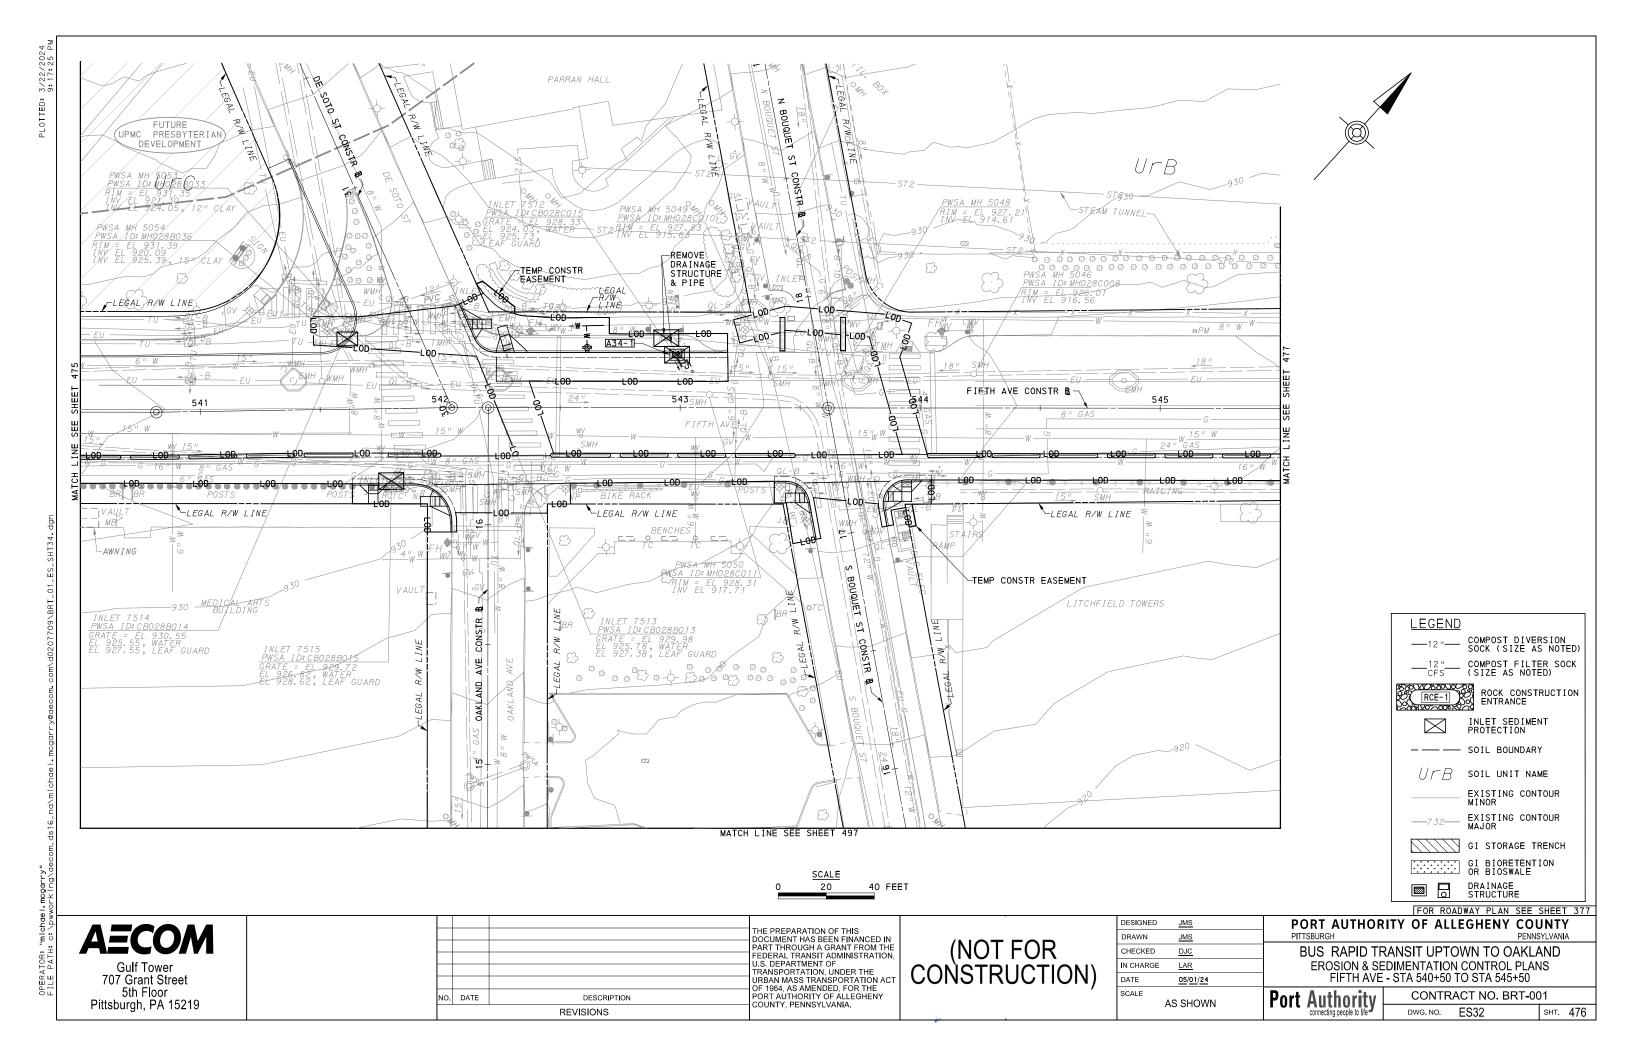

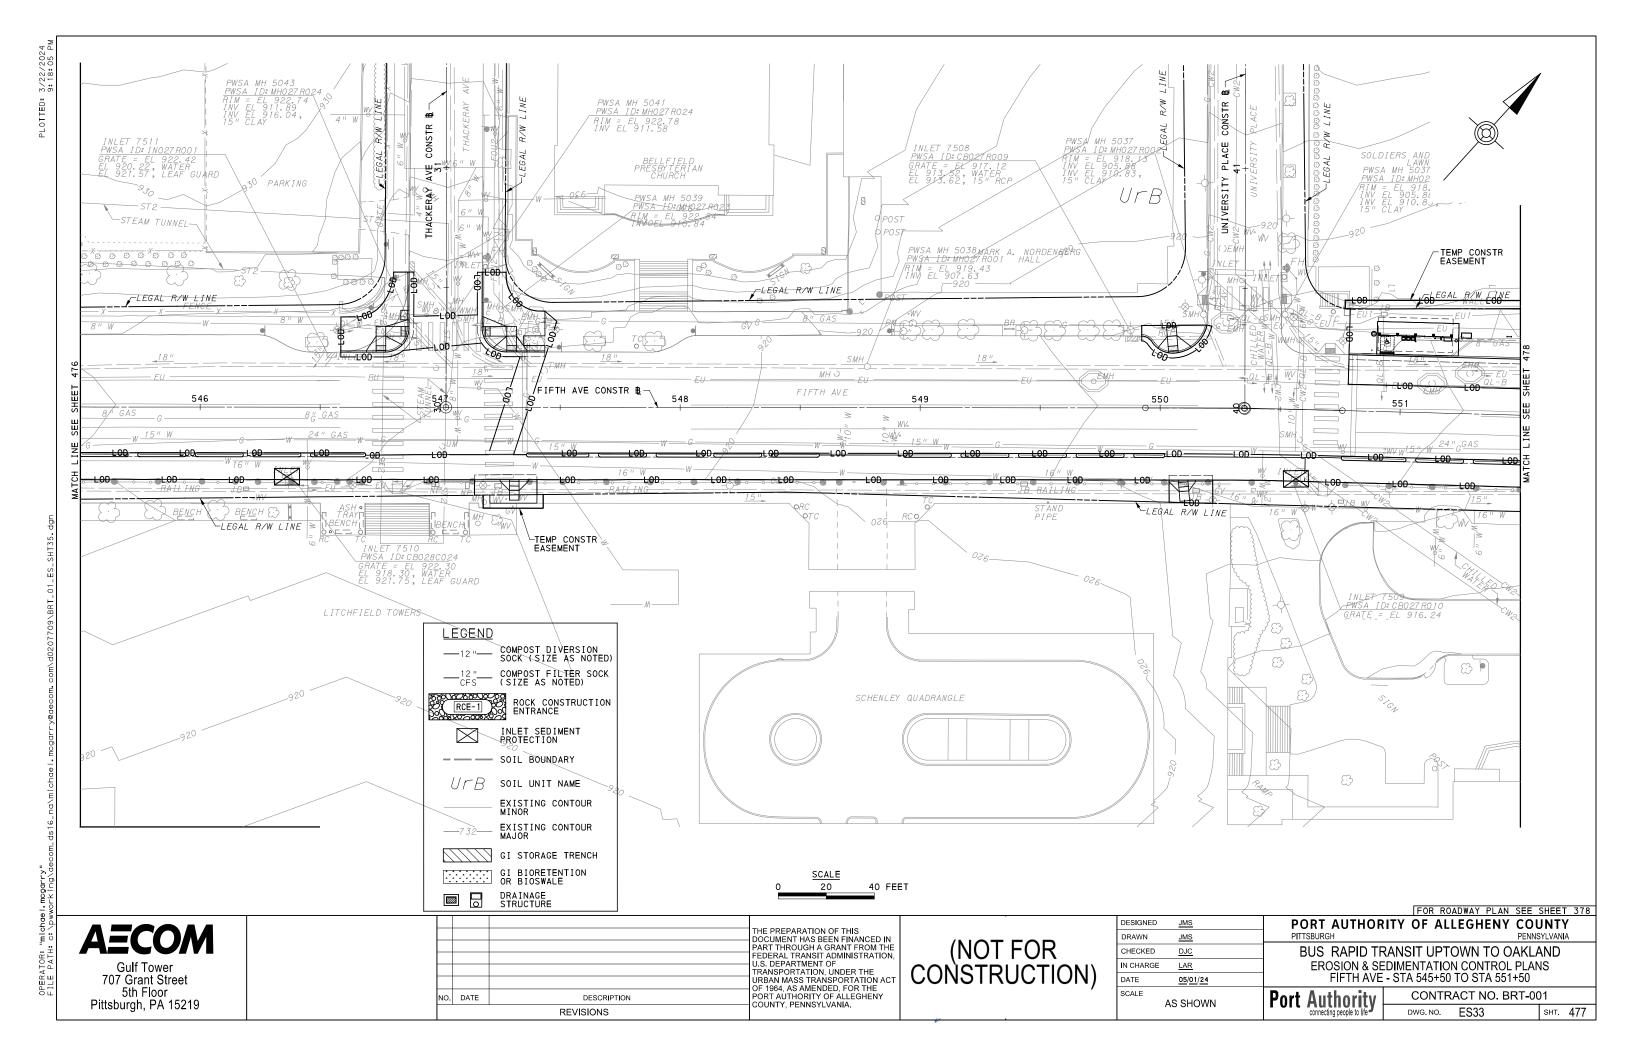

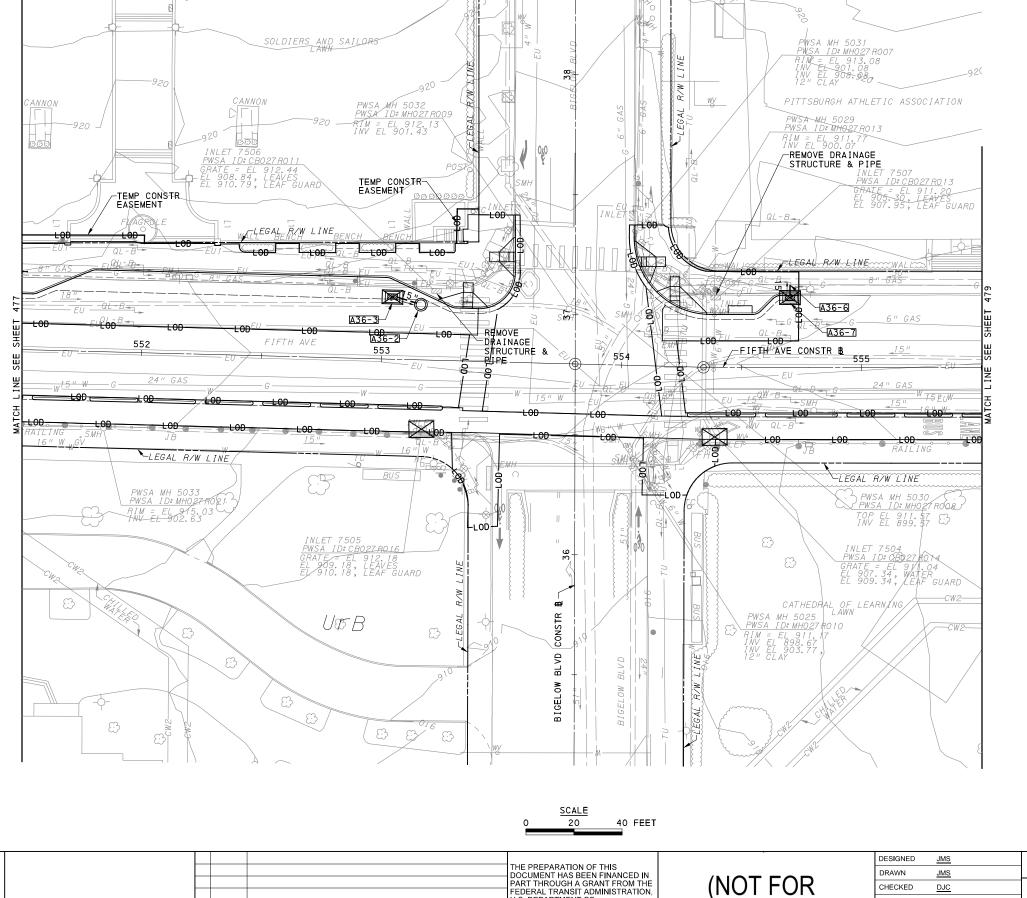

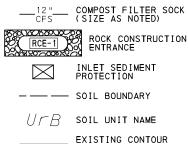

\_\_\_\_12 "\_\_\_ COMPOST DIVERSION SOCK (SIZE AS NOTED)

EXISTING CONTOUR MINOR

EXISTING CONTOUR

GI STORAGE TRENCH

DRAINAGE STRUCTURE 

**AECOM** 

707 Grant Street 5th Floor Pittsburgh, PA 15219

PEDERAL TRANSIT ADMINISTRATION,
U.S. DEPARTMENT OF
TRANSPORTATION, UNDER THE
URBAN MASS TRANSPORTATION ACT
OF 1964, AS AMENDED, FOR THE
PORT AUTHORITY OF ALLEGHENY
COUNTY, PENNSYLVANIA. NO. DATE DESCRIPTION REVISIONS

(NOT FOR CONSTRUCTION)


DESIGNED	<u>JMS</u>	
DRAWN	<u>JMS</u>	
CHECKED	DJC	
IN CHARGE	LAR	
DATE	05/01/24	
SCALE		
	AS SHOWN	


## FOR ROADWAY PLAN SEE SHEET 379 PORT AUTHORITY OF ALLEGHENY COUNTY

BUS RAPID TRANSIT UPTOWN TO OAKLAND EROSION & SEDIMENTATION CONTROL PLANS FIFTH AVE - STA 551+50 TO STA 555+50

**LEGEND** 

Port Authority connecting people to life	CONTRACT NO. BRT-001			
	DWG. NO.	ES34	SHT.	478

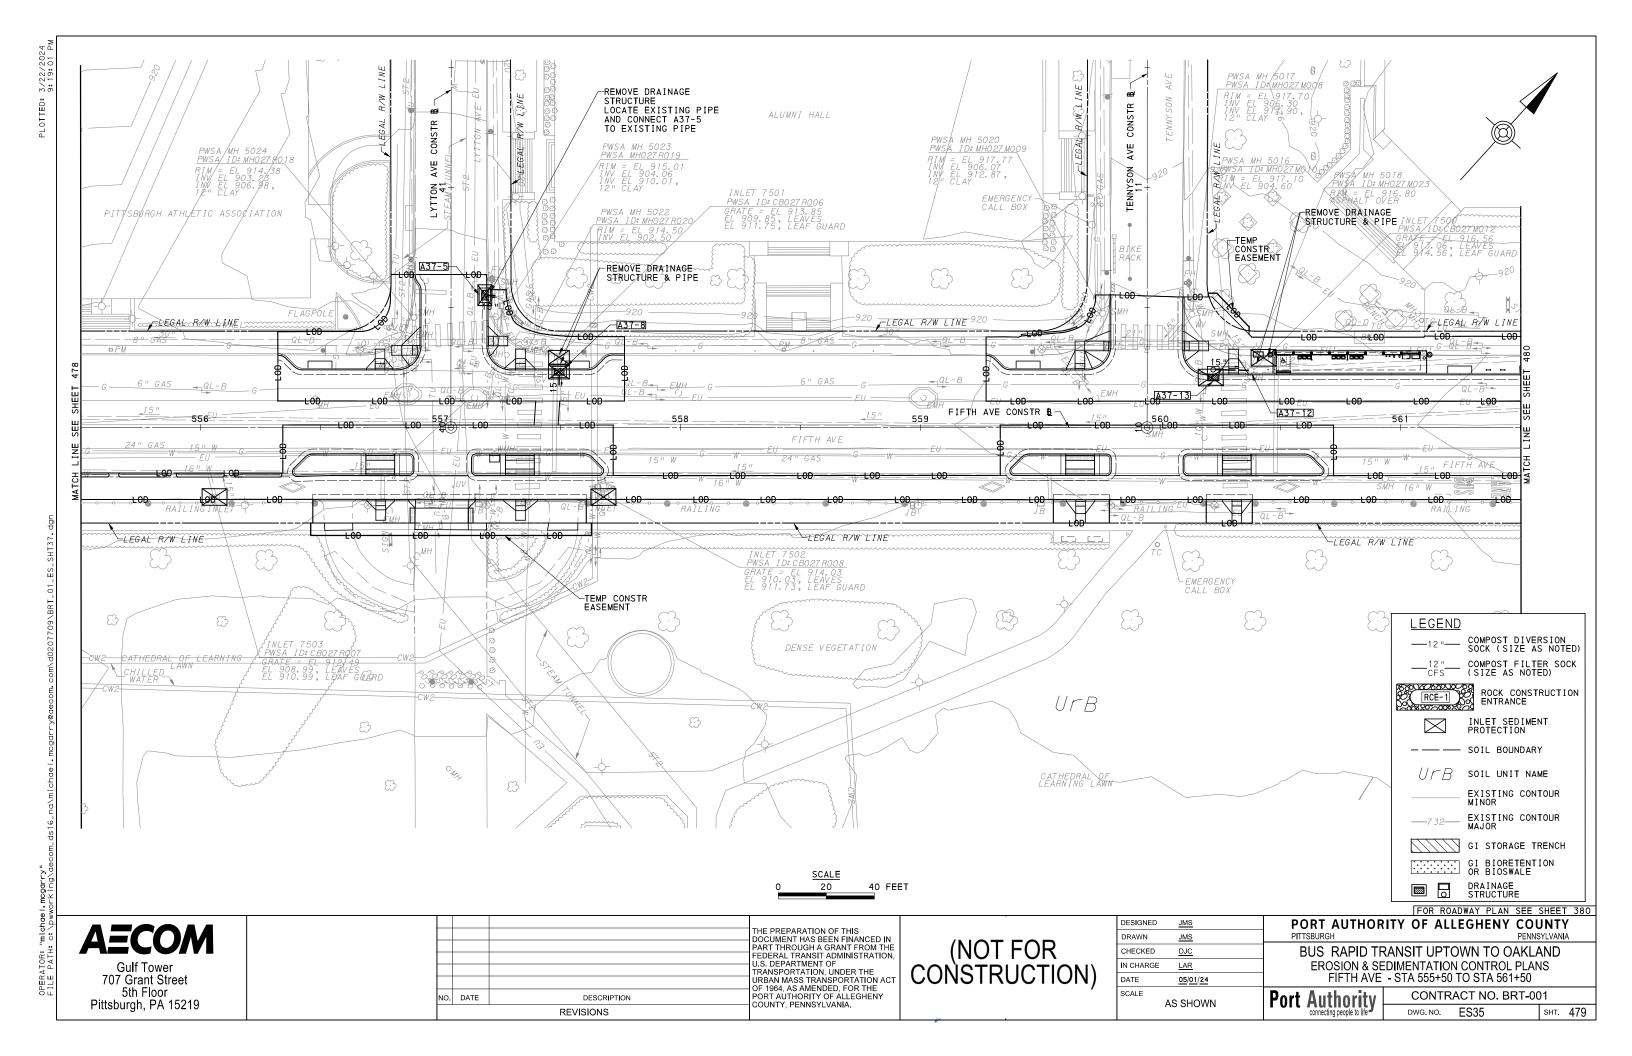

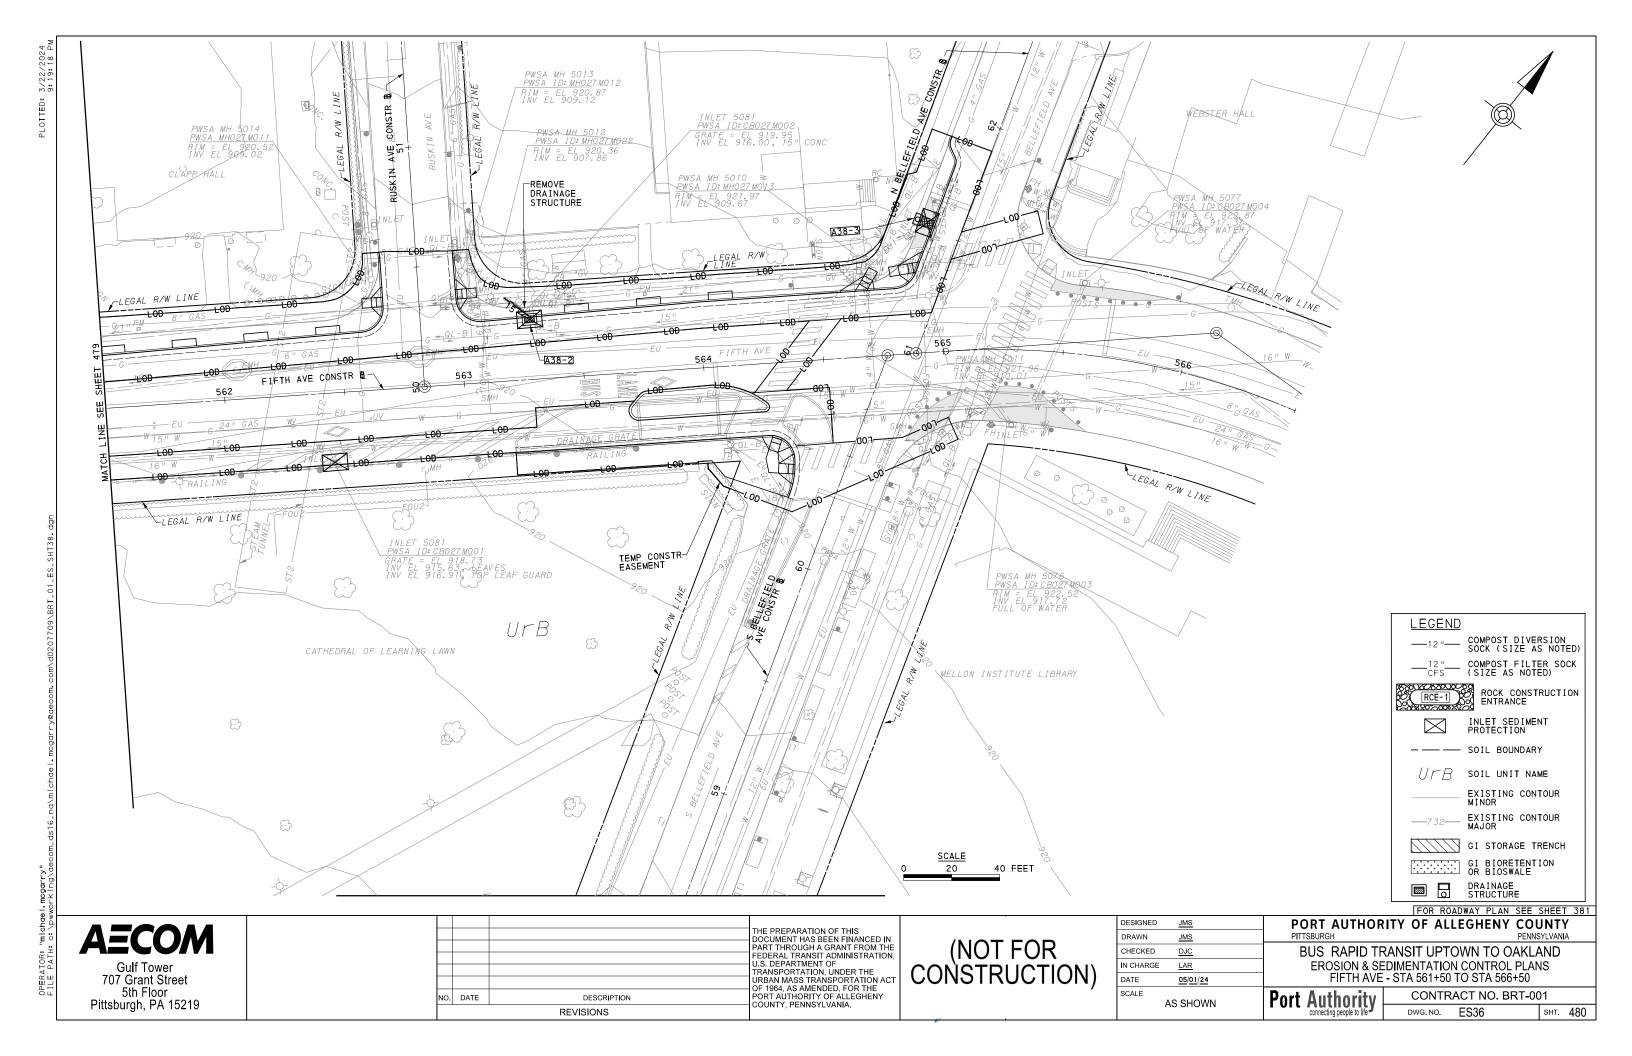

Gulf Tower 707 Grant Street 5th Floor Pittsburgh, PA 15219 Foster Plaza 8 Suite 400 730 Holiday Drive Pittsburgh, PA. 15220

NO. DATE


PEDERAL TRANSIT ADMINISTRATION,
U.S. DEPARTMENT OF
TRANSPORTATION, UNDER THE
URBAN MASS TRANSPORTATION ACT
OF 1964, AS AMENDED, FOR THE
PORT AUTHORITY OF ALLEGHENY
COUNTY, PENNSYLVANIA. DESCRIPTION REVISIONS

(NOT FOR CONSTRUCTION)

DESIGNED	<u>KMH</u>	
DRAWN	<u>кмн</u>	
CHECKED	<u>MRK</u>	
IN CHARGE	GEC	
DATE	05/01/24	
SCALE		
	AS SHOWN	


EROSION & SEDIMENTATION CONTROL PLANS FORBES AVE - STA 117+00 TO STA 122+00

	CONTRACT NO. BRT-001			
Port Authority CONTRACT NO. BRT-00 DWG. NO. ES37	SHT.	48		

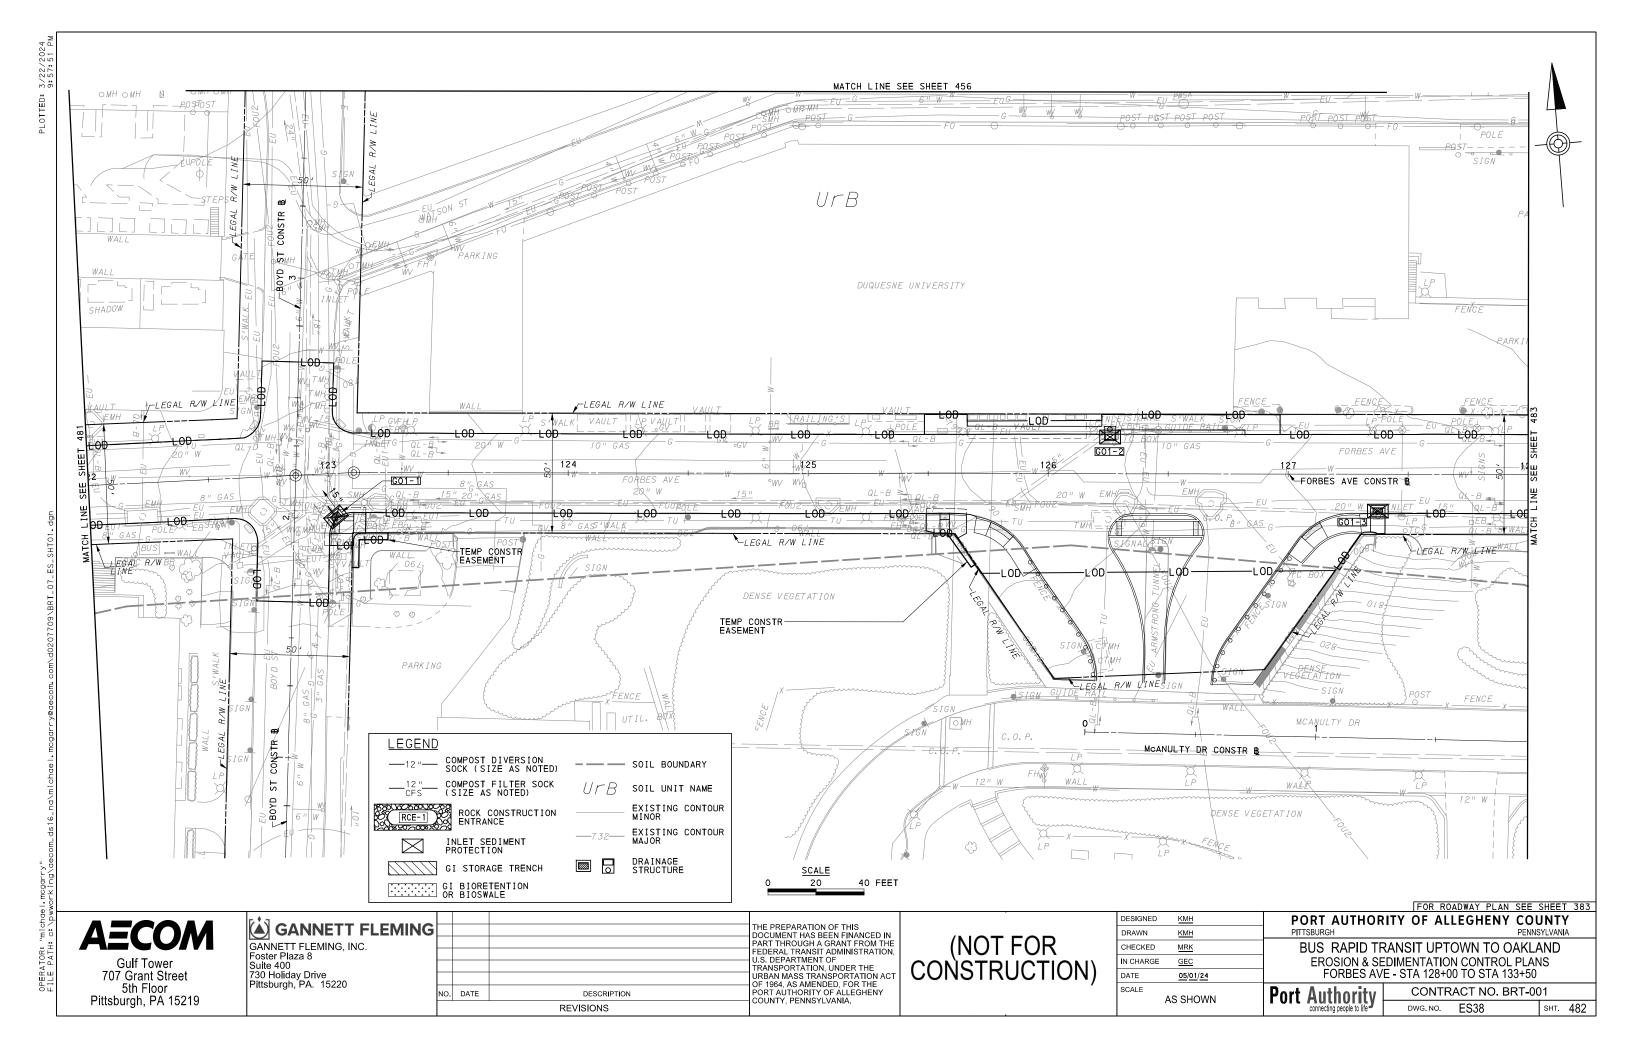



Pittsburgh, PA 15219

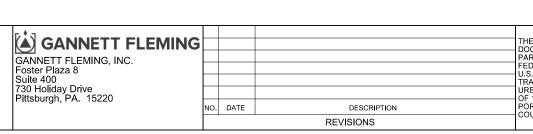


(NOT FOR CONSTRUCTION) PEDERAL TRANSIT ADMINISTRATION,
U.S. DEPARTMENT OF
TRANSPORTATION, UNDER THE
URBAN MASS TRANSPORTATION ACT
OF 1964, AS AMENDED, FOR THE
PORT AUTHORITY OF ALLEGHENY
COUNTY, PENNSYLVANIA.


<u>KMH</u> DRAWN KMH CHECKED MRK N CHARGE GEC DATE 05/01/24 SCALE AS SHOWN BUS RAPID TRANSIT UPTOWN TO OAKLAND EROSION & SEDIMENTATION CONTROL PLANS


FORBES AVE - STA 128+00 TO STA 133+50

**Port Authority** 

CONTRACT NO. BRT-001 DWG. NO. ES39 sнт. **483** 

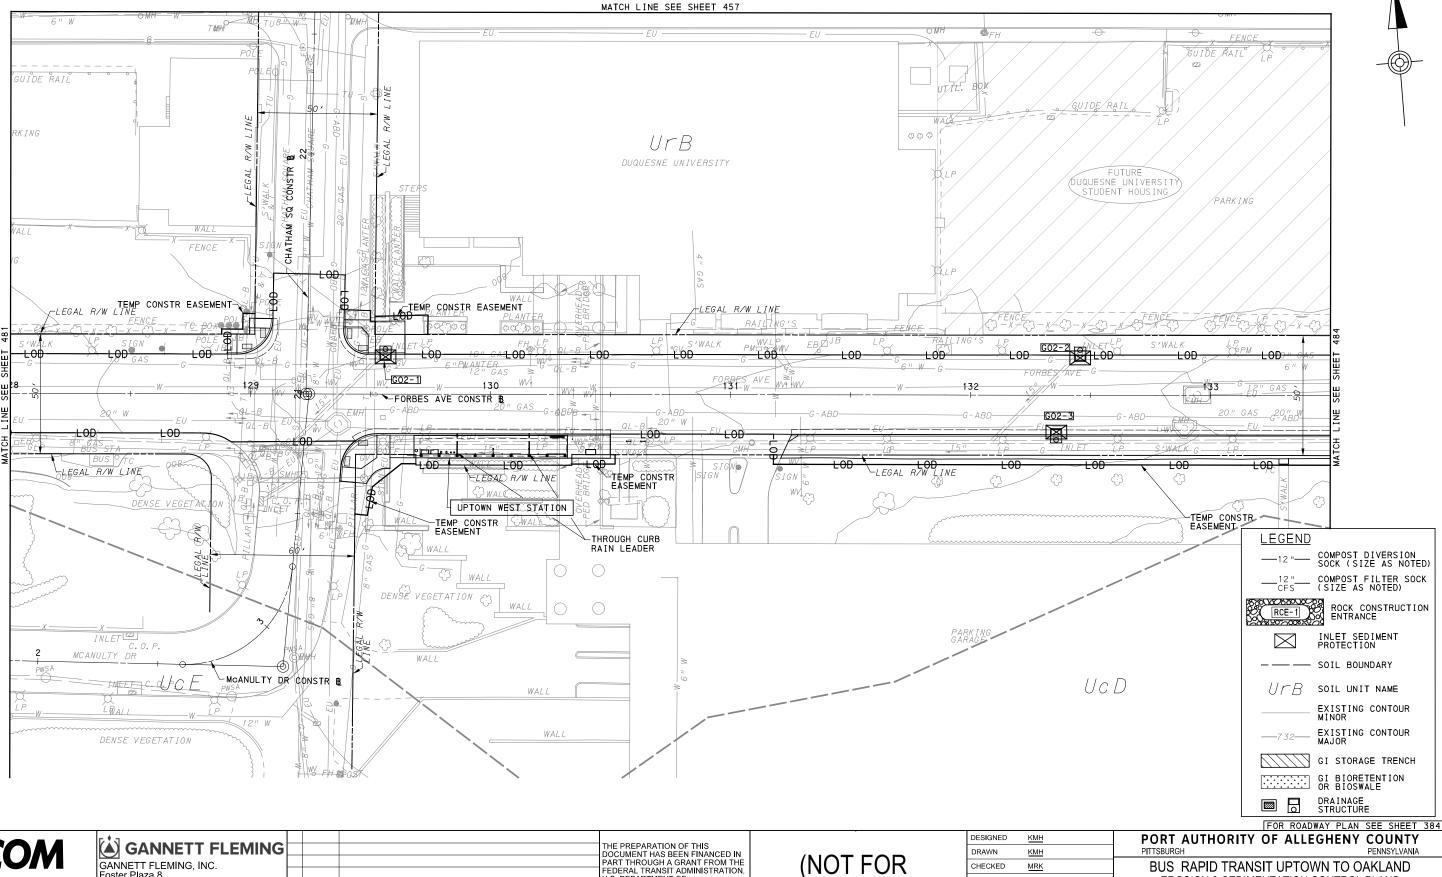

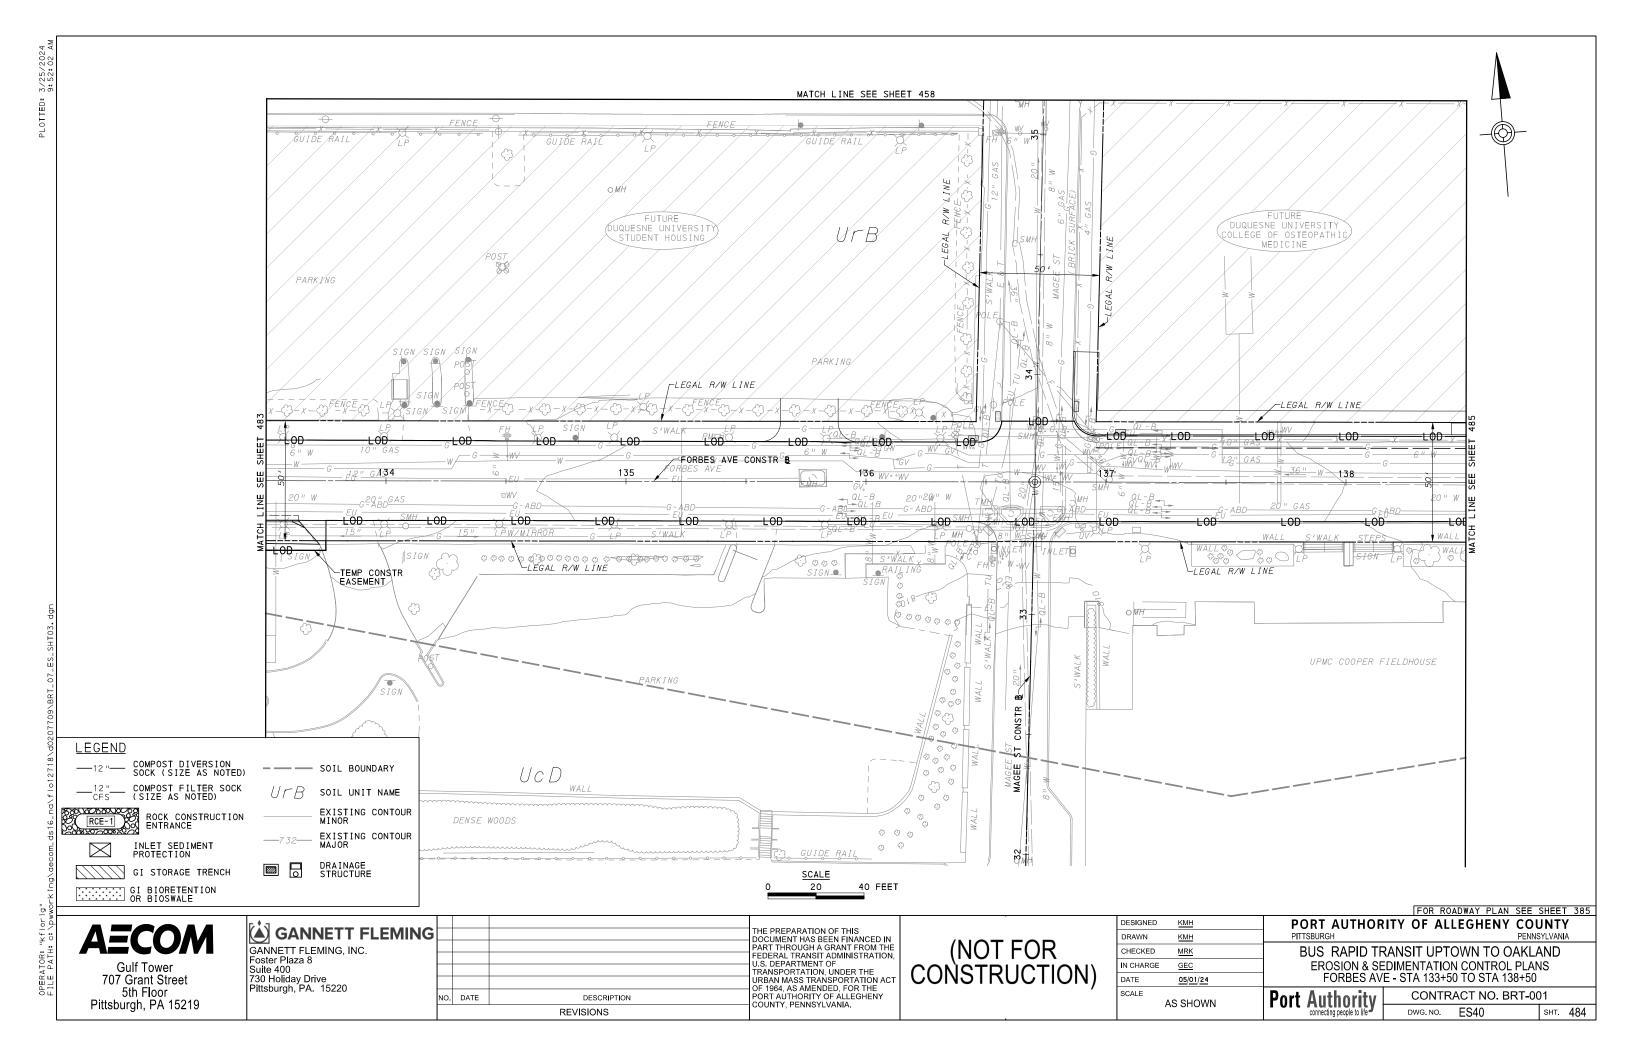

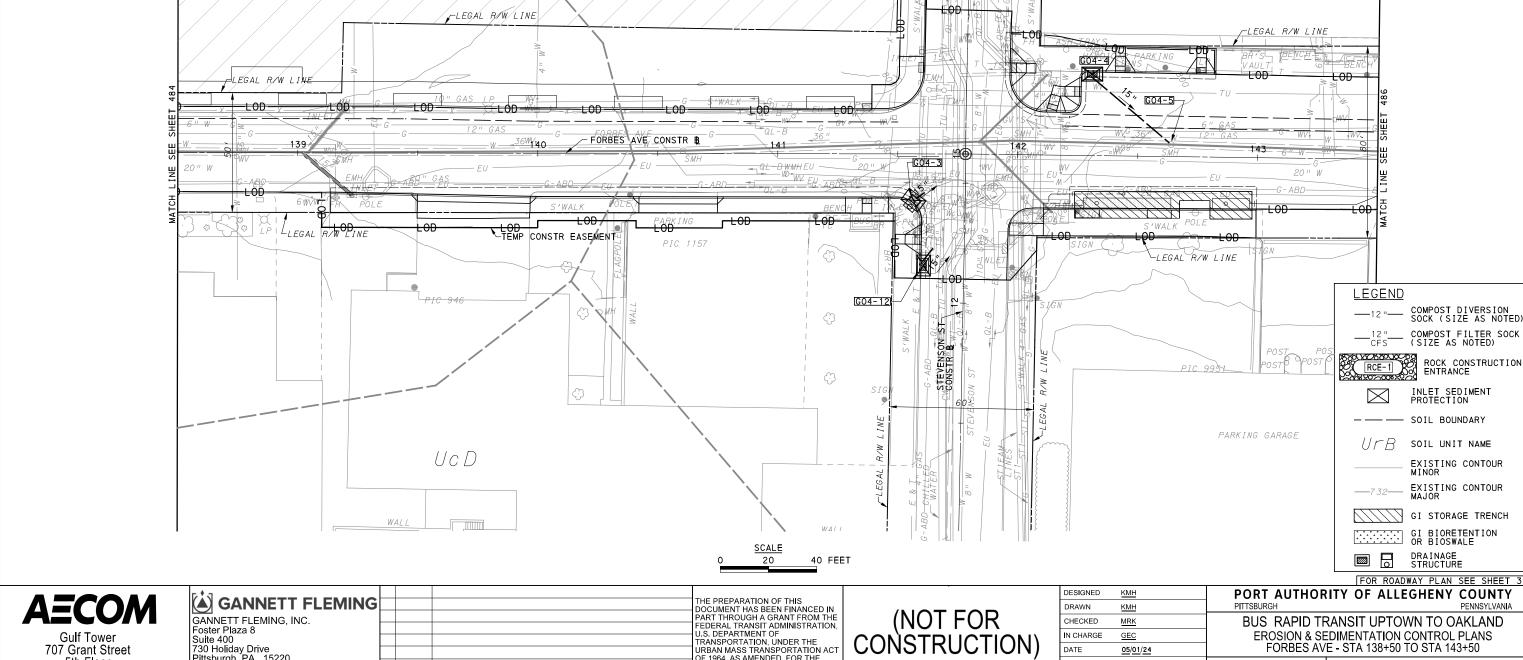

PEDERAL TRANSIT ADMINISTRATION,
U.S. DEPARTMENT OF
TRANSPORTATION, UNDER THE
URBAN MASS TRANSPORTATION ACT
OF 1964, AS AMENDED, FOR THE
PORT AUTHORITY OF ALLEGHENY
COUNTY, PENNSYLVANIA.

DUQUESNE UNIVERSITY

PIC /152

OSTEOPATHIC

MATCH LINE SEE SHEET 459

SMH

FORBES STEVENSON BUILDING

PIC 1161

ROCK CONSTRUCTION ENTRANCE

UFB SOIL UNIT NAME

DRAINAGE STRUCTURE

CONTRACT NO. BRT-001

EROSION & SEDIMENTATION CONTROL PLANS

FORBES AVE - STA 138+50 TO STA 143+50

DWG.NO. ES41

Port Authority connecting people to life

FOR ROADWAY PLAN SEE SHEET 386

sнт. 485

EXISTING CONTOUR GI STORAGE TRENCH

PIC 947

N CHARGE

DATE

SCALE

GEC

<u>05/01/24</u>

AS SHOWN

**Gulf Tower** 

707 Grant Street

5th Floor

Pittsburgh, PA 15219

Foster Plaza 8 Suite 400

730 Holiday Drive Pittsburgh, PA. 15220

NO. DATE

DESCRIPTION



707 Grant Street

5th Floor


Pittsburgh, PA 15219

730 Holiday Drive Pittsburgh, PA. 15220

NO. DATE

DESCRIPTION

REVISIONS

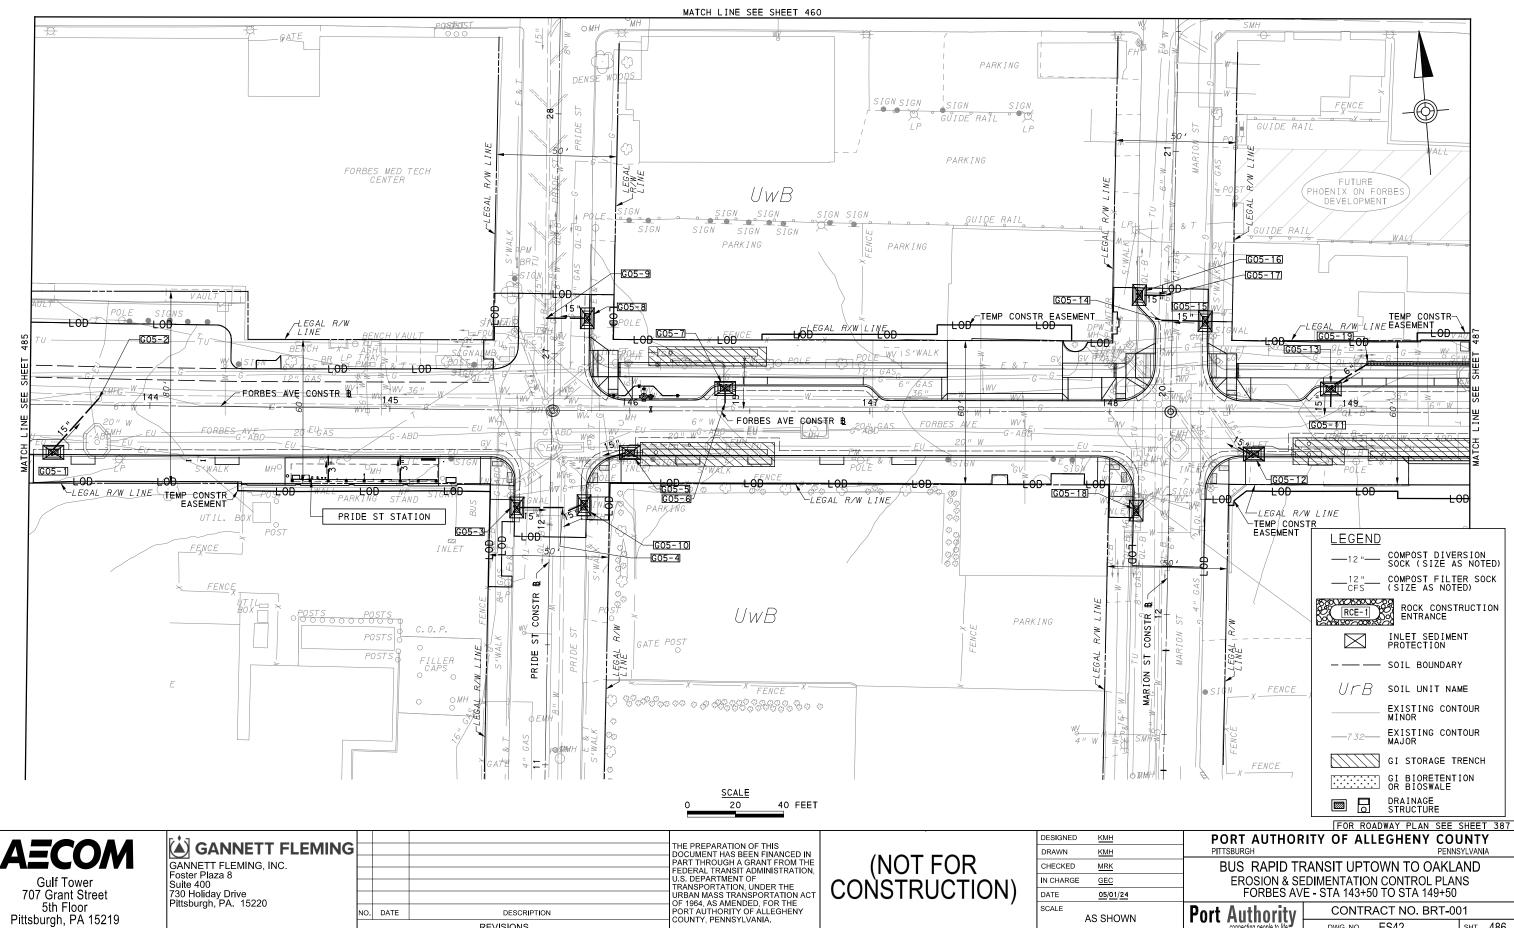

GEC

05/01/24

AS SHOWN

DATE

SCALE

FORBES AVE - STA 143+50 TO STA 149+50


DWG. NO.

**Port Authority** 

CONTRACT NO. BRT-001

sнт. 486

ES42

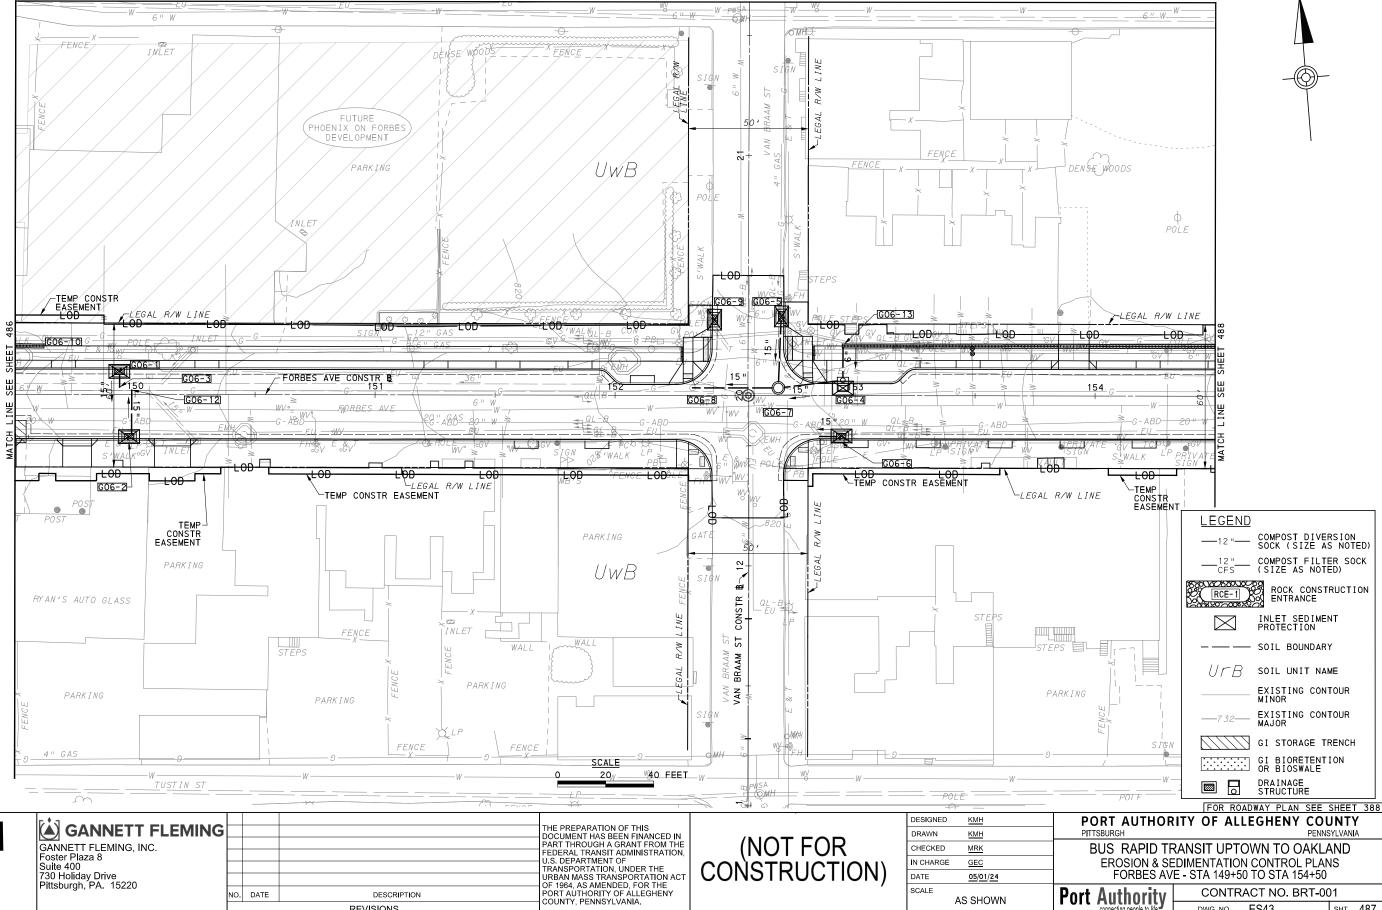

FORBES AVE - STA 149+50 TO STA 154+50

DWG. NO. ES43

CONTRACT NO. BRT-001

sнт. 487

Port Authority connecting people to life

DATE

SCALE

05/01/24

AS SHOWN

MATCH LINE SEE SHEET 461


**AECOM** 

Gulf Tower 707 Grant Street 5th Floor Pittsburgh, PA 15219

Foster Plaza 8 Suite 400 730 Holiday Drive Pittsburgh, PA. 15220

NO. DATE

DESCRIPTION

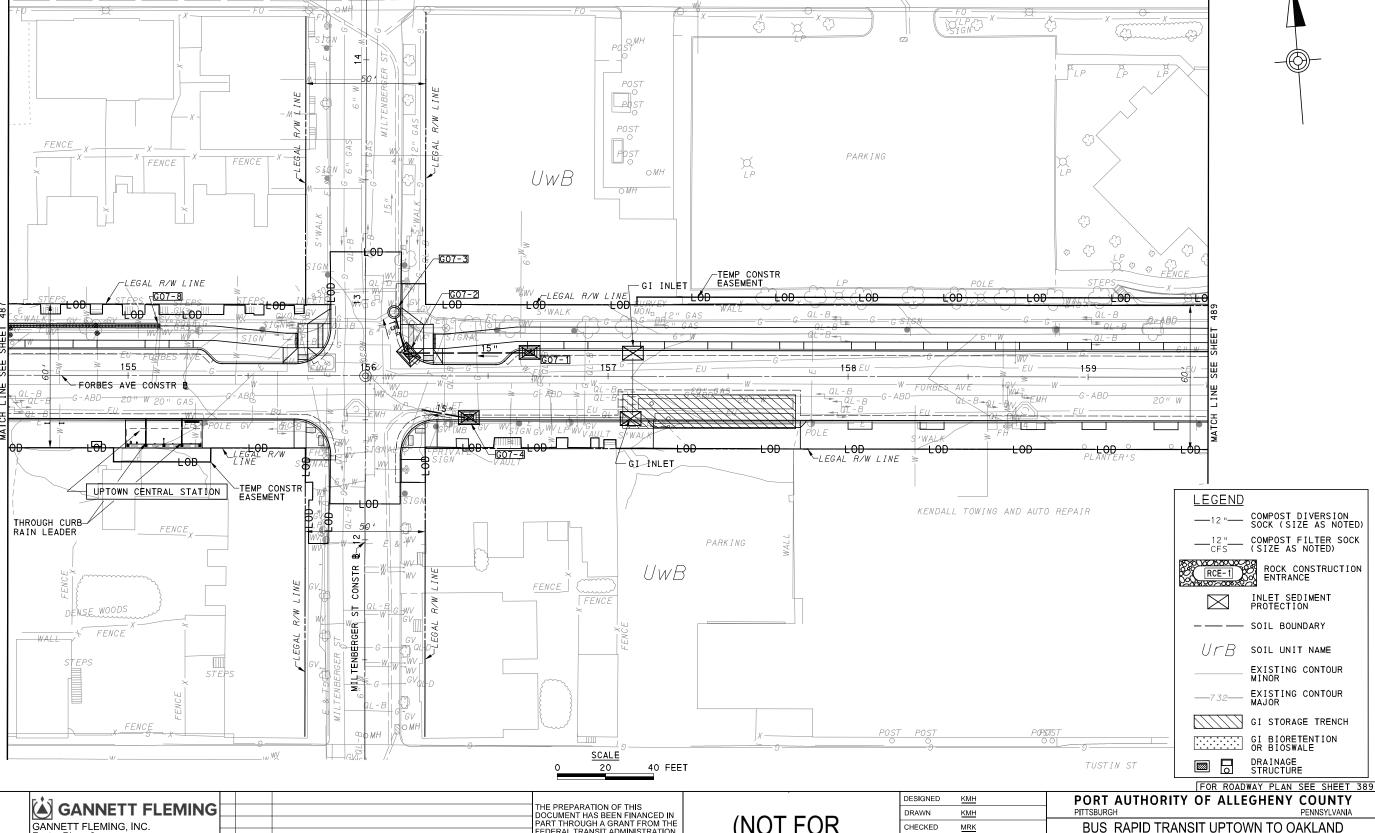

MATCH LINE SEE SHEET 462

**AECOM** 

**Gulf Tower** 707 Grant Street 5th Floor Pittsburgh, PA 15219 Foster Plaza 8 Suite 400 730 Holiday Drive Pittsburgh, PA. 15220

OMH

THE PREPARATION OF THIS
DOCUMENT HAS BEEN FINANCED IN
PART THROUGH A GRANT FROM THE
FEDERAL TRANSIT ADMINISTRATION, PEDERAL TRANSIT ADMINISTRATION,
U.S. DEPARTMENT OF
TRANSPORTATION, UNDER THE
URBAN MASS TRANSPORTATION ACT
OF 1964, AS AMENDED, FOR THE
PORT AUTHORITY OF ALLEGHENY
COUNTY, PENNSYLVANIA. NO. DATE DESCRIPTION REVISIONS

(NOT FOR CONSTRUCTION)

CHECKED MRK N CHARGE GEC DATE 05/01/24 SCALE AS SHOWN


BUS RAPID TRANSIT UPTOWN TO OAKLAND EROSION & SEDIMENTATION CONTROL PLANS FORBES AVE - STA 154+50 TO STA 159+50

sнт. 488

Port Authority CONTRACT NO. BRT-001

DWG. NO. ES44



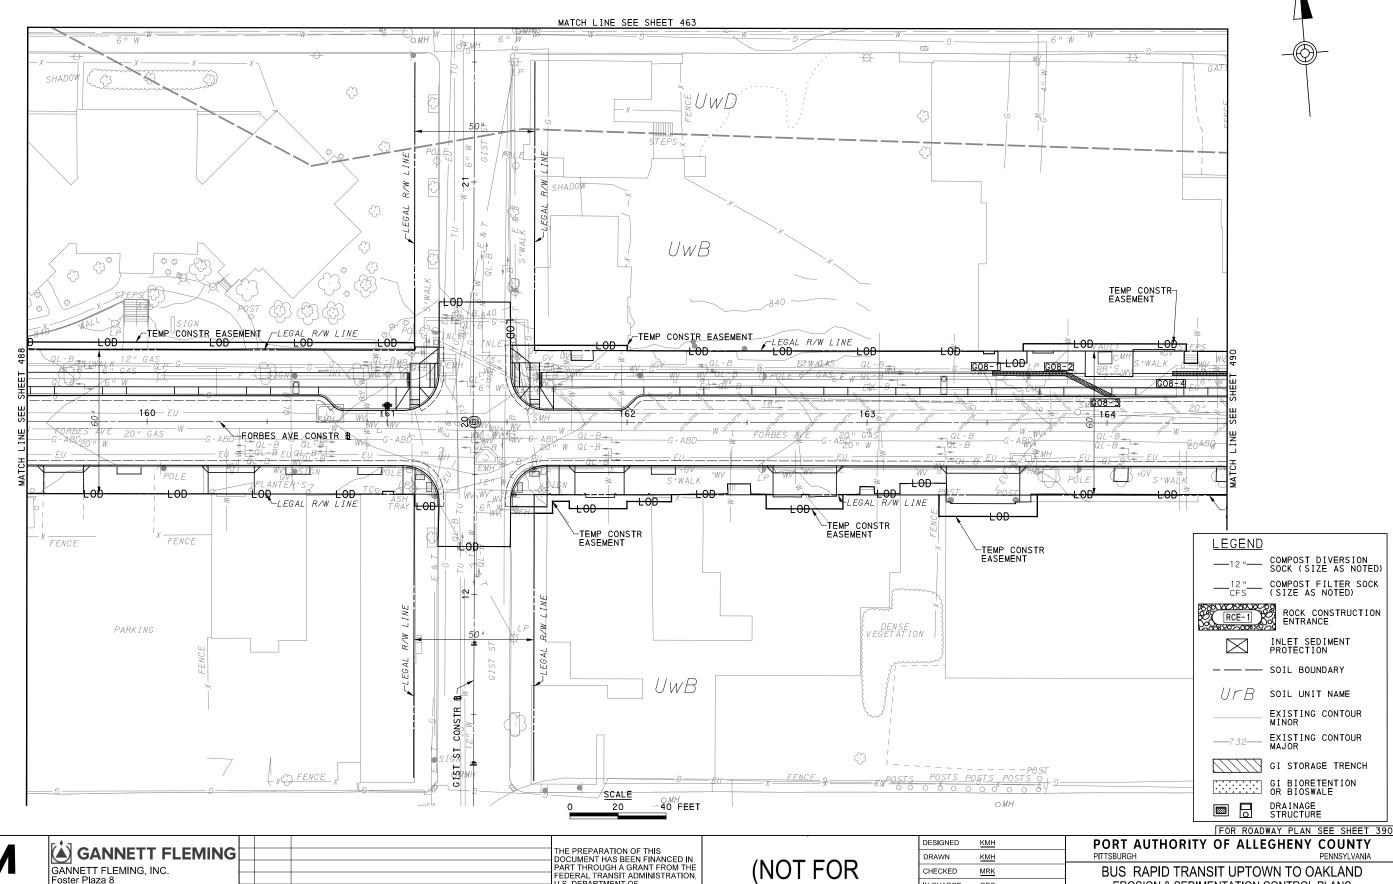

**AECOM** 

Gulf Tower 707 Grant Street 5th Floor Pittsburgh, PA 15219 GANNETT FLEMING, INC. Foster Plaza 8 Suite 400 730 Holiday Drive Pittsburgh, PA. 15220

NO. DATE

THE PREPARATION OF THIS
DOCUMENT HAS BEEN FINANCED IN
PART THROUGH A GRANT FROM THE
FEDERAL TRANSIT ADMINISTRATION,
U.S. DEPARTMENT OF
TRANSPORTATION, UNDER THE
URBAN MASS TRANSPORTATION ACT
OF 1964, AS AMENDED, FOR THE
DESCRIPTION
REVISIONS
THE PREPARATION OF THIS
PORT AUTHORITY OF ALLEGHENY
COUNTY, PENNSYLVANIA.

(NOT FOR CONSTRUCTION)


DESIGNED	<u>KMH</u>	
DRAWN	<u>КМН</u>	
CHECKED	MRK	
IN CHARGE	GEC	
DATE	05/01/24	
SCALE		
	AS SHOWN	

BUS RAPID TRANSIT UPTOWN TO OAKLAND EROSION & SEDIMENTATION CONTROL PLANS FORBES AVE - STA 159+50 TO STA 164+50

Port Authority CONTRACT NO. BRT-001

DWG. NO. ES45 SHT. 489



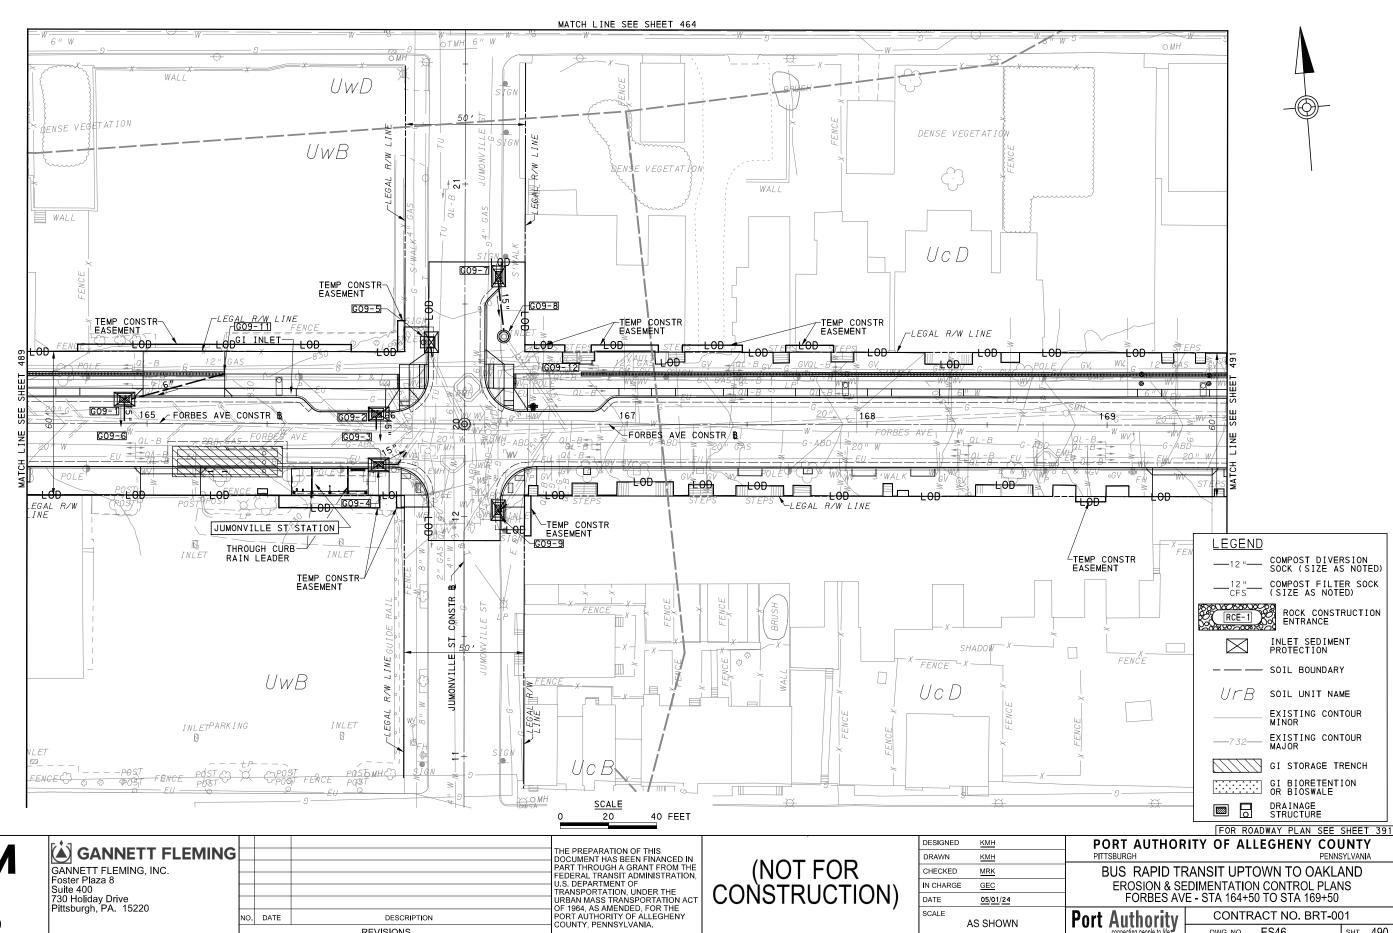

DATE

SCALE

05/01/24

AS SHOWN

Port Authority

CONTRACT NO. BRT-001

sнт. **490** 

ES46


DWG. NO.

AECOM

**Gulf Tower** 707 Grant Street 5th Floor Pittsburgh, PA 15219

NO. DATE

DESCRIPTION

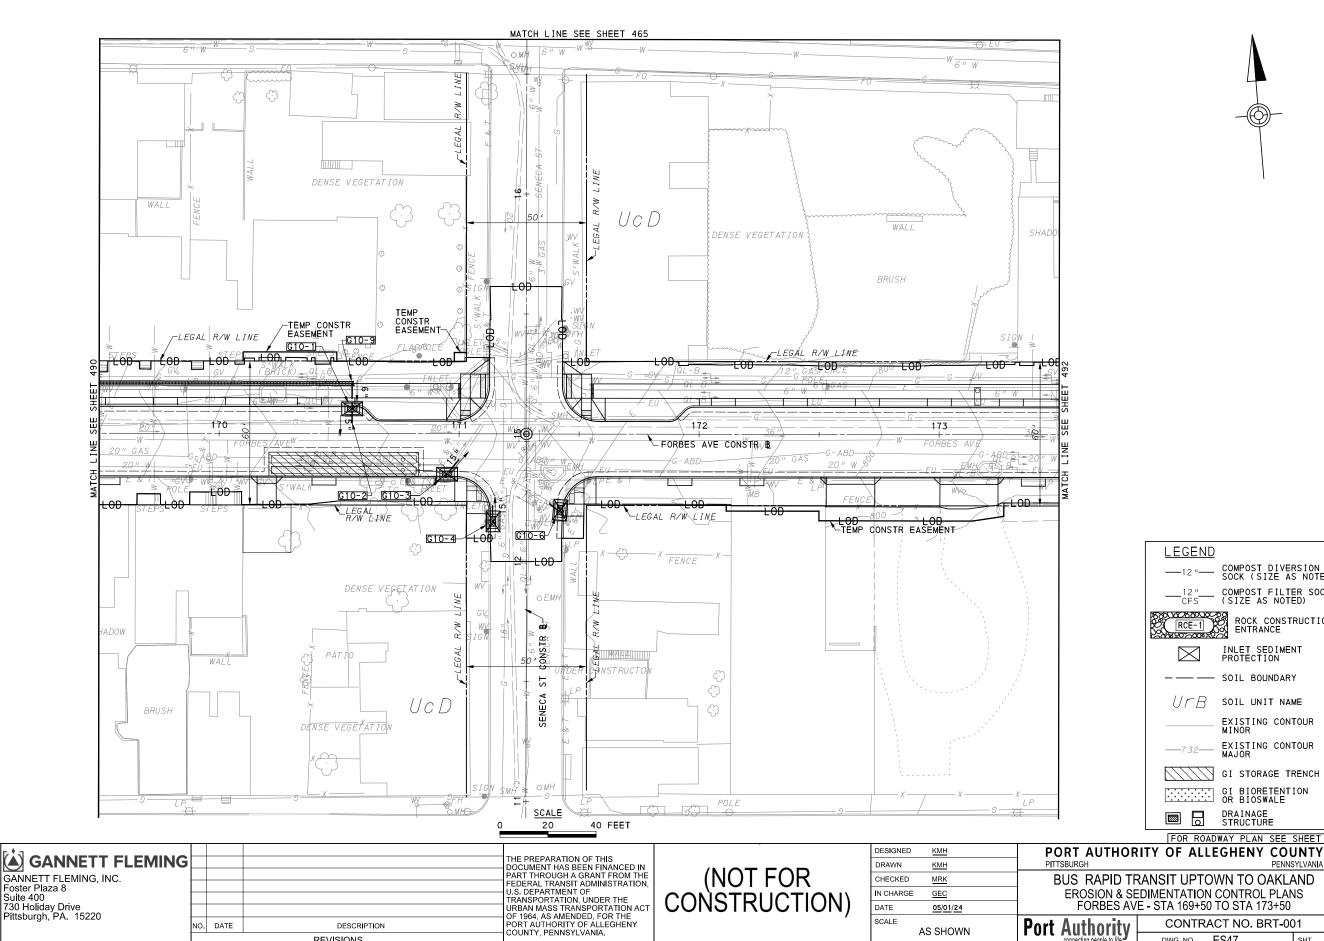

**LEGEND** 

RCE-1

Port Authority connecting people to life

SCALE

AS SHOWN

——12"—— COMPOST DIVERSION SOCK (SIZE AS NOTED)

\_\_\_12"\_\_\_ COMPOST FILTER SOCK (SIZE AS NOTED)

- SOIL BOUNDARY UFB SOIL UNIT NAME

GI BIORETENTION OR BIOSWALE

CONTRACT NO. BRT-001

DWG. NO. ES47

DRAINAGE STRUCTURE

FOR ROADWAY PLAN SEE SHEET 392

sнт. 491

EXISTING CONTOUR MINOR

EXISTING CONTOUR GI STORAGE TRENCH

ROCK CONSTRUCTION ENTRANCE

**AECOM** 

**Gulf Tower** 


707 Grant Street

5th Floor

Pittsburgh, PA 15219

NO. DATE

DESCRIPTION

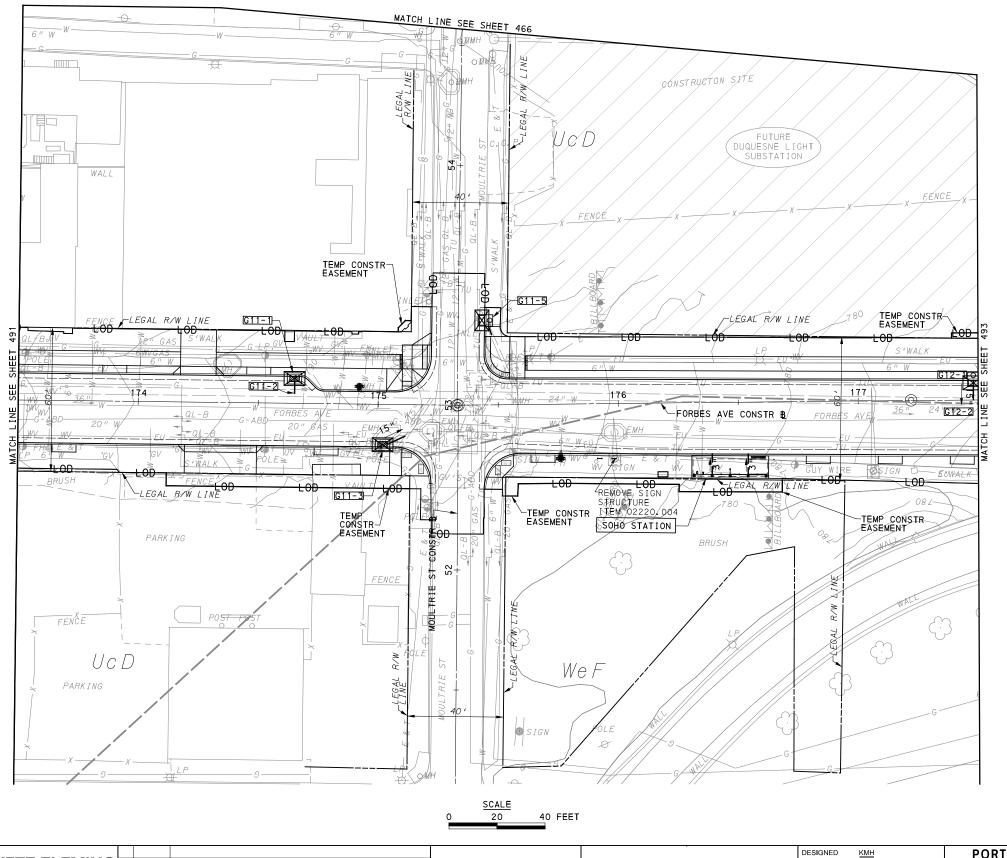

DRAINAGE
STRUCTURE

FOR ROADWAY PLAN SEE SHEET 393

**AECOM** 

Gulf Tower 707 Grant Street 5th Floor Pittsburgh, PA 15219 GANNETT FLEMING
GANNETT FLEMING, INC.
Foster Plaza 8
Suite 400
730 Holiday Drive
Pittsburgh, PA. 15220

THE PREPARATION OF THIS
DOCUMENT HAS BEEN FINANCED IN
PART THROUGH A GRANT FROM THE
FEDERAL TRANSIT ADMINISTRATION,
U.S. DEPARTMENT OF
TRANSPORTATION, UNDER THE
URBAN MASS TRANSPORTATION ACT
OF 1964, AS AMENDED, FOR THE
PORT AUTHORITY OF ALLEGHENY
COUNTY, PENNSYLVANIA.

(NOT FOR CONSTRUCTION)

DESIGNED	<u>KMH</u>	
DRAWN	<u>KMH</u>	
CHECKED	MRK	
IN CHARGE	GEC	
DATE	05/01/24	
SCALE		
AS SHOWN		

PORT AUTHORITY OF ALLEGHENY COUNTY

BUS RAPID TRANSIT UPTOWN TO OAKLAND EROSION & SEDIMENTATION CONTROL PLANS FORBES AVE - STA 173+50 TO STA 177+50

**LEGEND** 

RCE-1

-- SOIL BOUNDARY

UFB SOIL UNIT NAME

EXISTING CONTOUR
MAJOR

GI STORAGE TRENCH

ROCK CONSTRUCTION ENTRANCE

Port Authority	CONTRACT NO. BRT-001			
connecting people to life	DWG. NO.	ES48	SHT.	492

SCALE

AS SHOWN

Port Authority connecting people to life

CONTRACT NO. BRT-001


sнт. **493** 

DWG. NO. ES49

5th Floor Pittsburgh, PA 15219

NO. DATE

DESCRIPTION

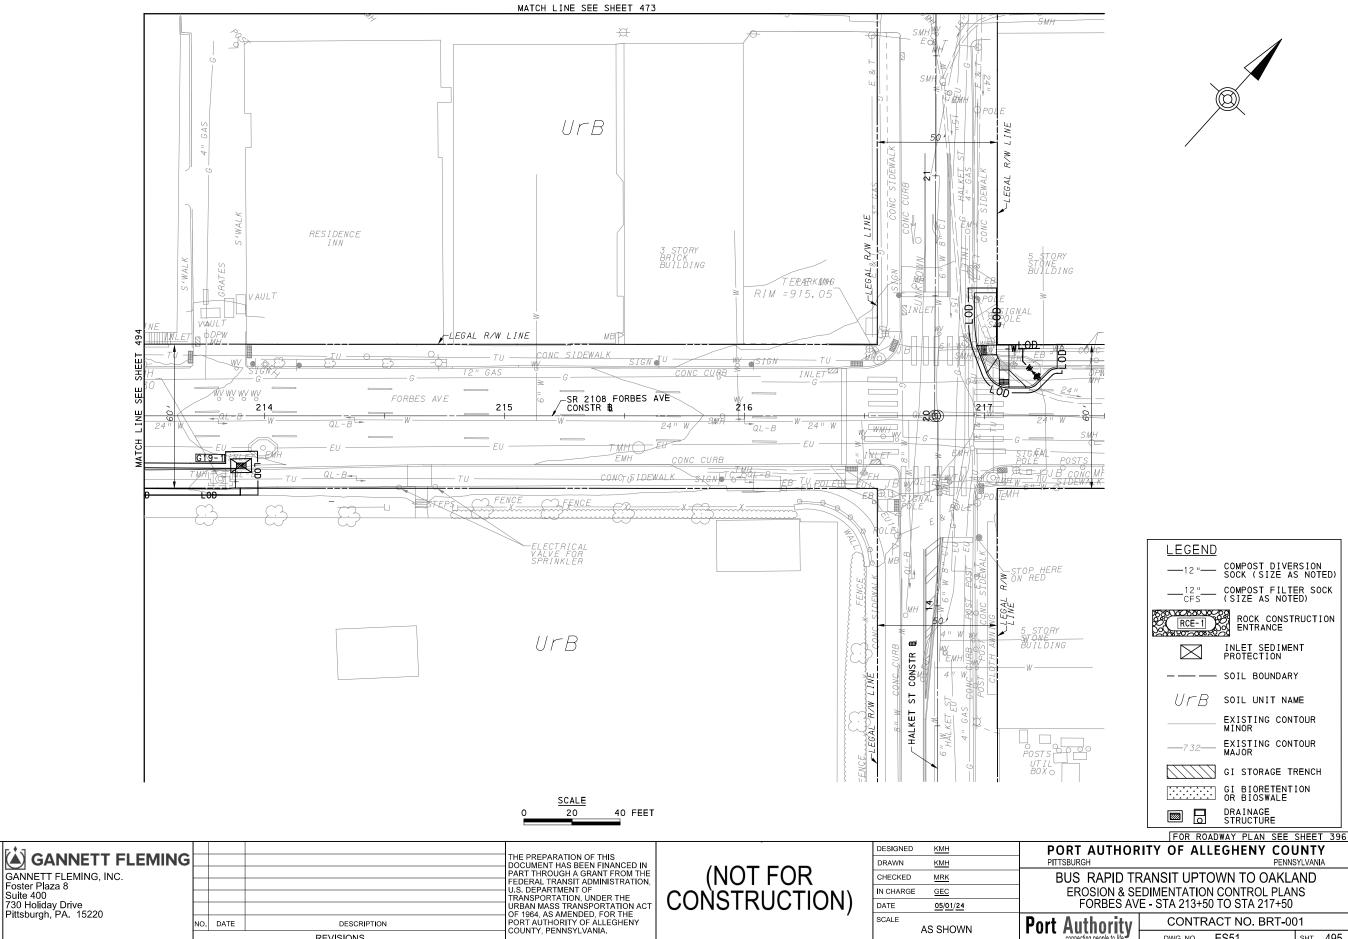

DATE

SCALE

<u>05/01/24</u>

AS SHOWN

**Port Authority** 

ROCK CONSTRUCTION ENTRANCE

EXISTING CONTOUR MINOR EXISTING CONTOUR GI STORAGE TRENCH

CONTRACT NO. BRT-001

sнт. 495

DWG. NO. ES51

**AECOM** 


**Gulf Tower** 

707 Grant Street

5th Floor Pittsburgh, PA 15219

NO. DATE

DESCRIPTION

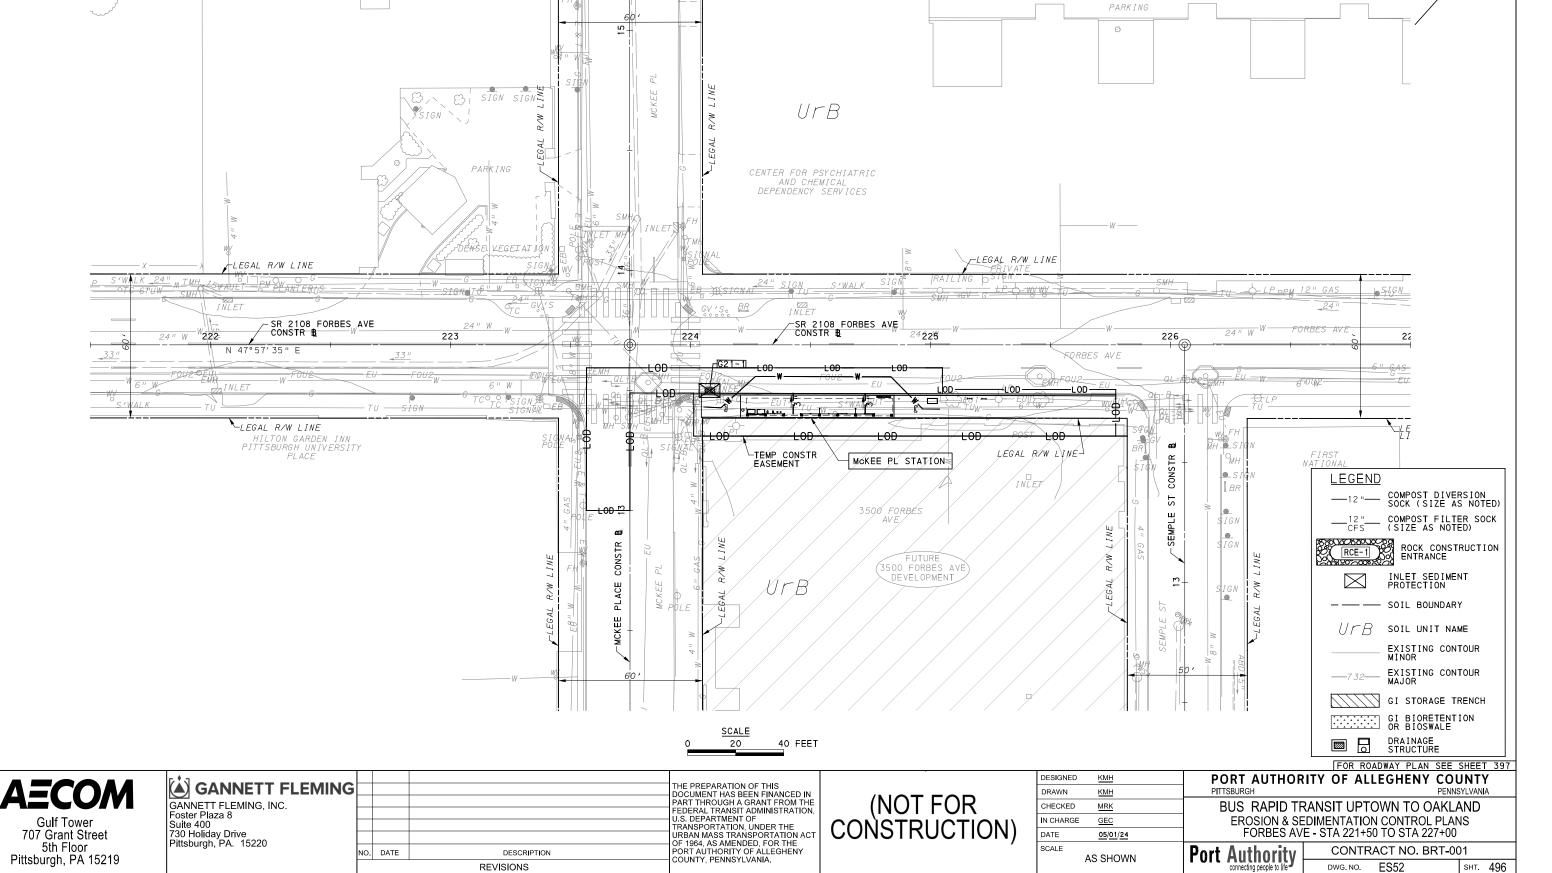

REVISIONS

AS SHOWN


DWG NO. ES52

sнт. **49**6

MATCH LINE SEE SHEET 475

Pittsburgh, PA 15219



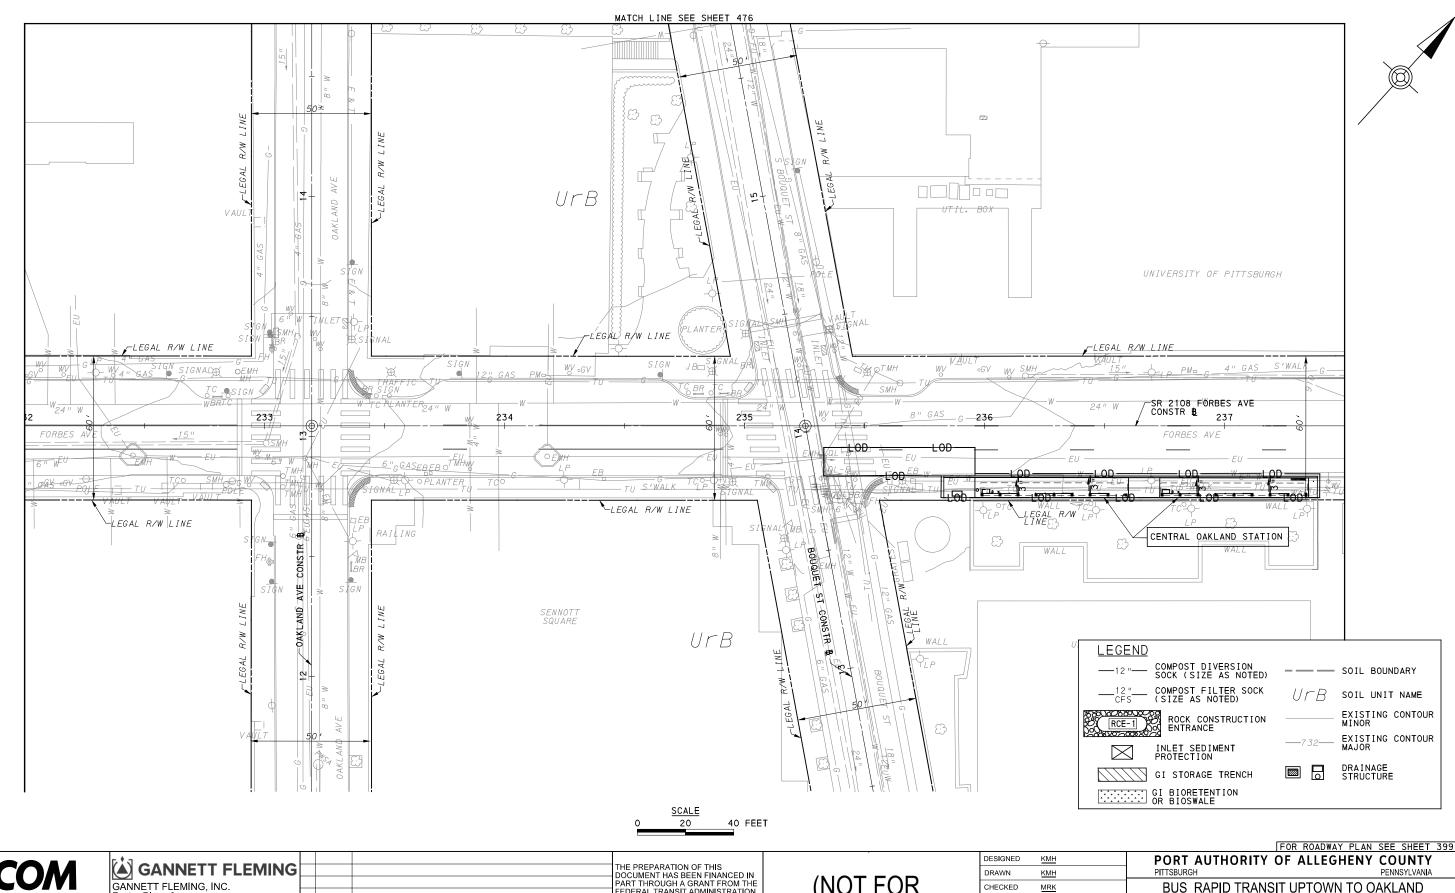

**AECOM** 

**Gulf Tower** 707 Grant Street 5th Floor Pittsburgh, PA 15219 Foster Plaza 8 Suite 400 730 Holiday Drive Pittsburgh, PA. 15220

THE PREPARATION OF THIS
DOCUMENT HAS BEEN FINANCED IN
PART THROUGH A GRANT FROM THE
FEDERAL TRANSIT ADMINISTRATION, FEDERAL TRANSIT ADMINISTRATION,
U.S. DEPARTMENT OF
TRANSPORTATION, UNDER THE
URBAN MASS TRANSPORTATION ACT
OF 1964, AS AMENDED, FOR THE
PORT AUTHORITY OF ALLEGHENY
COUNTY, PENNSYLVANIA. NO. DATE DESCRIPTION REVISIONS


(NOT FOR CONSTRUCTION)

ESIGNED	<u>KMH</u>	
RAWN	<u>KMH</u>	
HECKED	MRK	
CHARGE	GEC	
ATE	05/01/24	
CALE		
	AS SHOWN	

BUS RAPID TRANSIT UPTOWN TO OAKLAND EROSION & SEDIMENTATION CONTROL PLANS FORBES AVE - STA 232+00 TO STA 237+50

**Port Authority** 

CONTRACT NO. BRT-001 DWG. NO. ES53 sнт. 497

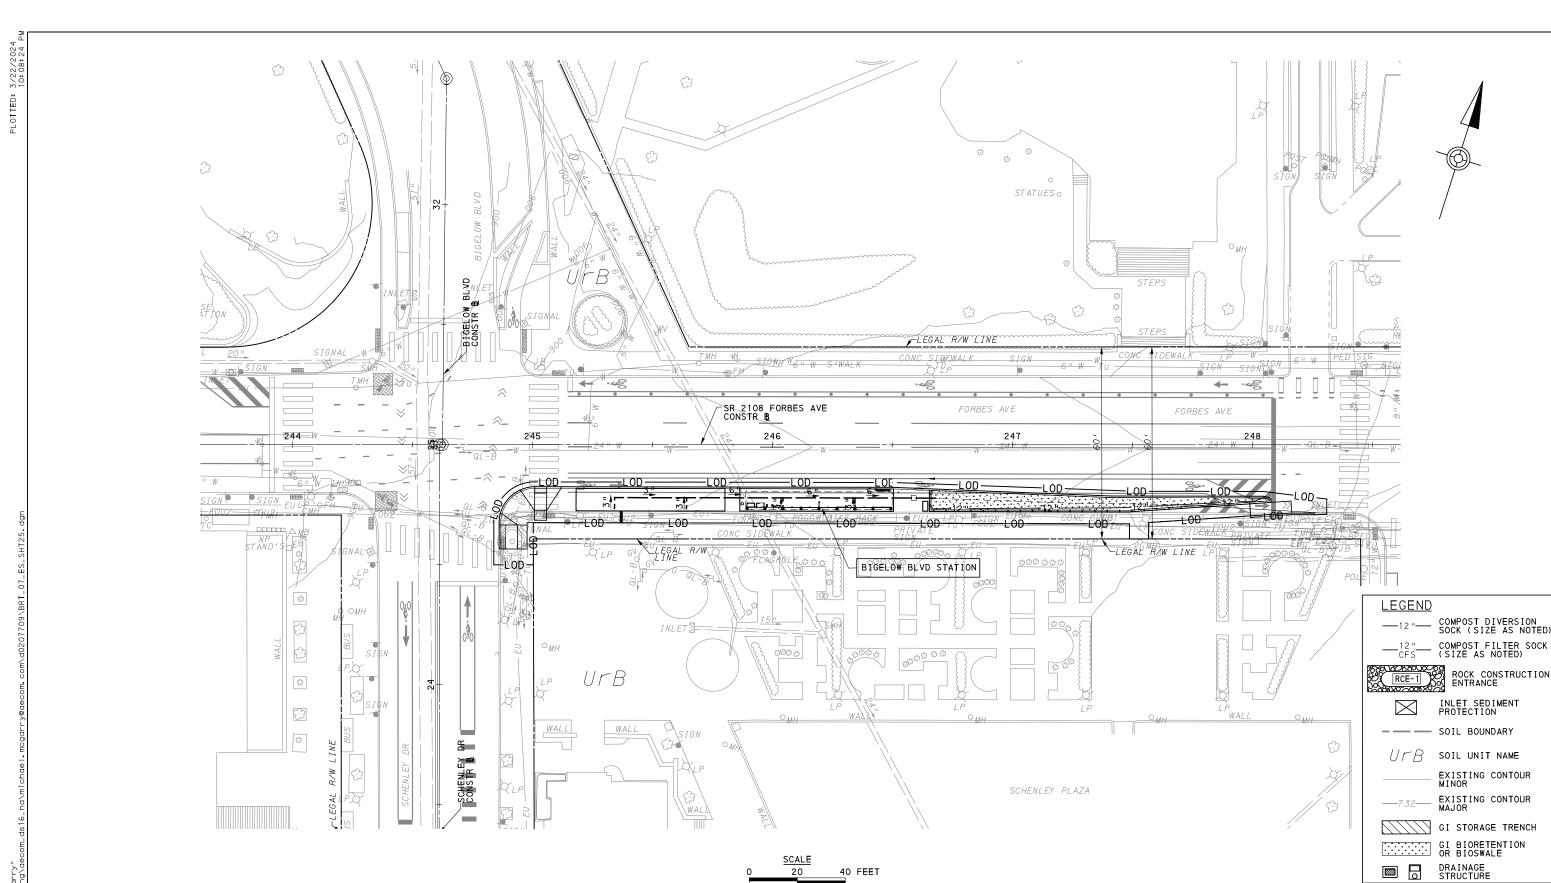

**AECOM** 

Gulf Tower 707 Grant Street 5th Floor Pittsburgh, PA 15219 GANNETT FLEMING
GANNETT FLEMING, INC.
Foster Plaza 8
Suite 400

730 Holiday Drive Pittsburgh, PA. 15220 NO. DATE DESCRIPTION
REVISIONS

THE PREPARATION OF THIS
DOCUMENT HAS BEEN FINANCED IN
PART THROUGH A GRANT FROM THE
FEDERAL TRANSIT ADMINISTRATION,
U.S. DEPARTMENT OF
TRANSPORTATION, UNDER THE
URBAN MASS TRANSPORTATION ACT
OF 1964, AS AMENDED, FOR THE
PORT AUTHORITY OF ALLEGHENY
COUNTY, PENNSYLVANIA.

(NOT FOR CONSTRUCTION)

ESIGNED	<u>KMH</u>	
RAWN	<u>KMH</u>	
HECKED	MRK	
CHARGE	GEC	
ATE	05/01/24	
CALE		
	AS SHOWN	

## FOR ROADWAY PLAN SEE SHEET 401 PORT AUTHORITY OF ALLEGHENY COUNTY

BUS RAPID TRANSIT UPTOWN TO OAKLAND
EROSION & SEDIMENTATION CONTROL PLANS
FORBES AVE - STA 242+50 TO STA 247+50

Port Authority CONTRACT NO. BRT-001

DWG. NO. ES54 SHT. 498

PERATOR: "michael.mogarry'