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PORT AUTHORITY OF ALLEGHENY COUNTY CONTRACT DRAWINGS BUS RAPID TRANSIT (BRT) UPTOWN TO OAKLAND CONSTRUCTION CONTRACT NO. BRT-001

FTA GRANT NO.: PA-2023-002-00

PROJECT NO.: CCA-G-22-23-PAAC-00702

CCA-21-22-PAAC-00764 CCA-20-21-PAAC-00715 CAA-19-20-PAAC-00538

ISSUE DATE: MAY 1, 2024

VOLUME 3 OF 3

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INDEX SHEETS


SIGNAL PLANS

CROSS SECTIONS

PWSA STORMWATER MANAGEMENT PLANS (ALSO PLAN)



THE PREPARATION OF THESE DRAWINGS HAS BEEN FINANCED, IN PART, THROUGH A GRANT FROM THE U.S. DEPARTMENT OF TRANSPORTATION, FEDERAL TRANSIT ADMINISTRATION, UNDER THE URBAN MASS TRANSPORTATION ACT OF 1964. AS AMENDED.

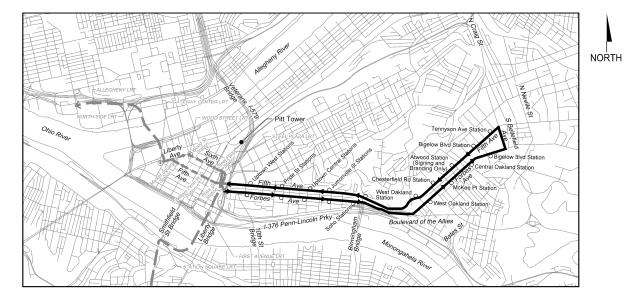


LOCATION MAP

(NOT FOR CONSTRUCTION)

BY: COM ulf Tower Grant Street 5th Floor		AECOM
h, PA 15219	Project Manager REGISTERED PROFESSIONAL E	Date ENGINEER, PENNSYLVANIA OF ALLEGHENY COUNTY
	Approved CHIEF ENGINEER - ENGINEERI	Date

APPROVAL	DATE
ASSISTANT DIRECTOR OF PLANNING, POLICY AND PERMITTING	
MUNICIPAL TRAFFIC ENGINEER	
CHIEF ENGINEER	

CITY OF PITTSBURGH

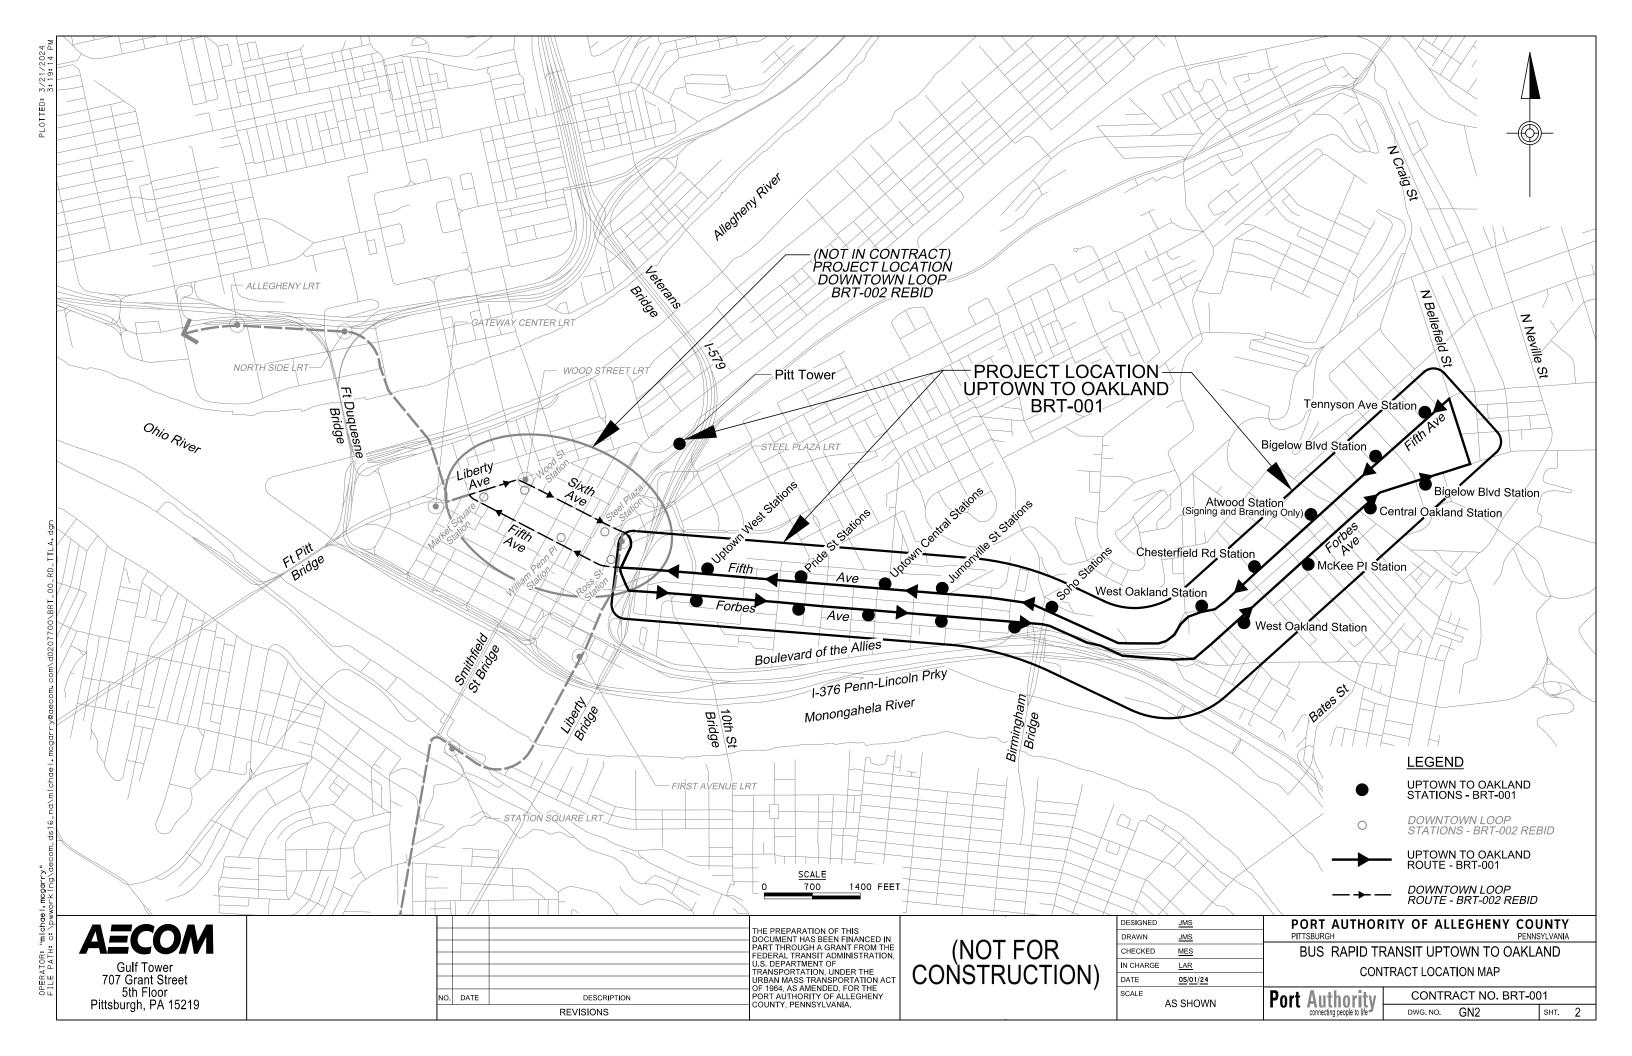

GENERAL NOTES/ABBREVIATIONS/SYMBOLOGY SHEETS BN21 21 AND STANDARD DATAINOS BN22 22 LIST OF PUBLICATIONS BN21 21 AND STANDARD DATAINOS BN22 22 LIST OF PUBLICATIONS BN23 23 STANDARD CARRESPICATIONS BN24 24 STANDARD SABBEVIATIONS BN25 25 STANDARD CURVE DATA AND SURVEY TERMS BN26 25 STANDARD CURVE DATA AND SURVEY TERMS BN27 27 STANDARD SYMBOLOGY BN27 27 STANDARD SYMBOLOGY BN28 25 ROADBAY TABULATION SHEET BN26 26 STANDARD SYMBOLOGY BN27 27 STANDARD SYMBOLOGY BN28 25 ROADBAY TABULATION SHEET BN26 26 BN27 27 STANDARD SYMBOLOGY BN27 27 STANDARD SYMBOLOGY BN27 27 STANDARD SYMBOLOGY BN28 25 ROADBAY TABULATION SHEET BN27 27 STANDARD SYMBOLOGY BN2 27 ROADBAY TABULATION SHEET BN28 25 BN2	DRAWING NUMBER	SHEET NUMBER	TITLE	DRAWING NUMBER	SHEET NUMBER	TITLE	DRAWING NUMBER	SHEET NUMBE	R TITLE		DRAWING NUMBER	SHEET NUMBER	TITLE
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		707 Grant	Street			URB OF 1	BAN MASS TRANSPORTATION 1964. AS AMENDED, FOR THE	E I	CONSTRUCTION)			Desi	
REVISIONS Connecting people to life DWG. NO. GN3 SHT.	Pit			NO. DATE		COL	RT AUTHORITY OF ALLEGHEI JNTY, PENNSYLVANIA.	INY		AS SHOWN	I	Port /	GULIIVIIIV

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))]			TYPICAL SECTIONS (CONT'D)			SPECIAL DETAILS (CONT'	D)		DRAINAGE PROFILES (CONT' D)		INTERSECTION DETAILS (CONT'D)
CV4	0 1	115	TYPICAL SECTIONS FORBES AVE	CV69	144	SPECIAL DETAILS PWSA - LARGE DIAMETER SEWER CONNEC	CTION CV96	171	DRAINAGE PROFILES DRAINAGE STRUCTURES		200	INTERSECTION DATA FIFTH AVE & JUMONVILLE ST/WYANDOTTE ST
CV4	1 1	116	TYPICAL SECTIONS FORBES AVE				CV97	172	DRAINAGE PROFILES DRAINAGE STRUCTURES GO5	1025	201	INTERSECTION DETAILS FIFTH AVE & SENECA ST
CV4	2 1	117	TYPICAL SECTIONS FORBES AVE			DRAINAGE DATA SHEETS	CV98	173	DRAINAGE PROFILES DRAINAGE STRUCTURES GO6	1036	202	INTERSECTION DATA FIFTH AVE & SENECA ST
CV4	3 1	118	TYPICAL SECTIONS FORBES AVE	CV70	145	DRAINAGE DATA DRAINAGE STRUCTURES A14 - A16	CV99	174	DRAINAGE PROFILES DRAINAGE STRUCTURES GO7	1027	203	INTERSECTION DETAILS FIFTH AVE & MOULTRIE ST
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CV4	5 12	120	TYPICAL SECTIONS FORBES AVE	CV72	147	DRAINAGE DATA DRAINAGE STRUCTURES A19- A20	CV101	176	DRAINAGE PROFILES DRAINAGE STRUCTURES G11		205	INTERSECTION DETAILS FIFTH AVE & KIRKPATRICK ST/BIRMINGHAM BR
CV4	6 1:	121	TYPICAL SECTIONS MARION ST AND JUMONVILLE ST	CV73	148	DRAINAGE DATA DRAINAGE STRUCTURES A21 - A22	:			ID30	206	INTERSECTION DATA FIFTH AVE & KIRKPATRICK ST/BIRMINGHAM BR
				CV74	149	DRAINAGE DATA DRAINAGE STRUCTURES A23 - A25	i		INTERSECTION DET	AILS ID31	207	INTERSECTION DATA FIFTH AVE & KIRKPATRICK ST/BIRMINGHAM BR
			SPECIAL DETAILS	CV75	150	DRAINAGE DATA DRAINAGE STRUCTURES A25 - A28	ID1	177	INTERSECTION DETAIL FIFTH AVE & DIAMOND		208	INTERSECTION DETAILS FIFTH AVE & BLVD OF THE ALLIES RAMP
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CV4	9 1:	124	SPECIAL DETAILS REINFORCED CONCRETE SIDEWALK AND JOINTS	CV78	153	DRAINAGE DATA DRAINAGE STRUCTURES GO1 - GO6	ID4	180	INTERSECTION DATA FIFTH AVE & CHATHAM SQ/WASH		211	INTERSECTION DATA FIFTH AVE & CRAFT AVE
CV5	0 12	125	SPECIAL DETAILS ISLAND REMOVAL / PAVEMENT PATCHING	CV79	154	DRAINAGE DATA DRAINAGE STRUCTURES GO6 - G11	ID5	181	INTERSECTION DETAIL FIFTH AVE & MAGEE S		212	INTERSECTION DETAILS FIFTH AVE & HALKET ST/CHESTERFIELD RD
CV5	1 12	126	SPECIAL DETAILS SIDEWALK CUT THROUGH	CV80	155	DRAINAGE DATA DRAINAGE STRUCTURES G11 - G21	ID6	182	INTERSECTION DATA FIFTH AVE & MAGEE S		213	INTERSECTION DATA FIFTH AVE & HALKET ST/CHESTERFIELD RD
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Бр CV5	4 12	129	SPECIAL DETAILS SUBGRADE UNDERCUT / TRENCH RESTORATION			DRAINAGE PROFILES	ID9	185	INTERSECTION DETAIL FIFTH AVE & STEVENSON	1 ST 1040	216	INTERSECTION DETAILS FIFTH AVE & LOTHROP ST/MEYRAN AVE
CV5	5 13	130	SPECIAL DETAILS REMOVABLE CURB	CV82	157	DRAINAGE PROFILES DRAINAGE STRUCTURES A14 - A15	ID10	186	INTERSECTION DATA FIFTH AVE & STEVENSON	I ST	217	INTERSECTION DATA FIFTH AVE & LOTHROP ST/MEYRAN AVE
CV5	6 1	131	SPECIAL DETAILS PWSA - MANHOLE FRAME CASTINGS	CV83	158	DRAINAGE PROFILES DRAINAGE STRUCTURES A15 - A16	ID11	187	INTERSECTION DETAIL FIFTH AVE & PRIDE S	ST 1042	218	INTERSECTION DETAILS FIFTH AVE & ATWOOD ST
CV2	7 1:	132	SPECIAL DETAILS PWSA - MANHOLE FRAME & COVER CASTINGS	CV84	159	DRAINAGE PROFILES DRAINAGE STRUCTURES A16 - A17	ID12	188	INTERSECTION DATA FIFTH AVE & PRIDE S	ST 1043	219	INTERSECTION DATA FIFTH AVE & ATWOOD ST
CV5	8 13	133	SPECIAL DETAILS PWSA - TRENCH IN SIDEWALK & TRENCH REPAVING	CV85	160	DRAINAGE PROFILES DRAINAGE STRUCTURES A17 - A19	ID13	189	INTERSECTION DETAIL FIFTH AVE & MARION ST/V	INE ST	220	INTERSECTION DETAILS FIFTH AVE & OAKLAND AVE/DE SOTO ST
CV5	9 13	134	SPECIAL DETAILS PWSA - PIPE REINFORCEMENT & CIP MH INVERT	CV86	161	DRAINAGE PROFILES DRAINAGE STRUCTURES A19 - A20	ID14	190	INTERSECTION DATA FIFTH AVE & MARION ST/V	INE ST	221	INTERSECTION DATA FIFTH AVE & OAKLAND AVE/DE SOTO ST
CV6	0 13	135	SPECIAL DETAILS PWSA - MANHOLES	CV87	162	DRAINAGE PROFILES DRAINAGE STRUCTURES A20 - A23	ID15	191	INTERSECTION DETAIL FIFTH AVE & VAN BRAAM	1046	222	INTERSECTION DETAILS FIFTH AVE & BOUQUET ST
CV6	1 13	136	SPECIAL DETAILS PWSA - MANHOLE STEPS / INLET FRAME & GRATE	CV88	163	DRAINAGE PROFILES DRAINAGE STRUCTURES A20	ID16	192	INTERSECTION DATA FIFTH AVE & VAN BRAAM	1 ST 1047	223	INTERSECTION DATA FIFTH AVE & BOUQUET ST
CV6	2 1	137	SPECIAL DETAILS PWSA - CATCH BASIN TYPE 13	CV89	164	DRAINAGE PROFILES DRAINAGE STRUCTURES A24 - A25	ID17	193	INTERSECTION DETAIL FIFTH AVE & MILTENBERG	ER ST	224	INTERSECTION DETAILS FIFTH AVE & THACKERY AVE
CV6	3 1.	138	SPECIAL DETAILS PWSA - CATCH BASINS TYPE 13 MODIFIED	CV90	165	DRAINAGE PROFILES DRAINAGE STRUCTURES A25 - A26	ID18	194	INTERSECTION DATA FIFTH AVE & MILTENBERG	ER ST	225	INTERSECTION DATA FIFTH AVE & THACKERY AVE
eph.	4 13	139	SPECIAL DETAILS TRENCH DRAIN	CV91	166	DRAINAGE PROFILES DRAINAGE STRUCTURES A27 - A28	ID19	195	INTERSECTION DETAIL FIFTH AVE & DINNWIDDI	E ST	226	INTERSECTION DETAILS FIFTH AVE & BIGELOW BLVD
cve	5 14	140	SPECIAL DETAILS THROUGH CURB RAIN LEADER	CV92	167	DRAINAGE PROFILES DRAINAGE STRUCTURES A29 - A34	ID20	196	INTERSECTION DATA	E ST	227	INTERSECTION DATA FIFTH AVE & BIGELOW BLVD
CA9	6 1	141	SPECIAL DETAILS PWSA - WYE CONTROL SPECIAL DETAILS	CV93	168	DRAINAGE PROFILES DRAINAGE STRUCTURES A36 - A38		197	INTERSECTION DETAIL FIFTH AVE & GIST S'	T 1032	228	INTERSECTION DETAILS FIFTH AVE & LYTTON AVE
₽ CV6	7 1.	142	SPECIAL DETAILS RECESSED CATCH BASIN CONVERSION	CV94	169	DRAINAGE PROFILES DRAINAGE STRUCTURES GO1 - GO2		198	INTERSECTION DATA FIFTH AVE & GIST S'	T 1033	229	INTERSECTION DATA FIFTH AVE & LYTTON AVE
CV6	8 1	143	SPECIAL DETAILS PIPE FIELD COLLAR & PWSA - CONCRETE PLUG	CV95	170	DRAINAGE PROFILES DRAINAGE STRUCTURES GO4 - GO5	ID23	199	INTERSECTION DETAIL FIFTH AVE & JUMONVILLE ST/WY	YANDOTTE ST ID54	230	INTERSECTION DETAILS FIFTH AVE & TENNYSON AVE
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ž d			NA.4			71	HE PREPARATION OF THIS			DESIGNED JMS		RT AUTHORITY OF ALLEGHENY COUNTY
,ö <u> </u>	4=		DM			D. D.	HE FREFARTION OF THIS OCUMENT HAS BEEN FINANCE ART THROUGH A GRANT FROM EDERAL TRANSIT ADMINISTRA	M THE	(NOT FOR	DRAWN JMS CHECKED MES		US RAPID TRANSIT UPTOWN TO OAKLAND
E PATH:		ulf Towe Grant St				U. Tr	EDERAL TRANSIT ADMINISTRA .S. DEPARTMENT OF RANSPORTATION, UNDER THE RBAN MASS TRANSPORTATIO		CONSTRUCTION)	IN CHARGE <u>LAR</u>		INDEX OF DRAWINGS
[[]	5t	th Floor		NO. DATE		DESCRIPTION P	F 1964, AS AMENDED, FOR THI ORT AUTHORITY OF ALLEGHE	E I		DATE	Port	Authority CONTRACT NO. BRT-001
	Pittsbur	igii, PA	10218			REVISIONS	OUNTY, PENNSYLVANIA.			AS SHOWN	1 011	connecting people to life DWG. NO. GN4 SHT. 4

TED: 4/2	DRAWING NUMBER	SHEET NUMBER	TITLE	DRAWING NUMBER	SHEET NUMBER	TITLE		SHEET NUMBER	TITLE	DRAWING NUMBER	SHEET NUMBER	TITLE
PL0T			INTERSECTION DETAILS (CONT'D)			INTERSECTION DETAILS (CO	NT' D)		CIVIL LAYOUT PLANS (CONT' D)	REMOV	AL & ADJUSTMENTS PLANS (CONT'D)
	ID55	231	INTERSECTION DATA FIFTH AVE & TENNYSON AVE	ID86	262	INTERSECTION DETAILS FORBES AVE & HALKET ST	CL24	291	CIVIL LAYOUT PLANS FIFTH AVE - STA 555+50 TO S	TA 561+50 RA11	320	REMOVAL & ADJUSTMENTS PLANS FIFTH AVE - STA 443+50 TO STA 448+50
	ID56	232	INTERSECTION DETAILS FIFTH AVE & RUSKIN AVE	ID87	263	INTERSECTION DATA FORBES AVE & HALKET ST	CL25	292	CIVIL LAYOUT PLANS FIFTH AVE - STA 561+50 TO ST	A 566+50 RA12	321	REMOVAL & ADJUSTMENTS PLANS FIFTH AVE - STA 448+50 TO STA 454+50
	ID57	233	INTERSECTION DATA FIFTH AVE & RUSKIN AVE	ID88	264	INTERSECTION DETAILS FORBES AVE & BIGELOW BLVD	CL26	293	CIVIL LAYOUT PLANS FORBES AVE - STA 122+00 TO S	TA 128+00 RA13	322	REMOVAL & ADJUSTMENTS PLANS FIFTH AVE - STA 454+50 TO STA 458+50
	ID58	234	INTERSECTION DETAILS FIFTH AVE & BELLEFIELD AVE	ID89	265	INTERSECTION DATA FORBES AVE & BIGELOW BLVD	CL27	294	CIVIL LAYOUT PLANS FORBES AVE - STA 128+00 TO S	TA 133+50 RA14	323	REMOVAL & ADJUSTMENTS PLANS FIFTH AVE - STA 458+50 TO STA 464+50
	ID59	235	INTERSECTION DATA FIFTH AVE & BELLEFIELD AVE	ID90	266	INTERSECTION DETAILS FORBES AVE & SCHENLEY DR EXT	. CL28	295	CIVIL LAYOUT PLANS FORBES AVE - STA 138+50 TO S	TA 143+50 RA15	324	REMOVAL & ADJUSTMENTS PLANS FIFTH AVE - STA 464+50 TO STA 470+50
	ID60	236	INTERSECTION DETAILS FORBES AVE & BOYD ST	ID91	267	INTERSECTION DETAILS FORBES AVE & SCHENLEY DR EXT	. CL29	296	CIVIL LAYOUT PLANS FORBES AVE - STA 143+50 TO S	TA 149+50 RA16	325	REMOVAL & ADJUSTMENTS PLANS FIFTH AVE - STA 470+50 TO STA 475+50
	ID61	237	INTERSECTION DATA FORBES AVE & BOYD ST				CL30	297	CIVIL LAYOUT PLANS FORBES AVE - STA 149+50 TO S	TA 154+50 RA17	326	REMOVAL & ADJUSTMENTS PLANS FIFTH AVE - STA 475+50 TO STA 480+50
	ID62	238	INTERSECTION DETAILS FORBES AVE & ARMSTRONG TUNNEL			CIVIL LAYOUT PLANS	CL31	298	CIVIL LAYOUT PLANS FORBES AVE - STA 154+50 TO S	TA 159+50 RA18	327	REMOVAL & ADJUSTMENTS PLANS FIFTH AVE - STA 480+50 TO STA 485+50
	ID63	239	INTERSECTION DATA FORBES AVE & ARMSTRONG TUNNEL	CL1	268	CIVIL LAYOUT PLANS FIFTH AVE - STA 433+50 TO STA 43	8+50 CL32	299	CIVIL LAYOUT PLANS FORBES AVE - STA 159+50 TO S	TA 164+50 RA19	328	REMOVAL & ADJUSTMENTS PLANS FIFTH AVE - STA 485+50 TO STA 490+50
	ID64	240	INTERSECTION DETAILS FORBES AVE & CHATHAM SQ	CL2	269	CIVIL LAYOUT PLANS FIFTH AVE - STA 438+50 TO STA 44	3+50 CL33	300	CIVIL LAYOUT PLANS FORBES AVE - STA 164+50 TO S	TA 169+50 RA20	329	REMOVAL & ADJUSTMENTS PLANS FIFTH AVE - STA 490+50 TO STA 496+50
	ID65	241	INTERSECTION DATA FORBES AVE & CHATHAM SQ	CL3	270	CIVIL LAYOUT PLANS FIFTH AVE - STA 443+50 TO STA 44	8+50 CL34	301	CIVIL LAYOUT PLANS FORBES AVE - STA 169+50 TO S	TA 173+50 RA21	330	REMOVAL & ADJUSTMENTS PLANS FIFTH AVE - STA 496+50 TO STA 502+50
	ID66	242	INTERSECTION DETAILS FORBES AVE & STEVENSON ST	CL4	271	CIVIL LAYOUT PLANS FIFTH AVE - STA 448+50 TO STA 45	4+50 CL35	302	CIVIL LAYOUT PLANS FORBES AVE - STA 173+50 TO S	TA 177+50 RA22	331	REMOVAL & ADJUSTMENTS PLANS FIFTH AVE - STA 502+50 TO STA 507+50
	ID67	243	INTERSECTION DATA FORBES AVE & STEVENSON ST	CL5	272	CIVIL LAYOUT PLANS FIFTH AVE - STA 454+50 TO STA 45	8+50 CL36	303	CIVIL LAYOUT PLANS FORBES AVE - STA 177+50 TO S	TA 182+50 RA23	332	REMOVAL & ADJUSTMENTS PLANS FIFTH AVE - STA 507+50 TO STA 513+50
	ID68	244	INTERSECTION DETAILS FORBES AVE & PRIDE ST	CL6	273	CIVIL LAYOUT PLANS FIFTH AVE - STA 458+50 TO STA 46	4+50 CL37	304	CIVIL LAYOUT PLANS FORBES AVE - STA 207+50 TO S	TA 213+50 RA24	333	REMOVAL & ADJUSTMENTS PLANS FIFTH AVE - STA 513+50 TO STA 517+50
	ID69	245	INTERSECTION DATA FORBES AVE & PRIDE ST	CL7	274	CIVIL LAYOUT PLANS FIFTH AVE - STA 464+50 TO STA 47	0+50 CL38	305	CIVIL LAYOUT PLANS FORBES AVE - STA 213+50 TO S	ΓA 217+50 RA25	334	REMOVAL & ADJUSTMENTS PLANS FIFTH AVE - STA 517+50 TO STA 522+50
	ID70	246	INTERSECTION DETAILS FORBES AVE & MARION ST	CL8	275	CIVIL LAYOUT PLANS FIFTH AVE - STA 470+50 TO STA 47	5+50 CL39	306	CIVIL LAYOUT PLANS FORBES AVE - STA 221+50 TO S	TA 227+00 RA26	335	REMOVAL & ADJUSTMENTS PLANS FIFTH AVE - STA 522+50 TO STA 528+50
. dgn	ID71	247	INTERSECTION DATA FORBES AVE & MARION ST	CL9	276	CIVIL LAYOUT PLANS FIFTH AVE - STA 475+50 TO STA 48	0+50 CL40	307	CIVIL LAYOUT PLANS FORBES AVE - STA 232+00 TO S	TA 237+50 RA27	336	REMOVAL & ADJUSTMENTS PLANS FIFTH AVE - STA 528+50 TO STA 534+50
10003	ID72	248	INTERSECTION DETAILS FORBES AVE & VAN BRAAM ST	CL10	277	CIVIL LAYOUT PLANS FIFTH AVE - STA 480+50 TO STA 48	5+50 CL41	308	CIVIL LAYOUT PLANS FORBES AVE - STA 242+50 TO S	TA 247+50 RA28	337	REMOVAL & ADJUSTMENTS PLANS FIFTH AVE - STA 534+50 TO STA 540+50
RD	ID73	249	INTERSECTION DATA FORBES AVE & VAN BRAAM ST	CL 1 1	278	CIVIL LAYOUT PLANS FIFTH AVE - STA 485+50 TO STA 49	0+50 CL42	309	CIVIL LAYOUT PLANS FORBES AVE - STA 247+50 TO S	TA 251+50 RA29	338	REMOVAL & ADJUSTMENTS PLANS FIFTH AVE - STA 540+50 TO STA 545+50
RT_01	ID74	250	INTERSECTION DETAILS FORBES AVE & MILTENBERGER ST	CL12	279	CIVIL LAYOUT PLANS FIFTH AVE - STA 490+50 TO STA 49	6+50			RA30	339	REMOVAL & ADJUSTMENTS PLANS FIFTH AVE - STA 545+50 TO STA 551+50
.00\B	ID75	251	INTERSECTION DATA FORBES AVE & MILTENBERGER ST	CL13	280	CIVIL LAYOUT PLANS FIFTH AVE - STA 496+50 TO STA 50	2+50		REMOVAL & ADJUSTMENTS		340	REMOVAL & ADJUSTMENTS PLANS FIFTH AVE - STA 551+50 TO STA 555+50
02077	ID76	252	INTERSECTION DETAILS FORBES AVE & GIST ST	CL14	281	CIVIL LAYOUT PLANS FIFTH AVE - STA 502+50 TO STA 50	7+50 RA1	310	REMOVAL & ADJUSTMENTS P LEGEND	RAJZ	341	REMOVAL & ADJUSTMENTS PLANS FIFTH AVE - STA 555+50 TO STA 561+50
P\mo:	ID77	253	INTERSECTION DATA FORBES AVE & GIST ST	CL15	282	CIVIL LAYOUT PLANS FIFTH AVE - STA 507+50 TO STA 51	3+50	311	REMOVAL & ADJUSTMENTS P TABULATIONS	RASS	342	REMOVAL & ADJUSTMENTS PLANS FIFTH AVE - STA 561+50 TO STA 566+50
com.	ID78	254	INTERSECTION DETAILS FORBES AVE & JUMONVILLE ST	CL16	283	CIVIL LAYOUT PLANS FIFTH AVE - STA 513+50 TO STA 51	7+50 RA3	312	REMOVAL & ADJUSTMENTS P TABULATIONS	RAS4	343	REMOVAL & ADJUSTMENTS PLANS FORBES AVE - STA 122+00 TO STA 128+00
sh@de	ID79	255	INTERSECTION DATA FORBES AVE & JUMONVILLE ST	CL17	284	CIVIL LAYOUT PLANS FIFTH AVE - STA 517+50 TO STA 52	2+50 RA4	313	REMOVAL & ADJUSTMENTS P TABULATIONS	RAJS	344	REMOVAL & ADJUSTMENTS PLANS FORBES AVE - STA 128+00 TO STA 133+50
silic	ID80	256	INTERSECTION DETAILS FORBES AVE & SENECA ST	CL18	285	CIVIL LAYOUT PLANS FIFTH AVE - STA 522+50 TO STA 52	8+50 RA5	314	REMOVAL & ADJUSTMENTS P TABULATIONS	RASE	345	REMOVAL & ADJUSTMENTS PLANS FORBES AVE - STA 138+50 TO STA 143+50
seph.	ID81	257	INTERSECTION DATA FORBES AVE & SENECA ST	CL19	286	CIVIL LAYOUT PLANS FIFTH AVE - STA 528+50 TO STA 53	4+50 RA6	315	REMOVAL & ADJUSTMENTS P TABULATIONS	RAST	346	REMOVAL & ADJUSTMENTS PLANS FORBES AVE - STA 143+50 TO STA 149+50
a\j 08	ID82	258	INTERSECTION DETAILS FORBES AVE & MOULTRIE ST	CL20	287	CIVIL LAYOUT PLANS FIFTH AVE - STA 534+50 TO STA 54	0+50 RA7	316	REMOVAL & ADJUSTMENTS P TABULATIONS	RAJO	347	REMOVAL & ADJUSTMENTS PLANS FORBES AVE - STA 149+50 TO STA 154+50
s16_n	ID83	259	INTERSECTION DATA FORBES AVE & MOULTRIE ST	CL21	288	CIVIL LAYOUT PLANS FIFTH AVE - STA 540+50 TO STA 54	5+50 RA8	317	REMOVAL & ADJUSTMENTS P TABULATIONS	RASS	348	REMOVAL & ADJUSTMENTS PLANS FORBES AVE - STA 154+50 TO STA 159+50
om_ de	ID84	260	INTERSECTION DETAILS FORBES AVE & BIRMINGHAM BR	CL22	289	CIVIL LAYOUT PLANS FIFTH AVE - STA 545+50 TO STA 55	1+50 RA9	318	REMOVAL & ADJUSTMENTS PIFIFTH AVE - STA 433+50 TO ST	A 438+50	349	REMOVAL & ADJUSTMENTS PLANS FORBES AVE - STA 159+50 TO STA 164+50
"" g\dec	ID85	261	INTERSECTION DATA FORBES AVE & BIRMINGHAM BR	CL23	290	CIVIL LAYOUT PLANS FIFTH AVE - STA 551+50 TO STA 55	5+50 RA10	319	REMOVAL & ADJUSTMENTS PI FIFTH AVE - STA 438+50 TO ST		350	REMOVAL & ADJUSTMENTS PLANS FORBES AVE - STA 164+50 TO STA 169+50
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"jose	A	ECC	<i>)M</i>				THE PREPARATION OF THIS DOCUMENT HAS BEEN FINANCED II PART THROUGH A GRANT FROM TH	HE	(NOT FOR	DRAWN JMS CHECKED MES	PITTSBU	JRGH PENNSYLVANIA S RAPID TRANSIT UPTOWN TO OAKLAND
RATOR: E PATH:		Gulf Towe	er			UT	EDERAL TRANSIT ADMINISTRATIO J.S. DEPARTMENT OF RANSPORTATION, UNDER THE		CONSTRUCTION)	IN CHARGE <u>LAR</u>		INDEX OF DRAWINGS
OPER FILE		07 Grant St 5th Floor	·	NO. DATE		DESCRIPTION C	JRBAN MASS TRANSPORTATION AG DF 1964, AS AMENDED, FOR THE PORT AUTHORITY OF ALLEGHENY			DATE <u>05/01/24</u> SCALE A.S. SLICOMAN	Port A	uthority CONTRACT NO. BRT-001
	Pitts	sburgh, PA	19218			REVISIONS	COUNTY, PENNSYLVANIA.			AS SHOWN	I UIL COI	necting people to life DWG. NO. GN5 SHT. 5

		SHEET NUMBER	TITLE	DRAWING NUMBER	SHEET NUMBER	TITLE	DRAWING NUMBER	SHEET NUMBER	TITLE	DRAW) NUMB		
		REMOVAI	L & ADJUSTMENTS PLANS (CONT'D)			ROADWAY PLANS (CONT'D	<u>)</u>		ROADWAY PROFILES (CONT'D)		ROADWAY PROFILES (CONT'D)
	RA42	351	REMOVAL & ADJUSTMENTS PLANS FORBES AVE - STA 169+50 TO STA 173+50	PP24	380	ROADWAY PLANS FIFTH AVE - STA 555+50 TO STA 56	S1+50 PP53	409	ROADWAY PROFILE FIFTH AVE - STA 464+50 TO S	TA 470+50 PP8	440	ROADWAY PROFILE VAN BRAAM ST AND MILTENBERGER ST
	RA43	352	REMOVAL & ADJUSTMENTS PLANS FORBES AVE - STA 173+50 TO STA 177+50	PP25	381	ROADWAY PLANS FIFTH AVE - STA 561+50 TO STA 56	DDE4	410	ROADWAY PROFILE FIFTH AVE - STA 470+50 TO S	DDO	5 441	ROADWAY PROFILE GIST ST AND JUMONVILLE ST
	RA44	353	REMOVAL & ADJUSTMENTS PLANS FORBES AVE - STA 207+50 TO STA 213+50	PP26	382	ROADWAY PLANS FORBES AVE - STA 117+00 TO STA 12	DDEE	411	ROADWAY PROFILE FIFTH AVE - STA 475+50 TO S	DDO	5 442	ROADWAY PROFILE SENECA ST AND MOULTRIE ST
	RA45	354	REMOVAL & ADJUSTMENTS PLANS FORBES AVE - STA 213+50 TO STA 217+50	PP27	383	ROADWAY PLANS FORBES AVE - STA 122+00 TO STA 12	28+00 PP56	412	ROADWAY PROFILE FIFTH AVE - STA 480+50 TO S			
	RA46	355	REMOVAL & ADJUSTMENTS PLANS FORBES AVE - STA 221+50 TO STA 227+00	PP28	384	ROADWAY PLANS FORBES AVE - STA 128+00 TO STA 13	DDE 7	413	ROADWAY PROFILE FIFTH AVE - STA 485+50 TO S			KIRKPATRICK ST PARKING LOT
	RA47	356	REMOVAL & ADJUSTMENTS PLANS FORBES AVE - STA 242+50 TO STA 247+50	PP29	385	ROADWAY PLANS FORBES AVE - STA 133+50 TO STA 13	38+50 PP58	414	ROADWAY PROFILE FIFTH AVE - STA 490+50 TO S	TA 496+50 KP	443	KIRKPATRICK ST STORMWATER MANAGEMENT PLAN
				PP30	386	ROADWAY PLANS FORBES AVE - STA 138+50 TO STA 14	13+50 PP59	415	ROADWAY PROFILE FIFTH AVE - STA 496+50 TO S	TA 502+50 KP2	444	KIRKPATRICK ST SPECIAL DETAILS
			ROADWAY PLANS	PP31	387	ROADWAY PLANS FORBES AVE - STA 143+50 TO STA 14	19+50 PP60	416	ROADWAY PROFILE FIFTH AVE - STA 502+50 TO S	TA 507+50		
	PP1	357	ROADWAY PLANS FIFTH AVE - STA 433+50 TO STA 438+50	PP32	388	ROADWAY PLANS FORBES AVE - STA 149+50 TO STA 15	54+50 PP61	417	ROADWAY PROFILE FIFTH AVE - STA 507+50 TO S	TA 513+50		
	PP2	358	ROADWAY PLANS FIFTH AVE - STA 438+50 TO STA 443+50	PP33	389	ROADWAY PLANS FORBES AVE - STA 154+50 TO STA 15	59+50 PP62	418	ROADWAY PROFILE DIAMOND ST, CHATHAM SQ, WASHINGTO	ON PL, MAGEE ST		EROSION & SEDIMENTATION CONTROL PLANS
	PP3	359	ROADWAY PLANS FIFTH AVE - STA 443+50 TO STA 448+50	PP34	390	ROADWAY PLANS FORBES AVE - STA 159+50 TO STA 16	64+50 PP63	419	ROADWAY PROFILE LOGAN ST, STEVENSON ST, P	RIDE ST ES	445	EROSION & SEDIMENTATION CONTROL PLANS GENERAL NOTES
	PP4	360	ROADWAY PLANS FIFTH AVE - STA 448+50 TO STA 454+50	PP35	391	ROADWAY PLANS FORBES AVE - STA 164+50 TO STA 16	59+50 PP64	420	ROADWAY PROFILE PRIDE ST, MARION ST, VINE ST,	VAN BRAAM ST ES2	446	EROSION & SEDIMENTATION CONTROL PLANS GENERAL NOTES
	PP5	361	ROADWAY PLANS FIFTH AVE - STA 454+50 TO STA 458+50	PP36	392	ROADWAY PLANS FORBES AVE - STA 169+50 TO STA 17	'3+50 PP65	421	ROADWAY PROFILE MILTENBERGER ST, DINWIDDIE S	r, GIST ST, ESS	447	EROSION & SEDIMENTATION CONTROL PLANS SEQUENCE OF CONSTRUCTION
	PP6	362	ROADWAY PLANS FIFTH AVE - STA 458+50 TO STA 464+50	PP37	393	ROADWAY PLANS FORBES AVE - STA 173+50 TO STA 17	7+50 PP66	422	ROADWAY PROFILE WYANDOTTE ST, SENECA ST, MO	ULTRIE ST ES4	448	EROSION & SEDIMENTATION CONTROL PLANS DETAILS
	PP7	363	ROADWAY PLANS FIFTH AVE - STA 464+50 TO STA 470+50	PP38	394	ROADWAY PLANS FORBES AVE - STA 177+50 TO STA 18	32+50 PP67	423	ROADWAY PROFILE KIRKPATRICK ST, BIRMING	HAM BR ESS	449	EROSION & SEDIMENTATION CONTROL PLANS DETAILS
	PP8	364	ROADWAY PLANS FIFTH AVE - STA 470+50 TO STA 475+50	PP39	395	ROADWAY PLANS FORBES AVE - STA 207+50 TO STA 21	3+50 PP68	424	ROADWAY PROFILE FORBES AVE - STA 119+00 TO S	STA 122+00 ES6	450	EROSION & SEDIMENTATION CONTROL PLANS DETAILS
- dgn	PP9	365	ROADWAY PLANS FIFTH AVE - STA 475+50 TO STA 480+50	PP40	396	ROADWAY PLANS FORBES AVE - STA 213+50 TO STA 21	7+50 PP69	425	ROADWAY PROFILE FORBES AVE - STA 122+00 TO S	STA 128+00 EST	451	EROSION & SEDIMENTATION CONTROL PLANS DETAILS
0D04	PP10	366	ROADWAY PLANS FIFTH AVE - STA 480+50 TO STA 485+50	PP41	397	ROADWAY PLANS FORBES AVE - STA 221+50 TO STA 22	27+00 PP70	426	ROADWAY PROFILE FORBES AVE - STA 128+00 TO S	STA 133+50 ES8	452	EROSION & SEDIMENTATION CONTROL PLANS DETAILS
-RD- I	PP11	367	ROADWAY PLANS FIFTH AVE - STA 485+50 TO STA 490+50	PP42	398	ROADWAY PLANS FORBES AVE - STA 227+00 TO STA 23	32+00 PP71	427	ROADWAY PROFILE FORBES AVE - STA 133+50 TO	STA 138+50 ESS	453	EROSION & SEDIMENTATION CONTROL PLANS DETAILS
T_01	PP12	368	ROADWAY PLANS FIFTH AVE - STA 490+50 TO STA 496+50	PP43	399	ROADWAY PLANS FORBES AVE - STA 232+00 TO STA 23	37+50 PP72	428	ROADWAY PROFILE FORBES AVE - STA 138+50 TO	STA 143+50 ES1	454	EROSION & SEDIMENTATION CONTROL PLANS DETAILS
00\BF	PP13	369	ROADWAY PLANS FIFTH AVE - STA 496+50 TO STA 502+50	PP44	400	ROADWAY PLANS FORBES AVE - STA 237+50 TO STA 24	PP73	429	ROADWAY PROFILE FORBES AVE - STA 143+50 TO	STA 149+50 ES1	1 455	EROSION & SEDIMENTATION CONTROL PLANS DETAILS
02077	PP14	370	ROADWAY PLANS FIFTH AVE - STA 502+50 TO STA 507+50	PP45	401	ROADWAY PLANS FORBES AVE - STA 242+50 TO STA 24	17+50 PP74	430	ROADWAY PROFILE FORBES AVE - STA 149+50 TO	STA 154+50 ES1	2 456	EROSION & SEDIMENTATION CONTROL PLANS FIFTH AVE - STA 433+50 TO STA 438+50
)p\mo	PP15	371	ROADWAY PLANS FIFTH AVE - STA 507+50 TO STA 513+50	PP46	402	ROADWAY PLANS FORBES AVE - STA 247+50 TO STA 25	51+50 PP75	431	ROADWAY PROFILE FORBES AVE - STA 154+50 TO S	STA 159+50 ES1	3 457	EROSION & SEDIMENTATION CONTROL PLANS FIFTH AVE - STA 438+50 TO STA 443+50
o moc	PP16	372	ROADWAY PLANS FIFTH AVE - STA 513+50 TO STA 517+50				PP76	432	ROADWAY PROFILE FORBES AVE - STA 159+50 TO S	STA 164+50 ES1	458	EROSION & SEDIMENTATION CONTROL PLANS FIFTH AVE - STA 443+50 TO STA 448+50
h@de	PP17	373	ROADWAY PLANS FIFTH AVE - STA 517+50 TO STA 522+50			ROADWAY PROFILES	PP77	433	ROADWAY PROFILE FORBES AVE - STA 164+50 TO S	STA 169+50 ES1	459	EROSION & SEDIMENTATION CONTROL PLANS FIFTH AVE - STA 448+50 TO STA 454+50
silic	PP18	374	ROADWAY PLANS FIFTH AVE - STA 522+50 TO STA 528+50	PP47	403	ROADWAY PROFILE FIFTH AVE - STA 433+50 TO STA 43	8+50 PP78	434	ROADWAY PROFILE FORBES AVE - STA 169+50 TO	STA 173+50 ES1	460	EROSION & SEDIMENTATION CONTROL PLANS FIFTH AVE - STA 454+50 TO STA 458+50
eph.	PP19	375	ROADWAY PLANS FIFTH AVE - STA 528+50 TO STA 534+50	PP48	404	ROADWAY PROFILE FIFTH AVE - STA 438+50 TO STA 44	3+50 PP79	435	ROADWAY PROFILE FORBES AVE - STA 173+50 TO	STA 177+50 ES1	7 461	EROSION & SEDIMENTATION CONTROL PLANS FIFTH AVE - STA 458+50 TO STA 464+50
d\jos	PP20	376	ROADWAY PLANS FIFTH AVE - STA 534+50 TO STA 540+50	PP49	405	ROADWAY PROFILE FIFTH AVE - STA 443+50 TO STA 44	8+50 PP80	436	ROADWAY PROFILE FORBES AVE - STA 177+50 TO	STA 182+50 ES1	3 462	EROSION & SEDIMENTATION CONTROL PLANS FIFTH AVE - STA 464+50 TO STA 470+50
16_n	PP21	377	ROADWAY PLANS FIFTH AVE - STA 540+50 TO STA 545+50	PP50	406	ROADWAY PROFILE FIFTH AVE - STA 448+50 TO STA 45	4+50 PP81	437	ROADWAY PROFILE BOYD ST, MCNULTY ST, CHA	THAM SQ ES1	9 463	EROSION & SEDIMENTATION CONTROL PLANS FIFTH AVE - STA 470+50 TO STA 475+50
om_ ds	PP22	378	ROADWAY PLANS FIFTH AVE - STA 545+50 TO STA 551+50	PP51	407	ROADWAY PROFILE FIFTH AVE - STA 454+50 TO STA 45	8+50 PP82	438	ROADWAY PROFILE MAGEE ST AND STEVENSOI		464	EROSION & SEDIMENTATION CONTROL PLANS FIFTH AVE - STA 475+50 TO STA 480+50
) dec	PP23	379	ROADWAY PLANS FIFTH AVE - STA 551+50 TO STA 555+50	PP52	408	ROADWAY PROFILE FIFTH AVE - STA 458+50 TO STA 46	4+50 PP83	439	ROADWAY PROFILE PRIDE ST AND MARION	ST ES2	1 465	EROSION & SEDIMENTATION CONTROL PLANS FIFTH AVE - STA 480+50 TO STA 485+50
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1 LE		7 Grant Stre 5th Floor		NO. DATE		U	RBAN MASS TRANSPORTATION F 1964, AS AMENDED, FOR THE ORT AUTHORITY OF ALLEGHEN	E	CONSTRUCTION)	DATE <u>05/01/24</u> SCALE	Dar	
	Pitts	burgh, PA 1	5219	INO. DATE			OUNTY, PENNSYLVANIA.			AS SHOWN	rur	t Authority CONTRACT NO. BRT-001 DWG. NO. GN6 SHT. 6

		SHEET NUMBER		TITLE	DRAWING NUMBER	SHEET NUMBER	TITLE	DRAWING NUMBER	SHEET NUMBER	TITLE	Ţ	DRAWING NUMBER	SHEET NUMBER	TITLE
	EROSI	ON & SE	<u>EDIMENTATI</u>	ON CONTROL PLANS (CONT'D)	EROS	SION & S	EDIMENTATION CONTROL PLANS	(CONT' D)		UTILITY PLANS (CO	NT' D)			PWSA RELOCATION PLANS (CONT'D)
	ES22	466	EROSION & S	SEDIMENTATION CONTROL PLANS - STA 485+50 TO STA 490+50	ES53	497	EROSION & SEDIMENTATION CONTROL FORBES AVE - STA 232+00 TO STA 2		526	UTILITY PLANS FORBES AVE - STA 128+00 TO S	STA 133+50	PWSA5	555	PWSA WATERLINE RELOCATION PLAN FIFTH AVE - STA 444+50
	ES23	467	EROSION & S	SEDIMENTATION CONTROL PLANS - STA 490+50 TO STA 496+50	ES54	498	EROSION & SEDIMENTATION CONTROL FORBES AVE - STA 242+50 TO STA 2	PLANS 247+50 UT29	527	UTILITY PLANS FORBES AVE - STA 133+50 TO S		PWSA6	556	PWSA WATERLINE RELOCATION PLAN FIFTH AVE & MAGEE ST - STA 448+00
	ES24	468		SEDIMENTATION CONTROL PLANS - STA 496+50 TO STA 502+50				UT30	528	UTILITY PLANS FORBES AVE - STA 138+50 TO S		PWSA7	557	PWSA WATERLINE RELOCATION PLAN FIFTH AVE & WYANDOTTE ST - STA 478+00
	ES25	469	EROSION & S	SEDIMENTATION CONTROL PLANS - STA 502+50 TO STA 507+50			UTILITY PLANS	UT31	529	UTILITY PLANS FORBES AVE - STA 143+50 TO S	STA 149+50	PWSA8	558	PWSA WATERLINE RELOCATION PLAN FIFTH AVE - STA 471+00 TO STA 481+00
	ES26	470		SEDIMENTATION CONTROL PLANS - STA 507+50 TO STA 513+50	UT1	499	UTILITY PLANS GENERAL NOTES & UTILITY LEGEN	NDS UT32	530	UTILITY PLANS FORBES AVE - STA 149+50 TO S	STA 154+50	PWSA9	559	PWSA WATERLINE RELOCATION PLAN FIFTH AVE - STA 490+00
	ES27	471		SEDIMENTATION CONTROL PLANS - STA 513+50 TO STA 517+50	UT2	500	UTILITY PLANS FIFTH AVE - STA 433+50 TO STA 4	38+50 UT33	531	UTILITY PLANS FORBES AVE - STA 154+50 TO S	STA 159+50	PWSA10	560	PWSA WATERLINE RELOCATION PLAN FIFTH AVE - STA 495+00
	ES28	472		SEDIMENTATION CONTROL PLANS - STA 528+50 TO STA 534+50	UT 3	501	UTILITY PLANS FIFTH AVE - STA 438+50 TO STA 4	43+50 UT34	532	UTILITY PLANS FORBES AVE - STA 159+50 TO S	STA 164+50	PWSA11	561	PWSA WATERLINE RELOCATION PLAN FIFTH AVE - STA 503+00
	ES29	473		SEDIMENTATION CONTROL PLANS - STA 522+50 TO STA 528+50	UT4	502	UTILITY PLANS FIFTH AVE - STA 443+50 TO STA 4	48+50 UT35	533	UTILITY PLANS FORBES AVE - STA 164+50 TO S	STA 169+50	PWSA12	562	PWSA WATERLINE RELOCATION PLAN FIFTH AVE - STA 511+50
	ES30	474		SEDIMENTATION CONTROL PLANS - STA 528+50 TO STA 534+50	UT5	503	UTILITY PLANS FIFTH AVE - STA 448+50 TO STA 4	54+50 UT36	534	UTILITY PLANS FORBES AVE - STA 169+50 TO S	STA 173+50	PWSA13	563	PWSA WATERLINE RELOCATION PLAN FIFTH AVE - STA 517+00
	ES31	475	EROSION & S	SEDIMENTATION CONTROL PLANS - STA 534+50 TO STA 540+50	UT6	504	UTILITY PLANS FIFTH AVE - STA 454+50 TO STA 4	58+50 UT37	535	UTILITY PLANS FORBES AVE - STA 173+50 TO S	STA 177+50	PWSA14	564	PWSA WATERLINE RELOCATION PLAN FIFTH AVE - STA 539+00
	ES32	476		SEDIMENTATION CONTROL PLANS - STA 540+50 TO STA 545+50	UT7	505	UTILITY PLANS FIFTH AVE - STA 458+50 TO STA 4	64+50 UT38	536	UTILITY PLANS FORBES AVE - STA 177+50 TO S	STA 182+50	PWSA15	565	PWSA WATERLINE RELOCATION PLAN FIFTH AVE - STA 542+50
	ES33	477		SEDIMENTATION CONTROL PLANS - STA 545+50 TO STA 551+50	UT8	506	UTILITY PLANS FIFTH AVE - STA 464+50 TO STA 4	70+50 UT39	537	UTILITY PLANS FORBES AVE - STA 182+50 TO S	STA 187+50	PWSA16	566	PWSA WATERLINE RELOCATION PLAN FORBES AVE & PRIDE ST - STA 146+00
	ES34	478		SEDIMENTATION CONTROL PLANS - STA 551+50 TO STA 555+50	UT9	507	UTILITY PLANS FIFTH AVE - STA 470+50 TO STA 4	75+50 UT40	538	UTILITY PLANS FORBES AVE - STA 187+50 TO S	STA 193+50	PWSA17	567	PWSA WATERLINE RELOCATION PLAN FORBES AVE - STA 153+00 TO STA 171+00
	ES35	479		SEDIMENTATION CONTROL PLANS - STA 555+50 TO STA 561+50	UT10	508	UTILITY PLANS FIFTH AVE - STA 475+50 TO STA 4	80+50 UT41	539	UTILITY PLANS FORBES AVE - STA 193+50 TO S	STA 198+50	PWSA18	568	PWSA WATERLINE RELOCATION PLAN FORBES AVE - STA 161+00 & 166+50
	ES36	480		SEDIMENTATION CONTROL PLANS - STA 561+50 TO STA 566+50	UT11	509	UTILITY PLANS FIFTH AVE - STA 480+50 TO STA 4	85+50 UT42	540	UTILITY PLANS FORBES AVE - STA 198+50 TO S	STA 202+50	PWSA19	569	PWSA WATERLINE RELOCATION PLAN FORBES AVE - STA 175+00
	ES37	481		SEDIMENTATION CONTROL PLANS - STA 117+00 TO STA 122+00	UT12	510	UTILITY PLANS FIFTH AVE - STA 485+50 TO STA 4	90+50 UT43	541	UTILITY PLANS FORBES AVE - STA 202+50 TO S	STA 207+50	PWSA20	570	PWSA WATERLINE RELOCATION PLAN FORBES AVE & HALKET ST - STA 217+00
. dgn	ES38	482	EROSION & S FORBES AVE	SEDIMENTATION CONTROL PLANS - STA 128+00 TO STA 133+50	UT13	511	UTILITY PLANS FIFTH AVE - STA 490+50 TO STA 4	96+50 UT44	542	UTILITY PLANS FORBES AVE - STA 207+50 TO S	STA 213+50	PWSA21	571	PWSA WATERLINE RELOCATION PLAN FORBES AVE & MCKEE PLACE - STA 224+00
10D05	ES39	483	EROSION & S FORBES AVE	SEDIMENTATION CONTROL PLANS - STA 128+00 TO STA 133+50	UT14	512	UTILITY PLANS FIFTH AVE - STA 496+50 TO STA 5	02+50 UT45	543	UTILITY PLANS FORBES AVE - STA 213+50 TO S	STA 217+50			
-RD-	ES40	484	EROSION & S FORBES AVE	SEDIMENTATION CONTROL PLANS - STA 133+50 TO STA 138+50	UT15	513	UTILITY PLANS FIFTH AVE - STA 502+50 TO STA 5	07+50 UT46	544	UTILITY PLANS FORBES AVE - STA 217+50 TO S	STA 221+50			LANDSCAPING PLANS
1T_01	ES41	485	EROSION & S FORBES AVE	SEDIMENTATION CONTROL PLANS - STA 138+50 TO STA 143+50	UT16	514	UTILITY PLANS FIFTH AVE - STA 507+50 TO STA 5	13+50 UT47	545	UTILITY PLANS FORBES AVE - STA 221+50 TO S	STA 227+00	LS1	572	LANDSCAPING PLANS DETAILS
00\Bf	ES42	486	EROSION & S FORBES AVE	SEDIMENTATION CONTROL PLANS - STA 143+50 TO STA 149+50	UT17	515	UTILITY PLANS FIFTH AVE - STA 513+50 TO STA 5	17+50 UT48	546	UTILITY PLANS FORBES AVE - STA 227+00 TO S	STA 232+00	LS2	573	LANDSCAPING PLANS DETAILS
72077	ES43	487	FORBES AVE	SEDIMENTATION CONTROL PLANS - STA 149+50 TO STA 154+50	UT18	516	UTILITY PLANS FIFTH AVE - STA 517+50 TO STA 5	22+50 UT49	547	UTILITY PLANS FORBES AVE - STA 232+00 TO S	STA 237+50	LS3	574	LANDSCAPING PLANS FIFTH AVE - STA 433+50 TO STA 438+50
)p\mo:	ES44	488	FORBES AVE	SEDIMENTATION CONTROL PLANS - STA 154+50 TO STA 159+50	UT19	517	UTILITY PLANS FIFTH AVE - STA 522+50 TO STA 5	28+50 UT50	548	UTILITY PLANS FORBES AVE - STA 237+50 TO S	STA 242+50	LS4	575	LANDSCAPING PLANS FIFTH AVE - STA 438+50 TO STA 443+50
o • uoo	ES45	489	FORBES AVE	SEDIMENTATION CONTROL PLANS - STA 159+50 TO STA 164+50	UT20	518	UTILITY PLANS FIFTH AVE - STA 528+50 TO STA 5	34+50 UT51	549	UTILITY PLANS FORBES AVE - STA 242+50 TO S	STA 247+50	LS5	576	LANDSCAPING PLANS FIFTH AVE - STA 443+50 TO STA 448+50
th@de	ES46	490	FORBES AVE	SEDIMENTATION CONTROL PLANS - STA 164+50 TO STA 169+50	UT21	519	UTILITY PLANS FIFTH AVE - STA 534+50 TO STA 5	40+50 UT52	550	UTILITY PLANS FORBES AVE - STA 247+50 TO S	STA 251+50	LS6	577	LANDSCAPING PLANS FIFTH AVE - STA 448+50 TO STA 454+50
01110	ES47	491	FORBES AVE	SEDIMENTATION CONTROL PLANS - STA 169+50 TO STA 173+50	UT22	520	UTILITY PLANS FIFTH AVE - STA 540+50 TO STA 5	45+50				LS7	578	LANDSCAPING PLANS FIFTH AVE - STA 454+50 TO STA 458+50
eph.	ES48	492	FORBES AVE	SEDIMENTATION CONTROL PLANS - STA 173+50 TO STA 177+50	UT23	521	UTILITY PLANS FIFTH AVE - STA 545+50 TO STA 5	51+50		PWSA RELOCATION P		LS8	579	LANDSCAPING PLANS FIFTH AVE - STA 458+50 TO STA 464+50
a\jos	ES49	493	FORBES AVE	SEDIMENTATION CONTROL PLANS - STA 177+50 TO STA 182+50	UT24	522	UTILITY PLANS FIFTH AVE - STA 551+50 TO STA 5	55+50 PWSA1	551	PWSA WATERLINE RELOCATIO PWSA DETAILS		LS9	580	LANDSCAPING PLANS FIFTH AVE - STA 464+50 TO STA 470+50
16_n	ES50	494		SEDIMENTATION CONTROL PLANS - STA 207+50 TO STA 213+50	UT25	523	UTILITY PLANS FIFTH AVE - STA 555+50 TO STA 5		552	PWSA WATERLINE RELOCATIO PWSA DETAILS		LS10	581	LANDSCAPING PLANS FIFTH AVE - STA 470+50 TO STA 475+50
om_ds	ES51	495		SEDIMENTATION CONTROL PLANS - STA 213+50 TO STA 217+50	UT26	524	UTILITY PLANS FIFTH AVE - STA 561+50 TO STA 5	66+50 PWSA3	553	PWSA WATERLINE RELOCATIO PWSA DETAILS		LS11	582	LANDSCAPING PLANS FIFTH AVE - STA 475+50 TO STA 480+50
g\dec	ES52	496	FORBES AVE	SEDIMENTATION CONTROL PLANS - STA 221+50 TO STA 227+00	UT27	525	UTILITY PLANS FORBES AVE - STA 122+00 TO STA 1	28+00 PWSA4	554	PWSA WATERLINE RELOCATIO FIFTH AVE - STA 441+	N PLAN 00	LS12	583	LANDSCAPING PLANS FIFTH AVE - STA 480+50 TO STA 485+50
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E PAT		Gulf Tower	r					FEDERAL TRANSIT ADMINISTRA U.S. DEPARTMENT OF TRANSPORTATION, UNDER THE		CONSTRUCTION)	IN CHARGE <u>LAR</u>			INDEX OF DRAWINGS
FILI		7 Grant Str 5th Floor			NO. DATE		DESCRIPTION	URBAN MASS TRANSPORTATIO OF 1964, AS AMENDED, FOR TH PORT AUTHORITY OF ALLEGHE	느 ㅣ		DATE 05/01/24 SCALE		Port I	Authority CONTRACT NO. BRT-001
	PILLSD	ourgh, PA 1	15219				REVISIONS	COUNTY, PENNSYLVANIA.		·	AS SHOWI	IN	I UIL F	onnecting people to life DWG. NO. GN7 SHT. 7

	RAWING UMBER	SHEET NUMBER	TITLE	DRAWING NUMBER	SHEET NUMBER	TITLE	DRAWING NUMBER	SHEET NUMBE			DRAWING NUMBER	SHEET NUMBER	TITLE
- [LANDSCAPING PLANS (CONT'D)		SIGNING 8	& PAVEMENT MARKING PLANS	(CONT'D)	SIGNI	NG & PAVEMENT MARKING PL	ANS (CONT'D)		SIGNING	& PAVEMENT MARKING PLANS (CONT'D)
	LS13	584	LANDSCAPING PLANS FIFTH AVE - STA 485+50 TO STA 490+50	SN8	611	SIGNING & PAVEMENT MARKING PL TABULATION SHEET	ANS SN39	642	SIGNING & PAVEMENT MARKIN SIXTH AVE - STA 624+50 TO S		SN70	673	SIGNING & PAVEMENT MARKING PLANS FORBES AVE - STA 138+50 TO STA 143+50
	LS14	585	LANDSCAPING PLANS FIFTH AVE - STA 490+50 TO STA 495+50	SN9	612	SIGNING & PAVEMENT MARKING PL TABULATION SHEET	ANS SN40	643	SIGNING & PAVEMENT MARKIN FIFTH AVE - STA 428+50 TO S		SN71	674	SIGNING & PAVEMENT MARKING PLANS FORBES AVE - STA 143+50 TO STA 149+50
	LS15	586	LANDSCAPING PLANS FIFTH AVE - STA 495+50 TO STA 502+50	SN10	613	SIGNING & PAVEMENT MARKING PL TABULATION SHEET	ANS SN41	644	SIGNING & PAVEMENT MARKIN SIXTH AVE - STA 631+50 TO S		SN72	675	SIGNING & PAVEMENT MARKING PLANS FORBES AVE - STA 149+50 TO STA 154+50
	LS16	587	LANDSCAPING PLANS FIFTH AVE - STA 502+50 TO STA 507+50	SN11	614	SIGNING & PAVEMENT MARKING PL TABULATION SHEET	ANS SN42	645	SIGNING & PAVEMENT MARKIN FIFTH AVE - STA 433+50 TO S		SN73	676	SIGNING & PAVEMENT MARKING PLANS FORBES AVE - STA 154+50 TO STA 159+50
	LS17	588	LANDSCAPING PLANS FIFTH AVE - STA 507+50 TO STA 513+50	SN12	615	SIGNING & PAVEMENT MARKING PL TABULATION SHEET	ANS SN43	646	SIGNING & PAVEMENT MARKIN FIFTH AVE - STA 438+50 TO S		SN74	677	SIGNING & PAVEMENT MARKING PLANS FORBES AVE - STA 159+50 TO STA 164+50
	LS18	589	LANDSCAPING PLANS FIFTH AVE - STA 513+50 TO STA 517+50	SN13	616	SIGNING & PAVEMENT MARKING PL TABULATION SHEET	ANS SN44	647	SIGNING & PAVEMENT MARKIN FIFTH AVE - STA 443+50 TO S		SN75	678	SIGNING & PAVEMENT MARKING PLANS FORBES AVE - STA 164+50 TO STA 169+50
	LS19	590	LANDSCAPING PLANS FIFTH AVE - STA 517+50 TO STA 522+50	SN14	617	SIGNING & PAVEMENT MARKING PL TABULATION SHEET	ANS SN45	648	SIGNING & PAVEMENT MARKIN FIFTH AVE - STA 448+50 TO S		SN76	679	SIGNING & PAVEMENT MARKING PLANS FORBES AVE - STA 169+50 TO STA 173+50
	LS20	591	LANDSCAPING PLANS FIFTH AVE - STA 551+50 TO STA 555+50	SN15	618	SIGNING & PAVEMENT MARKING PL SUMMARY OF ROADWAY SIGNS	ANS SN46	649	SIGNING & PAVEMENT MARKIN FIFTH AVE - STA 454+50 TO S		SN77	680	SIGNING & PAVEMENT MARKING PLANS FORBES AVE - STA 173+50 TO STA 177+50
	LS21	592	LANDSCAPING PLANS FIFTH AVE - STA 555+50 TO STA 561+50	SN16	619	SIGNING & PAVEMENT MARKING PL SUMMARY OF ROADWAY SIGNS	ANS SN47	650	SIGNING & PAVEMENT MARKIN FIFTH AVE - STA 458+50 TO S		SN78	681	SIGNING & PAVEMENT MARKING PLANS FORBES AVE - STA 177+50 TO STA 182+50
	LS22	593	LANDSCAPING PLANS FIFTH AVE - STA 561+50 TO STA 566+50	SN17	620	SIGNING & PAVEMENT MARKING PL SUMMARY OF ROADWAY SIGNS	ANS SN48	651	SIGNING & PAVEMENT MARKIN FIFTH AVE - STA 464+50 TO S		SN79	682	SIGNING & PAVEMENT MARKING PLANS FORBES AVE - STA 182+50 TO STA 187+50
	LS23	594	LANDSCAPING PLANS FORBES AVE - STA 138+50 TO STA 143+50	SN18	621	SIGNING & PAVEMENT MARKING PL SUMMARY OF ROADWAY SIGNS	ANS SN49	652	SIGNING & PAVEMENT MARKIN FIFTH AVE - STA 470+50 TO S		SN80	683	SIGNING & PAVEMENT MARKING PLANS FORBES AVE - STA 202+50 TO STA 207+50
	LS24	595	LANDSCAPING PLANS FORBES AVE - STA 143+50 TO STA 149+50	SN19	622	SIGNING & PAVEMENT MARKING PL SUMMARY OF ROADWAY SIGNS	ANS SN50	653	SIGNING & PAVEMENT MARKIN FIFTH AVE - STA 475+50 TO S		SN81	684	SIGNING & PAVEMENT MARKING PLANS FORBES AVE - STA 207+50 TO STA 213+50
	LS25	596	LANDSCAPING PLANS FORBES AVE - STA 149+50 TO STA 154+50	SN20	623	SIGNING & PAVEMENT MARKING PL SUMMARY OF ROADWAY SIGNS	ANS SN51	654	SIGNING & PAVEMENT MARKIN FIFTH AVE - STA 480+50 TO S		SN82	685	SIGNING & PAVEMENT MARKING PLANS FORBES AVE - STA 213+50 TO STA 217+50
	LS26	597	LANDSCAPING PLANS FORBES AVE - STA 154+50 TO STA 159+50	SN21	624	SIGNING & PAVEMENT MARKING PL SUMMARY OF ROADWAY SIGNS	ANS SN52	655	SIGNING & PAVEMENT MARKIN FIFTH AVE - STA 485+50 TO S		SN83	686	SIGNING & PAVEMENT MARKING PLANS FORBES AVE - STA 217+50 TO STA 221+50
	LS27	598	LANDSCAPING PLANS FORBES AVE - STA 159+50 TO STA 164+50	SN22	625	SIGNING & PAVEMENT MARKING PL SUMMARY OF ROADWAY SIGNS	ANS SN53	656	SIGNING & PAVEMENT MARKIN FIFTH AVE - STA 490+50 TO S		SN84	687	SIGNING & PAVEMENT MARKING PLANS FORBES AVE - STA 221+50 TO STA 227+00
	LS28	599	LANDSCAPING PLANS FORBES AVE - STA 164+50 TO STA 169+50	SN23	626	SIGNING & PAVEMENT MARKING PL SUMMARY OF ROADWAY SIGNS	ANS SN54	657	SIGNING & PAVEMENT MARKIN FIFTH AVE - STA 496+50 TO S		SN85	688	SIGNING & PAVEMENT MARKING PLANS FORBES AVE - STA 227+00 TO STA 232+00
· dgn	LS29	600	LANDSCAPING PLANS FORBES AVE - STA 169+50 TO STA 174+50	SN24	627	SIGNING & PAVEMENT MARKING PL SUMMARY OF ROADWAY SIGNS	ANS SN55	658	SIGNING & PAVEMENT MARKIN FIFTH AVE - STA 502+50 TO S		SN86	689	SIGNING & PAVEMENT MARKING PLANS FORBES AVE - STA 232+00 TO STA 237+50
90001	LS30	601	LANDSCAPING PLANS FORBES AVE - STA 174+50 TO STA 178+50	SN25	628	SIGNING & PAVEMENT MARKING PL SUMMARY OF ROADWAY SIGNS	ANS SN56	659	SIGNING & PAVEMENT MARKIN FIFTH AVE - STA 507+50 TO S		SN87	690	SIGNING & PAVEMENT MARKING PLANS FORBES AVE - STA 237+50 TO STA 242+50
RD 1	LS31	602	LANDSCAPING PLANS FORBES AVE - STA 207+50 TO STA 213+50	SN26	629	SIGNING & PAVEMENT MARKING PL SUMMARY OF ROADWAY SIGNS	ANS SN57	660	SIGNING & PAVEMENT MARKIN FIFTH AVE - STA 513+50 TO S		SN88	691	SIGNING & PAVEMENT MARKING PLANS FORBES AVE - STA 242+50 TO STA 247+50
T_01	LS32	603	LANDSCAPING PLANS FORBES AVE - STA 213+50 TO STA 217+50	SN27	630	SIGNING & PAVEMENT MARKING PL SUMMARY OF ROADWAY SIGNS	ANS SN58	661	SIGNING & PAVEMENT MARKIN FIFTH AVE - STA 517+50 TO S	NG PLANS STA 522+50	SN89	692	SIGNING & PAVEMENT MARKING PLANS FORBES AVE - STA 247+50 TO STA 251+50
00\BF				SN28	631	SIGNING & PAVEMENT MARKING PL SUMMARY OF ROADWAY SIGNS	ANS SN59	662	SIGNING & PAVEMENT MARKIN FIFTH AVE - STA 522+50 TO S		SN90	693	SIGNING & PAVEMENT MARKING PLANS FORBES AVE - STA 251+50 TO STA 256+50
72077				SN29	632	SIGNING & PAVEMENT MARKING PL SUMMARY OF ROADWAY SIGNS	ANS SN60	663	SIGNING & PAVEMENT MARKIN FIFTH AVE - STA 528+50 TO S		SN91	694	SIGNING & PAVEMENT MARKING PLANS BELLEFIELD AVE
)P\mo				SN30	633	SIGNING & PAVEMENT MARKING PL SUMMARY OF ROADWAY SIGNS	ANS SN61	664	SIGNING & PAVEMENT MARKIN FIFTH AVE - STA 534+50 TO S				
o moo			SIGNING & PAVEMENT MARKING PLANS	SN31	634	SIGNING & PAVEMENT MARKING PL SUMMARY OF ROADWAY SIGNS	ANS SN62	665	SIGNING & PAVEMENT MARKIN FIFTH AVE - STA 540+50 TO S	NG PLANS STA 545+50			
høded	SN1	604	SIGNING & PAVEMENT MARKING PLANS GENERAL NOTES	SN32	635	SIGNING & PAVEMENT MARKING PL SUMMARY OF ROADWAY SIGNS	ANS SN63	666	SIGNING & PAVEMENT MARKIN FIFTH AVE - STA 545+50 TO S	NG PLANS STA 551+50			LIGHTING PLANS
i - i c	SN2	605	SIGNING & PAVEMENT MARKING PLANS SUMMARY OF QUANTITIES	SN33	636	SIGNING & PAVEMENT MARKING PL DETAILS	ANS SN64	667	SIGNING & PAVEMENT MARKIN FIFTH AVE - STA 551+50 TO S	STA 555+50	LP1	695	LIGHTING PLANS GENERAL NOTES
eph.	SN3	606	SIGNING & PAVEMENT MARKING PLANS SUMMARY OF QUANTITIES	SN34	637	SIGNING & PAVEMENT MARKING PL DETAILS	31100	668	SIGNING & PAVEMENT MARKIN FIFTH AVE - STA 555+50 TO	NG PLANS STA 561+50	LP2	696	LIGHTING PLANS TABULATION SHEET
d\jos	SN4	607	SIGNING & PAVEMENT MARKING PLANS SUMMARY OF QUANTITIES	SN35	638	SIGNING & PAVEMENT MARKING PL DETAILS	21100	669	SIGNING & PAVEMENT MARKIN FIFTH AVE - STA 561+50 TO S	STA 566+50	LP3	697	LIGHTING PLANS DETAIL SHEET
16_n	SN5	608	SIGNING & PAVEMENT MARKING PLANS TABULATION SHEET	SN36	639	SIGNING & PAVEMENT MARKING PL DETAILS	2001	670	SIGNING & PAVEMENT MARKIN FORBES AVE - STA 122+00 TO	STA 128+00	LP4	698	LIGHTING PLANS DETAIL SHEET
om_ds	SN6	609	SIGNING & PAVEMENT MARKING PLANS TABULATION SHEET	SN37	640	SIGNING & PAVEMENT MARKING PL DETAILS	2008	671	SIGNING & PAVEMENT MARKIN FORBES AVE - STA 128+00 TO	STA 133+50	LP5	699	LIGHTING PLANS DETAIL SHEET
)\dec	SN7	610	SIGNING & PAVEMENT MARKING PLANS TABULATION SHEET	SN38	641	SIGNING & PAVEMENT MARKING PL DETAILS	ANS SN69	672	SIGNING & PAVEMENT MARKIN FORBES AVE - STA 133+50 TO		LP6	700	LIGHTING PLANS DETAIL SHEET
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1 LE		7 Grant S 5th Floo	or	NO. DATE		DESCRIPTION F	JRBAN MASS TRANSPORTATION OF 1964, AS AMENDED, FOR THE PORT AUTHORITY OF ALLEGHEN	E I	CONSTRUCTION)	DATE <u>05/01/24</u> SCALE		Dort A	
	Pitts	burgh, P	A 15219	DATE			COUNTY, PENNSYLVANIA.	-		AS SHOW	'N	FUIL A	Authority CONTRACT NO. BRT-001 DWG. NO. GN8 SHT. 8

	AWING JMBER	SHEET NUMBER	TITLE	DRAWING NUMBER	SHEET NUMBER	TITLE	DRAWING NUMBER	SHEET NUMBER	TITLE	DRAWING NUMBER	SHEET NUMBER	TITLE
PLOTT			LIGHTING PLANS (CONT'D)			LIGHTING PLANS (CONT'D)			ARCHITECTURAL PLANS (CONT'D)			STRUCTURAL PLANS (CONT'D)
	LP7	701	LIGHTING PLANS FIFTH AVE - STA 433+50 TO STA 438+50	LP38	732	LIGHTING PLANS FORBES AVE - STA 159+50 TO STA 164+50	AR032	761	ARCHITECTURAL PLANS 22 SOHO STATION-OVERALL SITE PLAN	ST6	790	STRUCTURAL PLANS BUS STATION 60' - PART 1
	LP8	702	LIGHTING PLANS FIFTH AVE - STA 438+50 TO STA 443+50	LP39	733	LIGHTING PLANS FORBES AVE - STA 164+50 TO STA 169+50	AR033	762	ARCHITECTURAL PLANS 23 WEST OAKLAND STATION-OVERALL SITE PLAN	ST7	791	STRUCTURAL PLANS BUS STATION 60' - PART 2
	LP9	703	LIGHTING PLANS FIFTH AVE - STA 443+50 TO STA 448+50	LP40	734	LIGHTING PLANS FORBES AVE - STA 169+50 TO STA 173+50	ARO34	763	ARCHITECTURAL PLANS 24 MCKEE PL STATION-OVERALL SITE PLAN	ST8	792	STRUCTURAL PLANS BUS STATION 60′ - PART 3
L	.P10	704	LIGHTING PLANS FIFTH AVE - STA 448+50 TO STA 454+50	LP41	735	LIGHTING PLANS FORBES AVE - STA 173+50 TO STA 177+50	AR035	764	ARCHITECTURAL PLANS 25 CENTRAL OAKLAND STATION-OVERALL SITE PLAN-PART	1 ST9	793	STRUCTURAL PLANS BUS STATION TABLES
L	_P11	705	LIGHTING PLANS FIFTH AVE - STA 454+50 TO STA 458+50	LP42	736	LIGHTING PLANS FORBES AVE - STA 177+50 TO STA 182+50	AR036	765	ARCHITECTURAL PLANS 25 CENTRAL OAKLAND STATION-OVERALL SITE PLAN-PART	2 ST10	794	STRUCTURAL PLANS DRAINAGE DETAILS - PART 1
L	.P12	706	LIGHTING PLANS FIFTH AVE - STA 458+50 TO STA 464+50	LP43	737	LIGHTING PLANS FORBES AVE - STA 207+50 TO STA 213+50	AR037	766	ARCHITECTURAL PLANS 26 BIGELOW BLVD STATION-OVERALL SITE PLAN-PART	sT11	795	STRUCTURAL PLANS DRAINAGE DETAILS - PART 2
L	.P13	707	LIGHTING PLANS FIFTH AVE - STA 464+50 TO STA 470+50	LP44	738	LIGHTING PLANS FORBES AVE - STA 213+50 TO STA 217+50	ARO38	767	ARCHITECTURAL PLANS 26 BIGELOW BLVD STATION-OVERALL SITE PLAN-PART	ST12	796	STRUCTURAL PLANS MISC DETAILS
L	P14	708	LIGHTING PLANS FIFTH AVE - STA 470+50 TO STA 475+50	LP45	739	LIGHTING PLANS FORBES AVE - STA 221+50 TO STA 227+00	AR095	768	ARCHITECTURAL PLANS WINDSCREEN TYPES	ST13	797	STRUCTURAL PLANS VAULT HATCH CLOSURE SLAB
L	.P15	709	LIGHTING PLANS FIFTH AVE - STA 475+50 TO STA 480+50	LP46	740	LIGHTING PLANS FORBES AVE - STA 232+00 TO STA 237+50	AR096	769	ARCHITECTURAL PLANS WINDSCREEN SCHEDULES	ST14	798	STRUCTURAL PLANS VAULT SLAB PARTIAL REMOVAL
L	.P16	710	LIGHTING PLANS FIFTH AVE - STA 480+50 TO STA 485+50	LP47	741	LIGHTING PLANS FORBES AVE - STA 242+50 TO STA 247+50	AR102	770	ARCHITECTURAL PLANS 30' SHELTER ENLARGED PLAN, ROOF PLAN, AND RCP	ST15	799	STRUCTURAL PLANS SLAB MODIFICATIONS - OVERLAY
	P17	711	LIGHTING PLANS FIFTH AVE - STA 485+50 TO STA 490+50	LP48	742	LIGHTING PLANS FORBES AVE - STA 247+50 TO STA 251+50	AR103	771	ARCHITECTURAL PLANS 30' SHELTER ELEVATIONS	ST16	800	STRUCTURAL PLANS SLAB MODIFICATIONS - SIDEWALK SLAB
L	P18	712	LIGHTING PLANS FIFTH AVE - STA 490+50 TO STA 496+50	LP49	743	LIGHTING PLANS FORBES AVE - STA 251+50 TO STA 256+50	AR104	772	ARCHITECTURAL PLANS 60' SHELTER ENLARGED PLAN, ROOF PLAN, AND RCP	ST17	801	STRUCTURAL PLANS VAULT BACKFILL – PART 1
L	.P19	713	LIGHTING PLANS FIFTH AVE - STA 496+50 TO STA 502+50				AR105	773	ARCHITECTURAL PLANS 60' SHELTER ELEVATIONS	ST18	802	STRUCTURAL PLANS VAULT BACKFILL – PART 2
L	.P20	714	LIGHTING PLANS FIFTH AVE - STA 502+50 TO STA 507+50			ARCHITECTURAL PLANS	AR106	774	ARCHITECTURAL PLANS-30' GULLWING SHELTER ENLARGED PLAN, ROOF PLAN AND RCP	ST19	803	STRUCTURAL PLANS VAULT BACKFILL – PART 3
L	_P21	715	LIGHTING PLANS FIFTH AVE - STA 507+50 TO STA 513+50	AR001	744	ARCHITECTURAL PLANS ABBREVIATIONS AND SYMBOLS	AR107	775	ARCHITECTURAL PLANS 30' GULLWING SHELTER ELEVATIONS	ST20	804	STRUCTURAL PLANS VAULT HATCH REMOVAL
L	.P22	716	LIGHTING PLANS FIFTH AVE - STA 513+50 TO STA 517+50	AR002	745	ARCHITECTURAL PLANS-GENERAL NOTES, APPLICAL CODES AND STANDARDS, AND CODE SUMMARY	BLE AR200	776	ARCHITECTURAL PLANS TYPICAL SHELTER SECTIONS	ST21	805	STRUCTURAL PLANS VAULT HATCH REPLACEMENT - PART 1
ngb .7	.P23	717	LIGHTING PLANS FIFTH AVE - STA 517+50 TO STA 522+50	AR003	746	ARCHITECTURAL PLANS SHELTER SIZE AND AMENITIES SCHEDULE	AR201	777	ARCHITECTURAL PLANS TYPICAL SHELTER SECTIONS	ST22	806	STRUCTURAL PLANS VAULT HATCH REPLACEMENT - PART 2
1000 r	.P24	718	LIGHTING PLANS FIFTH AVE - STA 522+50 TO STA 528+50	ARO16	747	ARCHITECTURAL PLANS 6 UPTOWN WEST STATION-OVERALL SITE PLAN	AR300	778	ARCHITECTURAL PLANS SHELTER CANOPY DETAILS	ST23	807	STRUCTURAL PLANS VAULT SLAB REMOVAL - FORBES AVE STA 163+90.86
-RD	.P25	719	LIGHTING PLANS FIFTH AVE - STA 528+50 TO STA 534+50	ARO17	748	ARCHITECTURAL PLANS 7 PRIDE ST STATION-OVERALL SITE PLAN	AR310	779	ARCHITECTURAL PLANS SHELTER WINDSCREEN DETAILS	ST24	808	STRUCTURAL PLANS VAULT SLAB MODIFICATION - FORBES AVE STA 163+90.86
RT_0	.P26	720	LIGHTING PLANS FIFTH AVE - STA 534+50 TO STA 540+50	ARO18	749	ARCHITECTURAL PLANS 8 UPTOWN CENTRAL STATION-OVERALL SITE PLA	AN AR311	780	ARCHITECTURAL PLANS SHELTER WINDSCREEN DETAILS	ST25	809	STRUCTURAL PLANS VAULT DETAILS - FORBES AVE STA 163+90.86
8/00/B	.P27	721	FIFTH AVE - STA 540+50 TO STA 545+50	AR019	750	ARCHITECTURAL PLANS 9 JUMONVILLE ST STATION-OVERALL SITE PLAN	N AR320	781	ARCHITECTURAL PLANS SHELTER SERVICE CARRIER DETAILS	ST26	810	STRUCTURAL PLANS VAULT SLAB REMOVAL - FIFTH AVE STA 437+12.03
10207	.P28	722	LIGHTING PLANS FIFTH AVE - STA 545+50 TO STA 551+50	AR020	751	ARCHITECTURAL PLANS 10 SOHO STATION-OVERALL SITE PLAN	AR330	782	ARCHITECTURAL PLANS SIGNAGE & WAYFINDING	ST27	811	STRUCTURAL PLANS VAULT SLAB REPLACEMENT - FIFTH AVE STA 437+12.03
P/moc	.P29	723	LIGHTING PLANS FIFTH AVE - STA 551+50 TO STA 555+50	AR021	752	ARCHITECTURAL PLANS 11 WEST OAKLAND STATION-OVERALL SITE PLA	AN AR331	783	ARCHITECTURAL PLANS SHELTER SIGNAGE DETAILS	ST28	812	STRUCTURAL PLANS VAULT SLAB REMOVAL - FIFTH AVE STA 442+54.33
E L	.P30	724	LIGHTING PLANS FIFTH AVE - STA 555+50 TO STA 561+50	AR022	753	ARCHITECTURAL PLANS 12 CHESTERFIELD RD STATION-OVERALL SITE P	LAN AR340	784	ARCHITECTURAL PLANS MISC SHELTER & WINDSCREEN DETAILS	ST29	813	STRUCTURAL PLANS VAULT SLAB REPLACEMENT - FIFTH AVE STA 442+54.33
ch@de	_P31	725	FIFTH AVE - STA 561+50 TO STA 566+50	AR023	754	ARCHITECTURAL PLANS 13 ATWOOD STATION-OVERALL SITE PLAN				ST30	814	VAULT SLAB REMOVAL - FIFTH AVE STA 469+59.93
·- o	.P32	726	LIGHTING PLANS FORBES AVE - STA 128+00 TO STA 133+50	AR024	755	ARCHITECTURAL PLANS 14 BIGELOW BLVD STATION-OVERALL SITE PLAN ARCHITECTURAL PLANS	N		STRUCTURAL PLANS	ST31	815	VAULT SLAB REPLACEMENT - FIFTH AVE STA 469+59.93
Sep.	.P33	727	LIGHTING PLANS FORBES AVE - STA 133+50 TO STA 138+50	AR025	756	ARCHITECTURAL PLANS 15 TENNYSON AVE STATION-OVERALL SITE PLA		785	STRUCTURAL PLANS GENERAL NOTES STRUCTURAL PLANS	ST32	816	STRUCTURAL PLANS VAULT SLAB REPLACEMENT DETAILS
[D	.P34	728	LIGHTING PLANS FORBES AVE - STA 138+50 TO STA 143+50	AR028	757	ARCHITECTURAL PLANS 18 UPTOWN WEST STATION-OVERALL SITE PLAN ARCHITECTURAL PLANS		786	SIRUCTURAL PLANS QUANTITIES STRUCTURAL PLANS	ST33	817	STRUCTURAL PLANS DLC VAULT SLAB REMOVAL - FIFTH AVE STA 438+14
s16	.P35	729	LIGHTING PLANS FORBES AVE - STA 143+50 TO STA 149+50 LIGHTING PLANS	AR029	758	ARCHITECTURAL PLANS 19 PRIDE ST STATION-OVERALL SITE PLAN ARCHITECTURAL PLANS	ST3	787	TYPICAL SLAB SECTIONS STRUCTURAL PLANS	ST34	818	STRUCTURAL PLANS DLC VAULT SLAB REPLACEMENT 1 - FIFTH AVE STA 438+14
Ü,	.P36	730	FORBES AVE - STA 149+50 TO STA 154+50 LIGHTING PLANS	AR030	759	20 UPTOWN CENTRAL STATION-OVERALL SITE PL		788	BUS STATION 30' - PART 1 STRUCTURAL PLANS	ST35	819	STRUCTURAL PLANS DLC VAULT SLAB REPLACEMENT 2 - FIFTH AVE STA 438+14
	.P37	731	FORBES AVE - STA 154+50 TO STA 159+50	AR031	760	21 JUMONVILLE ST STATION-OVERALL SITE PL	AN ST5	789	BUS STATION 30' - PART 2	ST36	820	STRUCTURAL PLANS DLC VAULT SLAB REMOVAL - FIFTH AVE STA 441+69
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E PA	7	Gulf Towe 07 Grant St				U.S. DEPA TRANSPO	ARTMENT OF DRTATION, UNDER THE ASS TRANSPORTATIO			<u>AR</u> 5/01/24	_	INDEX OF DRAWINGS
OPE F IL		5th Floor		NO. DATE		OF 1964, A DESCRIPTION PORT AUT	ASS TRANSPORTATIO AS AMENDED, FOR THI THORITY OF ALLEGHE PENNSYLVANIA.	E I	SCALE	6HOWN	Port	Authority CONTRACT NO. BRT-001
	riili	sburgh, PA	10218			REVISIONS	F LINING I LVAINIA.			A IOVVIV	010	connecting people to life DWG. NO. GN9 SHT. 9

	AWING JMBER	SHEET NUMBER	TITLE	DRAWING NUMBER	SHEET NUMBER	TITLE	DRAWING NUMBER	SHEET NUMBER	TITLE	DRAWING NUMBER		TITLE
PLOTI			STRUCTURAL PLANS (CONT'D)			STATION TAP IN PLANS (CO	NT′D)		CONTROL SYSTEMS PLANS (CONT'D)		CONTROL SYSTEMS PLANS (CONT'D)
	ST37	821	STRUCTURAL PLANS DLC VAULT SLAB REPLACEMENT 1 - FIFTH AVE STA 441+69	TI4	847	STATION TAP IN PLANS JUMONVILLE STATION	CS24	876	CONTROL SYSTEMS PLANS GENERAL NOTES	CS55	907	CONTROL SYSTEMS PLANS FORBES AVE - STA 169+50 TO STA 173+50
	ST38	822	STRUCTURAL PLANS DLC VAULT SLAB REPLACEMENT 2 - FIFTH AVE STA 441+69	T15	848	STATION TAP IN PLANS SOHO STATION	CS25	877	CONTROL SYSTEMS PLANS SPECIAL DETAILS	CS56	908	CONTROL SYSTEMS PLANS FORBES AVE - STA 173+50 TO STA 177+50
	ST39	823	STRUCTURAL PLANS DLC VAULT SLAB REMOVAL - FIFTH AVE STA 443+11	T16	849	STATION TAP IN PLANS WEST OAKLAND STATION	CS26	878	CONTROL SYSTEMS PLANS TABULATION SHEET	CS57	909	CONTROL SYSTEMS PLANS FORBES AVE - STA 177+50 TO STA 182+50
	ST40	824	STRUCTURAL PLANS DLC VAULT SLAB REPLACEMENT 1 - FIFTH AVE STA 443+11	TI7	850	STATION TAP IN PLANS CHESTERFIELD STATION	CS27	879	CONTROL SYSTEMS PLANS TABULATION SHEET	CS58	910	CONTROL SYSTEMS PLANS FORBES AVE - STA 207+50 TO STA 213+50
	ST41	825	STRUCTURAL PLANS DLC VAULT SLAB REPLACEMENT 2 - FIFTH AVE STA 443+11	TI8	851	STATION TAP IN PLANS BIGELOW STATION	CS28	880	CONTROL SYSTEMS PLANS FIFTH AVE - STA 438+50 TO STA		911	CONTROL SYSTEMS PLANS FORBES AVE - STA 221+50 TO STA 227+00
	ST42	826	STRUCTURAL PLANS VAULT SLAB MODIFICATION - MISC DETAILS	T19	852	STATION TAP IN PLANS TENNYSON STATION	CS29	881	CONTROL SYSTEMS PLANS FIFTH AVE - STA 443+50 TO STA		912	CONTROL SYSTEMS PLANS FORBES AVE - STA 232+00 TO STA 237+50
	ST43	827	STRUCTURAL PLANS KIRKPATRICK WALL – GENERAL PLAN				CS30	882	CONTROL SYSTEMS PLANS FIFTH AVE - STA 448+50 TO STA		913	CONTROL SYSTEMS PLANS FORBES AVE - STA 242+50 TO STA 247+50
	ST44	828	STRUCTURAL PLANS KIRKPATRICK WALL - TYPICAL SECTION			CONTROL SYSTEMS PLANS	S CS31	883	CONTROL SYSTEMS PLANS FIFTH AVE - STA 454+50 TO STA			
	ST45	829	STRUCTURAL PLANS KIRKPATRICK WALL - ELEVATION 1	CS1	853	CONTROL SYSTEMS PLANS SYSTEMS GENERAL NOTES	CS32	884	CONTROL SYSTEMS PLANS FIFTH AVE - STA 458+50 TO STA		MAINTEN	NANCE & PROTECTION OF TRAFFIC PLANS
	ST46	830	STRUCTURAL PLANS KIRKPATRICK WALL - ELEVATION 2	CS2	854	CONTROL SYSTEMS PLANS SYSTEMS SHELTER COMUNICATIONS OVE	:RVIEW CS33	885	CONTROL SYSTEMS PLANS FIFTH AVE - STA 464+50 TO STA		914	MAINTENANCE & PROTECTION OF TRAFFIC PLANS GENERAL NOTES
	ST47	831	STRUCTURAL PLANS KIRKPATRICK WALL - FOOTING PLAN	CS3	855	CONTROL SYSTEMS PLANS SYSTEMS BRT BLOCK DIAGRAM	CS34	886	CONTROL SYSTEMS PLANS FIFTH AVE - STA 470+50 TO STA		915	MAINTENANCE & PROTECTION OF TRAFFIC PLANS GENERAL NOTES
	ST48	832	STRUCTURAL PLANS KIRKPATRICK WALL - WALL DETAILS 1	CS4	856	CONTROL SYSTEMS PLANS PITT TOWER BLOCK DIAGRAM	CS35	887	CONTROL SYSTEMS PLANS FIFTH AVE - STA 475+50 TO STA		916	MAINTENANCE & PROTECTION OF TRAFFIC PLANS GENERAL NOTES
	ST49	833	STRUCTURAL PLANS OFFSET POLE FOUNDATIONS - PART 1	CS5	857	CONTROL SYSTEMS PLANS PITT TOWER PLAN	CS36	888	CONTROL SYSTEMS PLANS FIFTH AVE - STA 480+50 TO STA		917	MAINTENANCE & PROTECTION OF TRAFFIC PLANS INDEX SHEET
	ST50	834	STRUCTURAL PLANS OFFSET POLE FOUNDATIONS - PART 2	CS6	858	CONTROL SYSTEMS PLANS PITT TOWER EQUIPMENT RACK ELEVA	TION CS37	889	CONTROL SYSTEMS PLANS FIFTH AVE - STA 485+50 TO STA		918	MAINTENANCE & PROTECTION OF TRAFFIC PLANS INDEX SHEET
				CS7	859	CONTROL SYSTEMS PLANS TICKET VENDING MACHINE DETAILS SH	EET 01 CS38	890	CONTROL SYSTEMS PLANS FIFTH AVE - STA 490+50 TO STA		919	MAINTENANCE & PROTECTION OF TRAFFIC PLANS INDEX SHEET
			STATION ELECTRICAL PLANS	CS8	860	CONTROL SYSTEMS PLANS TICKET VENDING MACHINE DETAILS SH	EET 02 CS39	891	CONTROL SYSTEMS PLANS FIFTH AVE - STA 496+50 TO STA		920	MAINTENANCE & PROTECTION OF TRAFFIC PLANS INDEX SHEET
ngb.	EL1	835	STATION ELECTRICAL PLANS STATION TRACKER - CONSTRUCTION DATA	CS9	861	CONTROL SYSTEMS PLANS TICKET VALIDATOR DETAILS	CS40	892	CONTROL SYSTEMS PLANS FIFTH AVE - STA 502+50 TO STA		921	MAINTENANCE & PROTECTION OF TRAFFIC PLANS TABULATION SHEET
0008	EL2	836	STATION ELECTRICAL PLANS GENERAL ELECTRICAL NOTES	CS10	862	CONTROL SYSTEMS PLANS SYSTEM REAL TIME SIGN DETAILS SHE	EET 01 CS41	893	CONTROL SYSTEMS PLANS FIFTH AVE - STA 507+50 TO STA		922	MAINTENANCE & PROTECTION OF TRAFFIC PLANS TABULATION SHEET
-RD- I	EL3	837	STATION ELECTRICAL PLANS TYPICAL STATION PLAN & ELEVATION - 30 & 60 FT	CS11	863	CONTROL SYSTEMS PLANS SYSTEM REAL TIME SIGN DETAILS SHE	ET 02 CS42	894	CONTROL SYSTEMS PLANS FIFTH AVE - STA 513+50 TO STA		923	MAINTENANCE & PROTECTION OF TRAFFIC PLANS TABULATION SHEET
T01	EL4	838	STATION ELECTRICAL PLANS TYPICAL STATION PLAN & ELEVATION - 30 & 60 FT	CS12	864	CONTROL SYSTEMS PLANS SYSTEM REAL TIME SIGN DETAILS SHE	ET 03 CS43	895	CONTROL SYSTEMS PLANS FIFTH AVE - STA 522+50 TO STA		924	MAINTENANCE & PROTECTION OF TRAFFIC PLANS TABULATION SHEET
00\BF	EL5	839	STATION ELECTRICAL PLANS MISCELLANEOUS ELECTRICAL DETAILS	CS13	865	CONTROL SYSTEMS PLANS EMERGENCY CALL STATION DETAIL	.S CS44	896	CONTROL SYSTEMS PLANS FIFTH AVE - STA 528+50 TO STA		925	MAINTENANCE & PROTECTION OF TRAFFIC PLANS TABULATION SHEET
72077	EL6	840	STATION ELECTRICAL PLANS PANEL SCHEDULES - STATIONS 6 THRU 11	CS14	866	CONTROL SYSTEMS PLANS CCTV MOUNTING DETAILS	CS45	897	CONTROL SYSTEMS PLANS FIFTH AVE - STA 534+50 TO STA		926	MAINTENANCE & PROTECTION OF TRAFFIC PLANS TABULATION SHEET
)p\mo	EL7	841	STATION ELECTRICAL PLANS PANEL SCHEDULES - STATIONS 12 THRU 15	CS15	867	CONTROL SYSTEMS PLANS SYSTEM CABINET DETAILS	CS46	898	CONTROL SYSTEMS PLANS EXISTING ATWOOD STATION		927	MAINTENANCE & PROTECTION OF TRAFFIC PLANS TABULATION SHEET
o illo	EL8	842	STATION ELECTRICAL PLANS PANEL SCHEDULES - STATIONS 18 THRU 23	CS16	868	CONTROL SYSTEMS PLANS SYSTEMS 60' INBOUND EQUIPMENT P	PLAN CS47	899	CONTROL SYSTEMS PLANS FIFTH AVE - STA 545+50 TO STA	x 551+50 MT15	928	MAINTENANCE & PROTECTION OF TRAFFIC PLANS TABULATION SHEET
н@дес	EL9	843	STATION ELECTRICAL PLANS PANEL SCHEDULES - STATIONS 24 THRU 26	CS17	869	CONTROL SYSTEMS PLANS SYSTEMS 60' SPECIAL CASE EQUIPMEN	T PLAN CS48	900	CONTROL SYSTEMS PLANS FIFTH AVE - STA 555+50 TO STA	A 561+50 MT16	929	MAINTENANCE & PROTECTION OF TRAFFIC PLANS TABULATION SHEET
				CS18	870	CONTROL SYSTEMS PLANS SYSTEMS 30' INBOUND EQUIPMENT F	PLAN CS49	901	CONTROL SYSTEMS PLANS FORBES AVE - STA 128+00 TO STA		930	MAINTENANCE & PROTECTION OF TRAFFIC PLANS CONSTRUCTION SEQUENCE
eph.			STATION TAP IN PLANS	CS19	871	CONTROL SYSTEMS PLANS SYSTEMS 30' INBOUND CONDUIT PL	.AN CS50	902	CONTROL SYSTEMS PLANS FORBES AVE - STA 143+50 TO STA	A 149+50 MT18	931	MAINTENANCE & PROTECTION OF TRAFFIC PLANS CONSTRUCTION SEQUENCE
1/108	TI1	844	STATION TAP IN PLANS LOCATION MAP	CS20	872	CONTROL SYSTEMS PLANS SYSTEMS 30' OUTBOUND CONDUIT P	LAN CS51	903	CONTROL SYSTEMS PLANS FORBES AVE - STA 149+50 TO STA	A 154+50 MT19	932	MAINTENANCE & PROTECTION OF TRAFFIC PLANS CONSTRUCTION SEQUENCE
16_nc	TI2	845	STATION TAP IN PLANS TAP IN DETAILS	CS21	873	CONTROL SYSTEMS PLANS SYSTEMS 30' INBOUND CONDUIT PL	.AN CS52	904	CONTROL SYSTEMS PLANS FORBES AVE - STA 154+50 TO STA	A 159+50	933	MAINTENANCE & PROTECTION OF TRAFFIC PLANS CONSTRUCTION SEQUENCE
sp 'w	TI3	846	STATION TAP IN PLANS TAP IN DETAILS	CS22	874	CONTROL SYSTEMS PLANS SYSTEMS 30' OUTBOUND CONDUIT P	LAN CS53	905	CONTROL SYSTEMS PLANS FORBES AVE - STA 159+50 TO STA	A 164+50	934	MAINTENANCE & PROTECTION OF TRAFFIC PLANS CONSTRUCTION SEQUENCE
DO D				CS23	875	CONTROL SYSTEMS PLANS SYSTEMS EQUIPMENT CABINET LAYOUT (1	TYPICAL) CS54	906	CONTROL SYSTEMS PLANS FORBES AVE - STA 164+50 TO STA	A 169+50 MT22	935	MAINTENANCE & PROTECTION OF TRAFFIC PLANS CONSTRUCTION SEQUENCE
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OPER/ FILE		07 Grant 5th Flo	oor	NO. DATE		Į.	JRBAN MASS TRANSPORTATION DF 1964, AS AMENDED, FOR THE PORT AUTHORITY OF ALLEGHEN	=		DATE <u>05/01/24</u> SCALE	Dart	
	Pitts	sburgh, P		NO. DATE		REVISIONS	COUNTY, PENNSYLVANIA.			AS SHOWN	rutt	Authority CONTRACT NO. BRT-001 DWG. NO. GN10 SHT. 10

	AWING JMBER	SHEET NUMBER	TITLE	DRAW NUME		TITLE		NING SHE BER NUME	ET BER TITLE		DRAWING NUMBER	SHEET NUMBER	TITLE
PLOTT	MAINTE	ENANCE 8	& PROTECTION OF TRAFFIC PLANS (CON	<u>Γ΄ D)</u> ΜΑ	INTENANCE	& PROTECTION OF TRAFFIC PLANS	(CONT'D) MA	AINTENAN	CE & PROTECTION OF TRAFFIC PL	ANS (CONT'D)	MAINTE	NANCE &	PROTECTION OF TRAFFIC PLANS (CONT'D)
	MT23	936	MAINTENANCE & PROTECTION OF TRAFFIC PLAN CONSTRUCTION SEQUENCE	S MT5	967	MAINTENANCE & PROTECTION OF TRAFFIC F PHASE 1A / SIXTH AVE - STA 428+50 TO STA	PLANS A 433+50 MT	85 99	8 MAINTENANCE & PROTECTION OF TR PHASE 1D / FIFTH AVE - STA 555+50	AFFIC PLANS TO STA 561+50	MT116	1029	MAINTENANCE & PROTECTION OF TRAFFIC PLANS PHASE 1A / FORBES AVE - STA 169+50 TO STA 173+50
	MT24	937	MAINTENANCE & PROTECTION OF TRAFFIC PLAN CONSTRUCTION SEQUENCE	S MT5	55 968	MAINTENANCE & PROTECTION OF TRAFFIC F PHASE 2A / FIFTH AVE - STA 433+50 TO STA	PLANS A 438+50 MT	86 99	9 MAINTENANCE & PROTECTION OF TR PHASE 1D / FIFTH AVE - STA 561+50	AFFIC PLANS TO STA 566+50	MT117	1030	MAINTENANCE & PROTECTION OF TRAFFIC PLANS PHASE 1A / FORBES AVE - STA 173+50 TO STA 177+50
	MT25	938	MAINTENANCE & PROTECTION OF TRAFFIC PLAN CONSTRUCTION SEQUENCE	S MT5	66 969	MAINTENANCE & PROTECTION OF TRAFFIC F PHASE 2A / FIFTH AVE - STA 438+50 TO STA	PLANS A 443+50 MT	87 100	MAINTENANCE & PROTECTION OF TR PHASE 2A / FIFTH AVE - STA 490+50	AFFIC PLANS TO STA 496+50	MT118	1031	MAINTENANCE & PROTECTION OF TRAFFIC PLANS PHASE 1A / FORBES AVE - STA 177+50 TO STA 182+50
N	IT26	939	MAINTENANCE & PROTECTION OF TRAFFIC PLAN SIGN FABRICATION DETAILS	S MT5	970	MAINTENANCE & PROTECTION OF TRAFFIC F PHASE 2A / FIFTH AVE - STA 443+50 TO STA	PLANS A 448+50 MT	88 100	MAINTENANCE & PROTECTION OF TR PHASE 2A / FIFTH AVE - STA 496+50	AFFIC PLANS TO STA 502+50	MT119	1032	MAINTENANCE & PROTECTION OF TRAFFIC PLANS PHASE 1B / FORBES AVE - STA 138+50 TO STA 143+50
	MT27	940	MAINTENANCE & PROTECTION OF TRAFFIC PLAN DETAILS	S MT5	58 971	MAINTENANCE & PROTECTION OF TRAFFIC F PHASE 2A / FIFTH AVE - STA 448+50 TO STA	PLANS A 454+50 MT	89 100	MAINTENANCE & PROTECTION OF TR PHASE 2A / FIFTH AVE - STA 502+50		MT120	1033	MAINTENANCE & PROTECTION OF TRAFFIC PLANS PHASE 1B / FORBES AVE - STA 143+50 TO STA 149+50
	IT28	941	MAINTENANCE & PROTECTION OF TRAFFIC PLAN DETAILS	S MT5	972	MAINTENANCE & PROTECTION OF TRAFFIC F PHASE 2A / FIFTH AVE - STA 454+50 TO STA	PLANS A 458+50 MT	90 100	MAINTENANCE & PROTECTION OF TR PHASE 2A / FIFTH AVE - STA 507+50		MT121	1034	MAINTENANCE & PROTECTION OF TRAFFIC PLANS PHASE 1B / FORBES AVE - STA 149+50 TO STA 154+50
N	MT29	942	MAINTENANCE & PROTECTION OF TRAFFIC PLAN DETAILS	S МТ6	50 973	MAINTENANCE & PROTECTION OF TRAFFIC F PHASE 2B / FIFTH AVE - STA 454+50 TO STA	PLANS A 458+50 MT	91 100	MAINTENANCE & PROTECTION OF TR PHASE 2B / FIFTH AVE - STA 507+50		MT122	1035	MAINTENANCE & PROTECTION OF TRAFFIC PLANS PHASE 1B / FORBES AVE - STA 154+50 TO STA 159+50
N	1T30	943	MAINTENANCE & PROTECTION OF TRAFFIC PLAN DETAILS	S МТ6	51 974	MAINTENANCE & PROTECTION OF TRAFFIC F PHASE 2B / FIFTH AVE - STA 458+50 TO STA	PLANS A 464+50 MT	92 100	MAINTENANCE & PROTECTION OF TR PHASE 2B / FIFTH AVE - STA 513+50		MT123	1036	MAINTENANCE & PROTECTION OF TRAFFIC PLANS PHASE 1B / FORBES AVE - STA 159+50 TO STA 164+50
	AT31	944	MAINTENANCE & PROTECTION OF TRAFFIC PLAN DETAILS	S мте	52 975	MAINTENANCE & PROTECTION OF TRAFFIC F PHASE 2B / FIFTH AVE - STA 464+50 TO STA	PLANS A 470+50 MT	93 100	MAINTENANCE & PROTECTION OF TR PHASE 2B / FIFTH AVE - STA 517+50	AFFIC PLANS TO STA 522+50	MT124	1037	MAINTENANCE & PROTECTION OF TRAFFIC PLANS PHASE 1B / FORBES AVE - STA 164+50 TO STA 169+50
1	MT32	945	MAINTENANCE & PROTECTION OF TRAFFIC PLAN DETAILS	S мте	3 976	MAINTENANCE & PROTECTION OF TRAFFIC F PHASE 2B / FIFTH AVE - STA 470+50 TO STA	PLANS A 475+50 MT	94 100	MAINTENANCE & PROTECTION OF TR PHASE 2B / FIFTH AVE - STA 522+50	AFFIC PLANS TO STA 528+50	MT125	1038	MAINTENANCE & PROTECTION OF TRAFFIC PLANS PHASE 1C / FORBES AVE - STA 119+00 TO STA 122+00
1	MT33	946	MAINTENANCE & PROTECTION OF TRAFFIC PLAN DETAILS	S мте	977	MAINTENANCE & PROTECTION OF TRAFFIC F PHASE 2B / FIFTH AVE - STA 475+50 TO ST	PLANS A 481+50 MT	95 100	MAINTENANCE & PROTECTION OF TR PHASE 2C / FIFTH AVE - STA 522+50	AFFIC PLANS TO STA 528+50	MT126	1039	MAINTENANCE & PROTECTION OF TRAFFIC PLANS PHASE 1C / FORBES AVE - STA 122+00 TO STA 128+00
1	1T34	947	MAINTENANCE & PROTECTION OF TRAFFIC PLAN DETAILS	S мте	55 978	MAINTENANCE & PROTECTION OF TRAFFIC F PHASE 2C / FIFTH AVE - STA 470+50 TO ST		96 100	MAINTENANCE & PROTECTION OF TR PHASE 2C / FIFTH AVE - STA 528+50		MT127	1040	MAINTENANCE & PROTECTION OF TRAFFIC PLANS PHASE 1C / FORBES AVE - STA 128+00 TO STA 133+50
1	1T35	948	MAINTENANCE & PROTECTION OF TRAFFIC PLAN DETAILS	S МТ6	66 979	MAINTENANCE & PROTECTION OF TRAFFIC F PHASE 2C / FIFTH AVE - STA 475+50 TO STA	PLANS A 480+50 MT	97 101	O MAINTENANCE & PROTECTION OF TR PHASE 2C / FIFTH AVE - STA 534+50		MT128	1041	MAINTENANCE & PROTECTION OF TRAFFIC PLANS PHASE 1C / FORBES AVE - STA 133+50 TO STA 138+50
N	1T36	949	MAINTENANCE & PROTECTION OF TRAFFIC PLAN DETAILS	S МТ6	980	MAINTENANCE & PROTECTION OF TRAFFIC F PHASE 2C / FIFTH AVE - STA 480+50 TO STA		98 10	MAINTENANCE & PROTECTION OF TR PHASE 2C / FIFTH AVE - STA 540+50		MT129	1042	MAINTENANCE & PROTECTION OF TRAFFIC PLANS PHASE 1C / FORBES AVE - STA 138+50 TO STA 143+50
	1T37	950	MAINTENANCE & PROTECTION OF TRAFFIC PLAN TEMPORARY TRAFFIC SIGNAL TIMINGS	S МТ6	88 981	MAINTENANCE & PROTECTION OF TRAFFIC F PHASE 2C / FIFTH AVE - STA 485+50 TO ST		99 101	2 MAINTENANCE & PROTECTION OF TR PHASE 2D / FIFTH AVE - STA 540+50		MT130	1043	MAINTENANCE & PROTECTION OF TRAFFIC PLANS PHASE 1C / FORBES AVE - STA 143+50 TO STA 149+50
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3T_01	MT42	955	MAINTENANCE & PROTECTION OF TRAFFIC PLANS PHASE 1A / FIFTH AVE - STA 448+50 TO STA 454+	50 MT7	'3 986	MAINTENANCE & PROTECTION OF TRAFFIC F PHASE 1A / FIFTH AVE - STA 507+50 TO ST	A 513+50	104 101	THASE TA / TORDES AVE - STA 251+30) 10 STA 242+50	MT135		MAINTENANCE & PROTECTION OF TRAFFIC PLANS PHASE 2A / FORBES AVE - STA 177+50 TO STA 182+50
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	AWING IMBER		TITLE	DRAWING NUMBER	SHEET NUMBER	TITLE	DRAWING NUMBER	SHEET NUMBER	TITLE	DRAWI NUMBI		r R TITLE
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9	SG5	1065	SIGNAL PLANS WIRING, MOVEMENT, PHASING & SEQUENCE DIAGRAMS	SG36	1096	SIGNAL PLANS WIRING, MOVEMENT, PHASING & SEQUENCE DIAGRAMS	SG67	1127	SIGNAL PLANS FIFTH AVENUE & OAKLAND AVENUE/DE S	OTO STREET SG9	1158	SIGNAL PLANS TRAFFIC SIGNAL TABULATIONS
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P.I.	Pittsl	5th Flo burgh, F	oor PA 15219	NO. DATE		DESCRIPTION PORT AUTHORI' COUNTY, PENN.	ENDED, FOR THE TY OF ALLEGHEN SYLVANIA.	: 1	,	AS SHOWN	Por	t Authority CONTRACT NO. BRT-001
						REVISIONS						connecting people to life DWG. NO. GN12 SHT. 12

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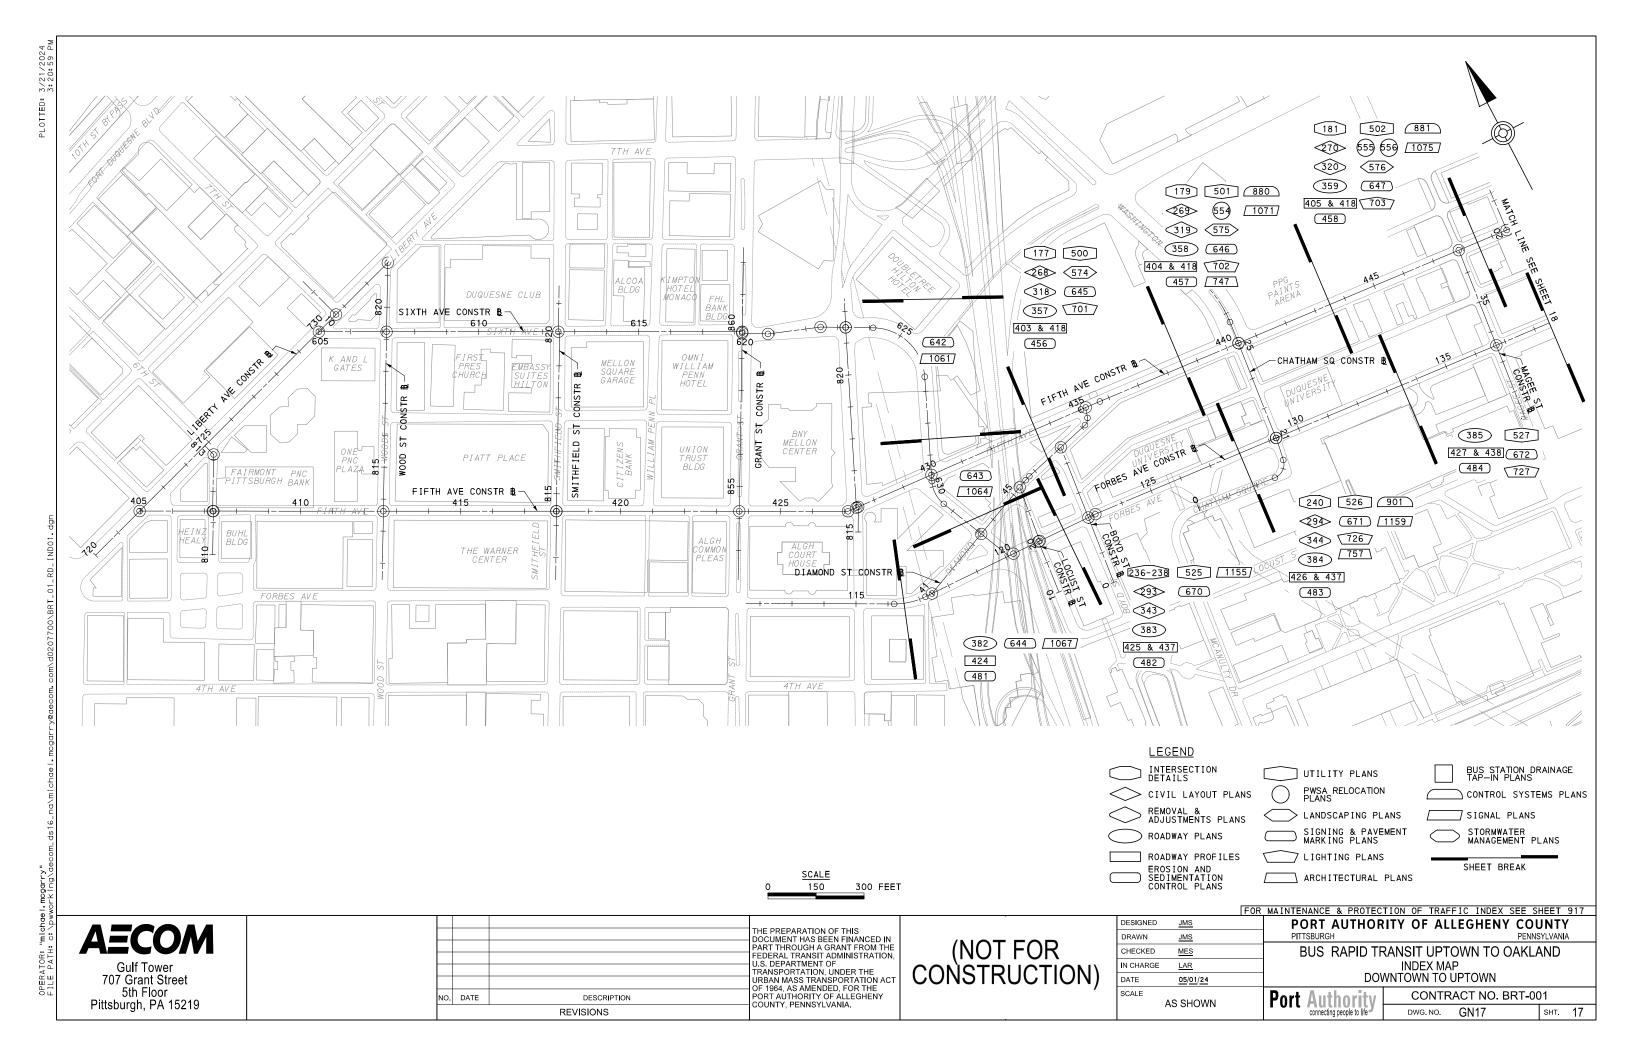
NUMBEF DRAWIN		T ER TITLE	DRAWIN NUMBE		TITLE	DRAWING NUMBER	SHEET NUMBER	TITLE	DRAW NUM		TITLE
7		SIGNAL PLANS (CO	NT' D)		CROSS SECTIONS (CONT	<u>′ D)</u>		CROSS SECTIONS (CO	DNT'D)		CROSS SECTIONS (CONT'D)
SG122	1182	SIGNAL PLANS TRAFFIC SIGNAL TABULA	TIONS XS5	1210	CROSS SECTIONS FIFTH AVE - STA 437+00.00	XS36	1241	CROSS SECTIONS FIFTH AVE - STA 460+00.00 TO S	TA 460+50.00 XS	57 1272	CROSS SECTIONS FIFTH AVE - STA 479+50.00 TO STA 480+00.00
SG123	1183	STONAL DIANS	VSC	1211	CROSS SECTIONS FIFTH AVE - STA 437+50.00	XS37	1242	CROSS SECTIONS FIFTH AVE - STA 461+00.00 TO S	VC.	88 1273	CROSS SECTIONS FIFTH AVE - STA 480+50.00 TO STA 481+00.00
SG124	1184	SIGNAL PLANS WIRING, MOVEMENT, PHASING & SEG	UENCE DIAGRAMS XS7	1212	CROSS SECTIONS FIFTH AVE - STA 438+00.00 TO STA 4	438+50.00 XS38	1243	CROSS SECTIONS FIFTH AVE - STA 462+00	Ve	59 1274	CROSS SECTIONS FIFTH AVE - STA 481+50.00 TO STA 482+00.00
SG125	1185	SIGNAL PLANS TRAFFIC SIGNAL TABULA	TIONS XS8	1213	CROSS SECTIONS FIFTH AVE - STA 439+00.00 TO STA 4	439+50.00 XS39	1244	CROSS SECTIONS FIFTH AVE - STA 462+50	0. 00 XS	0 1275	CROSS SECTIONS FIFTH AVE - STA 482+39.00
SG126	1186	SIGNAL PLANS TRAFFIC SIGNAL TABULA	TIONS XS9	1214	CROSS SECTIONS FIFTH AVE - STA 440+00.00 TO STA 4	140+21.00 XS40	1245	CROSS SECTIONS FIFTH AVE - STA 463+00.00 TO S	TA 463+50.00 XS	71 1276	CROSS SECTIONS FIFTH AVE - STA 482+50.00
SG127	1187	SIGNAL PLANS FORBES AVENUE & JUMONVILL	E STREET XS10	1215	CROSS SECTIONS FIFTH AVE - STA 440+40.00 TO STA 4	140+50.00 XS41	1246	CROSS SECTIONS FIFTH AVE - STA 463+65.00 TO S	TA 464+00.00 XS	1277	CROSS SECTIONS FIFTH AVE - STA 483+00.00
SG128	1188	SIGNAL PLANS WIRING, MOVEMENT, PHASING & SEG	UENCE DIAGRAMS XS11	1216	CROSS SECTIONS FIFTH AVE - STA 440+59.00 TO STA 4	141+00.00 XS42	1247	CROSS SECTIONS FIFTH AVE - STA 464+50.00 TO S	TA 465+00.00 XS	73 1278	CROSS SECTIONS FIFTH AVE - STA 483+50.00
SG129	1189	SIGNAL PLANS TRAFFIC SIGNAL TABULA	TIONS XS12	1217	CROSS SECTIONS FIFTH AVE - STA 441+50.00 TO STA 4	142+00.00 XS43	1248	CROSS SECTIONS FIFTH AVE - STA 465+50.00 TO S	TA 466+00.00 XS	74 1279	CROSS SECTIONS FIFTH AVE - STA 484+00.00 TO STA 484+50.00
SG130	1190	SIGNAL PLANS TRAFFIC SIGNAL TABULA	TIONS XS13	1218	CROSS SECTIONS FIFTH AVE - STA 442+11.00 TO STA 4	442+50 . 00 XS44	1249	CROSS SECTIONS FIFTH AVE - STA 466+50.00 TO S	TA 467+00.00 XS	75 1280	CROSS SECTIONS FIFTH AVE - STA 485+00.00
SG131	1191	SIGNAL PLANS FORBES AVENUE & MOULTRIE	STREET XS14	1219	CROSS SECTIONS FIFTH AVE - STA 443+00.00 TO STA 4	443+50.00 XS45	1250	CROSS SECTIONS FIFTH AVE - STA 467+08.00 TO	XS	76 1281	CROSS SECTIONS FIFTH AVE - STA 485+50.00
SG132	1192	SIGNAL PLANS WIRING, MOVEMENT, PHASING & SEG	UENCE DIAGRAMS XS15	1220	CROSS SECTIONS FIFTH AVE - STA 440+00.00 TO STA 4	444+50.00 XS46	1251	CROSS SECTIONS FIFTH AVE - STA 467+86.00 TO	XS	77 1282	CROSS SECTIONS FIFTH AVE - STA 486+00.00 TO STA 486+45.00
SG133	1193	SIGNAL PLANS TRAFFIC SIGNAL TABULA	TIONS XS16	1221	CROSS SECTIONS FIFTH AVE - STA 445+00.00 TO STA 4	445+50.00 XS47	1252	CROSS SECTIONS FIFTH AVE - STA 468+50.00 TO	XS 468+73.00	78 1283	CROSS SECTIONS FIFTH AVE - STA 486+50.00 TO STA 486+93.00
SG134	1194	SIGNAL PLANS TRAFFIC SIGNAL TABULA	TIONS XS17	1222	CROSS SECTIONS FIFTH AVE - STA 446+00.00	XS48	1253	CROSS SECTIONS FIFTH AVE - STA 469+00.00 TO S	TA 469+50.00 XS	79 1284	CROSS SECTIONS FIFTH AVE - STA 487+00.00 TO STA 487+50.00
SG135	1195	SIGNAL PLANS FORBES AVENUE & BIRMINGHAM BRID	GE ON-OFF RAMP XS18	1223	CROSS SECTIONS FIFTH AVE - STA 446+50.00	XS49	1254	CROSS SECTIONS FIFTH AVE - STA 470+0	0.00 XS	1285	CROSS SECTIONS FIFTH AVE - STA 488+00.00 TO STA 488+50.00
SG136	1196	SIGNAL PLANS WIRING, MOVEMENT, PHASING & SEG	UENCE DIAGRAMS XS19	1224	CROSS SECTIONS FIFTH AVE - STA 447+00.00 TO STA 4	447+50.00 XS50	1255	CROSS SECTIONS FIFTH AVE - STA 470+5	0.00 XS	1286	CROSS SECTIONS FIFTH AVE - STA 489+00.00 TO STA 489+50.00
SG137	1197	SIGNAL PLANS TRAFFIC SIGNAL TABULA	TIONS XS20	1225	CROSS SECTIONS FIFTH AVE - STA 447+86.00 TO STA 4	448+00.00 XS51	1256	CROSS SECTIONS FIFTH AVE - STA 471+00). 00 XS	32 1287	CROSS SECTIONS FIFTH AVE - STA 490+00.00
등 SG138	1198	TRAFFIC SIGNAL TABULA	TIONS XS21	1226	CROSS SECTIONS FIFTH AVE - STA 448+50.00 TO STA 4	149+00.00 XS52	1257	CROSS SECTIONS FIFTH AVE - STA 471+50.00 TO S	TA 472+00.00 XS	1288	CROSS SECTIONS FIFTH AVE - STA 490+50∙00
SG139	1199	FURBES AVENUE & HALKET	STREET XS22	1227	CROSS SECTIONS FIFTH AVE - STA 449+50.00 TO STA 4	450+00 . 00 XS53	1258	CROSS SECTIONS FIFTH AVE - STA 472+46.00 TO S	TA 472+50.00 XS	1289	CROSS SECTIONS FIFTH AVE - STA 491+00∙00
g SG140	1200	WIRING, MOVEMENT, PHASING & SEG	UENCE DIAGRAMS XS23	1228	CROSS SECTIONS FIFTH AVE - STA 450+50.00	XS54	1259	CROSS SECTIONS FIFTH AVE - STA 473+00.00 TO S	TA 473+50.00 XS	1290	CROSS SECTIONS FIFTH AVE - STA 491+50.00 TO STA 492+00.00
SG141	1201	TRAFFIC SIGNAL TABULA	TIONS XS24	1229	CROSS SECTIONS FIFTH AVE - STA 451+00.00 TO STA 4	451+50 . 00 XS55	1260	CROSS SECTIONS FIFTH AVE - STA 474+00.00 TO S	TA 474+50.00 XS	36 1291	CROSS SECTIONS FIFTH AVE - STA 492+14.00 TO STA 492+50.00
SG142	1202	FORDES AVENUE & SCHENLET DRI	VE EXTENSION XS25	1230	CROSS SECTIONS FIFTH AVE - STA 452+00.00 TO STA 4	452+50.00 XS56	1261	CROSS SECTIONS FIFTH AVE - STA 475+0	0.00 XS	1292	CROSS SECTIONS FIFTH AVE - STA 493+00.00 TO STA 493+50.00
SG143	1203	WINING, MOVEMENT, PHASING & SEG	UENCE DIAGRAMS XS26	1231	CROSS SECTIONS FIFTH AVE - STA 452+92.00 TO STA 4	453+00.00 XS57	1262	CROSS SECTIONS FIFTH AVE - STA 475+5	0.00 XS	1293	CROSS SECTIONS FIFTH AVE - STA 494+00.00 TO STA 494+50.00
SG144	1204	TRAFFIC SIGNAL TABULA	TIONS XS27	1232	CROSS SECTIONS FIFTH AVE - STA 453+50.00 TO STA 4	454+00.00 XS58	1263	CROSS SECTIONS FIFTH AVE - STA 476+0	0.00 XS	39 1294	CROSS SECTIONS FIFTH AVE - STA 495+00.00
SG145	1205	SIGNAL PLANS TRAFFIC SIGNAL TABULA	TIONS XS28	1233	CROSS SECTIONS FIFTH AVE - STA 454+50.00	XS59	1264	CROSS SECTIONS FIFTH AVE - STA 476+1		1295	CROSS SECTIONS FIFTH AVE - STA 495+50.00
chade			XS29	1234	CROSS SECTIONS FIFTH AVE - STA 455+00.00 TO STA 4	455+50.00 XS60	1265	CROSS SECTIONS FIFTH AVE - STA 476+5	0.00 XS	1296	CROSS SECTIONS FIFTH AVE - STA 496+00.00
			XS30	1235	CROSS SECTIONS FIFTH AVE - STA 455+65.00 TO STA 4		1266	CROSS SECTIONS FIFTH AVE - STA 477+00		1297	CROSS SECTIONS FIFTH AVE - STA 496+50.00
seph.		CROSS SECTION	<u>S</u> xs31	1236	CROSS SECTIONS FIFTH AVE - STA 456+50.00 TO STA 4	456+80.00 XS62	1267	CROSS SECTIONS FIFTH AVE - STA 477+4	2.00 XS	1298	CROSS SECTIONS FIFTH AVE - STA 497+00.00 CROSS SECTIONS
Š XS1	1206	FIFTH AVE - 3TA 434+00.00 TO .	STA 434+50.00 XS32	1237	CROSS SECTIONS FIFTH AVE - STA 457+00.00 TO STA	457+50.00 XS63	1268	CROSS SECTIONS FIFTH AVE - STA 477+5	0.00 XS	1299	FIFTH AVE - STA 497+50.00
XS2	1207	FIFTH AVE - 31A 433+00 TO 31	A 435+16.00 XS33	1238	CROSS SECTIONS FIFTH AVE - STA 458+00.00 TO STA	458+50.00 XS64	1269	CROSS SECTIONS FIFTH AVE - STA 477+9	0.00 XS	95 1300	CROSS SECTIONS FIFTH AVE - STA 498+00.00
XS3	1208	CROSS SECTIONS FIFTH AVE - STA 435+50.00 TO S CROSS SECTIONS	STA 436+00.00 XS34	1239	CROSS SECTIONS FIFTH AVE - STA 459+00.00 TO STA 4 CROSS SECTIONS	459+44.00 XS65	1270	CROSS SECTIONS FIFTH AVE - STA 478+0 CROSS SECTIONS	0.00 XS	96 1301	CROSS SECTIONS FIFTH AVE - STA 498+50.00 CROSS SECTIONS
XS4	1209	FIFTH AVE - STA 436+5	0.00 XS35	1240	FIFTH AVE - STA 459+50.00 TO STA	459+75.00 XS66	1271	FIFTH AVE - STA 478+50.00 TO S	TA 479+00.00 XS	37 1302	FIFTH AVE - STA 499+00.00 TO STA 499+50.00
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• ≤		8014				THE PREPARATION OF THIS		·	DESIGNED JMS		ORT AUTHORITY OF ALLEGHENY COUNTY
FILE PATH CIND						DOCUMENT HAS BEEN FINANCE PART THROUGH A GRANT FROM	THE	(NOT FOR	DRAWN JMS CHECKED MES		TSBURGH PENNSYLVANIA BUS RAPID TRANSIT UPTOWN TO OAKLAND
E PAT	Gulf 7	Tower				FEDERAL TRANSIT ADMINISTRATUS. DEPARTMENT OF TRANSPORTATION, UNDER THE		CONSTRUCTION)	IN CHARGE <u>LAR</u>		INDEX OF DRAWINGS
	5th F	ant Street Floor	NO. DATE		DESCRIPTION	URBAN MASS TRANSPORTATION OF 1964, AS AMENDED, FOR THE PORT AUTHORITY OF ALLEGHEN			DATE <u>05/01/24</u> SCALE	Port	Authority CONTRACT NO. BRT-001
F	πτspurgh,	n, PA 15219		1	REVISIONS	COUNTY, PENNSYLVANIA.			AS SHOWN	1 UIL	connecting people to life DWG. NO. GN13 SHT. 13

ED: 4/23	DRAWING NUMBER	SHEET NUMBER	TITLE	DRAWING NUMBER	SHEET NUMBER	TITLE	DRAWING NUMBER			DRAWING NUMBER	SHEET NUMBER	TITLE
PLOTT			CROSS SECTIONS (CONT'D)			CROSS SECTIONS (CONT'	D)		CROSS SECTIONS (CONT	- _' D)		CROSS SECTIONS (CONT'D)
	XS98	1303	CROSS SECTIONS FIFTH AVE - STA 500+00.00 TO STA 500+50.00	XS129	1334	CROSS SECTIONS FIFTH AVE - STA 533+00₊00 TO STA 53	33+50 00 0	0	0	XS191	1396	CROSS SECTIONS FORBES AVE - STA 138+00.00
	XS99	1304	CROSS SECTIONS FIFTH AVE - STA 500+50.00	XS130	1335	CROSS SECTIONS FIFTH AVE - STA 534+00.00 TO STA 53	VC1C1	1366	CROSS SECTIONS FORBES AVE - STA 121+50.0	xS192	1397	CROSS SECTIONS FORBES AVE - STA 138+50.00
	XS100	1305	CROSS SECTIONS FIFTH AVE - STA 501+50.00 TO STA 502+00.00	XS131	1336	CROSS SECTIONS FIFTH AVE - STA 535+00.00 TO STA 53	VC1C2	1367	CDOSS SECTIONS	VC103	1398	CROSS SECTIONS FORBES AVE - STA 139+00.00
	XS101	1306	CROSS SECTIONS FIFTH AVE - STA 502+50.00 TO STA 503+00.00	XS132	1337	CROSS SECTIONS FIFTH AVE - STA 536+00.00 TO STA 53	VC1C7	1368	CDOSS SECTIONS	VC104	1399	CROSS SECTIONS FORBES AVE - STA 139+50.00
	XS102	1307	CROSS SECTIONS FIFTH AVE - STA 503+50.00 TO STA 504+00.00	XS133	1338	CROSS SECTIONS FIFTH AVE - STA 537+00.00 TO STA 53	VC1C4	1369	CROSS SECTIONS	VC105	1400	CROSS SECTIONS FORBES AVE - STA 140+00.00
	XS103	1308	CROSS SECTIONS FIFTH AVE - STA 504+50.00 TO STA 505+00.00	XS134	1339	CROSS SECTIONS FIFTH AVE - STA 538+00.00 TO STA 53	VC1CE	1370	CDOSS SECTIONS	VC10C	1401	CROSS SECTIONS FORBES AVE - STA 140+50.00
	XS104	1309	CROSS SECTIONS FIFTH AVE - STA 505+50.00	XS135	1340	CROSS SECTIONS FIFTH AVE - STA 539+00.00 TO STA 53	VS1CC	1371	CROSS SECTIONS FORBES AVE - STA 123+50.00 TO STA	124+00.00 XS197	1402	CROSS SECTIONS FORBES AVE - STA 141+00.00
	XS105	1310	CROSS SECTIONS FIFTH AVE - STA 506+00.00	XS136	1341	CROSS SECTIONS FIFTH AVE - STA 540+00.00 TO STA 54	VC1C7	1372	CDACC CECTIONS	VC108	1403	CROSS SECTIONS FORBES AVE - STA 141+50.00
	XS106	1311	CROSS SECTIONS FIFTH AVE - STA 506+50.00 TO STA 507+00.00	XS137	1342	CROSS SECTIONS FIFTH AVE - STA 541+00.00 TO STA 54	11+50.00 XS168	1373	CROSS SECTIONS FORBES AVE - STA 125+00.0	0 XS199	1404	CROSS SECTIONS FORBES AVE - STA 141+78.00
	XS107	1312	CROSS SECTIONS FIFTH AVE - STA 507+50.00	XS138	1343	CROSS SECTIONS FIFTH AVE - STA 542+00.00 TO STA 54	2+50.00 XS169	1374	CROSS SECTIONS FORBES AVE - STA 125+50.0	xs200	1405	CROSS SECTIONS FORBES AVE - STA 142+00.00
	XS108	1313	CROSS SECTIONS FIFTH AVE - STA 508+00.00	XS139	1344	CROSS SECTIONS FIFTH AVE - STA 543+00.00 TO STA 54	3+50.00 XS170	1375	CROSS SECTIONS FORBES AVE - STA 126+00.00 TO STA	126+50.00 XS201	1406	CROSS SECTIONS FORBES AVE - STA 142+50.00
	XS109	1314	CROSS SECTIONS FIFTH AVE - STA 508+50.00	XS140	1345	CROSS SECTIONS FIFTH AVE - STA 544+00.00 TO STA 54	14+50.00 XS171	1376	CROSS SECTIONS FORBES AVE - STA 127+00.0	xs202	1407	CROSS SECTIONS FORBES AVE - STA 143+00.00 TO STA 143+50.00
	XS110	1315	CROSS SECTIONS FIFTH AVE - STA 509+00.00 TO STA 509+50.00	XS141	1346	CROSS SECTIONS FIFTH AVE - STA 550+94.00 TO STA 55	i1+00.00 XS172	1377	CROSS SECTIONS FORBES AVE - STA 127+50.0	xs203	1408	CROSS SECTIONS FORBES AVE - STA 144+00.00 TO STA 144+50.00
	XS111	1316	CROSS SECTIONS FIFTH AVE - STA 510+00.00 TO STA 510+50.00	XS142	1347	CROSS SECTIONS FIFTH AVE - STA 551+50.00 TO STA 55	32+00.00 XS173	1378	CROSS SECTIONS FORBES AVE - STA 128+00.0	00 XS204	1409	CROSS SECTIONS FORBES AVE - STA 145+00.00 TO STA 145+16.00
	XS112	1317	CROSS SECTIONS FIFTH AVE - STA 511+00.00 TO STA 511+50.00	XS143	1348	CROSS SECTIONS FIFTH AVE - STA 552+50.00 TO STA 55	3+00.00 XS174	1379	CROSS SECTIONS FORBES AVE - STA 128+50.0	xs205	1410	CROSS SECTIONS FORBES AVE - STA 145+50.00 TO STA 145+68.00
	XS113	1318	CROSS SECTIONS FIFTH AVE - STA 512+00.00 TO STA 512+50.00	XS144	1349	CROSS SECTIONS FIFTH AVE - STA 553+50.00 TO STA 55	34+00.00 XS175	1380	CROSS SECTIONS FORBES AVE - STA 129+00.0	xs206	1411	CROSS SECTIONS FORBES AVE - STA 146+00.00 TO STA 146+50.00
- dgn	XS114	1319	CROSS SECTIONS FIFTH AVE - STA 513+00.00 TO STA 513+50.00	XS145	1350	CROSS SECTIONS FIFTH AVE - STA 554+50.00 TO STA 55	55+00.00 XS176	1381	CROSS SECTIONS FORBES AVE - STA 129+24.0	0 XS207	1412	CROSS SECTIONS FORBES AVE - STA 147+00.00 TO STA 147+50.00
I 0D 12	XS115	1320	CROSS SECTIONS FIFTH AVE - STA 514+00.00 TO STA 514+50.00	XS146	1351	CROSS SECTIONS FIFTH AVE - STA 556+50.00 TO STA 55	57+00.00 XS177	1382	CROSS SECTIONS FORBES AVE - STA 129+50.0	0 XS208	1413	CROSS SECTIONS FORBES AVE - STA 148+00.00
-RD-	XS116	1321	CROSS SECTIONS FIFTH AVE - STA 515+00.00 TO STA 515+50.00	XS147	1352	CROSS SECTIONS FIFTH AVE - STA 557+50.00	XS178	1383	CROSS SECTIONS FORBES AVE - STA 130+00.0	00 XS209	1414	CROSS SECTIONS FORBES AVE - STA 148+25.00 TO STA 148+50.00
3T_01	XS117	1322	CROSS SECTIONS FIFTH AVE - STA 516+00.00 TO STA 516+50.00	XS148	1353	CROSS SECTIONS FIFTH AVE - STA 559+50.00 TO STA 56	xs179	1384	FUNDES AVE - STA 130+20.0	00 XS210	1415	CROSS SECTIONS FORBES AVE - STA 149+00.00 TO STA 149+50.00
,00\B	XS118	1323	CROSS SECTIONS FIFTH AVE - STA 516+97.00 TO STA 517+00.00	XS149	1354	CROSS SECTIONS FIFTH AVE - STA 560+50.00 TO STA 56	XS180	1385	FURDES AVE - STA 130+30.0	00 XS211	1416	CROSS SECTIONS FORBES AVE - STA 150+00.00 TO STA 150+50.00
02077	XS119	1324	CROSS SECTIONS FIFTH AVE - STA 517+50.00 TO STA 518+00.00	XS150	1355	CROSS SECTIONS FIFTH AVE - STA 561+50.00 TO STA 56	52+00.00 XS181	1386	FORDES AVE - STA 151+00.00 TO STA	131+50.00 XS212	1417	CROSS SECTIONS FORBES AVE - STA 151+00.00
P\moa	XS120	1325	CROSS SECTIONS FIFTH AVE - STA 518+50.00 TO STA 519+00.00	XS151	1356	CROSS SECTIONS FIFTH AVE - STA 562+50.00 TO STA 56	XS182	1387	CROSS SECTIONS FORBES AVE - STA 132+00.00 TO STA	132+50.00 XS213	1418	CROSS SECTIONS FORBES AVE - STA 151+50.00
com.	XS121	1326	CROSS SECTIONS FIFTH AVE - STA 520+50.00 TO STA 521+00.00	XS152	1357	CROSS SECTIONS FIFTH AVE - STA 563+50.00 TO STA 56	XS183	1388	FORBES AVE - STA 155+00.00 TO STA	133+50.00 XS214	1419	CROSS SECTIONS FORBES AVE - STA 152+00.00
sh@de	XS122	1327	CROSS SECTIONS FIFTH AVE - STA 521+50.00	XS153	1358	CROSS SECTIONS FIFTH AVE - STA 564+50.00 TO STA 57	73+95.00 XS184	1389	FUNDES AVE - STA 134+00.00 TO STA	134+50.00 XS215	1420	CROSS SECTIONS FORBES AVE - STA 152+50.00
 	XS123	1328	CROSS SECTIONS FIFTH AVE - STA 526+50.00 ORDER OF STA 526+50.00	XS155	1360	CROSS SECTIONS WASHINGTON PL - STA 25+50.00	XS185	1390	FORDES AVE - STA 135+00.00 TO STA	135+50.00 XS216	1421	CROSS SECTIONS FORBES AVE - STA 152+55.00
seph.	XS124	1329	CROSS SECTIONS FIFTH AVE - STA 527+00.00 TO STA 527+30.00	XS156	1361	CROSS SECTIONS PRIDE ST - STA 30+50.00	XS186	1391	FUNDES AVE - STA 136+00.0	0 XS217	1422	CROSS SECTIONS FORBES AVE - STA 153+50.00
10/108	XS125	1330	CROSS SECTIONS FIFTH AVE - STA 527+50.00 TO STA 528+00.00	XS157	1362	CROSS SECTIONS MARION ST - STA 22+75.00	XS187	1392	FUNDES AVE - STA 136+50.0	0 XS218	1423	CROSS SECTIONS FORBES AVE - STA 154+50.00 ODDOC STA 154+50.00
s16_n	XS126	1331	CROSS SECTIONS FIFTH AVE - STA 530+50.00 TO STA 531+00.00	XS158	1363	CROSS SECTIONS WYANDOTTE ST - STA 30+50.00	XS188	1393	FUNDES AVE - STA 136+10.0	0 XS219	1424	CROSS SECTIONS FORBES AVE - STA 155+00.00 TO STA 155+27.00
b Jmos	XS127	1332	CROSS SECTIONS FIFTH AVE - STA 531+50.00 TO STA 532+00.00	XS159	1364	CROSS SECTIONS KIRKPATRICK ST - STA 30+50.00 TO STA		1394	FUNDES AVE - STA 131+00.0			
g\dec	XS128	1333	CROSS SECTIONS FIFTH AVE - STA 532+50.00	XS160	1365	CROSS SECTIONS KIRKPATRICK ST - STA 31+50.00	0 XS190	1395	CROSS SECTIONS FORBES AVE - STA 137+50.0	00		
silich" orking\												
"joseph.			044			T T	THE PREPARATION OF THIS		DE	ESIGNED JMS		ORT AUTHORITY OF ALLEGHENY COUNTY
78 "jo	A						DOCUMENT HAS BEEN FINANG PART THROUGH A GRANT FRO EDERAL TRANSIT ADMINISTE	OM THE		RAWN JMS HECKED MES		SBURGH PENNSYLVANIA BUS RAPID TRANSIT UPTOWN TO OAKLAND
RATOR: E PATH:	7	Gulf Tow 07 Grant S					LDEPARTMENT OF TRANSPORTATION, UNDER TH JRBAN MASS TRANSPORTATI			<u> </u>		INDEX OF DRAWINGS
OPE FILI		5th Floosburgh, PA	or	NO. DATE		DESCRIPTION	DE 1964, AS AMENDED, FOR T PORT AUTHORITY OF ALLEGH COUNTY, PENNSYLVANIA.	HE	,	CALE AS SHOWN	Port	Authority CONTRACT NO. BRT-001
	riil	buurgii, P	7 10218			REVISIONS	JOONTI, FEMINOTEVANIA.			7.0 0110 1011		connecting people to life DWG. NO. GN14 SHT. 14

	DRAWING SHEET NUMBER NUMBER	TITLE	DRAWING SHE			
		CROSS SECTIONS (CONT'D)		CROSS SECTIONS ((CONT'D)	
	XS220 1425	CROSS SECTIONS FORBES AVE - STA 155+50.00	XS251 145	CROSS SECTIONS		
	XS221 1426	CROSS SECTIONS FORBES AVE - STA 155+99.00	XS252 145	CROSS SECTIONS		
	XS222 1427	CROSS SECTIONS FORBES AVE - STA 156+00.00	XS253 145	CROSS SECTIONS		
	XS223 1428	CROSS SECTIONS FORBES AVE - STA 156+50.00 TO STA 157+00.00	XS254 145	CDOSS SECTIONS		
	XS224 1429	CROSS SECTIONS FORBES AVE - STA 157+50.00	XS255 146	CDOSS SECTIONS		
	XS225 1430	CROSS SECTIONS FORBES AVE - STA 158+00.00	XS256 146	CROSS SECTIONS FORBES AVE - STA 176-	-50.00	
	XS226 1431	CROSS SECTIONS FORBES AVE - STA 158+50.00	XS257 146	CROSS SECTIONS FORBES AVE - STA 176-	-58.00	
	XS227 1432	CROSS SECTIONS FORBES AVE - STA 159+00.00	XS258 146	CROSS SECTIONS FORBES AVE - STA 177	-00.00	
	XS228 1433	CROSS SECTIONS FORBES AVE - STA 159+50.00	XS259 146	CROSS SECTIONS FORBES AVE - STA 177+50.00 TO	STA 178+00.00	
	XS229 1434	CROSS SECTIONS FORBES AVE - STA 160+00.00	XS260 146	CROSS SECTIONS FORBES AVE - STA 178-	-50.00	
	XS230 1435	CROSS SECTIONS FORBES AVE - STA 160+50.00	XS261 146	CROSS SECTIONS FORBES AVE - STA 179	-00.00	
	XS231 1436	CROSS SECTIONS FORBES AVE - STA 161+00.00	XS262 146	CROSS SECTIONS FORBES AVE - STA 179	-50.00	
	XS232 1437	CROSS SECTIONS FORBES AVE - STA 161+36.00	XS263 146	CROSS SECTIONS FORBES AVE - STA 180-	-00.00	
	XS233 1438	CROSS SECTIONS FORBES AVE - STA 161+50.00	XS264 146	CROSS SECTIONS FORBES AVE - STA 180-	-50.00	
	XS234 1439	CROSS SECTIONS FORBES AVE - STA 162+00.00	XS265 147	O CROSS SECTIONS FORBES AVE - STA 180	-65.89	
	XS235 1440	CROSS SECTIONS FORBES AVE - STA 162+50.00	XS266 147	CROSS SECTIONS FORBES AVE - STA 211+50.00 TO	STA 212+00.00	
	XS236 1441	CROSS SECTIONS FORBES AVE - STA 163+00.00	XS267 147	CROSS SECTIONS FORBES AVE - STA 212+41.00 TO	STA 212+50.00	
	XS237 1442	CROSS SECTIONS FORBES AVE - STA 163+50.00 TO STA 164+00.00	XS268 147	CROSS SECTIONS FORBES AVE - STA 213+00.00 TO	STA 213+50.00	
	XS238 1443	CROSS SECTIONS FORBES AVE - STA 164+50.00 TO STA 165+00.00	XS269 147	CROSS SECTIONS FORBES AVE - STA 217	-15.00	
	XS239 1444	CROSS SECTIONS FORBES AVE - STA 165+50.00	XS270 147	CROSS SECTIONS FORBES AVE - STA 217	-21.50	
	XS240 1445	CROSS SECTIONS FORBES AVE - STA 165+88.00	XS271 147	CROSS SECTIONS FORBES AVE - STA 224+00.00 TO	STA 224+50.00	
	XS241 1446	CROSS SECTIONS FORBES AVE - STA 166+00.00	XS272 147	FUNDES AVE - STA 224+73.00 TO		
	XS242 1447	CROSS SECTIONS FORBES AVE - STA 166+32.00	XS273 147	FUNDES AVE - STA 223		
	XS243 1448	CROSS SECTIONS FORBES AVE - STA 166+50.00	XS274 147	FURDES AVE - STA 236+00.00 TO	STA 236+50.00	
	XS244 1449	CROSS SECTIONS FORBES AVE - STA 167+00.00 TO STA 167+50.00	XS275 148	FUNDES AVE - STA 236+36.00 TO	STA 237+00.00	
	XS245 1450	CROSS SECTIONS FORBES AVE - STA 168+00.00 TO STA 168+50.00	XS276 148	FUNDES AVE - STA 231		
	XS246 1451	CROSS SECTIONS FORBES AVE - STA 169+00.00 TO STA 169+50.00	XS277 148	FUNDES AVE - STA 245		
	XS247 1452	CROSS SECTIONS FORBES AVE - STA 170+00.00 TO STA 170+50.00	XS278 148	FORDES AVE - STA 243+30,00 TO	STA 245+76.00	
	XS248 1453	CROSS SECTIONS FORBES AVE - STA 171+00.00	XS279 148	FURDES AVE - STA 246+00,00 TO	STA 246+46.00	
	XS249 1454	CROSS SECTIONS FORBES AVE - STA 171+28.00 TOSTA 171+50.00	XS280 148	FUNDES AVE - STA 246+50,00 TO	STA 247+00.00	
	XS250 1455	CROSS SECTIONS FORBES AVE - STA 172+00.00 TO STA 172+50.00	XS281 148	CROSS SECTIONS FORBES AVE - STA 247+50.00 TO	STA 248+00.00	
A = 00 A 4		THE BREAK	ION OF THIS	·	DESIGNED JMS	PORT AUTHORITY OF ALLEGHENY COUNTY
AECOM		PART THROUGH	S BEEN FINANCED IN I A GRANT FROM THE	(NOT FOR	DRAWN JMS CHECKED MES	PITTSBURGH PENNSYLVANIA BUS RAPID TRANSIT UPTOWN TO OAKLAND
Gulf Tower		U.S. DEPARTME TRANSPORTATI	ON, UNDER THE	CONSTRUCTION)	IN CHARGE <u>LAR</u>	INDEX OF DRAWINGS
707 Grant Street 5th Floor	NO. DATE	OF 1964, AS AME PORT AUTHORI	RANSPORTATION ACT ENDED, FOR THE TY OF ALLEGHENY	JONOTINO HON	DATE 05/01/24 SCALE A.S. S. H.O.M.N.I.	Port Authority CONTRACT NO. BRT-001
Pittsburgh, PA 15219		REVISIONS COUNTY, PENNS	SYLVANIA.	·	AS SHOWN	connecting people to life DWG. NO. GN15 SHT. 15

sнт. **16**

REVISIONS



SIGNING & PAVEMENT MARKING PLANS STORMWATER MANAGEMENT PLANS ROADWAY PLANS ROADWAY PROFILES SHEET BREAK EROSION AND SEDIMENTATION CONTROL PLANS ARCHITECTURAL PLANS 150 300 FEET DESIGN


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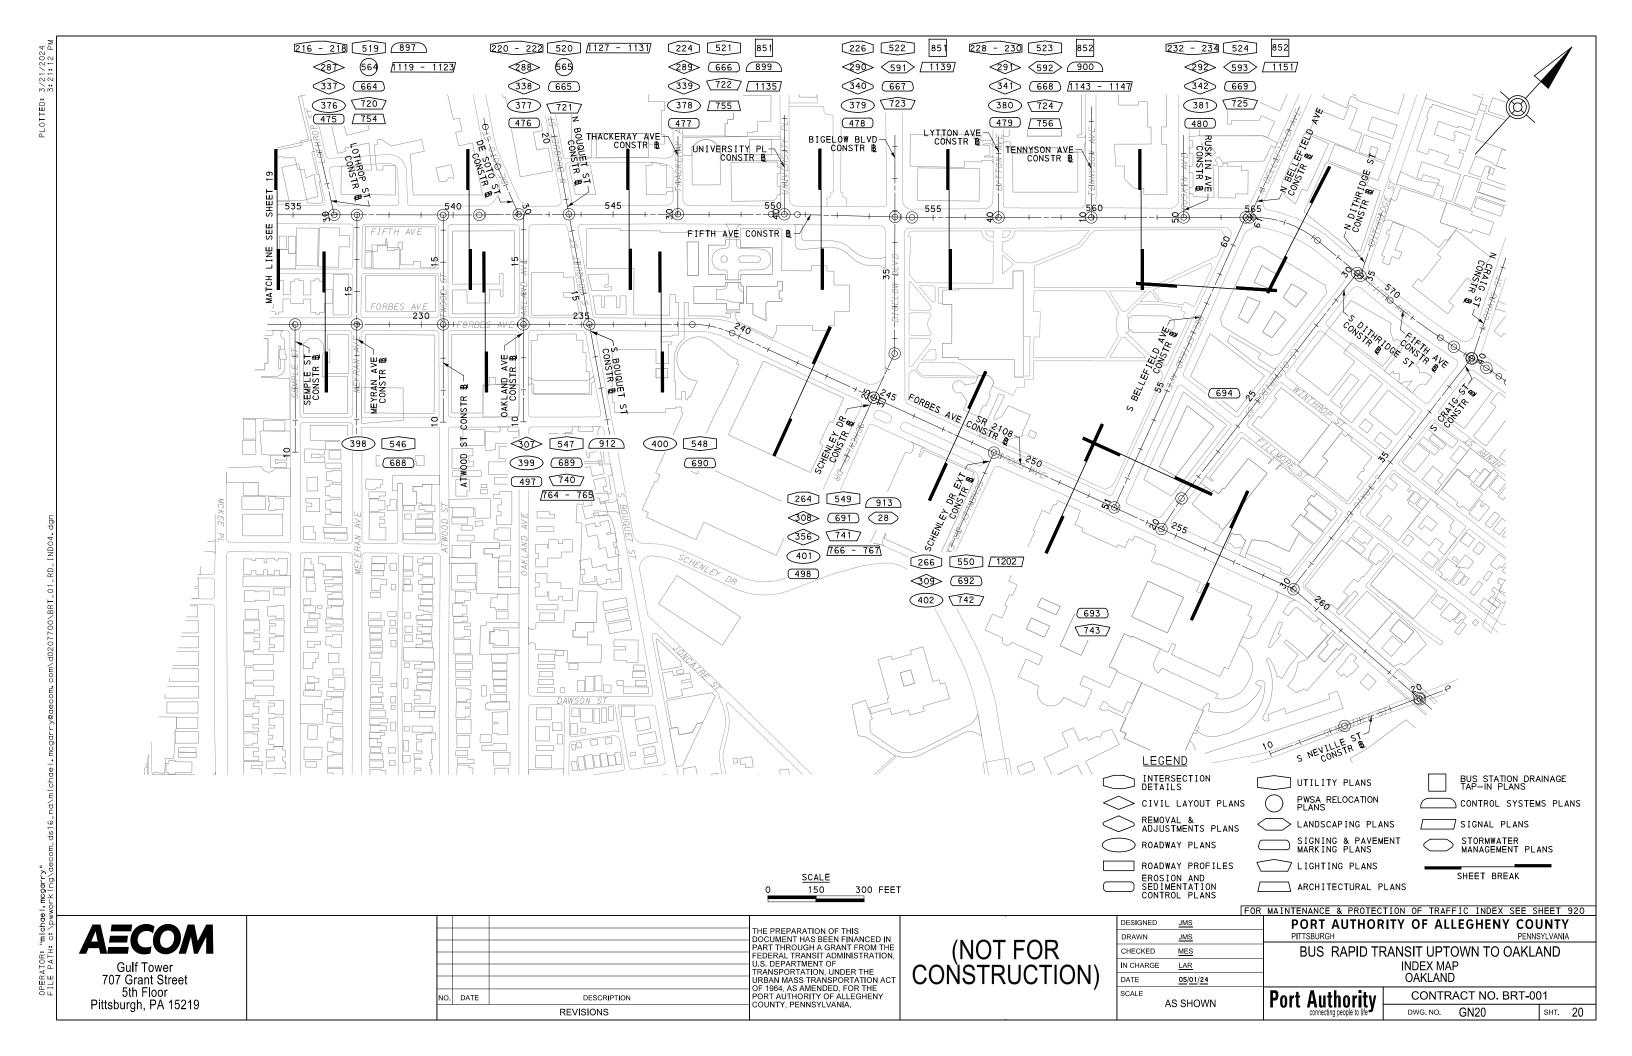
Gulf Tower 707 Grant Street 5th Floor Pittsburgh, PA 15219


THE PREPARATION OF THIS DOCUMENT HAS BEEN FINANCED IN PART THROUGH A GRANT FROM THE FEDERAL TRANSIT ADMINISTRATION, U.S. DEPARTMENT OF TRANSPORTATION, UNDER THE URBAN MASS TRANSPORTATION ACT OF 1964, AS AMENDED, FOR THE PORT AUTHORITY OF ALLEGHENY COUNTY, PENNSYLVANIA. NO. DATE DESCRIPTION REVISIONS


(NOT FOR CONSTRUCTION)

	FOR MAIN	TENANCE & PROTECTI	<u>ION OF TRAF</u>	<u>FIC INDEX SEE S</u>	<u>HEET 918</u>		
DESIGNED JMS		PORT AUTHORI	TY OF AL	LEGHENY COL	JNTY		
DRAWN <u>JMS</u>		PITTSBURGH		PENNS	SYLVANIA		
CHECKED MES		BUS RAPID TRA	ANSIT UPT	OWN TO OAKLA	AND		
IN CHARGE <u>LAR</u>			INDEX MA	•			
DATE <u>05/01</u>	24		UPTOWN				
AS SHOWN Port Authority CONTRACT NO. BRT-001							
AO ONE		connecting people to life	DWG. NO.	GN18	sнт. 18		



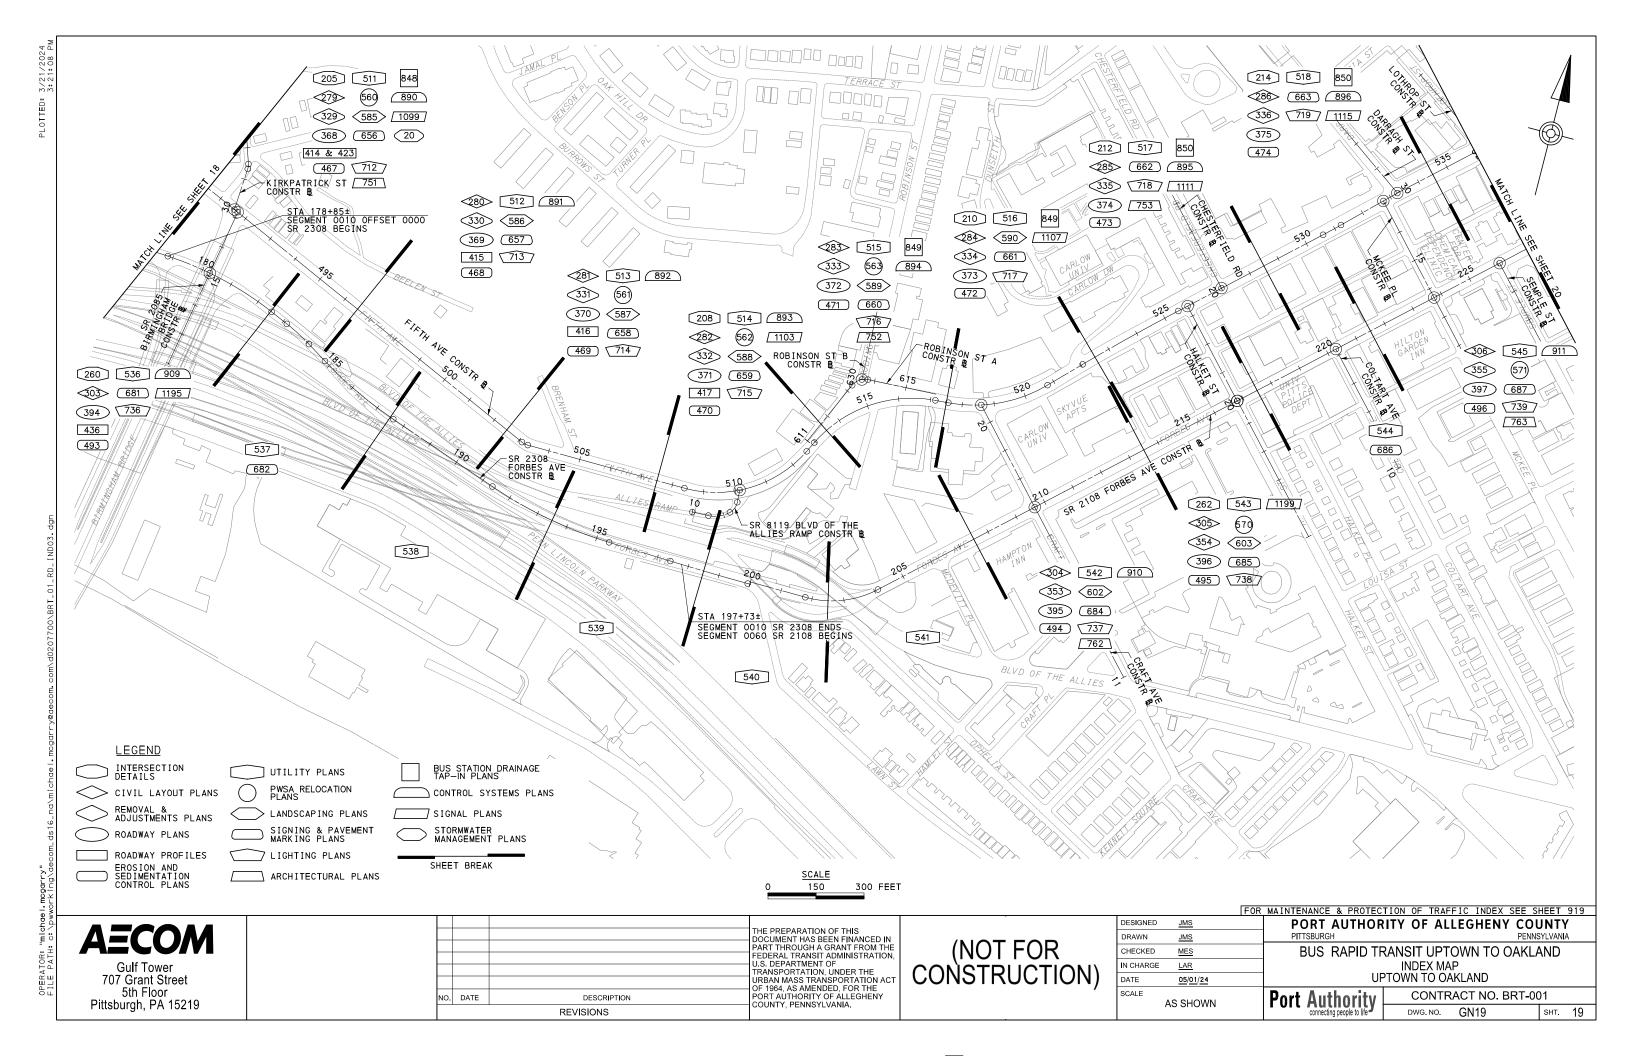

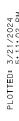

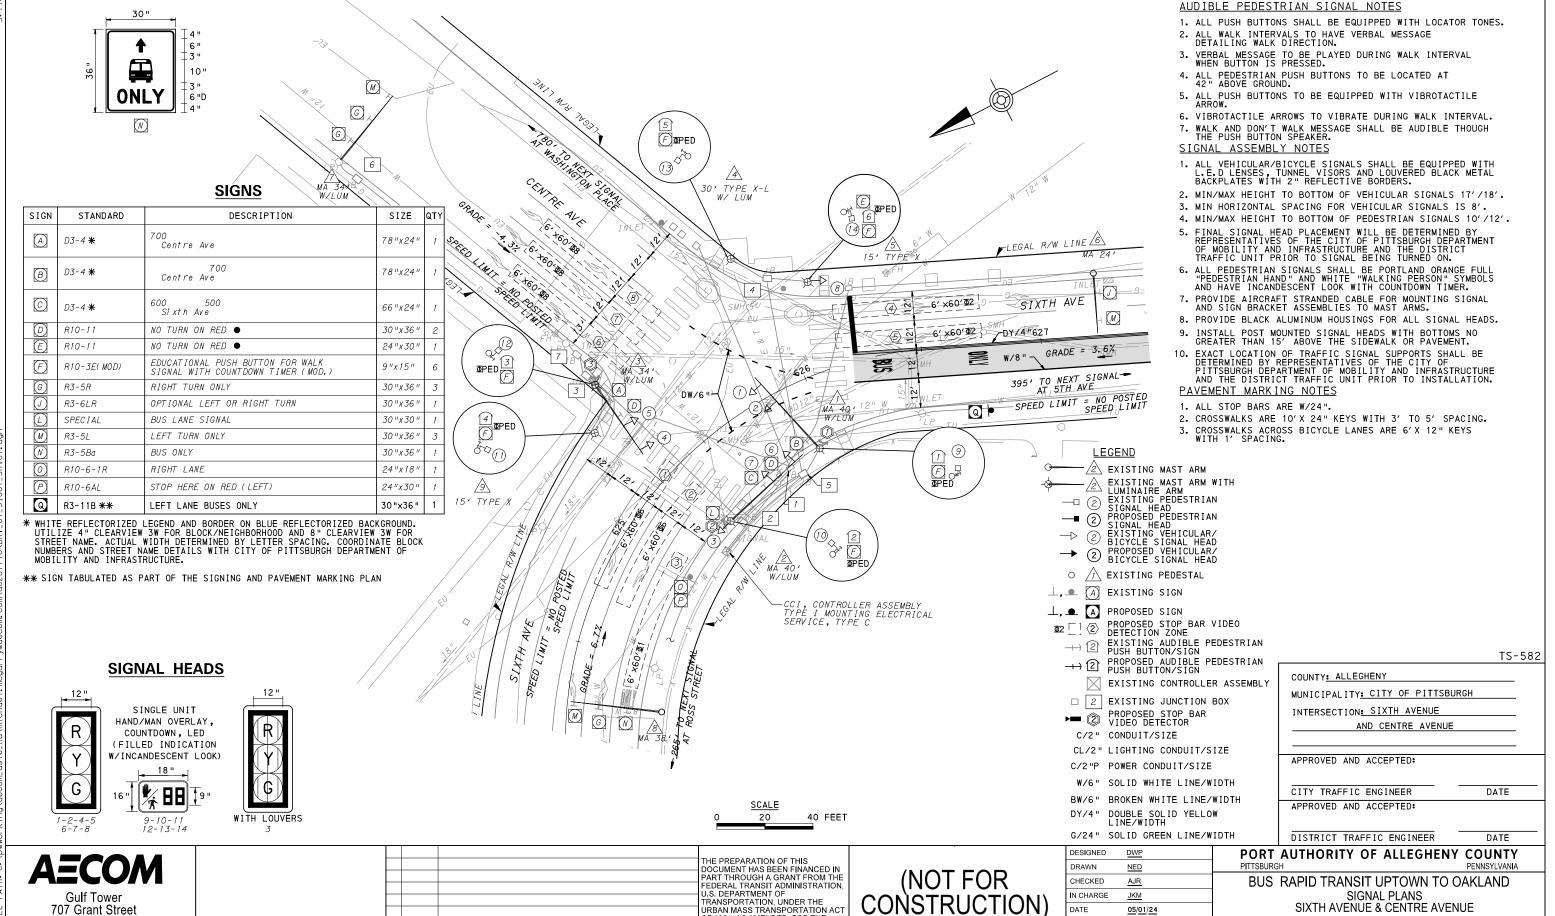

URBAN MASS TRANSPORTATION ACT

OF 1964 AS AMENDED FOR THE

COUNTY, PENNSYLVANIA.

SIXTH AVENUE & CENTRE AVENUE

DWG. NO.

Port Authority

CONTRACT NO. BRT-001

sнт. 1061

SG1

DATE

SCALE

05/01/24

AS SHOWN

707 Grant Street

5th Floor

Pittsburgh, PA 15219


NO. DATE

DESCRIPTION

REVISIONS

MOVEMENT, PHASING AND SEQUENCE CHART

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INTERVAL SIGNAL	1	2	3	4		1	2	3	4		1	2	3	4		1	2	3	4]
1-2	R	R	R			G	Υ	R			R	R	R			R	R	R			R
3	G	Υ	R			R	R	R			R	R	R			R	R	R			R
4-5-8	G	G	G			G	Υ	R			R	R	R			R	R	R			R
6-7	R	R	R			R	R	R			R	R	R			G	Υ	R			R
9-10-11-12-13-14	DW	DW	DW			DW	DW	DW			W	FD	DW			DW	DW	DW			OFF
FIXED	X	4	3			\times	3	3					3			\times	3	3			1
MINIMUM	5					15										7					1
PASSAGE	3					3										3					1
FREE (MAX)	10					60										45]
PEDESTRIAN											11	19									1
MEMORY		NON	LOC	KING		MIN RECALL			PED RECALL				NON LOCKING					1			

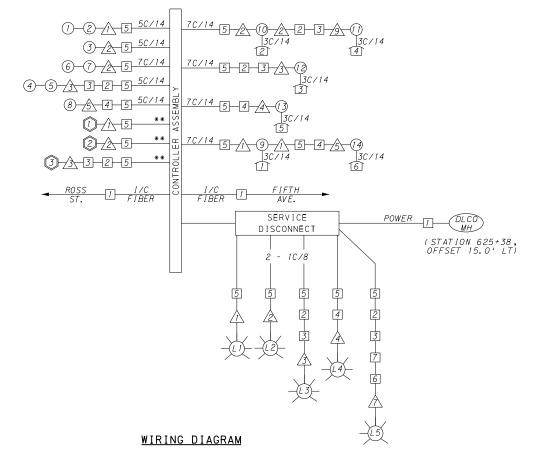

5C/14 - CABLE (NO. OF CONDUCTORS/SIZE AWG.)

- 1 EXISTING SIGNAL HEAD
- (1) PROPOSED SIGNAL HEAD
- EXISTING AUDIBLE PEDESTRIAN INDICATOR
- PROPOSED AUDIBLE PEDESTRIAN INDICATOR EXISTING SIGNAL SUPPORT 🔨 PROPOSED SIGNAL SUPPORT
- 1 EXISTING JUNCTION BOX
- 1 PROPOSED JUNCTION BOX -L1- PROPOSED LUMINAIRE
- EXISTING LUMINAIRE **(1)** PROPOSED DETECTOR
 - INCIDENTAL TO ITEM 02895.001, AS PER MANUFACTURERS SPECIFICATIONS

TRANSIT PRIORITY PRE-EMPTION NOTES (TO BE INSTALLED BY OTHERS)

- COORDINATE TRAFFIC CONTROLLER PROGRAMMING MODIFICATION WITH REPRESENTATIVES OF THE CITY OF PITTSBURGH AND DISTRICT TRAFFIC UNIT.
- 2. INCLUDE A TRANSIT PRIORITY PHASE THAT WILL EXTEND THE INDICATED PHASE A MAXIMUM OF 10 SECONDS WHEN ACTIVATED BY A PORT AUTHORITY VEHICLE. DO NOT VIOLATE SIDE STREET PEDESTRIAN MINIMUM TIMINGS.
- 3. MAINTAIN ALL YELLOW CLEARANCES AT ALL TIMES.
- 4. PROCEED TO THE SUBSEQUENT INTERVAL AS DEFINED IN THE MOVEMENT, SEQUENCE AND TIMING DIAGRAM UPON COMPLETING THE GREEN EXTENSION INTERVAL.
- 5. ONCE A TRANSIT CALL IS PLACED AND SATISFIED, THE CONTROLLER WILL NOT SATISFY ANOTHER CALL FOR
- 6. LOCATION OF BUS DETECTORS ARE TO BE FIELD ADJUSTED TO ACHIEVE MAXIMUM OPERATION.

DETECTOR ZONE INFORMATION

DETECTOR	DETECTION ZONE(S)	MODE	TYPE	ROUTE	PHASE	LOCATION MAST ARM
	⟨4⟩⟨5⟩ (6'x60')	PRESENCE	RADAR (STOP BAR)	6TH AVENUE	2	\triangle
	(1\2\) (6'x60')	PRESENCE	RADAR (STOP BAR)	6TH AVENUE	6	A
2	⟨3⟩ (6'x60')	FRESENCE	RADAR (STOF BAR)	61H AVENUE	1	
3	(6\7\8)(6'x60')	PRESENCE	RADAR (STOP BAR)	CENTRE AVENUE	8	3

COUNTY: ALLEGHENY	
MUNICIPALITY: CITY OF PITTSBURGH	
INTERSECTION: SIXTH AVENUE	
AND CENTRE AVENUE	
APPROVED AND ACCEPTED:	
CITY TRAFFIC ENGINEER	DATE
APPROVED AND ACCEPTED:	
DISTRICT TRAFFIC ENGINEER	DATE

AECOM

Gulf Tower 707 Grant Street 5th Floor Pittsburgh, PA 15219

THE PREPARATION OF THIS OF 1964 AS AMENDED FOR THE NO. DATE DESCRIPTION COUNTY, PENNSYLVANIA. REVISIONS

CONSTRUCTION)

ESIGNED	DWP	
RAWN	<u>NED</u>	
HECKED	<u>AJR</u>	
CHARGE	<u>JKM</u>	
ATE	05/01/24	
CALE		
	AS SHOWN	

PORT AUTHORITY OF ALLEGHENY COUNTY

BUS RAPID TRANSIT UPTOWN TO OAKLAND SIGNAL PLANS WIRING, MOVEMENT, PHASING & SEQUENCE DIAGRAMS

Port Authority

GENERAL NOTES

CONSTRUCTION NOTES

THE CITY OF PITTSBURGH SHALL INSPECT THE NEW SIGNAL EQUIPMENT PRIOR TO ACTIVATION.

ALL TRAFFIC SIGNAL MAINTENANCE AND OPERATION RESPONSIBILITIES SHALL BE TURNED OVER TO THE CITY OF PITTSBURGH AFTER THE FOLLOWING CONDITIONS ARE IMPLEMENTED TO THE CITY'S SATISFACTION:

1. PERMIT "AS-BUILT" TRAFFIC SIGNAL DRAWINGS ARE SUBMITTED AND APPROVED.

2. ALL PUNCH LIST ITEMS ARE COMPLETED BY THE CONTRACTOR.

3. AFTER THE 30-DAY CONTINUOUS UNINTERRUPTED SIGNAL OPERATION WITHOUT MALFUNCTIONS.

1. ALL JUNCTION BOXES IN WALK AREAS TO BE CITY OF PITTSBURGH STANDARD CONCRETE JUNCTION BOX, TYPE 1.

3. THERE SHALL BE NO SIGNAL WIRE OR FIBER CABLE SPLICING.

4. SERVICE WIRE FROM THE POWER SOURCE TO THE CONTROLLER CABINET SHALL BE PLACED IN SECONDARY SEPARATE CONDUIT.

9. REMOVE EXISTING SIGNAL EQUIPMENT NO LONGER IN USE AND RETURN TO THE CITY OF PITTSBURGH TRAFFIC CONTROL SHOP. COORDINATE DELIVERY OF EQUIPMENT WITH DELMAS MCELHANY, TRAFFIC CONTROL FOREMAN.

5. STREET LIGHT CABLE IS NOT PERMITTED TO RUN THROUGH THE CONTROLLER CABINET AND SHALL BE PLACED IN SEPARATE CONDUIT.

6. TRAFFIC SIGNAL CABLE SHALL BE PLACED IN DEDICATED CONDUIT. 7. MOUNT DISCONNECT ON POLE NEAREST TO THE CONTROLLER CABINET EXCLUDING TYPE X POLES. 8. REMOVE AND DISPOSE OF ALL EXISTING SIGNAL WIRING NO

2. ALL JUNCTION BOXES IN NON-WALK AREAS TO BE CITY STANDARD JB-2 WITH BOTTOM.

CONTRACT NO. BRT-001 DWG.NO. SG2 sнт. 1062

TS-582

DOCUMENT HAS BEEN FINANCED IN PART THROUGH A GRANT FROM THE (NOT FOR FEDERAL TRANSIT ADMINISTRATION U.S. DEPARTMENT OF TRANSPORTATION, UNDER THE URBAN MASS TRANSPORTATION ACT

ITEM NUMBER MISCELLANEOUS UNIT DESCRIPTION QTY. LOCATION REMARKS 01882002 TRAFFIC SIGNAL TIMING MODIFICATIONS 2 CC

DETECTORS

ITEM NUMBER	DESCRIPTION	SEN. NO.	QTY.	LOCATION			
	DIGITAL WAVE RADAR DETECTION		1				
	DIGITAL WAVE RADAR DETECTION	2	1	<u> </u>			
	DIGITAL WAVE RADAR DETECTION	3	1	<u> </u>			

TRAFFIC SIGNAL SUPPORTS **

POLE LEW DESCRIPTION > POUTE L B S										PE	AL															
POLE NO.	ITEM	DESCRIPTION	αΤΥ.	ROUTE	STATION	SIDE	OFFSE							ARM	"A"						Af	RM "(C "	SHAFT	SIG	NAL
					S		0	Н	K	L			LOCA			IGN				w	G	Х	z	Н	М	N
	UNIT										М	N	0	Р	R	S	T	U	Υ						<u> </u>	
\triangle		TRAFFIC SIGNAL SUPPORT, 40' MAST ARM WITH LUMINAIRE ARM (30' MOUNTING HEIGHT), PAINTED GRAY	1	SIXTH AVE	625+93	R	29 '	17 1	10'	40 '	36 '	26 '							5′	18°		30 '	o°			
<u> </u>		TRAFFIC SIGNAL SUPPORT, 40' MAST ARM WITH LUMINAIRE ARM (30' MOUNTING HEIGHT), PAINTED GRAY	1	SIXTH AVE	625+34	R	32 '	17 '	10'	40 '	36 '	24'			29 ′	19'	0'		13'	90°	- 1	30 ʻ	o°			
<u> </u>		TRAFFIC SIGNAL SUPPORT, 34' MAST ARM WITH LUMINAIRE ARM (30' MOUNTING HEIGHT), PAINTED GRAY	1	SIXTH AVE	625+35	L	47 '	17 '	10'	34 '	32'	20 '			15'				8'	349°		30 ′	0°			
4		TRAFFIC SIGNAL SUPPORT, 30' TYPE X-L WITH LUMINAIRE ARM, PAINTED GRAY	1	SIXTH AVE	625+95	L	58 '															30 '	o°	30 '		10'
<u> </u>		TRAFFIC SIGNAL SUPPORT, 15' TYPE X, PAINTED GRAY	1	SIXTH AVE	626+13	L	37 '																	15'		10'
Â		TRAFFIC SIGNAL SUPPORT, 24' MAST ARM, PAINTED GRAY	1	SIXTH AVE	627+24	L	26 '	17 '		24'					19'	7′										
A		TRAFFIC SIGNAL SUPPORT, 34' MAST ARM WITH LUMINAIRE ARM (30' MOUNTING HEIGHT), PAINTED GRAY	1	CENTRE AVE		R	40 '	17 '		34 '					33'	21'	8 '					30 '	o°			
<u> </u>		TRAFFIC SIGNAL SUPPORT, 38' MAST ARM, PAINTED GRAY	1	SIXTH AVE	624+24	R	40 ′	17 +		38 '					37 '	26 '	14'									
Á		TRAFFIC SIGNAL SUPPORT, 15' TYPE X, PAINTED GRAY	1	SIXTH AVE	625+23	L	35 '																	15'		10'

** REFER TO TRAFFIC STANDARDS TC-8800 SERIES FOR LETTER DESIGNATION

TS-582

Gulf Tower 707 Grant Street 5th Floor Pittsburgh, PA 15219

		THE PREPARATION OF THIS
		DOCUMENT HAS BEEN FINANCED IN PART THROUGH A GRANT FROM TH
		FEDERAL TRANSIT ADMINISTRATION
		U.S. DEPARTMENT OF
		TRANSPORTATION, UNDER THE URBAN MASS TRANSPORTATION AC
		OF 1964, AS AMENDED, FOR THE
DATE		PORT AUTHORITY OF ALLEGHENY COUNTY, PENNSYLVANIA.
	DEVISIONS	COUNTY, FEMINSTEVANIA.

(NOT FOR CONSTRUCTION)

DESIGNED	<u>DWP</u>	
DRAWN	NED	
CHECKED	<u>AJR</u>	
IN CHARGE	<u>JKM</u>	
DATE	05/01/24	
SCALE		
	AS SHOWN	

PORT AUTHORITY OF ALLEGHENY COUNTY
PITTSBURGH

BLIS RAPID TRANSIT LIPTOWN TO OAKLAND


BUS RAPID TRANSIT UPTOWN TO OAKLAND SIGNAL PLANS TRAFFIC SIGNAL TABULATIONS

Port Authority CONTRAC

CONTRACT NO. BRT-001

DWG. NO. SG3 SHT. 1063

OPERATOR: "michael.mogarry" FILE PATH: C:\nww.crking\decom de16 na\michae

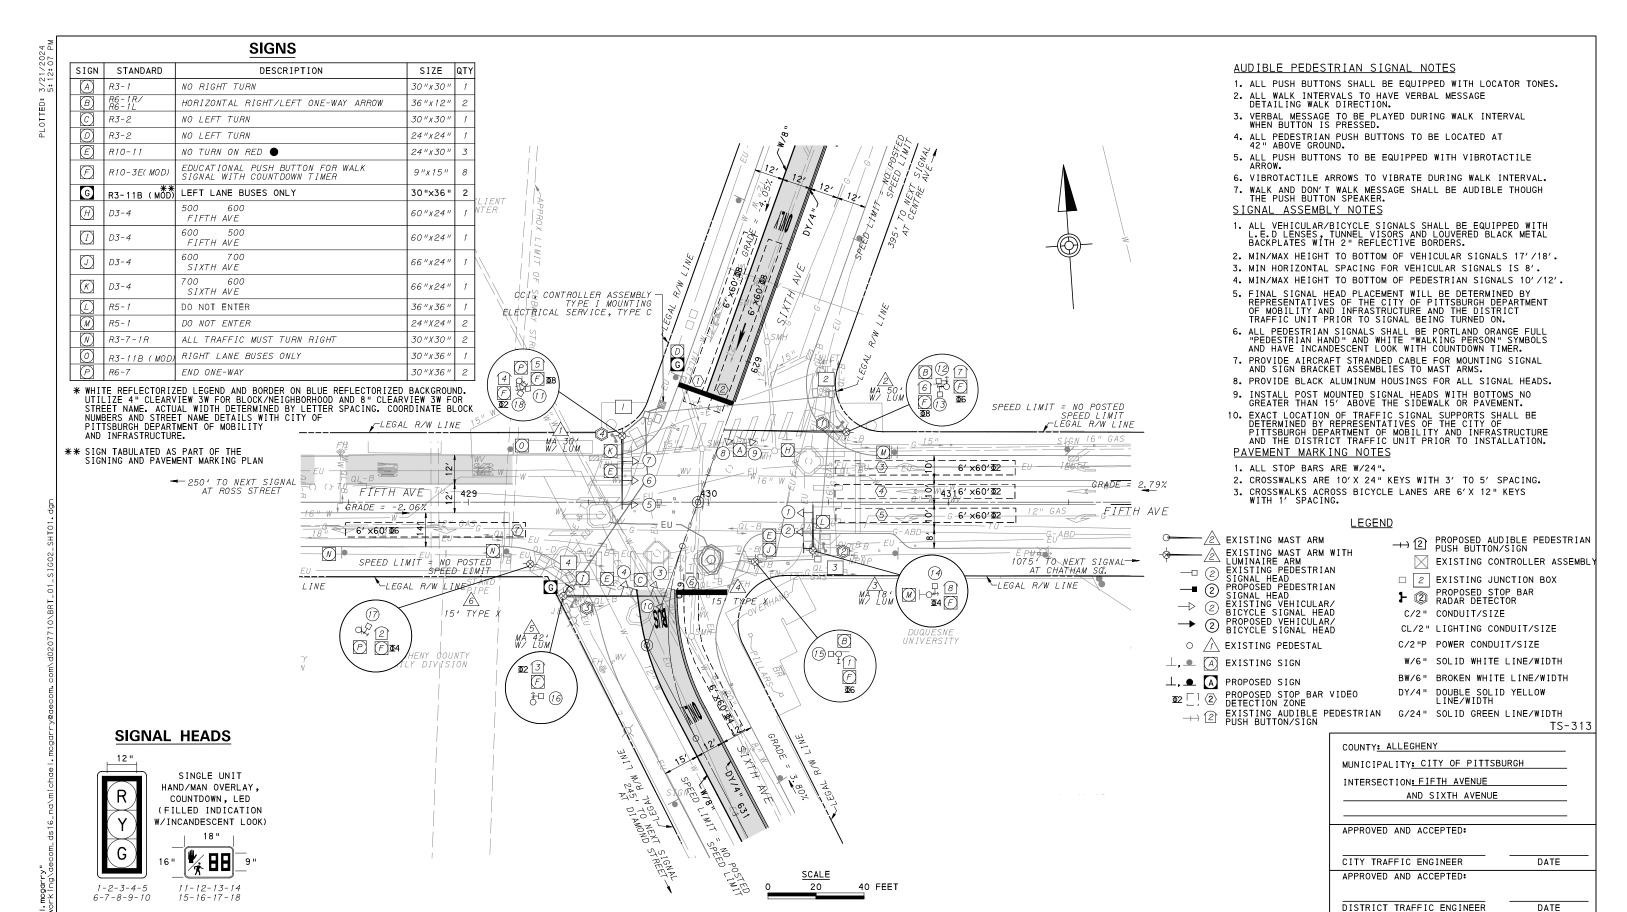

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FEDERAL TRANSIT ADMINISTRATION,
U.S. DEPARTMENT OF
TRANSPORTATION, UNDER THE
URBAN MASS TRANSPORTATION ACT
OF 1964, AS AMENDED, FOR THE
PORT AUTHORITY OF ALLEGHENY
COUNTY, PENNSYLVANIA.

REVISIONS

(NOT FOR CONSTRUCTION)

ESIGNED	DWP	
RAWN	NED	
HECKED	<u>AJR</u>	
CHARGE	<u>JKM</u>	
ATE	05/01/24	
CALE	AS SHOWN	
	710 0110 1111	

PORT AUTHORITY OF ALLEGHENY COUNTY PITTSBURGH PENNSYLVANIA

BUS RAPID TRANSIT UPTOWN TO OAKLAND
SIGNAL PLANS
EIETH AVENUE & SIXTH AVENUE

FIFTH AVENUE & SIXTH AVENUE

Port Authority CONTRACT NO. BRT-001


DWG. NO. SG4 SHT. 1064

MOVEMENT, PHASING AND SEQUENCE CHART

			4SE	2+6		P	HASE	4+	8		
	,		SN8-1			-	Blic		E		HLANTHZG HLANTHZG
		INT	ΓERV	ALS		I	NTER	RVAL	S		Y
SIGNAL	1	2	3	4	5	1	2	3	4	5	
1-2	R	G	G	Υ	R	R	R	R	R	R	R
3-4	R	R	R	R	R	R	G	G	Υ	R	R
5-6-7	R	G	G	Υ	R	R	R	R	R	R	R
8-9-10	R	R	R	R	R	R	G	G	Υ	R	R
11-12-15-16	W	W	FD	DW	DW	DW	DW	DW	DW	DW	OFF
13-14-17-18	DW	DW	DW	DW	DW	W	W	FD	DW	DW	OFF
FIXED		><	\leq	3.5	2.5	$/ \setminus$	><	\leq	4	2	
MINIMUM		1	5				1	5			
PASSAGE		,	3				- 3	3			
FREE (MAX)		6	0				4	5			
PEDESTRIAN	3	11	22			3	12	18			
MEMORY		PEI	RE	CALL	-		PΕ	D RE	CALI	-	

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WIRING DIAGRAM

5C/14 - CABLE (NO. OF CONDUCTORS/SIZE AWG.)

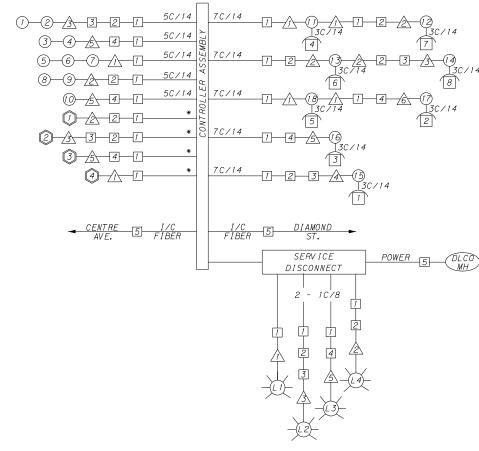EXISTING SIGNAL HEAD

(1) PROPOSED SIGNAL HEAD

EXISTING AUDIBLE PEDESTRIAN INDICATOR

PROPOSED AUDIBLE PEDESTRIAN INDICATOR

EXISTING SIGNAL SUPPORT

PROPOSED SIGNAL SUPPORT

1 EXISTING JUNCTION BOX PROPOSED JUNCTION BOX

EXISTING LUMINAIRE

—L1— PROPOSED LUMINAIRE

EXISTING DETECTOR PROPOSED DETECTOR

INCIDENTAL TO ITEM 02895.001 AS PER MANUFACTURERS SPECIFICATIONS

DETECTOR ZONE INFORMATION

DETECTOR	DETECTION ZONE(S)	MODE	TYPE	ROUTE	PHASE	LOCATION MAST ARM
①	⟨1\⟨2⟩ (6' x60')	PRESENCE	RADAR (STOP BAR)	6TH AVENUE	8	2
2	(3)(4)(5)(6' x60')	PRESENCE	RADAR (STOP BAR)	5TH AVENUE	2	3
3	⟨6⟩ (6′×60′)	PRESENCE	RADAR (STOP BAR)	6TH AVENUE	4	<u> </u>
4	⑦ (6′×60′)	PRESENCE	RADAR (STOP BAR)	5TH AVENUE	6	\triangle

GENERAL NOTES

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- 7. MOUNT DISCONNECT ON POLE NEAREST TO THE CONTROLLER CABINET EXCLUDING TYPE X POLES.
- 8. REMOVE AND DISPOSE OF ALL EXISTING SIGNAL WIRING NO
- 9. REMOVE EXISTING SIGNAL EQUIPMENT NO LONGER IN USE AND RETURN TO THE CITY OF PITTSBURGH TRAFFIC CONTROL SHOP. COORDINATE DELIVERY OF EQUIPMENT WITH DELMAS MCELHANY, TRAFFIC CONTROL FOREMAN.

TS-313

COUNTY: ALLEGHENY	
MUNICIPALITY: CITY OF PITTSBURGH	
INTERSECTION: FIFTH AVENUE	
AND SIXTH AVENUE	
APPROVED AND ACCEPTED:	
CITY TRAFFIC ENGINEER	DATE
APPROVED AND ACCEPTED:	
DISTRICT TRAFFIC ENGINEER	DATE

AECOM

Gulf Tower 707 Grant Street 5th Floor Pittsburgh, PA 15219

THE PREPARATION OF THIS DOCUMENT HAS BEEN FINANCED IN PART THROUGH A GRANT FROM THE FEDERAL TRANSIT ADMINISTRATION U.S. DEPARTMENT OF TRANSPORTATION, UNDER THE URBAN MASS TRANSPORTATION ACT OF 1964 AS AMENDED FOR THE NO. DATE DESCRIPTION COUNTY, PENNSYLVANIA. REVISIONS

(NOT FOR CONSTRUCTION)

ESIGNED	DWP	
RAWN	NED	
HECKED	<u>AJR</u>	
N CHARGE	<u>JKM</u>	
ATE	05/01/24	
CALE		
	AS SHOWN	

PORT AUTHORITY OF ALLEGHENY COUNTY PITTSBURGH

BUS RAPID TRANSIT UPTOWN TO OAKLAND SIGNAL PLANS WIRING, MOVEMENT, PHASING & SEQUENCE DIAGRAMS

Port Authorit

CONTRACT NO. BRT-001 DWG.NO. SG5 sнт. 1065

	DETE	CTORS		
ITEM NUMBER	DESCRIPTION	SEN. NO.	QTY.	LOCATION
	DIGITAL WAVE RADAR DETECTION	1	1	2
	DIGITAL WAVE RADAR DETECTION	2	1	3
	DIGITAL WAVE RADAR DETECTION	3	1	<u> </u>
	DIGITAL WAVE RADAR DETECTION	4	1	\triangle

I TEM NUMBER MISCELLANEOUS DESCRIPTION QTY. LOCATION REMARKS 01882. 002 TRAFFIC SIGNAL TIMING MODIFICATIONS 2 CC

TRAFFIC SIGNAL SUPPORTS **

				TRAFFIC	SIGNA		UFF	UKI	○ *	* 木																										
NO. I TEM					NO	ш	Ш								MAS	T ARI	М							PEC	ESTA	۱L										
POLE NO.	I I I	DESCRIPTION		DESCRIPTION		DESCRIPTION		DESCRIPTION		DESCRIPTION		DESCRIPTION		ROUTE	LAT I	SIDE	OFFSI							ARM	"A"						AF	RM "(M "C" SHAFT		SIGNAL	
					ST		0	Н	K	L	SIG	NAL I	OCA	TION	5	IGN	LOCA	10 I T	١	w	G	x	z	н	м	N										
	UNIT										М	N	0	Р	R	S	T	U	Υ																	
\triangle		TRAFFIC SIGNAL SUPPORT, 30' MAST ARM WITH LUMINAIRE ARM (30' MOUNTING HEIGHT), PAINTED GRAY	1	FIFTH AVE	429+64	L	28 ′	17 '	10'	30 '	28 '	18'	10'		15'				5′	o°		30 '	0°													
2		TRAFFIC SIGNAL SUPPORT, 50' MAST ARM WITH LUMINAIRE ARM (30' MOUNTING HEIGHT), PAINTED GRAY	1	SIXTH AVE	629+14	L	48 ′	17 '	10'	50 '	47 '	37 '			42'				24 '	19°		30 ′	o°													
3		TRAFFIC SIGNAL SUPPORT, 18' MAST ARM WITH LUMINAIRE ARM (30' MOUNTING HEIGHT), PAINTED GRAY	1	FIFTH AVE	430+43	R	20 '	17 ′	10'	18'	15'	7′			11'	4'			1'	o°		30 '	o°													
4		TRAFFIC SIGNAL SUPPORT, 15' TYPE X, PAINTED GRAY	1	SIXTH AVE	629+77	L	31'																	15'		10'										
<u> </u>		TRAFFIC SIGNAL SUPPORT, 42' MAST ARM WITH LUMINAIRE ARM (30' MOUNTING HEIGHT), PAINTED GRAY	1	SIXTH AVE	630+04	L	39 [,]	17 '	10'	42'	38 '	35 ′	23'		27 ′	18'			8 ′	5°		30 ′	0°													
<u>6</u>		TRAFFIC SIGNAL SUPPORT, 15' TYPE X, PAINTED GRAY	1	SIXTH AVE	629+99	R	60 '																	15'		10'										

** REFER TO TRAFFIC STANDARDS TC-8800 SERIES FOR LETTER DESIGNATION

TS-313

AECOM Gulf Tower 707 Grant Street 5th Floor Pittsburgh, PA 15219


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		U.S. DEPARTMENT OF TRANSPORTATION, UNDER THE
		URBAN MASS TRANSPORTATION AC
		OF 1964, AS AMENDED, FOR THE
DATE	DESCRIPTION	PORT AUTHORITY OF ALLEGHENY COUNTY, PENNSYLVANIA.
	REVISIONS	COUNTY, PENNSTEVANIA.

(NOT FOR CONSTRUCTION)

DESIGNED	<u>DWP</u>	
DRAWN	NED	
CHECKED	<u>AJR</u>	
IN CHARGE	<u>JKM</u>	
DATE	<u>05/01/24</u>	
SCALE		П
	AS SHOWN	

PORT AUTHORITY OF ALLEGHENY COUNTY BUS RAPID TRANSIT UPTOWN TO OAKLAND SIGNAL PLANS TRAFFIC SIGNAL TABULATIONS

Port Authority Connecting people to life CONTRACT NO. BRT-001 DWG. NO. SG6 sнт. 1066

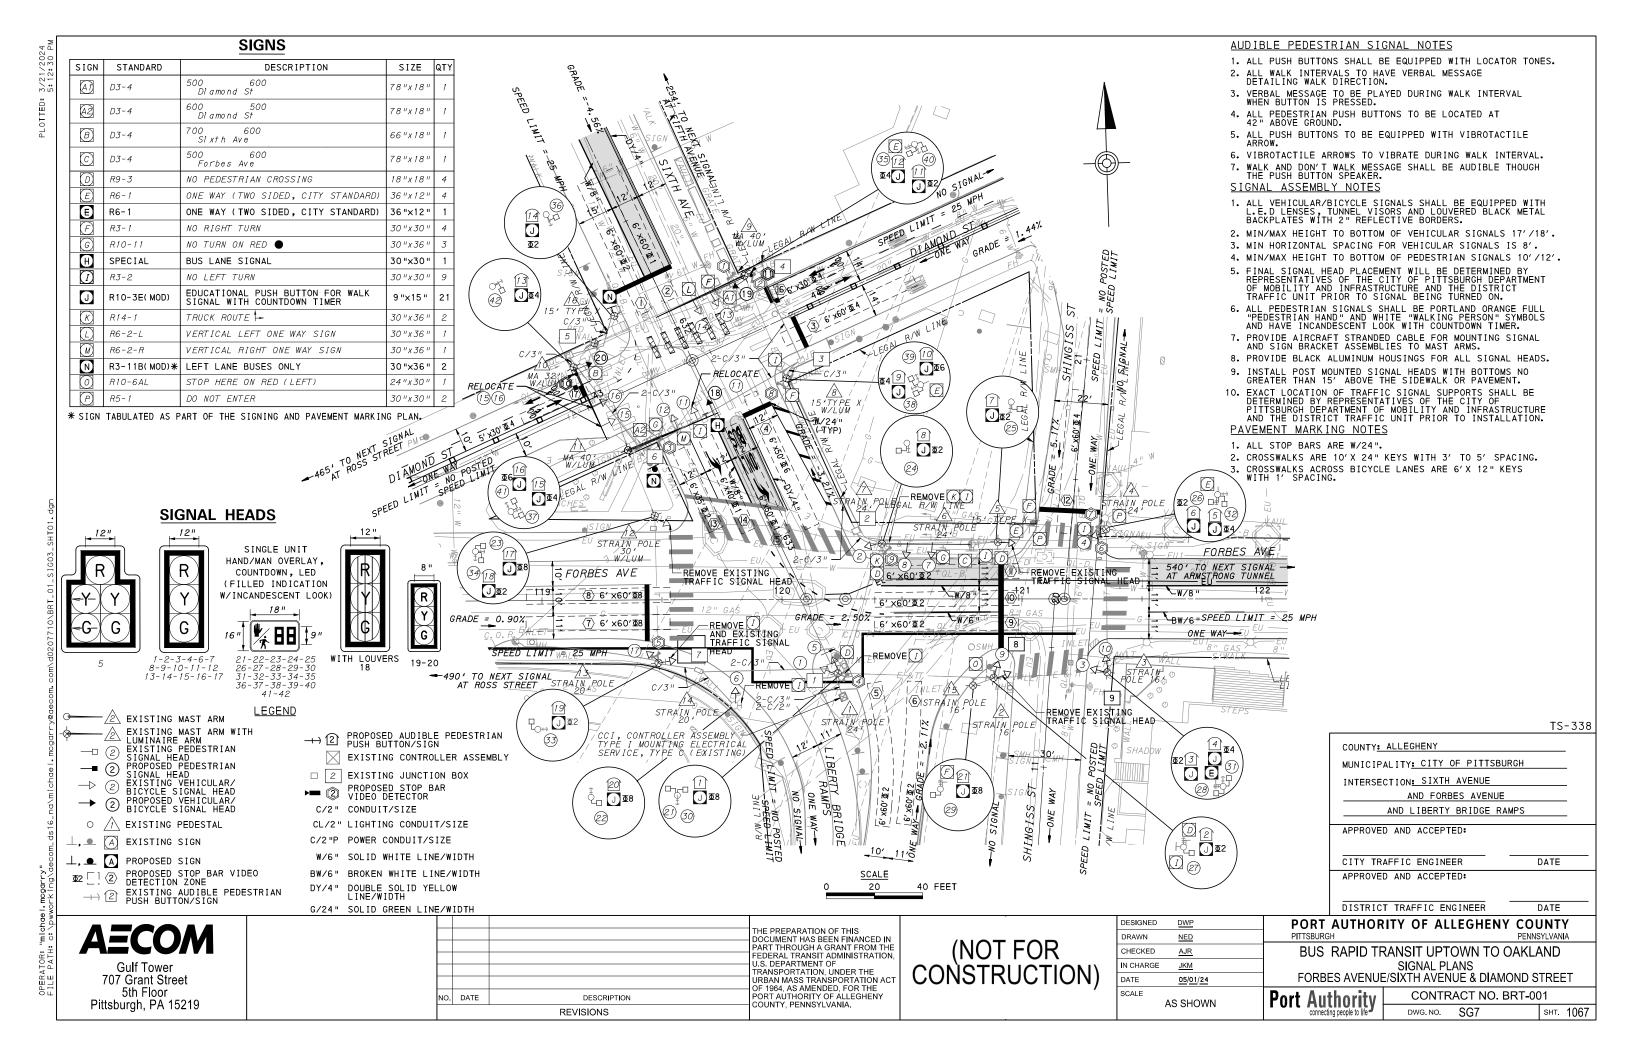

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		PH	HASE	8			PHASE 1					PH	HASE	2+6	5						
	31KE-[<u></u>	## ## #-	BIKE			ε <u>±</u> _ }τ		ВІК	##=	Bus Bus	BIKE BUS	===	BIKE-			FBIKE	 - 	EMERGEZCY
		INT	ΓERV	ALS			INT	ΓERV	ALS			I	NTEF	RVAL:	S		INT	ERV.	ALS		ľ
SIGNAL	1	2	3	4	-	1	2	3	-	-	1	2	3	4	5	1	2	3	4	-	
1-2-17	G	G	Υ	R		R	R	R			R	R	R	R	R	R	R	R	R		R
3-4	G	G	G	G		G	G	G			G	G	G	Υ	R	R	R	R	R		R
5	R	R	R	R		- G√G	- Y∕G	G			G	G	Υ	R	R	- G√G	- G√G	- Y-⁄Y	R		R
6	R	R	R	R		G	G	G			G	G	Υ	R	R	G	G	Υ	R		R
7 - 8	R	R	R	R		R	R	R			G	G	Υ	R	R	R	R	R	R		R
9-10	R	R	R	R		R	R	R			R	R	R	R	R	G	G	Υ	R		R
11-12-13-14	R	R	R	R		G	G	G			G	G	Υ	R	R	R	R	R	R		R
18	R	R	R	R		G	Υ	R			R	R	R	R	R	R	R	R	R		R
15-16	G	G	Υ	R		R	R	R			R	R	R	R	R	G	G	G	G		R
19-20	R	R	R	R		R	R	R			R	R	R	R	R	G	G	Υ	R		R
21-22-23-24-29-30	W	FD	DW	DW		DW	DW	DW			DW	DW	DW	DW	DW	DW	DW	DW	DW		OF
25-26-27-28	W	W	W	W		W	W	W			W	FD	DW	DW	DW	DW	DW	DW	DW		OF
31-32	DW	DW	DW	DW		DW	DW	DW			DW	DW	DW	DW	DW	W	FD	DW	DW		OF
33-34	DW	DW	DW	DW		W	W	W			W	W	W	W	W	W	FD	DW	DW		0FI
35-36-37-38	W	FD	DW	DW		DW	DW	DW			DW	DW	DW	DW	DW	W	W	W	W		OF
39-40-41-42	DW	DW	DW	DW		W	W	W			W	FD	DW	DW	DW	DW	DW	DW	DW		OF
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MINIMUM	1	0				7					1	0				1	0				
PASSAGE		3				3						3					3				
FREE (MAX)	3	3				9					2	7				2	7				
PEDESTRIAN	13	20				*					1.1	16				11	16				\vdash
MEMORY	1 3		RE(` A I . I	I		NON.	1.00	k I Nic		- ' '		REG	<u>Ι</u>	1			REC	`ΔΙΙ	I	+

MOVEMENT BUILDING AND SEQUENCE OURSE

DETECTOR ZONE INFORMATION

DETECTOR	DETECTION ZONE(S)	MODE	TYPE	ROUTE	PHASE	MAST ARM
	(1\(2\) (6' x60')	PRESENCE	RADAR (STOP BAR)	6TH AVENUE	2	<u> </u>
2	⟨3⟩ (6′×60′)	PRESENCE	RADAR (STOP BAR)	DIAMOND STREET	4	<u> </u>
	(3) (6′×35′)				2	
3	(4) (6'×40')	PRESENCE	RADAR (STOP BAR)	6TH AVENUE	2	\triangle
	(5) (6′×50′)				1	
4	(5)(6) (6' x60')	PRESENCE	RADAR (STOP BAR)	LIBERTY BRIDGE	2	\triangle
5	₹7\8\ (6′×60′)	PRESENCE	RADAR (STOP BAR)	FORBES AVENUE	8	<u> 1</u> 3
6	(9)(10) (6'×60')	PRESENCE	RADAR (STOP BAR)	FORBES AVENUE	2	4
\bigcirc	⟨2⟩ (6′×60′)	PRESENCE	RADAR (STOP BAR)	SHINGISS STREET	4	4
8	⟨4⟩ (6′ ×50′)	PRESENCE	RADAR (STOP BAR)	6TH AVENUE	6	8
9	(6′ ×60′)	PRESENCE	RADAR (STOP BAR)	FORBES AVENUE	2	À
10	⟨₹₹ (5′ ×30′)	PRESENCE	RADAR (STOP BAR)	DIAMOND STREET	4	Δà
	(6′ ×30′)	PRESENCE	RADAR (STOP BAR)	DIAMOND STREET	4	<u> </u>

GENERAL NOTES

THE CITY OF PITTSBURGH SHALL INSPECT THE NEW SIGNAL EQUIPMENT PRIOR TO ACTIVATION.

ALL TRAFFIC SIGNAL MAINTENANCE AND OPERATION RESPONSIBILITIES SHALL BE TURNED OVER TO THE CITY OF PITTSBURGH AFTER THE FOLLOWING CONDITIONS ARE IMPLEMENTED TO THE CITY'S SATISFACTION:

- PERMIT "AS-BUILT" TRAFFIC SIGNAL DRAWINGS ARE SUBMITTED AND APPROVED.
- 2. ALL PUNCH LIST ITEMS ARE COMPLETED BY THE CONTRACTOR.
- 3. AFTER THE 30-DAY CONTINUOUS UNINTERRUPTED SIGNAL OPERATION WITHOUT MALFUNCTIONS.

TRANSIT PRIORITY PRE-EMPTION NOTES (TO BE INSTALLED BY OTHERS)

- COORDINATE TRAFFIC CONTROLLER PROGRAMMING MODIFICATION WITH REPRESENTATIVES OF THE CITY OF PITTSBURGH AND DISTRICT TRAFFIC UNIT.
- 2. INCLUDE A TRANSIT PRIORITY PHASE THAT WILL EXTEND THE INDICATED PHASE A MAXIMUM OF 10 SECONDS WHEN ACTIVATED BY A PORT AUTHORITY VEHICLE. DO NOT VIOLATE SIDE STREET PEDESTRIAN MINIMUM TIMINGS.
- 3. MAINTAIN ALL YELLOW CLEARANCES AT ALL TIMES.
- 4. PROCEED TO THE SUBSEQUENT INTERVAL AS DEFINED IN THE MOVEMENT, SEQUENCE AND TIMING DIAGRAM UPON COMPLETING THE GREEN EXTENSION INTERVAL.
- 5. ONCE A TRANSIT CALL IS PLACED AND SATISFIED, THE CONTROLLER WILL NOT SATISFY ANOTHER CALL FOR 4 CYCLES.
- LOCATION OF BUS DETECTORS ARE TO BE FIELD ADJUSTED TO ACHIEVE MAXIMUM OPERATION.

DLCO WH#6103 U EXISTING FIBER OPTIC WH#6103 CONSTRUCTION NOTES

- 1. ALL JUNCTION BOXES IN WALK AREAS TO BE CITY OF PITTSBURGH STANDARD CONCRETE JUNCTION BOX, TYPE 1.
- ALL JUNCTION BOXES IN NON-WALK AREAS TO BE CITY STANDARD JB-2 WITH BOTTOM.

1 1 3C/14 5C/14

3C/14

3C/14

5C/14

3C/14

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4 3 2 1

6 4 6 A 1 D

9 8 3 2 1

10-8-3-2-1

11 9 4 3 2 1

12 9 4 3 2 7

16 1 2 1

17 /2 /A 6 3 2 /A /A /A

18 /2 /\ 6 3 2 /\ \ 1

19-13-7-1

20 12-11-

(5) <u>1</u> 7 - 1

21/3/2/1

13 /2 5 6 3 2 /2 /2

15 1 6 3 2 1

5C/14

7C/14

5C/14

7C/14

5C/14

1

7-7-6

-D-7-3-0

-11-17-13-33

1 1 2

5C/14

-1-1\hat{1}-13-16-1\hat{1}\hat{1}\hat{3}

-D-<u>A-A-®-A-</u>®

-11-/\-\/\-\/\-2--3--6--5--/\\-\\@

7 2 3 6 1 2 3

-11-\lambda \tau\lambda \tau\

- 3. THERE SHALL BE NO SIGNAL WIRE OR FIBER CABLE SPLICING.
- 4. SERVICE WIRE FROM THE POWER SOURCE TO THE CONTROLLER CABINET SHALL BE PLACED IN SECONDARY SEPARATE CONDUIT.
- 5. STREET LIGHT CABLE IS NOT PERMITTED TO RUN THROUGH THE CONTROLLER CABINET AND SHALL BE PLACED IN SEPARATE CONDUIT.
- 6. TRAFFIC SIGNAL CABLE SHALL BE PLACED IN DEDICATED CONDUIT.
- 7. MOUNT DISCONNECT ON POLE NEAREST TO THE CONTROLLER CABINET EXCLUDING TYPE X POLES.
- 8. REMOVE AND DISPOSE OF ALL EXISTING SIGNAL WIRING NO
- REMOVE EXISTING SIGNAL EQUIPMENT NO LONGER IN USE AND RETURN TO THE CITY OF PITTSBURGH TRAFFIC CONTROL SHOP. COORDINATE DELIVERY OF EQUIPMENT WITH DELMAS MCELHANY, TRAFFIC CONTROL FOREMAN.

TS	-338
COUNTY: ALLEGHENY	
MUNICIPALITY: CITY OF PITTSBURGH	_
INTERSECTION: SIXTH AVENUE	_
AND FORBES AVENUE	
AND LIBERTY BRIDGE RAMPS	
APPROVED AND ACCEPTED:	
CITY TRAFFIC ENGINEER DATE	
APPROVED AND ACCEPTED:	
DISTRICT TRAFFIC ENGINEER DATE	
AUTHORITY OF ALLEGHENY COUNTY	,

AECOM

Gulf Tower 707 Grant Street 5th Floor Pittsburgh, PA 15219

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(NOT FOR CONSTRUCTION)

DESIGNED	DWP	
DRAWN	NED	
CHECKED	AJR	
IN CHARGE	<u>JKM</u>	
DATE	05/01/24	
SCALE		
	AS SHOWN	

PORT PITTSBURGH PENNSYLVANIA

BUS RAPID TRANSIT UPTOWN TO OAKLAND SIGNAL PLANS WIRING, MOVEMENT, PHASING & SEQUENCE DIAGRAMS

Port Authority

CONTRACT NO. BRT-001 DWG. NO. SG8 sнт. 1068

TRAFFIC SIGNAL TABULATION

SIXTH AVENUE AND FORBES AVENUE AND LIBERTY BRIDGE RAMPS

TRAFFIC SIGNAL SUPPORTS **

					z											ST A	RM								ESTA	
POLE	ITEM NUMBER	DESCRIPTION	αΤΥ.	ROUTE	STATION	SIDE	OFFSET	١	.,					ARM "A"							RM "("C" SH		SIG	۱AL	
NO.			ď		STA	S	l A	H	K	L		_								G	x	Z	Н	м	N	
^	UNIT			500050							М	N	0	Р	R	S	Ť	U	Y							
		TRAFFIC SIGNAL SUPPORT, 24' STRAIN POLE		FORBES AV E	120+23	R	31'	24'																		
<u> </u>		TRAFFIC SIGNAL SUPPORT, 16' STRAIN POLE		FORBES AVE	120+79	R	36 '	16'	10'																	
<u>3</u>		TRAFFIC SIGNAL SUPPORT, 16' STRAIN POLE		FORBES AVE	121+36	R	31'	16'	10'																	
1		TRAFFIC SIGNAL SUPPORT, 24' STRAIN POLE		FORBES AVE	121+35	L	29 ′	24 ′	10'																	
<u> </u>		TRAFFIC SIGNAL SUPPORT, 15' TYPE X		FORBES AVE	120+90	L	24'																	15'		10'
<u>6</u>		TRAFFIC SIGNAL SUPPORT, 24' STRAIN POLE		FORBES AV E	120+41	L	23'	24'																		
À		TRAFFIC SIGNAL SUPPORT, 24' STRAIN POLE		FORBES AV E				24 '	10'																	
8		TRAFFIC SIGNAL SUPPORT, 15' TYPE X WITH LUMINAIRE ARM		SIXTH AVE	632+38	L	32'																	15'		10'
<u></u>		TRAFFIC SIGNAL SUPPORT, 40' MAST ARM WITH LUMINAIRE ARM		SIXTH AVE	631+92	L	35 '	17 '	10'	40'	22'	14'			18'	12'			6′							
10		TRAFFIC SIGNAL SUPPORT, 32' MAST ARM WITH LUMINAIRE ARM		DIAMOND ST	42+96	L	18'	17 '	10'	32'	26′	17′			12'				2'							
\triangle		TRAFFIC SIGNAL SUPPORT, 40' MAST ARM		SIXTH AVE	632+37	R	40 ′	40 ′	10'	42'	37′	30′	21'		35′	27 '	23 '	13'	8 '			30 '	o°			
12		TRAFFIC SIGNAL SUPPORT, 30' STRAIN POLE WITH LUMINAIRE ARM		SIXTH AVE	632+66	R	42'	30 '	10'															1		
13		TRAFFIC SIGNAL SUPPORT, 20' STRAIN POLE		FORBES AV E	119+48	R	26 '	20 '	10'																	
<u>A</u>		TRAFFIC SIGNAL SUPPORT, 20' STRAIN POLE		FORBES AV E	119+80	R	44'	20 ′																		
<u> </u>		TRAFFIC SIGNAL SUPPORT, 16' STRAIN POLE		FORBES AVE	120+71	R	36 '	16'	10'																	
18		TRAFFIC SIGNAL SUPPORT, 15' TYPE X, PAINTED GRAY		SIXTH AVE	631+83	R	21'																	15'		10'

** REFER TO TRAFFIC STANDARDS TC-8800 SERIES FOR LETTER DESIGNATION

DETECTORS

ITEM				
NUMBER	DESCRIPTION	SEN. NO.	QTY.	LOCATION
	DIGITAL WAVE RADAR DETECTION	1 2	2	Á
	DIGITAL WAVE RADAR DETECTION	3	1	\triangle
	DIGITAL WAVE RADAR DETECTION	4	1	\triangle
	DIGITAL WAVE RADAR DETECTION	(5)	1	ß
	DIGITAL WAVE RADAR DETECTION	6 7	2	<u> </u>
	DIGITAL WAVE RADAR DETECTION	8	1	<u>/8</u>
	DIGITAL WAVE RADAR DETECTION	9	1	\triangle
02895. 001 EACH	DIGITAL WAVE RADAR DETECTION	1	1	10
02895. 001 EACH	DIGITAL WAVE RADAR DETECTION	1	1	Á

TS-338

Gulf Tower
707 Grant Street
5th Floor
Pittsburgh, PA 15219

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PORT AUTHORITY OF ALLEGHENY
COUNTY, PENNSYLVANIA.

(NOT FOR CONSTRUCTION)

					13	-
DESIGNED	<u>DWP</u>	PORT AUTHOR	ITY OF AL	LEGHENY COL	JNT	Y
DRAWN	NED	PITTSBURGH		PENN	SYLVANI	Α.
CHECKED	<u>AJR</u>	BUS RAPID TF	RANSIT UPT	OWN TO OAKL	AND	
IN CHARGE	<u>JKM</u>		SIGNAL PL	ANS		
DATE	05/01/24	TRAF	FIC SIGNAL T	ABULATIONS		
SCALE	AS SHOWN	Port Authority	CONTR	ACT NO. BRT-00	01	
	AUUITOWN	connecting people to life	DWG. NO.	SG9	SHT.	1069

<u>TRAFFIC</u>	SIGNAL	TABULAT	<u> 101</u>

SIXTH AVENUE AND FORBES AVENUE AND LIBERTY BRIDGE RAMPS

ITEM NUMBER	I	MISCE	LLANEOUS	
UNIT	DESCRIPTION	QTY.	LOCATION	REMARKS
01882. 002 EACH	TRAFFIC SIGNAL TIMING MODIFICATIONS	2	СС	
02894. 001 EACH	VEHICULAR SIGNAL HEAD, THREE 12" SECTIONS	1	13	BLACK TUNNEL VISORS BLACK ALUMINUM HOUSINGS BLACK METAL LOUVERED BACKPLATE SIGNAL LOUVERS
02894. 006 EACH	VEHICULAR SIGNAL HEAD, THREE 8" SECTIONS	2	19 20	BLACK TUNNEL VISORS BLACK ALUMINUM HOUSINGS
02894. 021 EACH	RESET VEHICULAR SIGNAL HEAD	3	0000	
02894. 031 EACH	REMOVE VEHICULAR SIGNAL HEAD	4	12/3/5/2	

TRENCH, CONDUIT, JUNCTION BOX, ELECTRICAL ITEMS

DESCRIPTION	SIGNAL CABLE, 14 AWG, 5 CONDUCTOR
ITEM NUMBER	02900
TTEM NOMBEN	002
UNIT	LF
LOCATION	
COMPLETE INTERSECTION	1140
TOTAL	1140

SIGNS


SYMBOL	SERIES	SIZE	AREA EACH (SQ FT)	DESCRIPTION	QUANTITY	O2891,003 MOUNTED SIGNS, TYPE F	O2891.007 OSTRUCTURE MOUNTED FLAT SHEET ALUMINUM SIGN WITH STIFFENERS	REMOVE STRUCTURE MOUNTED FLAT SHEET ALUMINUM SIGNS
₿	R6-1	36"×12"	3.0	ONE WAY (TWO SIDED, CITY STANDARD)	1	3.0		
H	SPECIAL	30"×30"	6.3	BUS LANE SIGNAL	1		6.3	
1	R3-2	30"x30"	6.3	NO LEFT TURN	4			4
0	R10-3E	9"×15"	0.9	EDUCATIONAL PUSH BUTTON FOR WALK SIGNAL WITH COUNTDOWN TIMER (MOD)	21	18.9		
\mathbb{K}	R14-1	30"x36"	7.5	TRUCK ROUTE +	1			1
				TOTAL		21.9	6.3	5

Gulf Tower
707 Grant Street
5th Floor
Pittsburgh, PA 15219

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(NOT FOR CONSTRUCTION)

					TS-	338
ESIGNED	<u>DWP</u>	PORT AUTHOR	ITY OF AL	LEGHENY COL	JNTY	
DRAWN	NED	PITTSBURGH		PENNS	SYLVANIA	
CHECKED	<u>AJR</u>	BUS RAPID TF	RANSIT UPT	OWN TO OAKLA	AND	
N CHARGE	<u>JKM</u>		SIGNAL PL			
ATE	05/01/24	TRAF	FIC SIGNAL T	ABULATIONS		
CALE	AS SHOWN	Port Authority	CONTR	ACT NO. BRT-00)1	
,	40 OHOWN	connecting people to life	DWG. NO.	SG10	sнт. 1	070

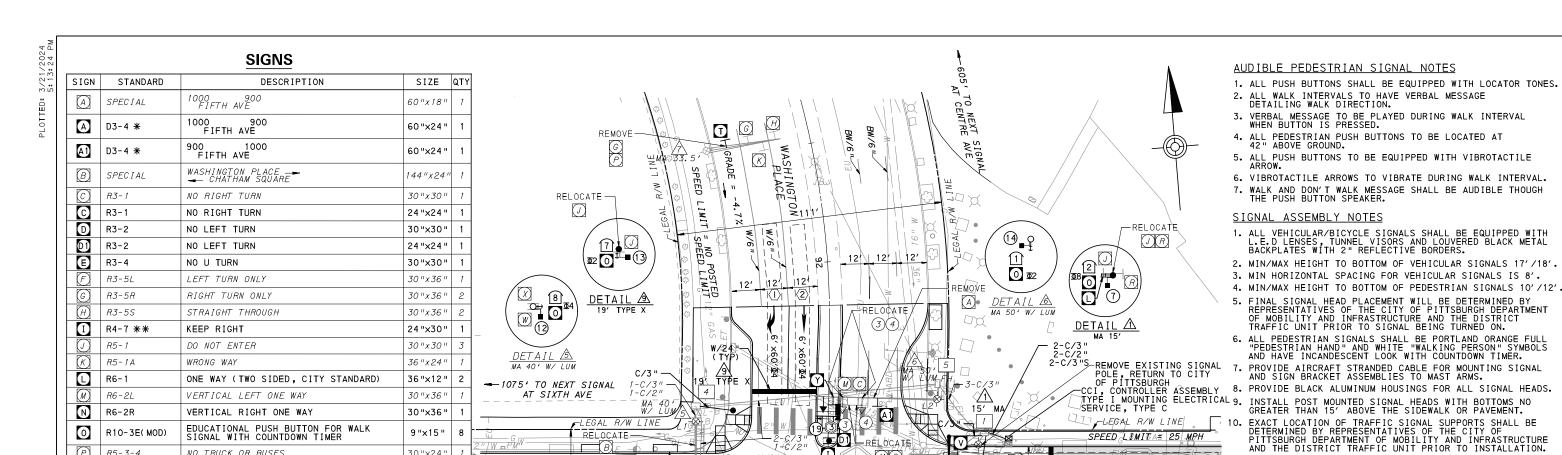

R10-6AL STOP HERE ON RED (LEFT) 24"x30" R10-6-1 LEFT LANE PLAQUE 24"×18" * WHITE REFLECTORIZED LEGEND AND BORDER ON BLUE REFLECTORIZED BACKGROUND.UTILIZE 4" CLEARVIEW 3W FOR BLOCK/NEIGHBORHOOD AND 8" CLEARVIEW 3W FOR STREET NAME.ACTUALWIDTH DETERMINED BY LETTER SPACING.COORDINATE BLOCKNUMBERS AND STREETNAME DETAILS WITH CITY OF PITTSBURGH DEPARTMENT OF MOBILITY AND INFRASTRUCTURE.

TURNING TRAFFIC MUST YIELD TO BIKES AND PEDESTRIANS

HORIZONTAL LEFT ONE-WAY

HORIZONTAL RIGHT ONE-WAY

LEFT TURN YIELD ON FLASHING

NO TRUCK OR BUSES

NO TURN ON RED


TRUCK ROUTE

HAZARD MARKER

PARKING LANE

BUS LANE SIGNAL

**POST MOUNTED SIGNS TABULATED IN SIGNING AND PAVEMENT MARKING PLANS.

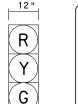

0

P

Q

V

(x)

R10-3E(MOD

R5-3-4

R10-11

R14-1

OM1-3 **

R10-15AL(MOD)


SPECIAL

SPECIAL


R6-11

R6-1R

R10-12A

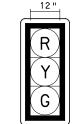


SINGLE UNIT HAND/MAN OVERLAY,

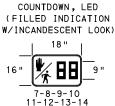



SIGNAL HEADS

15-16-17-20

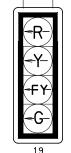

NO. DATE

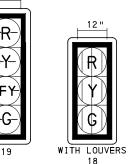

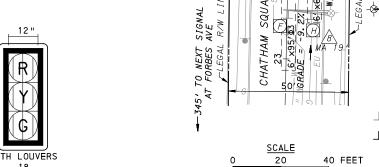

2 PROPOSED VEHICULAR/ BICYCLE SIGNAL HEAD EXISTING PEDESTAL ⊥, ■ A EXISTING SIGN ⊥, ▲ PROPOSED SIGN **ॼ**2 □] ②

DY/4" PROPOSED STOP BAR VIDEO \longrightarrow 2 EXISTING AUDIBLE PEDESTRIAN G/24" SOLID GREEN LINE/WIDTH PUSH BUTTON/SIGN

> RAWN NED CHECKED AJR N CHARGE JKM DATE 05/01/24 SCALE

APPROVED AND ACCEPTED: CITY TRAFFIC ENGINEER DATE APPROVED AND ACCEPTED: DISTRICT TRAFFIC ENGINEER DATE

INTERSECTION: FIFTH AVENUE

MUNICIPALITY<mark>: CITY OF PITTSB</mark>URGH

AND WASHINGTON PLACE

AND CHATHAM SQUARE

707 Grant Street 5th Floor Pittsburgh, PA 15219

PORT AUTHORITY OF ALLEGHENY COUNTY **PITTSBURGH** PENNSYLVANIA

BUS RAPID TRANSIT UPTOWN TO OAKLAND SIGNAL PLANS

FIFTH AVENUE & WASHINGTON PLACE

CONTRACT NO. BRT-001 SG11 sнт. 1071 DWG NO

EXISTING MAST ARM WITH LUMINATRE ARM **2**

C/3"-

EXISTING PEDESTRIAN SIGNAL HEAD PROPOSED PEDESTRIAN SIGNAL HEAD EXISTING VEHICULAR/ BICYCLE SIGNAL HEAD → 2

_____ PROPOSED AUDIBLE PEDESTRIAN
PUSH BUTTON∕SIGN EXISTING CONTROLLER ASSEMBLY ☐ 2 EXISTING JUNCTION BOX

PROPOSED STOP BAR VIDEO DETECTOR **▶** ②

C/2" CONDUIT/SIZE CL/2" LIGHTING CONDUIT/SIZE

C/2 "P POWER CONDUIT/SIZE

W/6" SOLID WHITE LINE/WIDTH

BW/6" BROKEN WHITE LINE/WIDTH DOUBLE SOLID YELLOW LINE/WIDTH

<u>PAVEMENT MARKING NOTES</u>

1. ALL STOP BARS ARE W/24".

CROSSWALKS ARE 10'X 24" KEYS WITH 3' TO 5' SPACING.

CROSSWALKS ACROSS BICYCLE LANES ARE 6'X 12" KEYS WITH 1' SPACING.

COUNTY: ALLEGHENY

Port Authority

9"x15"

30"x24"

30"x36"

30"x36"

18"×18"

30"x30"

30"x30"

30"x30"

36 "x12"

36 "x 12"

30"x36"

FIFTH AVE

REMOVE EXISTING-

POLE, TO CITY

SIGNAL POLE, RETURN TO CIT OF PITTSBURGH

439

DESCRIPTION

REVISIONS

THE PREPARATION OF THIS DOCUMENT HAS BEEN FINANCED IN PART THROUGH A GRANT FROM THE FEDERAL TRANSIT ADMINISTRATION J.S. DEPARTMENT OF FRANSPORTATION, UNDER THE URBAN MASS TRANSPORTATION ACT

OF 1964 AS AMENDED FOR THE COUNTY, PENNSYLVANIA.

DESIGNED (NOT FOR

CONSTRUCTION

O **Φ**4

RELOCATE-

_BW/6'

_B₩/6'

RELOCATE

2-C/3" 1-C/2"

©2 0

† 10

MA 40'

DETAIL 🕸

DETAIL A

RELOCATE

19'

(SFF

(5)|

REMOVE

∠C/3 "

EXISTING SIGNAL POLE, RETURN TO CITY OF PITTSBURGH

CONSTRUCTION

SPEED LEMITAS 25 MPH

--- FIFTH AVE

ONE WAY

GRADE # _-3.3%

755 TO NEXT SIGNAL

AT MAGEE ST

442

6' ×115' 1

VAUL7

6' x60' **4**2

DETAIL &

LEGEND

⟨4⟩ • W/8 " - /

- RELOCATE

(9)**•**

0

3 0 2

DETAIL

EXISTING MAST ARM

₩/6"-

DWF

AS SHOWN

TS-300

MOVEMENT, PHASING AND SEQUENCE CHART

		PH.	ASE	1			PH	ASE	2			PHA	SE	4+8			PHA	SE	3+8			
	вік	 - E⊢	L TT	F	BUS BIKE	BIKE BIKE					вік	 - 		li⊨	BUS BIKE	B I K I	- - E⊢	П	li⊨	BUS EMERE CONTROL CONTROL		
		INT	ERV	ALS			INT	ERVA	LS			INT	ERV	ALS			INT	ERV	ALS		Ÿ	
SIGNAL	1	2	3	-	-	1	2	3	4	5	1	2	3	4	5	1	2	3	4	-		
1-2	R	R	R			R	G	G	Y	R	R	R	R	R	R	R	R	R	R		R	
3-4	R	R	R			R	R	R	R	R	R	G	G	Υ ^Œ	R^{0}	G	G	Υ	R		R	
5-6	R	R	R			R	R	R	R	R	R	G	G	Y	R	R	R	R	R		R	
15-16-17-20	-17-20 R R R					R	G	Υ	R	R	R	R	R	R	R	R	R	R	R		R	
18	G	Υ	R			R	R	R	R	R	R	R	R	R	R	R	R	R	R		R	
19	-R -	- R−	- R-			- R−	- R−	 R	-R -	- R−	- R−	- F Y-				- G-	- G−	- Y-	- R-		- R−	
7-8	DW	DW	DW			DW	DW	DW	DW	DW	W	W	FD®				FD	DW	DW		0FF	
9-10	DW	DW	DW			W	W	FD	DW	DW	DW	DW	DW	DW	DW	DW	DW	DW	DW		0FF	
11-12	DW	DW	DW			DW	DW	DW	DW	DW	W	W	FD	DW	DW	DW	DW	DW	DW		0FF	
13-14	DW	DW	DW			W	W	FD	DW	DW	DW	DW	DW	DW	DW	DW	DW	DW	DW		0FF	
FIXED		3	2				L		4	3				4 5	3.5			4 5	3 . 5			
MINIMUM	8	۳						<u> </u>	-	٦		1	$\overline{\circ}$	7. 3	3. 3			7. 3	3.3			
PASSAGE	3							<u> </u>					3				3					
FREE (MAX)	8						_	0				_	0									
TILL (MAX)								Ĭ					Ĭ				, 					
PEDESTRIAN						3	7	19			3	7	14									
MEMORY		NON	LOC	(ING			PED	REC	ALL			PED	REC	CALL			NON	LOC	KING	;		

5C/14 5C/1 5C/14 5C/14号 (18) 7C/14吨 19 6 5 1 3C/14 3 5 1 SERVICE DL CO MH#6001 POWER DISCONNECT AT STATION 440+51 OFFSET 16' L FIFTH AVE 1C/8 5 5 4 -(L2)-

G IF FOLLOWED BY 3+8 W IF FOLLOWED BY 3+8

AECOM

707 Grant Street

5th Floor

Pittsburgh, PA 15219

WIRING DIAGRAM

5C/14 - CABLE (NO. OF CONDUCTORS/SIZE AWG.) EXISTING SIGNAL HEAD

PROPOSED SIGNAL HEAD

EXISTING AUDIBLE PEDESTRIAN INDICATOR

PROPOSED AUDIBLE PEDESTRIAN INDICATOR

 \triangle EXISTING SIGNAL SUPPORT 1 EXISTING JUNCTION BOX

PROPOSED SIGNAL SUPPORT 1 PROPOSED JUNCTION BOX

EXISTING LUMINAIRE

PROPOSED LUMINAIRE PROPOSED DETECTOR

3C/14 INCIDENTAL TO ITEM 02895.002

INCIDENTAL TO ITEM 02895.001 AS PER MANUFACTURERS SPECIFICATIONS

TRANSIT PRIORITY PRE-EMPTION NOTES (TO BE INSTALLED BY OTHERS)

- COORDINATE TRAFFIC CONTROLLER PROGRAMMING MODIFICATION WITH REPRESENTATIVES OF THE CITY OF PITTSBURGH AND DISTRICT TRAFFIC UNIT.
- 2. INCLUDE A TRANSIT PRIORITY PHASE THAT WILL EXTEND THE INDICATED PHASE A MAXIMUM OF 10 SECONDS WHEN ACTIVATED BY A PORT AUTHORITY VEHICLE. DO NOT VIOLATE SIDE STREET PEDESTRIAN MINIMUM TIMINGS.
- 3. MAINTAIN ALL YELLOW CLEARANCES AT ALL TIMES.
- 4. PROCEED TO THE SUBSEQUENT INTERVAL AS DEFINED IN THE MOVEMENT, SEQUENCE AND TIMING DIAGRAM UPON COMPLETING THE GREEN EXTENSION INTERVAL.
- 5. ONCE A TRANSIT CALL IS PLACED AND SATISFIED, THE CONTROLLER WILL NOT SATISFY ANOTHER CALL FOR
- 6. LOCATION OF BUS DETECTORS ARE TO BE FIELD ADJUSTED TO ACHIEVE MAXIMUM OPERATION.

DETECTOR ZONE INFORMATION

DETECTOR	DETECTION ZONE(S)	MODE	TYPE	ROUTE	PHASE	LOCATION MAST ARM
①	(1)(2) (6'x60')	PRESENCE	VIDEO (STOP BAR)	WASHINGTON PLACE	4	4
2	(3×4) (6'x60')	PRESENCE	VIDEO (STOP BAR)	FIFTH AVE	2	<u>\$</u>
	⟨₹\) (6'×115')	PRESENCE	VIDEO (STOP BAR)	FIFTH AVE	1	737
	⟨5⟩ (6′×60′)	PRESENCE	VIDEO (STOP BAR)	CHATHAM SQ	8	A
3	⟨6⟩ (6′×95′)	PRESENCE	VIDEO (STOP BAR)	CHATHAM SQ	3	6

GENERAL NOTES

THE CITY OF PITTSBURGH SHALL INSPECT THE NEW SIGNAL EQUIPMENT PRIOR TO ACTIVATION.

ALL TRAFFIC SIGNAL MAINTENANCE AND OPERATION RESPONSIBILITIES SHALL BE TURNED OVER TO THE CITY OF PITTSBURGH AFTER THE FOLLOWING CONDITIONS ARE IMPLEMENTED TO THE CITY'S SATISFACTION:

- PERMIT "AS-BUILT" TRAFFIC SIGNAL DRAWINGS ARE SUBMITTED AND APPROVED.
- 2. ALL PUNCH LIST ITEMS ARE COMPLETED BY THE CONTRACTOR.
- 3. AFTER THE 30-DAY CONTINUOUS UNINTERRUPTED SIGNAL OPERATION WITHOUT MALFUNCTIONS.

CONSTRUCTION NOTES

- 1. ALL JUNCTION BOXES IN WALK AREAS TO BE CITY OF PITTSBURGH STANDARD CONCRETE JUNCTION BOX, TYPE 1.
- 2. ALL JUNCTION BOXES IN NON-WALK AREAS TO BE CITY STANDARD JB-2 WITH BOTTOM.
- 3. THERE SHALL BE NO SIGNAL WIRE OR FIBER CABLE SPLICING.
- 4. SERVICE WIRE FROM THE POWER SOURCE TO THE CONTROLLER CABINET SHALL BE PLACED IN SECONDARY SEPARATE CONDUIT.
- 5. STREET LIGHT CABLE IS NOT PERMITTED TO RUN THROUGH THE CONTROLLER CABINET AND SHALL BE PLACED IN THE CONTROLLER CAB: SEPARATE CONDUIT.
- 6. TRAFFIC SIGNAL CABLE SHALL BE PLACED IN DEDICATED
- 7. MOUNT DISCONNECT ON POLE NEAREST TO THE CONTROLLER CABINET EXCLUDING TYPE X POLES.
- 8. REMOVE AND DISPOSE OF ALL EXISTING SIGNAL WIRING NO
- 9. REMOVE EXISTING SIGNAL EQUIPMENT NO LONGER IN USE AND RETURN TO THE CITY OF PITTSBURGH TRAFFIC CONTROL SHOP. COORDINATE DELIVERY OF EQUIPMENT WITH DELMAS MCELHANY, TRAFFIC CONTROL FOREMAN.
- 10. SEE 01720 UTILITY COORDINATION FOR INFORMATION ON RELOCATION OF EXISTING SECURITY CAMERAS AND SHOT

COUNTY: ALLEGHENY MUNICIPALITY: CITY OF PITTSBURGH INTERSECTION: FIFTH AVENUE AND WASHINGTON PLACE AND CHATHAM SQUARE APPROVED AND ACCEPTED:

CITY TRAFFIC ENGINEER

APPROVED AND ACCEPTED:

DATE

DATE

TS-300

DISTRICT TRAFFIC ENGINEER PORT AUTHORITY OF ALLEGHENY COUNTY PITTSBURGH

PENNSYLVANIA BUS RAPID TRANSIT UPTOWN TO OAKLAND SIGNAL PLANS

Port Authority

WIRING, MOVEMENT, PHASING & SEQUENCE DIAGRAMS CONTRACT NO. BRT-001 SG12 sнт. 1072 DWG NO

THE PREPARATION OF THIS DESCRIPTION

(NOT FOR

DOCUMENT HAS BEEN FINANCED IN PART THROUGH A GRANT FROM THE FEDERAL TRANSIT ADMINISTRATION U.S. DEPARTMENT OF TRANSPORTATION, UNDER THE URBAN MASS TRANSPORTATION ACT OF 1964 AS AMENDED FOR THE COUNTY, PENNSYLVANIA.

CONSTRUCTION

NO. DATE

REVISIONS

N CHARGE JKM DATE 05/01/24 SCALE AS SHOWN

DESIGNED

CHECKED

DRAWN

DWF

NED

AJR

AECOM
Gulf Tower 707 Grant Street 5th Floor Pittsburgh, PA 15219

ITEM NUMBER	MISC	ELLAN	IEOUS	
UNIT	DESCRIPTION	QTY.	LOCATION	REMARKS
01882. 002 EACH	TRAFFIC SIGNAL TIMING MODIFICATIONS	2	СС	
01883. 002 EACH	TRAFFIC SIGNAL TIMING MODIFICATIONS	1	СС	
02212. 009 LF	POLE FOUNDATION DRILLING, LESS THAN 30" DIAMETER	15	<u> </u>	
02212. 010 LF	POLE FOUNDATION DRILLING, GREATER THAN 30" DIAMETER	23	<u> </u>	
02889. 001 EACH	LED LUMINAIRE CITY STANDARD, GRAY	1	-)3	<u> </u>
02890. 001 EACH	TRAFFIC SIGNAL CONTROLLER ASSEMBLY, TYPE 2070 LC, WITH TYPE 332 BASE MOUNTED CABINET(MOD)	1	СС	332 CONTROLLER CABINET 8" RISER RE-ESTABLISH INTERCONNECT
02890. 003 EACH	ETHERNET SWITCH	1	CC	
02894. 001 EACH	VEHICULAR SIGNAL HEAD, THREE 12" SECTIONS	2	56	BLACK TUNNEL VISORS BLACK ALUMINUM HOUSINGS BLACK METAL LOUVERED BACKPLATE
02894.	VEHICULAR SIGNAL HEAD, THREE 12" SECTIONS	1	18	BLACK TUNNEL VISORS BLACK ALUMINUM HOUSINGS BLACK METAL LOUVERED BACKPLATE SIGNAL LOUVERS
02894. 002 EACH	VEHICULAR SIGNAL HEAD, FOUR 12" SECTIONS	1	19	BLACK TUNNEL VISORS BLACK ALUMINUM HOUSINGS BLACK METAL LOUVERED BACKPLATE
02894. 005 EACH	LED COUNTDOWN PEDESTRIAN SIGNAL HEAD, TYPE A	8	7890 000	BLACK TUNNEL VISORS BLACK ALUMINUM HOUSINGS

TRAFFIC SIGNAL TABULATION

FIFTH AVENUE AND WASHINGTON PLACE AND CHATHAM SQUARE

MISCELLANEOUS (CONT.) DESCRIPTION GTY. LOCATION REMARKS											
DESCRIPTION	QTY.	LOCATION	REMARKS								
VEHICULAR SIGNAL HEAD,	4	(3(3(1))	BLACK TUNNEL VISORS BLACK ALUMINUM HOUSINGS								
THIREE 0 SECTIONS			BLACK METAL LOUVERED BACKPLATE								
RESET VEHICULAR SIGNAL HEAD	3	234									
ACCESSIBLE PEDESTRIAN SIGNALS	8	11234									
		[2] [6] [1] [8]									
CONNECT TO EXISTING JUNCTION BOX	4	1234									
	DESCRIPTION VEHICULAR SIGNAL HEAD, THREE 8" SECTIONS RESET VEHICULAR SIGNAL HEAD ACCESSIBLE PEDESTRIAN SIGNALS	DESCRIPTION QTY. VEHICULAR SIGNAL HEAD, THREE 8" SECTIONS 4 RESET VEHICULAR SIGNAL HEAD 3 ACCESSIBLE PEDESTRIAN SIGNALS 8	DESCRIPTION QTY. LOCATION VEHICULAR SIGNAL HEAD, THREE 8" SECTIONS 4 19600 RESET VEHICULAR SIGNAL HEAD ACCESSIBLE PEDESTRIAN SIGNALS 8 11234								

DETECTORS

I TEM NUMBER	DESCRIPTION	SEN. NO.	QTY.	LOCATION
02895 . 001	VIDEO DETECTION	Ô	1	4
EACH		~		
02895. 001	VIDEO DETECTION	②	1	<u>/</u> 5\
EACH		~		
02895 . 001	VIDEO DETECTION	(3)	1	<u>/</u> 6\
EACH		~		

TRAFFIC SIGNAL SUPPORTS **

	ΣШ &				Z									M	IAST	ARM								PEC	DESTA	L				
POLE NO.	I TEM NUMBER	DESCRIPTION	αΤΥ.	ROUTE	ATIC	ATIC	ATIC		FS.							ARI	M "A"					ARM "C"		С"	SHAFT	SIG	NAL			
					ST	,	9 P	Н	н к	K	К	K	к	к	SIG	NAL	LOCAT	NOI	S	IGN	LOCA	OITA	N	w	G	x	z	Н	м	N
	UNIT									_	М	N	0	Р	R	S	T	U	Y	<u>l "</u>	السا		_		L	.,				
\triangle	02892. 101 EACH	TRAFFIC SIGNAL SUPPORT, 15' MAST ARM, PAINTED GRAY	1	FIFTH AVE	440+92	٦	27′	17′	10′	15′	10′				7′															
2	02892. 002 EACH	TRAFFIC SIGNAL SUPPORT, 19' TYPE X, PAINTED GRAY	1	FIFTH AVE	440+69	R	24′																	19′		10′				
3		TRAFFIC SIGNAL SUPPORT, 15' TYPE X		CHATHAM SQUARE	23+85	L	24′																	15′		10'				
4	02892. 100 EACH	TRAFFIC SIGNAL SUPPORT, 40' MAST ARM WITH LUMINAIRE (30' MOUNTING HEIGHT), PAINTED GRAY	1	FIFTH AVE	439+89	R	28′	17′	10′	40′	39′	27′			36′	30′	23′	18′	4'	270°		30′	0°	I						
<u>\$</u>		TRAFFIC SIGNAL SUPPORT, 40' MAST ARM WITH LUMINAIRE ARM		FIFTH AVE	439+85	L	23'	17 '	10'	40′	35 <i>†</i>	27 ′	17′		32′	23′			6′	0°		30 ′	o°							
<u> </u>		TRAFFIC SIGNAL SUPPORT, 50' MAST ARM WITH LUMINAIRE ARM		FIFTH AVE	440+86	L	43'	17 '	10'	50′	47′	38 ′	30 ′		43′	<i>37 </i>	32'		24′	269°		30′	o°	1						
À		TRAFFIC SIGNAL SUPPORT, 33.5' MAST ARM		WASHINGTON PLACE	26+57	L	43'	17 '	10'	33 . 5 ′					28 '	22'	16′	7′		357°										
8		TRAFFIC SIGNAL SUPPORT, 19' MAST ARM		CHATHAM SQUARE	23+19	R	18'	17 '	10'	19'					16'	7 ′				357°										
<u>\$</u>	02892. 002 EACH	TRAFFIC SIGNAL SUPPORT, 19' TYPE X, PAINTED GRAY	1	FIFTH AVE	440+01	L	38′																	19′		10′				

** REFER TO TRAFFIC STANDARDS TC-8800 SERIES FOR LETTER DESIGNATION

REVISIONS

(NOT FOR CONSTRUCTION)

DESIGNED	<u>DWP</u>	
DRAWN	<u>NED</u>	
CHECKED	<u>AJR</u>	
IN CHARGE	<u>JKM</u>	
DATE	05/01/24	
SCALE		
	AS SHOWN	

TS-300 PORT AUTHORITY OF ALLEGHENY COUNTY

BUS RAPID TRANSIT UPTOWN TO OAKLAND SIGNAL PLANS TRAFFIC SIGNAL TABULATIONS

Port Authority connecting people to life

CONTRACT NO. BRT-001 DWG. NO. SG13 sнт. 1073

THE PREPARATION OF THIS

DOCUMENT HAS BEEN FINANCED IN
PART THROUGH A GRANT FROM THE
FEDERAL TRANSIT ADMINISTRATION,
U.S. DEPARTMENT OF
TRANSPORTATION, UNDER THE
URBAN MASS TRANSPORTATION ACT
OF 1964, AS AMENDED, FOR THE
PORT AUTHORITY OF ALLEGHENY
COUNTY, PENNSYLVANIA. NO. DATE DESCRIPTION

		(
		~

SYMBOL	SERIES	SIZE	AREA EACH (SQ FT)	DESCRIPTION		02891,001 POST MOUNTED SIGNS, TYPE B	02891,003 POST MOUNTED SIGNS, TYPE F	02891.007 STRUCTURE MOUNTED FLAT SHEET ALUMINUM SIGN WITH STIFFENERS	02891.011 RESET POST MOUNTED SIGNS, TYPE B	02891.013 RESET POST MOUNTED SIGNS, TYPE F	RESET STRUCTURE MOUNTED FLAT SHEET ALUMINUM SIGN WITH STIFFENERS	02891.033 REMOVE STRUCTURE MOUNTED FLAT SHEET
(A)	SPECIAL	60"x18"	7.5	1000 900 Fifth Ave	1	SF	SF	SF	SF	SF	EACH	EACH 1
				1000 900								
A	D3-4 *	60 "X24 "	10.0	Fifth Ave	1			10.0				
A1	D3-4 *	60 "X24 "	10.0	900 1000 Fifth Ave	1			10.0				
B	SPECIAL	144"x24"	24.0	Washington Place → ← Chatham Square	1						1	
\bigcirc	R3-1	30"X30"	6.3	NO RIGHT TURN	1						1	
0	R3-1	24"X24"	4.0	NO RIGHT TURN	1	4.0						
0	R3-2	30"X30"	6.3	NO LEFT TURN	1			6.3				
0)	R3-2	24"X24"	4.0	NO LEFT TURN	1		4.0					
▣	R3-4	30 "X30 "	6.3	NO U TURN	1			6.3				
<u> </u>	R3-5R	30 "X36 "	7.5	RIGHT TURN ONLY	1							1
H	R3-5S	30 "X36 "	7.5	STRAIGHT THROUGH	1							1
[]	R5-1	30 "X30 "	6.3	DO NOT ENTER	3				1	2		
0	R6-1	36 "X12 "	3.0	ONE WAY (TWO SIDED, CITY STANDARD)	2		6.0					
M	R6-2L	30 "X36 "	7.5	VERTICAL LEFT ONE WAY	1						1	
N	R6-2R	30 "X36 "	7.5	VERTICAL RIGHT ONE WAY	1			7.5				
0	R10-3E(MOD)	9 "X15 "	0.9	EDUCATIONAL PUSH BUTTON FOR WALK SIGNAL WITH COUNTDOWN TIMER (MOD)	8		A					
P	R5-3-4	30 "X24"	5.0	NO TRUCKS OR BUSES	1							1
Q	R10-11	30 "X36 "	7.5	NO TURN ON RED	2			15.0				
R	R14-1	30 "X36 "	7.5	TRUCK ROUTE	1						1	
T	SPECIAL	30"X30"	6.3	PARKING LANE	1			6.3				
0	R10-15AL(MOD)	30 "X30 "	6.3	TURNING TRAFFIC MUST YIELD TO BIKES AND PEDESTRIANS	2		6.3	6.3				
V	SPECIAL	30"X30"	6.3	BUS LANE SIGNAL	1			6.3				
Y	R10-12A	30 "X36 "	7.5	LEFT TURN YIELD TO FLASHING YELLOW ARROW	1			7.5				
2	R10-6AL	24 "X30 "	5.0	STOP HERE ON RED (LEFT)	1	5.0						
AA	R10-6-1	24 "X18 "	3.0	LEFT LANE PLAQUE	1		3.0					
		1	1	TOTAL		9.0	19.3	81.5	1	2	4	4

▲ - INCIDENTAL TO ITEM 02895.002

PORT AUTHORITY OF ALLEGHENY COUNTY

DESIGNED DWP DRAWN NED CHECKED AJR IN CHARGE JKM DATE 05/01/24 SCALE

AS SHOWN

BUS RAPID TRANSIT UPTOWN TO OAKLAND SIGNAL PLANS TRAFFIC SIGNAL TABULATIONS

CONTRACT NO. BRT-001

Port	Authority	С
. 01	connecting people to life	DV

707 Grant Street 5th Floor

		THE DEEDADATION OF THE
		THE PREPARATION OF THIS DOCUMENT HAS BEEN FINANCED IN
		PART THROUGH A GRANT FROM TH
		FEDERAL TRANSIT ADMINISTRATION U.S. DEPARTMENT OF
		TRANSPORTATION, UNDER THE
		URBAN MASS TRANSPORTATION AC OF 1964, AS AMENDED, FOR THE
DATE	DESCRIPTION	PORT AUTHORITY OF ALLEGHENY COUNTY, PENNSYLVANIA.
	REVISIONS	COUNTY, FERNISTEVANIA.

(NOT FOR CONSTRUCTION)

AECOM Pittsburgh, PA 15219

1110 | 1200

1110 1200

4

SIGNAL CABLE, 7 CONDUCTOR

003

LF

SIGNAL CABLE, 5 CONDUCTOR

002

LF

02896 | 02898 | 02898 | 02899 | 02899 | 02900 | 02900 | 02900

003

LF

32

13

14

46 10

86

205

560

560

001

LF

002

LF

16

TRENCH, CONDUIT, JUNCTION BOX, ELECTRICAL ITEMS

ELECTRICAL SERV TYPE C (NEW)

004

EACH

002

LF

8

13

4

14

46

5

9

99

34

34

21

005

DESCRIPTION

ITEM NUMBER

UNIT

LOCATION CC TO [

1 TO 2 2 TO 🛕

1 TO 5 5 TO 🙆 5 TO 4 4 TO \$\sqrt{5}\$ 4 T0

4 TO 3 3 TO <u>∕</u>3

3 TO 4

1 TO S1

S1 - TABULATED ON THE SYSTEMS PLAN.


COMPLETE INTERSECTION

wg. no. SG14 sнт. 1074

TS-300

^{*} WHITE REFLECTORIZED LEGEND AND BORDER ON BLUE REFLECTORIZED BACKGROUND.
UTILIZE 4" CLEARVIEW 3W FOR BLOCK/NEIGHBORHOOD AND 8" CLEARVIEW 3W FOR
STREET NAME. ACTUAL WIDTH DETERMINED BY LETTER SPACING. COORDINATE BLOCK
NUMBERS AND STREET NAME DETAILS WITH CITY OF PITTSBURGH DEPARTMENT OF
MOBILITY AND INFRASTRUCTURE.



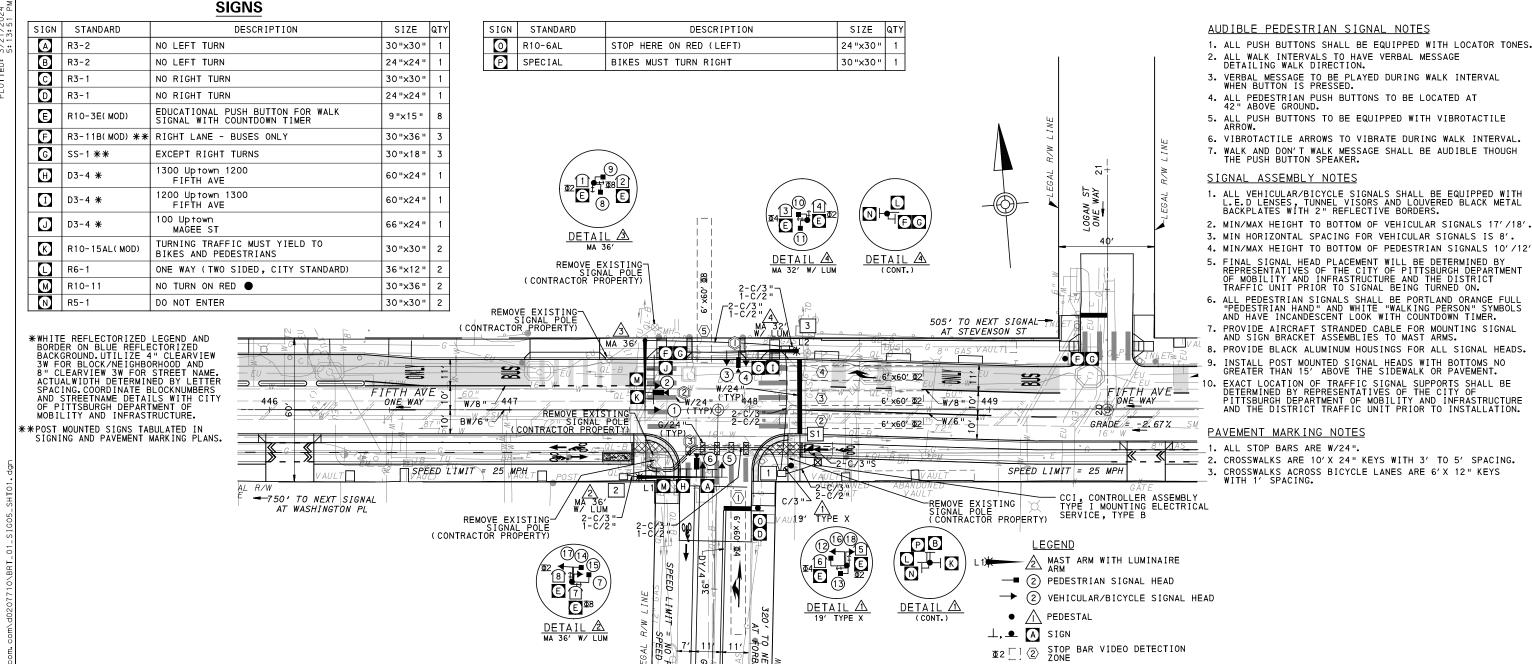

SIGN


20

40 FEET


70%

S

SIGNAL HEADS

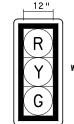

SINGLE UNIT HAND/MAN OVERLAY. COUNTDOWN. LED FILLED INDICATION W/INCANDESCENT LOOK)

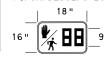

15-16 17-18

DOCUMENT HAS BEEN FINANCED IN PART THROUGH A GRANT FROM THE FEDERAL TRANSIT ADMINISTRATION J.S. DEPARTMENT OF FRANSPORTATION, UNDER THE URBAN MASS TRANSPORTATION ACT OF 1964 AS AMENDED FOR THE DESCRIPTION COUNTY, PENNSYLVANIA. REVISIONS

(NOT FOR CONSTRUCTION

DESIGNED DWF DRAWN NED CHECKED AJR N CHARGE JKM DATE 05/01/24 SCALE AS SHOWN

→ ② AUDIBLE PEDESTRIAN PUSH BUTTON/SIGN

☐ 2 JUNCTION BOX

C/2" CONDUIT/SIZE

CONTROLLER ASSEMBLY

STOP BAR VIDEO DETECTOR

CL/2" LIGHTING CONDUIT/SIZE

W/6" SOLID WHITE LINE/WIDTH

BW/6" BROKEN WHITE LINE/WIDTH

G/24" SOLID GREEN LINE/WIDTH

C/2"P POWER CONDUIT/SIZE

DY/4" DOUBLE SOLID YELLOW LINE/WIDTH

2. ALL WALK INTERVALS TO HAVE VERBAL MESSAGE

3. VERBAL MESSAGE TO BE PLAYED DURING WALK INTERVAL

4. ALL PEDESTRIAN PUSH BUTTONS TO BE LOCATED AT

5. ALL PUSH BUTTONS TO BE EQUIPPED WITH VIBROTACTILE ARROW.

6. VIBROTACTILE ARROWS TO VIBRATE DURING WALK INTERVAL.

1. ALL VEHICULAR/BICYCLE SIGNALS SHALL BE EQUIPPED WITH L.E.D LENSES, TUNNEL VISORS AND LOUVERED BLACK METAL BACKPLATES WITH 2" REFLECTIVE BORDERS.

- 2. MIN/MAX HEIGHT TO BOTTOM OF VEHICULAR SIGNALS 17'/18'
- 3. MIN HORIZONTAL SPACING FOR VEHICULAR SIGNALS IS 8'.
- 4. MIN/MAX HEIGHT TO BOTTOM OF PEDESTRIAN SIGNALS 10'/12'.
- 5. FINAL SIGNAL HEAD PLACEMENT WILL BE DETERMINED BY REPRESENTATIVES OF THE CITY OF PITTSBURGH DEPARTMENT OF MOBILITY AND INFRASTRUCTURE AND THE DISTRICT TRAFFIC UNIT PRIOR TO SIGNAL BEING TURNED ON.
- 6. ALL PEDESTRIAN SIGNALS SHALL BE PORTLAND ORANGE FULL "PEDESTRIAN HAND" AND WHITE "WALKING PERSON" SYMBOLS AND HAVE INCANDESCENT LOOK WITH COUNTDOWN TIMER.
- 7. PROVIDE AIRCRAFT STRANDED CABLE FOR MOUNTING SIGNAL AND SIGN BRACKET ASSEMBLIES TO MAST ARMS.
- 8. PROVIDE BLACK ALUMINUM HOUSINGS FOR ALL SIGNAL HEADS.
- INSTALL POST MOUNTED SIGNAL HEADS WITH BOTTOMS NO GREATER THAN 15' ABOVE THE SIDEWALK OR PAVEMENT.
- 10. EXACT LOCATION OF TRAFFIC SIGNAL SUPPORTS SHALL BE DETERMINED BY REPRESENTATIVES OF THE CITY OF PITTSBURGH DEPARTMENT OF MOBILITY AND INFRASTRUCTURE AND THE DISTRICT TRAFFIC UNIT PRIOR TO INSTALLATION.
- 2. CROSSWALKS ARE 10'X 24" KEYS WITH 3' TO 5' SPACING.
- 3. CROSSWALKS ACROSS BICYCLE LANES ARE 6'X 12" KEYS

TS-303

COUNTY: ALLEGHENY MUNICIPALITY: CITY OF PITTSBURGH INTERSECTION: FIFTH AVENUE AND MAGEE STREET APPROVED AND ACCEPTED: CITY TRAFFIC ENGINEER DATE APPROVED AND ACCEPTED: DISTRICT TRAFFIC ENGINEER DATE

PORT AUTHORITY OF ALLEGHENY COUNTY PITTSBURGH PENNSYLVANIA

BUS RAPID TRANSIT UPTOWN TO OAKLAND SIGNAL PLANS

FIFTH AVENUE & MAGEE STREET

Port Authority

CONTRACT NO. BRT-001 SG15 DWG NO sнт. 1075

707 Grant Street 5th Floor Pittsburgh, PA 15219


THE PREPARATION OF THIS NO. DATE

MOVEMENT, PHASING AND SEQUENCE CHART

		PH	IASE	2			PHA	SE ·	4+8		
	BIK	 = _ = _	- <u>-</u> -		⊔S IKE	вік	BUS IKE	HLANHIZG HLANHIZG			
		INT	ERV	٩LS			INT	ERV	ALS		Ÿ
SIGNAL	1	2	3	4	-	1	2	3	4	5	
1-2	G	G	Υ	R		R	R	R	R	R	R
3-4	R	R	R	R		R	G	G	Υ	R	R
5-6	R	R	R	R		R	G	G	Υ	R	R
7-8-11-12	DW	DW	DW	DW		W	W	FD	DW	DW	0FF
9-10-13-14	W	FD	DW	DW		DW	DW	DW	DW	DW	OFF
15-16-17-18	G	G	Υ	R		R	R	R	R	R	R
FIXED	\geq	\leq	3.5	2.5		\geq	><	\leq	4	2	
MINIMUM	1	0					1	0			
PASSAGE	Ţ	3					3				
FREE (MAX)	5	4					24				
PEDESTRIAN	7	10				3	7	13			
MEMORY		PED	REC	ALL			PED	REC	ALL		

TRANSIT PRIORITY PRE-EMPTION NOTES (TO BE INSTALLED BY OTHERS)

- COORDINATE TRAFFIC CONTROLLER PROGRAMMING MODIFICATION WITH REPRESENTATIVES OF THE CITY OF PITTSBURGH AND DISTRICT TRAFFIC UNIT.
- 2. INCLUDE A TRANSIT PRIORITY PHASE THAT WILL EXTEND THE INDICATED PHASE A MAXIMUM OF 10 SECONDS WHEN ACTIVATED BY A PORT AUTHORITY VEHICLE. DO NOT VIOLATE SIDE STREET PEDESTRIAN MINIMUM TIMINGS.
- 3. MAINTAIN ALL YELLOW CLEARANCES AT ALL TIMES.
- 4. PROCEED TO THE SUBSEQUENT INTERVAL AS DEFINED IN THE MOVEMENT, SEQUENCE AND TIMING DIAGRAM UPON COMPLETING THE GREEN EXTENSION INTERVAL.
- 5. ONCE A TRANSIT CALL IS PLACED AND SATISFIED, THE CONTROLLER WILL NOT SATISFY ANOTHER CALL FOR
- 6. LOCATION OF BUS DETECTORS ARE TO BE FIELD ADJUSTED TO ACHIEVE MAXIMUM OPERATION.

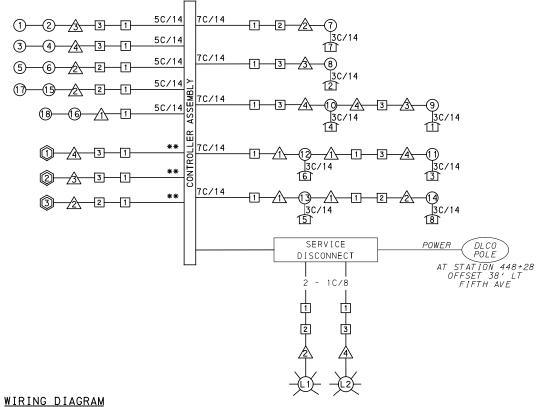

5C/14 - CABLE (NO. OF CONDUCTORS/SIZE AWG.)

- 1 EXISTING SIGNAL HEAD
- 1 PROPOSED SIGNAL HEAD
- EXISTING AUDIBLE PEDESTRIAN INDICATOR
- PROPOSED AUDIBLE PEDESTRIAN INDICATOR
- \triangle EXISTING SIGNAL SUPPORT / 1 EXISTING JUNCTION BOX
 - PROPOSED SIGNAL SUPPORT 1 PROPOSED JUNCTION BOX
- EXISTING LUMINAIRE
- -LI- PROPOSED LUMINAIRE
- **(1)** PROPOSED DETECTOR

3C/14 INCIDENTAL TO ITEM 02895.002

INCIDENTAL TO ITEM 02895.001, AS PER MANUFACTURERS SPECIFICATIONS

DETECTOR ZONE INFORMATION

DETECTOR		ECTION NE(S)	MODE	TYPE	ROUTE	PHASE	LOCATION MAST ARM
()	1	(6′×60′)	PRESENCE	VIDEO (STOP BAR)	MAGEE ST	4	4
2	2\3\4	(6' ×60')	PRESENCE	VIDEO (STOP BAR)	FIFTH AVE	2	<u> </u>
3	(5)	(6′×60′)	PRESENCE	VIDEO (STOP BAR)	MAGEE ST	8	2

GENERAL NOTES

THE CITY OF PITTSBURGH SHALL INSPECT THE NEW SIGNAL EQUIPMENT PRIOR TO ACTIVATION.

ALL TRAFFIC SIGNAL MAINTENANCE AND OPERATION RESPONSIBILITIES SHALL BE TURNED OVER TO THE CITY OF PITTSBURGH AFTER THE FOLLOWING CONDITIONS ARE IMPLEMENTED TO THE CITY'S SATISFACTION:

- 1. PERMIT "AS-BUILT" TRAFFIC SIGNAL DRAWINGS ARE SUBMITTED AND APPROVED.
- 2. ALL PUNCH LIST ITEMS ARE COMPLETED BY THE CONTRACTOR.
- 3. AFTER THE 30-DAY CONTINUOUS UNINTERRUPTED SIGNAL OPERATION WITHOUT MALFUNCTIONS.

CONSTRUCTION NOTES

- 1. ALL JUNCTION BOXES IN WALK AREAS TO BE CITY OF PITTSBURGH STANDARD CONCRETE JUNCTION BOX, TYPE 1.
- 2. ALL JUNCTION BOXES IN NON-WALK AREAS TO BE CITY STANDARD JB-2 WITH BOTTOM.
- 3. THERE SHALL BE NO SIGNAL WIRE OR FIBER CABLE SPLICING.
- 4. SERVICE WIRE FROM THE POWER SOURCE TO THE CONTROLLER CABINET SHALL BE PLACED IN SECONDARY SEPARATE CONDUIT.
- 5. STREET LIGHT CABLE IS NOT PERMITTED TO RUN THROUGH THE CONTROLLER CABINET AND SHALL BE PLACED IN SEPARATE CONDUIT.
- 6. TRAFFIC SIGNAL CABLE SHALL BE PLACED IN DEDICATED
- 7. MOUNT DISCONNECT ON POLE NEAREST TO THE CONTROLLER CABINET EXCLUDING TYPE X POLES.
- 8. REMOVE AND DISPOSE OF ALL EXISTING SIGNAL WIRING NO
- 9. REMOVE EXISTING SIGNAL EQUIPMENT NO LONGER IN USE AND RETURN TO THE CITY OF PITTSBURGH TRAFFIC CONTROL SHOP. COORDINATE DELIVERY OF EQUIPMENT WITH DELMAS MCELHANY, TRAFFIC CONTROL FOREMAN.

DETECTOR	DETECTION ZONE(S)		MODE	TYPE	ROUTE	PHASE	LOCATION MAST ARM
①	1	(6' x60')	PRESENCE	VIDEO (STOP BAR)	MAGEE ST	4	4
2	2×3×4	(6′×60′)	PRESENCE	VIDEO (STOP BAR)	FIFTH AVE	2	3
3	(5)	(6′×60′)	PRESENCE	VIDEO (STOP BAR)	MAGEE ST	8	2

AECOM

707 Grant Street 5th Floor Pittsburgh, PA 15219

THE PREPARATION OF THIS DOCUMENT HAS BEEN FINANCED IN PART THROUGH A GRANT FROM THE FEDERAL TRANSIT ADMINISTRATION U.S. DEPARTMENT OF TRANSPORTATION, UNDER THE URBAN MASS TRANSPORTATION ACT OF 1964 AS AMENDED FOR THE NO. DATE DESCRIPTION COUNTY, PENNSYLVANIA. REVISIONS

(NOT FOR CONSTRUCTION)

ESIGNED	DWP	
DRAWN	<u>NED</u>	
CHECKED	<u>AJR</u>	
N CHARGE	<u>JKM</u>	
ATE	05/01/24	
CALE		
	AS SHOWN	

DISTRICT TRAFFIC ENGINEER DATE PORT AUTHORITY OF ALLEGHENY COUNTY PITTSBURGH PENNSYLVANIA

MUNICIPALITY: CITY OF PITTSBURGH

AND MAGEE STREET

INTERSECTION: FIFTH AVENUE

APPROVED AND ACCEPTED:

CITY TRAFFIC ENGINEER

APPROVED AND ACCEPTED:

BUS RAPID TRANSIT UPTOWN TO OAKLAND SIGNAL PLANS WIRING, MOVEMENT, PHASING & SEQUENCE DIAGRAMS

Port Authority

CONTRACT NO. BRT-001 DWG. NO. SG16 sнт. 1076

TS-303

DATE

COUNTY: ALLEGHENY

MISC	ELLAN	IEOUS	
DESCRIPTION	QTY.	LOCATION	REMARKS
TRAFFIC SIGNAL TIMING MODIFICATIONS	2	СС	
POLE FOUNDATION DRILLING, LESS THAN 30" DIAMETER	8	\triangle	
POLE FOUNDATION DRILLING, GREATER THAN 30" DIAMETER	38	2 3 4	
LED LUMINAIRE CITY STANDARD, BLACK	2	英英	<u>/2</u> \/4\
TRAFFIC SIGNAL CONTROLLER ASSEMBLY, TYPE 2070 LC, WITH TYPE 332 BASE MOUNTED CABINET(MOD)	1	СС	332 CONTROLLER CABINET 8" RISER RE-ESTABLISH INTERCONNECT
ETHERNET SWITCH	1	СС	
GPS TIME CLOCK	1	СС	
VEHICULAR SIGNAL HEAD, THREE 12" SECTIONS	6	123 456	BLACK TUNNEL VISORS BLACK ALUMINUM HOUSINGS BLACK METAL LOUVERED BACKPLATE
LED COUNTDOWN PEDESTRIAN SIGNAL HEAD, TYPE A	8	7890 001	BLACK TUNNEL VISORS BLACK ALUMINUM HOUSINGS
VEHICULAR SIGNAL HEAD, THREE 8" SECTIONS	4	19191719	BLACK TUNNEL VISORS BLACK ALUMINUM HOUSINGS BLACK METAL LOUVERED BACKPLATE
ACCESSIBLE PEDESTRIAN SIGNALS	8	11234 5678	
	DESCRIPTION TRAFFIC SIGNAL TIMING MODIFICATIONS POLE FOUNDATION DRILLING, LESS THAN 30" DIAMETER POLE FOUNDATION DRILLING, GREATER THAN 30" DIAMETER LED LUMINAIRE CITY STANDARD, BLACK TRAFFIC SIGNAL CONTROLLER ASSEMBLY, TYPE 2070 LC, WITH TYPE 332 BASE MOUNTED CABINET(MOD) ETHERNET SWITCH GPS TIME CLOCK VEHICULAR SIGNAL HEAD, THREE 12" SECTIONS LED COUNTDOWN PEDESTRIAN SIGNAL HEAD, TYPE A VEHICULAR SIGNAL HEAD, THREE 8" SECTIONS	DESCRIPTION QTY. TRAFFIC SIGNAL TIMING MODIFICATIONS 2 POLE FOUNDATION DRILLING, LESS THAN 30" DIAMETER 8 POLE FOUNDATION DRILLING, GREATER THAN 38 LED LUMINAIRE CITY STANDARD, BLACK 2 TRAFFIC SIGNAL CONTROLLER ASSEMBLY, TYPE 2070 LC, WITH TYPE 332 BASE MOUNTED CABINET(MOD) 1 ETHERNET SWITCH 1 GPS TIME CLOCK 1 VEHICULAR SIGNAL HEAD, THREE 12" SECTIONS 6 LED COUNTDOWN PEDESTRIAN SIGNAL HEAD, 7 TYPE A 4	TRAFFIC SIGNAL TIMING MODIFICATIONS 2 CC POLE FOUNDATION DRILLING, LESS THAN 30" DIAMETER POLE FOUNDATION DRILLING, GREATER THAN 38 234 LED LUMINAIRE CITY STANDARD, BLACK TRAFFIC SIGNAL CONTROLLER ASSEMBLY, TYPE 2070 LC, WITH TYPE 332 BASE MOUNTED CABINET(MOD) ETHERNET SWITCH 1 CC VEHICULAR SIGNAL HEAD, THREE 12" SECTIONS LED COUNTDOWN PEDESTRIAN SIGNAL HEAD, TYPE A VEHICULAR SIGNAL HEAD, THREE 8" SECTIONS ACCESSIBLE PEDESTRIAN SIGNALS B LED COUNTDOWN PEDESTRIAN SIGNAL HEAD, THREE 8" SECTIONS ACCESSIBLE PEDESTRIAN SIGNALS B LED COUNTDOWN SIGNAL HEAD, THREE 8" SECTIONS ACCESSIBLE PEDESTRIAN SIGNALS B LED COUNTDOWN PEDESTRIAN SIGNAL HEAD, THREE 8" SECTIONS B LED COUNTDOWN PEDESTRIAN SIGNAL HEAD, THREE 8" SECTIONS

DETECTORS

ITEM NUMBER	DESCRIPTION	SEN. NO.	QTY.	LOCATION
02895 . 001	VIDEO DETECTION	(1)	1	<u> </u>
EACH				,
02895 . 001	VIDEO DETECTION	(2)	1	/3\
EACH				_
02895 . 001	VIDEO DETECTION	(3)	1	/2\
EACH				<u>—</u>

TRAFFIC SIGNAL SUPPORTS **

	¥₩ W			NO		-							1	MAST	ARM								PEI	DESTAI	
POLE NO.	DESCRIPTION	αΤΥ.	ROUTE	ATIC	SIDE	FFSE							ARM	"A"						AF	RM "(C "	SHAFT	SIGN	NAL
	_			ST	"	l P	н	K	ı	SIGN	NAL L	OCAT	ION	5	IGN	LOCA	10 I T	1	w	G	х	7	Н	м	N
	UNIT									М	N	0	Р	R	S	T	U	Υ			^			IVI	
\triangle	O2892. O04 EACH TRAFFIC SIGNAL SUPPORT, 19' TYPE X, PAINTED BLACK	1	FIFTH AVE	448+17	R	23′																	19′		10′
2	02892. 210 LUMINAIRE ARM (30' MOUNTING HEIGHT), EACH PAINTED BLACK	1	MAGEE ST	36+46	L	32′	17′	10′	36′	34′	26′			30′	6′			17′	1°		30′	0°			
<u>/3</u>	02892. 606 EACH TRAFFIC SIGNAL SUPPORT, 36' MAST ARM, PAINTED BLACK	1	FIFTH AVE	447+56	L	29′	17′	10′	36′	29′	19′			24′	16′	8′		12′	0°		30′	0°			
4	02892. 208 TRAFFIC SIGNAL SUPPORT, 32' MAST ARM WITH LUMINAIRE ARM (30' MOUNTING HEIGHT), PAINTED BLACK	1	FIFTH AVE	448+20	L	24′	17′	10′	32′	29′	21′			16′				10′	271°		30′	0°			

** REFER TO TRAFFIC STANDARDS TC-8800 SERIES FOR LETTER DESIGNATION

Gulf Tower
707 Grant Street
5th Floor
Pittsburgh, PA 15219

		THE PREPARATION OF THIS
		DOCUMENT HAS BEEN FINANCED IN PART THROUGH A GRANT FROM TH
		FEDERAL TRANSIT ADMINISTRATION U.S. DEPARTMENT OF
		TRANSPORTATION, UNDER THE
		URBAN MASS TRANSPORTATION AC OF 1964. AS AMENDED. FOR THE
DATE	DESCRIPTION	PORT AUTHORITY OF ALLEGHENY COUNTY, PENNSYLVANIA.
	REVISIONS	COONTT, FERINGTEVANIA.

					TS-30)3
IGNED	<u>DWP</u>	PORT AUTHOR	ITY OF AL	LEGHENY COL	JNTY	
NWA	NED	PITTSBURGH		PENN	SYLVANIA	
CKED	<u>AJR</u>	BUS RAPID TF	RANSIT UPT	OWN TO OAKLA	AND	
HARGE	<u>JKM</u>		SIGNAL PL	.ANS		
E	05/01/24	TRAF	FIC SIGNAL T	ABULATIONS		
LE	AS SHOWN	Port Authority	CONTR	ACT NO. BRT-0	01	
	AO OI IOWIN	connecting people to life	DWG. NO.	SG17	sнт. 107	7

TRENCH, CONDUIT, JUNCTION BOX, ELECTRICAL ITEMS

DESCRIPTION	ELECTRICAL SERVICE TYPE B	CITY OF PITTSBURGH STANDARD CONCRETE JUNCTION BOX, TYPE 1	TRENCH AND BACKFILL, TYPE II	TRENCH AND BACKFILL, TYPE IV	2 INCH CONDUIT	3 INCH CONDUIT	AWG 8, UNDERGROUND CABLE, COPPER, 1 CONDUCTOR	SIGNAL CABLE, 14 AWG, 5 CONDUCTOR	SIGNAL CABLE, 14 AWG, 7 CONDUCTOR
ITEM NUMBER	02896	02897	02898	02898	02899	02899	02900	02900	02900
TIEM NOMBER	002	001	001	005	002	003	001	002	003
UNIT	EACH	EACH	LF	LF	LF	LF	LF	LF	LF
LOCATION									
CC TO 1			13		26	26			
1 то 🛧		1	4			4			
1 TO 2			40	*	73	146			
2 TO 🖄		1	4		4	8			
1 TO 3			19	31	50	100			
3 TO <u>4</u>		1	3		3	6			
3 то ∕з҈			54		54	108			
CC TO S1			7			14			
COMPLETE INTERSECTION	1						530	680	720
TOTAL	1	3	144	31	210	412	530	680	720

S1 - TABULATED ON THE SYSTEMS PLAN.

SIGNS

SYMBOL	SERIES	SIZE	AREA EACH (SQ FT)	DESCRIPTION	QUANTITY	MOUNTED SIGNS, TYPE B	02891,003 MOUNTED SIGNS, TYPE F	O2891, 007 OSRUCTURE MOUNTED FLAT SHEET ALUMINUM SIGN WITH STIFFENERS
A	R3-2	30"X30"	6.3	NO LEFT TURN	1			6.3
В	R3-2	24"X24"	4.0	NO LEFT TURN	1		4.0	
O	R3-1	30"X30"	6.3	NO RIGHT TURN	1			6.3
O	R3-1	24"X24"	4.0	NO RIGHT TURN	1		4.0	
€	R10-3E(MOD)	9 "X15 "	0.9	EDUCATIONAL PUSH BUTTON FOR WALK SIGNAL WITH COUNTDOWN TIMER (MOD)	8		A	
E	R3-11B(MOD)	30 "X36 "	7.5	RIGHT LANE - BUSES ONLY	1			7.5
6	SS-1	30"X18"	3.8	EXCEPT RIGHT TURNS	3			11.4
H	D3-4*	60 "X24 "	10.0	1400 Uptown 1300 Fifth Ave	1			10.0
0	D3-4*	60"X24"	10.0	1300 Uptown 1400 Fifth Ave	1			10.0
O O	D3-4*	66 "X24 "	11.0	100 Uptown Magee St	1			11.0
K	R10-15AL(MOD)	30"X30"	6.3	TURNING TRAFFIC MUST YIELD TO BIKES AND PEDESTRAINS	2		6.3	6.3
0	R6-1	36 "X12 "	3.0	ONE WAY (TWO SIDED, CITY STANDARD)	2		6.0	
M	R10-11	30 "X36 "	7.5	NO TURN ON RED	2			15.0
N	R5-1	30"X30"	6.3	DO NOT ENTER	2		12.6	
0	R10-6AL	24"X30"	5.0	STOP HERE ON RED (LEFT)	1	5.0		
P	SPECIAL	30"X30"	6.3	BIKES MUST TURN RIGHT	1		6.3	
				TOTAL		5.0	39.2	83.8
				·				

▲ - INCIDENTAL TO ITEM 02895.002

* WHITE REFLECTORIZED LEGEND AND BORDER ON BLUE REFLECTORIZED BACKGROUND.
UTILIZE 4" CLEARVIEW 3W FOR BLOCK/NEIGHBORHOOD AND 8" CLEARVIEW 3W FOR
STREET NAME. ACTUAL WIDTH DETERMINED BY LETTER SPACING. COORDINATE BLOCK
NUMBERS AND STREET NAME DETAILS WITH CITY OF PITTSBURGH DEPARTMENT OF
MOBILITY AND INFRASTRUCTURE.

AECOM Gulf Tower 707 Grant Street 5th Floor Pittsburgh, PA 15219

		THE PREPARATION OF THIS
		DOCUMENT HAS BEEN FINANCED IN
		PART THROUGH A GRANT FROM THE
		FEDERAL TRANSIT ADMINISTRATION
		U.S. DEPARTMENT OF TRANSPORTATION, UNDER THE
		URBAN MASS TRANSPORTATION AC
DATE	DESCRIPTION	OF 1964, AS AMENDED, FOR THE PORT AUTHORITY OF ALLEGHENY COUNTY, PENNSYLVANIA.
	REVISIONS	COUNTY, PENNSTEVANIA.

					TS-303
ESIGNED	<u>DWP</u>	PORT AUTHOR	ITY OF AL	LEGHENY COL	JNTY
RAWN	<u>NED</u>	PITTSBURGH		PENNS	SYLVANIA
HECKED	<u>AJR</u>	BUS RAPID TF	RANSIT UPT	OWN TO OAKLA	AND
N CHARGE	<u>JKM</u>		S I GNAL PL		
ATE	05/01/24	TRAF	FIC SIGNAL T	ABULATIONS	
CALE _	S SHOWN	Port Authority	CONTR	ACT NO. BRT-00	01
	OTIOVII	connecting people to life	DWG. NO.	SG18	sнт. 1078

^{*} TYPE IV TRENCH TABULATED ON THE SYSTEMS PLAN.

SIGN

STANDARD

SIGNS


DESCRIPTION

SIZE QTY

NO. DATE

DESCRIPTION

REVISIONS

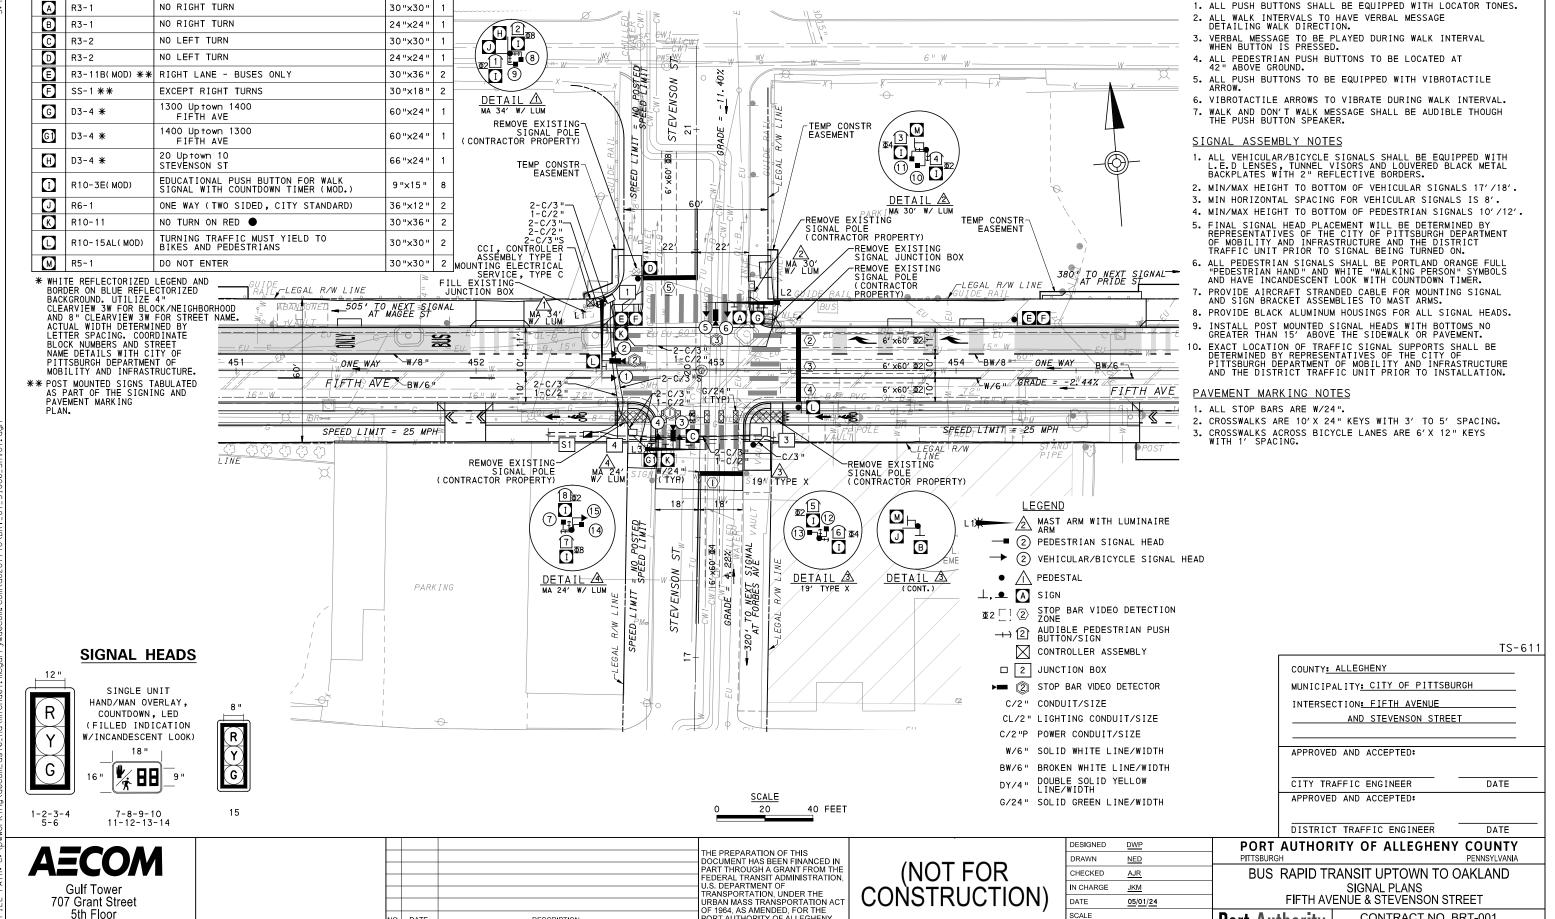

COUNTY, PENNSYLVANIA.

AUDIBLE PEDESTRIAN SIGNAL NOTES

CONTRACT NO. BRT-001

sнт. 1079

SG19

DWG NO

Port Authority


AS SHOWN

Pittsburgh, PA 15219

		PH	IASE	2			PHA	SE	4+8		
	- -	= -		11	BUS BIKE	EMEREGENCY					
		INT	ERV	ALS			INT	ERV	ALS		
SIGNAL	1	2	3	4	5	1	2	3	4	5	
1-2	R	G	G	Υ	R	R	R	R	R	R	R
3-4	R	R	R	R	R	R	G	G	Υ	R	R
5-6	R	R	R	R	R	R	G	G	Υ	R	R
7-8-11-12	DW	DW	DW	DW	DW	W	W	FD	DW	DW	OFF
9-10-13-14	W	W	FD	DW	DW	DW	DW	DW	DW	DW	OFF
15	R	G	G	Υ	R	R	R	R	R	R	R
FIXED		>	<	3.5	2.5		>	<	4.5	2.5	
MINIMUM		1	0				1	0			
PASSAGE			3					3			
FREE (MAX)		5	0				2	7			
PEDESTRIAN	3	7	13			3	4	11			
MEMORY		PED	REC	CALL			PED	REC	CALL		

TRANSIT PRIORITY PRE-EMPTION NOTES (TO BE INSTALLED BY OTHERS)

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- 6. LOCATION OF BUS DETECTORS ARE TO BE FIELD ADJUSTED TO ACHIEVE MAXIMUM OPERATION.

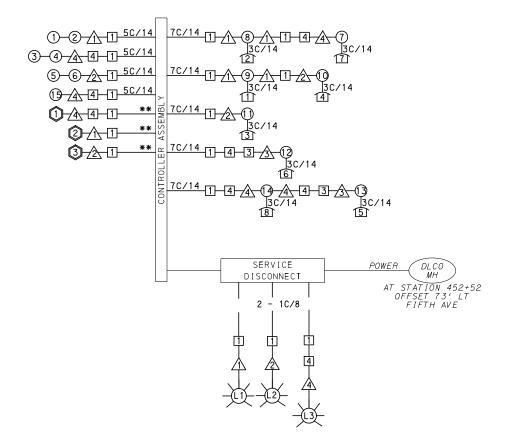

WIRING DIAGRAM

5C/14 - CABLE (NO. OF CONDUCTORS/SIZE AWG.)

- 1 EXISTING SIGNAL HEAD
- 1 PROPOSED SIGNAL HEAD
- EXISTING AUDIBLE PEDESTRIAN INDICATOR
- PROPOSED AUDIBLE PEDESTRIAN INDICATOR
- EXISTING SIGNAL SUPPORT 1 EXISTING JUNCTION BOX
 - PROPOSED SIGNAL SUPPORT 1 PROPOSED JUNCTION BOX
- EXISTING LUMINAIRE
- PROPOSED LUMINAIRE
- PROPOSED DETECTOR
- ** INCIDENTAL TO ITEM 02895.001, AS PER MANUFACTURERS SPECIFICATIONS

3C/14 INCIDENTAL TO ITEM 02895.002

DETECTOR ZONE INFORMATION

			0.1 20.12 2.11 0111			
DETECTOR	DETECTION ZONE(S)	MODE	TYPE	ROUTE	PHASE	LOCATION MAST ARM
①	⑤ (6′×60′)	PRESENCE	VIDEO (STOP BAR)	STEVENSON STREET	8	4
2	(2\3\4\)(6' x60')	PRESENCE	VIDEO (STOP BAR)	5TH AVENUE	2	\triangle
3	(6′ x60′)	PRESENCE	VIDEO (STOP BAR)	STEVENSON STREET	4	2

GENERAL NOTES

THE CITY OF PITTSBURGH SHALL INSPECT THE NEW SIGNAL EQUIPMENT PRIOR TO ACTIVATION.

ALL TRAFFIC SIGNAL MAINTENANCE AND OPERATION RESPONSIBILITIES SHALL BE TURNED OVER TO THE CITY OF PITTSBURGH AFTER THE FOLLOWING CONDITIONS ARE IMPLEMENTED TO THE CITY'S SATISFACTION:

- 1. PERMIT "AS-BUILT" TRAFFIC SIGNAL DRAWINGS ARE SUBMITTED AND APPROVED.
- 2. ALL PUNCH LIST ITEMS ARE COMPLETED BY THE
- 3. AFTER THE 30-DAY CONTINUOUS UNINTERRUPTED SIGNAL OPERATION WITHOUT MALFUNCTIONS.

CONSTRUCTION NOTES

- 1. ALL JUNCTION BOXES IN WALK AREAS TO BE CITY OF PITTSBURGH STANDARD CONCRETE JUNCTION BOX, TYPE 1.
- 2. ALL JUNCTION BOXES IN NON-WALK AREAS TO BE CITY STANDARD JB-2 WITH BOTTOM.
- 3. THERE SHALL BE NO SIGNAL WIRE OR FIBER CABLE SPLICING.
- 4. SERVICE WIRE FROM THE POWER SOURCE TO THE CONTROLLER CABINET SHALL BE PLACED IN SECONDARY SEPARATE CONDUIT.
- 5. STREET LIGHT CABLE IS NOT PERMITTED TO RUN THROUGH THE CONTROLLER CABINET AND SHALL BE PLACED IN SEPARATE CONDUIT.
- 6. TRAFFIC SIGNAL CABLE SHALL BE PLACED IN DEDICATED
- 7. MOUNT DISCONNECT ON POLE NEAREST TO THE CONTROLLER CABINET EXCLUDING TYPE X POLES.
- 8. REMOVE AND DISPOSE OF ALL EXISTING SIGNAL WIRING NO
- 9. REMOVE EXISTING SIGNAL EQUIPMENT NO LONGER IN USE AND RETURN TO THE CITY OF PITTSBURGH TRAFFIC CONTROL SHOP. COORDINATE DELIVERY OF EQUIPMENT WITH DELMAS MCELHANY, TRAFFIC CONTROL FOREMAN.

COUNTY: ALLEGHENY

MUNICIPALITY: CITY OF PITTSBURGH INTERSECTION: FIFTH AVENUE

AND STEVENSON STREET

APPROVED AND ACCEPTED:

CITY TRAFFIC ENGINEER APPROVED AND ACCEPTED:

DISTRICT TRAFFIC ENGINEER

PORT AUTHORITY OF ALLEGHENY COUNTY PENNSYLVANIA

DATE

DATE

TS-61

BUS RAPID TRANSIT UPTOWN TO OAKLAND SIGNAL PLANS

Port Authority

WIRING, MOVEMENT, PHASING & SEQUENCE DIAGRAMS CONTRACT NO. BRT-001 DWG. NO. SG20 sнт. 1080

AECOM

Gulf Tower 707 Grant Street 5th Floor Pittsburgh, PA 15219

THE PREPARATION OF THIS DOCUMENT HAS BEEN FINANCED IN PART THROUGH A GRANT FROM THE FEDERAL TRANSIT ADMINISTRATION U.S. DEPARTMENT OF TRANSPORTATION, UNDER THE URBAN MASS TRANSPORTATION ACT OF 1964 AS AMENDED FOR THE NO. DATE DESCRIPTION COUNTY, PENNSYLVANIA. REVISIONS

(NOT FOR **CONSTRUCTION** DESIGNED

CHECKED

N CHARGE

DRAWN

DATE

SCALE

DWF

NED

AJR

JKM

05/01/24

AS SHOWN

ITEM NUMBER

UNIT

01882.

EACH

009 LF 02212.

02889.

EACH

EACH 02890.

EACH 02894**.** 001

EACH

02894. 006

FACH 02895. 002

EACH

02890. 003 ETHERNET SWITCH

005 GPS TIME CLOCK

TRAFFIC SIGNAL TABULATION

FIFTH AVENUE AND STEVENSON STREET

DETEC	TORS
	SEN

	02120	10110		
ITEM NUMBER	DESCRIPTION	SEN. NO.	QTY.	LOCATION
02895 . 001	VIDEO DETECTION	(1)	1	A
EACH				
02895 . 001	VIDEO DETECTION	(2)	1	\bigwedge
EACH				
02895 . 001	VIDEO DETECTION	(3)	1	/2\
EACH				

TRAFFIC SIGNAL SUPPORTS **

REMARKS

 $\sqrt{1}\sqrt{2}\sqrt{4}$

BLACK TUNNEL VISORS BLACK ALUMINUM HOUSINGS BLACK METAL LOUVERED BACKPLATE

BLACK TUNNEL VISORS BLACK ALUMINUM HOUSINGS BLACK METAL LOUVERED BACKPLATE

BLACK TUNNEL VISORS BLACK ALUMINUM HOUSINGS

332 CONTROLLER CABINET

8" RISER RE-ESTABLISH INTERCONNECT

		-																								
	ER ER	HIN			NO NO		E							M	MAST	ARM	1							PE	DESTAL	L
POLE NO.	POLE NO. DESCRIPTION	αTY.	ROUTE	ATI	SIDE	L S							ARM	"A "						A	RM "(С"	SHAFT	SIGN	1AL	
				ST	"	OF.	Н	K		SIG	NAL I	_OCA	TION	S	IGN	LOC	OITA	N	w	G	x	z	н	м	N	
	UNIT									-	М	N	0	Р	R	S	T	U	Υ	"	"	^	_		"'	"
\triangle	02892. 209 EACH	TRAFFIC SIGNAL SUPPORT, 34' MAST ARM WITH LUMINAIRE ARM (30' MOUNTING HEIGHT), PAINTED BLACK	1	FIFTH AVE	452+52	L	29′	17′	10′	34′	32′	22′			27′	9′			12′	0°		30′	0°			
2	02892. 207 EACH	TRAFFIC SIGNAL SUPPORT, 30' MAST ARM WITH LUMINAIRE ARM (30' MOUNTING HEIGHT), PAINTED BLACK	1	STEVENSON ST	21+22	R	34′	17′	10′	30′	29′	21′			18′				6′	0°		30′	0°			
<u> </u>	02892. 004 EACH	TRAFFIC SIGNAL SUPPORT, 19' TYPE X, PAINTED BLACK	1	STEVENSON ST	17+88	R	22′																	15′		10′
4	02892. 204 EACH	TRAFFIC SIGNAL SUPPORT, 24' MAST ARM WITH LUMINAIRE ARM (30' MOUNTING HEIGHT), PAINTED BLACK	1	STEVENSON ST	17+87	L	22′	17′	10′	24′	13′	4′			17′	7′			1′	0°		30′	0°			

** REFER TO TRAFFIC STANDARDS TC-8800 SERIES FOR LETTER DESIGNATION

MISCELLANEOUS

2

36

3

QTY. LOCATION

CC

3

 $\sqrt{1}\sqrt{2}\sqrt{4}$

英英英

CC

CC

CC

456

7890

00000

13

11234

5678

DESCRIPTION

002 TRAFFIC SIGNAL TIMING MODIFICATIONS

002 LED LUMINAIRE CITY STANDARD, BLACK

02890-001 TRAFFIC SIGNAL CONTROLLER ASSEMBLY, TYPE 2070 LC, WITH TYPE 332 BASE MOUNTED CABINET(MOD)

VEHICULAR SIGNAL HEAD, THREE 12" SECTIONS

VEHICLE SIGNAL HEAD, THREE 8" SECTIONS

02894 LED COUNTDOWN PEDESTRIAN SIGNAL HEAD,

ACCESSIBLE PEDESTRIAN SIGNALS

POLE FOUNDATION DRILLING, LESS THAN 30" DIAMETER

POLE FOUNDATION DRILLING, GREATER THAN 30" DIAMETER

707 Grant Street 5th Floor Pittsburgh, PA 15219

THE PREPARATION OF THIS DOCUMENT HAS BEEN FINANCED IN PART THROUGH A GRANT FROM THE FEDERAL TRANSIT ADMINISTRATION, PEDERAL TRANSIT ADMINISTRATION,
U.S. DEPARTMENT OF
TRANSPORTATION, UNDER THE
URBAN MASS TRANSPORTATION ACT
OF 1964, AS AMENDED, FOR THE
PORT AUTHORITY OF ALLEGHENY
COUNTY, PENNSYLVANIA. NO. DATE DESCRIPTION REVISIONS

(NOT FOR CONSTRUCTION)

DESIGNED	<u>DWP</u>	Γ
DRAWN	<u>NED</u>	L
CHECKED	<u>AJR</u>	
IN CHARGE	<u>JKM</u>	
DATE	05/01/24	
SCALE		Г
	AS SHOWN	

TS-611 PORT AUTHORITY OF ALLEGHENY COUNTY

BUS RAPID TRANSIT UPTOWN TO OAKLAND SIGNAL PLANS

TRAFFIC SIGNAL TABULATIONS

CONTRACT NO. BRT-001 DWG. NO. SG21 sнт. 1081

Port Authority

FIFTH AVENUE AND STEVENSON STREET

TRENCH, CONDUIT, JUNCTION BOX, ELECTRICAL ITEMS

THEIROH & CON	,		1 1 0 1 1			INTOAL			
DESCRIPTION	ELECTRICAL SERVICE TYPE C (NEW)	CITY OF PITTSBURGH STANDARD CONCRETE JUNCTION BOX, TYPE 1	TRENCH AND BACKFILL, TYPE II	TRENCH AND BACKFILL, TYPE IV	2 INCH CONDUIT	3 INCH CONDUIT	AWG 8, UNDERGROUND CABLE, COPPER, 1 CONDUCTOR	SIGNAL CABLE, 14 AWG, 5 CONDUCTOR	SIGNAL CABLE, 14 AWG, 7 CONDUCTOR
ITEM NUMBER	02896	02897	02898	02898	02899	02899	02900	02900	02900
TIEM NOMBER	004	001	001	005	002	003	001	002	003
UNIT	EACH	EACH	LF	LF	LF	LF	LF	LF	LF
LOCATION									
сс то 1		1	8		16	32			
1 то 🔨			1		1	2			
1 то ∕2∕2			22	44	66	132			
1 TO 4		1	25	31**	56	112			
4 TO 4			8		8	16			
4 TO 3		1	15	*	52	104			
3 то ∕₃			5			5			
\$1 TO 1			21	**		126			
COMPLETE INTERSECTION	1						620	450	700
TOTAL	1	3	105	75	199	529	620	450	700

- S1 TABULATED ON THE SYSTEMS PLAN.
- * TYPE IV TRENCH TABULATED AS PART OF THE SYSTEMS PLAN.
- ** CONDUIT PLACED IN A SHARED TRENCH.

SIGNS

				316113				
SYMBOL	SERIES	SIZE	AREA EACH (SQ FT)	DESCRIPTION	QUANTITY	02891,001 POST MOUNTED SIGNS, TYPE B	O2891, 003 POST MOUNTED SIGNS, TYPE F	02891.007 STRUCTURE MOUNTED FLAT SHEET ALUMINUM SIGN WITH STIFFENERS
A	R3-1	30"×30"	6.3	NO RIGHT TURN	1	SF	SF	SF 6.3
B	R3-1	24"x24"	4.0	NO RIGHT TURN	1		4.0	
0	R3-2	30"×30"	6.3	NO LEFT TURN	1			6.3
0	R3-2	24"x24"	4.0	NO LEFT TURN	1		4.0	
▣	R3-11B(MOD)	30 "X36 "	7.5	RIGHT LANE - BUSES ONLY	2	7.5		7.5
<u> </u>	SS-1	30"X18"	3.8	EXCEPT RIGHT TURNS	2		3.8	3.8
<u> </u>	D3-4 *	60"x24"	10.0	1300 Uptown 1400 Fifth Ave	1			10.0
6	D3-4 *	60"x24"	10.0	1400 Uptown 1300 Fifth Ave	1			10.0
H	D3-4 *	66 "x24 "	11.0	20 Uptown 10 Stevenson St	1			11.0
1	R10-3E(MOD)	9"×15"	0.9	EDUCATIONAL PUSH BUTTON FOR WALK SIGNAL WITH COUNTDOWN TIMER (MOD.)	8		A	
0	R6-1	36"x12"	3.0	ONE WAY (TWO SIDED, CITY STANDARD)	2		6.0	
(R10-11	30"x36"	7.5	NO TURN ON RED	2			15.0
O	R10-15AL(MOD)	30"x30"	6.3	TURNING TRAFFIC MUST YIELD TO BIKES AND PEDESTRIANS	2	6.3		6.3
M	R5-1	30"x30"	6.3	DO NOT ENTER	2		12.6	
				TOTAL		13.8	30.4	76.2

▲ - INCIDENTAL TO ITEM 02895.002

* WHITE REFLECTORIZED LEGEND AND BORDER ON BLUE REFLECTORIZED BACKGROUND.
UTILIZE 4" CLEARVIEW 3W FOR BLOCK/NEIGHBORHOOD AND 8" CLEARVIEW 3W FOR
STREET NAME. ACTUAL WIDTH DETERMINED BY LETTER SPACING. COORDINATE BLOCK
NUMBERS AND STREET NAME DETAILS WITH CITY OF PITTSBURGH DEPARTMENT OF
MOBILITY AND INFRASTRUCTURE.

AECOM Gulf Tower 707 Grant Street 5th Floor Pittsburgh, PA 15219

		THE DEEDADATION OF THE
		THE PREPARATION OF THIS DOCUMENT HAS BEEN FINANCED IN
		PART THROUGH A GRANT FROM TH
		FEDERAL TRANSIT ADMINISTRATION U.S. DEPARTMENT OF
		TRANSPORTATION, UNDER THE
		URBAN MASS TRANSPORTATION AC OF 1964, AS AMENDED, FOR THE
DATE	DESCRIPTION	PORT AUTHORITY OF ALLEGHENY COUNTY, PENNSYLVANIA.
	REVISIONS	COUNTY, FERNISTEVANIA.

					TS-611				
DESIGNED	DWP	PORT AUTHOR	ITY OF AL	LEGHENY COL	JNTY				
DRAWN	NED	PITTSBURGH		PENNS	SYLVANIA				
CHECKED	<u>AJR</u>	BUS RAPID TRANSIT UPTOWN TO OAKLAND							
N CHARGE	<u>JKM</u>	SIGNAL PLANS							
DATE	<u>05/01/24</u>	TRAF	FIC SIGNAL T	ABULATIONS					
SCALE /	AS SHOWN	Port Authority CONTRACT NO. BRT-001							
,	10 01 10 1111	connecting people to life	DWG. NO.	SG22	sнт. 1082				




5th Floor

Pittsburgh, PA 15219

NO. DATE

DESCRIPTION

REVISIONS

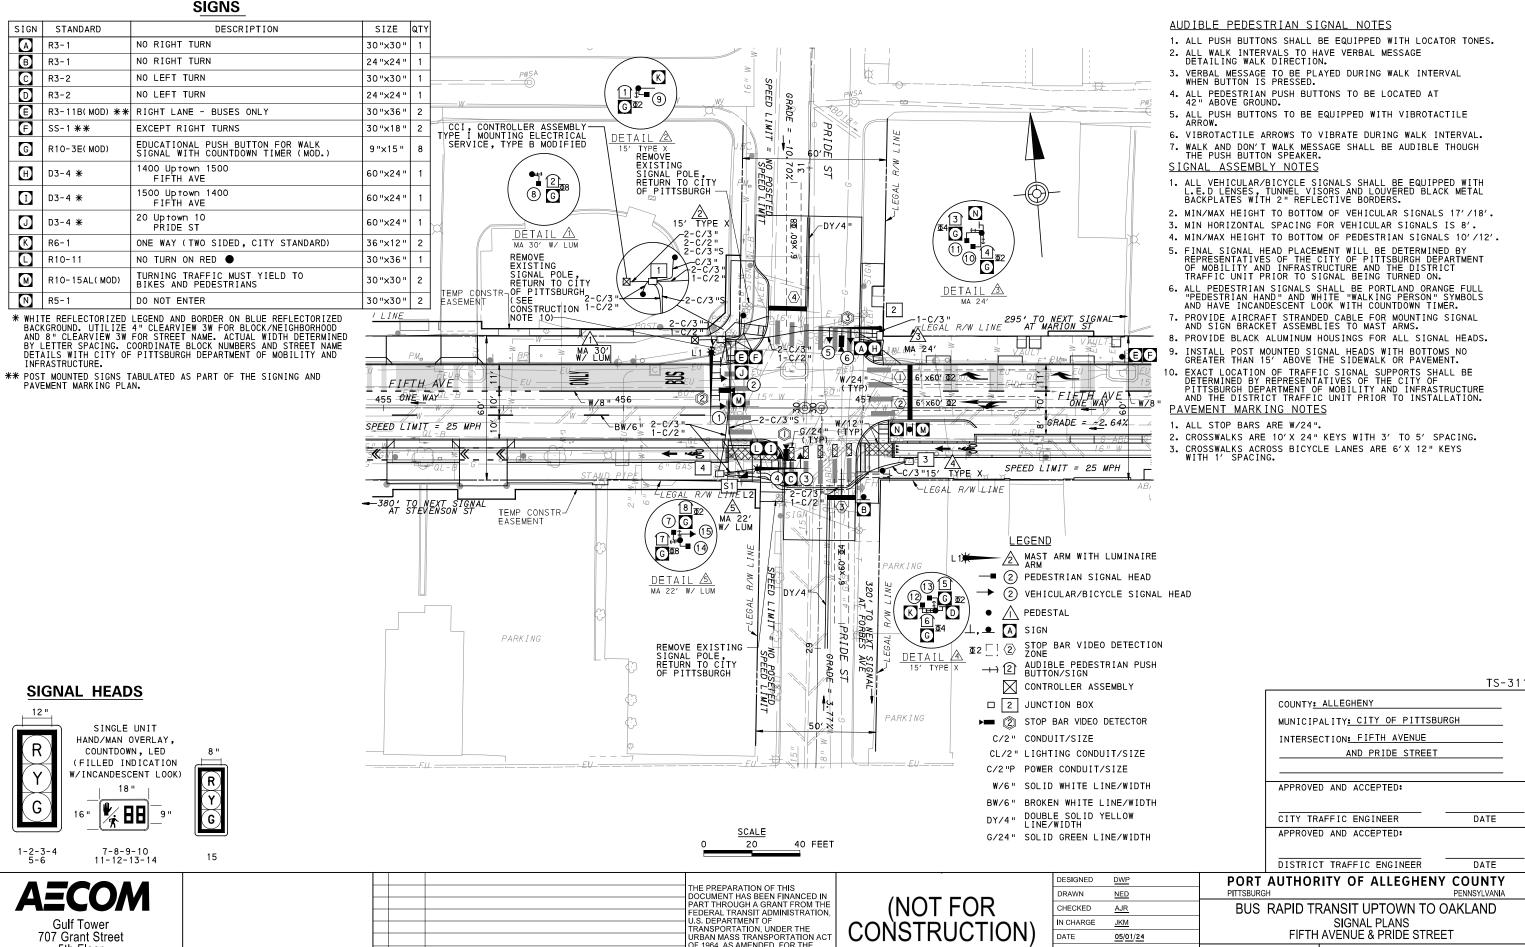

COUNTY, PENNSYLVANIA.

SCALE

AS SHOWN

CONTRACT NO. BRT-001

sнт. 1083

SG23


DWG NO

Port Authority

		PH	IASE	2			РНД	SE	4+8		E F
	-	<u>-</u> -	I	IUS IKE							
		INT	ERV	4LS			INT	ERV	ALS		
SIGNAL	1	1 2 3 4 5					2	3	4	5	
1-2	R	G	G	Υ	R	R	R	R	R	R	R
3 - 4	R	R	R	R	R	R	G	G	Υ	R	R
5-6	R	R	R	R	R	R	G	G	Υ	R	R
7-8-11-12	DW	DW	DW	DW	DW	W	W	FD	DW	DW	OFF
9-10-13-14	W	W	FD	DW	DW	DW	DW	DW	DW	DW	OFF
15	R	G	G	Υ	R	R	R	R	R	R	R
FIXED		\geq	\leq	3.5	2.5		\geq	\leq	4.5	2.5	
MINIMUM			0				1	0			
PASSAGE			3					3			
FREE (MAX)		60					1	7			
PEDESTRIAN	3	7	12			3	4	12			
MEMORY		PED	REC	ALL			PED	REC	CALL		

TRANSIT PRIORITY PRE-EMPTION NOTES (TO BE INSTALLED BY OTHERS)

- COORDINATE TRAFFIC CONTROLLER PROGRAMMING MODIFICATION WITH REPRESENTATIVES OF THE CITY OF PITTSBURGH AND DISTRICT TRAFFIC UNIT.
- 2. INCLUDE A TRANSIT PRIORITY PHASE THAT WILL EXTEND THE INDICATED PHASE A MAXIMUM OF 10 SECONDS WHEN ACTIVATED BY A PORT AUTHORITY VEHICLE. DO NOT VIOLATE SIDE STREET PEDESTRIAN MINIMUM TIMINGS.
- 3. MAINTAIN ALL YELLOW CLEARANCES AT ALL TIMES.
- 4. PROCEED TO THE SUBSEQUENT INTERVAL AS DEFINED IN THE MOVEMENT, SEQUENCE AND TIMING DIAGRAM UPON COMPLETING THE GREEN EXTENSION INTERVAL.
- 5. ONCE A TRANSIT CALL IS PLACED AND SATISFIED, THE CONTROLLER WILL NOT SATISFY ANOTHER CALL FOR
- 6. LOCATION OF BUS DETECTORS ARE TO BE FIELD ADJUSTED TO ACHIEVE MAXIMUM OPERATION.

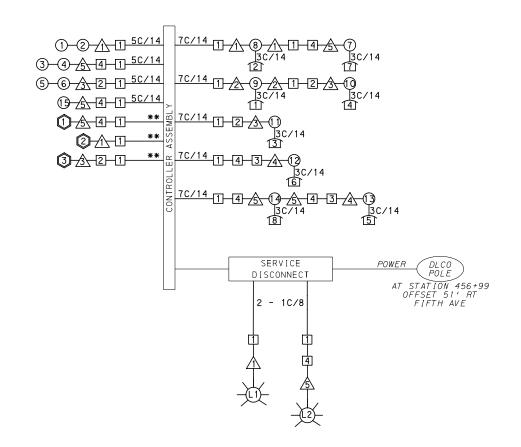

WIRING DIAGRAM

5C/14 - CABLE (NO. OF CONDUCTORS/SIZE AWG.)

- 1 EXISTING SIGNAL HEAD
- 1 PROPOSED SIGNAL HEAD
- EXISTING AUDIBLE PEDESTRIAN INDICATOR
- PROPOSED AUDIBLE PEDESTRIAN INDICATOR
- EXISTING SIGNAL SUPPORT 1 EXISTING JUNCTION BOX
 - PROPOSED SIGNAL SUPPORT 1 PROPOSED JUNCTION BOX
- EXISTING LUMINAIRE
- PROPOSED LUMINAIRE
- PROPOSED DETECTOR
- ** INCIDENTAL TO ITEM 02895.001, AS PER MANUFACTURERS SPECIFICATIONS

3C/14 INCIDENTAL TO ITEM 02895.002

DETECTOR ZONE INFORMATION

DETECTOR	DETECTION ZONE(S)	MODE	TYPE	ROUTE	PHASE	LOCATION MAST ARM
①	⟨ 4 ⟩ (6′×60′)	PRESENCE	RADAR (STOP BAR)	PRIDE STREET	8	<u>\$</u>
2	(1\(\)2\(\) (6'\(\)x60')	PRESENCE	RADAR (STOP BAR)	5TH AVENUE	2	\triangle
3	③ (6′×60′)	PRESENCE	RADAR (STOP BAR)	PRIDE STREET	4	3

GENERAL NOTES

THE CITY OF PITTSBURGH SHALL INSPECT THE NEW SIGNAL EQUIPMENT PRIOR TO ACTIVATION.

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- 4. SERVICE WIRE FROM THE POWER SOURCE TO THE CONTROLLER CABINET SHALL BE PLACED IN SECONDARY SEPARATE CONDUIT.
- 5. STREET LIGHT CABLE IS NOT PERMITTED TO RUN THROUGH THE CONTROLLER CABINET AND SHALL BE PLACED IN SEPARATE CONDUIT.
- 6. TRAFFIC SIGNAL CABLE SHALL BE PLACED IN DEDICATED
- 7. MOUNT DISCONNECT ON POLE NEAREST TO THE CONTROLLER CABINET EXCLUDING TYPE X POLES.
- 8. REMOVE AND DISPOSE OF ALL EXISTING SIGNAL WIRING NO
- 9. REMOVE EXISTING SIGNAL EQUIPMENT NO LONGER IN USE AND RETURN TO THE CITY OF PITTSBURGH TRAFFIC CONTROL SHOP. COORDINATE DELIVERY OF EQUIPMENT WITH DELMAS MCELHANY, TRAFFIC CONTROL FOREMAN.
- 10. SEE 01720 UTILITY COORDINATION FOR INFORMATION ON RELOCATION OF EXISTING SECURITY CAMERAS AND SHOT SPOTTERS.

TS-311

COUNTY: ALLEGHENY	
MUNICIPALITY: CITY OF PITTSBURGH	
INTERSECTION: FIFTH AVENUE	
AND PRIDE STREET	
APPROVED AND ACCEPTED:	
CITY TRAFFIC ENGINEER DATE	
APPROVED AND ACCEPTED:	
DISTRICT TRAFFIC ENGINEER DATE	

AECOM

707 Grant Street 5th Floor Pittsburgh, PA 15219

THE PREPARATION OF THIS DOCUMENT HAS BEEN FINANCED IN PART THROUGH A GRANT FROM THE FEDERAL TRANSIT ADMINISTRATION U.S. DEPARTMENT OF TRANSPORTATION, UNDER THE URBAN MASS TRANSPORTATION ACT OF 1964 AS AMENDED FOR THE NO. DATE DESCRIPTION COUNTY, PENNSYLVANIA. REVISIONS

(NOT FOR CONSTRUCTION)

DESIGNED	DWP	
DRAWN	<u>NED</u>	
CHECKED	<u>AJR</u>	
IN CHARGE	<u>JKM</u>	
DATE	05/01/24	
SCALE		
	AS SHOWN	

PORT AUTHORITY OF ALLEGHENY COUNTY PITTSBURGH

PENNSYLVANIA BUS RAPID TRANSIT UPTOWN TO OAKLAND SIGNAL PLANS

WIRING, MOVEMENT, PHASING & SEQUENCE DIAGRAMS **Port Authority**

CONTRACT NO. BRT-001 DWG. NO. SG24 sнт. 1084 ITEM NUMBER

UNIT

01882.

EACH

LF

02889.

EACH

EACH 02890.

EACH

02894**.** 006

EACH 02895.

002

EACH

02890. 003 ETHERNET SWITCH

005 GPS TIME CLOCK

02894. 001 VEHICULAR SIGNAL HEAD, THREE 12" SECTIONS

TRAFFIC SIGNAL TABULATION

FIFTH AVENUE AND PRIDE STREET

DE	TE	С	TC	R	S

	DETEC	10113		
I TEM NUMBER	DESCRIPTION	SEN. NO.	QTY.	LOCATION
02895 . 001	VIDEO DETECTION	(1)	1	/ 5\
EACH				
02895 . 001	VIDEO DETECTION	(2)	1	\wedge
EACH				
02895 . 001	VIDEO DETECTION	(3)	1	<u>/</u> 3\
EACH				

TRAFFIC SIGNAL SUPPORTS **

REMARKS

1\15

BLACK TUNNEL VISORS BLACK ALUMINUM HOUSINGS BLACK METAL LOUVERED BACKPLATE

BLACK TUNNEL VISORS BLACK ALUMINUM HOUSINGS BLACK METAL LOUVERED BACKPLATE

BLACK TUNNEL VISORS BLACK ALUMINUM HOUSINGS

332 CONTROLLER CABINET

8" RISER RE-ESTABLISH INTERCONNECT

	A B B B B B B B B B B B B B B B B B B B		MAST ARM									PE	DESTAL	-											
POLE NO.	DESCRIPTION	αΤΥ.	ROUTE	E TA 11.		OFFSE							ARM	и "А"						AF	RM "C	C "	SHAFT	SIGN	AL
				ST		0	Н	K		SIGN	NAL L	_OCA1	LION	S	IGN	LOCA	10 I T	١	w	G	$\mid _{X} \mid$	z	Н	М	N
	UNIT									М	N	0	Р	R	S	Ť	U	Y	"	Ū					.,
\triangle	02892- 207 TRAFFIC SIGNAL SUPPORT, 30' MAST ARM WITH LUMINAIRE ARM (30' MOUNTING HEIGHT), EACH PAINTED BLACK	1	FIFTH AVE	456+36	L	23′	17′	10′	30′	23′	11′			18′	4′			8′	0°		30′	0°			
<u>^</u>	O2892. O03 EACH TRAFFIC SIGNAL SUPPORT, 15' TYPE X, PAINTED BLACK	1	PRIDE ST	30+38	L	26′												- 1		-			15′	1	10′
<u> </u>	02892. 603 TRAFFIC SIGNAL SUPPORT, 24' MAST ARM, PAINTED BLACK	1	PRIDE ST	30+34	R	31′	17′	10′	24′	21′	12′			8′				3′	2°	1		1			
4	O2892. O03 TRAFFIC SIGNAL SUPPORT, 15' TYPE X, PAINTED BLACK	1	PRIDE ST	29+75	R	26′																	15′	1	10′
<u>\$</u>	02892- 203 TRAFFIC SIGNAL SUPPORT, 22' MAST ARM WITH LUMINAIRE ARM (30' MOUNTING HEIGHT, PAINTED BLACK	1	PRIDE ST	29+75	L	26′	17′	10′	22′	18′	10′			14′	1′			6′	2°		30′	0°			

** REFER TO TRAFFIC STANDARDS TC-8800 SERIES FOR LETTER DESIGNATION

MISCELLANEOUS

2

13

34

2

QTY. LOCATION

CC

2 4

<u>/1\/3\/\$\</u>

英 英

CC

CC

CC

456

7890 0030

13

11234

5678

DESCRIPTION

002 TRAFFIC SIGNAL TIMING MODIFICATIONS

009 POLE FOUNDATION DRILLING, LESS THAN 30" DIAMETER

02212-010 LF POLE FOUNDATION DRILLING, GREATER THAN 30" DIAMETER

002 LED LUMINAIRE CITY STANDARD, BLACK

02890. 001 TRAFFIC SIGNAL CONTROLLER ASSEMBLY, TYPE 2070 LC, WITH TYPE 332 BASE MOUNTED CABINET(MOD)

02894-005 EACH LED COUNTDOWN PEDESTRIAN SIGNAL HEAD, TYPE A

ACCESSIBLE PEDESTRIAN SIGNALS

VEHICULAR SIGNAL HEAD, THREE 8' SECTIONS

AECOM

707 Grant Street 5th Floor Pittsburgh, PA 15219

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U.S. DEPARTMENT OF
TRANSPORTATION, UNDER THE
URBAN MASS TRANSPORTATION ACT
OF 1964, AS AMENDED, FOR THE
PORT AUTHORITY OF ALLEGHENY
COUNTY, PENNSYLVANIA. NO. DATE DESCRIPTION REVISIONS

(NOT FOR CONSTRUCTION)

DESIGNED	<u>DWP</u>	
DRAWN	<u>NED</u>	
CHECKED	<u>AJR</u>	
IN CHARGE	<u>JKM</u>	
DATE	05/01/24	
SCALE		D
	AS SHOWN	[[

TS-311 PORT AUTHORITY OF ALLEGHENY COUNTY BUS RAPID TRANSIT UPTOWN TO OAKLAND

SIGNAL PLANS TRAFFIC SIGNAL TABULATIONS

ort Authority

CONTRACT NO. BRT-001 DWG. NO. SG25

sнт. 1085

TRENCH, CONDUIT, JUNCTION BOX, ELECTRICAL ITEMS

DESCRIPTION	ELECTRICAL SERVICE TYPE B	CITY OF PITTSBURGH STANDARD CONCRETE JUNCTION BOX, TYPE 1	TRENCH AND BACKFILL, TYPE II	TRENCH AND BACKFILL, TYPE IV	2 INCH CONDUIT	3 INCH CONDUIT	AWG 8, UNDERCROUND CABLE, COPPER, 1 CONDUCTOR	SIGNAL CABLE, 14 AWG, 5 CONDUCTOR	SIGNAL CABLE, 14 AWG, 7 CONDUCTOR
ITEM NUMBER	02896	02897	02898	02898	02899	02899	02900	02900	02900
TIEM NOMBER	002	001	002	005	002	003	001	002	003
UNIT	EACH	EACH	LF	LF	LF	LF	LF	LF	LF
LOCATION									
сс то 1		1	8		16	32			
1 то ⚠			5		10	20			
1 то 🖄			14			14			
1 то 2		1	25	39	64	128			
2 TO <u>3</u>			2			2			
1 TO 4		1	24	31**	55	110			
4 TO <u>\$</u>			13		13	26			
4 TO 3		1	54	*	79	158			
3 TO 4			9			9			
\$1 TO 1			19	**		140			
COMPLETE INTERSECTION	1						380	470	820
TOTAL	1	4	173	70	237	639	380	470	820

- S1 SYSTEMS JUNCTION BOX TABULATED AS PART OF THE SYSTEMS PLAN.
- * TYPE IV TRENCH TABULATED AS PART OF THE SYSTEMS PLAN.
- ** CONDUIT PLACED IN A SHARED TRENCH.

SIGNS

SYMBOL	SERIES	SIZE	AREA EACH (SQ FT)	DESCRIPTION	QUANTITY	O2891,001 MOUNTED SIGNS, TYPE B	O2891,003 MOUNTED SIGNS, TYPE F	O2891.007 OSTRUCTURE MOUNTED FLAT SHEET ALUMINUM SIGN WITH STIFFENERS
A	R3-1	30"×30"	6.3	NO RIGHT TURN	1	31	31	6.3
B	R3-1	24"×24"	4.0	NO RIGHT TURN	1	4.0		
C	R3-2	30"×30"	6.3	NO LEFT TURN	1			6.3
D	R3-2	24"×24"	4.0	NO LEFT TURN	1		4.0	
€	R3-11B(MOD)	30"x36"	7.5	RIGHT LANE - BUSES ONLY	2	7.5	7.5	
Ð	SS-1	30"×18"	3.8	EXCEPT RIGHT TURNS	2		7.6	
6	R10-3E(MOD)	9 "×15 "	0.9	EDUCATIONAL PUSH BUTTON FOR WALK SIGNAL WITH COUNTDOWN TIMER (MOD.)	8		A	
H	D3-4 *	60"×24"	10.0	1400 Uptown 1500 Fifth Ave	1			10.0
1	D3-4 *	60"×24"	10.0	1300 Uptown 1400 Fifth Ave	1			10.0
O	D3-4 *	60"×24"	10.0	20 Uptown 10 Pride St	1			10.0
K	R6-1	36"×12"	3.0	ONE WAY (TWO SIDED, CITY STANDARD)	2		6.0	
0	R10-11	30"×36"	7.5	NO TURN ON RED	1			7.5
M	R10-15AL(MOD)	30"×30"	6.3	TURNING TRAFFIC MUST YIELD TO BIKES AND PEDESTRIANS	2		6.3	6.3
N N	R5-1	30"×30"	6.3	DO NOT ENTER	2		12.6	
				TOTAL		11.5	44.0	56.4

▲ - INCIDENTAL TO ITEM 02895.002

* WHITE REFLECTORIZED LEGEND AND BORDER ON BLUE REFLECTORIZED BACKGROUND.
UTILIZE 4" CLEARVIEW 3W FOR BLOCK/NEIGHBORHOOD AND 8" CLEARVIEW 3W FOR
STREET NAME. ACTUAL WIDTH DETERMINED BY LETTER SPACING. COORDINATE BLOCK
NUMBERS AND STREET NAME DETAILS WITH CITY OF PITTSBURGH DEPARTMENT OF
MOBILITY AND INFRASTRUCTURE.

AECOM Gulf Tower 707 Grant Street 5th Floor Pittsburgh, PA 15219

		THE PREPARATION OF THIS DOCUMENT HAS BEEN FINANCED IN
		PART THROUGH A GRANT FROM THE
		FEDERAL TRANSIT ADMINISTRATION, U.S. DEPARTMENT OF
		TRANSPORTATION, UNDER THE
		URBAN MASS TRANSPORTATION ACT OF 1964, AS AMENDED, FOR THE
ATE	DESCRIPTION	PORT AUTHORITY OF ALLEGHENY COUNTY, PENNSYLVANIA.
	REVISIONS	COUNTY, PENINSTEVANIA.

					TS:	-311
ESIGNED	<u>DWP</u>	PORT AUTHOR	ITY OF AL	LEGHENY COL	JNT	/
DRAWN	NED	PITTSBURGH		PENNS	SYLVANI	A
CHECKED	<u>AJR</u>	BUS RAPID TF	RANSIT UPT	OWN TO OAKLA	AND	
N CHARGE	JKM		SIGNAL PL			
ATE	05/01/24	TRAF	FIC SIGNAL T	ABULATIONS		
CALE /	AS SHOWN	Port Authority	CONTR	ACT NO. BRT-00)1	
,	NO OFFICIAL	connecting people to life	DWG. NO.	SG26	SHT.	1086

SIGNS


SIGN	STANDARD	DESCRIPTION	SIZE	QTY
A	R3-2	NO LEFT TURN	24"x24"	2
В	R3-2	NO LEFT TURN	30"x30"	2
0	R5-1	DO NOT ENTER	30"x30"	4
D	R6-1	ONE-WAY (TWO SIDED, CITY STANDARD)	36"×12"	3
▣	R10-3E(MOD)	EDUCATIONAL PUSH BUTTON FOR WALK Signal With Countdown Timer (Mod)	9"×15"	8
Ð	D3-4 *	1600 Uptown 1500 Fifth Ave	60"x24"	1
G	D3-4 *	1500 Uptown 1600 Fifth Ave	60"x24"	1
H	D3-5 *	10 Uptown 10 → Marion St Vine St →	78 "x36 "	1
1	R3-1	NO RIGHT TURN	24"x24"	1
O)	R3-1	NO RIGHT TURN	30"x30"	1
K	R10-11	NO TURN ON RED	30"x36"	2
0	R3-11B(MOD)	RIGHT LANE - BUSES ONLY	30"x36"	2
M	SS-1	EXCEPT RIGHT TURNS	30"×18"	2
* WHIT	F REFLECTORI	ZED LEGEND AND BORDER ON		


BLUE REFLECTORIZED BACKGROUND. UTILIZE 4" CLEARVIEW 3W FOR BLOCK/NEIGHBORHOOD AND 8" CLEARVIEW 3W FOR STREET NAME. ACTUAL WIDTH DETERMINED BY LETTER SPACING. COORDINATE BLOCK NUMBERS AND STREET NAME DETAILS WITH CITY OF PITTSBURGH DEPARTMENT OF MOBILITY AND INFRASTRUCTURE.

SIGNAL HEADS

** POST MOUNTED SIGNS TABULATED AS PART OF THE SIGNING AND

PAVEMENT MARKING PLAN.

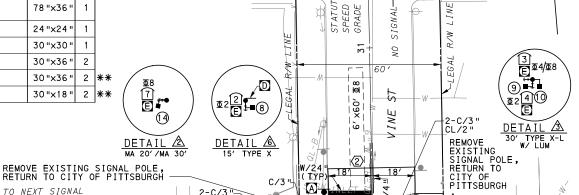

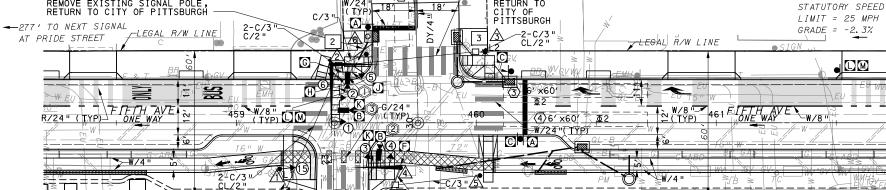

©2 (1)**■**(E)

DETAIL A

20

40 FEET

12

Φ4/Φ8 Ε

DETAIL &

-2-C/3" C/2"

ELECTRIC SERVICE

SPEED LIMIT = 25 MPH GRADE = 2.7% REMOVE EXISTING SIGNAL POLE, RETURN TO CITY OF PITTSBURGH (SEE CONSTRUCTION NOTE 9)

2-C/3"-2-C/3"S CCI, CONTROLLER ASSEMBLY TYPE I MOUNTING ELECTRICAL SERVICE, TYPE B-

ELECTRIC SERVICE POLE 2-C/3"-CL/2" C/2"P REMOVE EXISTING SIGNAL POLE, RETURN TO CITY OF PITTSBURGH

25

2-C/3

18" **₩ ВВ Т**9" 11-12-13-14

SINGLE UNIT

HAND/MAN OVERLAY,

COUNTDOWN, LED

(FILLED INDICATION

W/INCANDESCENT LOOK)

916' TO NEXT SIGNAL AT DINWIDDIE STREET-

LEGAL R/W LINE

<u>--</u>∠2\ MAST ARM

—■ ② PEDESTRIAN SIGNAL HEAD

→ ② VEHICULAR/BICYCLE SIGNAL HEAD

L1 PEDESTAL WITH LUMINAIRE

⊥, ▲ SIGN

Table 2 Stop Bar Video Detection Zone

☐ 2 JUNCTION BOX

▶**■** ② STOP BAR VIDEO DETECTOR

CL/2" LIGHTING CONDUIT/SIZE

C/3"S SYSTEM CONDUIT/SIZE C/2"P POWER CONDUIT/SIZE

ALL VEHICULAR/BICYCLE SIGNALS SHALL BE EQUIPPED WITH L.E.D LENSES, TUNNEL VISORS AND LOUVERED BLACK METAL BACKPLATES WITH 2" REFLECTIVE BORDERS.

AUDIBLE PEDESTRIAN SIGNAL NOTES

2. ALL WALK INTERVALS TO HAVE VERBAL MESSAGE DETAILING WALK DIRECTION.

3. VERBAL MESSAGE TO BE PLAYED DURING WALK INTERVAL WHEN BUTTON IS PRESSED. 4. ALL PEDESTRIAN PUSH BUTTONS TO BE LOCATED AT 42" ABOVE GROUND. 5. ALL PUSH BUTTONS TO BE EQUIPPED WITH VIBROTACTILE ARROW. 6. VIBROTACTILE ARROWS TO VIBRATE DURING WALK INTERVAL. 7. WALK AND DON'T WALK MESSAGE SHALL BE AUDIBLE THOUGH THE PUSH BUTTON SPEAKER.

2. MIN/MAX HEIGHT TO BOTTOM OF VEHICULAR SIGNALS 17'/18'

1. ALL PUSH BUTTONS SHALL BE EQUIPPED WITH LOCATOR TONES.

- 3. MIN HORIZONTAL SPACING FOR VEHICULAR SIGNALS IS 8'.
- 4. MIN/MAX HEIGHT TO BOTTOM OF PEDESTRIAN SIGNALS 10'/12'
- 5. FINAL SIGNAL HEAD PLACEMENT WILL BE DETERMINED BY REPRESENTATIVES OF THE CITY OF PITTSBURGH DEPARTMENT OF MOBILITY AND INFRASTRUCTURE AND THE DISTRICT TRAFFIC UNIT PRIOR TO SIGNAL BEING TURNED ON.
- 6. ALL PEDESTRIAN SIGNALS SHALL BE PORTLAND ORANGE FULL "PEDESTRIAN HAND" AND WHITE "WALKING PERSON" SYMBOLS AND HAVE INCANDESCENT LOOK WITH COUNTDOWN TIMER.
- 7. PROVIDE AIRCRAFT STRANDED CABLE FOR MOUNTING SIGNAL AND SIGN BRACKET ASSEMBLIES TO MAST ARMS.
- 8. PROVIDE BLACK ALUMINUM HOUSINGS FOR ALL SIGNAL HEADS.
- 9. INSTALL POST MOUNTED SIGNAL HEADS WITH BOTTOMS NO GREATER THAN 15' ABOVE THE SIDEWALK OR PAVEMENT.
- EXACT LOCATION OF TRAFFIC SIGNAL SUPPORTS SHALL BE DETERMINED BY REPRESENTATIVES OF THE CITY OF PITTSBURGH DEPARTMENT OF MOBILITY AND INFRASTRUCTURE AND THE DISTRICT TRAFFIC UNIT PRIOR TO INSTALLATION.

PAVEMENT MARKING NOTES

SIGNAL ASSEMBLY NOTES

- 1. ALL STOP BARS ARE W/24".
- 2. CROSSWALKS ARE 10'X 24" KEYS WITH 3' TO 5' SPACING.
- 3. CROSSWALKS ACROSS BICYCLE LANES ARE 6'X 12" KEYS WITH 1' SPACING.

LEGEND

A PEDESTAL

→ ② AUDIBLE PEDESTRIAN PUSH BUTTON/SIGN CONTROLLER ASSEMBLY

■ S1 SYSTEM JUNCTION BOX

C/2" CONDUIT/SIZE

W/6" SOLID WHITE LINE/WIDTH R/24" SOLID RED LINE/WIDTH

DY/4" DOUBLE SOLID YELLOW

G/24" SOLID GREEN LINE/WIDTH

TS-589

DATE

PENNSYLVANIA

COUNTY: ALLEGHENY MUNICIPALITY: CITY OF PITTSBURGH INTERSECTION: FIFTH AVENUE AND MARION STREET AND VINE STREET

APPROVED AND ACCEPTED:

CITY TRAFFIC ENGINEER APPROVED AND ACCEPTED:

DISTRICT TRAFFIC ENGINEER DATE

AECOM

Gulf Tower 707 Grant Street 5th Floor Pittsburgh, PA 15219



THE PREPARATION OF THIS NO. DATE DESCRIPTION COUNTY, PENNSYLVANIA. REVISIONS

DOCUMENT HAS BEEN FINANCED IN PART THROUGH A GRANT FROM THE (NOT FOR FEDERAL TRANSIT ADMINISTRATION U.S. DEPARTMENT OF TRANSPORTATION, UNDER THE URBAN MASS TRANSPORTATION ACT **CONSTRUCTION** OF 1964, AS AMENDED, FOR THE PORT AUTHORITY OF ALLEGHENY

DESIGNED RAWN WLZ CHECKED MSF N CHARGE LJF DATE 05/01/24 SCALE AS SHOWN PORT AUTHORITY OF ALLEGHENY COUNTY

BUS RAPID TRANSIT UPTOWN TO OAKLAND SIGNAL PLANS FIFTH AVENUE & MARION STREET/VINE STREET

CONTRACT NO. BRT-001

Port Authority DWG. NO.

SG27 sнт. 1087

		PH	IASE	2			PH	IASE	4			PH	IASE	8		
	:	BUS BUS BUS INTERVALS				_	Y		 -	BUS BIKE		T	ر -	 H	HMHRHGHZCY	
		INT	ERV.	ALS			INT	ERV	ALS			INT	ERV.	ALS		Ϋ́
SIGNAL	1	2	3	4	5	1	2	3	4	5	1	2	3	4	5	
1-2	G	G	Υ	R		R	R	R			R	R	R	R		R
3-4	R	R	R	R		R	R	R			G	G	Υ	R		R
5-6	R	R	R	R		G	Υ	R			R	R	R	R		R
7-11	W	FD	DW	DW		DW	DW	DW			DW	DW	DW	DW		OFF
8-9	W	FD	DW	DW		DW	DW	DW			DW	DW	DW	DW		0FF
10-12	DW	DW	DW	DW		W	W	W			W	FD	DW	DW		0FF
13-14	DW	DW	DW	DW		DW	DW	DW			W	FD	DW	DW		0FF
15	G	G	Y	R		R	R	R			R	R	R	R		R
FIXED	\geq	\leq	4	3		\geq	4.5	2.5			\wedge	\leq	4.5	2.5		
MINIMUM	1	0				10					1	0				
PASSAGE																
FREE (MAX)	3	7				14					1	8				
PEDESTRIAN	7	11				1					7	12				
MEMORY		PE	-RE	CALL	-	ΜI	NIM	UM F	RECA	LL		PED	REC	ALL		


① PEDESTRIAN PHASE TO START IN PHASE 4 AND BE COMPLETED IN PHASE 8

TRANSIT PRIORITY PRE-EMPTION NOTES (TO BE INSTALLED BY OTHERS)

- COORDINATE TRAFFIC CONTROLLER PROGRAMMING MODIFICATION WITH REPRESENTATIVES OF THE CITY OF PITTSBURGH AND DISTRICT TRAFFIC UNIT.
- 2. INCLUDE A TRANSIT PRIORITY PHASE THAT WILL EXTEND THE INDICATED PHASE A MAXIMUM OF 10 SECONDS WHEN ACTIVATED BY A PORT AUTHORITY VEHICLE. DO NOT VIOLATE SIDE STREET PEDESTRIAN MINIMUM TIMINGS.
- 3. MAINTAIN ALL YELLOW CLEARANCES AT ALL TIMES.
- 4. PROCEED TO THE SUBSEQUENT INTERVAL AS DEFINED IN THE MOVEMENT, SEQUENCE AND TIMING DIAGRAM UPON COMPLETING THE GREEN EXTENSION INTERVAL.
- 5. ONCE A TRANSIT CALL IS PLACED AND SATISFIED, THE CONTROLLER WILL NOT SATISFY ANOTHER CALL FOR
- 6. LOCATION OF BUS DETECTORS ARE TO BE FIELD ADJUSTED TO ACHIEVE MAXIMUM OPERATION.

DETECTOR ZONE INFORMATION

DETECTOR	DETECTION	MODE	TYPE	ROUTE	PHASE	LOCATION
DETECTOR	ZONE(S)	MODE	IIIE	ROUTE	FRASE	MAST ARM
	(6′ x75′)	PRESENCE	VIDEO (STOP BAR)	MARION STREET	4	2
②	② (6′×60′)	PRESENCE	VIDEO (STOP BAR)	VINE STREET	8	4
(3)	③4 (6'x60')	PRESENCE	VIDEO (STOP BAR)	FIFTH AVENUE	2	2

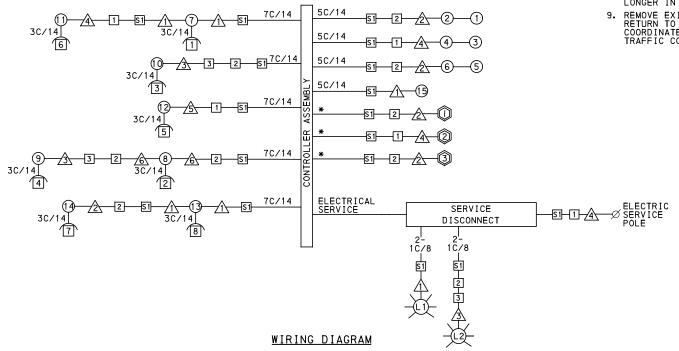

5C/14 - CABLE (NO. OF CONDUCTORS/SIZE AWG.)

PROPOSED DETECTOR

PROPOSED AUDIBLE

1 PROPOSED SIGNAL HEAD

↑ PROPOSED SIGNAL SUPPORT PEDESTRIAN INDICATOR -(L1)- PROPOSED LUMINAIRE 1 PROPOSED JUNCTION BOX

51 PROPOSED SYSTEM JUNCTION BOX

3C/14 INCIDENTAL TO ITEM 02895.002

* INCIDENTAL TO ITEM 02895.001, AS PER MANUFACTURERS SPECIFICATIONS

GENERAL NOTES

THE CITY OF PITTSBURGH SHALL INSPECT THE NEW SIGNAL EQUIPMENT PRIOR TO ACTIVATION.

ALL TRAFFIC SIGNAL MAINTENANCE AND OPERATION RESPONSIBILITIES SHALL BE TURNED OVER TO THE CITY OF PITTSBURGH AFTER THE FOLLOWING CONDITIONS ARE IMPLEMENTED TO THE CITY'S SATISFACTION:

- 1. PERMIT "AS-BUILT" TRAFFIC SIGNAL DRAWINGS ARE SUBMITTED AND APPROVED.
- 2. ALL PUNCH LIST ITEMS ARE COMPLETED BY THE CONTRACTOR.
- 3. AFTER THE 30-DAY CONTINUOUS UNINTERRUPTED SIGNAL OPERATION WITHOUT MALFUNCTIONS.

CONSTRUCTION NOTES

- 1. ALL JUNCTION BOXES IN WALK AREAS TO BE CITY OF PITTSBURGH STANDARD CONCRETE JUNCTION BOX, TYPE 1.
- 2. ALL JUNCTION BOXES IN NON-WALK AREAS TO BE CITY STANDARD JB-2 WITH BOTTOM.
- 3. THERE SHALL BE NO SIGNAL WIRE OR FIBER CABLE SPLICING.
- 4. SERVICE WIRE FROM THE POWER SOURCE TO THE CONTROLLER CABINET SHALL BE PLACED IN SECONDARY SEPARATE CONDUIT.
- 5. STREET LIGHT CABLE IS NOT PERMITTED TO RUN THROUGH THE CONTROLLER CABINET AND SHALL BE PLACED IN SEPARATE CONDUIT.
- 6. TRAFFIC SIGNAL CABLE SHALL BE PLACED IN DEDICATED
- 7. MOUNT DISCONNECT ON POLE NEAREST TO THE CONTROLLER CABINET EXCLUDING TYPE X POLES.
- 8. REMOVE AND DISPOSE OF ALL EXISTING SIGNAL WIRING NO LONGER IN USE.
- 9. REMOVE EXISTING SIGNAL EQUIPMENT NO LONGER IN USE AND RETURN TO THE CITY OF PITTSBURGH TRAFFIC CONTROL SHOP. COORDINATE DELIVERY OF EQUIPMENT WITH DELMAS MCELHANY, TRAFFIC CONTROL FOREMAN.

TS-589

COUNTY: ALLEGHENY MUNICIPALITY: CITY OF PITTSBURGH INTERSECTION: FIFTH AVENUE AND MARION STREET AND VINE STREET APPROVED AND ACCEPTED: CITY TRAFFIC ENGINEER DATE APPROVED AND ACCEPTED: DISTRICT TRAFFIC ENGINEER DATE

AECOM

Gulf Tower 707 Grant Street 5th Floor Pittsburgh, PA 15219



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(NOT FOR **CONSTRUCTION**

DESIGNED	<u>LJF</u>	
DRAWN	<u>WLZ</u>	
CHECKED	MSF	
IN CHARGE	<u>LJF</u>	
DATE	05/01/24	
SCALE		
	AS SHOWN	

PORT AUTHORITY OF ALLEGHENY COUNTY

BUS RAPID TRANSIT UPTOWN TO OAKLAND SIGNAL PLANS WIRING, MOVEMENT, PHASING & SEQUENCE DIAGRAMS

Port Authority

CONTRACT NO. BRT-001 SG28 DWG NO sнт. 1088

ITEM

UNIT

002

EACH 01883.

EACH

LF

02889.

EACH

EACH 02890.

EACH 02890. 005

EACH

EACH

EACH 02895.

EACH

TRAFFIC SIGNAL TABULATION

FIFTH AVENUE AND MARION STREET AND VINE STREET

ITEM NUMBER	DESCRIPTION	SEN. NO.	QTY.	LOCATION
02895 . 001	VIDEO DETECTION	Û	1	/2\
EACH		~		
02895 . 001	VIDEO DETECTION	2	1	<u> </u>
EACH		~		
02895 . 001	VIDEO DETECTION	3	1	/2\
EACH		_ ~		

DETECTORS

TDAEETO CTONAL CHIDDODTO **

						IR#	AFF IC	S I	IGNAL	SUPF	20K	15 *	**																		
POLE	ITEM	DESCRIPTION	QTY.	ROUTE	NOIL				MAST ARM ARM "A" ARM "B"										PEDEST												
NO.		DESCRIPTION	Q.	ROUTE	STA ⁻	SI	н	ĸ	- ⊢	NAL LO	OCAT	ION	S	IGN L	OCAT	ION	W	L	_		OCATIO	NC	SIGN	N LOCA		l w				M	
	UNIT								M	N	0	Р	R	S	T	UY			М	N	0 P	<u>' </u>	R S	\perp \perp \perp	U	<u> </u>					\perp
\triangle	02892. 005 EACH	TRAFFIC SIGNAL SUPPORT, 30' TYPE X-L WITH LUMINAIRE ARM, PAINTED BLACK	1	MARION ST	22+96	LT 22	,																				6' 30	90	° 30′	15′	10'
2	02892. 301 EACH	TRAFFIC SIGNAL SUPPORT, 20' MAST ARM AND 30' MAST ARM, PAINTED BLACK	1	FIFTH AVE	459+40	LT 24	17′ 1	10′	30′ 23′	13′		:	20′	16′	10′	4′	0°	20′	12′	0′		8	8′			4′ 90°					
3	02892. 005 EACH	TRAFFIC SIGNAL SUPPORT, 30' TYPE X-L WITH LUMINAIRE ARM, PAINTED BLACK	1	VINE ST	30+29	RT 28	,																				6′ 30	oʻ 0°	30′		10′
4	02892. 602 EACH	TRAFFIC SIGNAL SUPPORT, 20' MAST ARM, PAINTED BLACK	1	MARION ST	22+97	RT 28	17′ 1	10′	20′ 13′	4′			10′	8′		0′	0°														
<u>\$</u>	02892. 003 EACH	TRAFFIC SIGNAL SUPPORT, 15' TYPE X, PAINTED BLACK	1	FIFTH AVE	460+02	RT 22	,																						15′		10′
<u> </u>	02892. 003 EACH	TRAFFIC SIGNAL SUPPORT, 15' TYPE X, PAINTED BLACK	1	VINE STREET	30+29	LT 21	,																						15′		10′

** REFER TO PENNDOT TC-8800 TRAFFIC STANDARDS-SIGNALS FOR LETTER DESIGNATION

MISCELLANEOUS

30

24

2

6

8

QTY. LOCATION

CC

1_3_5_6\\\

2 4

英英

CC

CC

CC

CC

VINE STREET: STA 30+30 LT OFFSET 21'

123

456

7890

0000

(15)

11234

5678

REMARKS

 Λ

BLACK TUNNEL VISORS BLACK ALUMINUM HOUSINGS BLACK METAL LOUVERED BACKPLATE

BLACK TUNNEL VISORS BLACK ALUMINUM HOUSINGS BLACK METAL LOUVERED BACKPLATE

BLACK TUNNEL VISORS BLACK ALUMINUM HOUSINGS

332 CONTROLLER CABINET 8 " RISER RE-ESTABLISH INTERCONNECT

DESCRIPTION

TRAFFIC SIGNAL TIMING MODIFICATIONS

TEMPORARY TRAFFIC SIGNAL

002 LED LUMINAIRE CITY STANDARD, BLACK

02890-001 TRAFFIC SIGNAL CONTROLLER ASSEMBLY, TYPE 2070 LC WITH TYPE 332 BASE MOUNTED CABINET

02894. LED COUNTDOWN PEDESTRIAN SIGNAL HEAD,

TEMPORARY TRAFFIC SIGNAL CONTROLLER

02212. 009 DOLE FOUNDATION DRILLING, LESS THAN 30" DIAMETER

02212. 010 POLE FOUNDATION DRILLING, 30" DIAMETER OR GREATER

02890. 003 ETHERNET SWITCH

GPS TIME CLOCK

02893. REMOVE EXISTING POLE AND ENTIRE FOUNDATION

02894. 001 VEHICULAR SIGNAL HEAD, THREE 12" SECTIONS

02894. VEHICULAR SIGNAL HEAD, THREE 8" SECTIONS

002 ACCESSIBLE PEDESTRIAN SIGNALS

TYPE A

TS-589

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		THE DREPARATION OF THE
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ATE	DESCRIPTION	PORT AUTHORITY OF ALLEGHENY COUNTY, PENNSYLVANIA.
	REVISIONS	COUNTY, PENNSTEVANIA.

(NOT FOR CONSTRUCTION)

DESIGNED	<u>LJF</u>	
DRAWN	<u>WLZ</u>	
CHECKED	MSF	
IN CHARGE	<u>LJF</u>	
DATE	05/01/24	
SCALE		
	AS SHOWN	
	DRAWN CHECKED IN CHARGE DATE	DRAWN <u>WLZ</u> CHECKED <u>MSF</u> IN CHARGE <u>LJF</u> DATE <u>05/01/24</u> SCALE

PORT AUTHORITY OF ALLEGHENY COUNTY PENNSYLVANIA

BUS RAPID TRANSIT UPTOWN TO OAKLAND SIGNAL PLANS

	TRAF	FIC SIGNAL TABULATIONS
3~ r+	Authority	CONTRACT NO. BR

CONTRACT NO. BRT-001 Port Authority connecting people to life DWG. NO. SG29 sнт. 1089

FIFTH AVENUE AND MARION STREET AND VINE STREET

TRENCH, CONDUIT, JUNCTION BOX, ELECTRICAL ITEMS

DESCRIPTION	ELECTRICAL SERVICE	CITY OF PITTSBURGH STANDARD CONCRETE JUNCTION BOX, TYPE 1	TRENCH AND BACKFILL, TYPE II	TRENCH AND BACKFILL, TYPE IV	2 INCH CONDUIT	3 INCH CONDUIT	AWG 8, UNDERCROUND CABLE, COPPER, 1 CONDUCTOR	SIGNAL CABLE, 14 AWG, 5 CONDUCTOR	SIGNAL CABLE, 14 AWG, 7 CONDUCTOR
ITEM NUMBER	02896	02897	02898	02898	02899	02899	02900	02900	02900
. TEM TOMBET	002	001	002	005	002	003	001	002	003
TINU	EACH	EACH	LF	LF	LF	LF	LF	LF	LF
LOCATION		ı			ı	I		I	
CC TO §1			9		18	36			
1 TO §1		1	29	22*	102	102			
2 TO §1		1	30	28	58	116			
3 TO 2		1	22	36	58	116			
<u></u> ↑ ↑ ↑ ↑ ↑ ↑ ↑ ↑ ↑ ↑ ↑ ↑ ↑ ↑ ↑ ↑ ↑ ↑ ↑			10		10	20			
<u>∕2</u> TO 2			4		4	8			
<u>∕</u> 3 то 3			4		4	8			
			8		16	16			
<u>∕\$</u> TO 1			36			36			
_6 то 2			13			13			
COMPLETE INTERSECTION	1						500	475	835
TOTAL	1	3	165	64	270	471	500	475	835

^{*} TYPE IV TRENCH TABULATED AS PART OF THE SYSTEMS PLAN.

SIGNS

SYMBOL	SERIES	SIZE	AREA EACH (SQ FT)	DESCRIPTION	QUANTITY	02891, 001 POST MOUNTED SIGNS, TYPE B	02891,003 POST MOUNTED SIGNS, TYPE F	02891,007 STRUCTURE MOUNTED FLAT SHEET ALUMINUM SIGNS WITH STIFFENERS
	D7.0	0411 0411	4.0	NO LEET THOU		SF	SF	SF
	R3-2	24 "x24 "	4.0	NO LEFT TURN	2	4.0	4.0	
B	R3-2	30"x30"	6.3	NO LEFT TURN	2			12.6
\odot	R5-1	30"×30"	6.3	DO NOT ENTER	4	12.6	12.6	
\bigcirc	R6-1	36 "×12 "	3.0	ONE-WAY (TWO SIDED, CITY STANDARD)	3		9.0	
\blacksquare	R10-3E (MOD)	9"x15"	0.9	EDUCATIONAL PUSH BUTTON FOR WALK SIGNAL WITH COUNTDOWN TIMER (MOD)	8		A	
E	D3-4*	60"x24"	10.0	1600 Uptown 1500 Fifth Ave	1			10.0
<u>©</u>	D3-4*	60"×24"	10.0	1500 Uptown 1600 Fifth Ave	1			10.0
\oplus	D3-5*	78 "x36 "	19.5	10 Uptown 10 — Marion St Vine St—	1			19.5
	R3-1	24"×24"	4.0	NO RIGHT TURN	1	4.0		
0	R3-1	30"×30"	6.3	NO RIGHT TURN	1			6.3
K	R10-11	30"×36"	7.5	NO TURN ON RED ●	2			15.0
	R3-11B(MOD)	30 "x36 "	7.5	RIGHT LANE - BUSES ONLY	1			7.5
M	SS-1	30"×18"	3.8	EXCEPT RIGHT TURNS	1			3.8
	•			TOTAL		20.6	25.6	84.7

▲ - INCIDENTAL TO ITEM 02895.002

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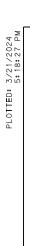


		THE DREDADATION OF THE
		THE PREPARATION OF THIS DOCUMENT HAS BEEN FINANCED IN
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		FEDERAL TRANSIT ADMINISTRATION, U.S. DEPARTMENT OF
		TRANSPORTATION, UNDER THE
		URBAN MASS TRANSPORTATION ACT OF 1964, AS AMENDED, FOR THE
Έ	DESCRIPTION	PORT AUTHORITY OF ALLEGHENY COUNTY, PENNSYLVANIA.
	REVISIONS	COUNTY, FEMINISTEVANIA.

					TS-589
ESIGNED	<u>LJF</u>	PORT AUTHOR	ITY OF AL	LEGHENY COL	JNTY
RAWN	<u>WLZ</u>	PITTSBURGH		PENNS	SYLVANIA
HECKED	MSF	BUS RAPID TF	RANSIT UPT	OWN TO OAKLA	AND
I CHARGE	<u>LJF</u>		SIGNAL PL	.ANS	
ATE	<u>05/01/24</u>	TRAF	FIC SIGNAL T	ABULATIONS	
CALE	AS SHOWN	Port Authority	CONTR	ACT NO. BRT-00	01
,	AS SHOWIN	connecting people to life	DWG. NO.	SG30	sнт. 1090


S1 - TABULATED ON SYSTEMS PLAN

^{*} WHITE REFLECTORIZED LEGEND AND BORDER ON BLUE REFLECTORIZED BACKGROUND.
UTILIZE 4" CLEARVIEW 3W FOR BLOCK/NEIGHBORHOOD AND 8" CLEARVIEW 3W FOR
STREET NAME. ACTUAL WIDTH DETERMINED BY LETTER SPACING. COORDINATE BLOCK
NUMBERS AND STREET NAME DETAILS WITH CITY OF PITTSBURGH DEPARTMENT OF
MOBILITY AND INFRASTRUCTURE.



Pittsburgh, PA 15219

SIGNS

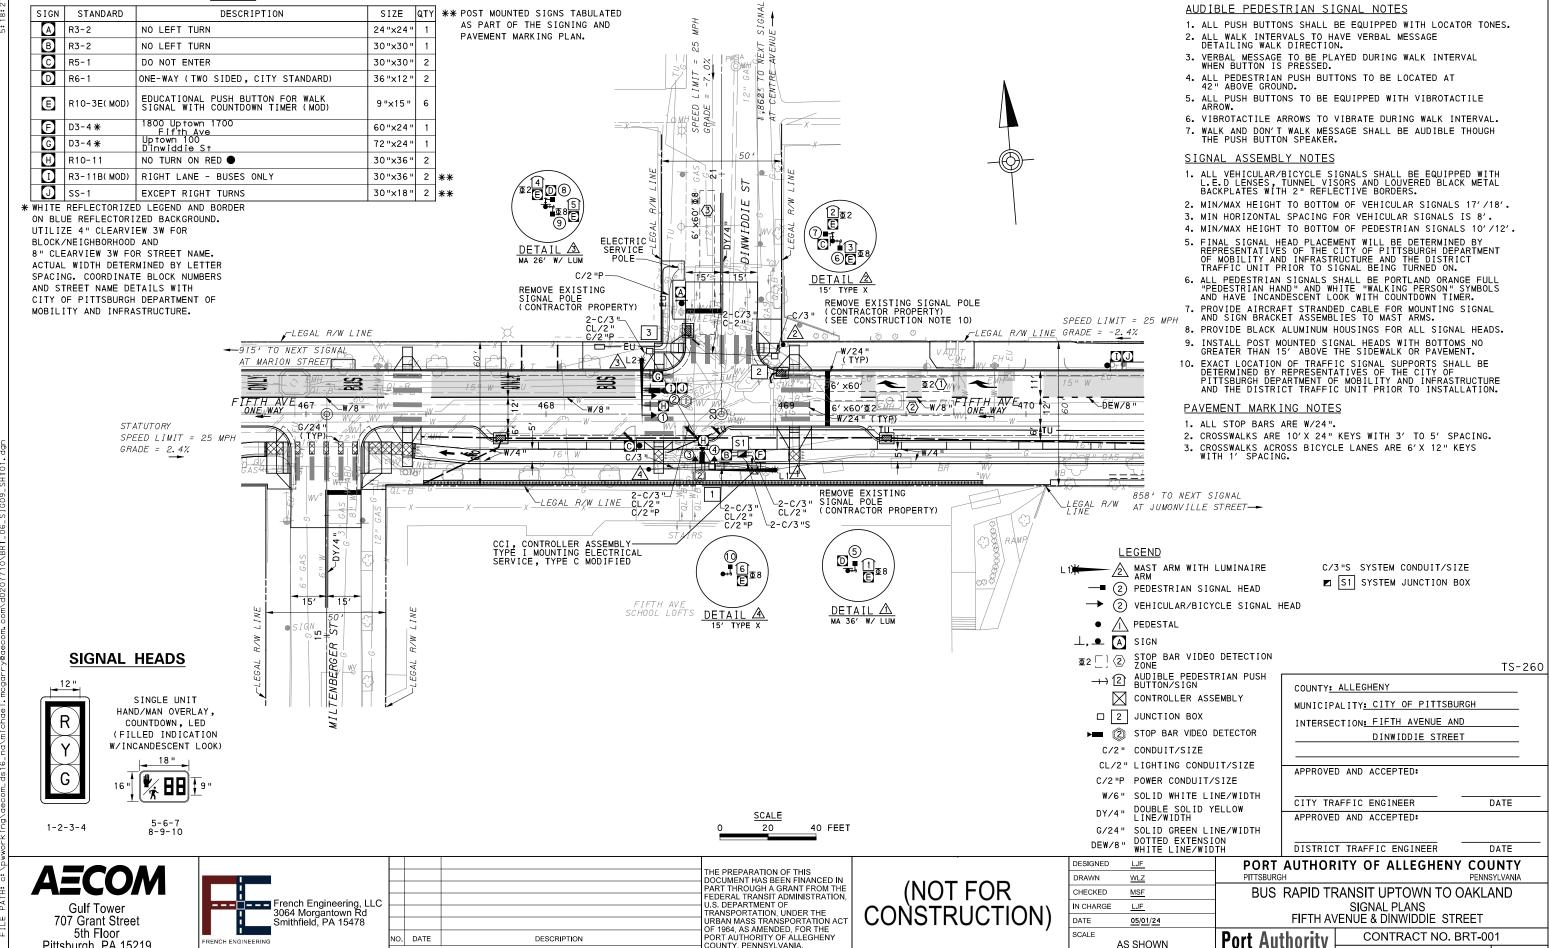

COUNTY, PENNSYLVANIA.

REVISIONS

AS SHOWN

SG31


sнт. 1091

DWG NO

		PHASE 2					PHASE 8					
	- -	BUS							! - -	SUS	HLANHIZG HLANHIZG	
_		INT	ERV	ALS			INT	ERV.	ALS		ĬΫ́	
SIGNAL	1	2	3	4	5	1	2	3	4	5		
1-2	G	G	Υ	R		R	R	R	R		R	
3-4	R	R	R	R		G	G	Υ	R		R	
5-6	DW	DW	DW	DW		W	FD	DW	DW		OFF	
7-8	W	FD	DW	DW		DW	DW	DW	DW		0FF	
9-10	DW	DW	DW	DW		W	FD	DW	DW		0FF	
FIXED	\geq	<	3.5	2.5		\geq	<	4	2			
MINIMUM	1	8				1	8					
PASSAGE	3	3					3					
FREE (MAX)	6	60		1	8							
PEDESTRIAN	7	10				7	11					
MEMORY	ΜI	NIM	UM F	RECA	LL		PED	-REC	CALL			

DETECTOR ZONE INFORMATION

DETECTOR	DETECTION ZONE(S)	MODE	TYPE	ROUTE	PHASE	LOCATION MAST ARM
(1)	1 2 (6' x60')	PRESENCE	VIDEO (STOP BAR)	FIFTH AVENUE	2	ß
②	③ (6′×60′)	PRESENCE	VIDEO (STOP BAR)	DINWIDDIE STREET	8	\triangle

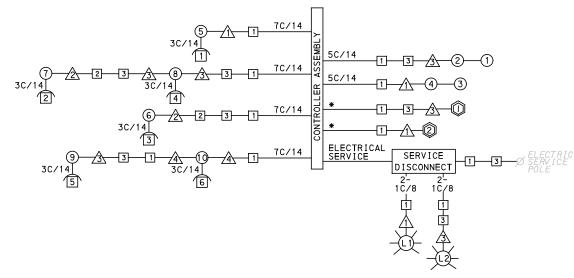

TRANSIT PRIORITY PRE-EMPTION NOTES (TO BE INSTALLED BY OTHERS)

- COORDINATE TRAFFIC CONTROLLER PROGRAMMING MODIFICATION WITH REPRESENTATIVES OF THE CITY OF PITTSBURGH AND DISTRICT TRAFFIC UNIT.
- 2. INCLUDE A TRANSIT PRIORITY PHASE THAT WILL EXTEND THE INDICATED PHASE A MAXIMUM OF 10 SECONDS WHEN ACTIVATED BY A PORT AUTHORITY VEHICLE. DO NOT VIOLATE SIDE STREET PEDESTRIAN MINIMUM TIMINGS.
- 3. MAINTAIN ALL YELLOW CLEARANCES AT ALL TIMES.
- 4. PROCEED TO THE SUBSEQUENT INTERVAL AS DEFINED IN THE MOVEMENT, SEQUENCE AND TIMING DIAGRAM UPON COMPLETING THE GREEN EXTENSION INTERVAL.
- 5. ONCE A TRANSIT CALL IS PLACED AND SATISFIED, THE CONTROLLER WILL NOT SATISFY ANOTHER CALL FOR
- 6. LOCATION OF BUS DETECTORS ARE TO BE FIELD ADJUSTED TO ACHIEVE MAXIMUM OPERATION.

WIRING DIAGRAM

5C/14 - CABLE (NO. OF CONDUCTORS/SIZE AWG.)

PROPOSED DETECTOR 1) PROPOSED SIGNAL HEAD PROPOSED AUDIBLE 1

PEDESTRIAN INDICATOR A PROPOSED SIGNAL SUPPORT

-(L1)- PROPOSED LUMINAIRE 1 PROPOSED JUNCTION BOX

3C/14 INCIDENTAL TO ITEM 02895.002 *INCIDENTAL TO ITEM 02895.001, AS PER MANUFACTURERS SPECIFICATIONS

GENERAL NOTES

THE CITY OF PITTSBURGH SHALL INSPECT THE NEW SIGNAL EQUIPMENT PRIOR TO ACTIVATION.

ALL TRAFFIC SIGNAL MAINTENANCE AND OPERATION RESPONSIBILITIES SHALL BE TURNED OVER TO THE CITY OF PITTSBURGH AFTER THE FOLLOWING CONDITIONS ARE IMPLEMENTED TO THE CITY'S SATISFACTION:

- 1. PERMIT "AS-BUILT" TRAFFIC SIGNAL DRAWINGS ARE SUBMITTED AND APPROVED.
- 2. ALL PUNCH LIST ITEMS ARE COMPLETED BY THE CONTRACTOR.
- 3. AFTER THE 30-DAY CONTINUOUS UNINTERRUPTED SIGNAL OPERATION WITHOUT MALFUNCTIONS.

CONSTRUCTION NOTES

- 1. ALL JUNCTION BOXES IN WALK AREAS TO BE CITY OF PITTSBURGH STANDARD CONCRETE JUNCTION BOX, TYPE 1.
- 2. ALL JUNCTION BOXES IN NON-WALK AREAS TO BE CITY STANDARD JB-2 WITH BOTTOM.
- 3. THERE SHALL BE NO SIGNAL WIRE OR FIBER CABLE SPLICING.
- 4. SERVICE WIRE FROM THE POWER SOURCE TO THE CONTROLLER CABINET SHALL BE PLACED IN SECONDARY SEPARATE CONDUIT.
- 5. STREET LIGHT CABLE IS NOT PERMITTED TO RUN THROUGH THE CONTROLLER CABINET AND SHALL BE PLACED IN SEPARATE CONDUIT.
- 6. TRAFFIC SIGNAL CABLE SHALL BE PLACED IN DEDICATED
- 7. MOUNT DISCONNECT ON POLE NEAREST TO THE CONTROLLER CABINET EXCLUDING TYPE X POLES.
- 8. REMOVE AND DISPOSE OF ALL EXISTING SIGNAL WIRING NO LONGER IN USE.
- 9. REMOVE EXISTING SIGNAL EQUIPMENT NO LONGER IN USE AND RETURN TO THE CITY OF PITTSBURGH TRAFFIC CONTROL SHOP. COORDINATE DELIVERY OF EQUIPMENT WITH DELMAS MCELHANY, TRAFFIC CONTROL FOREMAN.
- 10. SEE 01720 UTILITY COORDINATION FOR INFORMATION ON RELOCATION OF EXISTING SECURITY CAMERAS AND SHOT SPOTTERS.

TS-260

	APPROVED AND ACCEPTED:		
	CITY TRAFFIC ENGINEER	DATE	
İ	APPROVED AND ACCEPTED:		
		D . TE	
	DISTRICT TRAFFIC ENGINEER	DATE	

AECOM

Gulf Tower 707 Grant Street 5th Floor Pittsburgh, PA 15219



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(NOT FOR CONSTRUCTION)

DESIGNED	<u>LJF</u>	
DRAWN	<u>WLZ</u>	
CHECKED	MSF	
IN CHARGE	<u>LJF</u>	
DATE	05/01/24	
SCALE		
	AS SHOWN	

PORT AUTHORITY OF ALLEGHENY COUNTY PENNSYLVANIA

BUS RAPID TRANSIT UPTOWN TO OAKLAND SIGNAL PLANS WIRING, MOVEMENT, PHASING & SEQUENCE DIAGRAMS

Port Authority

CONTRACT NO. BRT-001 DWG.NO. SG32 sнт. 1092

FIFTH AVENUE AND DINWIDDIE STREET

ITEM NUMBER	MISC	ELLAN	EOUS	
UNIT	DESCRIPTION	QTY.	LOCATION	REMARKS
01882. 002 EACH	TRAFFIC SIGNAL TIMING MODIFICATIONS	2	СС	
02212 . 009 LF	POLE FOUNDATION DRILLING, LESS THAN 30" DIAMETER	13	2 4	
02212• 010 LF	POLE FOUNDATION DRILLING, 30" DIAMETER OR GREATER	24	<u> </u>	
02889. 002 EACH	LED LUMINAIRE CITY STANDARD, BLACK	2	英 英	<u> </u>
02890. 001 EACH	TRAFFIC SIGNAL CONTROLLER ASSEMBLY, TYPE 2070 LC WITH TYPE 332 BASE MOUNTED CABINET	1	СС	332 CONTROLLER CABINET 8" RISER RE-ESTABLISH INTERCONNECT
02890. 003 EACH	ETHERNET SWITCH	1	СС	
02890. 005 EACH	GPS TIME CLOCK	1	СС	
02894. 001 EACH	VEHICULAR SIGNAL HEAD, THREE 12" SECTIONS	4	1234	BLACK TUNNEL VISORS BLACK ALUMINUM HOUSINGS BLACK METAL LOUVERED BACKPLATE
02894. 005 EACH	LED COUNTDOWN PEDESTRIAN SIGNAL HEAD, TYPE A	6	\$67 890	BLACK TUNNEL VISORS BLACK ALUMINUM HOUSINGS
02895. 002 EACH	ACCESSIBLE PEDESTRIAN SIGNALS	6	1123 456	

DETECTORS

ITEM NUMBER	DESCRIPTION	SEN. NO.	QTY.	LOCATION
02895.	VIDEO DETECTION	①	1	<u>\$</u>
02895. 001	VIDEO DETECTION	2	1	\wedge
EACH			·	

TRAFFIC SIGNAL SUPPORTS **

	SER 3ER				NOI		ET								MAS1	T ARM	1							PEI	DESTA	.L
POLE NO.	I TEM NUMBER	DESCRIPTION	QTY,	ROUTE	'ATI	SIDE	OFFSE							ARM	"A"						А	RM "	C "	SHAFT	SIG	NAL
					l s		ō	Н	K		SIG	NAL I	_OCA	TION		SIGN	LOC	OITA	N	w	G	×	z	н	м	N
	UNIT										М	N	0	P	R	S	Т	U	Υ							
\triangle	02892. 210 EACH	TRAFFIC SIGNAL SUPPORT, 36' MAST ARM WITH LUMINAIRE ARM (30' MOUNTING HEIGHT), PAINTED BLACK	1	FIFTH AVE	468+95	RT	23′	17′	10′	36′	32′	24'			28′	20′			5′	90°	6′	30′	225°			
2	02892. 003 EACH	TRAFFIC SIGNAL SUPPORT, 15' TYPE X, PAINTED BLACK	1	FIFTH AVE	468+99	LT	29′																	15′		10′
3	02892. 205 EACH	TRAFFIC SIGNAL SUPPORT, 26' MAST ARM WITH LUMINAIRE ARM (30' MOUNTING HEIGHT), PAINTED BLACK	1	FIFTH AVE	468+40	LT	22′	17′	10′	26′	22′	14′			18′	11′			5′	0°	6′	30′	90°			
4	02892. 003 EACH	TRAFFIC SIGNAL SUPPORT, 15' TYPE X, PAINTED BLACK	1	FIFTH AVE	468+43	RT	23′																	15′		10′

** REFER TO PENNDOT TC-8800 TRAFFIC STANDARDS-SIGNALS FOR LETTER DESIGNATION

Gulf Tower 707 Grant Street 5th Floor Pittsburgh, PA 15219

French Engineering, LLC 3064 Morgantown Rd Smithfield, PA 15478

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U.S. DEPARTMENT OF
TRANSPORTATION, UNDER THE
URBAN MASS TRANSPORTATION ACT
OF 1964, AS AMENDED, FOR THE
NO. DATE
DESCRIPTION
REVISIONS

					TS-260
ESIGNED	<u>LJF</u>	PORT AUTHOR	ITY OF AL	LEGHENY COL	JNTY
RAWN	<u>WLZ</u>	PITTSBURGH		PENNS	SYLVANIA
HECKED	MSF	BUS RAPID TE	RANSIT UPT	OWN TO OAKLA	AND
I CHARGE	<u>LJF</u>		S I GNAL PL		
ATE	05/01/24	TRAF	FIC SIGNAL T	ABULATIONS	
CALE	AS SHOWN	Port Authority	CONTR	ACT NO. BRT-00)1
•	AO ONO WIN	connecting people to life	DWG. NO.	SG33	sнт. 1093

TRENCH, CONDUIT, JUNCTION BOX, ELECTRICAL ITEMS

INCINCIT, CON	,			DOX ,					
DESCRIPTION	ELECTRICAL SERVICE, TYPE C (NEW)	CITY OF PITTSBURGH STANDARD CONCRETE JUNCTION BOX, TYPE 1	TRENCH AND BACKFILL, TYPE II	TRENCH AND BACKFILL, TYPE IV	2 INCH CONDUIT	3 INCH CONDUIT	AWG 8, UNDERCROUND CABLE, COPPER, 1 CONDUCTOR	SIGNAL CABLE, 14 AWG, 5 CONDUCTOR	SIGNAL CABLE, 14 AWG, 7 CONDUCTOR
ITEM NUMBER	02896	02897	02898	02898	02899	02899	02900	02900	02900
TIEM NUMBER	004	001	002	005	002	003	001	002	003
UNIT	EACH	EACH	LF	LF	LF	LF	LF	LF	LF
LOCATION									
CC TO 1		1	18		36	36			
CC TO S1			9			18			
1 то 3		1	22	33	110	110			
2 TO 3		1	22	30	52	104			
то			26		26	52			
<u>∕2</u> TO 2			6			6			
₫ то З			6		12	12			
<u>A</u> TO 1			27			27			
STATION TO 3			42		42				
COMPLETE INTERSECTION	1						450	300	650
TOTAL	1	3	178	63	278	365	450	300	650

S1 - TABULATED ON SYSTEMS PLAN

SIGNS

SYMBOL	SERIES	SIZE	AREA EACH (SQ FT)	DESCRIPTION	QUANTITY	O2891,001 MOUNTED SIGNS, TYPE B	02891,003 MOUNTED SIGNS, TYPE F	OZ891.007 OZ891.007 T STRUCTURE MOUNTED FLAT SHEET ALUMINUM SIGNS WITH STIFFENERS
A	R3-2	24"X24"	4.0	NO LEFT TURN	1	4.0		<u> </u>
		27 727				7.0		
В	R3-2	30"X30"	6.3	NO LEFT TURN	1			6.3
C	R5-1	30"X30"	6.3	DO NOT ENTER	2	6.3	6.3	
0	R6-1	36 "X12 "	3.0	ONE-WAY (TWO SIDED, CITY STANDARD)	2		6.0	
E	R10-3E (MOD)	9 "X15 "	0.9	EDUCATIONAL PUSH BUTTON FOR WALK SIGNAL WITH COUNTDOWN TIMER (MOD)	6		A	
F	D3-4*	60 "X24 "	10.0	1800 Uptown 1700 Fifth Ave	1			10.0
G	D3-4*	72 "X24 "	12.0	Uptown 100 Dinwiddie St	1			12.0
H	R10-11	30 "X36 "	7.5	NO TURN ON RED ●	2			15.0
1	R3-11B(MOD)	30 "X36 "	7.5	RIGHT LANE - BUSES ONLY	1			7.5
0	SS-1	30"X18"	3.8	EXCEPT BUSES	1			3.8
				TOTAL		10.3	12.3	54.6

▲ - INCIDENTAL TO ITEM 02895.002


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NUMBERS AND STREET NAME DETAILS WITH CITY OF PITTSBURGH DEPARTMENT OF
MOBILITY AND INFRASTRUCTURE.

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		URBAN MASS TRANSPORTATION ACT
DATE	DESCRIPTION	OF 1964, AS AMENDED, FOR THE PORT AUTHORITY OF ALLEGHENY COUNTY, PENNSYLVANIA.
	REVISIONS	COUNTY, FERINGTEVANIA.

					TS-	-260
DESIGNED	LJF	PORT AUTHOR	ITY OF AL	LEGHENY COL	JNTY	′
DRAWN	<u>WLZ</u>	PITTSBURGH		PENNS	SYLVANIA	4
CHECKED	MSF	BUS RAPID TE	RANSIT UPT	OWN TO OAKLA	AND	
IN CHARGE	<u>LJF</u>		SIGNAL PL	ANS.		
DATE	<u>05/01/24</u>	TRAF	FIC SIGNAL T	ABULATIONS		
SCALE	AS SHOWN	Port Authority	CONTR	ACT NO. BRT-00)1	
•	AS SHOWN	connecting people to life	DWG. NO.	SG34	SHT.	1094



CONTROLLER ASSEMBLY I MOUNTING ELECTRICAL LEGAL R/W LINE SEE CONSTRUCTION NOTE 10 6 -LEGAL R/W LINE SPEED LIMIT = 25 MPH SERVICE, TYPE B M 4 476 FIFTH AVE SPEED LIMIT = 25 MPH W/8 " FIFTH AVE W. B. ⟨2⟩6′ ×60′ **¤**2 \DFW/4 2-C/3" CL/2" 2-C/3" 3 6 CL/2" 1,370' TO NEXT SIGNAL -LEGAL R/W LANE

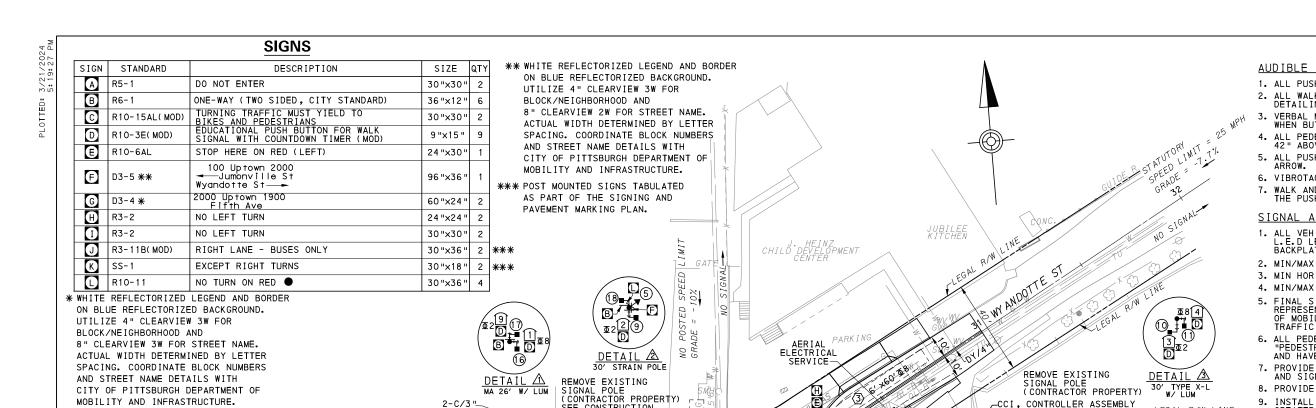2-C/3" CL/2"
2-C/3"S REMOVE EXISTING
CL/2" SIGNAL POLE
(CONTRACTOR PROPERTY) CL/2" → (2) PEDESTRIAN SIGNAL HEAD

JUMONVILL ONE WAY


25

DETAIL

MA 28' W/ LUM

REVISIONS

SIGNAL HEADS

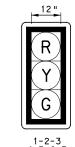

₹ 858' TO NEXT SIGNAL

GRADE = -2.4%

AT DINWIDDIE STREET



COUNTDOWN, LED 18"

HAND/MAN OVERLAY. (FILLED INDICATION W/INCANDESCENT LOOK) 紫田田

SINGLE UNIT

9-10-11-12-13 14-15-16-17-18

40 FEET

DETAIL

20

<u>/\$\</u>

DETAIL 🕰

MA 40' W/ I IIM

(NOT FOR

DESIGNED RAWN WLZ CHECKED MSF N CHARGE LJF DATE 05/01/24 SCALE

AT KIRKPATRICK STREET-

MAST ARM WITH LUMINAIRE

→ ② VEHICULAR/BICYCLE SIGNAL HEAD

Φ2 ☐] ② STOP BAR VIDEO DETECTION

→ ② AUDIBLE PEDESTRIAN PUSH BUTTON/SIGN

CL/2" LIGHTING CONDUIT/SIZE

C/2"P POWER CONDUIT/SIZE

CONTROLLER ASSEMBLY

STOP BAR VIDEO DETECTOR

SOLID WHITE LINE/WIDTH

DEW/8" DOTTED EXTENSION WHITE LINE/WIDTH

DOUBLE SOLID YELLOW LINE/WIDTH

G/24" SOLID GREEN LINE/WIDTH

LEGEND

/ PEDESTAL

☐ 2 JUNCTION BOX

C/2" CONDUIT/SIZE

⊥, • A SIGN

AUDIBLE PEDESTRIAN SIGNAL NOTES

- 1. ALL PUSH BUTTONS SHALL BE EQUIPPED WITH LOCATOR TONES.
- 2. ALL WALK INTERVALS TO HAVE VERBAL MESSAGE DETAILING WALK DIRECTION.
- VERBAL MESSAGE TO BE PLAYED DURING WALK INTERVAL WHEN BUTTON IS PRESSED.
- 4. ALL PEDESTRIAN PUSH BUTTONS TO BE LOCATED AT
- 5. ALL PUSH BUTTONS TO BE EQUIPPED WITH VIBROTACTILE ARROW.
- 6. VIBROTACTILE ARROWS TO VIBRATE DURING WALK INTERVAL.
- 7. WALK AND DON'T WALK MESSAGE SHALL BE AUDIBLE THOUGH THE PUSH BUTTON SPEAKER.

SIGNAL ASSEMBLY NOTES

- 1. ALL VEHICULAR/BICYCLE SIGNALS SHALL BE EQUIPPED WITH L.E.D LENSES, TUNNEL VISORS AND LOUVERED BLACK METAL BACKPLATES WITH 2" REFLECTIVE BORDERS.
- 2. MIN/MAX HEIGHT TO BOTTOM OF VEHICULAR SIGNALS 17'/18'.
- 3. MIN HORIZONTAL SPACING FOR VEHICULAR SIGNALS IS 8'.
- 4. MIN/MAX HEIGHT TO BOTTOM OF PEDESTRIAN SIGNALS 10'/12'
- 5. FINAL SIGNAL HEAD PLACEMENT WILL BE DETERMINED BY REPRESENTATIVES OF THE CITY OF PITTSBURGH DEPARTMENT OF MOBILITY AND INFRASTRUCTURE AND THE DISTRICT TRAFFIC UNIT PRIOR TO SIGNAL BEING TURNED ON.
- 6. ALL PEDESTRIAN SIGNALS SHALL BE PORTLAND ORANGE FULL "PEDESTRIAN HAND" AND WHITE "WALKING PERSON" SYMBOLS AND HAVE INCANDESCENT LOOK WITH COUNTDOWN TIMER.
- 7. PROVIDE AIRCRAFT STRANDED CABLE FOR MOUNTING SIGNAL AND SIGN BRACKET ASSEMBLIES TO MAST ARMS.
- 8. PROVIDE BLACK ALUMINUM HOUSINGS FOR ALL SIGNAL HEADS.
- 9. INSTALL POST MOUNTED SIGNAL HEADS WITH BOTTOMS NO GREATER THAN 15' ABOVE THE SIDEWALK OR PAVEMENT.
- EXACT LOCATION OF TRAFFIC SIGNAL SUPPORTS SHALL BE DETERMINED BY REPRESENTATIVES OF THE CITY OF PITTSBURGH DEPARTMENT OF MOBILITY AND INFRASTRUCTURE AND THE DISTRICT TRAFFIC UNIT PRIOR TO INSTALLATION.

PAVEMENT MARKING NOTES

- 1. ALL STOP BARS ARE W/24".
- 2. CROSSWALKS ARE 10'X 24" KEYS WITH 3' TO 5' SPACING.
- 3. CROSSWALKS ACROSS BICYCLE LANES ARE 6'X 12" KEYS WITH 1' SPACING.

C/3"S SYSTEM CONDUIT/SIZE

■ S1 SYSTEM JUNCTION BOX

L1★ ↑ PEDESTAL WITH LUMINAIRE

TS-554

DATE

PENNSYLVANIA

COUNTY: ALLEGHENY MUNICIPALITY: CITY OF PITTSBURGH INTERSECTION: FIFTH AVENUE AND JUMONVILLE STREET AND WYANDOTTE STREET APPROVED AND ACCEPTED:

CITY TRAFFIC ENGINEER APPROVED AND ACCEPTED:

DISTRICT TRAFFIC ENGINEER

DATE PORT AUTHORITY OF ALLEGHENY COUNTY

BUS RAPID TRANSIT UPTOWN TO OAKLAND SIGNAL PLANS

FIFTH AVENUE & JUMONVILLE STREET/WYANDOTTE ST

707 Grant Street 5th Floor Pittsburgh, PA 15219

AECOM



DATE

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CONSTRUCTION

DY/4"

AS SHOWN

Port Authority


PITTSBURGH

CONTRACT NO. BRT-001 SG35 DWG NO sнт. 1095

		PHASE 2					PH	IASE	8			PH	IASE	9			
	BUS BIKE				-			'H-	BUS BIKE	E HB1					HLANTIZG FLANTIZG		
	INTERVALS					INT	ERV	ALS			INT	ERV	ALS		Ϋ́		
SIGNAL	1	2	3	4	5	1	2	3	4	5	1	2	3	4	5		
1-2	G	G	Υ	R		R	R	R	R	R	R	R	R	R		R	
3-4-5	R	R	R	R		R	G	G	Υ	R	R	R	R	R		R	
6-7	R	R	R	R		R	R	R	R	R	G	G	Υ	R		R	
8	G	G	Υ	R		R	R	R	R	R	R	R	R	R		R	
9-10	W	FD	DW	DW		DW	DW	DW	DW	DW	DW	DW	DW	DW		0FF	
11-12	DW	DW	DW	DW		W	W	FD	DW	DW	DW	DW	DW	DW		0FF	
13-14	W	FD	DW	DW		DW	DW	DW	DW	DW	DW	DW	DW	DW		OFF	
15-16	DW	DW	DW	DW		W	W	FD	DW	DW	DW	DW	DW	DW		0FF	
17-18	W	FD	DW	DW		DW	DW	DW	DW	DW	DW	DW	DW	DW		OFF	
		L,										L,					
FIXED	\geq	\leq	3	4		\sim	$\geq \leq$	\leq	4	3	\geq	\leq	5	2			
MINIMUM	3	-						0				5					
PASSAGE	,	3						3				3					
FREE (MAX)	5	8					1	7			8	3					
PEDESTRIAN	7	23				3	4	10									
MEMORY		PED	REC	CALL		PED-RECALL				ı	NON-	NON-LOCK ING					

DETECTOR ZONE INFORMATION

DETECTOR	DETECTION	MODE	TYPE	ROUTE	PHASE	LOCATION
DETECTOR	ZONE(S)	MODE	111 2	ROSTE		MAST ARM
0	1 2 (6' x60')	PRESENCE	VIDEO (STOP BAR)	FIFTH AVENUE	2	\triangle
0	③ (6′×60′)	PRESENCE	VIDEO (STOP BAR)	WYANDOTTE STREET	8	<u> </u>
(3)	⟨ 4 ⟩ (6′ ×30′)	PRESENCE	VIDEO (STOP BAR)	DRIVEWAY	9	<u></u>

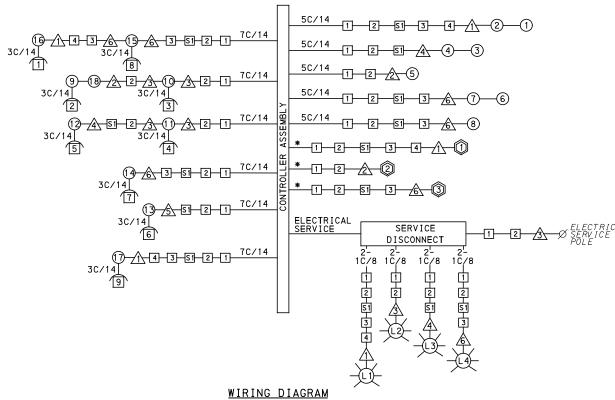

TRANSIT PRIORITY PRE-EMPTION NOTES (TO BE INSTALLED BY OTHERS)

- COORDINATE TRAFFIC CONTROLLER PROGRAMMING MODIFICATION WITH REPRESENTATIVES OF THE CITY OF PITTSBURGH AND DISTRICT TRAFFIC UNIT.
- 2. INCLUDE A TRANSIT PRIORITY PHASE THAT WILL EXTEND THE INDICATED PHASE A MAXIMUM OF 10 SECONDS WHEN ACTIVATED BY A PORT AUTHORITY VEHICLE. DO NOT VIOLATE SIDE STREET PEDESTRIAN MINIMUM TIMINGS.
- 3. MAINTAIN ALL YELLOW CLEARANCES AT ALL TIMES.
- 4. PROCEED TO THE SUBSEQUENT INTERVAL AS DEFINED IN THE MOVEMENT, SEQUENCE AND TIMING DIAGRAM UPON COMPLETING THE GREEN EXTENSION INTERVAL.
- 5. ONCE A TRANSIT CALL IS PLACED AND SATISFIED, THE CONTROLLER WILL NOT SATISFY ANOTHER CALL FOR
- 6. LOCATION OF BUS DETECTORS ARE TO BE FIELD ADJUSTED TO ACHIEVE MAXIMUM OPERATION.

5C/14 - CABLE (NO. OF CONDUCTORS/SIZE AWG.)

0 PROPOSED DETECTOR (1) PROPOSED SIGNAL HEAD PROPOSED AUDIBLE

A PROPOSED SIGNAL SUPPORT PEDESTRIAN INDICATOR - PROPOSED LUMINAIRE 1 PROPOSED JUNCTION BOX

1 PROPOSED SYSTEM JUNCTION BOX

3C/14 INCIDENTAL TO ITEM 02895.002

*INCIDENTAL TO ITEM 02895.001, AS PER MANUFACTURERS SPECIFICATIONS

GENERAL NOTES

THE CITY OF PITTSBURGH SHALL INSPECT THE NEW SIGNAL EQUIPMENT PRIOR TO ACTIVATION.

ALL TRAFFIC SIGNAL MAINTENANCE AND OPERATION RESPONSIBILITIES SHALL BE TURNED OVER TO THE CITY OF PITTSBURGH AFTER THE FOLLOWING CONDITIONS ARE IMPLEMENTED TO THE CITY'S SATISFACTION:

- 1. PERMIT "AS-BUILT" TRAFFIC SIGNAL DRAWINGS ARE SUBMITTED AND APPROVED.
- 2. ALL PUNCH LIST ITEMS ARE COMPLETED BY THE CONTRACTOR.
- 3. AFTER THE 30-DAY CONTINUOUS UNINTERRUPTED SIGNAL OPERATION WITHOUT MALFUNCTIONS.

CONSTRUCTION NOTES

- 1. ALL JUNCTION BOXES IN WALK AREAS TO BE CITY OF PITTSBURGH STANDARD CONCRETE JUNCTION BOX, TYPE 1.
- 2. ALL JUNCTION BOXES IN NON-WALK AREAS TO BE CITY STANDARD JB-2 WITH BOTTOM.
- 3. THERE SHALL BE NO SIGNAL WIRE OR FIBER CABLE SPLICING.
- 4. SERVICE WIRE FROM THE POWER SOURCE TO THE CONTROLLER CABINET SHALL BE PLACED IN SECONDARY SEPARATE CONDUIT.
- 5. STREET LIGHT CABLE IS NOT PERMITTED TO RUN THROUGH THE CONTROLLER CABINET AND SHALL BE PLACED IN SEPARATE CONDUIT.
- 6. TRAFFIC SIGNAL CABLE SHALL BE PLACED IN DEDICATED CONDUIT.
- 7. MOUNT DISCONNECT ON POLE NEAREST TO THE CONTROLLER CABINET EXCLUDING TYPE X POLES.
- 8. REMOVE AND DISPOSE OF ALL EXISTING SIGNAL WIRING NO LONGER IN USE.
- 9. REMOVE EXISTING SIGNAL EQUIPMENT NO LONGER IN USE AND RETURN TO THE CITY OF PITTSBURGH TRAFFIC CONTROL SHOP. COORDINATE DELIVERY OF EQUIPMENT WITH DELMAS MCELHANY, TRAFFIC CONTROL FOREMAN.
- 10. SEE 01720 UTILITY COORDINATION FOR INFORMATION ON RELOCATION OF EXISTING SECURITY CAMERAS AND SHOT

TS-554

COUNTY: ALLEGHENY
MUNICIPALITY: CITY OF PITTSBURGH
INTERSECTION: FIFTH AVENUE AND
JUMONVILLE STREET AND
WYANDOTTE STREET
APPROVED AND ACCEPTED:
CITY TRAFFIC ENGINEER DATE
APPROVED AND ACCEPTED:
DISTRICT TRAFFIC ENGINEER DATE

AECOM

Gulf Tower 707 Grant Street 5th Floor Pittsburgh, PA 15219



THE PREPARATION OF THIS DOCUMENT HAS BEEN FINANCED IN PART THROUGH A GRANT FROM THE FEDERAL TRANSIT ADMINISTRATION U.S. DEPARTMENT OF TRANSPORTATION, UNDER THE URBAN MASS TRANSPORTATION ACT OF 1964 AS AMENDED FOR THE NO. DATE DESCRIPTION COUNTY, PENNSYLVANIA. REVISIONS

(NOT FOR CONSTRUCTION)

ESIGNED	<u>LJF</u>	
RAWN	<u>WLZ</u>	
HECKED	MSF	
N CHARGE	<u>LJF</u>	
ATE	05/01/24	
CALE		
	AS SHOWN	

PORT AUTHORITY OF ALLEGHENY COUNTY

BUS RAPID TRANSIT UPTOWN TO OAKLAND SIGNAL PLANS WIRING, MOVEMENT, PHASING & SEQUENCE DIAGRAMS

CONTRACT NO. BRT-001 **Port Authority** SG36 DWG NO sнт. 1096

FIFTH AVENUE AND JUMONVILLE STREET AND WYANDOTTE STREET

DETECTORS

ITEM NUMBER	DESCRIPTION	SEN. NO.	QTY.	LOCATION
02895 . 001	VIDEO DETECTION	①	1	\rightarrow
EACH		_		
02895 . 001	VIDEO DETECTION	2	1	2
EACH		_		
02895 . 001	VIDEO DETECTION	3	1	<u>√6</u>
EACH				

ITEM NUMBER	MISCELL	.ANEO	US	
UNIT	DESCRIPTION	QTY.	LOCATION	REMARKS
01882. 002 EACH	TRAFFIC SIGNAL TIMING MODIFICATIONS	2	СС	
02212. 009 LF	POLE FOUNDATION DRILLING, LESS THAN 30" DIAMETER	15	<u>/</u> 3\/5\	
02212. 010 LF	POLE FOUNDATION DRILLING, 30" DIAMETER OR GREATER	48	1 2 4 6	
02889. 002 EACH	LED LUMINAIRE CITY STANDARD, BLACK	4	\ \\ \\ \\ \\ \\ \\ \\ \\ \\ \\ \\ \\ \	<u> </u>
02890. 001 EACH	TRAFFIC SIGNAL CONTROLLER ASSEMBLY, TYPE 2070 LC WITH TYPE 332 BASE MOUNTED CABINET	1	cc	332 CONTROLLER CABINET 8" RISER RE-ESTABLISH INTERCONNECT
02890. 003 EACH	ETHERNET SWITCH	1	сс	THE CONTROL OF THE CO
02890. 005 EACH	GPS TIME CLOCK	1	СС	
02894. 001 EACH	VEHICULAR SIGNAL HEAD, THREE 12" SECTIONS	7	123 4567	BLACK TUNNEL VISORS BLACK ALUMINUM HOUSINGS BLACK METAL LOUVERED BACKPLATE
02894. 005 EACH	LED COUNTDOWN PEDESTRIAN SIGNAL HEAD, TYPE A	10	90000 19060	BLACK TUNNEL VISORS BLACK ALUMINUM HOUSINGS
02894. 006 EACH	VEHICULAR SIGNAL HEAD, THREE 8 " SECTIONS	1	8	BLACK TUNNEL VISORS BLACK ALUMINUM HOUSINGS BLACK METAL LOUVERED BACKPLATE
02895. 002 EACH	ACCESSIBLE PEDESTRIAN SIGNALS	9	11234 56789	

TRAFFIC SIGNAL SUPPORTS **

	× α α		DESCRIPTION E ROUTE I GI									MAST	ARM	l							PEC	EST#	'L			
POLE NO.	1TEM NUMBER	DESCRIPTION	QTY.	ROUTE	TATIO	SIDE	FS							ARM	"A"						Af	RM "(2"	SHAFT	SIG	NAL
					S			Н	K	L	SIG	NAL I	OCA	TION		SIGN	LOCA	10174		w	G	х	z	н	м	N
	UNIT										М	N	0	Р	R	S	T	U	Y							
\triangle	02892. 205 EACH	TRAFFIC SIGNAL SUPPORT, 26' MAST ARM WITH LUMINAIRE ARM (30' MOUNTING HEIGHT), PAINTED BLACK	1	FIFTH AVE	477+05	LT	17′	17′	10′	26′	23′	14′			19′	11'				0°	6′	30′	0°			
2	02892. 011 EACH	TRAFFIC SIGNAL SUPPORT, STRAIN POLE, 2,000 POUNDS DESIGN TENSION, PAINTED BLACK	1	FIFTH AVE	477+65	LT	20′																	30′	12′	10′
3	02892. 005 EACH	TRAFFIC SIGNAL SUPPORT, 30' TYPE X-L WITH LUMINAIRE ARM, PAINTED BLACK	1	FIFTH AVE	478+14	LT	20′														6′	30′	0°	30′		10′
4	02892. 213 EACH	TRAFFIC SIGNAL SUPPORT, 40' MAST ARM WITH LUMINAIRE ARM (30' MOUNTING HEIGHT), PAINTED BLACK	1	FIFTH AVE	478+15	RŤ	22′	17′	10′	40′	36′	28′			32′	24′			17′	88°	6′	30′	180°			
<u>\(\frac{1}{5} \)</u>	02892. 003 EACH	TRAFFIC SIGNAL SUPPORT, 15' TYPE X, PAINTED BLACK	1	FIFTH AVE	477+57	RT	29′																	15′		10′
<u> </u>	02892. 206 EACH	TRAFFIC SIGNAL SUPPORT, 28' MAST ARM WITH LUMINAIRE ARM (30' MOUNTING HEIGHT), PAINTED BLACK	1	FIFTH AVE	477+15	RT	28′	17′	10′	28′	21′	11′			18′	14′			4′	270′	6′	30′	90°			

** REFER TO PENNDOT TC-8800 TRAFFIC STANDARDS-SIGNALS FOR LETTER DESIGNATION

Gulf Tower
707 Grant Street
5th Floor
Pittsburgh, PA 15219



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DOCUMENT HAS BEEN FINANCED IN
PART THROUGH A GRANT FROM THE
FEDERAL TRANSIT ADMINISTRATION,
U.S. DEPARTMENT OF
TRANSPORTATION, UNDER THE
URBAN MASS TRANSPORTATION ACT
OF 1964, AS AMENDED, FOR THE
TE DESCRIPTION
REVISIONS
THE PORT AUTHORITY OF ALLEGHENY
COUNTY, PENNSYLVANIA.

(NOT FOR CONSTRUCTION)

					15	-554
DESIGNED	LJF	PORT AUTHOR	ITY OF AL	LEGHENY CO	UNT	Υ
DRAWN	WLZ	PITTSBURGH		PENN	SYLVAN	IA
CHECKED	MSF	BUS RAPID TF	RANSIT UPT	OWN TO OAKL	AND	
IN CHARGE	<u>LJF</u>		SIGNAL PL	_ANS		
DATE	05/01/24	TRAF	FIC SIGNAL T	ABULATIONS		
SCALE	AS SHOWN	Port Authority	CONTR	RACT NO. BRT-0	01	
	AO OI IOWIN	connecting people to life	DWG. NO.	SG37	SHT.	1097

FIFTH AVENUE AND JUMONVILLE STREET AND WYANDOTTE STREET

TRENCH, CONDUIT, JUNCTION BOX, ELECTRICAL ITEMS

DESCRIPTION	ELECTRICAL SERVICE, TYPE B	CITY OF PITTSBURGH STANDARD CONCRETE JUNCTION BOX, TYPE 1	TRENCH AND BACKFILL, TYPE II	TRENCH AND BACKFILL, TYPE IV	2 INCH CONDUIT	3 INCH CONDUIT	AWG 8, UNDERGROUND CABLE, COPPER, 1 CONDUCTOR	SIGNAL CABLE, 14 AWG, 5 CONDUCTOR	SIGNAL CABLE, 14 AWG, 7 CONDUCTOR
ITEM NUMBER	02896	02897	02898	02898	02899	02899	02900	02900	02900
	002	001	002	005	002	003	001	002	003
UNIT	EACH	EACH	LF	LF	LF	LF	LF	LF	LF
LOCATION									
сс то 1		1	5		10	20			
1 TO 2		1	18		36	72			
S1 T0 2			22	28	50	200			
S1 T0 3		1	52	26	78	156			
4 TO 3		1	20	21	41	82			
<u></u> ↑ 10 4			5		5	10			
<u>∕2</u> то 2			17	30	47	94			
<u>∕</u> 3 то 2			8		16	16			
<u></u> ₹ ₹ ₹ ₹ ₹ ₹ ₹ ₹ ₹ ₹ ₹ ₹ ₹ ₹ ₹ ₹ ₹ ₹ ₹			37		37	74			
<u>√</u> \$ TO [51]			26			26			
€ то З			12		12	24			
COMPLETE INTERSECTION	1								
TOTAL	1	4	222	79	332	774	1455	1400	975

^{*} TYPE IV TRENCH TABULATED AS PART OF THE SYSTEMS PLAN.

SIGNS

SYMBOL	SERIES	SIZE	AREA EACH (SQ FT)	DESCRIPTION	QUANTITY	O2891,001 MOUNTED SIGNS, TYPE B	O2891,003 MOUNTED SIGNS, TYPE F	STRUCTURE MOUNTED FLAT SHEET ALUMINUM SIGNS WITH STIFFENERS
A	R5-1	30"X30"	6.3	DO NOT ENTER	2	12.6	31	31
B	R6-1	36 "X12 "	3.0	ONE-WAY (TWO SIDED, CITY STANDARD)	6		18.0	
0	R10-15AL(MOD)	30"X30"	6.3	TURNING TRAFFIC MUST YIELD TO BIKES AND PEDESTRIANS	2		6.3	6.3
0	R10-3E (MOD)	9 "X15 "	0.9	EDUCATIONAL PUSH BUTTON FOR WALK SIGNAL WITH COUNTDOWN TIMER (MOD)	9		A	
₿	R10-6AL	24"×30"	5.0	STOP HERE ON RED (LEFT)	1	5.0		
F	D3-5 **	96"×36"	24.0	100 Uptown 2000 Jumonville St Wyandotte St	1			24.0
©	D3-4 *	60"×24"	10.0	2000 Uptown 1900 Fifth Ave	2			20.0
(H)	R3-2	24"×24"	4.0	NO LEFT TURN	2		8.0	
1	R3-2	30"×30"	6.3	NO LEFT TURN	2			12.6
O	R10-11	30"×36"	7.5	NO TURN ON RED ●	4		7.5	22.5
				TOTAL		17.6	39.8	85.4
-						-		

▲ - INCIDENTAL TO ITEM 02895.002

- * WHITE REFLECTORIZED LEGEND AND BORDER ON BLUE REFLECTORIZED BACKGROUND.
 UTILIZE 4" CLEARVIEW 3W FOR BLOCK/NEIGHBORHOOD AND 8" CLEARVIEW 3W FOR
 STREET NAME. ACTUAL WIDTH DETERMINED BY LETTER SPACING. COORDINATE BLOCK
 NUMBERS AND STREET NAME DETAILS WITH CITY OF PITTSBURGH DEPARTMENT OF
 MOBILITY AND INFRASTRUCTURE.
- ** WHITE REFLECTORIZED LEGEND AND BORDER ON BLUE REFLECTORIZED BACKGROUND.
 UTILIZE 4" CLEARVIEW 3W FOR BLOCK/NEIGHBORHOOD AND 8" CLEARVIEW 2W FOR
 STREET NAME. ACTUAL WIDTH DETERMINED BY LETTER SPACING. COORDINATE BLOCK
 NUMBERS AND STREET NAME DETAILS WITH CITY OF PITTSBURGH DEPARTMENT OF
 MOBILITY AND INFRASTRUCTURE.

AECOM 707 Grant Street

5th Floor

Pittsburgh, PA 15219



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TE	DESCRIPTION	PORT AUTHORITY OF ALLEGHENY COUNTY, PENNSYLVANIA.
	REVISIONS	COUNTY, PENINSTEVANIA.

(NOT FOR CONSTRUCTION)

DESIGNED	<u>LJF</u>	PORT AL
DRAWN	<u>WLZ</u>	PITTSBURGH
CHECKED	MSF	BUS RA
IN CHARGE	<u>LJF</u>	
DATE	<u>05/01/24</u>	
SCALE	AS SHOWN	Port Auth


TS-554 AUTHORITY OF ALLEGHENY COUNTY RAPID TRANSIT UPTOWN TO OAKLAND SIGNAL PLANS TRAFFIC SIGNAL TABULATIONS CONTRACT NO. BRT-001

Authority connecting people to life

DWG. NO. SG38

sнт. 1098

S1 - TABULATED ON SYSTEMS PLAN

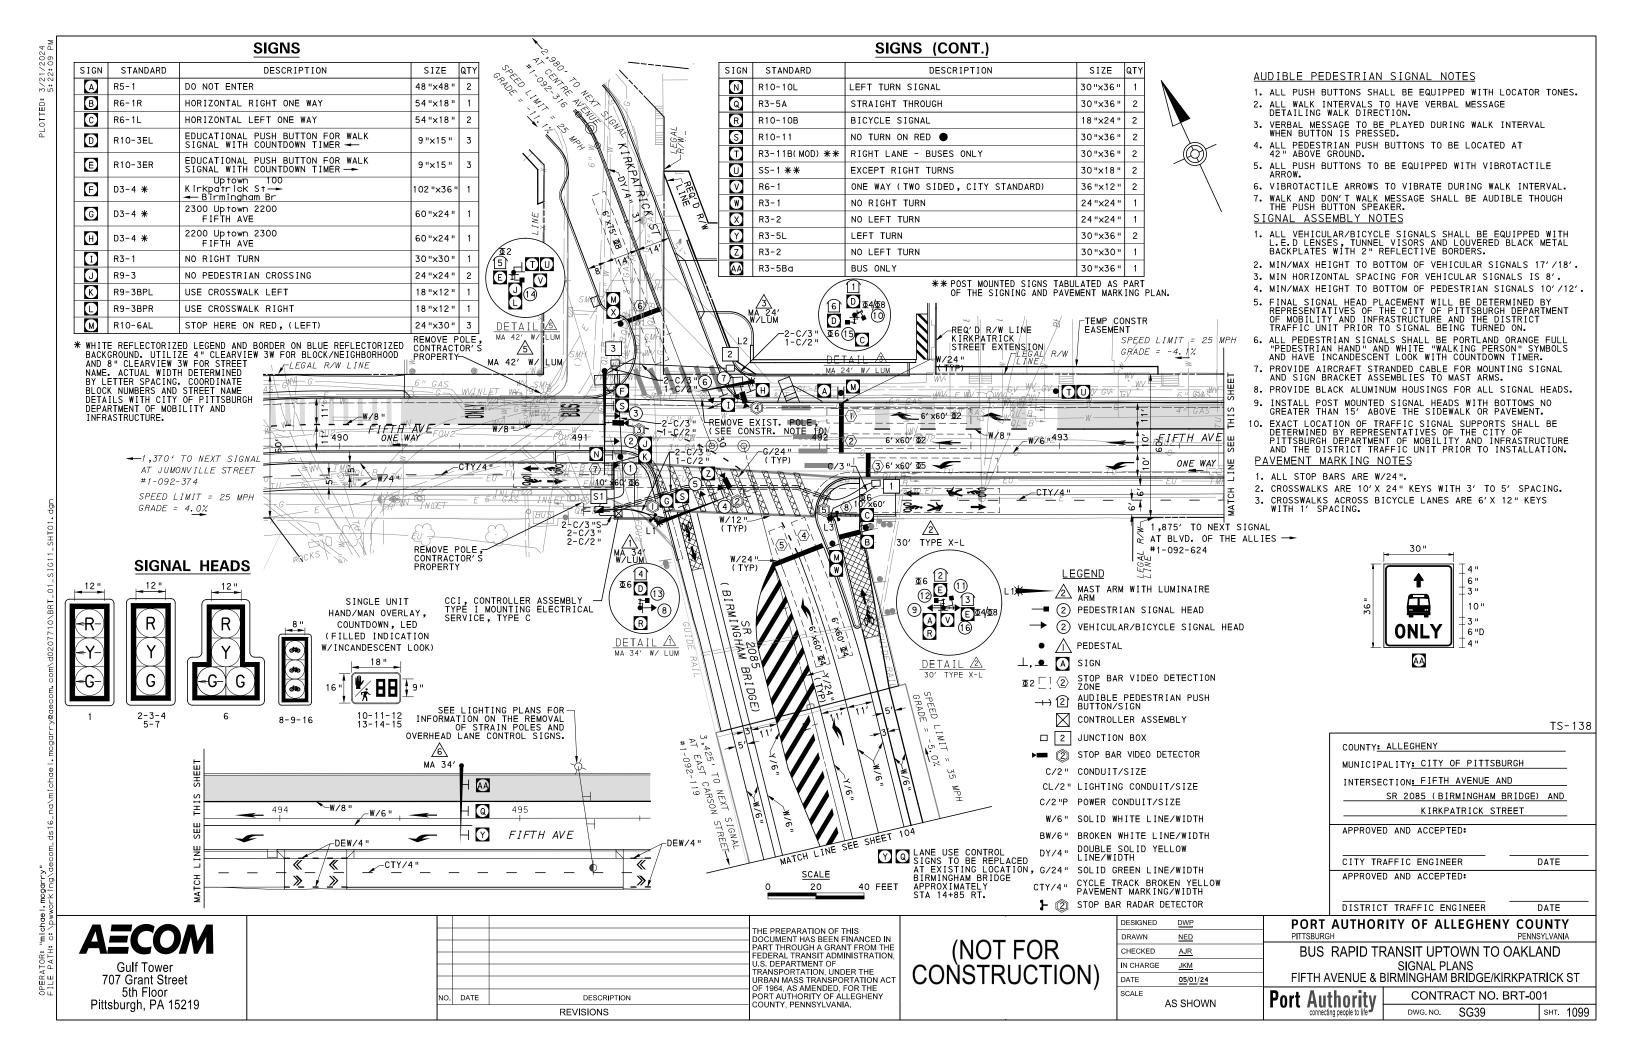


		MOVEMENT & THAST									THO AND SEQUENCE CHART										
		PHASE 2+6					PHA	\SE	2+5			PH	IASE	8			PH	IASE	4		
	- В І <u>К</u>	E		$\overline{}$	US IKE	- В I К Е	BUS				BIK	E⊢) 	¦Ε	IUS IKE	-BIKE	⊥ †	//	; E	BUS BIKE	HLANHING HLA
		INT	ERV	ALS			INTERVALS					INTERVALS IN						ERV	ALS		Ϋ́
SIGNAL	1	2	3	4	-	1	2	3	4	-	1	2	3	4	-	1	2	3	4	-	
1	R	R	R	R		- G-	- G-	- Y-	R		R	R	R	R		R	R	R	R		R
2-3	G	G	Υ	R		G	G	Υ	R		R	R	R	R		R	R	R	R		R
4-5	R	R	R	R		R	R	R	R		G	Υ	R	R		R	R	R	R		R
6	R	R	R	R		R	R	R	R		R	R	R	R		- G⁄G	С	Υ	R		R
7	R	R	R	R		R	R	R	R		R	R	R	R		G	G	Υ	R		R
8-9	G	G	Υ	R		R	R	R	R		R	R	R	R		R	R	R	R		R
10-11	DW	DW	DW	DW		DW	DW	DW	DW		W	FD [©]	DW	DW [®]		W	FD	DW	DW		0FF
12-13	W	FD	DW	DW		DW	DW	DW	DW		DW	DW	DW	DW		DW	DW	DW	DW		0FF
14-15	W	W	W	W		W	FD	DW	DW		DW	DW	DW	DW		DW	DW	DW	DW		0FF
16	G	G	Υ	R		R	R	R	R		R	R	R	R		R	R	R	R		R
FIXED		\succeq	3	6		\geq	\geq	4	3		\supset	5	3			\geq	\leq	5	2		
MINIMUM	!	5				1	2				10					1	0				
PASSAGE	:	3				;	3				3					3	3				
FREE (MAX)	2	9				5	2				30					3	8				
PEDESTRIAN *	7	22				7	22									7	11				
MEMORY			1 00	K I Nic	<u> </u>	MIN RECALL				<u> </u>	NON	1.00	OCKING NON LOCKING					\vdash			
MEMORI		INOIN	LOCKING MIN R			NEC	MLL		<u> </u>	NON	LUC	IN I ING		<u>'</u>	1011	LUC	1/11/1	,	\Box		

* UPON PEDESTRIAN ACTUATION ONLY, OTHERWISE DON'T WALK AT ALL TIMES

W IF FOLLOWED BY 4

TRANSIT PRIORITY PRE-EMPTION NOTES (TO BE INSTALLED BY OTHERS)

- COORDINATE TRAFFIC CONTROLLER PROGRAMMING MODIFICATION WITH REPRESENTATIVES OF THE CITY OF PITTSBURGH AND DISTRICT TRAFFIC UNIT.
- 2. INCLUDE A TRANSIT PRIORITY PHASE THAT WILL EXTEND THE INDICATED PHASE A MAXIMUM OF 10 SECONDS WHEN ACTIVATED BY A PORT AUTHORITY VEHICLE. DO NOT VIOLATE SIDE STREET PEDESTRIAN MINIMUM TIMINGS.
- 3. MAINTAIN ALL YELLOW CLEARANCES AT ALL TIMES.
- 4. PROCEED TO THE SUBSEQUENT INTERVAL AS DEFINED IN THE MOVEMENT, SEQUENCE AND TIMING DIAGRAM UPON COMPLETING THE GREEN EXTENSION INTERVAL.
- 5. ONCE A TRANSIT CALL IS PLACED AND SATISFIED, THE CONTROLLER WILL NOT SATISFY ANOTHER CALL FOR
- 6. LOCATION OF BUS DETECTORS ARE TO BE FIELD ADJUSTED TO ACHIEVE MAXIMUM OPERATION.

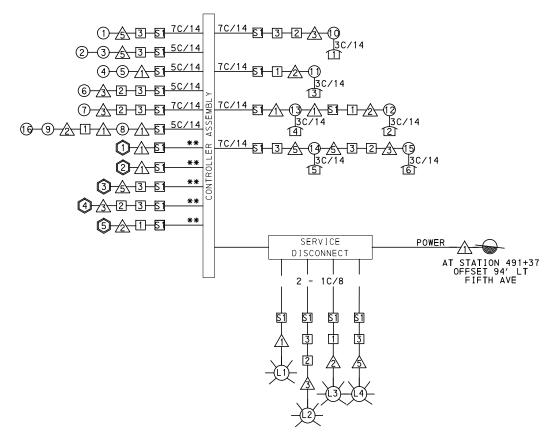

WIRING DIAGRAM

5C/14 - CABLE (NO. OF CONDUCTORS/SIZE AWG.)

- 1 EXISTING SIGNAL HEAD
- 1) PROPOSED SIGNAL HEAD

-L1- PROPOSED LUMINAIRE

- EXISTING AUDIBLE PEDESTRIAN INDICATOR
- PROPOSED AUDIBLE PEDESTRIAN INDICATOR PROPOSED SIGNAL SUPPORT
- EXISTING SIGNAL SUPPORT 1 EXISTING JUNCTION BOX
 - 1 PROPOSED JUNCTION BOX



- PROPOSED DETECTOR
- ** INCIDENTAL TO ITEM 02895.001, AS PER MANUFACTURERS SPECIFICATIONS

3C/14 INCIDENTAL TO ITEM 02895.002

DETECTOR ZONE INFORMATION

DETECTOR	DETECTION ZONE(S)	MODE	TYPE	ROUTE	PHASE	LOCATION MAST ARM
①	⟨7⟩ (10′×60′)	PRESENCE	RADAR (STOP BAR)	5TH AVENUE	6	\triangle
2	(6) (6' ×75')	PRESENCE	VIDEO (STOP BAR)	KIRKPATRICK STREET	8	\triangle
3	(1\(\)2\(\) (6'\(\)x60')	PRESENCE	VIDEO (STOP BAR)	5TH AVENUE	2	<u> </u>
	③ (6′×60′)	PRESENCE	VIDEO (STOP BAR)	5TH AVENUE	5	737
4	4\5\ (6' x60')	PRESENCE	VIDEO (STOP BAR)	BIRMINGHAM BRIDGE	4	<u> </u>
(5)	8 (10′x60′)	PRESENCE	RADAR (STOP BAR)	5TH AVENUE	6	2

GENERAL NOTES

THE CITY OF PITTSBURGH SHALL INSPECT THE NEW SIGNAL EQUIPMENT PRIOR TO ACTIVATION.

ALL TRAFFIC SIGNAL MAINTENANCE AND OPERATION RESPONSIBILITIES SHALL BE TURNED OVER TO THE CITY OF PITTSBURGH AFTER THE FOLLOWING CONDITIONS ARE IMPLEMENTED TO THE CITY'S SATISFACTION:

- 1. PERMIT "AS-BUILT" TRAFFIC SIGNAL DRAWINGS ARE SUBMITTED AND APPROVED.
- 2. ALL PUNCH LIST ITEMS ARE COMPLETED BY THE
- 3. AFTER THE 30-DAY CONTINUOUS UNINTERRUPTED SIGNAL OPERATION WITHOUT MALFUNCTIONS.

CONSTRUCTION NOTES

- 1. ALL JUNCTION BOXES IN WALK AREAS TO BE CITY OF PITTSBURGH STANDARD CONCRETE JUNCTION BOX, TYPE 1.
- 2. ALL JUNCTION BOXES IN NON-WALK AREAS TO BE CITY STANDARD JB-2 WITH BOTTOM.
- 3. THERE SHALL BE NO SIGNAL WIRE OR FIBER CABLE SPLICING.
- 4. SERVICE WIRE FROM THE POWER SOURCE TO THE CONTROLLER CABINET SHALL BE PLACED IN SECONDARY SEPARATE CONDUIT.
- 5. STREET LIGHT CABLE IS NOT PERMITTED TO RUN THROUGH THE CONTROLLER CABINET AND SHALL BE PLACED IN SEPARATE CONDUIT.
- 6. TRAFFIC SIGNAL CABLE SHALL BE PLACED IN DEDICATED
- 7. MOUNT DISCONNECT ON POLE NEAREST TO THE CONTROLLER CABINET EXCLUDING TYPE X POLES.
- 8. REMOVE AND DISPOSE OF ALL EXISTING SIGNAL WIRING NO
- 9. REMOVE EXISTING SIGNAL EQUIPMENT NO LONGER IN USE AND RETURN TO THE CITY OF PITTSBURGH TRAFFIC CONTROL SHOP. COORDINATE DELIVERY OF EQUIPMENT WITH DELMAS MCELHANY, TRAFFIC CONTROL FOREMAN.
- 10. SEE 01720 UTILITY COORDINATION FOR INFORMATION ON RELOCATION OF EXISTING SECURITY CAMERAS AND SHOT SPOTTERS. REMOVE THIS POLE, CONTRACTOR'S PROPERTY.

COUNTY: ALLEGHENY

MUNICIPALITY: CITY OF PITTSBURGH

INTERSECTION: FIFTH AVENUE AND

SR 2085 (BIRMINGHAM BRIDGE) AND

KIRKPATRICK STREET

TS-138

DATE

DATE

APPROVED AND ACCEPTED:

CITY TRAFFIC ENGINEER APPROVED AND ACCEPTED:

DISTRICT TRAFFIC ENGINEER

PORT AUTHORITY OF ALLEGHENY COUNTY

BUS RAPID TRANSIT UPTOWN TO OAKLAND SIGNAL PLANS WIRING, MOVEMENT, PHASING & SEQUENCE DIAGRAMS

Port Authority

CONTRACT NO. BRT-001 DWG.NO. SG40 sнт. 1100

THE PREPARATION OF THIS DOCUMENT HAS BEEN FINANCED IN PART THROUGH A GRANT FROM THE FEDERAL TRANSIT ADMINISTRATION

U.S. DEPARTMENT OF TRANSPORTATION, UNDER THE URBAN MASS TRANSPORTATION ACT OF 1964 AS AMENDED FOR THE

AECOM 707 Grant Street 5th Floor

Pittsburgh, PA 15219

NO. DATE DESCRIPTION COUNTY, PENNSYLVANIA. REVISIONS

RAWN (NOT FOR CHECKED N CHARGE **CONSTRUCTION** DATE SCALE

DESIGNED

DWF

NED

AJR

JKM

05/01/24

AS SHOWN

FIFTH AVENUE AND SR 2085 (BIRMINGHAM BRIDGE)
AND KIRKPATRICK STREET

DETECTORS

	DETEC	IUKS		
ITEM NUMBER	DESCRIPTION	SEN. NO.	QTY.	LOCATION
02895 . 005	DIGITAL WAVE RADAR DETECTION	(1)	1	1
EACH				
02895 . 001	VIDEO DETECTION	(2)	1	\wedge
EACH				
02895 . 001	VIDEO DETECTION	(3)	1	/ 5\
EACH				
02895. 001	VIDEO DETECTION	4	1	/3\
EACH				
02895. 005	DIGITAL WAVE RADAR DETECTION	(5)	1	/2\
EACH				

ITEM NUMBER MISCELLANEOUS UNIT DESCRIPTION QTY. LOCATION REMARKS 01882. 002 TRAFFIC SIGNAL TIMING MODIFICATIONS СС EACH 01883. 001 TEMPORARY TRAFFIC SIGNAL CC EACH 009 POLE FOUNDATION DRILLING, LESS THAN 30 " DIAMETER $\sqrt{2}$ 9 02212. 010 POLE FOUNDATION DRILLING, GREATER THAN 30" DIAMETER 1\3\ 2\6\ 49 02889. 002 LED LUMINAIRE CITY STANDARD, BLACK DODD 1/3/2/5 02890. TRAFFIC SIGNAL CONTROLLER ASSEMBLY, TYPE 2070 LC, WITH TYPE 332 BASE MOUNTED CABINET 332 CONTROLLER CABINET 8" RISER CC 02890. CC 003 ETHERNET SWITCH EACH 02890. 005 GPS TIME CLOCK CC EACH BLACK TUNNEL VISORS BLACK ALUMINUM HOUSINGS BLACK METAL LOUVERED BACKPLATE VEHICULAR SIGNAL HEAD, THREE 12" SECTIONS 001 457 02894. 002 VEHICULAR SIGNAL HEAD, FOUR 12 " SECTIONS BLACK TUNNEL VISORS BLACK ALUMINUM HOUSINGS BLACK METAL LOUVERED BACKPLATE 6 02894**.** 004 BLACK TUNNEL VISORS BLACK ALUMINUM HOUSINGS BLACK METAL LOUVERED BACKPLATE BICYCLE SIGNAL HEAD, THREE 8" SECTIONS 3 896 EACH 02894-005-EACH LED COUNTDOWN PEDESTRIAN SIGNAL HEAD, TYPE A

000

(13(1)(15)

1123 456

6

TRAFFIC SIGNAL SUPPORTS **

BLACK TUNNEL VISORS BLACK ALUMINUM HOUSINGS

			TIVALLE 10																						
DOLF.	MBEN MBEN DESCRIPTION	;		NOI	믬	SET		ARM			ARM	1								DESTAI					
POLE NO.	Li	 	ROUTE	₽	N 118	l LL							ARM	"A"						Af	RM "(2"	SHAFT	SIGN	1AL
				ST	0,	P	н	K		SIGN	NAL L	OCAT	LION	5	IGN	LOCA	OITA	N	w	G	×	7	Н	м	N
	UNIT								_	М	N	0	Р	R	S	Т	U	Υ	"		\ \ \	_		"	
\triangle	02892. 209 EACH TRAFFIC SIGNAL SUPPORT, 34' MAST ARM WITH LUMINAIRE ARM (30' MOUNTING HEIGHT), PAINTED BLACK	1	BIRMINGHAM BR	16+98	L	42′	17′	10′	34′	29′	21′			25′	12′			5′	6°	6′	30′	0°			
<u>^</u>	02892. 005 EACH TRAFFIC SIGNAL SUPPORT, 30' TYPE X-L WITH LUMINAIRE ARM, PAINTED BLACK	1	FIFTH AVE	492+04	R	30′															30′	0°	30′		10′
<u>\$</u>	02892- 204 TRAFFIC SIGNAL SUPPORT, 24' MAST ARM WITH LUMINAIRE ARM (30' MOUNTING HEIGHT), PAINTED BLACK	1	KIRKPATRICK ST	30+13	R	25′	17′	10′	24′	19′	8′			14′				2′	349°	6′	30′	0°			
<u>\$</u>	02892. 608 EACH TRAFFIC SIGNAL SUPPORT, 42' MAST ARM, PAINTED BLACK	1	FIFTH AVE	491+10	L	31′	17′	10′	42′	39′	29′	19′		35′	14′			8′	0°						
É	02892. 605 EACH TRAFFIC SIGNAL SUPPORT, 34' MAST ARM, PAINTED BLACK	1	FIFTH AVE	494+76	L	22′	17′		34′					29′	19′	8′			0°						

** REFER TO TRAFFIC STANDARDS TC-8800 SERIES FOR LETTER DESIGNATION

02895. 002 ACCESSIBLE PEDESTRIAN SIGNALS

AECOM 707 Grant Street 5th Floor Pittsburgh, PA 15219

			THE PREPARATION OF THIS DOCUMENT HAS BEEN FINANCED IN
			PART THROUGH A GRANT FROM THE
			FEDERAL TRANSIT ADMINISTRATION, U.S. DEPARTMENT OF
			TRANSPORTATION, UNDER THE
			URBAN MASS TRANSPORTATION ACT OF 1964, AS AMENDED, FOR THE
٥.	DATE		PORT AUTHORITY OF ALLEGHENY COUNTY, PENNSYLVANIA.
		REVISIONS	COUNTY, PENNSTEVANIA.

(NOT FOR CONSTRUCTION)

				13 1			
DESIGNED	<u>DWP</u>	PORT AUTHOR	RITY OF ALLEGHENY	COUNTY			
DRAWN	NED	PITTSBURGH		PENNSYLVANIA			
CHECKED	<u>AJR</u>	BUS RAPID TRANSIT UPTOWN TO OAKLAN					
IN CHARGE	<u>JKM</u>	SIGNAL PLANS					
DATE	05/01/24	TRAFFIC SIGNAL TABULATIONS					
SCALE	AS SHOWN Port Authority		CONTRACT NO. B	RT-001			
	AS SHOWN	connecting people to life	DWG. NO. SG41	sнт. 1 1			

TS-138

sнт. 1101

TRENCH, CONDUIT, JUNCTION BOX, ELECTRICAL ITEMS

DESCRIPTION	ELECTRICAL SERVICE TYPE C (NEW)	CITY OF PITTSBURGH STANDARD CONCRETE JUNCTION BOX, TYPE 1	TRENCH AND BACKFILL, TYPE I	TRENCH AND BACKFILL, TYPE IV	2 INCH CONDUIT	3 INCH CONDUIT	AWG 8, UNDERGROUND CABLE, COPPER, 1 CONDUCTOR	SIGNAL CABLE, 14 AWG, 5 CONDUCTOR	SIGNAL CABLE, 14 AWG, 7 CONDUCTOR
ITEM NUMBER	02896	02897	02898	02898	02899	02899	02900	02900	02900
TTEM NOMBER	004	001	001	005	002	003	001	002	003
UNIT	EACH	EACH	LF	LF	LF	LF	LF	LF	LF
LOCATION									1
CC TO S1		1	8		16	32			
§1 TO <u>↑</u>			24		24	48			
S1 T0 1		1	47	*	116	232			
1 то 🖄			24			24			
S1 T0 3		1	38	28	66	132			
3 то ∕ѕ			3		6	12			
3 TO 2		1	10	35	45	90			
2 то 🔏			9		9	18			
COMPLETE INTERSECTION	1						960	410	1160
TOTAL	1	3	163	63	282	588	960	410	1160

S1 SYSTEMS JUNCTION BOX TABULATED AS PART OF THE SYSTEMS PLAN.

SIGNS

				310113				
SYMBOL	SERIES	SIZE	AREA EACH (SQ FT)	DESCRIPTION	QUANTITY	02891,001 POST MOUNTED SIGNS, TYPE B	02891.003 POST MOUNTED SIGNS, TYPE F	02891,007 STRUCTURE MOUNTED FLAT SHEET ALUMINUM SIGN WITH STIFFENERS
					_	SF	SF	SF
	R5-1	48 "×48 "	16.0	DO NOT ENTER	2	16.0	16.0	
B	R6-1R	54"x18"	6.8	HORIZONTAL RIGHT ONE WAY	1		6.8	
<u> </u>	R6-1L	54"×18"	6.8	HORIZONTAL LEFT ONE WAY	2		13.6	
D	R10-3EL	9"x15"	0.9	EDUCATIONAL PUSH BUTTON FOR WALK SIGNAL WITH COUNTDOWN TIMER -	3		A	
€	R10-3ER	9"×15"	0.9	EDUCATIONAL PUSH BUTTON FOR WALK SIGNAL WITH COUNTDOWN TIMER -	3		•	
F	D3-4 *	102 "x36 "	25.5	Uptown 100 Kirkpatrick St→ → Birmingham Br	1		25.5	
©	D3-4 *	60"x24"	10.0	2300 Uptown 2200 Fifth Ave	1		10.0	
H	D3-4 *	60 "x24 "	10.0	2200 Uptown 2300 Fifth Ave	1		10.0	
1	R3-1	30"x30"	6.3	NO RIGHT TURN	1		6.3	
<u> </u>	R9-3	24"x24"	4.0	NO PEDESTRIAN CROSSING	2	4.0	4.0	
K	R9-3BPL	18 "×12 "	1.5	USE CROSSWALK LEFT	1		1.5	
<u> </u>	R9-3BPR	18 "x12 "	1.5	USE CROSSWALK RIGHT	1		1.5	
M	R10-6AL	24"x30"	5.0	STOP HERE ON RED, (LEFT)	3	15.0		
N	R10-10L	30"x36"	7.5	LEFT TURN SIGNAL	1			7.5
<u> </u>	R3-5A	30"x36"	7.5	STRAIGHT THROUGH	2			15.0
R	R10-10B	18 "x24 "	3.0	BICYCLE SIGNAL	2		6.0	
<u>s</u>	R10-11	30"x36"	7.5	NO TURN ON RED	2			15.0
<u> </u>	R3-11B(MOD)	30"x36"	7.5	RIGHT LANE - BUSES ONLY	2		15.0	
0	SS-1	30"x18"	3.8	EXCEPT RIGHT TURNS	2		7.6	
V	R6-1	36"x12"	3.0	ONE WAY (TWO SIDED, CITY STANDARD)	2		6.0	
W	R3-1	24 "X24 "	4.0	NO RIGHT TURN	1		4.0	
\boxtimes	R3-2	24"X24"	4.0	NO LEFT TURN	1		4.0	
Ø	R3-5L	30 "X36 "	7.5	LEFT TURN	2			15.0
2	R3-2	30"X30"	6.3	NO LEFT TURN	1			6.3
AA	R3-5Ba	30"x36"	7.5	BUS ONLY	1			7.5
				TOTAL		35.0	137.8	66.3

▲ - INCIDENTAL TO ITEM 02895.002

* WHITE REFLECTORIZED LEGEND AND BORDER ON BLUE REFLECTORIZED BACKGROUND.
UTILIZE 4" CLEARVIEW 3W FOR BLOCK/NEIGHBORHOOD AND 8" CLEARVIEW 3W FOR
STREET NAME. ACTUAL WIDTH DETERMINED BY LETTER SPACING. COORDINATE BLOCK
NUMBERS AND STREET NAME DETAILS WITH CITY OF PITTSBURGH DEPARTMENT OF
MOBILITY AND INFRASTRUCTURE.

TS-138

sнт. 1102

AECOM 707 Grant Street 5th Floor Pittsburgh, PA 15219

		THE PREPARATION OF THIS DOCUMENT HAS BEEN FINANCED IN
		PART THROUGH A GRANT FROM THE
		FEDERAL TRANSIT ADMINISTRATION,
		U.S. DEPARTMENT OF TRANSPORTATION. UNDER THE
		URBAN MASS TRANSPORTATION ACT
DATE	DESCRIPTION	OF 1964, AS AMENDED, FOR THE PORT AUTHORITY OF ALLEGHENY
DAIL	DESCRIPTION	COUNTY, PENNSYLVANIA
	REVISIONS	COUNTY, PENNSTEVANIA.

(NOT FOR CONSTRUCTION)

DESIGNED	<u>DWP</u>	
DRAWN	<u>NED</u>	
CHECKED	<u>AJR</u>	
IN CHARGE	<u>JKM</u>	
DATE	05/01/24	
SCALE		
	AS SHOWN	

PORT AUTHORITY OF ALLEGHENY COUNTY

BUS RAPID TRANSIT UPTOWN TO OAKLAND SIGNAL PLANS TRAFFIC SIGNAL TABULATIONS

Port Authority connecting people to life CONTRACT NO. BRT-001 DWG. NO. SG42

^{*} TYPE IV TRENCH TABULATED AS PART OF THE SYSTEMS PLAN.

SIGN STANDARD

R10-11

R10-22

D R10-6AR

R10-3E(MOD)

LEGEND

PEDESTAL

⊥, ▲ SIGN

MAST ARM WITH LUMINAIRE

→ (2) VEHICULAR/BICYCLE SIGNAL HEAD

→ ② AUDIBLE PEDESTRIAN PUSH → AF

CL/2" PROPOSED LIGHTING CONDUIT/SIZE

—■ (2) PEDESTRIAN SIGNAL HEAD

©2 ☐ ② STOP BAR RADAR DETECTION ZONE

CONTROLLER ASSEMBLY

🗜 😰 STOP BAR RADAR DETECTOR

BW/6" BROKEN WHITE LINE/WIDTH

DEW/4" DOTTED EXTENSION WHITE PAVEMENT MARKING/WIDTH

G/24" SOLID GREEN LINE/WIDTH

■ S1 SYSTEM JUNCTION BOX

C/3"S SYSTEM CONDUIT/SIZE

STOP BAR VIDEO DETECTOR


DOUBLE SOLID YELLOW LINE/WIDTH


C/2 "P POWER CONDUIT/SIZE W/6" SOLID WHITE LINE/WIDTH


☐ 2 JUNCTION BOX


C/2" CONDUIT/SIZE

В

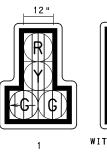

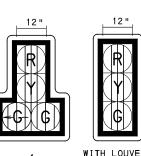

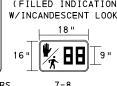


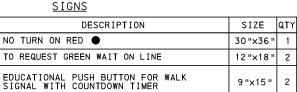

24"x30"

DEW/8"

STOP HERE ON RED. (RIGHT)

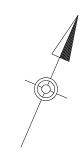

AUDIBLE PEDESTRIAN SIGNAL NOTES

- 1. ALL PUSH BUTTONS SHALL BE EQUIPPED WITH LOCATOR TONES.
- 2. ALL WALK INTERVALS TO HAVE VERBAL MESSAGE DETAILING WALK DIRECTION.
- 3. VERBAL MESSAGE TO BE PLAYED DURING WALK INTERVAL WHEN BUTTON IS PRESSED.
- 4. ALL PEDESTRIAN PUSH BUTTONS TO BE LOCATED AT 42" ABOVE GROUND.
- 5. ALL PUSH BUTTONS TO BE EQUIPPED WITH VIBROTACTILE
- 6. VIBROTACTILE ARROWS TO VIBRATE DURING WALK INTERVAL.
- 7. WALK AND DON'T WALK MESSAGE SHALL BE AUDIBLE THOUGH THE PUSH BUTTON SPEAKER.

SIGNAL ASSEMBLY NOTES

- 1. ALL VEHICULAR/BICYCLE SIGNALS SHALL BE EQUIPPED WITH L.E.D LENSES, TUNNEL VISORS AND LOUVERED BLACK METAL BACKPLATES WITH 2" REFLECTIVE BORDERS.
- 2. MIN/MAX HEIGHT FOR VEHICULAR SIGNALS 17'/18'.
- 3. MIN HORIZONTAL SPACING FOR VEHICULAR SIGNALS IS 8'.
- 4. MIN/MAX HEIGHT FOR PEDESTRIAN MOUNTED SIGNALS 10'/12'.
- 5. FINAL SIGNAL HEAD PLACEMENT WILL BE DETERMINED BY A REPRESENTATIVE OF THE CITY OF PITTSBURGH DEPARTMENT OF MOBILITY AND INFRASTRUCTURE PRIOR TO SIGNAL BEING
- 6. ALL PEDESTRIAN SIGNALS SHALL BE PORTLAND ORANGE FULL "PEDESTRIAN HAND" AND WHITE "WALKING PERSON" SYMBOLS AND HAVE INCANDESCENT LOOK WITH COUNTDOWN TIMER.
- 7. PROVIDE AIRCRAFT STRANDED CABLE FOR MOUNTING SIGNAL AND SIGN BRACKET ASSEMBLIES TO MAST ARMS.
- 8. PROVIDE BLACK ALUMINUM HOUSINGS FOR ALL SIGNAL HEADS.
- 9. INSTALL POST MOUNTED SIGNAL HEADS WITH BOTTOMS NO GREATER THAN 15' ABOVE THE SIDEWALK OR PAVEMENT.

 10. EXACT LOCATION OF TRAFFIC SIGNAL SUPPORTS SHALL BE DETERMINED BY A REPRESENTATIVE OF THE CITY OF PITTSBURGH DEPARTMENT OF MOBILITY AND INFRASTRUCTURE PRIOR TO INSTALLATION.
- 11. POSITION LOUVERED VEHICULAR SIGNAL HEADS TO LATERALLY CONCEAL THE VISIBILITY OF ITS INDICATIONS FROM MOTORISTS IN THE ADJACENT LANE. SIGNAL HEADS 1 AND 2 SHALL BE VISIBLE TO MOTORISTS TRAVELING TO THE LEFT OF THE CONCRETE MEDIAN. SIGNAL VISIBILITY SHALL NOT BE DISTANCE I INITED

PAVEMENT MARKING NOTES

- 1. ALL STOP BARS ARE W/24".
- 2. CROSSWALKS ARE MIN. 10'X24" KEYS WITH 3' TO 5' SPACING.
- 3. CROSSWALKS ACROSS BICYCLE LANES ARE 6'X 12" KEYS WITH 1' SPACING.


TS-XX	(X
COUNTY: ALLEGHENY	
MUNICIPALITY: CITY OF PITTSBURGH	
INTERSECTION: FIFTH AVENUE AND	
SR 8119 (RAMP B, BLVD OF THE ALLIES ON RAM	P)
APPROVED AND ACCEPTED:	
	_
CITY TRAFFIC ENGINEER DATE	
APPROVED AND ACCEPTED:	
DISTRICT TRAFFIC ENGINEER DATE	

AECOM

707 Grant Street 5th Floor Pittsburgh, PA 15219



595 Skippack Pk, Suite 400 Blue Bell, PA 19422

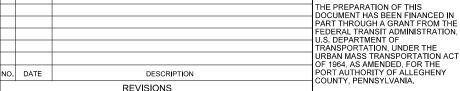

11 W/6"

SHARE TYPE IV PORTION WITH-

PARKING

REMOVE EXISTING POLE, RETURN TO CITY OF PITTSBURGH

CCI, CONTROLLER ASSEMBLY
TYPE I MOUNTING ELECTRICAL
SERVICE, TYPE C

LEGAL R/W LINE

(NOT FOR CONSTRUCTION)

LEGAL R/W LINE

OMH SE

OMH

GRADE .

614×60 ⟨1⟩ ⊈2

19' TYPE X

ELETRICAL SERVICE POLE

40 FEET

-C/3" CL/2" C/2" C/2"P

UNDERGROUND ELETRICAL SERVICE

ESIGNED	MW	
RAWN	MW	
HECKED	<u>EMC</u>	
CHARGE	EMC	
ATE	05/01/24	
CALE		
	AS SHOWN	

TO NEXT SIGNAL - CRAFT AVENUE +1-092-375

8 B C

DETAIL &

PORT AUTHORITY OF ALLEGHENY COUNTY

BUS RAPID TRANSIT UPTOWN TO OAKLAND SIGNAL PLANS FIFTH AVENUE & RAMP TO BOULEVARD OF THE ALLIES

CONTRACT NO. BRT-001 **Port Authority** SG43 DWG NO sнт. 1103

3-4-5-6

WITH LOUVERS

(FILLED INDICATION W/INCANDESCENT LOOK)

7-8

CTY/4" CYCLE TRACK BROKEN YELLOW PAVEMENT MARKING/WIDTH o B DETAIL A

840, TO NEXT SIGNAL T BIRMINGHAM BIGNAL KIRKPATRICK BRIDGE/ #1-092-153

FIFTH AVENUE

GRADE = -5.1%

SPEED LIMIT = 25 MPH

₫ 14 7

SIGNAL HEADS

SINGLE UNIT HAND/MAN OVERLAY, COUNTDOWN, LED

	110			<u> </u>	<u> </u>	<u>, 10</u>	<u> </u>	<u> </u>			. <u> </u>	=
	PHASE 2				PHASE 4 (BIKE + PED PHASE)							
	BIKE	-	f	⊢в	IKE	ВІ	(E		⊢ —B —	_ IKE	HL40HHZG HL40HHZG	
SIGNAL	1	2	3			1	2	3	4			
2	G	Υ	R			R	R	R	R		R	
1	G <u>∠</u> G_	Υ	R			R	R	R	R		R	
3-4-5-6	R	R	R			G	G	Υ	R		0FF	
7-8	DW	DW	DW			W	FD	DW	DW		0FF	
FIXED	>	\geq	4	3		$\overline{}$	\geq	4	3			
MINIMUM	10	\Box				- !	5					
PASSAGE	3						3					
FREE (MAX)	47					2	0					
PEDESTRIAN*						7	10					
MEMORY		MAX	REC	ALL		1	NON-	LOC	< INC	;		
UDON DEDECTRIAN ACTUATION ONLY OTHERWICED DON'T WALK AT												


* UPON PEDESTRIAN ACTUATION ONLY, OTHERWISED DON'T WALK AT ALL TIMES

DETECTOR ZONE INFORMATION

DETECTOR	DETECTION ZONE(S)	MODE	TYPE	ROUTE	PHASE	LOCATION MAST ARM
3	(1) (11' × 60')	PRESENCE	VIDEO (STOP BAR)	FIFTH AVENUE	2	\triangle
1	② (10′ × 30′)	PRESENCE	RADAR (STOP BAR)	FIFTH AVENUE	4	2
2	⟨3⟩ (10′ × 30′)	PRESENCE	RADAR (STOP BAR)	FIFTH AVENUE	4	\triangle

TRANSIT PRIORITY PRE-EMPTION NOTES (TO BE INSTALLED BY OTHERS)

- COORDINATE TRAFFIC CONTROLLER PROGRAMMING MODIFICATION WITH REPRESENTATIVES OF THE CITY OF PITTSBURGH AND DISTRICT TRAFFIC UNIT.
- 2. INCLUDE A TRANSIT PRIORITY PHASE THAT WILL EXTEND THE INDICATED PHASE A MAXIMUM OF 10 SECONDS WHEN ACTIVATED BY A PORT AUTHORITY VEHICLE. DO NOT VIOLATE SIDE STREET PEDESTRIAN MINIMUM TIMINGS.
- 3. MAINTAIN ALL YELLOW CLEARANCES AT ALL TIMES.
- 4. PROCEED TO THE SUBSEQUENT INTERVAL AS DEFINED IN THE MOVEMENT, SEQUENCE AND TIMING DIAGRAM UPON COMPLETING THE GREEN EXTENSION INTERVAL.
- 5. ONCE A TRANSIT CALL IS PLACED AND SATISFIED, THE CONTROLLER WILL NOT SATISFY ANOTHER CALL FOR
- 6. LOCATION OF BUS DETECTORS ARE TO BE FIELD ADJUSTED TO ACHIEVE MAXIMUM OPERATION.

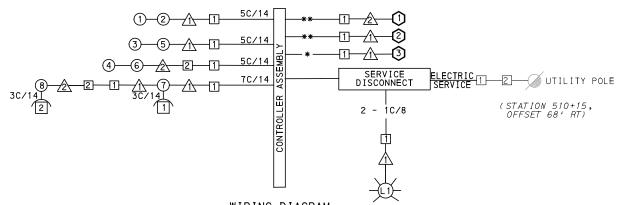

WIRING DIAGRAM

5C/14 - CABLE(NO. OF CONDUCTORS/SIZE AWG.)

SIGNAL HEAD

A SIGNAL SUPPORT

 $\hfill \square$ AUDIBLE PEDESTRIAN $\hfill \square$ JUNCTION BOX INDICATOR

—L1)— LUMINAIRE PROPOSED DETECTOR

INCIDENTAL TO ITEM 02895.001, AS PER MANUFACTURERS SPECIFICATIONS

3C/14 INCIDENTAL TO ITEM 02895.002

** INCIDENTAL TO ITEM 02895.005 AS PER MANUFACTURERS SPECIFICATIONS

GENERAL NOTES


THE CITY OF PITTSBURGH SHALL INSPECT THE NEW SIGNAL EQUIPMENT PRIOR TO ACTIVATION.

ALL TRAFFIC SIGNAL MAINTENANCE AND OPERATION RESPONSIBILITIES SHALL BE TURNED OVER TO THE CITY OF PITTSBURGH AFTER THE FOLLOWING CONDITIONS ARE IMPLEMENTED TO THE CITY'S SATISFACTION:

- 1. PERMIT "AS-BUILT" TRAFFIC SIGNAL DRAWINGS ARE SUBMITTED AND APPROVED.
- 2. ALL PUNCH LIST ITEMS ARE COMPLETED BY THE
- 3. AFTER THE 30-DAY CONTINUOUS UNINTERRUPTED SIGNAL OPERATION WITHOUT MALFUNCTIONS.

CONSTRUCTION NOTES

- 1. ALL JUNCTION BOXES IN WALK AREAS TO BE CITY OF PITTSBURGH STANDARD CONCRETE JUNCTION BOX, TYPE 1.
- 2. ALL JUNCTION BOXES IN NON-WALK AREAS TO BE CITY STANDARD JB-2 WITH BOTTOM.
- 3. THERE SHALL BE NO SIGNAL WIRE OR FIBER CABLE SPLICING.
- 4. SERVICE WIRE FROM THE POWER SOURCE TO THE CONTROLLER CABINET SHALL BE PLACED IN SECONDARY SEPARATE CONDUIT.
- 5. STREET LIGHT CABLE IS NOT PERMITTED TO RUN THROUGH THE CONTROLLER CABINET AND SHALL BE PLACED IN SEPARATE CONDUIT.
- 6. TRAFFIC SIGNAL CABLE SHALL BE PLACED IN DEDICATED
- 7. MOUNT DISCONNECT ON POLE NEAREST TO THE CONTROLLER CABINET EXCLUDING TYPE X POLES.
- 8. REMOVE AND DISPOSE OF ALL EXISTING SIGNAL WIRING NO
- 9. REMOVE EXISTING SIGNAL EQUIPMENT NO LONGER IN USE AND RETURN TO THE CITY OF PITTSBURGH TRAFFIC CONTROL SHOP. COORDINATE DELIVERY OF EQUIPMENT WITH DELMAS MCELHANY, TRAFFIC CONTROL FOREMAN.

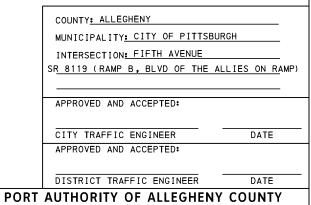

AECOM

Gulf Tower 707 Grant Street 5th Floor Pittsburgh, PA 15219 **ENGINEERING**

595 Skippack Pk, Suite 400 Blue Bell, PA 19422

THE PREPARATION OF THIS DOCUMENT HAS BEEN FINANCED IN PART THROUGH A GRANT FROM THE FEDERAL TRANSIT ADMINISTRATION U.S. DEPARTMENT OF TRANSPORTATION, UNDER THE URBAN MASS TRANSPORTATION ACT OF 1964 AS AMENDED FOR THE NO. DATE DESCRIPTION COUNTY, PENNSYLVANIA. REVISIONS

(NOT FOR CONSTRUCTION)

DESIGNED	MW	
DRAWN	MW	
CHECKED	EMC	
IN CHARGE	<u>EMC</u>	
DATE	05/01/24	
SCALE		
	AS SHOWN	

PENNSYLVANIA BUS RAPID TRANSIT UPTOWN TO OAKLAND

SIGNAL PLANS WIRING, MOVEMENT, PHASING & SEQUENCE DIAGRAMS

Port Authority

CONTRACT NO. BRT-001

DWG.NO. SG44 sнт. 1104

FIFTH AVENUE AND SR 8119 (RAMP B, BLVD OF THE ALLIES ON RAMP

DETECTORS	5
-----------	---

	DETEC	1042		
ITEM NUMBER	DESCRIPTION	SEN. NO.	QTY.	LOCATION
02895 . 005	DIGITAL WAVE RADAR DETECTION		1	<u> </u>
EACH				
02895 . 005	DIGITAL WAVE RADAR DETECTION	2	1	\wedge
EACH		~		
02895 . 001	VIDEO DETECTION	(3)	1	\wedge
EACH				

ITEM NUMBER	MISCELL	ANEOU	S	
UNIT	DESCRIPTION	QTY.	LOCATION	REMARKS
01882 .002 EACH	TRAFFIC SIGNAL TIMING MODIFICATIONS	2	CC	
02890. 001 EACH	TRAFFIC SIGNAL CONTROLLER ASSEMBLY, TYPE 2070 LC, WITH TYPE 332 BASE MOUNTED CABINET	1	CC	332 CONTROLLER CABINET 8" RISER
02890. 003 EACH	ETHERNET SWITCH	1	СС	
02894. 001 EACH	VEHICULAR SIGNAL HEAD, THREE 12" SECTIONS	1	2	BLACK TUNNEL VISORS BLACK ALUMINUM HOUSINGS BLACK METAL LOUVERED BACKPLATE SIGNAL LOUVERS BLACK TUNNEL VISORS
02894. 002 EACH	VEHICULAR SIGNAL HEAD, FOUR 12" SECTIONS	1	1	BLACK TUNNEL VISORS BLACK ALUMINUM HOUSINGS BLACK METAL LOUVERED BACKPLATE SIGNAL LOUVERS
02894. 004 EACH	BICYCLE SIGNAL HEAD, THREE 8" SECTIONS	2	56 34	BLACK TUNNEL VISORS BLACK ALUMINUM HOUSINGS
02894. 005 EACH	LED COUNTDOWN PEDESTRIAN SIGNAL HEAD, TYPE A	2	78	BLACK TUNNEL VISORS BLACK ALUMINUM HOUSINGS
02895. 002 EACH	ACCESSIBLE PEDESTRIAN SIGNALS	2	112	
02889. 002 EACH	LED LUMINAIRE CITY STANDARD, BLACK	1	- <u>Ú</u>	\triangle
02893. 001 EACH	REMOVE EXISTING POLE	1		SW CORNER
02212 009 LF	POLE FOUNDATION DRILLING, LESS THAN 30" DIAMETER	8	<u> </u>	
02212. 010 LF	POLE FOUNDATION DRILLING, 30" DIAMETER OR GREATER	13	Δ	

TRAFFIC SIGNAL SUPPORTS **

	Σm				NO					MAST ARM											PEDE	DESTAL				
POLE NO.	ITEM	DESCRIPTION	QTY.	ROUTE	ATI	SIDE	FFSE							ARM	"A"						А	RM "(C "	SHAFT	SIG	NAL
					ST		OF	Н	K		SIG	NAL	LOCA	TION	:	SIGN	LOC	OITA	N	w	G	x	7	Н	М	N
	UNIT										М	N	0	Р	R	S	T	U	Y				_			
\triangle	02892. 208 EACH	TRAFFIC SIGNAL SUPPORT, 32' MAST ARM WITH LUMINAIRE ARM, 30' MOUNTING, PAINTED BLACK	1	FIFTH AVENUE	509+82	RT	30′	17′	10′	32′			29′	19′	23′					182°	6′	30′	0°			
2	02892. 004 EACH	TRAFFIC SIGNAL SUPPORT, 19' TYPE X, PAINTED BLACK	1	FIFTH AVENUE	510+28	RT	29′																	19′		10′

** REFER TO PENNDOT TC-8800 TRAFFIC STANDARDS - SIGNALS FOR LETTER DESIGNATION

AECOM

Gulf Tower 707 Grant Street 5th Floor Pittsburgh, PA 15219

((DRIVE ENGINEERING 595 Skippack Pk, Suite 400 Blue Bell, PA 19422

			THE PREPARATION OF THIS DOCUMENT HAS BEEN FINANCED IN
			PART THROUGH A GRANT FROM THE FEDERAL TRANSIT ADMINISTRATION,
			U.S. DEPARTMENT OF TRANSPORTATION, UNDER THE
			URBAN MASS TRANSPORTATION ACT OF 1964, AS AMENDED, FOR THE
NO.	DATE	DESCRIPTION	PORT AUTHORITY OF ALLEGHENY COUNTY, PENNSYLVANIA.
		REVISIONS	COUNTY, PENNSTEVANIA.

(NOT FOR CONSTRUCTION)

DESIGNED	MW	Р
DRAWN	MW	PIT
CHECKED	<u>EMC</u>	
IN CHARGE	EMC	
DATE	05/01/24	
SCALE	AS SHOWN	Port

PORT AUTHORITY OF ALLEGHENY COUNTY

BUS RAPID TRANSIT UPTOWN TO OAKLAND SIGNAL PLANS TRAFFIC SIGNAL TABULATIONS

rt Authority
connecting people to life CONTRACT NO. BRT-001 DWG. NO. SG45 sнт. 1105

DESCRIPTION	2 INCH CONDUIT	3 INCH CONDUIT	TRENCH AND BACKFILL, TYPE I	TRENCH AND BACKFILL, TYPE II	TRENCH AND BACKFILL,	AWG 8, UNDERGROUND CABLE, COPPER,1 CONDUCTOR	SIGNAL CABLE, 14 AWG, 5 CONDUCTOR	SIGNAL CABLE, 14 AWG, 7 CONDUCTOR	ELECTRICAL SERVICE TYPE C (NEW)	CITY OF PITTSBURGH STANDARD CONCRETE JUNCTION BOX, TYPE 1
ITEM NUMBER	02899	02899	02898	02898	02898	02900	02900	02900	02896	02897
TTEM NOMBER	002	003	001	002	005	001	002	003	004	001
UNIT	LF	LF	LF	LF	LF	LF	LF	LF	EACH	EACH
LOCATION										
1 то ⚠	6	12	6							
2 TO <u>2</u>	13	26	13							
1 TO 2	146	146	35		*					1
1 то СС	18	18	9							
S1 TO CC		54	27							
ELECTRICAL SERVICE (STA 152+72, TO 2 OFFSET 30.3' RT)	37			37						1
COMPLETE INTERSECTION						79	334	210	1	
TOTAL	220	256	90	37	*	79	334	210	1	2

^{* -} TYPE IV TRENCH TABULATED AS PART OF THE SYSTEMS PLAN.

SIGNS

SYMBOL	SERIES	SIZE	AREA EACH (SQ FT)	DESCRIPTION	QUANTITY	O2891,001 MOUNTED SIGNS, TYPE B	02891,003 MOUNTED SIGNS, TYPE F	O2891.007 O2891.007 STRUCTURE MOUNTED FLAT SHEET ALUMINUM SIGNS WITH STIFFENERS
A	R10-11	30"×36"	7.5	NO TURN ON RED ●	1			7.5
B	R10-22	12"×18"	1.5	TO REQUEST GREEN WAIT ON LINE	2		3	
▲ ©	R10-3E(MOD)	9"×15"	. 9	EDUCATIONAL PUSH BUTTON FOR WALK SIGNAL WITH COUNTDOWN TIMER	2			A
D	R10-6AR	24"x30"	5	STOP HERE ON RED, (RIGHT)	1	5		
				TOTAL	6	5	3	7.5

▲ - INCIDENTAL TO ITEM #02895.002



Gulf Tower 707 Grant Street 5th Floor Pittsburgh, PA 15219



140.	DATE	REVISIONS	COUNTY, PENNSYLVANIA.
NO.	DATE	DESCRIPTION	OF 1964, AS AMENDED, FOR THE PORT AUTHORITY OF ALLEGHENY
			PART THROUGH A GRANT FROM THE FEDERAL TRANSIT ADMINISTRATION, U.S. DEPARTMENT OF TRANSPORTATION, UNDER THE URBAN MASS TRANSPORTATION ACT
			THE PREPARATION OF THIS DOCUMENT HAS BEEN FINANCED IN

(NOT FOR CONSTRUCTION)

ESIGNED	MW	PORT AUTHORITY OF ALLEG	HENY COUNTY
DRAWN	MW	PITTSBURGH	PENNSYLVANIA
HECKED	EMC	BUS RAPID TRANSIT UPTOW	N TO OAKLAND
N CHARGE	EMC	SIGNAL PLANS	
ATE	05/01/24	TRAFFIC SIGNAL TABU	LATIONS
0.41.5			

Port Authority connecting people to life

AS SHOWN

CONTRACT NO. BRT-001

DWG. NO. SG46 SHT. 1106

S1 - TABULATED ON SYSTEMS PLAN

STANDARD

R10-3E(MOD)

D3-4 *

D3-4 *

D3-4 *

R3-1

R3-1

R3-2

R3-2

R9-3

R9-3BPL

R9-3BPR

K

SPECIAL-4

SPECIAL-1

A R6-1

SIGNS

USE CAUTION WHEN EXITING LOT

BIRMINGHAM BRIDGE 3200 Oakland 3300 Fifth Ave 3300 Oakland 3200

Fifth Ave

NO RIGHT TURN

NO RIGHT TURN

NO LEFT TURN

NO LEFT TURN

NO PEDESTRIAN CROSSING

USE CROSSWALK LEFT

USE CROSSWALK RIGHT

60"x24"

60"x24"

42 "x36"

30"x30

24"x24

30"x30

24"x24

24"x24

18 "x12

18"x12

30"x36

30"x36

24"x30

72"x42

72 "x42"

30"x36

DETAIL

<u>513145</u>							
DESCRIPTION	SIZE	QTY	SIGN	STANDARD	DESCRIPTION	SIZE	QTY
ONE WAY (TWO SIDED, CITY STANDARD)	36"x12'	2	0	R6-2L	VERTICAL LEFT ONE-WAY	30"x36"	1
EDUCATIONAL PUSH BUTTON FOR WALK SIGNAL WITH COUNTDOWN TIMER (MOD)	9"×15"	6		R10-10L	LEFT TURN SIGNAL	30"×36"	1
100 Oakland Craft Ave	66"x24"	1	W	R3-17	BIKE LANE	30"x24"	1
UPTOWN BIRMINGHAM BRIDGE	72 "x42 '	1	X	SPECIAL-5	BEGINS	30"x9"	1

CCI, CONTROLLER ASSEMBLY
TYPE I MOUNTING ELECTRICAL
SERVICE, TYPE C
MODIFIED 7

(6) ×

DETAIL 2 MA 32' W/ LUM

* WHITE REFLECTORIZED LEGEND AND BORDER ON BLUE REFLECTORIZED BACKGROUND. UTILIZE 4" CLEARVIEW 3W FOR BLOCK/NEIGHBORHOOD AND 8" CLEARVIEW 3W FOR STREET NAME. ACTUAL WIDTH DETERMINED BY LETTER SPACING. COORDINATE BLOCK NUMBERS AND STREET NAME DETAILS WITH CITY OF PITTSBURGH DEPARTMENT OF MOBILITY AND INFRASTRUCTURE.

5. ALL PUSH BUTTONS TO BE EQUIPPED WITH VIBROTACTILE ARROW. 6. VIBROTACTILE ARROWS TO VIBRATE DURING WALK INTERVAL. 7. WALK AND DON'T WALK MESSAGE SHALL BE AUDIBLE THOUGH THE PUSH BUTTON SPEAKER. SIGNAL ASSEMBLY NOTES 1. ALL VEHICULAR/BICYCLE SIGNALS SHALL BE EQUIPPED WITH L.E.D LENSES, TUNNEL VISORS AND LOUVERED BLACK METAL BACKPLATES WITH 2" REFLECTIVE BORDERS. 2. MIN/MAX HEIGHT TO BOTTOM OF VEHICULAR SIGNALS 17'/18'

> 3. MIN HORIZONTAL SPACING FOR VEHICULAR SIGNALS IS 8'. 4. MIN/MAX HEIGHT TO BOTTOM OF PEDESTRIAN SIGNALS 10'/12 5. FINAL SIGNAL HEAD PLACEMENT WILL BE DETERMINED BY REPRESENTATIVES OF THE CITY OF PITTSBURGH DEPARTMENT OF MOBILITY AND INFRASTRUCTURE AND THE DISTRICT TRAFFIC UNIT PRIOR TO SIGNAL BEING TURNED ON.

1. ALL PUSH BUTTONS SHALL BE EQUIPPED WITH LOCATOR TONES.

6. ALL PEDESTRIAN SIGNALS SHALL BE PORTLAND ORANGE FULL "PEDESTRIAN HAND" AND WHITE "WALKING PERSON" SYMBOLS AND HAVE INCANDESCENT LOOK WITH COUNTDOWN TIMER.

AUDIBLE PEDESTRIAN SIGNAL NOTES

2. ALL WALK INTERVALS TO HAVE VERBAL MESSAGE DETAILING WALK DIRECTION.

3. VERBAL MESSAGE TO BE PLAYED DURING WALK INTERVAL WHEN BUTTON IS PRESSED.

4. ALL PEDESTRIAN PUSH BUTTONS TO BE LOCATED AT 42" ABOVE GROUND.

7. PROVIDE AIRCRAFT STRANDED CABLE FOR MOUNTING SIGNAL AND SIGN BRACKET ASSEMBLIES TO MAST ARMS.


8. PROVIDE BLACK ALUMINUM HOUSINGS FOR ALL SIGNAL HEADS.

INSTALL POST MOUNTED SIGNAL HEADS WITH BOTTOMS NO GREATER THAN 15' ABOVE THE SIDEWALK OR PAVEMENT.

EXACT LOCATION OF TRAFFIC SIGNAL SUPPORTS SHALL BE DETERMINED BY REPRESENTATIVES OF THE CITY OF PITTSBURGH DEPARTMENT OF MOBILITY AND INFRASTRUCTURE AND THE DISTRICT TRAFFIC UNIT PRIOR TO INSTALLATION.

PAVEMENT MARKING NOTES

- 1. ALL STOP BARS ARE W/24".
- CROSSWALKS ARE 10'X 24" KEYS WITH 3' TO 5' SPACING.
- CROSSWALKS ACROSS BICYCLE LANES ARE 6'X 12" KEYS WITH 1' SPACING.

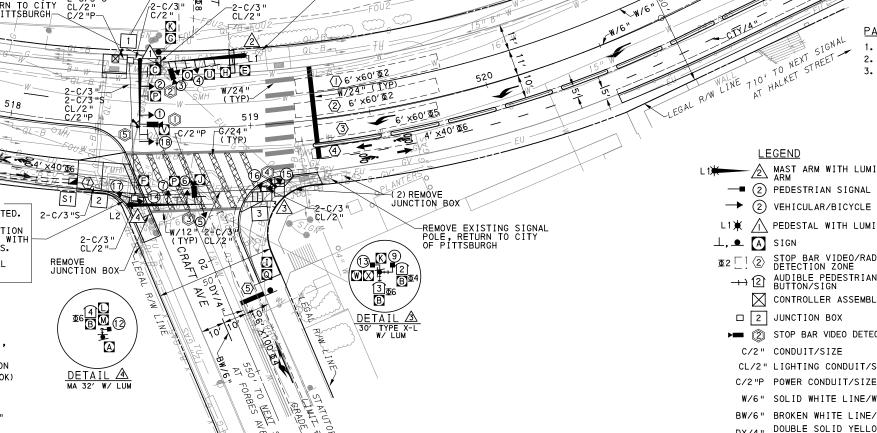

20

40 FEET

REMOVE EXISTING SIGNAL POLE, RETURN TO CITY OF PITTSBURGH

LEGEND - AMST ARM WITH LUMINAIRE

 $\sqrt{\mathbf{0}}$

()

— ② PEDESTRIAN SIGNAL HEAD

→ ② VEHICULAR/BICYCLE SIGNAL HEAD L1 X PEDESTAL WITH LUMINAIRE

→ ② AUDIBLE PEDESTRIAN PUSH BUTTON/SIGN CONTROLLER ASSEMBLY

☐ 2 JUNCTION BOX

STOP BAR VIDEO DETECTOR

CL/2" LIGHTING CONDUIT/SIZE

W/6" SOLID WHITE LINE/WIDTH

BW/6" BROKEN WHITE LINE/WIDTH

DY/4" DOUBLE SOLID YELLOW LINE/WIDTH G/24" SOLID GREEN LINE/WIDTH

COLD THERMOPLASTIC YELLOW LINE/WIDTH CTY/4

■ S1 SYSTEM JUNCTION BOX

C/3"S SYSTEM CONDUIT/SIZE

-<u>∕2</u>\ MAST ARM

-∕5\ EXISTING MAST ARM

1- 2 DIGITAL WAVE RADAR DETECTOR

TS-242

DATE

COUNTY: ALLEGHENY MUNICIPALITY: CITY OF PITTSBURGH INTERSECTION: FIFTH AVENUE AND CRAFT AVENUE

APPROVED AND ACCEPTED:

CITY TRAFFIC ENGINEER APPROVED AND ACCEPTED:

DISTRICT TRAFFIC ENGINEER

DATE

AECOM

Gulf Tower 707 Grant Street 5th Floor Pittsburgh, PA 15219



THE PREPARATION OF THIS DOCUMENT HAS BEEN FINANCED IN PART THROUGH A GRANT FROM THE FEDERAL TRANSIT ADMINISTRATION U.S. DEPARTMENT OF TRANSPORTATION, UNDER THE URBAN MASS TRANSPORTATION ACT OF 1964 AS AMENDED FOR THE NO. DATE DESCRIPTION COUNTY, PENNSYLVANIA. REVISIONS

(NOT FOR **CONSTRUCTION** DESIGNED RAWN WLZ CHECKED MSF N CHARGE LJF DATE 05/01/24 SCALE

AS SHOWN

PORT AUTHORITY OF ALLEGHENY COUNTY PITTSBURGH PENNSYLVANIA

BUS RAPID TRANSIT UPTOWN TO OAKLAND SIGNAL PLANS

FIFTH AVENUE & CRAFT AVENUE

CONTRACT NO. BRT-001 Port Authority SG47 sнт. 1107 DWG NO

		PHA	SE	2+6			PHA	SE	2+5							
	=	KE BIKEB					 ===================================		<u></u>	BIKE	BIKE-I					ELASHIZG FLASHIZG
		INT	ERV.	ALS			INT	ERV	ALS			INT	ERV	ALS		
SIGNAL	1	2	3	4	5	1	2	3	4	5	1	2	3	4	5	
1-2	G	G	ΥÛ	R ^①		G	G	Υ	R		R	R	R	R		R
3-4-5	R	R	R	R		R	R	R	R		G	G	Υ	R		R
6-7	R	R	R	R		R	R	R	R		G	G	Υ	R		R
8-9	DW	DW	DW	DW		DW	DW	DW	DW		W	FD	DW	DW		0FF
10-11	W	FD ²	DW ²	Dw ²		W	FD	DW	DW		DW	DW	DW	DW		0FF
12-13	W	FD	DW	DW		DW	DW	DW	DW		DW	DW	DW	DW		0FF
14-15	G	G	Υ	R		R	R	R	R		R	R	R	R		R
16-17	G	G	Υ	R		R	R	R	R		R	R	R	R		R
18	- R−	- R-	+	- R-		- G-	- G−	- Y-	-R -		- R-	- R−	- R-	- R-		0FF
FIXED		\geq	3	5				4	3			\geq	3.5	3.5		
MINIMUM	!	5				1	0				1	0				
PASSAGE	;	3				;	3					3				
FREE (MAX)	2	0				4	3				4	7				
PEDESTRIAN	7	13				7	13				7	13				
MEMORY	<u> </u>	PED		`^			MIN	DEC	\ \ \ \ \ \		<u> </u>	PED	DEC	CALL		
MEMORT		rev	REC	ALL			MIN	κEU	ALL			rev	תבנ	ALL		l


- 1 G IF FOLLOWED BY 2+5.
- 2 W IF FOLLOWED BY 2+5.

TRANSIT PRIORITY PRE-EMPTION NOTES (TO BE INSTALLED BY OTHERS)

- COORDINATE TRAFFIC CONTROLLER PROGRAMMING MODIFICATION WITH REPRESENTATIVES OF THE CITY OF PITTSBURGH AND DISTRICT TRAFFIC UNIT.
- 2. INCLUDE A TRANSIT PRIORITY PHASE THAT WILL EXTEND THE INDICATED PHASE A MAXIMUM OF 10 SECONDS WHEN ACTIVATED BY A PORT AUTHORITY VEHICLE. DO NOT VIOLATE SIDE STREET PEDESTRIAN MINIMUM TIMINGS.
- 3. MAINTAIN ALL YELLOW CLEARANCES AT ALL TIMES.
- 4. PROCEED TO THE SUBSEQUENT INTERVAL AS DEFINED IN THE MOVEMENT, SEQUENCE AND TIMING DIAGRAM UPON COMPLETING THE GREEN EXTENSION INTERVAL.
- 5. ONCE A TRANSIT CALL IS PLACED AND SATISFIED, THE CONTROLLER WILL NOT SATISFY ANOTHER CALL FOR 4 CYCLES.
- 6. LOCATION OF BUS DETECTORS ARE TO BE FIELD ADJUSTED TO ACHIEVE MAXIMUM OPERATION.


DETECTOR ZONE INFORMATION

DETECTOR	DETECTION ZONE(S)	MODE	TYPE	ROUTE	PHASE	LOCATION MAST ARM
	1 2 (6' x60')	PRESENCE	VIDEO (STOP BAR)	FIFTH AVENUE	2	
	③ (6′×60′)	PRESENCE	VIDEO (STOP BAR)	FIFTH AVENUE	5	
(4)	⟨ 4 ⟩ (4′×40′)	PRESENCE	RADAR (STOP BAR)	FIFTH AVENUE BICYCLE LANE	6	<u> </u>
0	⟨5⟩ (6′×100′)	PRESENCE	VIDEO (STOP BAR)	CRAFT AVENUE	4	<u> </u>
(3)	⟨6⟩ (6′×30′)	PRESENCE	VIDEO (STOP BAR)	PARKING LOT	8	4
(5)	⑦ (4′×40′)	PRESENCE	RADAR (STOP BAR)	FIFTH AVENUE BICYCLE LANE	6	Â

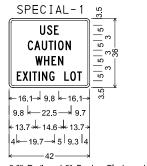


2.0" Radius, 1.0" Border, Black on White; "USE", C 2K; "CAUTION". C 2K: "WHEN", C 2K;

"EXITING LOT", C 2K;

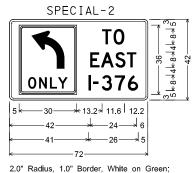

"TO". D 2K: "EAST". D 2K: "I-376". D 2K:

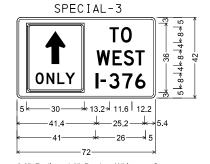

2.0" Radius, 1.0" Border, White on Green "TO". D 2K: "WEST". D 2K: "I-376". D 2K:

GENERAL NOTES


THE CITY OF PITTSBURGH SHALL INSPECT THE NEW SIGNAL EQUIPMENT PRIOR TO ACTIVATION.

ALL TRAFFIC SIGNAL MAINTENANCE AND OPERATION RESPONSIBILITIES SHALL BE TURNED OVER TO THE CITY OF PITTSBURGH AFTER THE FOLLOWING CONDITIONS ARE IMPLEMENTED TO THE CITY'S SATISFACTION:

- 1. PERMIT "AS-BUILT" TRAFFIC SIGNAL DRAWINGS ARE SUBMITTED AND APPROVED.
- 2. ALL PUNCH LIST ITEMS ARE COMPLETED BY THE CONTRACTOR.
- 3. AFTER THE 30-DAY CONTINUOUS UNINTERRUPTED SIGNAL OPERATION WITHOUT MALFUNCTIONS.

CONSTRUCTION NOTES


- 1. ALL JUNCTION BOXES IN WALK AREAS TO BE CITY OF PITTSBURGH STANDARD CONCRETE JUNCTION BOX, TYPE 1.
- 2. ALL JUNCTION BOXES IN NON-WALK AREAS TO BE CITY STANDARD JB-2 WITH BOTTOM.
- 3. THERE SHALL BE NO SIGNAL WIRE OR FIBER CABLE SPLICING.
- 4. SERVICE WIRE FROM THE POWER SOURCE TO THE CONTROLLER CABINET SHALL BE PLACED IN SECONDARY SEPARATE CONDUIT.
- 5. STREET LIGHT CABLE IS NOT PERMITTED TO RUN THROUGH THE CONTROLLER CABINET AND SHALL BE PLACED IN SEPARATE CONDUIT.
- 6. TRAFFIC SIGNAL CABLE SHALL BE PLACED IN DEDICATED
- 7. MOUNT DISCONNECT ON POLE NEAREST TO THE CONTROLLER CABINET EXCLUDING TYPE X POLES.
- 8. REMOVE AND DISPOSE OF ALL EXISTING SIGNAL WIRING NO
- 9. REMOVE EXISTING SIGNAL EQUIPMENT NO LONGER IN USE AND RETURN TO THE CITY OF PITTSBURGH TRAFFIC CONTROL SHOP. COORDINATE DELIVERY OF EQUIPMENT WITH DELMAS MCELHANY, TRAFFIC CONTROL FOREMAN.
- 10. REMOVE ALL SIGNALS WHILE POLE IS PAINTED, REFER TO SECTION 02892.

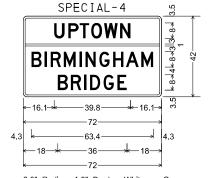

2.0" Radius, 1.0" Border, White on Green; "UPTOWN", D 2K; "BIRMINGHAM", D 2K; "BRIDGE", D 2K;



1.0" Radius, 0.6" Border, 0.4" Indent, Black on White "BEGINS", D 2K;

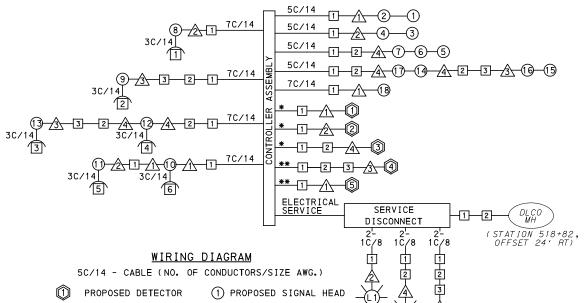


PROPOSED AUDIBLE

-L1- PROPOSED LUMINAIRE 1 PROPOSED JUNCTION BOX

↑ PROPOSED SIGNAL SUPPORT

3C/14 INCIDENTAL TO ITEM 02895.002

- *INCIDENTAL TO ITEM 02895.001, AS PER MANUFACTURERS SPECIFICATIONS
- **INCIDENTAL TO ITEM 02895.005, AS PER MANUFACTURERS SPECIFICATIONS

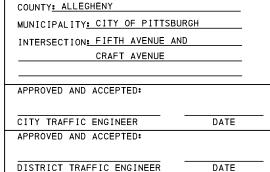

TS-242

AECOM

Gulf Tower 707 Grant Street 5th Floor Pittsburgh, PA 15219



THE PREPARATION OF THIS DOCUMENT HAS BEEN FINANCED IN PART THROUGH A GRANT FROM THE FEDERAL TRANSIT ADMINISTRATION J.S. DEPARTMENT OF FRANSPORTATION, UNDER THE URBAN MASS TRANSPORTATION ACT OF 1964 AS AMENDED FOR THE NO. DATE DESCRIPTION COUNTY, PENNSYLVANIA. REVISIONS

(NOT FOR CONSTRUCTION)

DESIGNED	<u>LJF</u>	
DRAWN	<u>WLZ</u>	
CHECKED	MSF	
IN CHARGE	<u>LJF</u>	
DATE	05/01/24	
SCALE		
	AS SHOWN	

PORT AUTHORITY OF ALLEGHENY COUNTY PITTSBURGH PENNSYLVANIA

BUS RAPID TRANSIT UPTOWN TO OAKLAND SIGNAL PLANS

Port Authority

WIRING, MOVEMENT, PHASING & SEQUENCE DIAGRAMS CONTRACT NO. BRT-001

SG48 DWG NO sнт. 1108 ITEM

NŮMBËR

01882.

EACH 02212.

LF 02212.

LF 02889.

EACH

EACH

EACH

02894.

EACH 02894**.** 004

EACH 02894.

005

EACH

EACH

EACH

02890. 003 ETHERNET SWITCH

02890. 005 GPS TIME CLOCK

TYPE A

	<u>TRAFFIC</u>	SIGNAL	TABULATION
--	----------------	--------	------------

FIFTH AVENUE AND CRAFT AVENUE

DETECTORS

ITEM NUMBER	DESCRIPTION	SEN. NO.	QTY.	LOCATION
02895 . 001	VIDEO DETECTION	n	1	\bigwedge
EACH		~		
02895 . 001	VIDEO DETECTION	2	1	/2\
EACH		_		
02895 . 001	VIDEO DETECTION	3	1	4
EACH		~		
02895 . 005	DIGITAL WAVE RADAR DETECTION	(4)	1	3
EACH		~		
02895. 005	DIGITAL WAVE RADAR DETECTION	(5)	1	\wedge
EACH				

111213 02895**.** 002 1123 ACCESSIBLE PEDESTRIAN SIGNALS 41516 02897. 012 REMOVE EXISTING JUNCTION BOX 3

MISCELLANEOUS

2

9

38

3

8

QTY. LOCATION

CC

3

 $\sqrt{1}\sqrt{2}\sqrt{4}$

英英

CC STA 518+42 OFF 28' LT

CC

CC

<u></u>

0234

5678

(9)(5)(7)

890

DESCRIPTION

TRAFFIC SIGNAL TIMING MODIFICATIONS

LED LUMINAIRE CITY STANDARD, BLACK

LED_COUNTDOWN PEDESTRIAN SIGNAL HEAD,

POLE FOUNDATION DRILLING, LESS THAN 30" DIAMETER

POLE FOUNDATION DRILLING, 30" DIAMETER OR GREATER

02890. TRAFFIC SIGNAL CONTROLLER ASSEMBLY, TYPE 2070 LC WITH TYPE 332 BASE MOUNTED CABINET

02892. 501 EXISTING TRAFFIC SIGNAL SUPPORT, PAINTED BLACK

VEHICULAR SIGNAL HEAD, THREE 12" SECTIONS

BICYCLE SIGNAL HEAD, THREE 8" SECTIONS

TRAFFIC SIGNAL SUPPORTS **

REMARKS

2 3 4

BLACK TUNNEL VISORS BLACK ALUMINUM HOUSINGS BLACK METAL LOUVERED BACKPLATE

BLACK TUNNEL VISORS BLACK ALUMINUM HOUSINGS BLACK METAL LOUVERED BACKPLATE

BLACK TUNNEL VISORS BLACK ALUMINUM HOUSINGS

332 CONTROLLER CABINET 8" RISER RE-ESTABLISH INTERCONNECT

	R R				NO		_							١	MAST	ARM								PEC	DESTA	L
POLE NO.	ITEM	DESCRIPTION	QTY.	ROUTE	[AT I	SIDE	OFFSE							ARM	"A "						А	.RM "(C "	SHAFT	SIG	NAL
					_{[S}		0	Н	K	١,	SIG	NAL I	_OCA	TION	S	IGN	LOC	10 I TA	N	w	G	X	z	н	м	N
	UNIT									_	М	N	0	Р	R	S	T	U	Υ			<u></u>			IVI	- 1
\triangle	02892. 605 EACH	TRAFFIC SIGNAL SUPPORT, 34' MAST ARM, PAINTED BLACK	1	FIFTH AVE	518+53	LT	27.5	17′	10′	34′	33′	22′	10′		30′	14′			4′	4°						
2	02892. 208 EACH	TRAFFIC SIGNAL SUPPORT, 32' MAST ARM WITH LUMINAIRE ARM (30' MOUNTING HEIGHT), PAINTED BLACK	1	FIFTH AVE	518+99	LT	29′	17′	10′	32′	28′	20′			24′	16′	12′		4′	2729	6′	30′	90°			
3	02892. 005 EACH	TRAFFIC SIGNAL SUPPORT, 30' TYPE X-L WITH LUMINAIRE ARM, PAINTED BLACK	1	FIFTH AVE	519+06	RT	27′														6′	30'	0°	30′	12′	10′
4	02892. 208 EACH	TRAFFIC SIGNAL SUPPORT, 32' MAST ARM WITH LUMINAIRE ARM (30' MOUNTING HEIGHT), PAINTED BLACK	1	FIFTH AVE	518+51	RT	33′	17′	10′	32′	29′	23′	15′		29′	19′			5′	2739	6′	30′	90°			
<u> </u>		TRAFFIC SIGNAL SUPPORT, 30' MAST ARM		FIFTH AVE	521+50	LT	23 '			30 '					27′	17′	6′			0°						

^{**} REFER TO PENNDOT TC-8800 TRAFFIC STANDARDS-SIGNALS FOR LETTER DESIGNATION

AECOM Gulf Tower 707 Grant Street 5th Floor Pittsburgh, PA 15219



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U.S. DEPARTMENT OF
TRANSPORTATION, UNDER THE
URBAN MASS TRANSPORTATION ACT
OF 1964, AS AMENDED, FOR THE
PORT AUTHORITY OF ALLEGHENY
COUNTY, PENNSYLVANIA. DESCRIPTION REVISIONS

(NOT FOR CONSTRUCTION)

					15-242
DESIGNED	<u>LJF</u>	PORT AUTHOR	ITY OF AL	LEGHENY COL	JNTY
DRAWN	WLZ	PITTSBURGH		PENN	SYLVANIA
CHECKED	MSF	BUS RAPID TE	RANSIT UPT	OWN TO OAKL	AND
IN CHARGE	<u>LJF</u>		SIGNAL PL	.ANS	
DATE	05/01/24	TRAF	FIC SIGNAL T	ABULATIONS	
SCALE	AS SHOWN	Port Authority	CONTR	ACT NO. BRT-0	01
l '	AU ULIOVIII	connecting people to life	DWG. NO.	SG49	sнт. 1109

TS-242

FIFTH AVENUE AND CRAFT AVENUE

TRENCH, CONDUIT, JUNCTION BOX, ELECTRICAL ITEMS

DESCRIPTION	ELECTRICAL SERVICE, TYPE C (NEW)	CITY OF PITTSBURCH STANDARD CONCRETE JUNCTION BOX, TYPE 1	TRENCH AND BACKFILL, TYPE II	TRENCH AND BACKFILL, TYPE IV	INCH CONDUIT	INCH CONDUIT	AWG 8, UNDERGROUND CABLE, COPPER, 1 CONDUCTOR	SIGNAL CABLE, 14 AWG, 5 CONDUCTOR	SIGNAL CABLE, 14 AWG, 7 CONDUCTOR
	ELE	STA	TAP TYP	TYP	2 I	3 1	AWG	S 16	\$16 7 C
ITEM NUMBER	02896	02897	02898	02898	02899	02899	02900	02900	02900
TIEM NOMBEN	004	001	002	005	002	003	001	002	003
UNIT	EACH	EACH	LF	LF	LF	LF	LF	LF	LF
LOCATION									
сс то 1		1	7		14	28			
1 TO 2		1	17	41	116	232			
2 TO 3		1	9	45	54	108			
			5		5	10			
			48		48	96			
<u>∕</u> 3 то 3			3		3	6			
<u>√4</u> TO 2			4		4	8			
S1 T0 2			27			54			
ELECTRICAL SERVICE TO 2 MANHOLE			4	28	32				
COMPLETE INTERSECTION	1						805	720	565
TOTAL	1	3	124	114	276	542	805	720	565

S1 - TABULATED ON SYSTEMS PLAN

SIGNS

SYMBOL	SERIES	SIZE	AREA EACH (SQ FT)	DESCRIPTION	QUANTITY	M POST MOUNTED SIGNS, TYPE B	02891,003 MOUNTED SIGNS, TYPE F	STRUCTURE MOUNTED FLAT SHEET ALUMINUM SIGNS WITH STIFFENERS
A	R6-1	36"X12"	3.0	ONE-WAY (TWO SIDED, CITY STANDARD)	2	31	6.0	35
B	R10-3E (MOD)	9 "X15 "	0.9	EDUCATIONAL PUSH BUTTON FOR WALK SIGNAL WITH COUNTDOWN TIMER (MOD)	6		A	
0	D3-4 *	66"×24"	11.0	100 Oakland Craft Ave	1			11.0
0	SPECIAL-4	72 "×42 "	21.0	UPTOWN BIRMINGHAM BRIDGE	1			21.0
<u> </u>	D3-4 *	60"x24"	10.0	3200 Oakland 3300 Fifth Ave	1			10.0
<u> </u>	D3-4 *	60"x24"	10.0	3300 Oakland 3200 Fifth Ave	1			10.0
<u> </u>	SPECIAL-1	42 "x36 "	10.5	USE CAUTION WHEN EXITING LOT	1	10.5		
H	R3-1	30"x30"	6.3	NO RIGHT TURN	1			6.3
1	R3-1	24"×24"	4.0	NO RIGHT TURN	1		4.0	
J	R3-2	30"x30"	6.3	NO LEFT TURN	1			6.3
K	R3-2	24"x24"	4.0	NO LEFT TURN	2		8.0	
0	R9-3	24"x24"	4.0	NO PEDESTRIAN CROSSING	2		8.0	
M	R9-3BPL	18"×12"	1.5	USE CROSSWALK LEFT	1		1.5	
N	R9-3BPR	18"×12"	1.5	USE CROSSWALK RIGHT	1		1.5	
0	R10-12	30"×36"	7.5	LEFT TURN YIELD ON GREEN	1			7.5
P	R10-11	30"×36"	7.5	NO TURN ON RED	2			15.0
Q	R10-6AL	24"×30"	5.0	STOP HERE ON RED (LEFT)	1	5.0		
R	SPECIAL-2	72 "×42 "	21.0	LEFT TURN TO EAST I-376	1			21.0
S	SPECIAL-3	72 "×42 "	21.0	STRAIGHT THROUGH TO WEST I-376	1			21.0
O	R3-6SR	30"x36"	7.5	OPTIONAL RIGHT TURN	1			7.5
0	R6-2L	30"x36"	7.5	VERTICAL LEFT ONE-WAY	1			7.5
V	R10-10L	30"x36"	7.5	LEFT TURN SIGNAL	1			7.5
R	R3-17	30"x24"	5.0	BIKE LANE	1		5.0	
\boxtimes	SPECIAL-5	30"x9"	1.9	BEGINS	1		1.9	
				TOTAL		15.5	35.9	151.6

▲ - INCIDENTAL TO ITEM 02895.002

* WHITE REFLECTORIZED LEGEND AND BORDER ON BLUE REFLECTORIZED BACKGROUND.
UTILIZE 4" CLEARVIEW 3W FOR BLOCK/NEIGHBORHOOD AND 8" CLEARVIEW 3W FOR
STREET NAME. ACTUAL WIDTH DETERMINED BY LETTER SPACING. COORDINATE BLOCK
NUMBERS AND STREET NAME DETAILS WITH CITY OF PITTSBURGH DEPARTMENT OF
MOBILITY AND INFRASTRUCTURE.


AECOM 707 Grant Street

5th Floor Pittsburgh, PA 15219



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URBAN MASS TRANSPORTATION ACT
OF 1964, AS AMENDED, FOR THE
PORT AUTHORITY OF ALLEGHENY
COUNTY, PENNSYLVANIA. NO. DATE DESCRIPTION REVISIONS

					TS-2	42			
DESIGNED	<u>LJF</u>	PORT AUTHOR	ITY OF AL	LEGHENY COL	JNTY				
DRAWN	<u>WLZ</u>	PITTSBURGH		PENNS	SYLVANIA				
CHECKED	MSF	BUS RAPID TE	RANSIT UPT	OWN TO OAKLA	AND				
IN CHARGE	<u>LJF</u>		SIGNAL PL	ANS					
DATE	05/01/24	TRAF	FIC SIGNAL T	ABULATIONS					
SCALE	S SHOWN	S SHOWN Port Authority CONTRACT NO							
_ ^	3 31 IOVVIV	connecting people to life	DWG. NO.	SG50	sнт. 11	10			

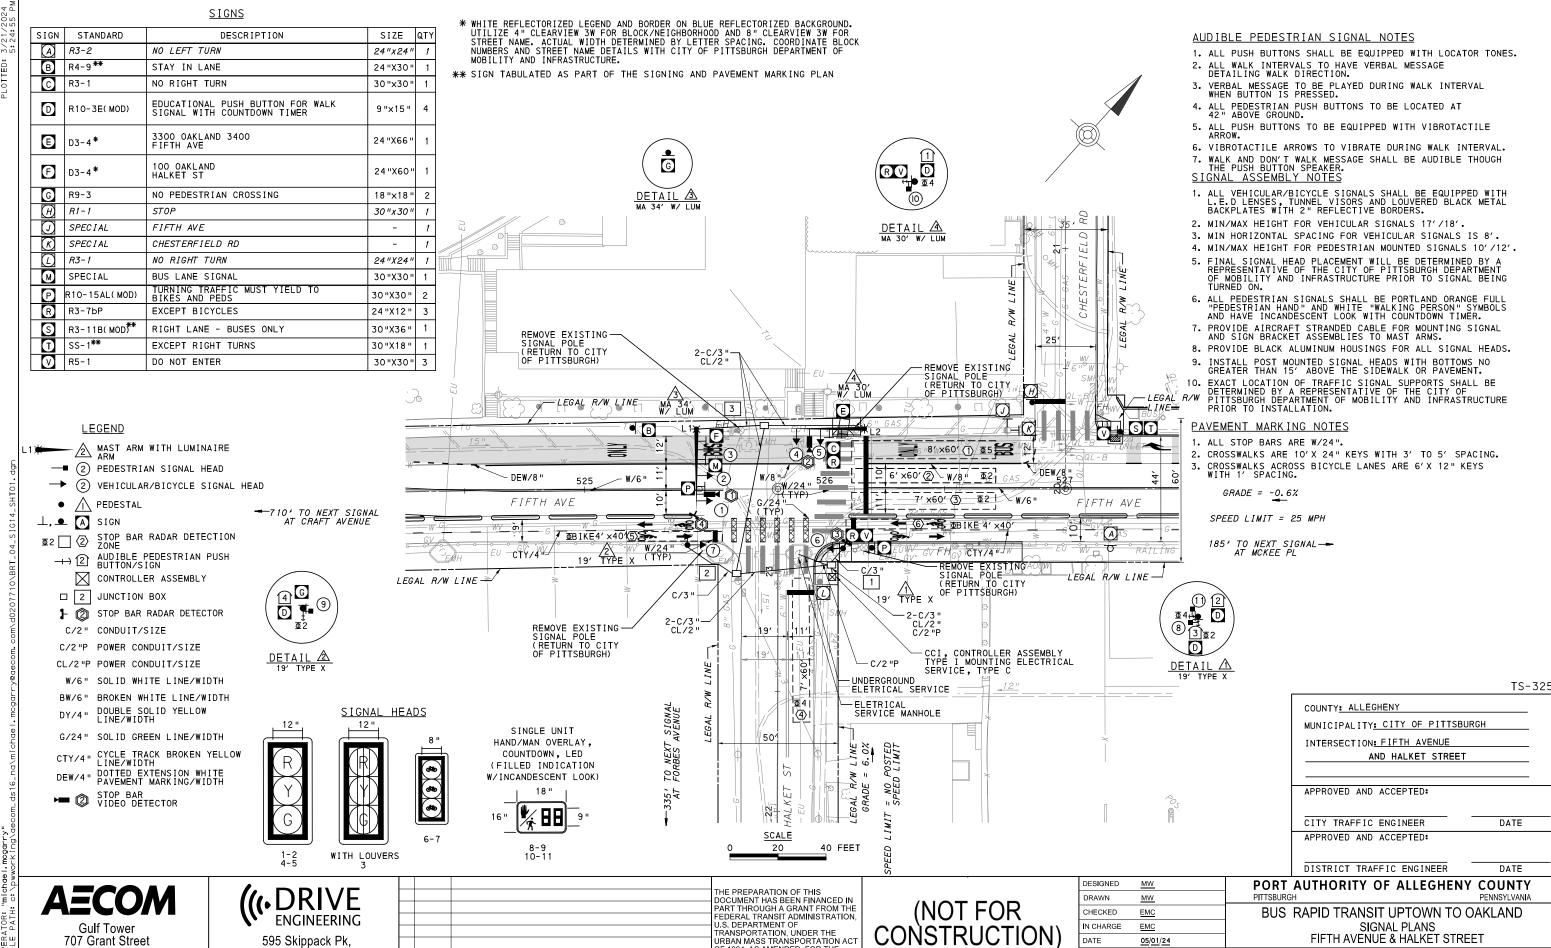

OF 1964 AS AMENDED FOR THE

COUNTY, PENNSYLVANIA.

SCALE

AS SHOWN

CONTRACT NO. BRT-001

sнт. **1111**

SG51

DWG NO

Port Authority

5th Floor

Pittsburgh, PA 15219

Suite 400

Blue Bell, PA 19422

NO. DATE

DESCRIPTION

REVISIONS

		PH	IASE	5			PH	IASE	2+5	5	PHASE 4					
	BIKE	 ≣⊣			BUS BIKE	вік	.			BUS BIKE	BIK	-	\ <u> </u>	⊨ ^{BU} F®I		HT40HHZG HT40HHZG
INTERVAL	1					1	2	3	4		1	2	3	4		
1-2	R					G	G	Υ	R		R	R	R	R		R
3	G					G	G	Υ	R		R	R	R	R		R
4-5	R					R	R	R	R		G	G	Υ	R		R
6-7	R					G	G	Υ	R		R	R	R	R		OFF
8-9	D₩Œ					W	FD	DW	DW		DW	DW	DW	DW		OFF
10-11	DW					DW	DW	DW	DW		W	FD	DW	DW		OFF
FIXED	\bowtie					\supset	<	3	2		\wedge	<	3	2		
MINIMUM	5					1	5				1	5				
PASSAGE	3					,	3					3]
FREE (MAX)	5					5	5				2	4				
PEDESTRIAN						7	10				7	13				
MEMORY	1	NON	LOC	KINO	•		PED	REC	ALL			PED	REC	CALL]


(1) - W IF FOLLOWED BY 2+5.

DETECTOR ZONE INFORMATION

DETECTOR	DETECTION ZONE(S)	MODE	TYPE	ROUTE	PHASE	LOCATION MAST ARM
①	(8' × 60')	PRESENCE	VIDEO (STOP BAR)	FIFTH AVE.	2	<u>\$</u>
	② (6' × 60')	PRESENCE	VIDEO (STOP BAR)	FIFTH AVE.	2	<u> </u>
()	⟨3⟩ (7′× 60′)	PRESENCE	VIDEO (STOP BAR)	FIFTH AVE.	2	3
2	⟨4⟩ (7′ × 60′)	PRESENCE	VIDEO (STOP BAR)	HALKET ST.	4	4
4	⟨5⟩ (4′× 40′)	PRESENCE	RADAR (STOP BAR)	FIFTH AVENUE BICYCLE LANE	2	<u>\$</u>
3	⑥ (4'× 40')	PRESENCE	RADAR (STOP BAR)	FIFTH AVENUE BICYCLE LANE	2	\triangle

TRANSIT PRIORITY PRE-EMPTION NOTES (TO BE INSTALLED BY OTHERS)

- COORDINATE TRAFFIC CONTROLLER PROGRAMMING MODIFICATION WITH REPRESENTATIVES OF THE CITY OF PITTSBURGH AND DISTRICT TRAFFIC UNIT.
- 2. INCLUDE A TRANSIT PRIORITY PHASE THAT WILL EXTEND THE INDICATED PHASE A MAXIMUM OF 10 SECONDS WHEN ACTIVATED BY A PORT AUTHORITY VEHICLE. DO NOT VIOLATE SIDE STREET PEDESTRIAN MINIMUM TIMINGS.
- 3. MAINTAIN ALL YELLOW CLEARANCES AT ALL TIMES.
- 4. PROCEED TO THE SUBSEQUENT INTERVAL AS DEFINED IN THE MOVEMENT, SEQUENCE AND TIMING DIAGRAM UPON COMPLETING THE GREEN EXTENSION INTERVAL.
- 5. ONCE A TRANSIT CALL IS PLACED AND SATISFIED, THE CONTROLLER WILL NOT SATISFY ANOTHER CALL FOR
- 6. LOCATION OF BUS DETECTORS ARE TO BE FIELD ADJUSTED TO ACHIEVE MAXIMUM OPERATION.

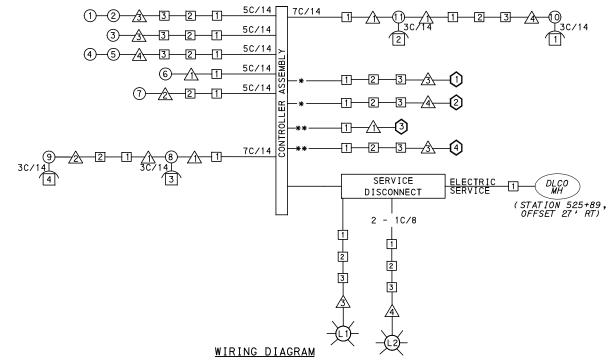

5C/14 - CABLE(NO. OF CONDUCTORS/SIZE AWG.)

SIGNAL HEAD

A SIGNAL SUPPORT

AUDIBLE PEDESTRIAN | JUNCTION BOX INDICATOR

RADAR DETECTOR

—(I)—LUMINAIRE

- INCIDENTAL TO ITEM 02895.001, AS PER MANUFACTURERS SPECIFICATIONS 3C/14 INCIDENTAL TO ITEM 02895.002
- INCIDENTAL TO ITEM 02895.005, AS PER MANUFACTURERS SPECIFICATIONS

GENERAL NOTES

THE CITY OF PITTSBURGH SHALL INSPECT THE NEW SIGNAL EQUIPMENT PRIOR TO ACTIVATION.

ALL TRAFFIC SIGNAL MAINTENANCE AND OPERATION RESPONSIBILITIES SHALL BE TURNED OVER TO THE CITY OF PITTSBURGH AFTER THE FOLLOWING CONDITIONS ARE IMPLEMENTED TO THE CITY'S SATISFACTION:

- 1. PERMIT "AS-BUILT" TRAFFIC SIGNAL DRAWINGS ARE SUBMITTED AND APPROVED.
- 2. ALL PUNCH LIST ITEMS ARE COMPLETED BY THE CONTRACTOR.
- 3. AFTER THE 30-DAY CONTINUOUS UNINTERRUPTED SIGNAL OPERATION WITHOUT MALFUNCTIONS.

CONSTRUCTION NOTES

- 1. ALL JUNCTION BOXES IN WALK AREAS TO BE CITY OF PITTSBURGH STANDARD CONCRETE JUNCTION BOX, TYPE 1.
- 2. ALL JUNCTION BOXES IN NON-WALK AREAS TO BE CITY STANDARD JB-2 WITH BOTTOM.
- 3. THERE SHALL BE NO SIGNAL WIRE OR FIBER CABLE SPLICING.
- 4. SERVICE WIRE FROM THE POWER SOURCE TO THE CONTROLLER CABINET SHALL BE PLACED IN SECONDARY SEPARATE CONDUIT.
- 5. STREET LIGHT CABLE IS NOT PERMITTED TO RUN THROUGH THE CONTROLLER CABINET AND SHALL BE PLACED IN SEPARATE CONDUIT.
- 6. TRAFFIC SIGNAL CABLE SHALL BE PLACED IN DEDICATED
- 7. MOUNT DISCONNECT ON POLE NEAREST TO THE CONTROLLER CABINET EXCLUDING TYPE X POLES.
- 8. REMOVE AND DISPOSE OF ALL EXISTING SIGNAL WIRING NO LONGER IN USE.
- 9. REMOVE EXISTING SIGNAL EQUIPMENT NO LONGER IN USE AND RETURN TO THE CITY OF PITTSBURGH TRAFFIC CONTROL SHOP. COORDINATE DELIVERY OF EQUIPMENT WITH DELMAS MCELHANY, TRAFFIC CONTROL FOREMAN.

TS-325

_	ALIEU ODIEV OE ALLEGUENV O		_
	DISTRICT TRAFFIC ENGINEER	DATE	_
	APPROVED AND ACCEPTED:		
		DATE	
	CITY TRAFFIC ENGINEER	DATE	_
	AFFROVED AND ACCEPTED:		
	APPROVED AND ACCEPTED:		
	AND HALKET STREET		
	INTERSECTION: FIFTH AVENUE		
	MUNICIPALITY: CITY OF PITTSBURGH		
	COUNTY: ALLEGHENY		

AECOM

Gulf Tower 707 Grant Street 5th Floor Pittsburgh, PA 15219 ((₁DRIVE **ENGINEERING**

595 Skippack Pk, Suite 400 Blue Bell, PA 19422

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		OF 1964. AS AMENDED, FOR THE
DATE	DESCRIPTION	PORT AUTHORITY OF ALLEGHENY COUNTY, PENNSYLVANIA.
	REVISIONS	COONTT, FENING LEVANIA.

(NOT FOR CONSTRUCTION)

ESIGNED	MW	
DRAWN	<u>MW</u>	
CHECKED	EMC	
N CHARGE	<u>EMC</u>	
ATE	05/01/24	
CALE		
	AS SHOWN	

PORT AUTHORITY OF ALLEGHENY COUNTY

BUS RAPID TRANSIT UPTOWN TO OAKLAND SIGNAL PLANS WIRING, MOVEMENT, PHASING & SEQUENCE DIAGRAMS

Port Authority

CONTRACT NO. BRT-001 DWG.NO. SG52 sнт. 1112

FIFTH AVENUE AND HALKET STREET

ITEM NUMBER	MISC	ELLAN	EOUS	
UNIT	DESCRIPTION	QTY.	LOCATION	REMARKS
01882 .002 EACH	TRAFFIC SIGNAL TIMING MODIFICATIONS	2	CC	
02890. 001 EACH	TRAFFIC SIGNAL CONTROLLER ASSEMBLY, TYPE 2070 LC, WITH TYPE 332 BASE MOUNTED CABINET(MOD)	1	CC	332 CONTROLLER CABINET 8" RISER
02890. 003 EACH	ETHERNET SWITCH	1	СС	
02894. 001 EACH	VEHICULAR SIGNAL HEAD, THREE 12" SECTIONS	4	(1)(2) (4)(5)	BLACK TUNNEL VISORS BLACK ALUMINUM HOUSINGS BLACK METAL LOUVERED BACKPLATE
02894. 001 EACH	VEHICULAR SIGNAL HEAD, THREE 12" SECTIONS	1	3	BLACK TUNNEL VISORS BLACK ALUMINUM HOUSINGS BLACK METAL LOUVERED BACKPLATE SIGNAL LOUVERS
02894. 004 EACH	BICYCLE SIGNAL HEAD, THREE 8" SECTIONS	2	67	BLACK TUNNEL VISORS BLACK ALUMINUM HOUSINGS
02894. 005 EACH	LED COUNTDOWN PEDESTRIAN SIGNAL HEAD, TYPE A	4	89 101)	BLACK TUNNEL VISORS BLACK ALUMINUM HOUSINGS
02895. 002 EACH	ACCESSIBLE PEDESTRIAN SIGNALS	4	112	
02889. 002 EACH	LED LUMINAIRE CITY STANDARD, BLACK	2	\	<u>\$</u> & <u>4</u>
02890. 005 EACH	GPS TIME CLOCK	1	CC	
02212. 009 LF	POLE FOUNDATION DRILLING, LESS THAN 30" DIAMETER	15	<u> </u>	
02212. 010 LF	POLE FOUNDATION DRILLING, 30" DIAMETER OR GREATER	24	<u> </u>	

DETECTORS

ITEM NUMBER	DESCRIPTION	SEN. NO.	QTY.	LOCATION
02895 . 001	VIDEO DETECTION	<u> </u>	2	3 4
EACH				20213
02895 . 005	DIGITAL WAVE RADAR DETECTION	(3) (4)	2	1/3
EACH		_ ~ ~		

TRAFFIC SIGNAL SUPPORTS **

	¥Ш «	NH N			NO NO				MAST ARM											PEDES ⁻		-				
POLE NO.	1 TEM NUMBER	DESCRIPTION	aT.	ROUTE	l → l		FFSE				ARM "A"						ARM "C"			SHAFT	SIG	NAL				
	_				S1		9F	Н	K		SIGN	NAL I	_OCA	TION	5	IGN	LOCA	10 I T	1	w	G	х	z	н	м	N
	UNIT										М	N	0	Р	R	S	Т	U	Υ	"		^	_	- 11	141	_``_
\triangle	02892. 004 EACH	TRAFFIC SIGNAL SUPPORT, 19' TYPE X, PAINTED BLACK	1	FIFTH AVE.	526+08	RT	24′																	19′	17′	10′
2	02892. 004 EACH	TRAFFIC SIGNAL SUPPORT, 19' TYPE X, PAINTED BLACK	1	FIFTH AVE.	525+43	RT	22′																	19′	17′	10′
<u> </u>	02892. 209 EACH	TRAFFIC SIGNAL SUPPORT, 34' MAST ARM WITH LUMINAIRE ARM, 30' MOUNTING, PAINTED BLACK	1	FIFTH AVE.	525+46	LT	25′	17′		34′	39′	19′	8′		23′	12′			4′	0°		30′	0°			
4	02892. 207 EACH	TRAFFIC SIGNAL SUPPORT, 30' MAST ARM WITH LUMINAIRE ARM, 30' MOUNTING, PAINTED BLACK	1	FIFTH AVE.	526+16	LT	24′	17′	10′	30′	28′	18′			14′				9′	90°		30′	0°			

^{**} REFER TO PENNDOT TC-8800 TRAFFIC STANDARDS - SIGNALS FOR LETTER DESIGNATION

AECOM

Gulf Tower 707 Grant Street 5th Floor Pittsburgh, PA 15219

((DRIVE ENGINEERING 595 Skippack Pk, Suite 400 Blue Bell, PA 19422

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_			TRANSPORTATION, UNDER THE URBAN MASS TRANSPORTATION ACT
			OF 1964, AS AMENDED, FOR THE
NO.	DATE	DESCRIPTION	PORT AUTHORITY OF ALLEGHENY COUNTY, PENNSYLVANIA.
		REVISIONS	COUNTY, PENNSTEVANIA.

(NOT FOR CONSTRUCTION)

DESIGNED	MW	
DRAWN	MW	
CHECKED	EMC	
IN CHARGE	<u>EMC</u>	
DATE	05/01/24	
SCALE		
	AS SHOWN	

PORT AUTHORITY OF ALLEGHENY COUNTY BUS RAPID TRANSIT UPTOWN TO OAKLAND SIGNAL PLANS TRAFFIC SIGNAL TABULATIONS

Port Authority connecting people to life

CONTRACT NO. BRT-001

DWG. NO. SG53 sнт. 1113

FIFTH AVENUE AND HALKET STREET

TRENCH, CONDUIT, JUNCTION BOX, ELECTRICAL ITEMS

DESCRIPTION	2 INCH CONDUIT	3 INCH CONDUIT	TRENCH AND BACKFILL, TYPE I	TRENCH AND BACKFILL, TYPE II	TRENCH AND BACKFILL, TYPE IV	AWG 8, UNDERGROUND CABLE, COPPER, 1 CONDUCTOR	SIGNAL CABLE, 14 AWG, 5 CONDUCTOR	SIGNAL CABLE, 14 AWG, 7 CONDUCTOR	ELECTRICAL SERVICE TYPE C (NEW)	CITY OF PITTSBURGH STANDARD CONCRETE JUNCTION BOX, TYPE 1
ITEM NUMBER	02899	02899	02898	02898	02898	02900	02900	02900	02896	02897
	002	003	001	002	005	001	002	003	004	001
UNIT	LF	LF	LF	LF	LF	LF	LF	LF	EACH	EACH
LOCATION										
сс то 1	6	6	3							1
1 TO 2	37	74	6	1	30					1
2 TO 3	61	122		9	52					1
		8	8							
<u>∕2</u> TO 2		22		22						
<u>₹</u> то 3	27	54		27						
<u>A</u> TO 3	40	80	11	29						
ELECTRICAL SERVICE (STA 161+61, TO 1 OFFSET 19.5' RT)	14		7		7					
COMPLETE INTERSECTION						439	877	430	1	
TOTAL	185	366	35	88	89	439	877	430	1	3

SIGNS

SYMBOL	SERIES	SIZE	AREA EACH (SQ FT)	DESCRIPTION	QUANTITY	02891,001 MOUNTED SIGNS, TYPE B	O2891,003 MOUNTED SIGNS, TYPE F	STRUCTURE MOUNTED FLAT SHEET ALUMINUM SIGNS WITH STIFFENERS
<u>C</u>	R3-1	30"×30"	6.3	NO RIGHT TURN	1		•	6.3
▲ ①	R10-3E(MOD)	9"×15"	. 9	EDUCATIONAL PUSH BUTTON FOR WALK SIGNAL WITH COUNTDOWN TIMER	4			A
E	D3-4*	66 "x24 "	11	3300 OAKLAND 3400 FIFTH AVE	1			11
E	D3-4*	60"x24"	10	100 OAKLAND HALKET ST	1			10
<u>©</u>	R9-3	18"×18"	2.3	NO PEDESTRIAN CROSSING	2		4.5	
M	SPECIAL	30"×30"	6.3	BUS LANE SIGNAL	1			6.3
P	R10-10B	30"x30"	6.3	TURNING TRAFFIC MUST YIELD TO BIKES AND PEDS	2	6.3		6.3
R	R3-7bP	24"x12"	2	EXCEPT BICYCLES	3		4	2
\bigcirc	R5-1	30"×30"	6.3	DO NOT ENTER	3	6.3	6.3	6.3
				TOTAL		12.6	14.8	48.2

▲ - INCIDENTAL TO ITEM #02895.002

* WHITE REFLECTORIZED LEGEND AND BORDER ON BLUE REFLECTORIZED BACKGROUND.
UTILIZE 4" CLEARVIEW 3W FOR BLOCK/NEIGHBORHOOD AND 8" CLEARVIEW 3W FOR
STREET NAME. ACTUAL WIDTH DETERMINED BY LETTER SPACING. COORDINATE BLOCK
NUMBERS AND STREET NAME DETAILS WITH CITY OF PITTSBURGH DEPARTMENT OF
MOBILITY AND INFRASTRUCTURE.

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Gulf Tower 707 Grant Street 5th Floor Pittsburgh, PA 15219 ((* DRIVE ENGINEERING 595 Skippack Pk, Suite 400

Blue Bell, PA 19422

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-			OF 1964, AS AMENDED, FOR THE
NO.	DATE	DESCRIPTION	PORT AUTHORITY OF ALLEGHENY COUNTY, PENNSYLVANIA.
		REVISIONS	COONTY, FEMNOTEVANIA.

(NOT FOR CONSTRUCTION)

DESIGNED	MW	PORT AUTHOR	ITY OF AL	LEGHENY COL	JNTY
DRAWN	MW	PITTSBURGH		PENNS	SYLVANIA
CHECKED	<u>EMC</u>	BUS RAPID TE	RANSIT UPT	OWN TO OAKLA	AND
IN CHARGE	<u>EMC</u>		S I GNAL PL		
DATE	<u>05/01/24</u>	TRAF	FIC SIGNAL T	ABULATIONS	
SCALE	AS SHOWN	Port Authority	CONTR	ACT NO. BRT-00)1
	AS SHOWN	connecting people to life	DWG. NO.	SG54	sнт. 1114

5th Floor

Pittsburgh, PA 15219

Suite 400


Blue Bell, PA 19422

NO. DATE

DESCRIPTION

REVISIONS

<u>SIGNS</u>

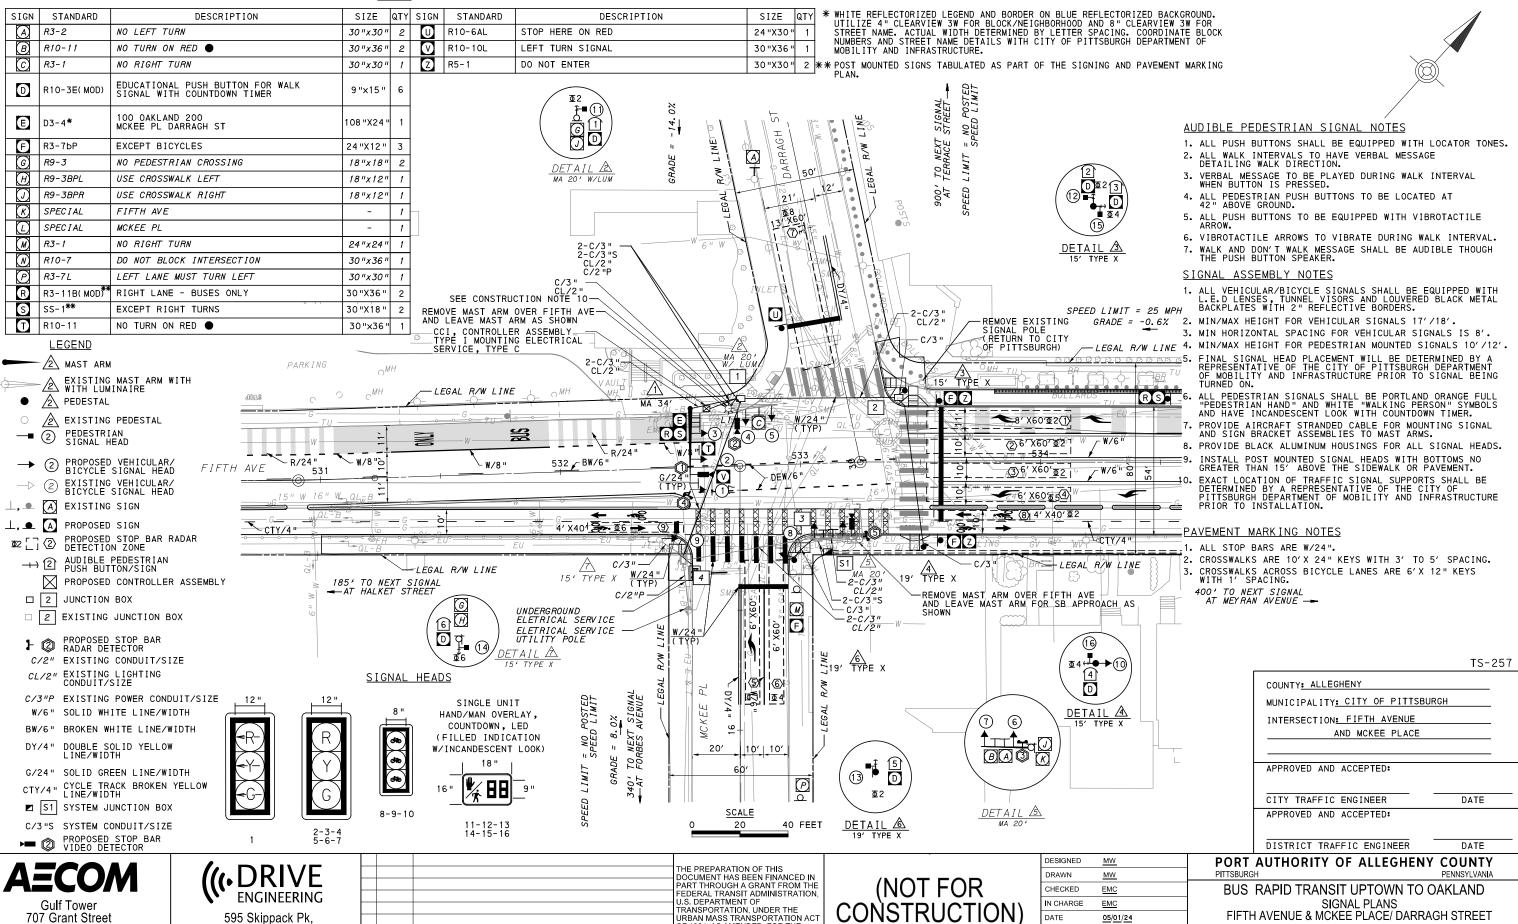

OF 1964 AS AMENDED FOR THE

COUNTY, PENNSYLVANIA.

SCALE

AS SHOWN

CONTRACT NO. BRT-001


sнт. 1115

SG55

DWG NO

Port Authority

		PH	ASE	2+6	,		PH	ASE	2+5			PHA	SE ·	4+8		
	BIK	BIKE BIKE				BIKE BIKE					BIKE-					EMEREGENCY
SIGNAL	1	2	3	4		1	2	3	4		1	2	3	4		
1	-R -	- R-	-R	- R-		- -G-	- G−	- Y−	- R−		- R-	-R -	-R	- R−		0FF
2-3	G	G	G	G		G	G	Υ	R		R	R	R	R		R
4-5	R	R	R	R		R	R	R	R		G	G	Υ	R		R
6-7	R	R	R	R		R	R	R	R		G	G	Υ	R		R
8-9-10	G	G	Υ	R		R	R	R	R		R	R	R	R		0FF
11-12	W	W	W	W		W	FD	DW	DW		DW	DW	DW	DW		0FF
13-14	W	FD	DW	DW		DW	DW	DW	DW		DW	DW	DW	DW		0FF
15-16	DW	DW	DW	DW		DW	DW	DW	DW		W	FD	DW	DW		0FF
FIXED	\geq	\leq	3	4		\geq	\leq	3.5	3.5		> <		3.5	3.5		
MINIMUM	8	3				1	8				15					
PASSAGE	;	3				,	3				,	3				
FREE (MAX)	2	0				3	8				3	1				
PEDESTRIAN	7	13				7 13					7	16				
MEMORY		PED	REC	CALL			MIN	REC	CALL			PED	REC	ALL		

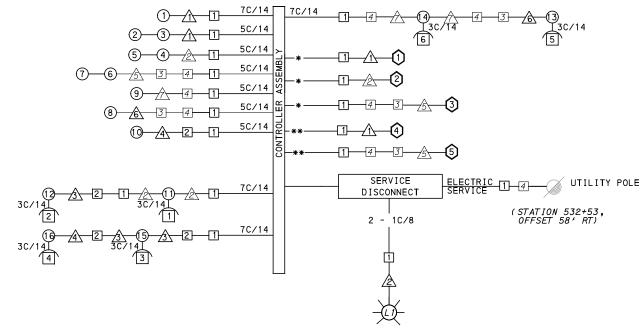

WIRING DIAGRAM

5C/14 - CABLE(NO. OF CONDUCTORS/SIZE AWG.)

SIGNAL HEAD

AUDIBLE PEDESTRIAN | JUNCTION BOX

RADAR DETECTOR

-L1)-LUMINAIRE

3C/14 INCIDENTAL TO ITEM 02895.002

- INCIDENTAL TO ITEM 02895.001 AS PER MANUFACTURERS SPECIFICATIONS
- INCIDENTAL TO ITEM 02895.005, AS PER MANUFACTURERS SPECIFICATIONS

DETECTOR ZONE INFORMATION

DETECTOR	DETECTION ZONE(S)	MODE	TYPE	ROUTE	PHASE	LOCATION MAST ARM
①	(8' × 60')	PRESENCE	VIDEO (STOP BAR)	FIFTH AVE.	2	\triangle
0	② (6' × 60')	PRESENCE	VIDEO (STOP BAR)	FIFTH AVE.	2	\triangle
0	③ (6'× 60')	PRESENCE	VIDEO (STOP BAR)	FIFTH AVE.	2	\triangle
()	⟨4⟩ (6′ × 60′)	PRESENCE	VIDEO (STOP BAR)	FIFTH AVE.	5	\triangle
2	⟨5⟩ (6′ × 60′)	PRESENCE	VIDEO (STOP BAR)	MCKEE PL.	8	2
2	⑥ (6′ × 60′)	PRESENCE	VIDEO (STOP BAR)	MCKEE PL.	8	2
3	⟨7⟩ (13′ × 60′)	PRESENCE	VIDEO (STOP BAR)	DARRAGH ST.	8	<u>\$</u>
(5)	(8) (4' × 40')	PRESENCE	RADAR (STOP BAR)	FIFTH AVENUE BICYCLE LANE	2	<u>\$</u>
4	⑤ (4′× 40′)	PRESENCE	RADAR (STOP BAR)	FIFTH AVENUE BICYCLE LANE	2	\triangle

GENERAL NOTES

THE CITY OF PITTSBURGH SHALL INSPECT THE NEW SIGNAL EQUIPMENT PRIOR TO ACTIVATION.

ALL TRAFFIC SIGNAL MAINTENANCE AND OPERATION RESPONSIBILITIES SHALL BE TURNED OVER TO THE CITY OF PITTSBURGH AFTER THE FOLLOWING CONDITIONS ARE IMPLEMENTED TO THE CITY'S SATISFACTION:

- 1. PERMIT "AS-BUILT" TRAFFIC SIGNAL DRAWINGS ARE SUBMITTED AND APPROVED.
- 2. ALL PUNCH LIST ITEMS ARE COMPLETED BY THE CONTRACTOR.
- 3. AFTER THE 30-DAY CONTINUOUS UNINTERRUPTED SIGNAL OPERATION WITHOUT MALFUNCTIONS.

CONSTRUCTION NOTES

- 1. ALL JUNCTION BOXES IN WALK AREAS TO BE CITY OF PITTSBURGH STANDARD CONCRETE JUNCTION BOX, TYPE 1.
- 2. ALL JUNCTION BOXES IN NON-WALK AREAS TO BE CITY STANDARD JB-2 WITH BOTTOM.
- 3. THERE SHALL BE NO SIGNAL WIRE OR FIBER CABLE SPLICING.
- 4. SERVICE WIRE FROM THE POWER SOURCE TO THE CONTROLLER CABINET SHALL BE PLACED IN SECONDARY SEPARATE CONDUIT.
- 5. STREET LIGHT CABLE IS NOT PERMITTED TO RUN THROUGH THE CONTROLLER CABINET AND SHALL BE PLACED IN SEPARATE CONDUIT.
- 6. TRAFFIC SIGNAL CABLE SHALL BE PLACED IN DEDICATED CONDUIT.
- 7. MOUNT DISCONNECT ON POLE NEAREST TO THE CONTROLLER CABINET EXCLUDING TYPE X POLES.
- 8. REMOVE AND DISPOSE OF ALL EXISTING SIGNAL WIRING NO LONGER IN USE.
- 9. REMOVE EXISTING SIGNAL EQUIPMENT NO LONGER IN USE AND RETURN TO THE CITY OF PITTSBURGH TRAFFIC CONTROL SHOP. COORDINATE DELIVERY OF EQUIPMENT WITH DELMAS MCELHANY, TRAFFIC CONTROL FOREMAN.
- 10. SEE 01720 UTILITY COORDINATION FOR INFORMATION ON RELOCATION OF EXISTING SECURITY CAMERAS AND SHOT SPOTTERS
- 11. REMOVE ALL SIGNALS WHILE POLE IS PAINTED. REFER TO SECTION 02892.

TS-257

COUNTY: ALLEGHENY	
MUNICIPALITY: CITY OF PITTSBURGH	
INTERSECTION: FIFTH AVENUE	
AND MCKEE PLACE	
APPROVED AND ACCEPTED:	
CITY TRAFFIC ENGINEER DATE	
APPROVED AND ACCEPTED:	
DISTRICT TRAFFIC ENGINEER DATE	
AUTUODITY OF AUTEOUENIX COUNTY	

AECOM

TRANSIT PRIORITY PRE-EMPTION NOTES (TO BE INSTALLED BY OTHERS)

3. MAINTAIN ALL YELLOW CLEARANCES AT ALL TIMES.

COORDINATE TRAFFIC CONTROLLER PROGRAMMING MODIFICATION WITH REPRESENTATIVES OF THE CITY OF PITTSBURGH AND DISTRICT TRAFFIC UNIT.

2. INCLUDE A TRANSIT PRIORITY PHASE THAT WILL EXTEND THE INDICATED PHASE A MAXIMUM OF 10 SECONDS WHEN ACTIVATED BY A PORT AUTHORITY VEHICLE. DO NOT VIOLATE SIDE STREET PEDESTRIAN MINIMUM TIMINGS.

4. PROCEED TO THE SUBSEQUENT INTERVAL AS DEFINED IN THE MOVEMENT, SEQUENCE AND TIMING DIAGRAM UPON COMPLETING THE GREEN EXTENSION INTERVAL.

5. ONCE A TRANSIT CALL IS PLACED AND SATISFIED, THE CONTROLLER WILL NOT SATISFY ANOTHER CALL FOR

6. LOCATION OF BUS DETECTORS ARE TO BE FIELD ADJUSTED TO ACHIEVE MAXIMUM OPERATION.

Gulf Tower 707 Grant Street 5th Floor Pittsburgh, PA 15219 ((₁DRIVE **ENGINEERING** 595 Skippack Pk,

Suite 400

Blue Bell, PA 19422

THE PREPARATION OF THIS DOCUMENT HAS BEEN FINANCED IN PART THROUGH A GRANT FROM THE FEDERAL TRANSIT ADMINISTRATION U.S. DEPARTMENT OF TRANSPORTATION, UNDER THE URBAN MASS TRANSPORTATION ACT OF 1964 AS AMENDED FOR THE NO. DATE DESCRIPTION COUNTY, PENNSYLVANIA. REVISIONS

(NOT FOR CONSTRUCTION)

ESIGNED	MW	
RAWN	MW	
HECKED	EMC	
CHARGE	<u>EMC</u>	
ATE	05/01/24	
CALE		

PORT AUTHORITY OF ALLEGHENY COUNTY PENNSYLVANIA BUS RAPID TRANSIT UPTOWN TO OAKLAND

SIGNAL PLANS WIRING, MOVEMENT, PHASING & SEQUENCE DIAGRAMS

Port Authority

CONTRACT NO. BRT-001 SG56 sнт. 1116 DWG NO

AS SHOWN

|--|

FIFTH AVENUE AND MCKEE PLACE/DARRAGH ST

ITEM NUMBER	MISCE	ELLAN	EOUS	
UNIT	DESCRIPTION	QTY.	LOCATION	REMARKS
02890. 001 EACH	TRAFFIC SIGNAL CONTROLLER ASSEMBLY, TYPE 2070 LC, WITH TYPE 332 BASE MOUNTED CABINET(MOD)	1	СС	332 CONTROLLER CABINET 8" RISER
02890. 003 EACH	ETHERNET SWITCH	1	СС	
02890. 005 EACH	GPS TIME CLOCK	1	СС	
02894. 001 EACH	VEHICULAR SIGNAL HEAD, THREE 12" SECTIONS	6	123 456	BLACK TUNNEL VISORS BLACK ALUMINUM HOUSINGS BLACK METAL LOUVERED BACKPLATE
02894. 004 EACH	BICYCLE SIGNAL HEAD, THREE 8 " SECTIONS	3	890	BLACK TUNNEL VISORS BLACK ALUMINUM HOUSINGS
02894. 005 EACH	LED COUNTDOWN PEDESTRIAN SIGNAL HEAD, TYPE A	6	(1)(1)(1)(1)(1)(1)(1)(1)(1)(1)(1)(1)(1)(BLACK TUNNEL VISORS BLACK ALUMINUM HOUSINGS
02895. 002 EACH	ACCESSIBLE PEDESTRIAN SIGNALS	6	1123 1456	
02897. 011 EACH	CONNECT TO EXISTING JUNCTION BOX	2	3 4	
02893. 003 EACH	REMOVE EXISTING MAST ARM	2		NW CORNER SE CORNER
02899. 007 EACH	INSTALL CONDUIT TO EXISTING TRAFFIC SIGNAL SUPPORT	1	2	
01882. 002 EACH	TRAFFIC SIGNAL TIMING MODIFICATIONS	2	СС	
02892. 501 EACH	EXISTING TRAFFIC SIGNAL SUPPORT, PAINTED BLACK	3	<u> </u>	TEMPORARILY REMOVE ATTACHED SIGNAL HARDWARE AND PAINT SIGNAL SUPPORT BLACK. REATTACH HARDWARE WHEN COMPLETE.
02212. 009 LF	POLE FOUNDATION DRILLING, LESS THAN 30" DIAMETER	20	346	
02212. 010 LF	POLE FOUNDATION DRILLING, 30" DIAMETER OR GREATER	13	\triangle	

DETECTORS

ITEM NUMBER	DESCRIPTION	SEN. NO.	QTY.	LOCATION
02895.	VIDEO DETECTION		3	125
EACH 02895.		<u> </u>		
005	DIGITAL WAVE RADAR DETECTION	4 5	2	<u> </u>
EACH		~ ~		

TRAFFIC SIGNAL SUPPORTS **

	ΣШ «		PORT, 20' MAST ARM WITH FIFTH AVE. 532+70 LT 23' 17' 10' 20' 17' 6' 11' 270° PORT, 15' TYPE X, PAINTED 1 FIFTH AVE. 533+25 RT 31' 17' 20' 18' 6' 14' 10' 270° FIFTH AVE. 533+25 RT 31' 17' 20' 18' 6' 14' 10' 270°		PEDE	PEDESTAL																				
POLE NO.	I TEM NUMBER	DESCRIPTION	αΤΥ.	ROUTE	₩	SIDE	FSE							ARM	"A"						A	RM "	С"	SHAFT	SIG	NAL
	_				ST	"	9	н	К	L	SIGN	NAL I	OCA	TION	:	SIGN	LOC	ATIO	N	w	G	x	z	Н	м	N
	UNIT										М	N	0	Р	R	S	Т	U	Υ					• •		
\triangle	02892. 605 EACH	TRAFFIC SIGNAL SUPPORT, 34' MAST ARM, PAINTED BLACK	1	FIFTH AVE.	532+54	LT	23′	17′		34′	33′	21′	10′		31′	16′	7′		4′	0°						
2		TRAFFIC SIGNAL SUPPORT, 20' MAST ARM WITH LUMINAIRE ARM, 30' MOUNTING		FIFTH AVE.	532+70	LT	23'	17 '	10′	20 '	17′	6′			11'					270	•					
<u> </u>	02892. 003 EACH	TRAFFIC SIGNAL SUPPORT, 15' TYPE X, PAINTED BLACK	1	FIFTH AVE.	533+43	LT	30′																	15′		10′
4	02892. 003 EACH	TRAFFIC SIGNAL SUPPORT, 15' TYPE X, PAINTED BLACK	1	FIFTH AVE.	533+51	RT	34′																	15′	15′	10′
<u> </u>		TRAFFIC SIGNAL SUPPORT, 20' MAST ARM		FIFTH AVE.	533+25	RT	31 '	17 '		20 '	18′	6′			14'	10'				270°						
<u> </u>	02892. 004 EACH	TRAFFIC SIGNAL SUPPORT, 19' TYPE X, PAINTED BLACK	1	FIFTH AVE.	532+97	RT	38′																	19′	15′	10′
\triangle		TRAFFIC SIGNAL SUPPORT, 15' TYPE X		FIFTH AVE.	532+41	RT	29 '																	15'	15′	10′

** REFER TO PENNDOT TC-8800 TRAFFIC STANDARDS - SIGNALS FOR LETTER DESIGNATION

AECOM

((DRIVE ENGINEERING Gulf Tower 707 Grant Street 5th Floor Pittsburgh, PA 15219 595 Skippack Pk, Suite 400 Blue Bell, PA 19422

		THE PREPARATION OF THIS DOCUMENT HAS BEEN FINANCED IN PART THROUGH A GRANT FROM THE FEDERAL TRANSIT ADMINISTRATION, U.S. DEPARTMENT OF TRANSPORTATION, UNDER THE URBAN MASS TRANSPORTATION ACT OF 1964. AS AMENDED, FOR THE
DATE	DESCRIPTION	PORT AUTHORITY OF ALLEGHENY COUNTY, PENNSYLVANIA.
	REVISIONS	COUNTY, FEMINSTEVANIA.

(NOT FOR CONSTRUCTION)

DESIGNED	MW	
DRAWN	MW	
CHECKED	EMC	
IN CHARGE	EMC	
DATE	05/01/24	
SCALE		
	AS SHOWN	

PORT AUTHORITY OF ALLEGHENY COUNTY

BUS RAPID TRANSIT UPTOWN TO OAKLAND SIGNAL PLANS TRAFFIC SIGNAL TABULATIONS

CONTRACT NO. BRT-001 DWG. NO. SG57

Port Authority connecting people to life

sнт. 1117

FIFTH AVENUE AND MCKEE PLACE/DARRAGH STREET

TRENCH, CONDUIT, JUNCTION BOX, ELECTRICAL ITEMS

DESCRIPTION	2 INCH CONDUIT	3 INCH CONDUIT	TRENCH AND BACKFILL, TYPE I	TRENCH AND BACKFILL, TYPE II	TRENCH AND BACKFILL, TYPE IV	SIGNAL CABLE, 14 AWG, 5 CONDUCTOR	SIGNAL CABLE, 14 AWG, 7 CONDUCTOR	ELECTRICAL SERVICE TYPE C (EXISTING)	CITY OF PITTSBURGH STANDARD CONCRETE JUNCTION BOX, TYPE 1	8 AWG, UNDERGROUND CABLE, COPPER, 1 CONDUCTOR
ITEM NUMBER	02899	02899	02898	02898	02898	02900	02900	02896	02897	02900
TTEM NOMBER	002	003	001	002	005	002	003	003	001	001
UNIT	LF	LF	LF	LF	LF	LF	LF	EACH	EACH	LF
LOCATION					I					
сс то []	24	24		12					1	
4 TO 1	138	276	5	5	59					
	20	40		20						
то □	4	4		4						
2 TO 1	63	125	2	8	53				1	
<u>√3</u> TO 2		3	3							
<u>4</u> TO 2		63	9		54					
_€ то З		12	12							
S1 T0 3		10	5							
ELECTRICAL SERVICE (STA 532+53, TO 3 OFFSET 58' RT)										
COMPLETE INTERSECTION						1018	798	1		85
TOTAL	249	557	36	49	166	1018	798	1	2	85

S1 - TABULATED ON SYSTEMS PLAN

SIGNS

				310113				
SYMBOL	SERIES	SIZE	AREA EACH (SQ FT)	DESCRIPTION	QUANTITY	O2891,001 MOUNTED SIGNS, TYPE B	02891.003 MOUNTED SIGNS, TYPE F	O2891.007 OSTRUCTURE MOUNTED FLAT SHEET ALUMINUM SIGNS WITH STIFFENERS
	R10-3E(MOD)	9"x15"	.9	EDUCATIONAL PUSH BUTTON FOR WALK SIGNAL WITH COUNTDOWN TIMER	6	31	31	<u> </u>
E	D3-4*	108"×24'	18	100 OAKLAND 200 MCKEE PL DARRAGH ST	1			18
R	R3-7bP	24"x12"	2	EXCEPT BICYCLES	3		6	
R	R3-11B(MOD)	30"x36"	7.5	RIGHT LANE - BUSES ONLY	1			7.5
<u>s</u>	SS-1	30"x18"	3.8	EXCEPT RIGHT TURNS	1			3.8
1	R10-11	30"x36"	7.5	NO TURN ON RED ●	1			7.5
0	R10-6AL	24"x30"	5	STOP HERE ON RED	1	5		
∇	R10-10L	30"x36"	7.5	LEFT TURN SIGNAL	1			7.5
\square	R5-1	30"x30"	6.3	DO NOT ENTER	2	12.6		
		ı	ı	TOTAL		17.6	6	44.3
■ _ TNI	CIDENTAL TO	TTEM #O	2005 002					

- INCIDENTAL TO ITEM #02895.002

* WHITE REFLECTORIZED LEGEND AND BORDER ON BLUE REFLECTORIZED BACKGROUND.
UTILIZE 4" CLEARVIEW 3W FOR BLOCK/NEIGHBORHOOD AND 8" CLEARVIEW 3W FOR
STREET NAME. ACTUAL WIDTH DETERMINED BY LETTER SPACING. COORDINATE BLOCK
NUMBERS AND STREET NAME DETAILS WITH CITY OF PITTSBURGH DEPARTMENT OF
MOBILITY AND INFRASTRUCTURE.

AECOM

Gulf Tower 707 Grant Street 5th Floor Pittsburgh, PA 15219 ((DRIVE ENGINEERING 595 Skippack Pk, Suite 400

Blue Bell, PA 19422

			DOCUMENT HAS BEEN FINANCED IN PART THROUGH A GRANT FROM THE FEDERAL TRANSIT ADMINISTRATION, U.S. DEPARTMENT OF TRANSPORTATION, UNDER THE LURBAN MASS TRANSPORTATION ACT
NO.	DATE	DESCRIPTION	OF 1964, AS AMENDED, FOR THE PORT AUTHORITY OF ALLEGHENY
		REVISIONS	COUNTY, PENNSYLVANIA.


(NOT FOR CONSTRUCTION)

DESIGNED	MW	PORT AUTHOR	ITY OF ALLEGHEN	Y COUNTY
DRAWN	MW	PITTSBURGH		PENNSYLVANIA
CHECKED	<u>EMC</u>	BUS RAPID TE	RANSIT UPTOWN TO	OAKLAND
IN CHARGE	EMC		SIGNAL PLANS	PENNSYLVANIA TO OAKLAND TIONS O. BRT-001
DATE	05/01/24	TRAF	FIC SIGNAL TABULATIO	NS
SCALE	AS SHOWN	Port Authority	CONTRACT NO.	BRT-001
	O OI IOVVIV	connecting people to life	DWG. NO. SG58	SHT. 1

sнт. 1118

OPERATOR: "michael.modarry"

		PH	IASE	2		PH	IASE	2+5	5		PH	IASE	4		
	ВІК	E		_BU: _BI	ВІК	<u> </u>	T	_BU: = - 	SIKE	- BI	KE-			US IKE	HLASHING
INTERVAL SIGNAL	1	2	3	4	1	2	3	4		1	2	3	4	5	
1	- R−	- R−	+	- R−	 G-	- G-	- Y-	- R−		- R−	- R−	-R	- R-	- R−	0FF
2-3	G	G	G	G	G	G	Υ	R		R	R	R	R	R	R
4-5	R	R	R	R	R	R	R	R		R	G	G	Υ	R	R
6-7	G	G	Υ	R	R	R	R	R		R	R	R	R	R	0FF
8-9	DW	DW	DW	DW	DW	DW	DW	DW		W	W	FD	DW	DW	0FF
10-11	DW	DW	DW	DW	DW	DW	DW	DW		W	W	FD	DW	DW	0FF
12-13	W	FD	DW	DW	DW	DW	DW	DW		DW	DW	DW	DW	DW	0FF
FIXED	\supset	<	3	3	\supset	<	3	3			$\overline{}$	=	3	4	
MINIMUM	8	3			1	8					1	8			
PASSAGE		3			;	3						3			
FREE (MAX)	1	7			4	6					1	9]
PEDESTRIAN	7	10			7	10				5	2	16			
MEMORY		PED	REC	ALL		MIN	REC	CALL			PED	REC	CALL		

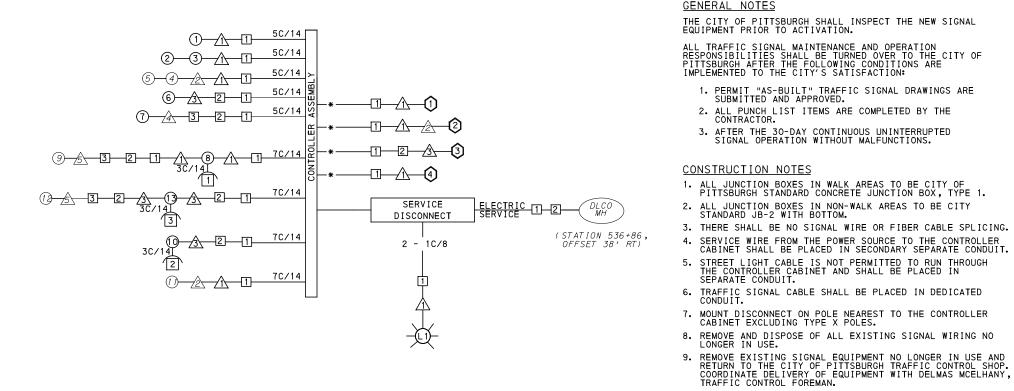

WIRING DIAGRAM

5C/14 - CABLE(NO. OF CONDUCTORS/SIZE AWG.)

SIGNAL HEAD

∆ SIGNAL SUPPORT

AUDIBLE PEDESTRIAN INDICATOR

☐ JUNCTION BOX

-L1)-LUMINAIRE RADAR DETECTOR

3C/14 INCIDENTAL TO ITEM 02895.002 INCIDENTAL TO ITEM 02895.001, AS PER MANUFACTURERS SPECIFICATIONS

** INCIDENTAL TO ITEM 02895.005 AS PER MANUFACTURERS SPECIFICATIONS

DETECTOR ZONE INFORMATION

DETECTOR	DETECTION ZONE(S)	MODE	TYPE	ROUTE	PHASE	LOCATION MAST ARM							
①	(7' × 60')	PRESENCE	VIDEO (STOP BAR)	FIFTH AVENUE	2	\triangle							
0	② (6' × 60')	PRESENCE	VIDEO (STOP BAR)	FIFTH AVENUE	2	\triangle							
0	③ (6′ × 60′)	PRESENCE	VIDEO (STOP BAR)	FIFTH AVENUE	2	\triangle							
0	⟨4⟩ (6′ × 60′)	PRESENCE	VIDEO (STOP BAR)	FIFTH AVENUE	5	\triangle							
2	⟨5⟩ (7′× 60′)	PRESENCE	VIDEO (STOP BAR)	MEYRAN AVE.	4	2							
3	⟨6⟩ (4′ × 40′)	PRESENCE	RADAR (STOP BAR)	FIFTH AVENUE BICYCLE LANE	2	4							
4	⟨₹⟩ (4′ × 40′)	PRESENCE	RADAR (STOP BAR)	FIFTH AVENUE BICYCLE LANE	2	\triangle							

TRANSIT PRIORITY PRE-EMPTION NOTES (TO BE INSTALLED BY OTHERS)

- COORDINATE TRAFFIC CONTROLLER PROGRAMMING MODIFICATION WITH REPRESENTATIVES OF THE CITY OF PITTSBURGH AND DISTRICT TRAFFIC UNIT.
- 2. INCLUDE A TRANSIT PRIORITY PHASE THAT WILL EXTEND THE INDICATED PHASE A MAXIMUM OF 10 SECONDS WHEN ACTIVATED BY A PORT AUTHORITY VEHICLE. DO NOT VIOLATE SIDE STREET PEDESTRIAN MINIMUM TIMINGS.
- 3. MAINTAIN ALL YELLOW CLEARANCES AT ALL TIMES.
- 4. PROCEED TO THE SUBSEQUENT INTERVAL AS DEFINED IN THE MOVEMENT, SEQUENCE AND TIMING DIAGRAM UPON COMPLETING THE GREEN EXTENSION INTERVAL.
- 5. ONCE A TRANSIT CALL IS PLACED AND SATISFIED, THE CONTROLLER WILL NOT SATISFY ANOTHER CALL FOR
- 6. LOCATION OF BUS DETECTORS ARE TO BE FIELD ADJUSTED TO ACHIEVE MAXIMUM OPERATION.

AECOM

Gulf Tower 707 Grant Street 5th Floor Pittsburgh, PA 15219



595 Skippack Pk, Suite 400 Blue Bell, PA 19422

DATE	DESCRIPTION REVISIONS	THE PREPARATION OF THIS DOCUMENT HAS BEEN FINANCED IN PART THROUGH A GRANT FROM THE FEDERAL TRANSIT ADMINISTRATION, U.S. DEPARTMENT OF TRANSPORTATION, UNDER THE URBAN MASS TRANSPORTATION ACT OF 1964, AS AMENDED, FOR THE PORT AUTHORITY OF ALLEGHENY COUNTY, PENNSYLVANIA.
------	-----------------------	---

(NOT FOR CONSTRUCTION)

DESIGNED	MW	
DRAWN	<u>MW</u>	
CHECKED	EMC	
N CHARGE	<u>EMC</u>	
DATE	05/01/24	
SCALE		
	AS SHOWN	

DISTRICT TRAFFIC ENGINEER PORT AUTHORITY OF ALLEGHENY COUNTY

COUNTY: ALLEGHENY

1. PERMIT "AS-BUILT" TRAFFIC SIGNAL DRAWINGS ARE SUBMITTED AND APPROVED.

CABINET SHALL BE PLACED IN SECONDARY SEPARATE CONDUIT.

2. ALL PUNCH LIST ITEMS ARE COMPLETED BY THE CONTRACTOR.

3. AFTER THE 30-DAY CONTINUOUS UNINTERRUPTED SIGNAL OPERATION WITHOUT MALFUNCTIONS.

10. CONTRACTOR IS TO MAINTAIN VEHICULAR SIGNAL HEAD VISIBILITY AT ALL TIMES DURING CONSTRUCTION.

11. REMOVE ALL SIGNALS WHILE POLE IS PAINTED. REFER TO SECTION 02892.

BUS RAPID TRANSIT UPTOWN TO OAKLAND SIGNAL PLANS WIRING, MOVEMENT, PHASING & SEQUENCE DIAGRAMS

MUNICIPALITY: CITY OF PITTSBURGH

AND MEYRAN AVENUE AND LOTHROP STREET

INTERSECTION: FIFTH AVENUE

APPROVED AND ACCEPTED:

CITY TRAFFIC ENGINEER

APPROVED AND ACCEPTED:

Port Authority

CONTRACT NO. BRT-001 DWG. NO. SG60 sнт. 1120

TS-59

DATE

DATE

PENNSYLVANIA

ITEM NUMBER	MISC	ELLAN	EOUS	
UNIT	DESCRIPTION	QTY.	LOCATION	REMARKS
02889. 002 EACH	LED LUMINAIRE CITY STANDARD, BLACK	1	-\X	\triangle
02890. 001 EACH	TRAFFIC SIGNAL CONTROLLER ASSEMBLY, TYPE 2070 LC, WITH TYPE 332 BASE MOUNTED CABINET(MOD)	1	СС	332 CONTROLLER CABINET 8" RISER
02890. 003 EACH	ETHERNET SWITCH	1	СС	
02894. 001 EACH	VEHICULAR SIGNAL HEAD, THREE 12" SECTIONS	3	123	BLACK TUNNEL VISORS BLACK ALUMINUM HOUSINGS BLACK METAL LOUVERED BACKPLATE
02894. 004 EACH	BICYCLE SIGNAL HEAD, THREE 8" SECTIONS	2	67	BLACK TUNNEL VISORS BLACK ALUMINUM HOUSINGS BLACK METAL LOUVERED BACKPLATE
02894. 005 EACH	LED COUNTDOWN PEDESTRIAN SIGNAL HEAD, TYPE A	3	803	BLACK TUNNEL VISORS BLACK ALUMINUM HOUSINGS
02895. 002 EACH	ACCESSIBLE PEDESTRIAN SIGNALS	3	1123	
02893. 001 EACH	REMOVE EXISTING POLE	2		NW CORNER AND SE CORNER
02899. 007 EACH	INSTALL CONDUIT TO EXISTING TRAFFIC SIGNAL SUPPORT	1	4	
02890. 005 EACH	GPS TIME CLOCK	1	CC	
01882 .002 EACH	TRAFFIC SIGNAL TIMING MODIFICATIONS	2	СС	
02892. 501 EACH	EXISTING TRAFFIC SIGNAL SUPPORT, PAINTED BLACK	1	<u>/5</u>	TEMPORARILY REMOVE ATTACHED SIGNAL HARDWARE AND PAINT SIGNAL SUPPORT BLACK. REATTACH HARDWARE WHEN COMPLETE.
02891. 013 EACH	RESET POST MOUNTED SIGNS, TYPE F	2	<u>/3\</u>	
02897. 012 EACH	REMOVE EXISTING JUNCTION BOX	1		SW CORNER
02212. 009 LF	POLE FOUNDATION DRILLING, LESS THAN 30" DIAMETER	8	<u> </u>	
02212. 010 LF	POLE FOUNDATION DRILLING, 30" DIAMETER OR GREATER	13	A	

TRAFFIC SIGNAL TABULATION FIFTH AVENUE AND MEYRAN AVENUE AND LOTHROP STREET

DETECTORS

ITEM NUMBER	DESCRIPTION	SEN. NO.	QTY.	LOCATION
02895 . 001	VIDEO DETECTION	<u> (1) (2)</u>	2	\wedge
EACH		~		>2=>
02895 . 005	DIGITAL WAVE RADAR DETECTION	(3) (A)	2	\wedge
EACH			_	

TRAFFIC SIGNAL SUPPORTS **

_					0 010117																					
	POLE	DESCRIPTION	;		NOI	ET ET		SET		MAST ARM											STAL					
	NO.		DESCRIPTION	QTY.	ROUTE		STATIO	L LL							ARM	"A"						AH	RM "C	ا "د	SHAFT	SIGNAL
						ST		ㅂ	Н	н к	SIGNAL LOCA		L LOCATION SIGN LOCATION					w	G	x	7	н	M N			
		UNI	T								_	М	N	0	Р	R	S	Т	U	Y	"		^	-	''	" '
	\triangle	0289 214 EACI	TRAFFIC SIGNAL SUPPORT, 46' MAST ARM WITH LUMINAIRE ARM (30' MOUNTING HEIGHT), PAINTED BLACK	1	FIFTH AVE.	536+70	LT	26′	17′	10′	46′	42′	24′	10′		40′	12′			3′	0°		30′	0°		
	2		TRAFFIC SIGNAL SUPPORT, 15' MAST ARM		FIFTH AVE.	537 + 19	LT	30 '	17 '	10'	15'	14'	5'			8 '				1 '	90°					
	3		TRAFFIC SIGNAL SUPPORT, 11' MAST ARM		FIFTH AVE.	537 +27	RT	30 '	17 '		11'										0°		30 '	0°		
	4	0289 004 EACI	— PAINIED BLACK	1	FIFTH AVE.	537+19	RT	40′																	19′	17′ 10′
	<u>/</u> 5\		TRAFFIC SIGNAL SUPPORT, 15' TYPE X		FIFTH AVE.	536+70	RT	30 '															30 '	0°	15'	15 ' 10 '

** REFER TO PENNDOT TC-8800 TRAFFIC STANDARDS - SIGNALS FOR LETTER DESIGNATION

AECOM

Gulf Tower 707 Grant Street 5th Floor Pittsburgh, PA 15219

((DRIVE ENGINEERING 595 Skippack Pk, Suite 400 Blue Bell, PA 19422

		THE PREPARATION OF THIS DOCUMENT HAS BEEN FINANCED IN PART THROUGH A GRANT FROM THE FEDERAL TRANSIT ADMINISTRATION, U.S. DEPARTMENT OF TRANSPORTATION, UNDER THE URBAN MASS TRANSPORTATION ACT OF 1964, AS AMENDED, FOR THE
DATE	DESCRIPTION	PORT AUTHORITY OF ALLEGHENY COUNTY, PENNSYLVANIA.
	REVISIONS	COUNTY, FEMINSTEVANIA.

(NOT FOR CONSTRUCTION)

DESIGNED	MW	
DRAWN	MW	
CHECKED	<u>EMC</u>	
IN CHARGE	EMC	
DATE	05/01/24	
SCALE		
	AS SHOWN	

PORT AUTHORITY OF ALLEGHENY COUNTY BUS RAPID TRANSIT UPTOWN TO OAKLAND

SIGNAL PLANS TRAFFIC SIGNAL TABULATIONS

CONTRACT NO. BRT-001 DWG. NO. SG61 sнт. 1121

Port Authority connecting people to life

		,								
DESCRIPTION	2 INCH CONDUIT	3 INCH CONDUIT	TRENCH AND BACKFILL, TYPE I	TRENCH AND BACKFILL, TYPE II	TRENCH AND BACKFILL, TYPE IV	AWG 8, UNDERGROUND CABLE, COPPER, 1 CONDUCTOR	SIGNAL CABLE, 14 AWG, 5 CONDUCTOR	SIGNAL CABLE, 14 AWG, 7 CONDUCTOR	ELECTRICAL SERVICE TYPE C (EXISTING)	CITY OF PITTSBURGH STANDARD CONCRETE JUNCTION BOX, TYPE 1
ITEM NUMBER	02899	02899	02898	02898	02898	02900	02900	02900	02896	02897
Trem Homber	002	003	001	002	005	001	002	003	003	001
UNIT	LF	LF	LF	LF	LF	LF	LF	LF	EACH	EACH
LOCATION										
сс то 1	34	68		17						1
1 TO 2	144	288	7	11	54					1
2 TO S1	63	252	26		37					
1 то 🔨	3	6		3						
3 TO 🚣		5	5							
2 то 🖄		9	9							
2 TO POWER SERVICE (CITY MANHOLE)	39		10		29					
COMPLETE INTERSECTION						110	874	949	1	
TOTAL	283	628	57	31	120	110	874	949	1	2

NOTE: THE EQUIPMENT GROUNDING CONDUCTOR FOR LIGHTING CIRCUITS IS INCLUDED WITH THE CIRCUIT ITEM QUANTITIES.

S1 - TABULATED ON SYSTEMS PLAN

SIGNS

SYMBOL	SERIES	SIZE	AREA EACH (SQ FT)	CH DESCRIPTION		POST MOUNTED SIGNS, TYPE B	POST MOUNTED SIGNS, TYPE F	STRUCTURE MOUNTED FLAT SHEET ALUMINUM SIGNS WITH STIFFENERS
▲□	R10-3E(MOD)	9"x15"	0.9	EDUCATIONAL PUSH BUTTON FOR WALK SIGNAL WITH COUNTDOWN TIMER	3			A
€	D3-4*	96 "X32 "	21.3	100 OAKLAND 200 MEYRAN AVE LOTHROP ST	1			21.3
6	R10-6AL	24"×30"	5	STOP HERE ON RED	1	5		
R	R3-1	24"×24"	4	NO RIGHT TURN	1		4	
S	R3-11B(MOD)	30 "x36 "	7.5	RIGHT LANE - BUSES ONLY	1			7.5
1	SS-1	30"×18"	3.8	EXCEPT RIGHT TURNS	1			3.8
O	R10-10L	30 "X36 "	7.5	LEFT TURN SIGNAL	1			7.5
V	R3-7bP	24"×12"	2	EXCEPT BICYCLES	4		10	
Ø	R5-1	30"x30"	6.3	DO NOT ENTER	4	12.6	12.6	
			2895 002	TOTAL		17.6	26.6	40.1

▲ - INCIDENTAL TO ITEM #02895.002

* WHITE REFLECTORIZED LEGEND AND BORDER ON BLUE REFLECTORIZED BACKGROUND.
UTILIZE 4" CLEARVIEW 3W FOR BLOCK/NEIGHBORHOOD AND 8" CLEARVIEW 3W FOR
STREET NAME. ACTUAL WIDTH DETERMINED BY LETTER SPACING. COORDINATE BLOCK
NUMBERS AND STREET NAME DETAILS WITH CITY OF PITTSBURGH DEPARTMENT OF
MOBILITY AND INFRASTRUCTURE.

AECOM


Gulf Tower 707 Grant Street 5th Floor Pittsburgh, PA 15219 ((* DRIVE ENGINEERING 595 Skippack Pk, Suite 400

Blue Bell, PA 19422

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		U.S. DEPARTMENT OF TRANSPORTATION. UNDER THE
		URBAN MASS TRANSPORTATION ACT OF 1964, AS AMENDED, FOR THE
DATE	DESCRIPTION	PORT AUTHORITY OF ALLEGHENY COUNTY, PENNSYLVANIA.
	REVISIONS	COUNTY, PENINSTEVANIA.

(NOT FOR CONSTRUCTION)

DESIGNED	MW	PORT AUTHOR	HORITY OF ALLEGHENY COUNTY								
DRAWN	MW	PITTSBURGH		PENNS	SYLVANIA						
CHECKED	<u>EMC</u>	BUS RAPID TRANSIT UPTOWN TO OAKLAND									
IN CHARGE	<u>EMC</u>	SIGNAL PLANS									
DATE	05/01/24	TRAF	FIC SIGNAL T	ABULATIONS							
SCALE AS SHOWN		Port Authority	CONTRACT NO. BRT-001								
^	SOLOWIN	connecting people to life	DWG. NO.	SG62	sнт. 1122						

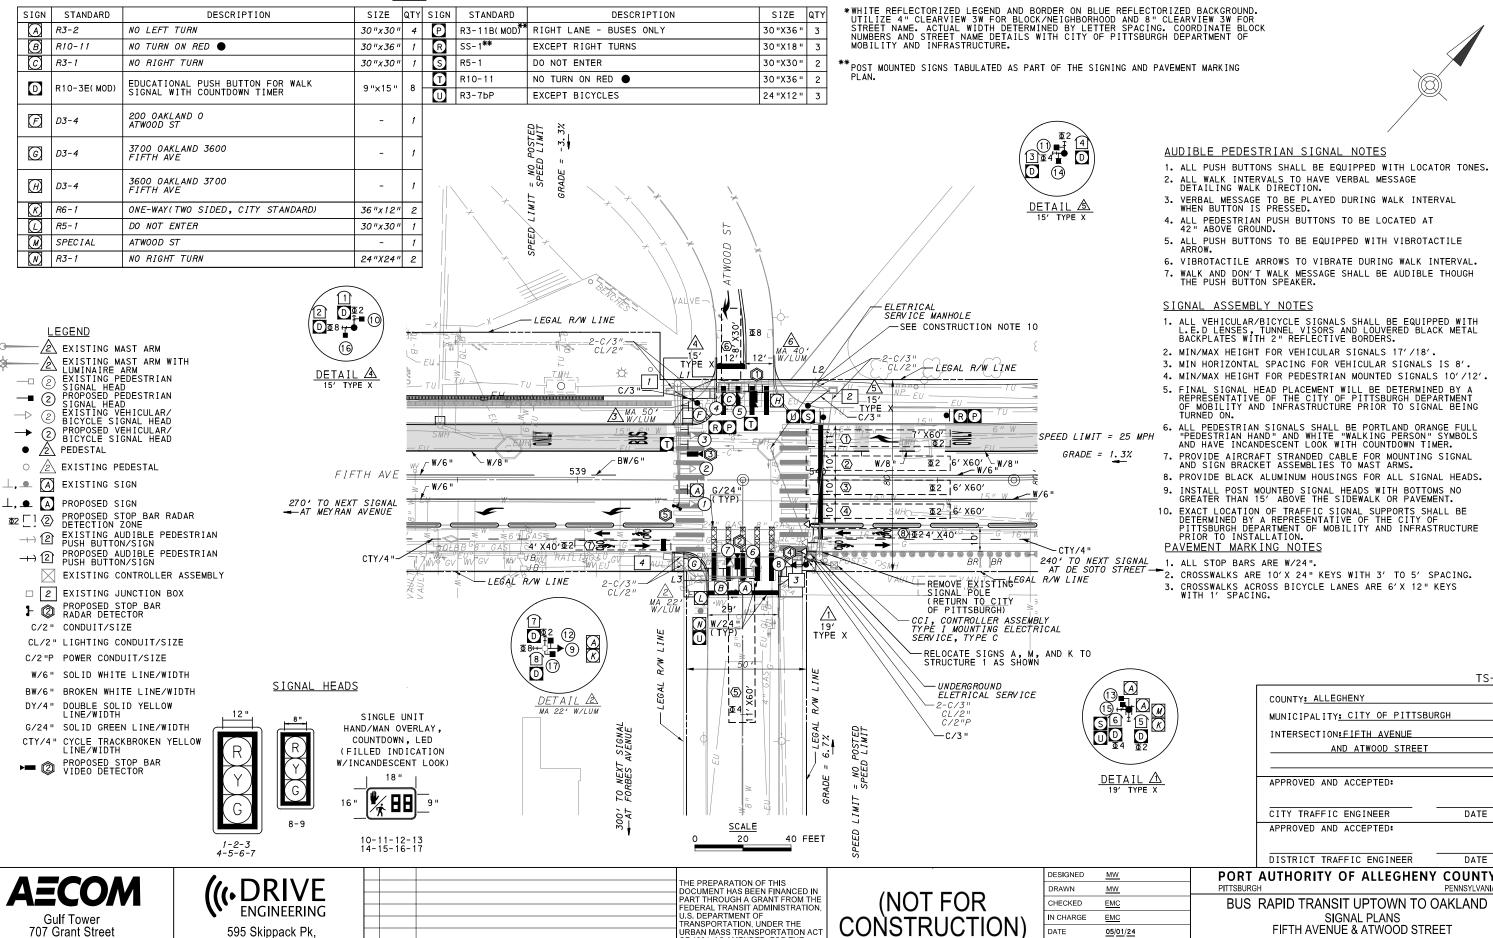

OF 1964, AS AMENDED, FOR THE PORT AUTHORITY OF ALLEGHENY

COUNTY, PENNSYLVANIA.

SCALE

AS SHOWN

TS-053

DATE

DATE

PENNSYLVANIA

sнт. 1123

CONTRACT NO. BRT-001

SG63

DWG. NO.

Port Authority

SIGNS

5th Floor

Pittsburgh, PA 15219

Suite 400


Blue Bell, PA 19422

NO. DATE

DESCRIPTION

REVISIONS

		PH	ASE	2		PH	IASE	4+8	3	
	В	IKE_		_ві _ві _ві	BIK	HLASHIZG				
INTERVAL SIGNAL	1	2	3	4	1	2	3	4	5	
1-2-3	G	G	Υ	R		R	R	R	R	R
4-5	R	R	R	R		G	G	Υ	R	R
6-7	R	R	R	R		G	G	Υ	R	R
8-9	G	G	Υ	R		R	R	R	R	OFF
10-11	W	FD	DW	DW		DW	DW	DW	DW	0FF
12-13	w	FD	DW	DW		DW	DW	DW	DW	0FF
14-15	DW	DW	DW	DW		W	FD	DW	DW	0FF
16-17	DW	DW	DW	DW		W	FD	DW	DW	OFF
FIXED	\geq	\leq	3	3	\geq	><	\leq	3.5	2.5	
MINIMUM	1	5				1	8			
PASSAGE	;	3				,	3			
FREE (MAX)	5	8				3	0			
PEDESTRIAN	7	10			5	2	16			
MEMORY		MIN	REC	CALL		PED	REC	CALL		

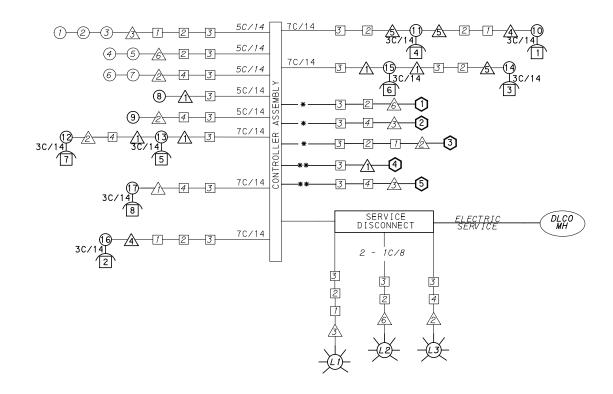

WIRING DIAGRAM

5C/14 - CABLE(NO. OF CONDUCTORS/SIZE AWG.)

SIGNAL HEAD

A SIGNAL SUPPORT

AUDIBLE PEDESTRIAN __ JUNCTION BOX INDICATOR

__L1_LUMINAIRE

RADAR DETECTOR

INCIDENTAL TO ITEM 02895.001, AS PER MANUFACTURERS SPECIFICATIONS

3C/14 INCIDENTAL TO ITEM 02895.002 ** INCIDENTAL TO ITEM 02895.005, AS PER MANUFACTURERS SPECIFICATIONS

DETECTOR ZONE INFORMATION

	DETECTION					LOCATION
DETECTOR	ZONE(S)	MODE	TYPE	ROUTE	PHASE	MAST ARM
3	(7' × 60')	PRESENCE	VIDEO (STOP BAR)	FIFTH AVE.	2	<u> </u>
3	② (6′× 60′)	PRESENCE	VIDEO (STOP BAR)	FIFTH AVE.	2	3
3	③ (6′ × 60′)	PRESENCE	VIDEO (STOP BAR)	FIFTH AVE.	2	<u> </u>
3	⟨ 4 ⟩ (6′ × 60′)	PRESENCE	VIDEO (STOP BAR)	FIFTH AVE.	2	<u>A</u>
0	⑤ (11′× 60′)	PRESENCE	VIDEO (STOP BAR)	ATWOOD ST.	4	<u> </u>
2	⑥ (8′× 30′)	PRESENCE	VIDEO (STOP BAR)	ATWOOD ST.	8	2
(5)	⟨₹⟩ (4′ × 40′)	PRESENCE	RADAR (STOP BAR)	FIFTH AVENUE BICYCLE LANE	2	<u> </u>
4	8 (4' × 40')	PRESENCE	RADAR (STOP BAR)	FIFTH AVENUE BICYCLE LANE	2	Δ

TRANSIT PRIORITY PRE-EMPTION NOTES (TO BE INSTALLED BY OTHERS)

- COORDINATE TRAFFIC CONTROLLER PROGRAMMING MODIFICATION WITH REPRESENTATIVES OF THE CITY OF PITTSBURGH AND DISTRICT TRAFFIC UNIT.
- 2. INCLUDE A TRANSIT PRIORITY PHASE THAT WILL EXTEND THE INDICATED PHASE A MAXIMUM OF 10 SECONDS WHEN ACTIVATED BY A PORT AUTHORITY VEHICLE. DO NOT VIOLATE SIDE STREET PEDESTRIAN MINIMUM TIMINGS.
- 3. MAINTAIN ALL YELLOW CLEARANCES AT ALL TIMES.
- 4. PROCEED TO THE SUBSEQUENT INTERVAL AS DEFINED IN THE MOVEMENT, SEQUENCE AND TIMING DIAGRAM UPON COMPLETING THE GREEN EXTENSION INTERVAL.
- 5. ONCE A TRANSIT CALL IS PLACED AND SATISFIED, THE CONTROLLER WILL NOT SATISFY ANOTHER CALL FOR
- 6. LOCATION OF BUS DETECTORS ARE TO BE FIELD ADJUSTED TO ACHIEVE MAXIMUM OPERATION.

AECOM

Gulf Tower 707 Grant Street 5th Floor Pittsburgh, PA 15219 (DRIVE **ENGINEERING**

595 Skippack Pk, Suite 400 Blue Bell, PA 19422

THE PREPARATION OF THIS DOCUMENT HAS BEEN FINANCED IN PART THROUGH A GRANT FROM THE FEDERAL TRANSIT ADMINISTRATION U.S. DEPARTMENT OF TRANSPORTATION, UNDER THE URBAN MASS TRANSPORTATION ACT OF 1964 AS AMENDED FOR THE NO. DATE DESCRIPTION COUNTY, PENNSYLVANIA. REVISIONS

(NOT FOR CONSTRUCTION)

DESIGNED	MW	
DRAWN	<u>MW</u>	
CHECKED	EMC	
IN CHARGE	EMC	
DATE	05/01/24	
SCALE		
	AS SHOWN	

DATE PORT AUTHORITY OF ALLEGHENY COUNTY PENNSYLVANIA

BUS RAPID TRANSIT UPTOWN TO OAKLAND SIGNAL PLANS

Port Authority

GENERAL NOTES

CONTRACTOR.

CONSTRUCTION NOTES

THE CITY OF PITTSBURGH SHALL INSPECT THE NEW SIGNAL EQUIPMENT PRIOR TO ACTIVATION.

ALL TRAFFIC SIGNAL MAINTENANCE AND OPERATION RESPONSIBILITIES SHALL BE TURNED OVER TO THE CITY OF PITTSBURGH AFTER THE FOLLOWING CONDITIONS ARE IMPLEMENTED TO THE CITY'S SATISFACTION:

1. PERMIT "AS-BUILT" TRAFFIC SIGNAL DRAWINGS ARE SUBMITTED AND APPROVED. 2. ALL PUNCH LIST ITEMS ARE COMPLETED BY THE

3. AFTER THE 30-DAY CONTINUOUS UNINTERRUPTED SIGNAL OPERATION WITHOUT MALFUNCTIONS.

1. ALL JUNCTION BOXES IN WALK AREAS TO BE CITY OF PITTSBURGH STANDARD CONCRETE JUNCTION BOX, TYPE 1. 2. ALL JUNCTION BOXES IN NON-WALK AREAS TO BE CITY STANDARD JB-2 WITH BOTTOM. 3. THERE SHALL BE NO SIGNAL WIRE OR FIBER CABLE SPLICING.

4. SERVICE WIRE FROM THE POWER SOURCE TO THE CONTROLLER CABINET SHALL BE PLACED IN SECONDARY SEPARATE CONDUIT.

5. STREET LIGHT CABLE IS NOT PERMITTED TO RUN THROUGH THE CONTROLLER CABINET AND SHALL BE PLACED IN SEPARATE CONDUIT.

6. TRAFFIC SIGNAL CABLE SHALL BE PLACED IN DEDICATED

7. MOUNT DISCONNECT ON POLE NEAREST TO THE CONTROLLER CABINET EXCLUDING TYPE X POLES. 8. REMOVE AND DISPOSE OF ALL EXISTING SIGNAL WIRING NO

10. SEE 01720 UTILITY COORDINATION FOR INFORMATION ON RELOCATION OF EXISTING SECURITY CAMERAS AND

9. REMOVE EXISTING SIGNAL EQUIPMENT NO LONGER IN USE AND RETURN TO THE CITY OF PITTSBURGH TRAFFIC CONTROL SHOP. COORDINATE DELIVERY OF EQUIPMENT WITH DELMAS MCELHANY, TRAFFIC CONTROL FOREMAN.

CONTRACT NO. BRT-001 SG64 sнт. 1124 DWG NO

COUNTY: ALLEGHENY MUNICIPALITY: CITY OF PITTSBURGH TS-053

DATE

INTERSECTION: FIFTH AVENUE

AND ATWOOD STREET

APPROVED AND ACCEPTED:

CITY TRAFFIC ENGINEER APPROVED AND ACCEPTED:

DISTRICT TRAFFIC ENGINEER

PITTSBURGH

WIRING, MOVEMENT, PHASING & SEQUENCE DIAGRAMS

FIFTH AVENUE AND ATWOOD STREET

ITEM NUMBER	MISCE	ELLAN	EOUS	
UNIT	DESCRIPTION	QTY.	LOCATION	REMARKS
01882. 002	TRAFFIC SIGNAL TIMING MODIFICATIONS	2	СС	
EACH 02890. 005	GPS TIME CLOCK	1	CC	
EACH				
006	VEHICULAR SIGNAL HEAD, THREE 8" SECTIONS	2	89	BLACK TUNNEL VISORS BLACK ALUMINUM HOUSINGS BLACK METAL LOUVERED BACKPLATE
EACH				BLACK METAL LOUVERED BACKFLATE
02894. 005 EACH	LED COUNTDOWN PEDESTRIAN SIGNAL HEAD, TYPE A	8	1001213 14151617	BLACK TUNNEL VISORS BLACK ALUMINUM HOUSINGS
02895. 002 EACH	ACCESSIBLE PEDESTRIAN SIGNALS	8	1234	
02897. 011 EACH	CONNECT TO EXISTING JUNCTION BOX	3	123	
02893. 001 EACH	REMOVE EXISTING POLE	1		SE CORNER
02891. 021 EACH	RESET STRUCTURE MOUNTED FLAT SHEET ALUMINIUM SIGN	3	\triangle	
02212. 009 EACH	POLE FOUNDATION DRILLING, LESS THAN 30" DIAMETER	20	1 4 5	

DETECTORS

ITEM NUMBER	DESCRIPTION	SEN. NO.	QTY.	LOCATION
02895 . 001	VIDEO DETECTION	123	2	236
EACH		~~~		7-32-32-3
02895 . 005	DIGITAL WAVE RADAR DETECTION	4 5	2	A 3
EACH				

TRAFFIC SIGNAL SUPPORTS **

	≥ ⊞	E III			NO		⊢										PEDE	ESTAL	-							
POLE NO.	ITEM	DESCRIPTION	aty.	ROUTE	ATI	SIDE	FSE							ARM	"A "						ΑF	RM "(2"	SHAFT	SIG	NAL
	_				ST	0,	<u>F</u>	н	к		SIG	NAL I	LOCA	TION	:	SIGN	LOC	ATIO	N	w	G	Х	Z	н	м	N
	UNIT									-	М	N	0	Р	R	S	Т	U	Y	"	Ü	^	_	"	"	ı ''
\triangle	02892. 004 EACH	TRAFFIC SIGNAL SUPPORT, 19' TYPE X, PAINTED BLACK	1	FIFTH AVE.	539+95	RT	35′																	19′	17′	10'
2		TRAFFIC SIGNAL SUPPORT, 22' MAST ARM WITH LUMINAIRE ARM (30' MOUNTING HEIGHT		FIFTH AVE.	539+50	RT	40 ′	17 ′	10'	22'	21'	12'			19'	9,			3'	o°		30 '	0°			
3		TRAFFIC SIGNAL SUPPORT, 50' MAST ARM WITH LUMINAIRE ARM (30' MOUNTING HEIGHT		FIFTH AVE.	539+42	LT	39 '	17 '		50 '	49 '	34 '	20 '		43'	24′	18′		8'	o°		30 '	0°			
4	02892. 003 EACH	TRAFFIC SIGNAL SUPPORT, 15' TYPE X, PAINTED BLACK	1	FIFTH AVE.	539+50	LT	31′																	15′		10′
<u>\$</u>	02892. 003 EACH	TRAFFIC SIGNAL SUPPORT, 15' TYPE X, PAINTED BLACK	1	FIFTH AVE.	539+97	LT	30′																	15′		10′
<u>6</u>		TRAFFIC SIGNAL SUPPORT, 40' MAST ARM WITH LUMINAIRE ARM (30' MOUNTING HEIGHT		FIFTH AVE.	540+00	LT	39 '	17 '		40 '	39 '	29 ′			35 '	27′			21 '	90°		30 '	0°			

** REFER TO PENNDOT TC-8800 TRAFFIC STANDARDS - SIGNALS FOR LETTER DESIGNATION

Gulf Tower 707 Grant Street 5th Floor Pittsburgh, PA 15219 ((* DRIVE ENGINEERING 595 Skippack Pk, Suite 400 Blue Bell, PA 19422

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NO.	DATE	DESCRIPTION	PORT AUTHORITY OF ALLEGHENY COUNTY, PENNSYLVANIA.
		REVISIONS	COUNTY, PENNSTLVANIA.

(NOT FOR CONSTRUCTION)

SIGNED	MW	PORT AUTHOR	ITY OF ALLEGHENY CO	DUNT
AWN	MW	PITTSBURGH	PE	NNSYLVA
ECKED	<u>EMC</u>	BUS RAPID TE	RANSIT UPTOWN TO OAK	LAND
CHARGE	<u>EMC</u>		SIGNAL PLANS	
TE	<u>05/01/24</u>	TRAF	FIC SIGNAL TABULATIONS	
ALE	AS SHOWN	Port Authority	CONTRACT NO. BRT-	001
	AS SHOWN	connecting people to life	DWG NO SG65	SHT

DESCRIPTION	3 INCH CONDUIT	TRENCH AND BACKFILL, TYPE I	TRENCH AND BACKFILL, TYPE II	SIGNAL CABLE, 14 AWG, 5 CONDUCTOR	SIGNAL CABLE, 14 AWG, 7 CONDUCTOR
ITEM NUMBER	02899	02898	02898	02900	02900
TTEM NOMBER	003	001	002	002	003
UNIT	LF	LF	LF	LF	LF
LOCATION					
<u>4</u> TO <u>1</u>	11	7	4		
<u>∱</u> TO 2	11	11			
<u>↑</u> TO 3	3	3			
COMPLETE INTERSECTION				197	998
TOTAL	25	21	4	197	998

SIGNS

SYMBOL	SERIES	SIZE	AREA EACH (SQ FT)	DESCRIPTION	QUANTITY	02891,001 POST MOUNTED SIGNS, TYPE B	02891,003 POST MOUNTED SIGNS, TYPE F	02891.007 STRUCTURE MOUNTED FLAT SHEET ALUMINUM SIGN WITH STIFFENERS
						SF	SF	SF
D	R10-3E(MOD)	9 "X15 "	.9	EDUCATIONAL PUSH BUTTON FOR WALK SIGNAL WITH COUNTDOWN TIMER	8			•
9	R3-11B(MOD)	30 "X36 "	7.5	RIGHT LANE - BUSES ONLY	1			7.5
R	SS-1	30"X18"	3.8	EXCEPT RIGHT TURNS	1			3.8
S	R5-1	30"X30"	6.3	DO NOT ENTER	2	6.3	6.3	
Ū	R10-11	30"X36"	7.5	NO TURN ON RED	2			15
O	R3-7bP	24"X12"	2	EXCEPT BICYCLES	3		6	
			•	TOTAL	•	6.3	12.3	26.3

▲ - INCIDENTAL TO ITEM 02895.002

* WHITE REFLECTORIZED LEGEND AND BORDER ON BLUE REFLECTORIZED BACKGROUND.
UTILIZE 4" CLEARVIEW 3W FOR BLOCK/NEIGHBORHOOD AND 8" CLEARVIEW 3W FOR
STREET NAME. ACTUAL WIDTH DETERMINED BY LETTER SPACING. COORDINATE BLOCK
NUMBERS AND STREET NAME DETAILS WITH CITY OF PITTSBURGH DEPARTMENT OF
MOBILITY AND INFRASTRUCTURE.

AECOM

Gulf Tower 707 Grant Street 5th Floor Pittsburgh, PA 15219 ((DRIVE ENGINEERING 595 Skippack Pk, Suite 400 Blue Bell, PA 19422

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NO.	DATE	DESCRIPTION	PORT AUTHORITY OF ALLEGHENY COUNTY, PENNSYLVANIA.
		REVISIONS	COUNTY, PENNSTEVANIA.

(NOT FOR CONSTRUCTION)

DESIGNED	MW	PORT AUTHOR	ITY OF AL	LEGHENY	COUNTY
DRAWN	MW	PITTSBURGH			PENNSYLVANIA
CHECKED	EMC	BUS RAPID TF	RANSIT UPT	OWN TO O	AKLAND
IN CHARGE	EMC		SIGNAL PL	.ANS	
DATE	05/01/24	TRAF	FIC SIGNAL T	ABULATIONS	S
SCALE	AS SHOWN	Port Authority	CONTR	RACT NO. BI	RT-001
	AS SHOWN	connecting people to life	DWG. NO.	SG66	sнт. 112

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COUNTY, PENNSYLVANIA.


REVISIONS

SG67

DWG NO

sнт. 1127

		PH	IASE	2			PHA	SE	4+8		
	BIK	(E	<u></u>		US	вік	HLANHIZG				
SIGNAL	1	2	3	4		1	2	3	4		
1-2	G	G	Υ	R		R	R	R	R		R
3-4-5	R	R	R	R		G	G	Υ	R		R
6-7	R	R	R	R		-G -	-G -	-Y-	R		R
8-9	G	G	Υ	R		R	R	R	R		R
10-11-12	W	FD	DW	DW		DW	DW	DW	DW		0FF
13-14-15-16	DW	DW	DW	DW		w	FD	DW	DW		0FF
FIXED	\setminus	<	3.5	2.5		\setminus	\leq	3.5	3.5		
MINIMUM	1	8				1	8				
PASSAGE		3				;	3				
FREE (MAX)	5	54				34					
PEDESTRIAN	7	7 10				7 16					
MEMORY		MIN	REC	RECALL			PED	REC	ALL		

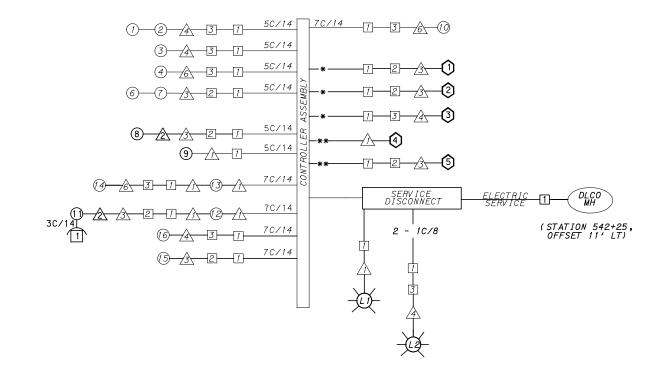

WIRING DIAGRAM

5C/14 - CABLE(NO. OF CONDUCTORS/SIZE AWG.)

SIGNAL HEAD

AUDIBLE PEDESTRIAN __ JUNCTION BOX INDICATOR

RADAR DETECTOR

L1-LUMINAIRE INCIDENTAL TO ITEM 02895.001, AS PER MANUFACTURERS SPECIFICATIONS

3C/14 INCIDENTAL TO ITEM 02895.002

** INCIDENTAL TO ITEM 02895.005, AS PER MANUFACTURERS SPECIFICATIONS

DETECTOR ZONE INFORMATION

DETECTOR	DETECTION ZONE(S)	MODE	TYPE	ROUTE	PHASE	LOCATION MAST ARM
3	(8' × 60')	PRESENCE	VIDEO (STOP BAR)	FIFTH AVE.	2	A
3	② (6' × 60')	PRESENCE	VIDEO (STOP BAR)	FIFTH AVE.	2	<u>A</u>
3	⟨3⟩ (6' × 60')	PRESENCE	VIDEO (STOP BAR)	FIFTH AVE.	2	4
3	⟨4⟩ (6′ × 60′)	PRESENCE	VIDEO (STOP BAR)	FIFTH AVE.	2	<u>A</u>
2	⟨5⟩ (12′× 60′)	PRESENCE	VIDEO (STOP BAR)	DE SOTO ST.	4	<u>\$</u>
①	⟨6⟩ (16′ × 60′)	PRESENCE	VIDEO (STOP BAR)	OKLAND AVE.	8	<u>A</u>
4	⟨7⟩ (4′× 40′)	PRESENCE	RADAR (STOP BAR)	FIFTH AVENUE BICYCLE LANE	2	2
(5)	(8) (4' × 40')	PRESENCE	RADAR (STOP BAR)	FIFTH AVENUE BICYCLE LANE	2	<u>A</u>

TRANSIT PRIORITY PRE-EMPTION NOTES (TO BE INSTALLED BY OTHERS)

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- 2. INCLUDE A TRANSIT PRIORITY PHASE THAT WILL EXTEND THE INDICATED PHASE A MAXIMUM OF 10 SECONDS WHEN ACTIVATED BY A PORT AUTHORITY VEHICLE. DO NOT VIOLATE SIDE STREET PEDESTRIAN MINIMUM TIMINGS.
- 3. MAINTAIN ALL YELLOW CLEARANCES AT ALL TIMES.
- 4. PROCEED TO THE SUBSEQUENT INTERVAL AS DEFINED IN THE MOVEMENT, SEQUENCE AND TIMING DIAGRAM UPON COMPLETING THE GREEN EXTENSION INTERVAL.
- 5. ONCE A TRANSIT CALL IS PLACED AND SATISFIED, THE CONTROLLER WILL NOT SATISFY ANOTHER CALL FOR
- 6. LOCATION OF BUS DETECTORS ARE TO BE FIELD ADJUSTED TO ACHIEVE MAXIMUM OPERATION.

AECOM

Gulf Tower 707 Grant Street 5th Floor Pittsburgh, PA 15219 ((₁DRIVE **ENGINEERING**

595 Skippack Pk, Suite 400 Blue Bell, PA 19422

THE PREPARATION OF THIS DOCUMENT HAS BEEN FINANCED IN PART THROUGH A GRANT FROM THE FEDERAL TRANSIT ADMINISTRATION U.S. DEPARTMENT OF TRANSPORTATION, UNDER THE URBAN MASS TRANSPORTATION ACT OF 1964 AS AMENDED FOR THE NO. DATE DESCRIPTION COUNTY, PENNSYLVANIA. REVISIONS

(NOT FOR CONSTRUCTION)

DESIGNED	MW	
DRAWN	<u>MW</u>	
CHECKED	<u>EMC</u>	
IN CHARGE	<u>EMC</u>	
DATE	06/21/22	
SCALE	AS SHOWN	

THE CITY OF PITTSBURGH SHALL INSPECT THE NEW SIGNAL EQUIPMENT PRIOR TO ACTIVATION.

ALL TRAFFIC SIGNAL MAINTENANCE AND OPERATION RESPONSIBILITIES SHALL BE TURNED OVER TO THE CITY OF PITTSBURGH AFTER THE FOLLOWING CONDITIONS ARE IMPLEMENTED TO THE CITY'S SATISFACTION:

- 1. PERMIT "AS-BUILT" TRAFFIC SIGNAL DRAWINGS ARE SUBMITTED AND APPROVED.
- 2. ALL PUNCH LIST ITEMS ARE COMPLETED BY THE CONTRACTOR.
- 3. AFTER THE 30-DAY CONTINUOUS UNINTERRUPTED SIGNAL OPERATION WITHOUT MALFUNCTIONS.

CONSTRUCTION NOTES

GENERAL NOTES

- 1. ALL JUNCTION BOXES IN WALK AREAS TO BE CITY OF PITTSBURGH STANDARD CONCRETE JUNCTION BOX, TYPE 1.
- 2. ALL JUNCTION BOXES IN NON-WALK AREAS TO BE CITY STANDARD JB-2 WITH BOTTOM.
- 3. THERE SHALL BE NO SIGNAL WIRE OR FIBER CABLE SPLICING.
- 4. SERVICE WIRE FROM THE POWER SOURCE TO THE CONTROLLER CABINET SHALL BE PLACED IN SECONDARY SEPARATE CONDUIT.
- 5. STREET LIGHT CABLE IS NOT PERMITTED TO RUN THROUGH THE CONTROLLER CABINET AND SHALL BE PLACED IN SEPARATE CONDUIT.
- 6. TRAFFIC SIGNAL CABLE SHALL BE PLACED IN DEDICATED
- 7. MOUNT DISCONNECT ON POLE NEAREST TO THE CONTROLLER CABINET EXCLUDING TYPE X POLES.
- 8. REMOVE AND DISPOSE OF ALL EXISTING SIGNAL WIRING NO
- 9. REMOVE EXISTING SIGNAL EQUIPMENT NO LONGER IN USE AND RETURN TO THE CITY OF PITTSBURGH TRAFFIC CONTROL SHOP. COORDINATE DELIVERY OF EQUIPMENT WITH DELMAS MCELHANY, TRAFFIC CONTROL FOREMAN.

TS-258 COUNTY: ALLEGHENY MUNICIPALITY: CITY OF PITTSBURGH INTERSECTION: FIFTH AVENUE AND DE SOTO AVENUE APPROVED AND ACCEPTED: CITY TRAFFIC ENGINEER DATE APPROVED AND ACCEPTED: DISTRICT TRAFFIC ENGINEER DATE

PORT AUTHORITY OF ALLEGHENY COUNTY PITTSBURGH PENNSYLVANIA

BUS RAPID TRANSIT UPTOWN TO OAKLAND SIGNAL PLANS WIRING, MOVEMENT, PHASING & SEQUENCE DIAGRAMS

Port Authority

CONTRACT NO. BRT-001 DWG. NO. SG68 sнт. 1128

FIFTH AVENUE AND DE SOTO AVENUE

ITEM NUMBER	MISCE	ELLAN	EOUS	
UNIT	DESCRIPTION	QTY.	LOCATION	REMARKS
01882. 002 EACH	TRAFFIC SIGNAL TIMING MODIFICATIONS	2	СС	
02890. 005 EACH	GPS TIME CLOCK	1	СС	
02894. 006 EACH	VEHICULAR SIGNAL HEAD, THREE 8" SECTIONS	2	89	BLACK TUNNEL VISORS BLACK ALUMINUM HOUSINGS BLACK METAL LOUVERED BACKPLATE
02894. 005 EACH	LED COUNTDOWN PEDESTRIAN SIGNAL HEAD, TYPE A	1	1)	BLACK TUNNEL VISORS BLACK ALUMINUM HOUSINGS
02895. 002 EACH	ACCESSIBLE PEDESTRIAN SIGNALS	1	11	
02894. 031 EACH	REMOVE VEHICULAR SIGNAL HEAD		\triangle	SE CORNER
02212. 009 EACH	POLE FOUNDATION DRILLING, LESS THAN 30" DIAMETER		<u> </u>	

DETECTORS

I TEM NUMBER	DESCRIPTION	SEN. NO.	QTY.	LOCATION
02895. 001 EACH	VIDEO DETECTION	000	3	<u> </u>
02895. 005 EACH	DIGITAL WAVE RADAR DETECTION	34	2	<u> </u>

TRAFFIC SIGNAL SUPPORTS **

TRAITIC SIGNAL SUITORIS **																										
	¥W W				STATION	SIDE	 -	MAST ARM											PEDE	ESTAL						
POLE NO.	ITEM	DESCRIPTION	QTY.	ROUTE			OFF SE							ARM	"A"						Al	₹M "	C "	SHAFT	SIG	NAL
						"	9	Н	к	SIGNAL		SIGNAL LOCATION			:	SIGN LOCATION			ON	w	G	x	z	Н	м	N
	UNIT										М	N	0	Р	R	S	T	U	Y] "			-	- 11	IVI	"
\triangle		TRAFFIC SIGNAL SUPPORT, 14' MAST ARM WITH LUMINAIRE ARM (30' MOUNTING HEIGHT		FIFTH AVE.	542+53	RT	32'	17'		14'												30 '	0°			
2	02892. 004 EACH	TRAFFIC SIGNAL SUPPORT, 19' TYPE X, PAINTED BLACK	1	FIFTH AVE.	541+96	RT	41′																	19′	17'	10'
3		TRAFFIC SIGNAL SUPPORT, 30' MAST ARM		FIFTH AVE.	541+86	RT	32'	17 '	10'	20 '	19'	13'	7 '		10'											
4		TRAFFIC SIGNAL SUPPORT, 40' MAST ARM WITH LUMINAIRE ARM (30' MOUNTING HEIGHT		FIFTH AVE.	541+53	LT	31'	17 '	10'	40 '	37 '	17 '			34 '	14'	6'					30 '	o°			
<u>\$</u>	02892. 008 EACH	TRAFFIC SIGNAL SUPPORT, 15' TYPE X, (FOUNDATION ONLY)	1	FIFTH AVE.	542+25	LT	31																			
<u>6</u>		TRAFFIC SIGNAL SUPPORT, 15' TYPE X		FIFTH AVE.	542+33	LT	31'																	15'	101	10'

** REFER TO PENNDOT TC-8800 TRAFFIC STANDARDS - SIGNALS FOR LETTER DESIGNATION

AECOM

Gulf Tower 707 Grant Street 5th Floor Pittsburgh, PA 15219

((DRIVE ENGINEERING 595 Skippack Pk, Suite 400 Blue Bell, PA 19422

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		URBAN MASS TRANSPORTATION ACT OF 1964, AS AMENDED, FOR THE
DATE	DESCRIPTION	PORT AUTHORITY OF ALLEGHENY COUNTY, PENNSYLVANIA.
	REVISIONS	COUNTY, FEMINSTEVANIA.

(NOT FOR CONSTRUCTION)

DESIGNED	MW	
DRAWN	MW	
CHECKED	EMC	
IN CHARGE	<u>EMC</u>	
DATE	05/01/24	
SCALE		
	AS SHOWN	

PORT AUTHORITY OF ALLEGHENY COUNTY BUS RAPID TRANSIT UPTOWN TO OAKLAND SIGNAL PLANS TRAFFIC SIGNAL TABULATIONS

Port Authority connecting people to life CONTRACT NO. BRT-001 DWG. NO. SG69

sнт. 1129

Pittsburgh, PA 15219

((DRIVE ENGINEERING 595 Skippack Pk, Suite 400 Blue Bell, PA 19422

١٥.	DATE	DES
		REVISIO

THE PREPARATION OF THIS THE PREPARATION OF THIS
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PORT AUTHORITY OF ALLEGHENY
COUNTY, PENNSYLVANIA.

(NOT FOR CONSTRUCTION

	DESIGNED	IVIVV
	DRAWN	<u>MW</u>
	CHECKED	<u>EMC</u>
N I N	IN CHARGE	<u>EMC</u>
IN)	DATE	05/01/24
,	SCALE	
		AS SHOWN

PORT AUTHORITY OF ALLEGHENY COUNTY BUS RAPID TRANSIT UPTOWN TO OAKLAND 01/24

SIGNAL PLANS TRAFFIC SIGNAL TABULATIONS

Port Authority
connecting people to life

CONTRACT NO. BRT-001 DWG. NO. SG70 sнт. 1130

DESCRIPTION	2 INCH CONDUIT	3 INCH CONDUIT	TRENCH AND BACKFILL, TYPE I	TRENCH AND BACKFILL, TYPE II	TRENCH AND BACKFILL, TYPE IV	SIGNAL CABLE, 14 AWG, 5 CONDUCTOR	SIGNAL CABLE, 14 AWG, 7 CONDUCTOR	CITY OF PITTSBURGH STANDARD CONCRETE JUNCTION BOX, TYPE 1
ITEM NUMBER	02899	02899	02898	02898	02898	02900	02900	02897
TIEM NUMBER	002	003	001	002	005	002	003	001
TINU	LF	LF	LF	LF	LF	LF	LF	EACH
LOCATION								
2 TO <u>2</u>								
1 TO 2	59	118	14	13	32			1
1 TO 3	76	152	12	6	58			1
3 то ∕҈€		2	2					1
2 то 🛕		9	9					
COMPLETE INTERSECTION						180	183	
1								

37

19

90

180

183

3

NOTE: THE EQUIPMENT GROUNDING CONDUCTOR FOR LIGHTING CIRCUITS IS INCLUDED WITH THE CIRCUIT ITEM QUANTITIES.

135

281

TOTAL

SIGNS


SYMBOL	SERIES	SIZE	AREA EACH (SQ FT)	DESCRIPTION	QUANTITY	STRUCTURE MOUNTED FLAT SHEET ALUMINUM SIGN WITH STIFFENERS			
D	R10-3E(MOD)	9 "X15 "	0.9	EDUCATIONAL PUSH BUTTON FOR WALK SIGNAL WITH COUNTDOWN TIMER	1	A			
R	R3-7R	30"×30"	7.5	RIGHT LANE - BUSES ONLY	1	7.5			
①	SS-1	30"×18"	3.8	EXCEPT RIGHT TURN	1	3.8			
TOTAL									


▲ - INCIDENTAL TO ITEM 02895.002

* WHITE REFLECTORIZED LEGEND AND BORDER ON BLUE REFLECTORIZED BACKGROUND.
UTILIZE 4" CLEARVIEW 3W FOR BLOCK/NEIGHBORHOOD AND 8" CLEARVIEW 3W FOR
STREET NAME. ACTUAL WIDTH DETERMINED BY LETTER SPACING. COORDINATE BLOCK
NUMBERS AND STREET NAME DETAILS WITH CITY OF PITTSBURGH DEPARTMENT OF
MOBILITY AND INFRASTRUCTURE.

AECOM

SCRIPTION DNS

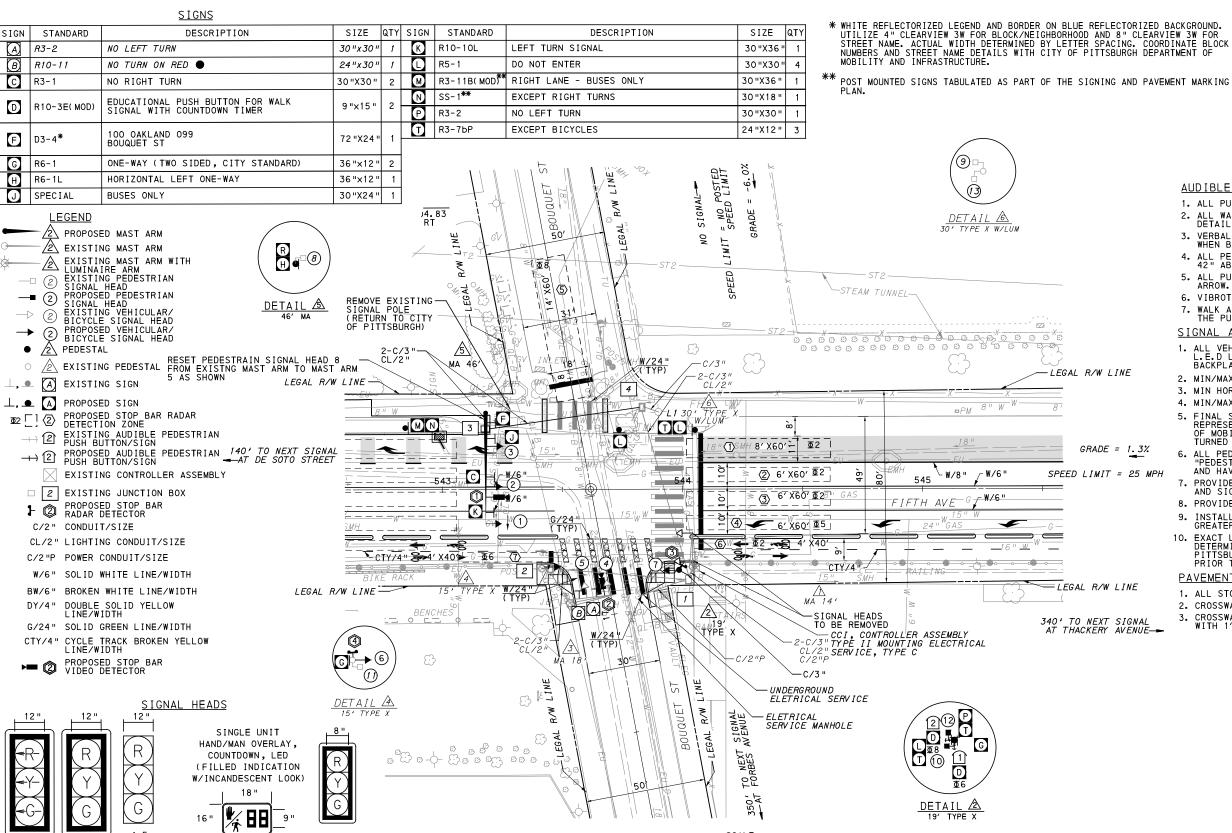

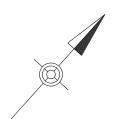

AUDIBLE PEDESTRIAN SIGNAL NOTES

- 1. ALL PUSH BUTTONS SHALL BE EQUIPPED WITH LOCATOR TONES.
- 2. ALL WALK INTERVALS TO HAVE VERBAL MESSAGE DETAILING WALK DIRECTION.
- 3. VERBAL MESSAGE TO BE PLAYED DURING WALK INTERVAL WHEN BUTTON IS PRESSED.
- 4. ALL PEDESTRIAN PUSH BUTTONS TO BE LOCATED AT 42" ABOVE GROUND.
- 5. ALL PUSH BUTTONS TO BE EQUIPPED WITH VIBROTACTILE ARROW.
- 6. VIBROTACTILE ARROWS TO VIBRATE DURING WALK INTERVAL.
- 7. WALK AND DON'T WALK MESSAGE SHALL BE AUDIBLE THOUGH THE PUSH BUTTON SPEAKER.

SIGNAL ASSEMBLY NOTES

- ALL VEHICULAR/BICYCLE SIGNALS SHALL BE EQUIPPED WITH L.E.D LENSES, TUNNEL VISORS AND LOUVERED BLACK METAL BACKPLATES WITH 2" REFLECTIVE BORDERS.
- 2. MIN/MAX HEIGHT FOR VEHICULAR SIGNALS 17'/18'.
- 3. MIN HORIZONTAL SPACING FOR VEHICULAR SIGNALS IS 8'.
- 4. MIN/MAX HEIGHT FOR PEDESTRIAN MOUNTED SIGNALS 10'/12'.
- 5. FINAL SIGNAL HEAD PLACEMENT WILL BE DETERMINED BY A REPRESENTATIVE OF THE CITY OF PITTSBURCH DEPARTMENT OF MOBILITY AND INFRASTRUCTURE PRIOR TO SIGNAL BEING TURNED ON.
- ALL PEDESTRIAN SIGNALS SHALL BE PORTLAND ORANGE FULL "PEDESTRIAN HAND" AND WHITE "WALKING PERSON" SYMBOLS AND HAVE INCANDESCENT LOOK WITH COUNTDOWN TIMER.
- PROVIDE AIRCRAFT STRANDED CABLE FOR MOUNTING SIGNAL AND SIGN BRACKET ASSEMBLIES TO MAST ARMS.
- 8. PROVIDE BLACK ALUMINUM HOUSINGS FOR ALL SIGNAL HEADS.
- 9. INSTALL POST MOUNTED SIGNAL HEADS WITH BOTTOMS NO GREATER THAN 15' ABOVE THE SIDEWALK OR PAVEMENT.

 10. EXACT LOCATION OF TRAFFIC SIGNAL SUPPORTS SHALL BE DETERMINED BY A REPRESENTATIVE OF THE CITY OF PITTSBURGH DEPARTMENT OF MOBILITY AND INFRASTRUCTURE PRIOR TO INSTALLATION PRIOR TO INSTALLATION.

PAVEMENT MARKING NOTES

- 1. ALL STOP BARS ARE W/24".
- 2. CROSSWALKS ARE 10'X 24" KEYS WITH 3' TO 5' SPACING.
- 3. CROSSWALKS ACROSS BICYCLE LANES ARE 6^\prime X 12" KEYS WITH 1' SPACING.

TS-130

COUNTY: ALLEGHENY MUNICIPALITY: CITY OF PITTSBURGH INTERSECTION: FIFTH AVENUE AND BOUQUET STREET APPROVED AND ACCEPTED: CITY TRAFFIC ENGINEER DATE APPROVED AND ACCEPTED: DISTRICT TRAFFIC ENGINEER DATE

707 Grant Street 5th Floor Pittsburgh, PA 15219



Blue Bell, PA 19422

THE PREPARATION OF THIS DOCUMENT HAS BEEN FINANCED IN PART THROUGH A GRANT FROM THE FEDERAL TRANSIT ADMINISTRATION J.S. DEPARTMENT OF FRANSPORTATION, UNDER THE URBAN MASS TRANSPORTATION ACT OF 1964, AS AMENDED, FOR THE PORT AUTHORITY OF ALLEGHENY NO. DATE DESCRIPTION COUNTY, PENNSYLVANIA. REVISIONS

20

40 FEET

(NOT FOR CONSTRUCTION)

DESIGNED	MW	
DRAWN	MVV	
CHECKED	EMC	
IN CHARGE	<u>EMC</u>	
DATE	05/01/24	
SCALE		
	AS SHOWN	


PORT AUTHORITY OF ALLEGHENY COUNTY **PENNSYLVANIA**

BUS RAPID TRANSIT UPTOWN TO OAKLAND SIGNAL PLANS

FIFTH AVENUE & BOUQUET STREET

CONTRACT NO. BRT-001 **Port Authority** SG71 sнт. **1131** DWG. NO.

								1						PHASE 8					
		PH	IASE	2+6	5	PHASE 2+5													
	BIKI		L ====================================	=	US FIKE	ВІКІ	<u>-</u> = ⊟		=	BUS BIKE	ВІК	- E⊢				HLANHING			
SIGNAL	1	2	3	4		1	2	3	4		1	2	3	4	5				
1	-R -	-R	 R-	- R−		- -G−	 G-	- Y-	 R-		- R-	- R-	-R	- R-	 R−	0FF			
2-3	G	G	G	G		G	G	Υ	R		R	R	R	R	R	R			
4-5	R	R	R	R		R	R	R	R		R	G	G	Υ	R	R			
6-7	G	G	Υ	R		R	R	R	R		R	R	R	R	R	OFF			
8-9	W	W	W	W		W	FD	DW	DW		DW	DW	DW	DW	DW	0FF			
10-11	W	FD	DW	DW		DW	DW	DW	DW		DW	DW	DW	DW	DW	0FF			
12-13	DW	DW	DW	DW		DW	DW	DW	DW		W	W	FD	DW	DW	0FF			
FIXED	>	<	3.5	3.5		>	\leq	3.5	2.5			><		4	3				
MINIMUM	1	3				1	8					15							
PASSAGE	;	3					3					3							
FREE (MAX)	1	7				5	0					23							
PEDESTRIAN	7	10				7	10				5	2	16						
MEMORY		PED	REC	CALL			MIN	REC	CALL			PED	REC	ALL					

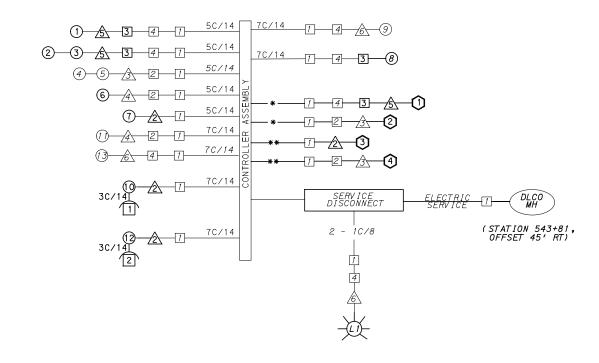

WIRING DIAGRAM

5C/14 - CABLE(NO. OF CONDUCTORS/SIZE AWG.)

SIGNAL HEAD

AUDIBLE PEDESTRIAN __ JUNCTION BOX INDICATOR LUMINAIRE

RADAR DETECTOR

* INCIDENTAL TO ITEM 02895.001, AS PER MANUFACTURERS SPECIFICATIONS

3C/14 INCIDENTAL TO ITEM 02895.002

** INCIDENTAL TO ITEM 02895.005, AS PER MANUFACTURERS SPECIFICATIONS

TRANSIT PRIORITY PRE-EMPTION NOTES (TO BE INSTALLED BY OTHERS)

- COORDINATE TRAFFIC CONTROLLER PROGRAMMING MODIFICATION WITH REPRESENTATIVES OF THE CITY OF PITTSBURGH AND DISTRICT TRAFFIC UNIT.
- 2. INCLUDE A TRANSIT PRIORITY PHASE THAT WILL EXTEND THE INDICATED PHASE A MAXIMUM OF 10 SECONDS WHEN ACTIVATED BY A PORT AUTHORITY VEHICLE. DO NOT VIOLATE SIDE STREET PEDESTRIAN MINIMUM TIMINGS.
- 3. MAINTAIN ALL YELLOW CLEARANCES AT ALL TIMES.
- 4. PROCEED TO THE SUBSEQUENT INTERVAL AS DEFINED IN THE MOVEMENT, SEQUENCE AND TIMING DIAGRAM UPON COMPLETING THE GREEN EXTENSION INTERVAL.
- 5. ONCE A TRANSIT CALL IS PLACED AND SATISFIED, THE CONTROLLER WILL NOT SATISFY ANOTHER CALL FOR
- 6. LOCATION OF BUS DETECTORS ARE TO BE FIELD ADJUSTED TO ACHIEVE MAXIMUM OPERATION.

DETECTOR ZONE INFORMATION

DETECTOR	DETECTION ZONE(S)	MODE	TYPE	ROUTE	PHASE	LOCATION MAST ARM
①	(8' x 60')	PRESENCE	VIDEO (STOP BAR)	FIFTH AVE.	2	<u>\$</u>
0	② (6' × 60')	PRESENCE	VIDEO (STOP BAR)	FIFTH AVE.	2	<u>/\$</u>
	⟨3⟩ (6′ × 60′)	PRESENCE	VIDEO (STOP BAR)	FIFTH AVE.	2	<u>\$</u>
①	⟨4⟩ (6′ × 60′)	PRESENCE	VIDEO (STOP BAR)	FIFTH AVE.	5	<u>\$</u>
2	⟨5⟩ (14′× 60′)	PRESENCE	VIDEO (STOP BAR)	BOUQUET ST.	8	<u>\$</u>
3	⑥ (4′× 40′)	PRESENCE	RADAR (STOP BAR)	FIFTH AVENUE BICYCLE LANE	2	2
4	⑦ (4'× 40')	PRESENCE	RADAR (STOP BAR)	FIFTH AVENUE BICYCLE LANE	6	<u> </u>

GENERAL NOTES

THE CITY OF PITTSBURGH SHALL INSPECT THE NEW SIGNAL EQUIPMENT PRIOR TO ACTIVATION.

ALL TRAFFIC SIGNAL MAINTENANCE AND OPERATION RESPONSIBILITIES SHALL BE TURNED OVER TO THE CITY OF PITTSBURGH AFTER THE FOLLOWING CONDITIONS ARE IMPLEMENTED TO THE CITY'S SATISFACTION:

- 1. PERMIT "AS-BUILT" TRAFFIC SIGNAL DRAWINGS ARE SUBMITTED AND APPROVED.
- 2. ALL PUNCH LIST ITEMS ARE COMPLETED BY THE CONTRACTOR.
- 3. AFTER THE 30-DAY CONTINUOUS UNINTERRUPTED SIGNAL OPERATION WITHOUT MALFUNCTIONS.

CONSTRUCTION NOTES

- 1. ALL JUNCTION BOXES IN WALK AREAS TO BE CITY OF PITTSBURGH STANDARD CONCRETE JUNCTION BOX, TYPE 1.
- 2. ALL JUNCTION BOXES IN NON-WALK AREAS TO BE CITY STANDARD JB-2 WITH BOTTOM.
- 3. THERE SHALL BE NO SIGNAL WIRE OR FIBER CABLE SPLICING.
- 4. SERVICE WIRE FROM THE POWER SOURCE TO THE CONTROLLER CABINET SHALL BE PLACED IN SECONDARY SEPARATE CONDUIT.
- 5. STREET LIGHT CABLE IS NOT PERMITTED TO RUN THROUGH THE CONTROLLER CABINET AND SHALL BE PLACED IN SEPARATE CONDUIT.
- 6. TRAFFIC SIGNAL CABLE SHALL BE PLACED IN DEDICATED CONDUIT.
- 7. MOUNT DISCONNECT ON POLE NEAREST TO THE CONTROLLER CABINET EXCLUDING TYPE X POLES.
- 8. REMOVE AND DISPOSE OF ALL EXISTING SIGNAL WIRING NO LONGER IN USE.
- 9. REMOVE EXISTING SIGNAL EQUIPMENT NO LONGER IN USE AND RETURN TO THE CITY OF PITTSBURGH TRAFFIC CONTROL SHOP. COORDINATE DELIVERY OF EQUIPMENT WITH DELMAS MCELHANY, TRAFFIC CONTROL FOREMAN.
- 10. REMOVE ALL SIGNALS WHILE POLE IS PAINTED. REFER TO SECTION 02892.

TS-130

_		- · · · · · · · ·	_
	DISTRICT TRAFFIC ENGINEER	DATE	_
	APPROVED AND ACCEPTED:		
	APPROVED AND ACCEPTED:	27.112	
	CITY TRAFFIC ENGINEER	DATE	_
	, , , , , , , , , , , , , , , , , , , ,		
	APPROVED AND ACCEPTED:		_
	AND BOUQUET STREET		
	INTERSECTION: FIFTH AVENUE		
	MUNICIPALITY: CITY OF PITTSBURGH	<u> </u>	
	COUNTY: ALLEGHENY		

AECOM

Gulf Tower 707 Grant Street 5th Floor Pittsburgh, PA 15219 ((₁DRIVE **ENGINEERING**

595 Skippack Pk, Suite 400 Blue Bell, PA 19422

			THE PREPARATION OF THIS
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-			U.S. DEPARTMENT OF
-			TRANSPORTATION, UNDER THE URBAN MASS TRANSPORTATION ACT
			OF 1964. AS AMENDED, FOR THE
NO.	DATE	DESCRIPTION	PORT AUTHORITY OF ALLEGHENY COUNTY, PENNSYLVANIA.
		REVISIONS	COUNTY, PENINSTEVANIA.

(NOT FOR CONSTRUCTION)

DESIGNED	MW	
DRAWN	MW	
CHECKED	<u>EMC</u>	
IN CHARGE	EMC	
DATE	05/01/24	
SCALE		
	AS SHOWN	

PORT AUTHORITY OF ALLEGHENY COUNTY

BUS RAPID TRANSIT UPTOWN TO OAKLAND SIGNAL PLANS WIRING, MOVEMENT, PHASING & SEQUENCE DIAGRAMS

Port Authority

CONTRACT NO. BRT-001 sнт. 1132

DWG.NO. SG72

sнт. 1133

I TEM NUMBER	MISC	ELLAN	IEOUS	
UNIT	DESCRIPTION	QTY.	LOCATION	REMARKS
01882. 002 EACH	TRAFFIC SIGNAL TIMING MODIFICATIONS	2	СС	
02890. 005 EACH	GPS TIME CLOCK	1	СС	
02894. 001 EACH	VEHICULAR SIGNAL HEAD, THREE 12" SECTIONS	3	123	BLACK TUNNEL VISORS BLACK ALUMINUM HOUSINGS BLACK METAL LOUVERED BACKPLATE
02894. 006 EACH	VEHICULAR SIGNAL HEAD, THREE 8" SECTIONS	2	67	BLACK TUNNEL VISORS BLACK ALUMINUM HOUSINGS BLACK METAL LOUVERED BACKPLATE
02894. 005 EACH	LED COUNTDOWN PEDESTRIAN SIGNAL HEAD, TYPE A	2	00	BLACK TUNNEL VISORS BLACK ALUMINUM HOUSINGS
02895. 002 EACH	ACCESSIBLE PEDESTRIAN SIGNALS	2	112	
02897. 011 EACH	CONNECT TO EXISTING JUNCTION BOX	2	1 4	
02894. 022 EACH	RESET PEDESTRIAN SIGNAL HEAD	1	<u></u> \$	NW CORNER
02894. 031 EACH	REMOVE VEHICULAR SIGNAL HEAD	2	\triangle	SE CORNER
02892. 501 EACH	EXISTING TRAFFIC SIGNAL SUPPORT, PAINTED BLACK	4	<u> </u>	TEMPORARILY REMOVE ATTACHED SIGNAL HARDWARE AND PAINT SIGNAL SUPPORT BLACK. REATTACH HARDWARE WHEN COMPLETE.
02212. 009 EACH	POLE FOUNDATION DRILLING, LESS THAN 30" DIAMETER	8	<u> </u>	
02212. 010 EACH	POLE FOUNDATION DRILLING, 30" DIAMETER OR GREATER	13	<u>\$</u>	

DETECTORS

ITEM NUMBER	DESCRIPTION	SEN. NO.	QTY.	LOCATION
02895 . 001	VIDEO DETECTION	<u> </u>	2	<i>3</i> √5
EACH		~ ~		7-7-2-3
02895. 005 EACH	DIGITAL WAVE RADAR DETECTION	34	2	<u> </u>

TRAFFIC SIGNAL SUPPORTS **

	ΣЩ Δ			ROUTE	TION		_		MAST ARM PEDESTA									≣STAI	_							
POLE NO.	1 TE	TIE DESCRIPTION F ROUTE E	QTY.			SIDE	OFFSET		ARM "A"										ARM "C"			SHAFT	SIG	NAL		
	_		ST	"	5	Н	нк		SIGNAL LOCATION				:	SIGN	LOC	OITA	1	w	G	x	z	Н	м	N		
	UNIT										М	N	0	Р	R	S	Т	U	Υ							
\triangle		TRAFFIC SIGNAL SUPPORT, 14' MAST ARM		FIFTH AVE.	544+04	RT	31'	17 '	10'	14'	13'	1 '			3'					o°						
<u>^</u>	02892. 004 EACH	TRAFFIC SIGNAL SUPPORT, 19' TYPE X, PAINTED BLACK	1	FIFTH AVE.	543+98	RT	33′																	19′	17′	10′
3		TRAFFIC SIGNAL SUPPORT, 18' MAST ARM		FIFTH AVE.	543+53	RT	46 '	17 '	10'	18'	15'	6'			10'	6′				90°						
4		TRAFFIC SIGNAL SUPPORT, 15' TYPE X		FIFTH AVE.	543+41	RT	321																	15'	17 '	10'
<u>/\$</u>	02892. 607 EACH	TRAFFIC SIGNAL SUPPORT, 46' MAST ARM, PAINTED BLACK	1	FIFTH AVE.	543+18	LT	31′	17′	10′	10′	45′	30′	13′		40′	26′	10′		3′	0°						
<u>6</u>		TRAFFIC SIGNAL SUPPORT, 30' TYPE X WITH LUMINAIRE ARM (30' MOUNTING HEIGHT)		FIFTH AVE.	543+90	LT	31 ′															30 '	o°	15′	17 '	10'

** REFER TO PENNDOT TC-8800 TRAFFIC STANDARDS - SIGNALS FOR LETTER DESIGNATION

AECOM

Gulf Tower 707 Grant Street 5th Floor Pittsburgh, PA 15219

((DRIVE ENGINEERING 595 Skippack Pk, Suite 400 Blue Bell, PA 19422

		THE PREPARATION OF THIS DOCUMENT HAS BEEN FINANCED IN
		PART THROUGH A GRANT FROM THE
		FEDERAL TRANSIT ADMINISTRATION, U.S. DEPARTMENT OF
		TRANSPORTATION, UNDER THE
		URBAN MASS TRANSPORTATION ACT OF 1964, AS AMENDED, FOR THE
DATE		PORT AUTHORITY OF ALLEGHENY COUNTY, PENNSYLVANIA.
	REVISIONS	COUNTY, FEMINISTEVANIA.

(NOT FOR CONSTRUCTION)

SIGNED	MW	PORT AUTHOR	ITY OF AL	LEGHENY CO	UNTY
RAWN	MW	PITTSBURGH		PENN	SYLVANIA
IECKED	<u>EMC</u>	BUS RAPID TE	RANSIT UPT	OWN TO OAKL	AND
CHARGE	<u>EMC</u>		SIGNAL PL		
TE	05/01/24	TRAF	FIC SIGNAL T	ABULATIONS	
ALE	AS SHOWN	Port Authority	CONTR	ACT NO. BRT-0	01
	AS SHOWN	connecting people to life	DWG. NO.	SG73	sнт. 11

FIFTH AVENUE AND BOUQUET STREET

TRENCH, CONDUIT, JUNCTION BOX, ELECTRICAL ITEMS

DESCRIPTION	CITY OF PITTSBURGH STANDARD CONCRETE JUNCTION BOX, TYPE 1	TRENCH AND BACKFILL, TYPE I	TRENCH AND BACKFILL, TYPE II	TRENCH AND BACKFILL, TYPE IV	2 INCH CONDUIT	3 INCH CONDUIT	SIGNAL CABLE, 14 AWG, 5 CONDUCTOR	SIGNAL CABLE, 14 AWG, 7 CONDUCTOR
ITEM NUMBER	02897	02898	02898	02898	02899	02899	02900	02900
TIEM IVOMOLIN	001	001	002	005	002	003	002	003
UNIT	EACH	LF	LF	LF	LF	LF	LF	LF
LOCATION								
4 TO 3	1		63		63	126		
1 то ∕҈≥		5				5		
3 то ∕ѕ∕		4	1		5	10		
COMPLETE INTERSECTION							704	318
TOTAL	1	9	64		68	141	704	318

SIGNS

SYMBOL	SERIES	SIZE	AREA EACH (SQ FT)	DESCRIPTION	QUANTITY	02891.001 POST MOUNTED SIGNS, TYPE B	02891.003 POST MOUNTED SIGNS, TYPE F	STRUCTURE MOUNTED FLAT SHEET ALUMINUM SIGN WITH STIFFENERS
0	R3-1	30"X30"	6.3	NO RIGHT TURN	2		6.3	6.3
D	R10-3E(MOD)	9 "X15 "	0.9	EDUCATIONAL PUSH BUTTON FOR WALK SIGNAL WITH COUNTDOWN TIMER	2			A
F	D3-4*	72 "X24 "	12	100 OAKLAND 099 BOUQUET ST	1			12
G	R6-1	36 "X12 "	2.5	ONE-WAY (TWO SIDED, CITY STANDARD)	2		5	
J	SPECIAL	30 "X24 "	5.0	BUSES ONLY	1			5
K	R10-10L	30"×36"	7.5	LEFT TURN SIGNAL	1			7.5
	R5-1	30"X30"	6.3	DO NOT ENTER	4	12.6	12.6	
P	R3-2	30"X30"	6.3	NO LEFT TURN	1		6.3	
①	R3-7bP	24"X12"	2	EXCEPT BICYCLES	3		6	
				TOTAL		12.6	36.2	30.8

▲ - INCIDENTAL TO ITEM 02895.002

* WHITE REFLECTORIZED LEGEND AND BORDER ON BLUE REFLECTORIZED BACKGROUND.
UTILIZE 4" CLEARVIEW 3W FOR BLOCK/NEIGHBORHOOD AND 8" CLEARVIEW 3W FOR
STREET NAME. ACTUAL WIDTH DETERMINED BY LETTER SPACING. COORDINATE BLOCK
NUMBERS AND STREET NAME DETAILS WITH CITY OF PITTSBURGH DEPARTMENT OF
MOBILITY AND INFRASTRUCTURE.

AECOM

Gulf Tower 707 Grant Street 5th Floor Pittsburgh, PA 15219



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FEDERAL TRANSIT ADMINISTRATION,
U.S. DEPARTMENT OF
TRANSPORTATION, UNDER THE
URBAN MASS TRANSPORTATION ACT
OF 1964, AS AMENDED, FOR THE
PORT AUTHORITY OF ALLEGHENY
COUNTY, PENNSYLVANIA. NO. DATE DESCRIPTION REVISIONS

(NOT FOR CONSTRUCTION)

DESIGNED	MW	PORT AUTHOR	ITY OF AL	LEGHENY COL	JNTY				
DRAWN	MW	PITTSBURGH		PENNS	SYLVANIA				
CHECKED	<u>EMC</u>	BUS RAPID TRANSIT UPTOWN TO OAKLAND							
IN CHARGE	EMC	SIGNAL PLANS							
DATE	<u>05/01/24</u>	TRAF	FIC SIGNAL T	ABULATIONS					
SCALE	AS SHOWN	Port Authority	CONTR	ACT NO. BRT-00)1				
	AOOHOWN	connecting people to life	DWG. NO.	SG74	sнт. 1134				

sнт. 1134



AUDIBLE PEDESTRIAN SIGNAL NOTES

- 1. ALL PUSH BUTTONS SHALL BE EQUIPPED WITH LOCATOR TONES.
- 2. ALL WALK INTERVALS TO HAVE VERBAL MESSAGE DETAILING WALK DIRECTION.
- 3. VERBAL MESSAGE TO BE PLAYED DURING WALK INTERVAL WHEN BUTTON IS PRESSED.
- 4. ALL PEDESTRIAN PUSH BUTTONS TO BE LOCATED AT
- 5. ALL PUSH BUTTONS TO BE EQUIPPED WITH VIBROTACTILE
- 6. VIBROTACTILE ARROWS TO VIBRATE DURING WALK INTERVAL.

7. WALK AND DON'T WALK MESSAGE SHALL BE AUDIBLE THOUGH THE PUSH BUTTON SPEAKER. SIGNAL ASSEMBLY NOTES

- 1. ALL VEHICULAR/BICYCLE SIGNALS SHALL BE EQUIPPED WITH L.E.D LENSES, TUNNEL VISORS AND LOUVERED BLACK METAL BACKPLATES WITH 2" REFLECTIVE BORDERS.
- 2. MIN/MAX HEIGHT FOR VEHICULAR SIGNALS 17'/18'.
- 3. MIN HORIZONTAL SPACING FOR VEHICULAR SIGNALS IS 8'.
- 4. MIN/MAX HEIGHT FOR PEDESTRIAN MOUNTED SIGNALS 10'/12'.
- FINAL SIGNAL HEAD PLACEMENT WILL BE DETERMINED BY A REPRESENTATIVE OF THE CITY OF PITTSBURGH DEPARTMENT OF MOBILITY AND INFRASTRUCTURE PRIOR TO SIGNAL BEING
- 6. ALL PEDESTRIAN SIGNALS SHALL BE PORTLAND ORANGE FULL "PEDESTRIAN HAND" AND WHITE "WALKING PERSON" SYMBOLS AND HAVE INCANDESCENT LOOK WITH COUNTDOWN TIMER.
- 7. PROVIDE AIRCRAFT STRANDED CABLE FOR MOUNTING SIGNAL AND SIGN BRACKET ASSEMBLIES TO MAST ARMS.
- 8. PROVIDE BLACK ALUMINUM HOUSINGS FOR ALL SIGNAL HEADS.
- 9. INSTALL POST MOUNTED SIGNAL HEADS WITH BOTTOMS NO GREATER THAN 15' ABOVE THE SIDEWALK OR PAVEMENT.

 10. EXACT LOCATION OF TRAFFIC SIGNAL SUPPORTS SHALL BE DETERMINED BY A REPRESENTATIVE OF THE CITY OF PITTSBURGH DEPARTMENT OF MOBILITY AND INFRASTRUCTURE PRIOR TO INSTALLATION PRIOR TO INSTALLATION.

PAVEMENT MARKING NOTES

- 1. ALL STOP BARS ARE W/24".
- CROSSWALKS ARE 10'X 24" KEYS WITH 3' TO 5' SPACING.
- 3. CROSSWALKS ACROSS BICYCLE LANES ARE 6'X 12" KEYS WITH 1' SPACING.

TS-316

COUNTY: ALLEGHENY MUNICIPALITY: CITY OF PITTSBURGH INTERSECTION: FIFTH AVENUE AND THACKERAY AVENUE APPROVED AND ACCEPTED: CITY TRAFFIC ENGINEER DATE APPROVED AND ACCEPTED:

DISTRICT TRAFFIC ENGINEER

DATE PORT AUTHORITY OF ALLEGHENY COUNTY **PITTSBURGH** PENNSYLVANIA

BUS RAPID TRANSIT UPTOWN TO OAKLAND SIGNAL PLANS

FIFTH AVENUE & THACKERY AVENUE

Port Authority DWG NO

CONTRACT NO. BRT-001 SG75 sнт. 1135

AECOM

707 Grant Street 5th Floor Pittsburgh, PA 15219 **ENGINEERING**

595 Skippack Pk, Suite 400 Blue Bell, PA 19422

FEDERAL TRANSIT ADMINISTRATION J.S. DEPARTMENT OF FRANSPORTATION, UNDER THE URBAN MASS TRANSPORTATION ACT OF 1964 AS AMENDED FOR THE NO. DATE DESCRIPTION COUNTY, PENNSYLVANIA. REVISIONS

CONSTRUCTION

N CHARGE

DATE

SCALE


EMC

05/01/24

AS SHOWN

(NOT FOR

		Pł	HASE	2			PH	IASE	8						
							BIKE-								
INTERVAL	1	2	3	4		1	2	3	4	5					
1-2	G	G	Υ	R		R	R R		R	R	R				
3-4	R	R	R	R		R	G	G	Υ	R	R				
5-6	G	G	Y	R		RRR			R	R	OFF				
7-8	W	FD	DW	DW		DW DW DW			DW	DW	0FF				
9-10	DW	DW	DW	DW		W	W	FD	DW	DW	OFF				
11-12	DW	DW	DW	DW		W	W	FD	DW	DW	OFF				
FIXED	\wedge	\leq	3.5	2.5		$/ \setminus$	><	\leq	3	4					
MINIMUM	1	5					18								
PASSAGE		3				3									
FREE (MAX)	5	6					31								
PEDESTRIAN	7	10				5	2	16							
MEMORY		MIN	REC	CALL			PED	REC	CALL						

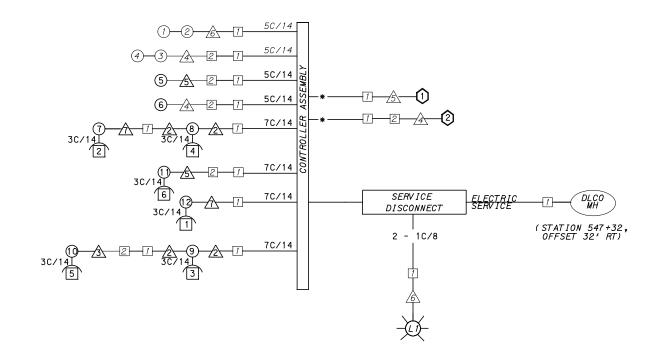

WIRING DIAGRAM

5C/14 - CABLE(NO. OF CONDUCTORS/SIZE AWG.)

SIGNAL HEAD

AUDIBLE PEDESTRIAN __ JUNCTION BOX INDICATOR

RADAR DETECTOR

LUMINAIRE

INCIDENTAL TO ITEM 02895.001, AS PER MANUFACTURERS SPECIFICATIONS

3C/14 INCIDENTAL TO ITEM 02895.002

TRANSIT PRIORITY PRE-EMPTION NOTES (TO BE INSTALLED BY OTHERS)

- COORDINATE TRAFFIC CONTROLLER PROGRAMMING MODIFICATION WITH REPRESENTATIVES OF THE CITY OF PITTSBURGH AND DISTRICT TRAFFIC UNIT.
- 2. INCLUDE A TRANSIT PRIORITY PHASE THAT WILL EXTEND THE INDICATED PHASE A MAXIMUM OF 10 SECONDS WHEN ACTIVATED BY A PORT AUTHORITY VEHICLE. DO NOT VIOLATE SIDE STREET PEDESTRIAN MINIMUM TIMINGS.
- 3. MAINTAIN ALL YELLOW CLEARANCES AT ALL TIMES.
- 4. PROCEED TO THE SUBSEQUENT INTERVAL AS DEFINED IN THE MOVEMENT, SEQUENCE AND TIMING DIAGRAM UPON COMPLETING THE GREEN EXTENSION INTERVAL.
- 5. ONCE A TRANSIT CALL IS PLACED AND SATISFIED, THE CONTROLLER WILL NOT SATISFY ANOTHER CALL FOR
- 6. LOCATION OF BUS DETECTORS ARE TO BE FIELD ADJUSTED TO ACHIEVE MAXIMUM OPERATION.

DETECTOR ZONE INFORMATION

DETECTOR	DETECTION ZONE(S)	MODE	TYPE	ROUTE	PHASE	LOCATION MAST ARM
(1)	(8' x 60')	PRESENCE	VIDEO (STOP BAR)	FIFTH AVE.	2	<u> </u>
0	② (6' × 60')	PRESENCE	VIDEO (STOP BAR)	FIFTH AVE.	2	<u> </u>
0	⟨3⟩ (6′ × 60′)	PRESENCE	VIDEO (STOP BAR)	FIFTH AVE.	2	<u> </u>
0	⟨4⟩ (6′ × 60′)	PRESENCE	VIDEO (STOP BAR)	FIFTH AVE.	2	<u> </u>
2	⟨5⟩ (19′× 60′)	PRESENCE	VIDEO (STOP BAR)	THACKERAY AVE.	8	<u> </u>

GENERAL NOTES

THE CITY OF PITTSBURGH SHALL INSPECT THE NEW SIGNAL EQUIPMENT PRIOR TO ACTIVATION.

ALL TRAFFIC SIGNAL MAINTENANCE AND OPERATION RESPONSIBILITIES SHALL BE TURNED OVER TO THE CITY OF PITTSBURGH AFTER THE FOLLOWING CONDITIONS ARE IMPLEMENTED TO THE CITY'S SATISFACTION:

- 1. PERMIT "AS-BUILT" TRAFFIC SIGNAL DRAWINGS ARE SUBMITTED AND APPROVED.
- 2. ALL PUNCH LIST ITEMS ARE COMPLETED BY THE CONTRACTOR.
- 3. AFTER THE 30-DAY CONTINUOUS UNINTERRUPTED SIGNAL OPERATION WITHOUT MALFUNCTIONS.

CONSTRUCTION NOTES

- 1. ALL JUNCTION BOXES IN WALK AREAS TO BE CITY OF PITTSBURGH STANDARD CONCRETE JUNCTION BOX, TYPE 1.
- 2. ALL JUNCTION BOXES IN NON-WALK AREAS TO BE CITY STANDARD JB-2 WITH BOTTOM.
- 3. THERE SHALL BE NO SIGNAL WIRE OR FIBER CABLE SPLICING.
- 4. SERVICE WIRE FROM THE POWER SOURCE TO THE CONTROLLER CABINET SHALL BE PLACED IN SECONDARY SEPARATE CONDUIT.
- 5. STREET LIGHT CABLE IS NOT PERMITTED TO RUN THROUGH THE CONTROLLER CABINET AND SHALL BE PLACED IN SEPARATE CONDUIT.
- 6. TRAFFIC SIGNAL CABLE SHALL BE PLACED IN DEDICATED CONDUIT.
- 7. MOUNT DISCONNECT ON POLE NEAREST TO THE CONTROLLER CABINET EXCLUDING TYPE X POLES.
- 8. REMOVE AND DISPOSE OF ALL EXISTING SIGNAL WIRING NO LONGER IN USE.
- 9. REMOVE EXISTING SIGNAL EQUIPMENT NO LONGER IN USE AND RETURN TO THE CITY OF PITTSBURGH TRAFFIC CONTROL SHOP. COORDINATE DELIVERY OF EQUIPMENT WITH DELMAS MCELHANY, TRAFFIC CONTROL FOREMAN.
- 10. REMOVE ALL SIGNALS WHILE POLE IS PAINTED. REFER TO SECTION 02892.

TS-316

sнт. 1136

COUNTY: ALLEGHENY	
MUNICIPALITY: CITY OF PITTSBURGH	
INTERSECTION:FIFTH AVENUE	
AND THACKERAY AVENUE	
APPROVED AND ACCEPTED:	
CITY TRAFFIC ENGINEER DATE	
APPROVED AND ACCEPTED:	
DISTRICT TRAFFIC ENGINEER DATE	

AECOM

Gulf Tower 707 Grant Street 5th Floor Pittsburgh, PA 15219 **ENGINEERING**

595 Skippack Pk, Suite 400 Blue Bell, PA 19422

			THE PREPARATION OF THIS OCUMENT HAS BEEN FINANCED IN
			PART THROUGH A GRANT FROM TH
			FEDERAL TRANSIT ADMINISTRATION
			TRANSPORTATION, UNDER THE
			URBAN MASS TRANSPORTATION AC OF 1964, AS AMENDED, FOR THE
NO.	DATE	DESCRIPTION	PORT AUTHORITY OF ALLEGHENY COUNTY, PENNSYLVANIA.
		REVISIONS	COUNTY, FEMING PEVANIA.

(NOT FOR CONSTRUCTION)

DESIGNED	MW	
DRAWN	<u>MW</u>	
CHECKED	<u>EMC</u>	
IN CHARGE	<u>EMC</u>	
DATE	05/01/24	
SCALE	AS SHOWN	

PORT AUTHORITY OF ALLEGHENY COUNTY

BUS RAPID TRANSIT UPTOWN TO OAKLAND SIGNAL PLANS WIRING, MOVEMENT, PHASING & SEQUENCE DIAGRAMS

CONTRACT NO. BRT-001 **Port Authority** DWG.NO. SG76

TRAFFIC SIGNAL TABULATION

FIFTH AVENUE AND THACKERAY AVENUE

ITEM NUMBER	MISCE	ELLAN	IEOUS	
UNIT	DESCRIPTION	QTY.	LOCATION	REMARKS
01882. 002 EACH	TRAFFIC SIGNAL TIMING MODIFICATIONS	2	СС	
02890. 005 EACH	GPS TIME CLOCK	1	СС	
02890. 006 EACH	TRAFFIC SIGNAL CONTROLLER ASSEMBLY FOUNDATION, FUTURE INSTALLATION OF TYPE 332 BASE MOUNTED CABINET AND 8" RISER	1		ONLY INSTALL A CONTROLLER CABINET FOUNDATION AND PROPOSED CONDUITS TO FIT A FUTURE TYPE 332 CABINET AND 8" RISER.
02894. 005 EACH	LED COUNTDOWN PEDESTRIAN SIGNAL HEAD, TYPE A	6	789 000	BLACK TUNNEL VISORS BLACK ALUMINUM HOUSINGS
02894. 006 EACH	VEHICULAR SIGNAL HEAD, THREE 8" SECTIONS		56	BLACK TUNNEL VISORS BLACK ALUMINUM HOUSINGS BLACK METAL LOUVERED BACKPLATE
02895. 002 EACH	ACCESSIBLE PEDESTRIAN SIGNALS	6	①23 456	
02897. 011 EACH	CONNECT TO EXISTING JUNCTION BOX	2	12	
02891. 021 EACH	RESET STRUCTURE MOUNTED FLAT SHEET ALUMINUM SIGN WITH STIFFERNERS	1	Â	NW CORNER
02893. 003 EACH	REMOVE EXISTING MAST ARM	1	À	SOUTHERN CORNER
02892. 501 EACH	EXISTING TRAFFIC SIGNAL SUPPORT, PAINTED BLACK	3	A A 6	TEMPORARILY REMOVE ATTACHED SIGNAL HARDWARE AND PAINT SIGNAL SUPPORT BLACK. REATTACH HARDWARE WHEN COMPLETE.

26 /2 /3 /5 /7

DETECTORS

ITEM NUMBER	DESCRIPTION	SEN. NO.	QTY.	LOCATION
02895. 001 EACH	VIDEO DETECTION	00	2	<u> </u>

TRAFFIC SIGNAL SUPPORTS **

	- K				NO							MAST	ARM																PE	DESTA	L
POLE NO.	1 TEM NUMBER	DESCRIPTION	QTY.	ROUTE	ATI	10E				ARM "A"					ARM "B"						ARM "C"		SHAFT	SIG	NAL						
					ST	s 문	Н	K		SIGNAL	LOCATIO	N S	SIGN I	LOCA		w	L	SIGNA	L LC	CATI	ION		GN LO			w	G	x z	н	м	N
	UNIT									M N	0 P	R	S	T	UY			М	N	0	P	R	S T	U	Y						
\triangle		TRAFFIC SIGNAL SUPPORT, 15' TYPE X		FIFTH AVE	547+44	LT 34	,																						15'		
<u>^</u>	02892. 003 EACH	TRAFFIC SIGNAL SUPPORT, 15' TYPE X, PAINTED BLACK	1	FIFTH AVE	547+25	LT 27	,																						15′		10′
<u> </u>	02892. 003 EACH	TRAFFIC SIGNAL SUPPORT, 15' TYPE X, PAINTED BLACK	1	FIFTH AVE	547+37	RT 31	,																						15′		10′
4		TRAFFIC SIGNAL SUPPORT, 20' MAST ARM		FIFTH AVE	547+16	RT 31	17 '	15′	20 '	18' 7'		15'	11'			o°															
<u>\(\frac{1}{5} \)</u>	02892. 004 EACH	TRAFFIC SIGNAL SUPPORT, 19' TYPE X, PAINTED BLACK	1	FIFTH AVE	546+91	RT 31	,																						19′	17′	10′
<u></u>		TRAFFIC SIGNAL SUPPORT, 40' MAST ARM WITH LUMINAIRE ARM (30' MOUNTING HEIGHT)		FIFTH AVE	546+58	LT 31	17 '		40'	38 ' 16 '		23′	13'		4'	0°											3	0' 0'			
A	02892. 003 EACH	TRAFFIC SIGNAL SUPPORT, 15' TYPE X, PAINTED BLACK	1	FIFTH AVE	546+79	LT 27	,																						15′		10′

** REFER TO PENNDOT TC-8800 TRAFFIC STANDARDS - SIGNALS FOR LETTER DESIGNATION

02212-009 POLE FOUNDATION DRILLING, LESS THAN 30" DIAMETER

707 Grant Street 5th Floor Pittsburgh, PA 15219

((DRIVE ENGINEERING 595 Skippack Pk, Suite 400 Blue Bell, PA 19422

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DATE	DESCRIPTION	TRANSPORTATION, UNDER THE URBAN MASS TRANSPORTATION ACT OF 1964, AS AMENDED, FOR THE PORT AUTHORITY OF ALLEGHENY
	REVISIONS	COUNTY, PENNSYLVANIA.

(NOT FOR CONSTRUCTION)

DESIGNED	MW	
DRAWN	MW	
CHECKED	EMC	
IN CHARGE	EMC	
DATE	05/01/24	
SCALE		
	AS SHOWN	

PORT AUTHORITY OF ALLEGHENY COUNTY PENNSYLVANIA BUS RAPID TRANSIT UPTOWN TO OAKLAND

SIGNAL PLANS TRAFFIC SIGNAL TABULATIONS

Port Authority
connecting people to life CONTRACT NO. BRT-001 DWG. NO. SG77 sнт. 1137

FIFTH AVENUE AND THACKERAY AVENUE

TRENCH, CONDUIT, JUNCTION BOX, ELECTRICAL ITEMS

DESCRIPTION	2 INCH CONDUIT	3 INCH CONDUIT	TRENCH AND BACKFILL, TYPE I	TRENCH AND BACKFILL, TYPE II	TRENCH AND BACKFILL, TYPE IV	SIGNAL CABLE, 14 AWG, 5 CONDUCTOR	SIGNAL CABLE, 14 AWG, 7 CONDUCTOR	CITY OF PITTSBURGH STANDARD CONCRETE JUNCTION BOX, TYPE 1
ITEM NUMBER	02899	02899	02898	02898	02898	02900	02900	02897
TIEW NOMBER	002	003	001	002	005	002	003	001
UNIT	LF	LF	LF	LF	LF	LF	LF	EACH
LOCATION								
<u> </u>		11	11					
<u> </u>		64	32		32			
<u>∕2</u> то <i>1</i>		17	17					
2 TO <u>\$</u>		33	9	24				
/ то ▶	6	12	1	2				
COMPLETE INTERSECTION						297	652	
TOTAL	6	137	70	26	32	297	652	

NOTE: THE EQUIPMENT GROUNDING CONDUCTOR FOR LIGHTING CIRCUITS IS INCLUDED WITH THE CIRCUIT ITEM QUANTITIES.

SIGNS

SYMBOL	SERIES	SIZE	AREA EACH (SQ FT)	DESCRIPTION	QUANTITY	02891.001 뉴 POST MOUNTED SIGNS, TYPE B	02891,003 유 POST MOUNTED SIGNS, TYPE F	STRUCTURE MOUNTED FLAT SHEET ALUMINUM SIGN WITH STIFFENERS
D	R10-3E(MOD)	9 "X15 "	0.9	EDUCATIONAL PUSH BUTTON FOR WALK SIGNAL WITH COUNTDOWN TIMER	6			A
C	SPECIAL	30 "X24 "	5	BUSES ONLY	1			5
G	R5-1	30"X30"	6.3	DO NOT ENTER	4	18.9	6.3	
P	R3-7bP	24"X12"	2	EXCEPT BICYCLES	2		4	
				TOTAL		18.9	10.3	5

▲ - INCIDENTAL TO ITEM 02895.002

* WHITE REFLECTORIZED LEGEND AND BORDER ON BLUE REFLECTORIZED BACKGROUND.
UTILIZE 4" CLEARVIEW 3W FOR BLOCK/NEIGHBORHOOD AND 8" CLEARVIEW 3W FOR
STREET NAME. ACTUAL WIDTH DETERMINED BY LETTER SPACING. COORDINATE BLOCK
NUMBERS AND STREET NAME DETAILS WITH CITY OF PITTSBURGH DEPARTMENT OF
MOBILITY AND INFRASTRUCTURE.



Gulf Tower 707 Grant Street 5th Floor Pittsburgh, PA 15219



Blue Bell, PA 19422

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U.S. DEPARTMENT OF
TRANSPORTATION, UNDER THE
URBAN MASS TRANSPORTATION ACT
OF 1984, AS AMENDED, FOR THE
NO. DATE
DESCRIPTION
PORT AUTHORITY OF ALLEGHENY
COUNTY, PENNSYLVANIA.

(NOT FOR CONSTRUCTION)

DESIGNED	MW	PORT AUTHORITY OF ALLEGHENY COUNTY	
DRAWN	MW	PITTSBURGH PENNSYLVANIA	
CHECKED	EMC	BUS RAPID TRANSIT UPTOWN TO OAKLAND	
N CHARGE	EMC	SIGNAL PLANS	
DATE	05/01/24	TRAFFIC SIGNAL TABULATIONS	

Port Authority CCC

AS SHOWN

CONTRACT NO. BRT-001

DWG. NO. SG78 SHT. 1138


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		PH	IASE	6			PH	ASE	2+5			РНА	SE ·	4+8		
	B I K į			一	BUS IKE	BIKE	=	——————————————————————————————————————	=	BUS	B I K			ľĖ	BUS	HT40HT2C
SIGNAL	1	2	3	4	-	1	2	3	-	-	1	2	3	4	5	
1	- R-	- R−	 R-	 R-		- G−	- Y-	- R-			- R-	- R-	- R-	- R−	 R-	0FF
2-3-4	G	G	YΦ	RΦ		G	Υ	R			R	R	R	R	R	R
5-6	R	R	R	R		R	R	R			R	G	G	Υ	R	R
7-8	R	R	R	R		R	R	R			R	G	G	Υ	R	R
9-10-11	G	G	Υ	R		R	R	R			R	R	R	R	R	0FF
12-13	R	R	R	R		R	R	R			R	G	G	Υ	R	0FF
14-15	W	FD	DW	DW		DW	DW	DW			DW	DW	DW	DW	DW	0FF
16-17	W	FD	DW	DW		DW	DW	DW			DW	DW	DW	DW	DW	0FF
18-19	DW	DW	DW	DW		DW	DW	DW			W	W	FD	DW	DW	0FF
20-21	DW	DW	DW	DW		DW	DW	DW			W	W	FD	DW	DW	0FF
		L,				Ĺ.,							L			
FIXED	\geq	\leq	2.5	5.5		\geq	4	3			\geq	<u>~</u>	\leq	3.5	2.5	
MINIMUM		5				1	8					15				
PASSAGE		3					3					3				
FREE (MAX)	25					3	4				56					
PEDESTRIAN	7 18										5	2	17			
MEMORY		PED	-REC	ALL		ΜI	NIM	UM F	RECA	LL		PED	-REC	CALL		

CONTROLLER NOTES

1 G IF FOLLOWED BY PHASE 2+5

TRANSIT PRIORITY PRE-EMPTION NOTES (TO BE INSTALLED BY OTHERS)

- COORDINATE TRAFFIC CONTROLLER PROGRAMMING MODIFICATION WITH REPRESENTATIVES OF THE CITY OF PITTSBURGH AND DISTRICT TRAFFIC UNIT.
- 2. INCLUDE A TRANSIT PRIORITY PHASE THAT WILL EXTEND THE INDICATED PHASE A MAXIMUM OF 10 SECONDS WHEN ACTIVATED BY A PORT AUTHORITY VEHICLE. DO NOT VIOLATE SIDE STREET PEDESTRIAN MINIMUM TIMINGS.
- 3. MAINTAIN ALL YELLOW CLEARANCES AT ALL TIMES.
- 4. PROCEED TO THE SUBSEQUENT INTERVAL AS DEFINED IN THE MOVEMENT, SEQUENCE AND TIMING DIAGRAM UPON COMPLETING THE GREEN EXTENSION INTERVAL.
- 5. ONCE A TRANSIT CALL IS PLACED AND SATISFIED, THE CONTROLLER WILL NOT SATISFY ANOTHER CALL FOR
- 6. LOCATION OF BUS DETECTORS ARE TO BE FIELD ADJUSTED TO ACHIEVE MAXIMUM OPERATION.

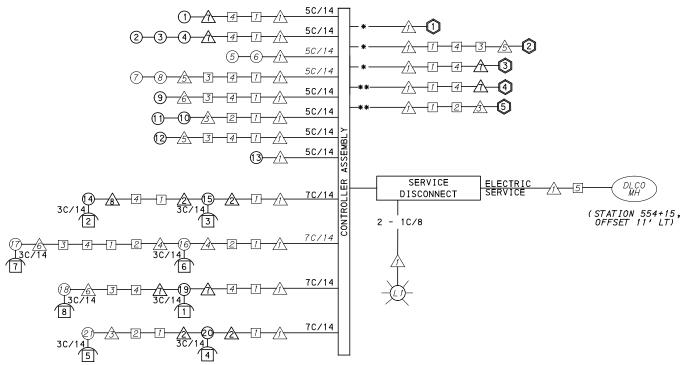

WIRING DIAGRAM

5C/14 - CABLE(NO. OF CONDUCTORS/SIZE AWG.)

SIGNAL HEAD

AUDIBLE PEDESTRIAN INDICATOR

☐ JUNCTION BOX

RADAR DETECTOR

-L1-LUMINAIRE

* INCIDENTAL TO ITEM 02895.001, AS PER MANUFACTURERS SPECIFICATIONS

3C/14 INCIDENTAL TO ITEM 02895.002

** INCIDENTAL TO ITEM 02895.005, AS PER MANUFACTURERS SPECIFICATIONS

DETECTOR ZONE INFORMATION

DETECTOR	DETECTION ZONE(S)	MODE	TYPE	ROUTE	PHASE	LOCATION MAST ARM
3	(1) (7' × 60')	PRESENCE	VIDEO (STOP BAR)	FIFTH AVENUE	2	A
3	② (6' × 60')	PRESENCE	VIDEO (STOP BAR)	FIFTH AVENUE	2	A
3	③ (6′× 60′)	PRESENCE	VIDEO (STOP BAR)	FIFTH AVENUE	2	A
3	⟨ 4 ⟩ (6′ × 60′)	PRESENCE	VIDEO (STOP BAR)	FIFTH AVENUE	5	A
0	⟨5⟩ (8′× 60′)	PRESENCE	VIDEO (STOP BAR)	BIGELOW BOULEVARD	4	\triangle
0	⟨6⟩ (6′ × 60′)	PRESENCE	VIDEO (STOP BAR)	BIGELOW BOULEVARD	4	\triangle
2	⟨7⟩ (8′× 60′)	PRESENCE	VIDEO (STOP BAR)	BIGELOW BOULEVARD	8	<u> </u>
2	(8' × 60')	PRESENCE	VIDEO (STOP BAR)	BIGELOW BOULEVARD	8	<u> </u>
4	⟨9⟩ (4′ × 40′)	PRESENCE	RADAR (STOP BAR)	FIFTH AVENUE BICYCLE LANE	6	<u> </u>
3	(0) (4' × 40')	PRESENCE	RADAR (STOP BAR)	FIFTH AVENUE BICYCLE LANE	6	A

GENERAL NOTES

THE CITY OF PITTSBURGH SHALL INSPECT THE NEW SIGNAL EQUIPMENT PRIOR TO ACTIVATION.

ALL TRAFFIC SIGNAL MAINTENANCE AND OPERATION RESPONSIBILITIES SHALL BE TURNED OVER TO THE CITY OF PITTSBURGH AFTER THE FOLLOWING CONDITIONS ARE IMPLEMENTED TO THE CITY'S SATISFACTION:

- 1. PERMIT "AS-BUILT" TRAFFIC SIGNAL DRAWINGS ARE SUBMITTED AND APPROVED.
- 2. ALL PUNCH LIST ITEMS ARE COMPLETED BY THE CONTRACTOR.
- 3. AFTER THE 30-DAY CONTINUOUS UNINTERRUPTED SIGNAL OPERATION WITHOUT MALFUNCTIONS.

CONSTRUCTION NOTES

- 1. ALL JUNCTION BOXES IN WALK AREAS TO BE CITY OF PITTSBURGH STANDARD CONCRETE JUNCTION BOX, TYPE 1.
- 2. ALL JUNCTION BOXES IN NON-WALK AREAS TO BE CITY STANDARD JB-2 WITH BOTTOM.
- 3. THERE SHALL BE NO SIGNAL WIRE OR FIBER CABLE SPLICING.
- 4. SERVICE WIRE FROM THE POWER SOURCE TO THE CONTROLLER CABINET SHALL BE PLACED IN SECONDARY SEPARATE CONDUIT.
- 5. STREET LIGHT CABLE IS NOT PERMITTED TO RUN THROUGH THE CONTROLLER CABINET AND SHALL BE PLACED IN SEPARATE CONDUIT.
- 6. TRAFFIC SIGNAL CABLE SHALL BE PLACED IN DEDICATED CONDUIT.
- 7. MOUNT DISCONNECT ON POLE NEAREST TO THE CONTROLLER CABINET EXCLUDING TYPE X POLES.
- 8. REMOVE AND DISPOSE OF ALL EXISTING SIGNAL WIRING NO LONGER IN USE.
- 9. REMOVE EXISTING SIGNAL EQUIPMENT NO LONGER IN USE AND RETURN TO THE CITY OF PITTSBURGH TRAFFIC CONTROL SHOP. COORDINATE DELIVERY OF EQUIPMENT WITH DELMAS MCELHANY, TRAFFIC CONTROL FOREMAN.
- 10. SEE 01720 UTILITY COORDINATION FOR INFORMATION ON RELOCATION OF EXISTING SECURITY CAMERAS AND SHOT SPOTTERS

TS-119

COUNTY: ALLEGHENY MUNICIPALITY: CITY OF PITTSBURGH INTERSECTION: FIFTH AVENUE AND BIGELOW BOULEVARD APPROVED AND ACCEPTED: CITY TRAFFIC ENGINEER DATE APPROVED AND ACCEPTED: DISTRICT TRAFFIC ENGINEER DATE

AECOM

Gulf Tower 707 Grant Street 5th Floor Pittsburgh, PA 15219 ((DRIVE ENGINEERING

595 Skippack Pk, Suite 400 Blue Bell, PA 19422 THE PREPARATION OF THIS
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U.S. DEPARTMENT OF
TRANSPORTATION, UNDER THE
URBAN MASS TRANSPORTATION ACT
OF 1964, AS AMENDED, FOR THE
PORT AUTHORITY OF ALLEGHENY
COUNTY, PENNSYLVANIA.

(NOT FOR CONSTRUCTION)

ESIGNED	MW	
DRAWN	MW	
CHECKED	EMC	
N CHARGE	<u>EMC</u>	
ATE	05/01/24	
CALE		
	AS SHOWN	

PORT AUTHORITY OF ALLEGHENY COUNTY PENNSYLVANIA

BUS RAPID TRANSIT UPTOWN TO OAKLAND SIGNAL PLANS WIRING, MOVEMENT, PHASING & SEQUENCE DIAGRAMS

Port Authority

CONTRACT NO. BRT-001

DWG. NO. SG80 SHT. 1140

ITEM NUMBER

TINU 01882. 002

EACH 02890. 005

EACH

02893. 001

EACH

EACH 02894**.** 005

EACH 02894.

EACH 02895.

EACH

013

EACH 02212.

EACH

EACH 8" RISER

TRAFFIC	SIGNAL	TABULATION

FIFTH AVENUE AND BIGELOW BOULEVARD

DETECTORS

ITEM NUMBER	DESCRIPTION	SEN. NO.	QTY.	LOCATION
02895 . 001	VIDEO DETECTION	1000	3	$\wedge \wedge \wedge \wedge$
EACH		~~~		
02895 . 005	DIGITAL WAVE RADAR DETECTION	(4) (5)	2	3 1
EACH				75777

TRAFFIC SIGNAL SUPPORTS **

	_			C SIGNA	1																					
	-84				z		_							MAST	ARN	И								PEDES.		L
POLE NO.	E LIN DESCRIPTION		QTY.	ROUTE	ATION	SIDE	OFFSET				ARM "A"		ARM "C"			SHAFT	SIC	SIGNAL								
	_				ST	"	5	Н	K	L	SIGN	NAL I	_OCA	LION		SIGN	LOC	ATIC	N	w	G	x	z	Н	м	N
	UNIT										М	N	0	Ρ	R	S	T	U	Υ							
\triangle		TRAFFIC SIGNAL SUPPORT, 26' MAST ARM		FIFTH AVE.	554+08	LT	50 '	17 1	10′	26 ′	20 '	9'			16'	9'			5′	90°						
2	02892. 003 EACH	TRAFFIC SIGNAL SUPPORT, 15' TYPE X, PAINTED BLACK	1	FIFTH AVE.	554+17	LT	35′																	15′		10′
3		TRAFFIC SIGNAL SUPPORT, 15' TYPE X		FIFTH AVE.	554+29	RT	33 '																	15'		10'
4		TRAFFIC SIGNAL SUPPORT, 15' TYPE X		FIFTH AVE.	554+15	RT	49 '																	15 '		10 4
<u>\(\) \(\) \(\) \(\)</u>		TRAFFIC SIGNAL SUPPORT, 30' MAST ARM		FIFTH AVE.	553+44	RT	62'	17 ′	10′	30 ′	29 ′	16'								0°						
<u></u>		TRAFFIC SIGNAL SUPPORT, 15' TYPE X		FIFTH AVE.	553+38	RT	44 '																	15'	15'	10'
A	02892. 607 EACH	TRAFFIC SIGNAL SUPPORT, 46' MAST ARM, PAINTED BLACK	1	FIFTH AVE.	553+39	LT	30′	17′	10′	46′	44′	34′	20′	9′	40′	30′	11′		9′	0°		30′	0°			
<u> </u>	02892. 003 EACH	TRAFFIC SIGNAL SUPPORT, 15' TYPE X, PAINTED BLACK	1	FIFTH AVE.	553+49	LT	47′																	15′		10′

** REFER TO PENNDOT TC-8800 TRAFFIC STANDARDS - SIGNALS FOR LETTER DESIGNATION

AECOM

707 Grant Street 5th Floor Pittsburgh, PA 15219

ENGINEERING 595 Skippack Pk, Suite 400

Blue Bell, PA 19422

MISCELLANEOUS

QTY. LOCATION

CC

CC

SE CORNER

1234

900

(4(5)(9(2)

0

11234

1 4

NW CORNER

2 8

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2

2

13

13

REMARKS

ONLY INSTALL A CONTROLLER
CABINET FOUNDATION AND PROPOSED
CONDUITS TO FIT A FUTURE
TYPE 332 CABINET AND 8" RISER.

BLACK TUNNEL VISORS BLACK ALUMINUM HOUSINGS BLACK METAL LOUVERED BACKPLATE

BLACK TUNNEL VISORS BLACK ALUMINUM HOUSINGS BLACK METAL LOUVERED BACKPLATE

BLACK TUNNEL VISORS BLACK ALUMINUM HOUSINGS BLACK METAL LOUVERED BACKPLATE

DESCRIPTION

LED COUNTDOWN PEDESTRIAN SIGNAL HEAD,

TRAFFIC SIGNAL TIMING MODIFICATIONS

02890. TRAFFIC SIGNAL CONTROLLER ASSEMBLY FOUNDATION, FUTURE INSTALLATION OF TYPE 332 BASE MOUNTED CABINET AND

REMOVE EXISTING POLE

VEHICULAR SIGNAL HEAD, THREE 8" SECTIONS

002 ACCESSIBLE PEDESTRIAN SIGNALS

02897. 011 CONNECT TO EXISTING JUNCTION BOX

RESET POST MOUNTED SIGNS, TYPE F

POLE FOUNDATION DRILLING, LESS THAN 30" DIAMETER

O2212. 010 OR GREATER

POLE FOUNDATION DRILLING, 30" DIAMETER

GPS TIME CLOCK

02894. 001 VEHICULAR SIGNAL HEAD, THREE 12" SECTIONS

02894. 004 BICYCLE SIGNAL HEAD, THREE 8" SECTIONS

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			DOCUMENT HAS BEEN FINANCED IN PART THROUGH A GRANT FROM THE
			FEDERAL TRANSIT ADMINISTRATION, U.S. DEPARTMENT OF
			TRANSPORTATION, UNDER THE
			URBAN MASS TRANSPORTATION ACT OF 1964. AS AMENDED. FOR THE
NO.	DATE	DESCRIPTION	PORT AUTHORITY OF ALLEGHENY COUNTY, PENNSYLVANIA.
		REVISIONS	COUNTY, FEINING LVAINIA.

(NOT FOR CONSTRUCTION)

DESIGNED	MW	
DRAWN	MW	
CHECKED	EMC	
IN CHARGE	EMC	
DATE	05/01/24	
SCALE	-	
	AS SHOWN	

PORT AUTHORITY OF ALLEGHENY COUNTY BUS RAPID TRANSIT UPTOWN TO OAKLAND

SIGNAL PLANS

TRAFFIC SIGNAL TABULATIONS

CONTRACT NO. BRT-001 DWG. NO. SG81

Port Authority

sнт. **1141**

FIFTH AVENUE AND BIGELOW BOULEVARD

TRENCH, CONDUIT, JUNCTION BOX, ELECTRICAL ITEMS

DESCRIPTION	TRENCH AND BACKFILL, TYPE I	TRENCH AND BACKFILL, TYPE IV	2 INCH CONDUIT	3 INCH CONDUIT	AWG 8, UNDERGROUND CABLE, COPPER, 1 CONDUCTOR	SIGNAL CABLE, 14 AWG, 5 CONDUCTOR	SIGNAL CABLE, 14 AWG, 7 CONDUCTOR
ITEM NUMBER	02898	02898	02899	02899	02900	02900	02900
	001	005	002	003	001	002	003
UNIT	LF	LF	LF	LF	LF	LF	LF
LOCATION							
сс то 🛆							
/ то ∕∱							
1 TO 2							
1 TO 4							
4 TO 3							
/ то ∕2∕2	2			2			
2 TO <u>3</u>							
2 TO 4							
3 TO <u>\$</u>							
3 TO 6							
3 TO <u>6</u>	7		7	14			
4 TO <u>8</u>	11			11			
4 TO 🔀	6		12	24			
COMPLETE INTERSECTION					155	1093	450
TOTAL	35		19	51	155	1093	450

SIGNS

SYMBOL	SERIES	SIZE	AREA EACH (SQ FT)	DESCRIPTION	QUANTITY	POST MOUNTED SIGNS, TYPE B	STRUCTURE MOUNTED FLAT SHEET ALUMINUM SIGN WITH STIFFENERS
В	R10-11	30"x36"	7.5	NO TURN ON RED	2		15
D	R10-3E(MOD)	9 "×15 "	0.9	EDUCATIONAL PUSH BUTTON FOR WALK SIGNAL WITH COUNTDOWN TIMER	4		•
6	D3-4*	72 "x24 "	12.0	100 OAKLAND 099 BIGELOW BLVD	1		12
H	R10-10L	30"×36"	7.5	LEFT TURN SIGNAL	1		7.5
R	R5-1	30"x30"	6.3	DO NOT ENTER	2	6.3	6.3
				TOTAL		6.3	40.8

▲ - INCIDENTAL TO ITEM 02895.002

* WHITE REFLECTORIZED LEGEND AND BORDER ON BLUE REFLECTORIZED BACKGROUND.
UTILIZE 4" CLEARVIEW 3W FOR BLOCK/NEIGHBORHOOD AND 8" CLEARVIEW 3W FOR
STREET NAME. ACTUAL WIDTH DETERMINED BY LETTER SPACING. COORDINATE BLOCK
NUMBERS AND STREET NAME DETAILS WITH CITY OF PITTSBURGH DEPARTMENT OF
MOBILITY AND INFRASTRUCTURE.

AECOM

Gulf Tower 707 Grant Street 5th Floor Pittsburgh, PA 15219 ((* DRIVE ENGINEERING 595 Skippack Pk, Suite 400


Blue Bell, PA 19422

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			DOCUMENT HAS BEEN FINANCED IN
			PART THROUGH A GRANT FROM THE
			FEDERAL TRANSIT ADMINISTRATION,
\vdash			U.S. DEPARTMENT OF
			TRANSPORTATION, UNDER THE
			URBAN MASS TRANSPORTATION ACT
			OF 1964, AS AMENDED, FOR THE
NO.	DATE	DESCRIPTION	PORT AUTHORITY OF ALLEGHENY COUNTY, PENNSYLVANIA.
		REVISIONS	COUNTY, PENINSYLVANIA.

(NOT FOR CONSTRUCTION)

DESIGNED	<u>MW</u>	PORT AUTHOR	ITY OF AL	LEGHENY CO	TNU	<u> </u>
DRAWN	MW	PITTSBURGH		PENN	SYLVAN	Α
CHECKED	EMC	BUS RAPID TF	RANSIT UPT	OWN TO OAKL	AND	
IN CHARGE	<u>EMC</u>		SIGNAL PL			
DATE	05/01/24	TRAF	FIC SIGNAL T	ABULATIONS		
SCALE	AS SHOWN	Port Authority	CONTR	RACT NO. BRT-0	01	
,	AS SHOWIN	connecting people to life	DWG. NO.	SG82	SHT.	114

SIGNS

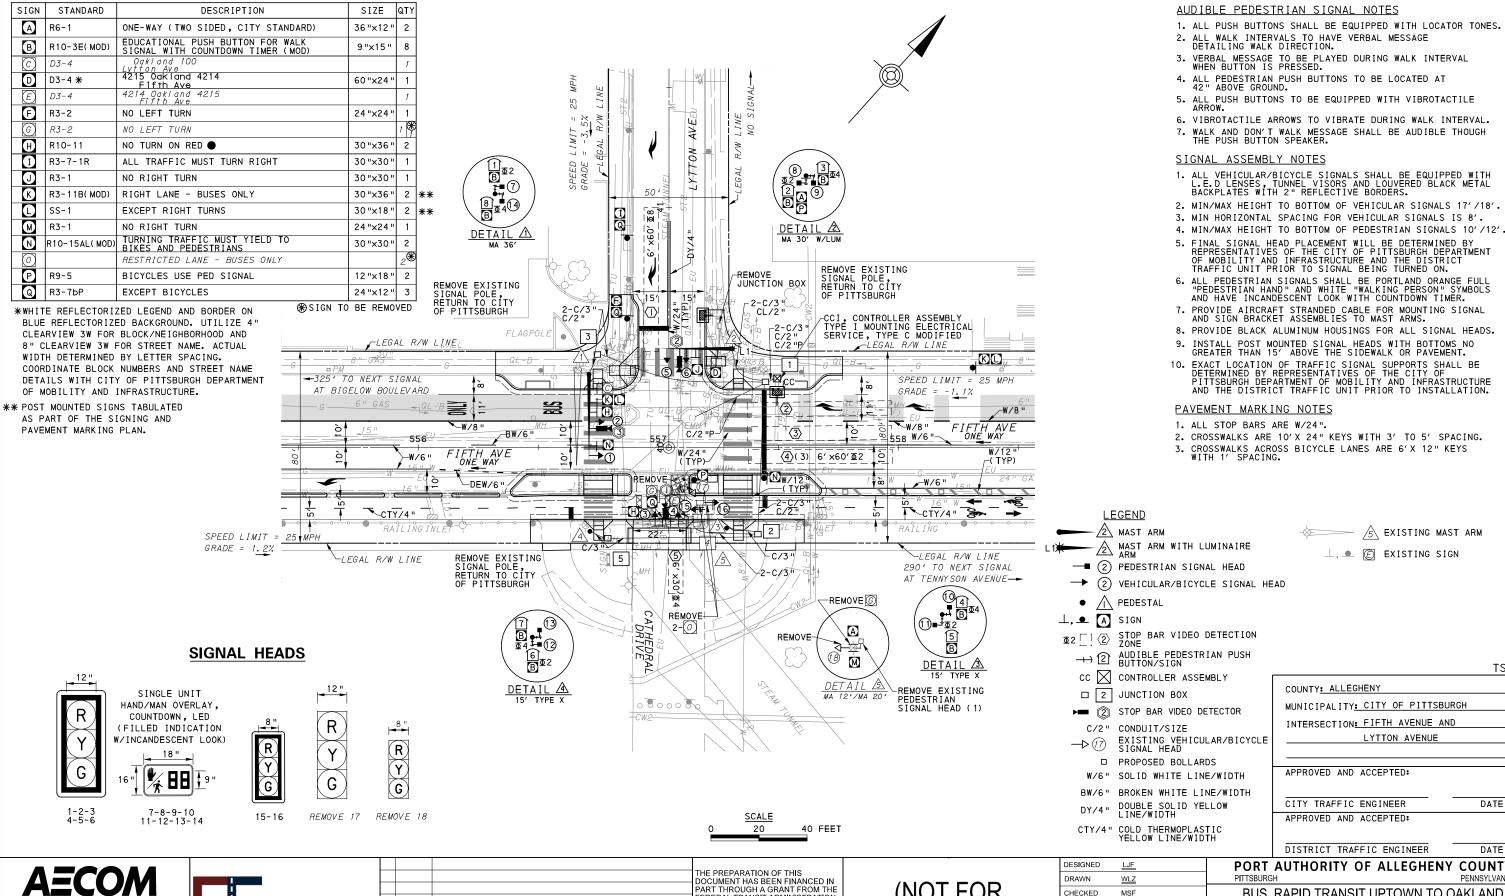

Gulf Tower 707 Grant Street 5th Floor

Pittsburgh, PA 15219



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(NOT FOR CONSTRUCTION)

DESIGNED	LJF	
DRAWN	<u>WLZ</u>	
CHECKED	MSF	
IN CHARGE	<u>LJF</u>	
DATE	05/01/24	
SCALE		
	AS SHOWN	

DATE PORT AUTHORITY OF ALLEGHENY COUNTY PENNSYLVANIA

TS-302

DATE

BUS RAPID TRANSIT UPTOWN TO OAKLAND SIGNAL PLANS

FIFTH AVENUE & LYTTON AVENUE

CONTRACT NO. BRT-001 Port Authority SG83 DWG. NO. sнт. 1143


		PH	IASE	2			PHA	SE	4+8						
	BIK	1	TT		BUS BIKE	- BIKI	- 1		BIKE						
		INT	ERV	ALS			INT	ERV	ALS		HLANTHZG HLANTHZG				
SIGNAL	1	2	3	4	5	1	2	3	4	5					
1-2	R	G	G	Υ	R	R	R	R	R	R	R				
3-4	R	R	R	R	R	R	G	G	Υ	R	R				
5-6	R	R	R	R	R	R	G	G	Υ	R	R				
7-8	W	W	FD	DW	DW	DW	DW	DW	DW	DW	0FF				
9-10	DW	DW	DW	DW	DW	W	W FD		DW	DW	0FF				
11-12	W	W	FD	DW	DW	DW	DW DW		DW	DW	0FF				
13-14	DW	DW	DW	DW	DW	W	W FI		DW	DW	0FF				
15-16	G	G	G	Υ	R	R	R	R	R	R	R				
FIXED		><	<	3.5	2.5	$/ \setminus$	><	<	3.5	2.5					
MINIMUM		1	5				1	5							
PASSAGE		P	3					3							
FREE (MAX)		6	9				1	9							
PEDESTRIAN	3	4	10			5	2	16							
MEMORY	ΜI	NIM	UM F	RECA	LL		PED	REC							

TRANSIT PRIORITY PRE-EMPTION NOTES (TO BE INSTALLED BY OTHERS)

- 1. COORDINATE TRAFFIC CONTROLLER PROGRAMMING MODIFICATION WITH REPRESENTATIVES OF THE CITY OF PITTSBURGH AND DISTRICT TRAFFIC UNIT.
- 2. INCLUDE A TRANSIT PRIORITY PHASE THAT WILL EXTEND THE INDICATED PHASE A MAXIMUM OF 10 SECONDS WHEN ACTIVATED BY A PORT AUTHORITY VEHICLE. DO NOT VIOLATE SIDE STREET PEDESTRIAN MINIMUM TIMINGS.
- 3. MAINTAIN ALL YELLOW CLEARANCES AT ALL TIMES.
- 4. PROCEED TO THE SUBSEQUENT INTERVAL AS DEFINED IN THE MOVEMENT, SEQUENCE AND TIMING DIAGRAM UPON COMPLETING THE GREEN EXTENSION INTERVAL.
- 5. ONCE A TRANSIT CALL IS PLACED AND SATISFIED, THE CONTROLLER WILL NOT SATISFY ANOTHER CALL FOR 4 CYCLES
- 6. LOCATION OF BUS DETECTORS ARE TO BE FIELD ADJUSTED TO ACHIEVE MAXIMUM OPERATION.

DETECTOR ZONE INFORMATION

DETECTOR	DETECTION ZONE(S)	MODE	TYPE	ROUTE	PHASE	LOCATION MAST ARM
	(1) (6' x60')	DDECENCE	VIDEO (STOP BAR)	LYTTON AVENUE		
	(1) (8, X80.)	PRESENCE	VIDEO (STOP BAR)	LITTON AVENUE	8	<u> </u>
	⟨5⟩ (6′ ×30′)	PRESENCE	VIDEO (STOP BAR)	DRIVEWAY	4	2
3	② ③ ④ (6' x60')	PRESENCE	VIDEO (STOP BAR)	FIFTH AVENUE	2	\triangle

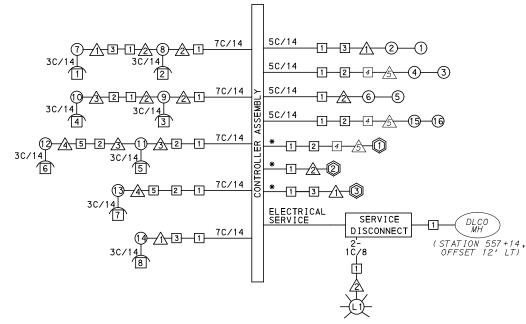

WIRING DIAGRAM

5C/14 - CABLE (NO. OF CONDUCTORS/SIZE AWG.)

- PROPOSED DETECTOR
- 1 PROPOSED SIGNAL HEAD
- PROPOSED PEDESTRI
 - PEDESTRIAN INDICATOR APPROPOSED SIGNAL SUPPORT

1 PROPOSED JUNCTION BOX

3C/14 INCIDENTAL TO ITEM 02895.002

*INCIDENTAL TO ITEM 02895.001, AS PER MANUFACTURERS SPECIFICATIONS

GENERAL NOTES

THE CITY OF PITTSBURGH SHALL INSPECT THE NEW SIGNAL EQUIPMENT PRIOR TO ACTIVATION.

ALL TRAFFIC SIGNAL MAINTENANCE AND OPERATION RESPONSIBILITIES SHALL BE TURNED OVER TO THE CITY OF PITTSBURGH AFTER THE FOLLOWING CONDITIONS ARE IMPLEMENTED TO THE CITY'S SATISFACTION:

- 1. PERMIT "AS-BUILT" TRAFFIC SIGNAL DRAWINGS ARE SUBMITTED AND APPROVED.
- ALL PUNCH LIST ITEMS ARE COMPLETED BY THE CONTRACTOR.
- 3. AFTER THE 30-DAY CONTINUOUS UNINTERRUPTED SIGNAL OPERATION WITHOUT MALFUNCTIONS.

CONSTRUCTION NOTES

- 1. ALL JUNCTION BOXES IN WALK AREAS TO BE CITY OF PITTSBURGH STANDARD CONCRETE JUNCTION BOX, TYPE 1.
- 2. ALL JUNCTION BOXES IN NON-WALK AREAS TO BE CITY STANDARD JB-2 WITH BOTTOM.
- 3. THERE SHALL BE NO SIGNAL WIRE OR FIBER CABLE SPLICING.
- 4. SERVICE WIRE FROM THE POWER SOURCE TO THE CONTROLLER CABINET SHALL BE PLACED IN SECONDARY SEPARATE CONDUIT.
- 5. STREET LIGHT CABLE IS NOT PERMITTED TO RUN THROUGH THE CONTROLLER CABINET AND SHALL BE PLACED IN SEPARATE CONDUIT.
- 6. TRAFFIC SIGNAL CABLE SHALL BE PLACED IN DEDICATED CONDUIT.
- 7. MOUNT DISCONNECT ON POLE NEAREST TO THE CONTROLLER CABINET EXCLUDING TYPE X POLES.
- 8. REMOVE AND DISPOSE OF ALL EXISTING SIGNAL WIRING NO LONGER IN USE.
- 9. REMOVE EXISTING SIGNAL EQUIPMENT NO LONGER IN USE AND RETURN TO THE CITY OF PITTSBURGH TRAFFIC CONTROL SHOP. COORDINATE DELIVERY OF EQUIPMENT WITH DELMAS MCELHANY, TRAFFIC CONTROL FOREMAN.
- 10. REMOVE ALL SIGNALS WHILE POLE IS PAINTED, REFER TO SECTION 02892.

TS-302

COUNTY: ALLEGHENY

MUNICIPALITY: CITY OF PITTSBURGH

INTERSECTION: FIFTH AVENUE AND

LYTTON AVENUE

APPROVED AND ACCEPTED:

CITY TRAFFIC ENGINEER DATE

APPROVED AND ACCEPTED:

DISTRICT TRAFFIC ENGINEER DATE

AECOM

Gulf Tower 707 Grant Street 5th Floor Pittsburgh, PA 15219



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TRANSPORTATION, UNDER THE
URBAN MASS TRANSPORTATION ACT
OF 1964, AS AMENDED, FOR THE
PORT AUTHORITY OF ALLEGHENY
COUNTY, PENNSYLVANIA.

(NOT FOR CONSTRUCTION)

DESIGNED	<u>LJF</u>	
DRAWN	<u>WLZ</u>	
CHECKED	MSF	
IN CHARGE	<u>LJF</u>	
DATE	05/01/24	
SCALE		
	AS SHOWN	

PORT AUTHORITY OF ALLEGHENY COUNTY
PITTSBURGH
PENNSYLVANIA

BUS RAPID TRANSIT UPTOWN TO OAKLAND SIGNAL PLANS WIRING, MOVEMENT, PHASING & SEQUENCE DIAGRAMS

Port Authority

CONTRACT NO. BRT-001

DWG. NO. SG84 SHT. 1144

I TEM NUMBER	MISO	CELLA	NEOUS	
UNIT	DESCRIPTION	QTY.	LOCATION	REMARKS
01882. 002 EACH	TRAFFIC SIGNAL TIMING MODIFICATIONS	2	CC	ILIMAINS
02212. 009 LF	POLE FOUNDATION DRILLING, LESS THAN 30" DIAMETER	13	3 4	
02212. 010 LF	POLE FOUNDATION DRILLING, 30" DIAMETER OR GREATER	24	12	
02889. 002 EACH	LED LUMINAIRE CITY STANDARD, BLACK	1	\tilde{\	<u> </u>
02890. 001 EACH	TRAFFIC SIGNAL CONTROLLER ASSEMBLY, TYPE 2070 LC IN WITH TYPE 332 BASE MOUNTED CABINET	1	cc	
02890. 003 EACH	ETHERNET SWITCH	1	СС	
02890. 005 EACH	GPS TIME CLOCK	1	СС	
02892. 501 EACH	EXISTING TRAFFIC SIGNAL SUPPORT, PAINTED BLACK	1	<u> </u>	TEMPORARILY REMOVE ATTACHED SIGNAL HARDWARE AND PAINT SIGNAL SUPPORT BLACK. REATTACH HARDWARE WHEN COMPLETE.
02893. 001 EACH	REMOVE EXISTING POLE	1	557+44 LT 0FFSET 33'	
02894. 001 EACH	VEHICULAR SIGNAL HEAD, THREE 12" SECTIONS	6	123 456	BLACK TUNNEL VISORS BLACK ALUMINUM HOUSINGS BLACK METAL LOUVERED BACKPLATE
02894. 005 EACH	LED COUNTDOWN PEDESTRIAN SIGNAL HEAD,	8	7890 0030	BLACK TUNNEL VISORS BLACK ALUMINUM HOUSINGS
02894. 006 EACH	VEHICULAR SIGNAL HEAD, THREE 8" SECTIONS	2	1919	BLACK TUNNEL VISORS BLACK ALUMINUM HOUSINGS BLACK METAL LOUVERED BACKPLATE
02894. 031 EACH	REMOVE VEHICULAR SIGNAL HEAD	2	70	
02894. 032 EACH	REMOVE PEDESTRIAN SIGNAL HEAD	1	<u> </u>	
02895. 002 EACH	ACCESSIBLE PEDESTRIAN SIGNALS	8	11234 5678	
02897. 010 EACH	REPLACE EXISTING JUNCTION BOX LID	1	4	

FIFTH AVENUE AND LYTTON AVENUE

ITEM NUMBER	MISCELLA	ANEOU	S (CONT.)	
UNIT	DESCRIPTION	QTY.	LOCATION	REMARKS
02897 . 011	CONNECT TO EXISTING JUNCTION BOX	1	4	
EACH				
02897. 012	REMOVE EXISTING JUNCTION BOX	1		
EACH				

DETECTORS

ITEM NUMBER	DESCRIPTION	SEN. NO.	QTY.	LOCATION
02895 . 001	VIDEO DETECTION	Û	1	<u>/</u> 5\
EACH		~		<u> </u>
02895 . 001	VIDEO DETECTION	2	1	/2\
EACH		~		
02895 . 001	VIDEO DETECTION	3	1	\bigwedge
EACH				

TRAFFIC SIGNAL SUPPORTS **

						IKA	\FF	IC S	SIGN	IAL	SUPF	OR	15 :	**																		
	BEM BER				NO		ET							MAS	T AR	RM														PEI	DESTAL	
POLE NO.	I T S	DESCRIPTION	QTY.	ROUTE	ATI	SIDE	FS						Αf	RM "A	11							,	RM	"B "				ARM	"C "	SHAFT	SIGN	AL
	_				ST	,	OF	Н	К		SIGNA	L LO	CATI	ON	SIGN	N LOCA	ATION	w	١,	SIG	NAL L	CAT	ION	S	IGN	LOCATIO	ON W	G X	ΚZ		м	N
	UNIT										М	N	0 1	P R	S	Т	U Y			М	N	0	Р	R	S	T U	Υ "				141	IN
\triangle	02892. 606 EACH	TRAFFIC SIGNAL SUPPORT, 36' MAST ARM, PAINTED BLACK	1	FIFTH AVE	556+71	LT	30′	17′	10′	36′	33′ 1	9′		29	15	, 11'	5′	0°														
<u> </u>	02892. 207 EACH	TRAFFIC SIGNAL SUPPORT, 30' MAST ARM WITH LUMINAIRE ARM (30' MOUNTING HEIGHT), PAINTED BLACK	1	FIFTH AVE	557+31	LT	41′	17′	10′	30′	26′ 1	8′			14'	,	5′	270	•									6′ 30	٥/ 90	,		
3	02892. 003 EACH	TRAFFIC SIGNAL SUPPORT, 15' TYPE X, PAINTED BLACK	1	FIFTH AVE	557+28	RT	34′																							15′		10′
4	02892. 003 EACH	TRAFFIC SIGNAL SUPPORT, 15' TYPE X, PAINTED BLACK	1	FIFTH AVE	556+72	RT	35′																							15′		10′
<u>\(\frac{1}{5} \)</u>		TRAFFIC SIGNAL SUPPORT, 20' MAST ARM AND 12' MAST ARM		FIFTH AVE	557 +20	RT	32'	17 4		20 '	19′ 9	9'		16	12	,	5 *	90°	12	8'	5′						0°					

** REFER TO PENNDOT TC-8800 TRAFFIC STANDARDS-SIGNALS FOR LETTER DESIGNATION

AECOM Gulf Tower 707 Grant Street 5th Floor Pittsburgh, PA 15219



		THE PREPARATION OF THIS DOCUMENT HAS BEEN FINANCED IN PART THROUGH A GRANT FROM THE FEDERAL TRANSIT ADMINISTRATION, U.S. DEPARTMENT OF TRANSPORTATION, UNDER THE URBAN MASS TRANSPORTATION ACT
DATE	DESCRIPTION	OF 1964, AS AMENDED, FOR THE PORT AUTHORITY OF ALLEGHENY
	REVISIONS	COUNTY, PENNSYLVANIA.

(NOT FOR CONSTRUCTION)

DESIGNED	<u>LJF</u>	
DRAWN	<u>WLZ</u>	
CHECKED	MSF	
IN CHARGE	<u>LJF</u>	
DATE	05/01/24	
SCALE		
	AS SHOWN	

TS-302 PORT AUTHORITY OF ALLEGHENY COUNTY PITTSBURGH PENNSYLVANIA

BUS RAPID TRANSIT UPTOWN TO OAKLAND

SIGNAL PLANS TRAFFIC SIGNAL TABULATIONS

DWG. NO. SG85

Port Authority connecting people to life

CONTRACT NO. BRT-001 sнт. **1145**

FIFTH AVENUE AND LYTTON AVENUE

TRENCH, CONDUIT, JUNCTION BOX, ELECTRICAL ITEMS

DESCRIPTION	CITY OF PITTSBURGH STANDARD CONCRETE JUNCTION BOX, TYPE 1	TRENCH AND BACKFILL, TYPE II	TRENCH AND BACKFILL, TYPE IV	2 INCH CONDUIT	3 INCH CONDUIT	AWG 8, UNDERCROUND CABLE, COPPER, 1 CONDUCTOR	SIGNAL CABLE, 14 AWG, 5 CONDUCTOR	SIGNAL CABLE, 14 AWG, 7 CONDUCTOR
ITEM NUMBER	02897	02898	02898	02899	02899	02900	02900	02900
	001	002	005	002	003	001	002	003
UNIT	EACH	LF	LF	LF	LF	LF	LF	LF
LOCATION								
сс то 1		6		12	12			
1 TO 2	2	29	35	64	128			
1 TO 3	1	41	31	72	144			
2 TO 5	1	63			63			
4 TO 2		28			56			
то з		9		9	18			
∕2 то 1		22		22	44			
<u></u> ₹ ₹ ₹ ₹ ₹ ₹ ₹ ₹ ₹ ₹ ₹ ₹ ₹ ₹ ₹ ₹ ₹ ₹ ₹		13			13			
<u>∕</u> 4 TO 5		8			8			
ELECTRIC SERVICE TO 1 MANHOLE		6	28	34				
COMPLETE INTERSECTION						150	625	930
TOTAL	4	225	94	213	486	150	625	930

SIGNS

SYMBOL	SERIES	SIZE	AREA EACH (SQ FT)	DESCRIPTION		유 POST MOUNTED SIGNS, TYPE B	02891,003 MOUNTED SIGNS, TYPE F	STRUCTURE MOUNTED FLAT THEST ALUMINUM SIGNS WITH STIFFENERS	RESET STRUCTURE MOUNTED FLAT SHEET ALUMINUM SIGNS WITH STIFFENERS	REMOVE POST MOUNTED SIGNS TYPE F	REMOVE STRUCTURE ROUNTED FLAT SHEET ALUMINUM SIGN
A	R6-1	36"×12"	3.0	ONE-WAY (TWO SIDED, CITY STANDARD)	2		6.0				
B	R10-3E(MOD)	9"×15"	0.9	EDUCATIONAL PUSH BUTTON FOR WALK SIGNAL WITH COUNTDOWN TIMER (MOD)	8		A				
	D3-4			Oakland 100 Lytton Ave	1				1		
D	D3-4 *	60"x24"	10.0	4215 Oakland 4214 Fifth Ave				10.0			
(F)	R3-2	24"×24"	4.0	NO LEFT TURN		4.0					
<u></u>	R3-2			NO LEFT TURN					1	1	
H	R10-11	30"×36"	7.5	NO TURN ON RED ●				15.0			
1	R3-7-1R	30"×30"	6.3	ALL TRAFFIC MUST TURN RIGHT	1	6.3					
0	R3-1	30"×30"	6.3	NO RIGHT TURN	1			6.3			
K	R3-11B(MOD)	30"×36"	7.5	RIGHT LANE - BUSES ONLY	1			7.5			
0	SS-1	30"×18"	3.8	EXCEPT RIGHT TURNS	1			3.8			
M	R3-1	24"×24"	4.0	NO RIGHT TURN	1		4.0				
N	R10-15AL(MOD)	30"×30"	6.3	TURNING TRAFFIC MUST YIELD TO BIKES AND PEDESTRIANS		6.3		6.3			
0				RESTRICTED LANE - BUSES ONLY							2
P	R9-5	12"×18"	1.5	BICYCLES USE PED SIGNAL		1.5	1.5				
0	R3-7bP	24"×12"	2.0	EXCEPT BICYCLES	3		4.0	2.0			
				TOTAL		18.1	15.5	50.9	2	1	2

▲ - INCIDENTAL TO ITEM 02895.002

AECOM Gulf Tower 707 Grant Street 5th Floor

Pittsburgh, PA 15219



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FEDERAL TRANSIT ADMINISTRATION,
U.S. DEPARTMENT OF
TRANSPORTATION, UNDER THE
URBAN MASS TRANSPORTATION ACT
OF 1964, AS AMENDED, FOR THE
PORT AUTHORITY OF ALLEGHENY
COUNTY, PENNSYLVANIA. NO. DATE DESCRIPTION REVISIONS

(NOT FOR CONSTRUCTION)

				TS-				
ESIGNED	LJF	PORT AUTHOR	ITY OF ALLEGHENY	COUNTY				
RAWN	WLZ	PITTSBURGH		PENNSYLVANIA				
HECKED	MSF	BUS RAPID TRANSIT UPTOWN TO OAKLA						
CHARGE	<u>LJF</u>		SIGNAL PLANS					
ATE	<u>05/01/24</u>	TRAF	FIC SIGNAL TABULATION	1S				
CALE	AS SHOWN	Port Authority	CONTRACT NO. E	3RT-001				
	AO ONOWN	connecting people to life	DWG. NO. SG86	SHT.				

TS-302 GHENY COUNTY

sнт. **1146**

PENNSYLVANIA

^{*} WHITE REFLECTORIZED LEGEND AND BORDER ON BLUE REFLECTORIZED BACKGROUND.
UTILIZE 4" CLEARVIEW 3W FOR BLOCK/NEIGHBORHOOD AND 8" CLEARVIEW 3W FOR
STREET NAME. ACTUAL WIDTH DETERMINED BY LETTER SPACING. COORDINATE BLOCK
NUMBERS AND STREET NAME DETAILS WITH CITY OF PITTSBURGH DEPARTMENT OF
MOBILITY AND INFRASTRUCTURE.

SIGN	STANDARD	DESCRIPTION	SIZE	QTY	
A	R10-3E(MOD)	EDUCATIONAL PUSH BUTTON FOR WALK SIGNAL WITH COUNTDOWN TIMER (MOD)	9"x15"	6	
B	D3-1	Tennyson Ave		1	
0	D3-4	Oakland 100 Tennyson Ave		1	
D	D3-4	4300 Oakland 4200 Fifth Ave		1	
E	R3-2	NO LEFT TURN		2	
Ð	R3-2	NO LEFT TURN	24"x24"	1	
G	R9-5	BICYCLES USE PED SIGNAL	12 "×18 "	2	
\oplus	R10-11	NO TURN ON RED ●	24"x30"	1	
1	R10-11	NO TURN ON RED ●	30"x36"	2	
0	R3-11B(MOD)	RIGHT LANE - BUSES ONLY	30"x36"	2	*
K	SS-1	EXCEPT RIGHT TURNS	30"×18"	2	*
L)	R6-1	ONE-WAY (TWO SIDED, CITY STANDARD)	36"×12"	2	
M	R3-7-1R	ALL TRAFFIC MUST TURN RIGHT	30"x30"	1	
N	R3-7bP	EXCEPT BICYCLES	24"×12"	4	
0		CARS/BIKES SHARE THE ROAD		1 *	

SIGNS

* SIGN TO BE REMOVED

** POST MOUNTED SIGNS TABULATED AS PART OF THE SIGNING AND PAVEMENT MARKING PLAN.

AUDIBLE PEDESTRIAN SIGNAL NOTES


- 1. ALL PUSH BUTTONS SHALL BE EQUIPPED WITH LOCATOR TONES.
- 2. ALL WALK INTERVALS TO HAVE VERBAL MESSAGE DETAILING WALK DIRECTION.
- 3. VERBAL MESSAGE TO BE PLAYED DURING WALK INTERVAL WHEN BUTTON IS PRESSED.
 - 4. ALL PEDESTRIAN PUSH BUTTONS TO BE LOCATED AT 42" ABOVE GROUND.
- 5. ALL PUSH BUTTONS TO BE EQUIPPED WITH VIBROTACTILE ARROW.
- 6. VIBROTACTILE ARROWS TO VIBRATE DURING WALK INTERVAL.
- 7. WALK AND DON'T WALK MESSAGE SHALL BE AUDIBLE THOUGH THE PUSH BUTTON SPEAKER.

SIGNAL ASSEMBLY NOTES

- 1. ALL VEHICULAR/BICYCLE SIGNALS SHALL BE EQUIPPED WITH L.E.D LENSES, TUNNEL VISORS AND LOUVERED BLACK METAL BACKPLATES WITH 2" REFLECTIVE BORDERS.
- 2. MIN/MAX HEIGHT TO BOTTOM OF VEHICULAR SIGNALS 17'/18'
- 3. MIN HORIZONTAL SPACING FOR VEHICULAR SIGNALS IS 8'.
- 4. MIN/MAX HEIGHT TO BOTTOM OF PEDESTRIAN SIGNALS 10'/12'
- 5. FINAL SIGNAL HEAD PLACEMENT WILL BE DETERMINED BY REPRESENTATIVES OF THE CITY OF PITTSBURGH DEPARTMENT OF MOBILITY AND INFRASTRUCTURE AND THE DISTRICT TRAFFIC UNIT PRIOR TO SIGNAL BEING TURNED ON.
- 6. ALL PEDESTRIAN SIGNALS SHALL BE PORTLAND ORANGE FULL "PEDESTRIAN HAND" AND WHITE "WALKING PERSON" SYMBOLS AND HAVE INCANDESCENT LOOK WITH COUNTDOWN TIMER.
- 7. PROVIDE AIRCRAFT STRANDED CABLE FOR MOUNTING SIGNAL AND SIGN BRACKET ASSEMBLIES TO MAST ARMS.
- 8. PROVIDE BLACK ALUMINUM HOUSINGS FOR ALL SIGNAL HEADS.
- 9. INSTALL POST MOUNTED SIGNAL HEADS WITH BOTTOMS NO GREATER THAN 15' ABOVE THE SIDEWALK OR PAVEMENT.
- 10. EXACT LOCATION OF TRAFFIC SIGNAL SUPPORTS SHALL BE DETERMINED BY REPRESENTATIVES OF THE CITY OF PITTSBURGH DEPARTMENT OF MOBILITY AND INFRASTRUCTURE AND THE DISTRICT TRAFFIC UNIT PRIOR TO INSTALLATION.

PAVEMENT MARKING NOTES

- 1. ALL STOP BARS ARE W/24".
- 2. CROSSWALKS ARE 10'X 24" KEYS WITH 3' TO 5' SPACING.
- 3. CROSSWALKS ACROSS BICYCLE LANES ARE 6'X 12" KEYS WITH 1' SPACING.

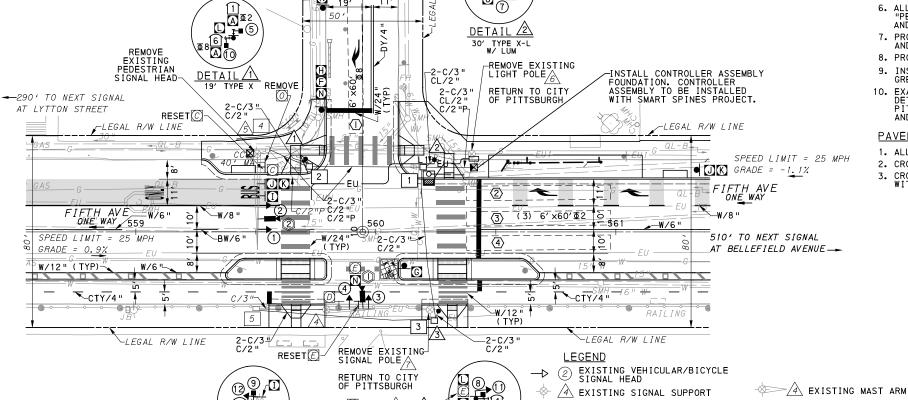

NO

₹

SIGNAL HEADS


SINGLE UNIT

HAND/MAN OVERLAY,


COUNTDOWN, LED


18"

K BB

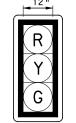

R

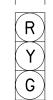

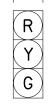











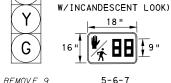

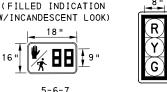



11-12

THE PREPARATION OF THIS DOCUMENT HAS BEEN FINANCED IN PART THROUGH A GRANT FROM THE U.S. DEPARTMENT OF TRANSPORTATION, UNDER THE Smithfield, PA 15478 NO. DATE DESCRIPTION COUNTY, PENNSYLVANIA. REVISIONS

(NOT FOR CONSTRUCTION)

L1 * PEDESTAL WITH LUMINAIRE

—■ ② PEDESTRIAN SIGNAL HEAD

 $\label{eq:def_def} \Phi 2 \begin{tabular}{ll} \hline \end{tabular} \begin{tabular}{ll} \hline \hline \end{tabular} \begin{tabular}{ll} \hline \end{tabular} \be$

AUDIBLE PEDESTRIAN PUSH
BUTTON/SIGN
CC CONTROLLER ASSEMBLY
FOUNDATION

STOP BAR VIDEO DETECTOR

2 VEHICULAR/BICYCLE SIGNAL HEAD

 \rightarrow

40 FEET

• N PEDESTAL

☐ 2 JUNCTION BOX

⊥, • A SIGN

DESIGNED WLZ CHECKED MSF N CHARGE LJF DATE 05/01/24 SCALE AS SHOWN

☐ 2 EXISTING JUNCTION BOX

■ □ PROPOSED BOLLARDS

C/2"P POWER CONDUIT/SIZE

CTY/4" COLD THERMOPLASTIC YELLOW LINE/WIDTH

W/6" SOLID WHITE LINE/WIDTH

BROKEN WHITE LINE/WIDTH

DOUBLE SOLID YELLOW LINE/WIDTH

⊥, ● ② EXISTING SIGN

C/2" CONDUIT/SIZE

DISTRICT TRAFFIC ENGINEER DATE PORT AUTHORITY OF ALLEGHENY COUNTY

MUNICIPALITY: CITY OF PITTSBURGH

TENNYSON AVENUE

INTERSECTION: FIFTH AVENUE AND

TS-315

DATE

sнт. **1147**

BUS RAPID TRANSIT UPTOWN TO OAKLAND SIGNAL PLANS

FIFTH AVENUE & TENNYSON AVENUE

COUNTY: ALLEGHENY

APPROVED AND ACCEPTED:

CITY TRAFFIC ENGINEER

APPROVED AND ACCEPTED:

CONTRACT NO. BRT-001 **Port Authority** SG87 DWG. NO.

Gulf Tower 707 Grant Street 5th Floor Pittsburgh, PA 15219

AECOM French Engineering, LLC 3064 Morgantown Rd

FEDERAL TRANSIT ADMINISTRATION URBAN MASS TRANSPORTATION ACT OF 1964 AS AMENDED FOR THE

RESET FROM TO 3-

REMOVE EXISTING SIGNAL HEAD ®

	PHASE 2				PHASE 8						
	BIKE- BIKE					- BIKI	- - 			BUS BIKE	HLASHING
		INT	ERV	ALS			INT	ERV	ALS		Y
SIGNAL	1	2	3	4	5	1	2	3	4	5	
1-2	G	G	Υ	R		R	R	R	R	R	R
3-4	R	R	R	R		R	G	G	Υ	R	R
5-6	W	FD	DW	DW		DW	DW	DW	DW	DW	OFF
7-8	DW	DW	DW	DW		W	W	FD	DW	DW	OFF
9-10	DW	DW	DW	DW		W	W	FD	DW	DW	OFF
11-12	G	G	Υ	R		R	R	R	R	R	R
FIXED	\geq	\leq	3.5	2.5		\geq	>-<	\leq	4	3	
MINIMUM	1	5					1	5			
PASSAGE	3							3			
FREE (MAX)	68						1	9			
PEDESTRIAN	7	10				5	2	16			
MEMORY		PED	REC	ALL			PED	REC	ALL		

DETECTOR ZONE INFORMATION

DETECTOR	DETECTION	MODE	TYPE	ROUTE	PHASE	LOCATION
DETECTOR	ZONE(S)	MODE	IIIFE	ROUTE	FHASE	MAST ARM
	(1) (6' x60')	PRESENCE	VIDEO (STOP BAR)	TENNYSON AVENUE	8	4
②	② ③ 4 (6' x60')	PRESENCE	VIDEO (STOP BAR)	FIFTH AVENUE	2	ß

3C/14| 3C/14| 3C/14| 1 5C/14 5 2 1 /5-4-2-1-3-5-/4-() 9 4 5 3 1 2 1 1 2 1 5 SERVICE DLCO MH (2-45-3-3-(1-2-4-5-5c/14 DISCONNECT (STATION 559+73, OFFSET 12' LT) 2 - 1C/8 4 WIRING DIAGRAM 5C/14 - CABLE (NO. OF CONDUCTORS/SIZE AWG.) PROPOSED DETECTOR PROPOSED SIGNAL HEAD PROPOSED AUDIBLE PEDESTRIAN INDICATOR EXISTING SIGNAL SUPPORT PROPOSED JUNCTION BOX Λ PROPOSED SIGNAL SUPPORT EXISTING JUNCTION BOX -LI- PROPOSED LUMINAIRE 3C/14 INCIDENTAL TO ITEM 02895.002

*INCIDENTAL TO ITEM 02895.001, AS PER MANUFACTURERS SPECIFICATIONS

TRANSIT PRIORITY PRE-EMPTION NOTES (TO BE INSTALLED BY OTHERS)

- COORDINATE TRAFFIC CONTROLLER PROGRAMMING MODIFICATION WITH REPRESENTATIVES OF THE CITY OF PITTSBURGH AND DISTRICT TRAFFIC UNIT.
- 2. INCLUDE A TRANSIT PRIORITY PHASE THAT WILL EXTEND THE INDICATED PHASE A MAXIMUM OF 10 SECONDS WHEN ACTIVATED BY A PORT AUTHORITY VEHICLE. DO NOT VIOLATE SIDE STREET PEDESTRIAN MINIMUM TIMINGS.
- 3. MAINTAIN ALL YELLOW CLEARANCES AT ALL TIMES.
- 4. PROCEED TO THE SUBSEQUENT INTERVAL AS DEFINED IN THE MOVEMENT, SEQUENCE AND TIMING DIAGRAM UPON COMPLETING THE GREEN EXTENSION INTERVAL.
- 5. ONCE A TRANSIT CALL IS PLACED AND SATISFIED, THE CONTROLLER WILL NOT SATISFY ANOTHER CALL FOR
- 6. LOCATION OF BUS DETECTORS ARE TO BE FIELD ADJUSTED TO ACHIEVE MAXIMUM OPERATION.

AECOM

Gulf Tower 707 Grant Street 5th Floor Pittsburgh, PA 15219



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(NOT FOR **CONSTRUCTION** DESIGNED RAWN WLZ CHECKED MSF N CHARGE LJF DATE 05/01/24 SCALE AS SHOWN

DATE PORT AUTHORITY OF ALLEGHENY COUNTY PENNSYLVANIA

BUS RAPID TRANSIT UPTOWN TO OAKLAND SIGNAL PLANS

CONTRACT NO. BRT-001 SG88 DWG NO

INTERSECTION: FIFTH AVENUE AND TENNYSON AVENUE APPROVED AND ACCEPTED: CITY TRAFFIC ENGINEER DATE APPROVED AND ACCEPTED:

MUNICIPALITY: CITY OF PITTSBURGH

TS-315

sнт. 1148

COUNTY: ALLEGHENY

DISTRICT TRAFFIC ENGINEER

WIRING, MOVEMENT, PHASING & SEQUENCE DIAGRAMS

Port Authority

GENERAL NOTES

CONSTRUCTION NOTES

THE CITY OF PITTSBURGH SHALL INSPECT THE NEW SIGNAL EQUIPMENT PRIOR TO ACTIVATION.

ALL TRAFFIC SIGNAL MAINTENANCE AND OPERATION RESPONSIBILITIES SHALL BE TURNED OVER TO THE CITY OF PITTSBURGH AFTER THE FOLLOWING CONDITIONS ARE IMPLEMENTED TO THE CITY'S SATISFACTION:

1. PERMIT "AS-BUILT" TRAFFIC SIGNAL DRAWINGS ARE SUBMITTED AND APPROVED. 2. ALL PUNCH LIST ITEMS ARE COMPLETED BY THE CONTRACTOR. 3. AFTER THE 30-DAY CONTINUOUS UNINTERRUPTED SIGNAL OPERATION WITHOUT MALFUNCTIONS.

1. ALL JUNCTION BOXES IN WALK AREAS TO BE CITY OF PITTSBURGH STANDARD CONCRETE JUNCTION BOX, TYPE 1. 2. ALL JUNCTION BOXES IN NON-WALK AREAS TO BE CITY STANDARD JB-2 WITH BOTTOM. 3. THERE SHALL BE NO SIGNAL WIRE OR FIBER CABLE SPLICING. 4. SERVICE WIRE FROM THE POWER SOURCE TO THE CONTROLLER CABINET SHALL BE PLACED IN SECONDARY SEPARATE CONDUIT.

5. STREET LIGHT CABLE IS NOT PERMITTED TO RUN THROUGH THE CONTROLLER CABINET AND SHALL BE PLACED IN SEPARATE CONDUIT. 6. TRAFFIC SIGNAL CABLE SHALL BE PLACED IN DEDICATED 7. MOUNT DISCONNECT ON POLE NEAREST TO THE CONTROLLER CABINET EXCLUDING TYPE X POLES. 8. REMOVE AND DISPOSE OF ALL EXISTING SIGNAL WIRING NO

9. REMOVE EXISTING SIGNAL EQUIPMENT NO LONGER IN USE AND RETURN TO THE CITY OF PITTSBURGH TRAFFIC CONTROL SHOP. COORDINATE DELIVERY OF EQUIPMENT WITH DELMAS MCELHANY, TRAFFIC CONTROL FOREMAN.

10. REMOVE ALL SIGNALS WHILE POLE IS PAINTED, REFER TO SECTION 02892.

ITEM NUMBER	MISCE	ELLAN	E0US	
UNIT	DESCRIPTION	QTY.	LOCATION	REMARKS
01882. 002 EACH	TRAFFIC SIGNAL TIMING MODIFICATIONS	2	CC	TEMPORE
01883. 002 EACH	TEMPORARY MODIFICATION OF EXISTING TRAFFIC SIGNAL	1		
02212. 009 LF	POLE FOUNDATION DRILLING, LESS THAN 30" DIAMETER	24	1 2 3	
02889. 002 EACH	LED LUMINAIRE CITY STANDARD, BLACK	1	<u>\</u>	<u>∕</u> 2\
02890. 002 EACH	TRAFFIC SIGNAL CONTROLLER, TYPE 2070 LC IN EXISTING CABINET	1	CC	<u> </u>
02890. 003 EACH	ETHERNET SWITCH	1	CC	
02890. 005 EACH	GPS TIME CLOCK	1	CC	
02890. 006 EACH	TRAFFIC SIGNAL CONTROLLER ASSEMBLY FOUNDATION, FUTURE INSTALLATION OF TYPE 332 BASE MOUNTED CABINET AND 8" RISER	1		ONLY INSTALL A CONTROLLER CABINET FOUNDATION AND PROPOSED CONDUITS TO FIT A FUTURE TYPE 332 CABINET AND 8" RISER.
02892. 501 EACH	EXISTING TRAFFIC SIGNAL SUPPORT, PAINTED BLACK	2	<u> </u>	TEMPORARILY REMOVE ATTACHED SIGNAL HARDWARE AND PAINT SIGNAL SUPPORT BLACK. REATTACH HARDWARE WHEN COMPLETE.
02893. 001 EACH	REMOVE EXISTING POLE	2	<u> </u>	
02894. 001 EACH	VEHICULAR SIGNAL HEAD, THREE 12" SECTIONS	4	1234	
02894. 005 EACH	LED COUNTDOWN PEDESTRIAN SIGNAL HEAD,	6	567 8910	BLACK TUNNEL VISORS BLACK ALUMINUM HOUSINGS
02894. 006 EACH	VEHICULAR SIGNAL HEAD, THREE 8" SECTIONS	2	00	BLACK TUNNEL VISORS BLACK ALUMINUM HOUSINGS BLACK METAL LOUVERED BACKPLATE
02894. 031 EACH	REMOVE VEHICULAR SIGNAL HEAD	1	9	<u> </u>
02894. 032 EACH	REMOVE PEDESTRIAN SIGNAL HEAD	1	<u> </u>	
02895. 002 EACH	ACCESSIBLE PEDESTRIAN SIGNALS	6	1123 456	

ITEM NUMBER	MISCELLAN	NEOUS	(CONT.)		1
UNIT	DESCRIPTION	QTY.	LOCATION	REMARKS	
02897 . 010	REPLACE EXISTING JUNCTION BOX LID	2	4 5		
EACH					
02897 . 011	CONNECT TO EXISTING JUNCTION BOX	2	4 5		
EACH					

FIFTH AVENUE AND TENNYSON AVENUE

DETECTORS

I TEM NUMBER	DESCRIPTION	SEN. NO.	QTY.	LOCATION
02895 . 001	VIDEO DETECTION	Û	1	4
EACH				
02895.	VIDEO DETECTION	2	1	5
EACH				75

TRAFFIC SIGNAL SUPPORTS **

	≅m R		MAST ARM						PEDESTAL																	
POLE NO.	I TEM NUMBER	DESCRIPTION	QTY.	ROUTE	⊢∀	SIDE	OFFSE							ARM	"A "						Af	RM "	С "	SHAFT	SIG	NAL
					ST		0	н	K		SIG	NAL I	LOCA	TION	:	SIGN	LOC	ATIO	N	w	G	x	z	н	м	N
	UNIT										М	N	0	Р	R	S	T	U	Y		L					اثنا
\triangle	02892. 004 EACH	TRAFFIC SIGNAL SUPPORT, 19' TYPE X, PAINTED BLACK	1	FIFTH AVE	559+71	LT	30′																	19′		10′
<u>^</u> 2	02892. 005 EACH	TRAFFIC SIGNAL SUPPORT, 30' TYPE X-L WITH LUMINAIRE ARM, PAINTED BLACK	1	FIFTH AVE	560+24	LT	30′														6′	30′	0°	30′		10′
<u>/</u> 3\	02892. 004 EACH	TRAFFIC SIGNAL SUPPORT, 19' TYPE X, PAINTED BLACK	1	FIFTH AVE	560+26	RT	33′																	19′	15′	10′
4		TRAFFIC SIGNAL SUPPORT, 20' MAST ARM		FIFTH AVE	559+79	RT	32'			20 '	16′	8′			12′				4'							
<u>\$</u>		TRAFFIC SIGNAL SUPPORT, 40' MAST ARM		FIFTH AVE	559+51	LT	32'			40′	30′	20′				16′	11′		4′							

** REFER TO PENNDOT TC-8800 TRAFFIC STANDARDS-SIGNALS FOR LETTER DESIGNATION

DESIGNED DRAWN WLZ CHECKED MSF IN CHARGE LJF DATE 05/01/24 SCALE AS SHOWN

TS-315 PORT AUTHORITY OF ALLEGHENY COUNTY

BUS RAPID TRANSIT UPTOWN TO OAKLAND SIGNAL PLANS TRAFFIC SIGNAL TABULATIONS

Port Authority
connecting people to life

CONTRACT NO. BRT-001 DWG. NO. SG89 sнт. **1149**

AECOM 707 Grant Street 5th Floor Pittsburgh, PA 15219



THE PREPARATION OF THIS
DOCUMENT HAS BEEN FINANCED IN
PART THROUGH A GRANT FROM THE
FEDERAL TRANSIT ADMINISTRATION,
U.S. DEPARTMENT OF
TRANSPORTATION, UNDER THE
URBAN MASS TRANSPORTATION ACT
OF 1964, AS AMENDED, FOR THE
PORT AUTHORITY OF ALLEGHENY
COUNTY, PENNSYLVANIA. NO. DATE DESCRIPTION REVISIONS

FIFTH AVENUE AND TENNYSON AVENUE

TRENCH, CONDUIT, JUNCTION BOX, ELECTRICAL ITEMS

DESCRIPTION	CITY OF PITTSBURGH STANDARD CONCRETE JUNCTION BOX, TYPE 1	TRENCH AND BACKFILL, TYPE II	TRENCH AND BACKFILL, TYPE IV	2 INCH CONDUIT	3 INCH CONDUIT	AWG 8, UNDERCROUND CABLE, COPPER, 1 CONDUCTOR	SIGNAL CABLE, 14 AWG, 5 CONDUCTOR	SIGNAL CABLE, 14 AWG, 7 CONDUCTOR
ITEM NUMBER	02897	02898	02898	02899	02899	02900	02900	02900
TTEM NOMBER	001	002	005	002	003	001	002	003
UNIT	EACH	LF	LF	LF	LF	LF	LF	LF
LOCATION								
FOUNDATION TO 1	1	21		42	42			
1 TO 2	1	14	34	96	96			
1 то 3	1	32	33	65	130			
2 TO 4		19		38	38			
3 TO 5		75		75	150			
<u> </u>		4		4	8			
<u> </u>		6		6	12			
<u>∕3</u> то 3		4		4	8			
COMPLETE INTERSECTION						270	765	720
TOTAL	3	175	67	330	484	270	765	720

SIGNS

SYMBOL	SERIES	SIZE	AREA EACH (SQ FT)	DESCRIPTION	QUANTITY	M POST MOUNTED SIGNS, TYPE B	02891,003 유 POST MOUNTED SIGNS, TYPE F	STRUCTURE MOUNTED FLAT SHEET ALUMINUM SIGNS WITH STIFFENERS	RESET POST MOUNTED SIGNS, TYPE F	RESET STRUCTURE MOUNTED FLAT SHEET ALUMINUM SIGN WITH STIFFENERS	REMOVE STRUCTURE ROUNTED FLAT SHEET ALUMINUM SIGN
A	R10-3E(MOD)	9"×15"	0.9	EDUCATIONAL PUSH BUTTON FOR WALK Signal With Countdown Timer (MOD)	6		A				
				Oakland 100 Tennyson Ave	1					1	
E				NO LEFT TURN	2				1	1	
Ē	R3-2	24"x24"	4.0	NO LEFT TURN	1		4.0				
6	R9-5	12"×18"	1.5	BICYCLES USE PED SIGNAL	2	1.5	1.5				
(H)	R10-11	24"X30"	5.0	NO TURN ON RED ●	1	5.0					
1	R10-11	30"×36"	7.5	NO TURN ON RED ●	2		7.5	7.5			
0	R3-11B(MOD)	30"×36"	7.5	RIGHT LANE - BUSES ONLY	1			7.5			
K	SS-1	30"×18"	3.8	EXCEPT RIGHT TURNS	1			3.8			
	R6-1	36"×12"	3.0	ONE-WAY (TWO SIDED, CITY STANDARD)	2		6.0				
M	R3-7-1R	30"×30"	6.3	ALL TRAFFIC MUST TURN RIGHT	1	6.3					
N	R3-7bP	24"×12"	2.0	EXCEPT BICYCLES	4		6.0	2.0			
0				CARS/BIKES SHARE THE ROAD	1						1
	TOTAL							20.8	1	2	1


▲ - INCIDENTAL TO ITEM 02895.002

Gulf Tower
707 Grant Street
5th Floor
Pittsburgh, PA 15219



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URBAN MASS TRANSPORTATION ACT
OF 1964, AS AMENDED, FOR THE
PORT AUTHORITY OF ALLEGHENY
COUNTY, PENNSYLVANIA.

					TS-	-315
ESIGNED	<u>LJF</u>	PORT AUTHOR	ITY OF AL	LEGHENY COL	JNTY	7
DRAWN	WLZ	PITTSBURGH		PENNS	SYLVANIA	4
CHECKED	MSF	BUS RAPID TF	RANSIT UPT	OWN TO OAKLA	AND	
N CHARGE	<u>LJF</u>		SIGNAL PL	ANS.		
ATE	05/01/24	TRAF	FIC SIGNAL T	ABULATIONS		
CALE /	AS SHOWN	Port Authority	CONTR	ACT NO. BRT-00)1	
,	40 OHOWN	connecting people to life	DWG. NO.	SG90	SHT.	1150

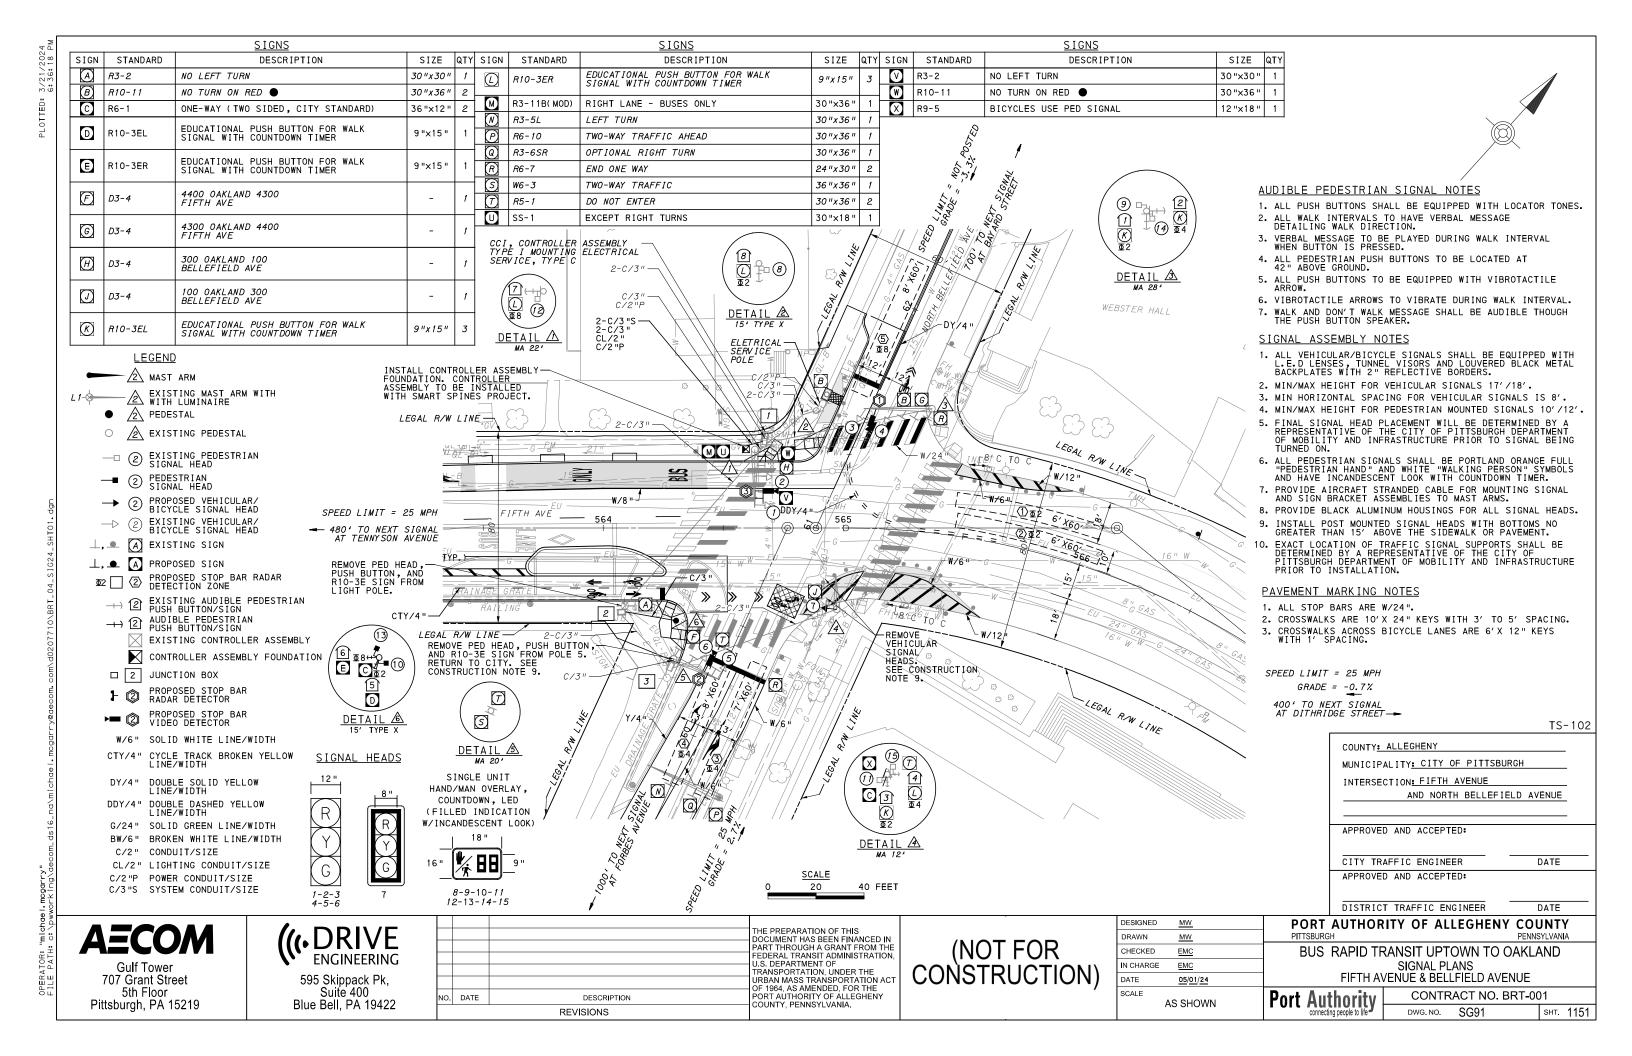

PHASE 2

PASSAGE FREE (MAX)

MEMORY

PEDESTRIAN

		1.1	IASL				1 111	43L	710		
	BIKI	<u>.</u>	<u></u>	<u></u>	BIKE	BIK	 			IKE	HLANHIZG HLANHIZG
INTERVAL	1	2	3	4	5	1	2	3	4	5	
1-2	R	G	G	Υ	R	R	R	R	R	R	R
3-4	R	R	R	R	R	R	G	G	Υ	R	R
5-6	R	R	R	R	R	R	G	G	Υ	R	R
7	G	G	G	Y	R	R	R	R	R	R	0FF
8-9	W	W	FD	DW	DW	DW	DW	DW	DW	DW	0FF
10-11	W	W	FD	DW	DW	DW	DW	DW	DW	DW	0FF
12-13	DW	DW	DW	DW	DW	W	W	FD	DW	DW	0FF
14-15	DW	DW	DW	DW	DW	W	W	FD	DW	DW	0FF
											,
FIXED		><	<	4	3		><	<	4	3	
MINIMUM		15					15				

35

3 4 14

MINIMUM RECALL

MOVEMENT, PHASING AND SEQUENCE CHART

PHASE 4+8

51

5 2 20

PED-RECALL

—∭UTILITY POLE (STATION 61+48, OFFSET 19' LT)

WIRING DIAGRAM

5C/14 - CABLE(NO. OF CONDUCTORS/SIZE AWG.)

SIGNAL HEAD

A SIGNAL SUPPORT

AUDIBLE PEDESTRIAN INDICATOR

☐ JUNCTION BOX

-LUMINAIRE

RADAR DETECTOR

INCIDENTAL TO ITEM 02895.001, AS PER MANUFACTURERS SPECIFICATIONS

3C/14 INCIDENTAL TO ITEM 02895.002

TRANSIT PRIORITY PRE-EMPTION NOTES (TO BE INSTALLED BY OTHERS)

- COORDINATE TRAFFIC CONTROLLER PROGRAMMING MODIFICATION WITH REPRESENTATIVES OF THE CITY OF PITTSBURGH AND DISTRICT TRAFFIC UNIT.
- 2. INCLUDE A TRANSIT PRIORITY PHASE THAT WILL EXTEND THE INDICATED PHASE A MAXIMUM OF 10 SECONDS WHEN ACTIVATED BY A PORT AUTHORITY VEHICLE. DO NOT VIOLATE SIDE STREET PEDESTRIAN MINIMUM TIMINGS.
- 3. MAINTAIN ALL YELLOW CLEARANCES AT ALL TIMES.
- 4. PROCEED TO THE SUBSEQUENT INTERVAL AS DEFINED IN THE MOVEMENT, SEQUENCE AND TIMING DIAGRAM UPON COMPLETING THE GREEN EXTENSION INTERVAL.
- 5. ONCE A TRANSIT CALL IS PLACED AND SATISFIED, THE CONTROLLER WILL NOT SATISFY ANOTHER CALL FOR
- 6. LOCATION OF BUS DETECTORS ARE TO BE FIELD ADJUSTED TO ACHIEVE MAXIMUM OPERATION.

DETECTOR ZONE INFORMATION


DETECTOR	DETECTION ZONE(S)	MODE	TYPE	ROUTE	PHASE	LOCATION MAST ARM
3	(6' x 60')	PRESENCE	VIDEO (STOP BAR)	FIFTH AVENUE	2	\triangle
3	② (6′× 60′)	PRESENCE	VIDEO (STOP BAR)	FIFTH AVENUE	2	\triangle
0	③ (7'× 60')	PRESENCE	VIDEO (STOP BAR)	BELLEFIELD AVENUE	4	<u> </u>
0	⟨4⟩ (8′ × 60′)	PRESENCE	VIDEO (STOP BAR)	BELLEFIELD AVENUE	4	<u> </u>
2	⟨5⟩ (8′× 60′)	PRESENCE	VIDEO (STOP BAR)	BELLEFIELD AVENUE	8	<u>\$</u>

AECOM

Gulf Tower 707 Grant Street 5th Floor Pittsburgh, PA 15219



595 Skippack Pk, Suite 400 Blue Bell, PA 19422

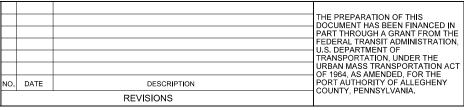

(NOT FOR CONSTRUCTION)

DESIGNED	<u>MW</u>	
DRAWN	<u>MW</u>	
CHECKED	<u>EMC</u>	
IN CHARGE	<u>EMC</u>	
DATE	05/01/24	
SCALE		
	AS SHOWN	

GENERAL NOTES

THE CITY OF PITTSBURGH SHALL INSPECT THE NEW SIGNAL EQUIPMENT PRIOR TO ACTIVATION.

ALL TRAFFIC SIGNAL MAINTENANCE AND OPERATION RESPONSIBILITIES SHALL BE TURNED OVER TO THE CITY OF PITTSBURGH AFTER THE FOLLOWING CONDITIONS ARE IMPLEMENTED TO THE CITY'S SATISFACTION:

- 1. PERMIT "AS-BUILT" TRAFFIC SIGNAL DRAWINGS ARE SUBMITTED AND APPROVED.
- 2. ALL PUNCH LIST ITEMS ARE COMPLETED BY THE CONTRACTOR.
- 3. AFTER THE 30-DAY CONTINUOUS UNINTERRUPTED SIGNAL OPERATION WITHOUT MALFUNCTIONS.

CONSTRUCTION NOTES

- 1. ALL JUNCTION BOXES IN WALK AREAS TO BE CITY OF PITTSBURGH STANDARD CONCRETE JUNCTION BOX, TYPE 1.
- 2. ALL JUNCTION BOXES IN NON-WALK AREAS TO BE CITY STANDARD JB-2 WITH BOTTOM.
- 3. THERE SHALL BE NO SIGNAL WIRE OR FIBER CABLE SPLICING.
- 4. SERVICE WIRE FROM THE POWER SOURCE TO THE CONTROLLER CABINET SHALL BE PLACED IN SECONDARY SEPARATE CONDUIT.
- 5. STREET LIGHT CABLE IS NOT PERMITTED TO RUN THROUGH THE CONTROLLER CABINET AND SHALL BE PLACED IN SEPARATE CONDUIT.
- 6. TRAFFIC SIGNAL CABLE SHALL BE PLACED IN DEDICATED
- 7. MOUNT DISCONNECT ON POLE NEAREST TO THE CONTROLLER CABINET EXCLUDING TYPE X POLES.
- 8. REMOVE AND DISPOSE OF ALL EXISTING SIGNAL WIRING NO
- 9. REMOVE EXISTING SIGNAL EQUIPMENT NO LONGER IN USE AND RETURN TO THE CITY OF PITTSBURGH TRAFFIC CONTROL SHOP. COORDINATE DELIVERY OF EQUIPMENT WITH DELMAS MCELHANY, TRAFFIC CONTROL FOREMAN.

COUNTY: ALLEGHENY MUNICIPALITY: CITY OF PITTSBURGH INTERSECTION: FIFTH AVENUE AND NORTH BELLEFIELD AVENUE APPROVED AND ACCEPTED: CITY TRAFFIC ENGINEER DATE APPROVED AND ACCEPTED:

TS-102

DISTRICT TRAFFIC ENGINEER DATE PORT AUTHORITY OF ALLEGHENY COUNTY PITTSBURGH PENNSYLVANIA

BUS RAPID TRANSIT UPTOWN TO OAKLAND SIGNAL PLANS WIRING, MOVEMENT, PHASING & SEQUENCE DIAGRAMS

CONTRACT NO. BRT-001 **Port Authority** DWG.NO. SG92 sнт. 1152

TRAIT TO STONAL TABOLATTO	<u>TRA</u>	\FF	ΙC	SIGNAL	TABUL	AT	10
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FIFTH AVENUE AND NORTH BELLEFIELD AVENUE

MISC	ELLAN	EOUS	
DESCRIPTION	QTY.	LOCATION	REMARKS
TRAFFIC SIGNAL TIMING MODIFICATIONS	1	СС	
GPS TIME CLOCK	1	СС	
TRAFFIC SIGNAL CONTROLLER ASSEMBLY FOUNDATION, FUTURE INSTALLATION OF TYPE 332 BASE MOUNTED CABINET AND 8" RISER	1		ONLY INSTALL A CONTROLLER CABINET FOUNDATION AND PROPOSED CONDUITS TO FIT A FUTURE TYPE 332 CABINET AND 8 " RISER.
VEHICULAR SIGNAL HEAD, THREE 8" SECTIONS	1	①	BLACK TUNNEL VISORS BLACK ALUMINUM HOUSINGS BLACK METAL LOUVERED BACKPLATE
LED COUNTDOWN PEDESTRIAN SIGNAL HEAD,	2	00	BLACK TUNNEL VISORS BLACK ALUMINUM HOUSINGS
ACCESSIBLE PEDESTRIAN SIGNALS	2	56	
CONNECT TO EXISTING JUNCTION BOX	2	12	
REMOVE VEHICULAR SIGNAL HEAD	2	<u> </u>	SE CORNER
REMOVE PEDESTRIAN SIGNAL HEAD	2	<u>\$</u>	SW CORNER SIGNAL POLE (1) SW CORNER LIGHT POLE (1)
REMOVE ACCESSIBLE PEDESTRIAN SIGNAL	2	<u>\$</u>	SW CORNER SIGNAL POLE (1) SW CORNER LIGHT POLE (1)
POLE FOUNDATION DRILLING, LESS THAN 30" DIAMETER	6	<u></u>	
	DESCRIPTION TRAFFIC SIGNAL TIMING MODIFICATIONS GPS TIME CLOCK TRAFFIC SIGNAL CONTROLLER ASSEMBLY FOUNDATION, FUTURE INSTALLATION OF TYPE 332 BASE MOUNTED CABINET AND 8" RISER VEHICULAR SIGNAL HEAD, THREE 8" SECTIONS LED COUNTDOWN PEDESTRIAN SIGNAL HEAD, TYPE A ACCESSIBLE PEDESTRIAN SIGNALS CONNECT TO EXISTING JUNCTION BOX REMOVE VEHICULAR SIGNAL HEAD REMOVE PEDESTRIAN SIGNAL HEAD REMOVE ACCESSIBLE PEDESTRIAN SIGNAL POLE FOUNDATION DRILLING, LESS THAN	DESCRIPTION QTY. TRAFFIC SIGNAL TIMING MODIFICATIONS 1 GPS TIME CLOCK 1 TRAFFIC SIGNAL CONTROLLER ASSEMBLY FOUNDATION, FUTURE INSTALLATION OF TYPE 332 BASE MOUNTED CABINET AND 8" RISER VEHICULAR SIGNAL HEAD, 1 LED COUNTDOWN PEDESTRIAN SIGNAL HEAD, 2 ACCESSIBLE PEDESTRIAN SIGNAL HEAD, 2 CONNECT TO EXISTING JUNCTION BOX 2 REMOVE VEHICULAR SIGNAL HEAD 2 REMOVE PEDESTRIAN SIGNAL HEAD 2 POLE FOUNDATION DRILLING, LESS THAN 6	DESCRIPTION TRAFFIC SIGNAL TIMING MODIFICATIONS 1 CC GPS TIME CLOCK TRAFFIC SIGNAL CONTROLLER ASSEMBLY FOUNDATION, FUTURE INSTALLATION OF TYPE 332 BASE MOUNTED CABINET AND 8" RISER VEHICULAR SIGNAL HEAD, THREE 8" SECTIONS LED COUNTDOWN PEDESTRIAN SIGNAL HEAD, 2 16 CONNECT TO EXISTING JUNCTION BOX REMOVE VEHICULAR SIGNAL HEAD REMOVE PEDESTRIAN SIGNAL HEAD REMOVE ACCESSIBLE PEDESTRIAN SIGNAL POLE FOUNDATION DRILLING, LESS THAN

DETECTORS

I TEM NUMBER	DESCRIPTION	SEN. NO.	QTY.	LOCATION
02895. 001 EACH	VIDEO DETECTION	123	3	<u> </u>

TRAFFIC SIGNAL SUPPORTS **

				0 310117																						
	≥ Ⅲ ~				NO NO		 -						1	MAST	ARM									PEDE	STAL	-
POLE NO.	ITEM	DESCRIPTION	QTY.	ROUTE	AT I (SIDE	OFFSET							ARM	"A"						AF	:M "C) "	SHAFT	SIG	NAL
1101					ST	"	 P	Н	K	L	SIGN	NAL	_OCA	NOIT		SIGN	LOC	ATIO	N	w	G	х	Z	н	м	N
	UNIT									_	М	N	0	Р	R	S	T	U	Υ			^			IVI	
\triangle		TRAFFIC SIGNAL SUPPORT, 22' MAST ARM		FIFTH AVE.	564+63	LT	24 '	17 '	10'	22'	21'	10'			16′	5′	0′			o°						
2		TRAFFIC SIGNAL SUPPORT, 15' TYPE X		FIFTH AVE.	564+87	LT	48 '	17 '	10'															15'		10'
3		TRAFFIC SIGNAL SUPPORT, 28' MAST ARM		FIFTH AVE.	565+37	LT	48 '	17 '	10'	28 '	26 '	15'			11'	5 '	0'			90°						
4		TRAFFIC SIGNAL SUPPORT, 12' MAST ARM		FIFTH AVE.	564+96	RT	33 '	17 '	10'	12'	1,															
<u> </u>		TRAFFIC SIGNAL SUPPORT, 20' MAST ARM		FIFTH AVE.	564+29	RT	53'	17 '	10'	20 ′	19'	9'			16'	6'	0'									
<u> </u>	02892. 003 EACH	TRAFFIC SIGNAL SUPPORT, 15' TYPE X, PAINTED BLACK	1	FIFTH AVE.	564+30	RT	39′																	15′		10′

** REFER TO PENNDOT TC-8800 TRAFFIC STANDARDS - SIGNALS FOR LETTER DESIGNATION

AECOM

Gulf Tower 707 Grant Street 5th Floor Pittsburgh, PA 15219

((DRIVE ENGINEERING 595 Skippack Pk, Suite 400 Blue Bell, PA 19422

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DATE		PORT AUTHORITY OF ALLEGHENY COUNTY, PENNSYLVANIA.
	REVISIONS	COUNTY, PENNSTEVANIA.

(NOT FOR CONSTRUCTION)

DESIGNED	<u>MW</u>	
DRAWN	<u>MW</u>	
CHECKED	<u>EMC</u>	
IN CHARGE	<u>EMC</u>	
DATE	05/01/24	
SCALE	4.0.011014/41	
	AS SHOWN	

PORT AUTHORITY OF ALLEGHENY COUNTY PENNSYLVANIA BUS RAPID TRANSIT UPTOWN TO OAKLAND

SIGNAL PLANS TRAFFIC SIGNAL TABULATIONS

Port Authority
connecting people to life

CONTRACT NO. BRT-001 DWG. NO. SG93

sнт. 1153

DESCRIPTION	TRENCH AND BACKFILL, TYPE I	2 INCH CONDUIT	3 INCH CONDUIT	SIGNAL CABLE, 14 AWG, 5 CONDUCTOR	SIGNAL CABLE, 14 AWG, 7 CONDUCTOR
TTEN MUNDED	02898	02899	02899	02900	02900
ITEM NUMBER	001	002	003	002	003
UNIT	LF	LF	LF	LF	LF
LOCATION					
CC TO []					
/ TO 2					
2 TO 3					
/ то ∕∱					
/ TO <u>/2</u>					
1 то ▶	7	14	28		
2 TO <u>6</u>	22		22		
3 TO 4					
3 TO 5					
COMPLETE INTERSECTION				268	334
TOTAL	29	14	50	268	334

SIGNS

SYMBOL	SERIES	SIZE	AREA EACH (SQ FT)	DESCRIPTION	QUANTITY	POST MOUNTED SIGNS,	02891,003 MOUNTED SIGNS, TYPE F	STRUCTURE MOUNTED FLAT SHEET ALUMINUM SIGNS WITH STIFFENERS
C	R6-1	36 "X12 "	3.0	ONE-WAY (TWO SIDED, CITY STANDARD)	2			6.0
D	R10-3EL	9 "×15 "	0.9	EDUCATIONAL PUSH BUTTON FOR WALK SIGNAL WITH COUNTDOWN TIMER	1			•
E	R10-3ER	9 "×15 "	0.9	EDUCATIONAL PUSH BUTTON FOR WALK SIGNAL WITH COUNTDOWN TIMER	1			•
M	R3-11B(MOD)	30 "x36 "	7.5	RIGHT LANE - BUSES ONLY	1	7.5		
O	SS-1	30"×18"	3.8	EXCEPT RIGHT TURNS	1		3.8	
Ø	R3-2	30"x30"	6.3	NO LEFT TURN	1			6.3
W	R10-11	30"×36"	7.5	NO TURN ON RED	1			7.5
X	R9-5	12"×18"	1.5	BICYCLES USE PED SIGNAL	1			1.5
			•	TOTAL		7.5	3.8	21.3

▲ - INCIDENTAL TO ITEM 02895.002

* WHITE REFLECTORIZED LEGEND AND BORDER ON BLUE REFLECTORIZED BACKGROUND.
UTILIZE 4" CLEARVIEW 3W FOR BLOCK/NEIGHBORHOOD AND 8" CLEARVIEW 3W FOR
STREET NAME. ACTUAL WIDTH DETERMINED BY LETTER SPACING. COORDINATE BLOCK
NUMBERS AND STREET NAME DETAILS WITH CITY OF PITTSBURGH DEPARTMENT OF
MOBILITY AND INFRASTRUCTURE.

AECOM


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595 Skippack Pk, Suite 400 Blue Bell, PA 19422

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			OF 1964, AS AMENDED, FOR THE
NO.	DATE	DESCRIPTION	PORT AUTHORITY OF ALLEGHENY COUNTY, PENNSYLVANIA.
		REVISIONS	COUNTY, PENINSYLVANIA.

DESIGNED	MW	PORT AUTHOR	ITY OF AL	LEGHENY COL	JNTY
DRAWN	MW	PITTSBURGH		PENNS	SYLVANIA
CHECKED	<u>EMC</u>	BUS RAPID TE	RANSIT UPT	OWN TO OAKLA	AND
IN CHARGE	EMC		SIGNAL PL		
DATE	<u>05/01/24</u>	TRAF	FIC SIGNAL T	ABULATIONS	
SCALE	AS SHOWN	Port Authority	CONTR	ACT NO. BRT-00)1
,		connecting people to life	DWG. NO.	SG94	sнт. 1154



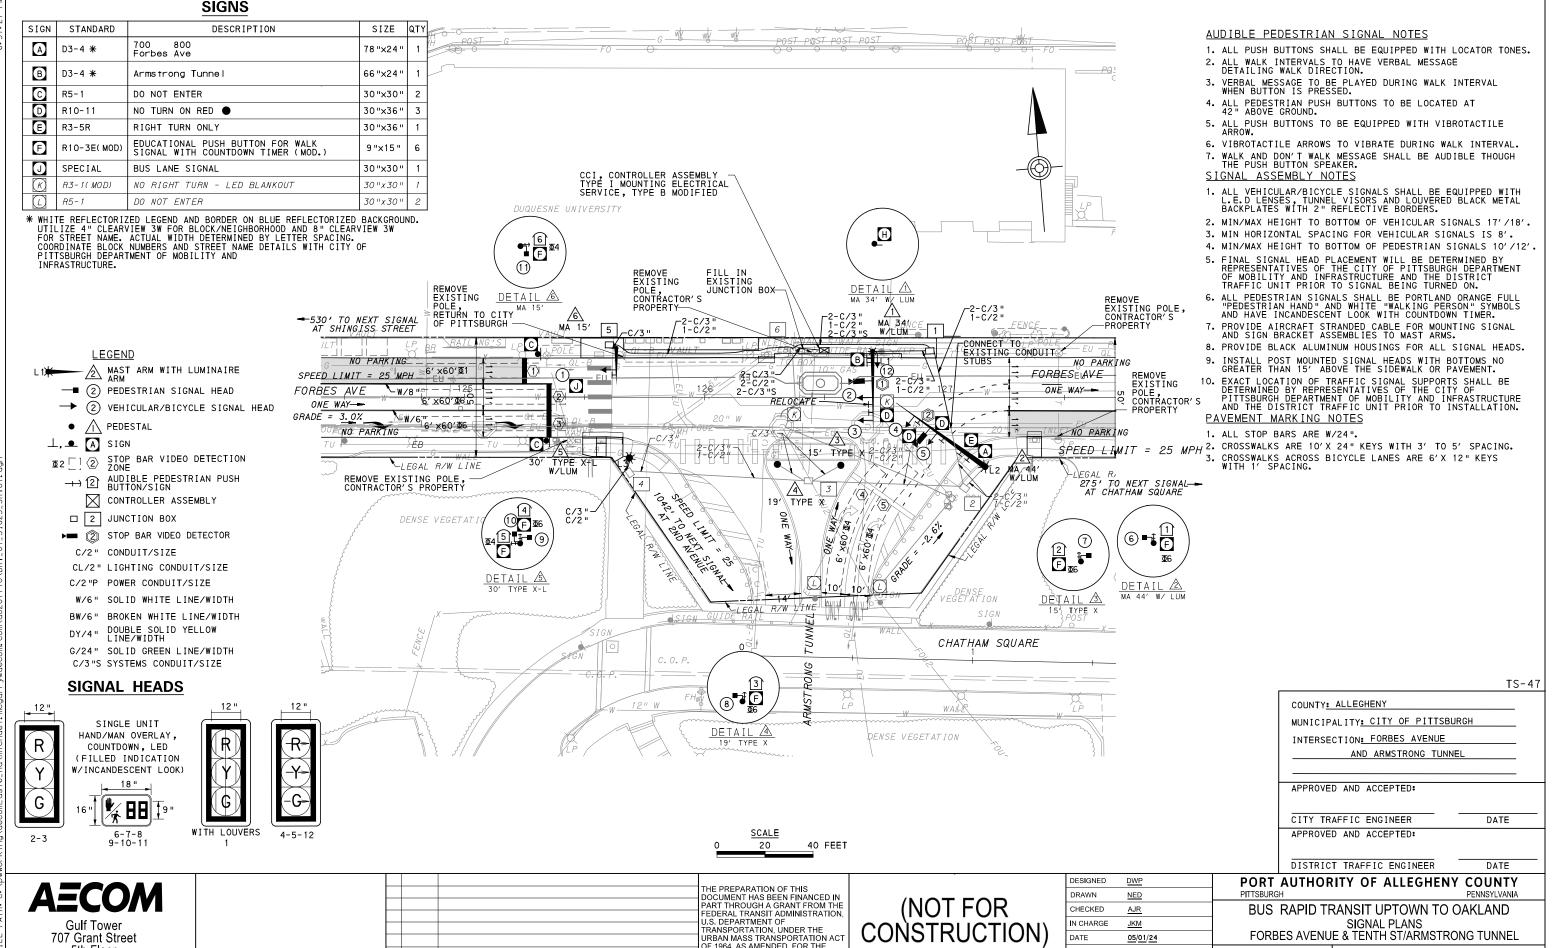

COUNTY, PENNSYLVANIA.

SCALE

AS SHOWN

CONTRACT NO. BRT-001

sнт. 1155

SG95

DWG NO

Port Authority

5th Floor

Pittsburgh, PA 15219

NO. DATE

DESCRIPTION

REVISIONS

		PH	IASE	1			PI	HASE	6			PH	ASE	4			TI PRE	JNNE EMPT	ION		
	BU <u>\$</u>		\ - 		-	BU'	SH 	 	<u>-</u>	.	BU	 S- 			=	ВІ	JSH			-	ELASHIZG FLASHIZG
		INT	ERV	4LS			IN.	TERV	ALS			INT	ERV.	4LS			IN.	TERV.	ALS		Ϋ́
SIGNAL	1	2	3	-	-	1	2	3	4	-	1	2	3	4	-		1	2	3		
1	G	Υ	R			R	R	R	R		R	R	R	R		s (R	R	R		R
2-3	R	R	R			G	G	Υ	R		R	R	R	R		SELECT		R	R		R
4-5-12	R	R	R			R	R	R	R		-G -	-G -	-Y -	-R -		le ?	4 −G −	-Y -	-R -		-R -
6-7-8-9	W	W	W			W	FD	DW	DW		DW	DW	DW	DW		Ę.	ΔDW	DW	DW		OFF
10-11	DW	DW	DW			DW	DW	DW	DW		W	FD	DW	DW]E !	DW	DW	DW		OFF
																E CT E					
FIXED	\times	3	2			\wedge	<	3.5	5.5		>	<	3.5	2.5		b	\times	3	2		
MINIMUM	5					1	0				1	0									
PASSAGE						12.3	3				;	3									
FREE (MAX)	5					9	0				9	0					93				
PEDESTRIAN	*	*				7	35				7	10									
MEMORY		NON	LOC	KING			MIN	REC	ALL			PED	REC	ALL			L	OCK I	NG		

* PEDESTRIAN PHASE STARTS HERE ONLY WHEN PHASE 1 IS CALLED AND WILL TERMINATE IN PHASE 6.

DLCO MH

AT STATION 126+33

FORBES AVE

POWER

中

\$

\$

4


2

<u>/</u>2\

TUNNEL EMERGENCY PREEMPTION NOTES

- 1. IF THE CONTROLLER OPERATION IS IN A GREEN INTERVAL OF A NON-PREEMPTION PHASE, THE CONTROLLER SHALL TERMINATE THE INTERVAL IMMEDIATELY AND PROCEED NORMALLY THROUGH THE YELLOW AND ALL RED INTERVALS PROCEEDING TO THE PREEMPTION PHASE.
- 2. IF THE CONTROLLER OPERATION IS IN A GREEN INTERVAL OF A PREEMPTION PHASE, THE CONTROLLER SHALL REMAIN IN THAT INTERVAL.
- 3. IF THE CONTROLLER OPERATION IS IN THE YELLOW OR ALL RED INTERVALS OF ANY PHASE, THE CONTROLLER SHALL TIME OUT THOSE INTERVALS NORMALLY BEFORE PROCEEDING TO THE PREEMPTION PHASES.
- 4. UPON TERMINATION OF THE PREEMPTION PHASES, THE CONTROLLER SHALL PROCEED NORMALLY THROUGH YELLOW AND ALL RED INTERVALS TO NORMAL "PHASE NEXT" OPERATION.

WIRING DIAGRAM

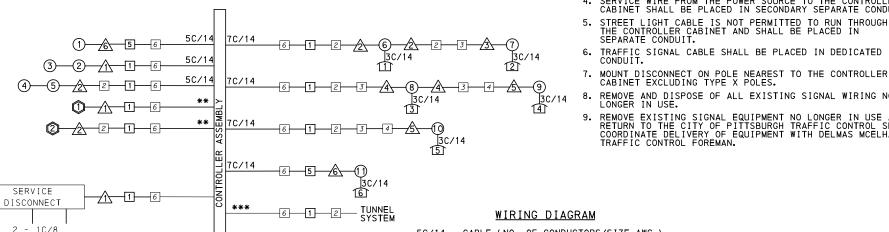

5C/14 - CABLE (NO. OF CONDUCTORS/SIZE AWG.)

EXISTING SIGNAL HEAD PROPOSED SIGNAL HEAD

GENERAL NOTES

CONTRACTOR.

CONSTRUCTION NOTES

THE CITY OF PITTSBURGH SHALL INSPECT THE NEW SIGNAL EQUIPMENT PRIOR TO ACTIVATION.

ALL TRAFFIC SIGNAL MAINTENANCE AND OPERATION RESPONSIBILITIES SHALL BE TURNED OVER TO THE CITY OF PITTSBURGH AFTER THE FOLLOWING CONDITIONS ARE IMPLEMENTED TO THE CITY'S SATISFACTION:

1. PERMIT "AS-BUILT" TRAFFIC SIGNAL DRAWINGS ARE SUBMITTED AND APPROVED.

2. ALL PUNCH LIST ITEMS ARE COMPLETED BY THE

3. AFTER THE 30-DAY CONTINUOUS UNINTERRUPTED SIGNAL OPERATION WITHOUT MALFUNCTIONS.

1. ALL JUNCTION BOXES IN WALK AREAS TO BE CITY OF PITTSBURGH STANDARD CONCRETE JUNCTION BOX, TYPE 1. 2. ALL JUNCTION BOXES IN NON-WALK AREAS TO BE CITY STANDARD JB-2 WITH BOTTOM. 3. THERE SHALL BE NO SIGNAL WIRE OR FIBER CABLE SPLICING.

4. SERVICE WIRE FROM THE POWER SOURCE TO THE CONTROLLER CABINET SHALL BE PLACED IN SECONDARY SEPARATE CONDUIT.

REMOVE AND DISPOSE OF ALL EXISTING SIGNAL WIRING NO

REMOVE EXISTING SIGNAL EQUIPMENT NO LONGER IN USE AND RETURN TO THE CITY OF PITTSBURGH TRAFFIC CONTROL SHOP. COORDINATE DELIVERY OF EQUIPMENT WITH DELMAS MCELHANY, TRAFFIC CONTROL FOREMAN.

6. TRAFFIC SIGNAL CABLE SHALL BE PLACED IN DEDICATED

EXISTING AUDIBLE PROPOSED AUDIBLE PEDESTRIAN INDICATOR PEDESTRIAN INDICATOR

EXISTING SIGNAL SUPPORT 🛕 PROPOSED SIGNAL SUPPORT 1 1 EXISTING JUNCTION BOX PROPOSED JUNCTION BOX

-(L1)- PROPOSED LUMINAIRE —(∠1)— EXISTING LUMINAIRE

PROPOSED DETECTOR

INCIDENTAL TO ITEM 02895.001, AS PER MANUFACTURERS SPECIFICATIONS

DESIGNED

CHECKED

N CHARGE

DATE

SCALE

DWF

NED

AJR

JKM

3C/14 INCIDENTAL TO ITEM 02895.002

*** TUNNEL PREEMPTION CABLE PROVIDED BY OTHERS.

CONNECTION TO CONTROLLER INCIDENTAL TO ITEM 02890.007

DETECTOR ZONE INFORMATION

DETECTOR		ECTION ONE(S)	MODE	TYPE	ROUTE	PHASE	LOCATION MAST ARM
()	1	(6′×60′)	PRESENCE	VIDEO (STOP BAR)	FORBES AVE	1	A
	2\3	(6′×60′)	FRESENCE	VIDEO (STOP BAR)	FURBES AVE	6	
2	4\5	(6′×60′)	PRESENCE	VIDEO (STOP BAR)	ARMSTRONG TUNNEL	4	2

TS-47 COUNTY: ALLEGHENY MUNICIPALITY: CITY OF PITTSBURGH INTERSECTION: FORBES AVENUE AND ARMSTRONG TUNNEL

DATE

PENNSYLVANIA

APPROVED AND ACCEPTED:

CITY TRAFFIC ENGINEER APPROVED AND ACCEPTED:

DISTRICT TRAFFIC ENGINEER

DATE PORT AUTHORITY OF ALLEGHENY COUNTY

BUS RAPID TRANSIT UPTOWN TO OAKLAND SIGNAL PLANS

Port Authority

WIRING, MOVEMENT, PHASING & SEQUENCE DIAGRAMS CONTRACT NO. BRT-001

AECOM 707 Grant Street 5th Floor Pittsburgh, PA 15219

TRANSIT PRIORITY PRE-EMPTION NOTES (TO BE INSTALLED BY OTHERS)

3. MAINTAIN ALL YELLOW CLEARANCES AT ALL TIMES.

COORDINATE TRAFFIC CONTROLLER PROGRAMMING MODIFICATION WITH REPRESENTATIVES OF THE CITY OF PITTSBURGH AND DISTRICT TRAFFIC UNIT.

2. INCLUDE A TRANSIT PRIORITY PHASE THAT WILL EXTEND THE INDICATED PHASE A MAXIMUM OF 10 SECONDS WHEN ACTIVATED BY A PORT AUTHORITY VEHICLE. DO NOT VIOLATE SIDE STREET PEDESTRIAN MINIMUM TIMINGS.

4. PROCEED TO THE SUBSEQUENT INTERVAL AS DEFINED IN THE MOVEMENT, SEQUENCE AND TIMING DIAGRAM UPON COMPLETING THE GREEN EXTENSION INTERVAL.

5. ONCE A TRANSIT CALL IS PLACED AND SATISFIED, THE CONTROLLER WILL NOT SATISFY ANOTHER CALL FOR

6. LOCATION OF BUS DETECTORS ARE TO BE FIELD ADJUSTED TO ACHIEVE MAXIMUM OPERATION.

THE PREPARATION OF THIS DOCUMENT HAS BEEN FINANCED IN PART THROUGH A GRANT FROM THE FEDERAL TRANSIT ADMINISTRATION U.S. DEPARTMENT OF TRANSPORTATION, UNDER THE URBAN MASS TRANSPORTATION ACT OF 1964 AS AMENDED FOR THE NO. DATE DESCRIPTION COUNTY, PENNSYLVANIA. REVISIONS

(NOT FOR CONSTRUCTION

05/01/24 AS SHOWN

SG96 sнт. 1156 DWG NO

ITEM NUMBER MISCELLANEOUS DESCRIPTION REMARKS LOCATION 01882 002 TRAFFIC SIGNAL TIMING MODIFICATIONS CC EACH POLE FOUNDATION DRILLING, LESS THAN 30" DIAMETER <u></u> 9

O2212-010 POLE FOUNDATION DRILLING, GREATER THAN 30" DIAMETER 23 <u> 1</u>

LED COUNTDOWN PEDESTRIAN SIGNAL HEAD,

002 ACCESSIBLE PEDESTRIAN SIGNALS

02897. 011 CONNECT TO EXISTING JUNCTION BOX

02897. 001 CITY OF PITTSBURGH STANDARD CONCRETE JUNCTION BOX, TYPE 1

EACH

02890.

EACH 02894.

EACH

02894**.** 001

EACH 02894.

EACH 02895.

1/2/5 002 LED LUMINAIRE CITY STANDARD, BLACK **英 英 英**

02890. 001 TRAFFIC SIGNAL CONTROLLER ASSEMBLY, TYPE 2070 LC, WITH TYPE 332 BASE MOUNTED CABINET(MOD) 332 CONTROLLER CABINET 8" RISER RE-ESTABLISH INTERCONNECT CC 02890**.** 003 CC ETHERNET SWITCH EACH

TUNNEL PREEMPTION CONNECTION CC 23450 BLACK TUNNEL VISORS
BLACK ALUMINUM HOUSINGS
BLACK METAL LOUVERED BACKPLATE VEHICULAR SIGNAL HEAD,
THREE 12" SECTIONS

BLACK TUNNEL VISORS BLACK ALUMINUM HOUSINGS BLACK METAL LOUVERED BACKPLATE SIGNAL LOUVERS VEHICULAR SIGNAL HEAD, THREE 12" SECTIONS 1

4 6

2

678 BLACK TUNNEL VISORS BLACK ALUMINUM HOUSINGS 6 900

1123 1456 RECONNECT EXISTING LIGHTING WIRING WITHIN NEW JB <u></u>

TRAFFIC SIGNAL SUPPORTS **

	Σ Ω				NO		-								MAST	ARM								PE)EST/	4L
POLE NO.	ITEM	DESCRIPTION	αTΥ.	ROUTE	ATIC	SIDE	FFSE							ARM	"A"						Αf	RM "	C "	SHAFT	SIG	SNAL
	_				ST	"	OF	н	K	L	SIG	NAL I	LOCA	TION		SIGN	LOC	OITA	N	w	G	x	z	Н	м	N
	UNIT										М	N	0	Р	R	S	Т	U	Y							
\triangle	02892. 209 EACH	TRAFFIC SIGNAL SUPPORT, 34' MAST ARM WITH LUMINAIRE ARM (30' MOUNTING HEIGHT), PAINTED BLACK	1	FORBES AVE	126+70	L	19′	17′	10′	34′	28′	18′			25′	22'			4′	0°	6′	30′	0°			
2	02892. 401 EACH	TRAFFIC SIGNAL SUPPORT, 44' MAST ARM WITH LUMINAIRE ARM (30' MOUNTING HEIGHT), PAINTED BLACK (POLE ONLY)	1	FORBES AVE	127+16	R	29′	17′	10′	44′	36′	24′			33′	21′	11′		7′	54°	6′	30'	45°			
<u> </u>	02892. 006 EACH	TRAFFIC SIGNAL SUPPORT, 15' TYPE X, PAINTED BLACK, POLE ONLY	1	FORBES AVE	126+56	R	28′																	15′		10′
4	02892. 009 EACH	TRAFFIC SIGNAL SUPPORT, 19' TYPE X, PAINTED BLACK, POLE ONLY	1	FORBES AVE	126+30	R	28′																	19′		10′
<u>\$</u>	02892. 005 EACH	TRAFFIC SIGNAL SUPPORT, 30' TYPE X-L WITH LUMINAIRE ARM, PAINTED BLACK	1	FORBES AVE	125+68	R	25′														6′	30′	315°	30′		10′
<u></u>	02892. 609 EACH	TRAFFIC SIGNAL SUPPORT, 15' MAST ARM, PAINTED BLACK	1	FORBES AVE	125+63	L	20′				9′				11′											10′

** REFER TO TRAFFIC STANDARDS TC-8800 SERIES FOR LETTER DESIGNATION

707 Grant Street 5th Floor Pittsburgh, PA 15219

			THE PREPARATION OF THIS DOCUMENT HAS BEEN FINANCED IN
			PART THROUGH A GRANT FROM THE
			FEDERAL TRANSIT ADMINISTRATION, U.S. DEPARTMENT OF
			TRANSPORTATION, UNDER THE
			URBAN MASS TRANSPORTATION ACT OF 1964, AS AMENDED, FOR THE
٥.	DATE	DESCRIPTION	PORT AUTHORITY OF ALLEGHENY COUNTY, PENNSYLVANIA.
		REVISIONS	COUNTY, PENNSTEVANIA.

(NOT FOR CONSTRUCTION)

ITEM NUMBER

EACH

02895.

EACH

02895. 001 VIDEO DETECTION

001 VIDEO DETECTION

DESIGNED	DWP	
DRAWN	<u>NED</u>	
CHECKED	<u>AJR</u>	
IN CHARGE	<u>JKM</u>	
DATE	05/01/24	
SCALE	-	
	AS SHOWN	

DETECTORS

SEN. NO.

 \bigcirc

2

QTY.

LOCATION

 \triangle

2

DESCRIPTION

TS-47 PORT AUTHORITY OF ALLEGHENY COUNTY

TRAFFIC SIGNAL TABULATION

FORBES AVENUE AND ARMSTRONG TUNNEL

BUS RAPID TRANSIT UPTOWN TO OAKLAND SIGNAL PLANS TRAFFIC SIGNAL TABULATIONS

CONTRACT NO. BRT-001 DWG. NO. SG97 sнт. 1157

Port Authority

TRENCH, CONDUIT, JUNCTION BOX, ELECTRICAL ITEMS

DESCRIPTION	ELECTRICAL SERVICE	CITY OF PITTSBURGH STANDARD CONCRETE JUNCTION BOX, TYPE 1	TRENCH AND BACKFILL, TYPE II	TRENCH AND BACKFILL, TYPE IV	2 INCH CONDUIT	3 INCH CONDUIT	AWG 8, UNDERGROUND CABLE, COPPER, 1 CONDUCTOR	SIGNAL CABLE, 14 AWG, 5 CONDUCTOR	SIGNAL CABLE, 14 AWG, 7 CONDUCTOR
	02896	02897	02898	02898	02899	02899	02900	02900	02900
ITEM NUMBER	002	001	002	005	002	003	001	002	003
UNIT	EACH	EACH	LF	LF	LF	LF	LF	LF	LF
LOCATION									
CC TO 6			11		22	44			
6 то 1		1	59		59	236			
1 то 🔨			22		22	44			
1 TO 2			5	30	35	70			
2 TO <u>2</u>									
2 TO 3									
3 TO <u>∕</u> 3									
3 TO <u>4</u>									
3 TO 4									
4 TO <u>√</u> \$			4		4	4			
6 TO 5		1	77		77	154			
5 то 🚖			9			9			
COMPLETE INTERSECTION	1						1320	550	1080
TOTAL	1	2	187	30	219	561	1320	550	1080

SIGNS

SYMBOL	SERIES	SIZE	AREA EACH (SQ FT)	DESCRIPTION	QUANTITY	POST MOUNTED SIGNS,	STRUCTURE MOUNTED FLAT SHEET ALUMINUM SIGN WITH STIFFENERS	
A	D3-4*	78 "X24"	13.0	700 800 Forbes Ave	1		13.0	
В	D3-4*	66 "X24 "	11.0	Armstrong Tunnel	1		11.0	
C	R5-1	30"X30"	6.3	DO NOT ENTER	2	12.6		
D	R10-11	30"X36"	7.5	NO TURN ON RED ●	3		7.5	
▣	R3-5R	30"X36"	7.5	RIGHT TURN ONLY	1		22.5	
Ē	R10-3E(MOD)	9 "X15 "	0.9	EDUCATIONAL PUSH BUTTON FOR WALK SIGNAL WITH COUNTDOWN TIMER (MOD)	6	•		
0	SPECIAL	30 "X30 "	6.3	BUS LANE SIGNAL	1		6.3	
K	R3-1(MOD)	30 "X30 "	6.3	NO RIGHT TURN - LED BLANKOUT	1			1
				TOTAL		12.6	60.3	1

▲ - INCIDENTAL TO ITEM 02895.002


* WHITE REFLECTORIZED LEGEND AND BORDER ON BLUE REFLECTORIZED BACKGROUND.
UTILIZE 4" CLEARVIEW 3W FOR BLOCK/NEIGHBORHOOD AND 8" CLEARVIEW 3W FOR
STREET NAME. ACTUAL WIDTH DETERMINED BY LETTER SPACING. COORDINATE BLOCK
NUMBERS AND STREET NAME DETAILS WITH CITY OF PITTSBURGH DEPARTMENT OF
MOBILITY AND INFRASTRUCTURE.

AECOM


Gulf Tower 707 Grant Street 5th Floor Pittsburgh, PA 15219

		THE DREPARATION OF THE
		THE PREPARATION OF THIS DOCUMENT HAS BEEN FINANCED IN
		PART THROUGH A GRANT FROM THE
		FEDERAL TRANSIT ADMINISTRATION, U.S. DEPARTMENT OF
		TRANSPORTATION, UNDER THE
		URBAN MASS TRANSPORTATION ACT OF 1964, AS AMENDED, FOR THE
DATE	DESCRIPTION	PORT AUTHORITY OF ALLEGHENY COUNTY, PENNSYLVANIA.
	REVISIONS	COUNTY, PENNSTEVANIA.

				TS-47
ESIGNED	<u>DWP</u>	PORT AUTHOR	ITY OF ALLEGHI	ENY COUNTY
DRAWN	NED	PITTSBURGH		PENNSYLVANIA
CHECKED	<u>AJR</u>	BUS RAPID TF	RANSIT UPTOWN 1	ΓΟ OAKLAND
N CHARGE	<u>JKM</u>		SIGNAL PLANS	
ATE	05/01/24	TRAF	FIC SIGNAL TABULAT	TIONS
CALE	AS SHOWN	Port Authority	CONTRACT N	O. BRT-001
	40 01 10 VVIV	connecting people to life	DWG. NO. SG98	sнт. 1158

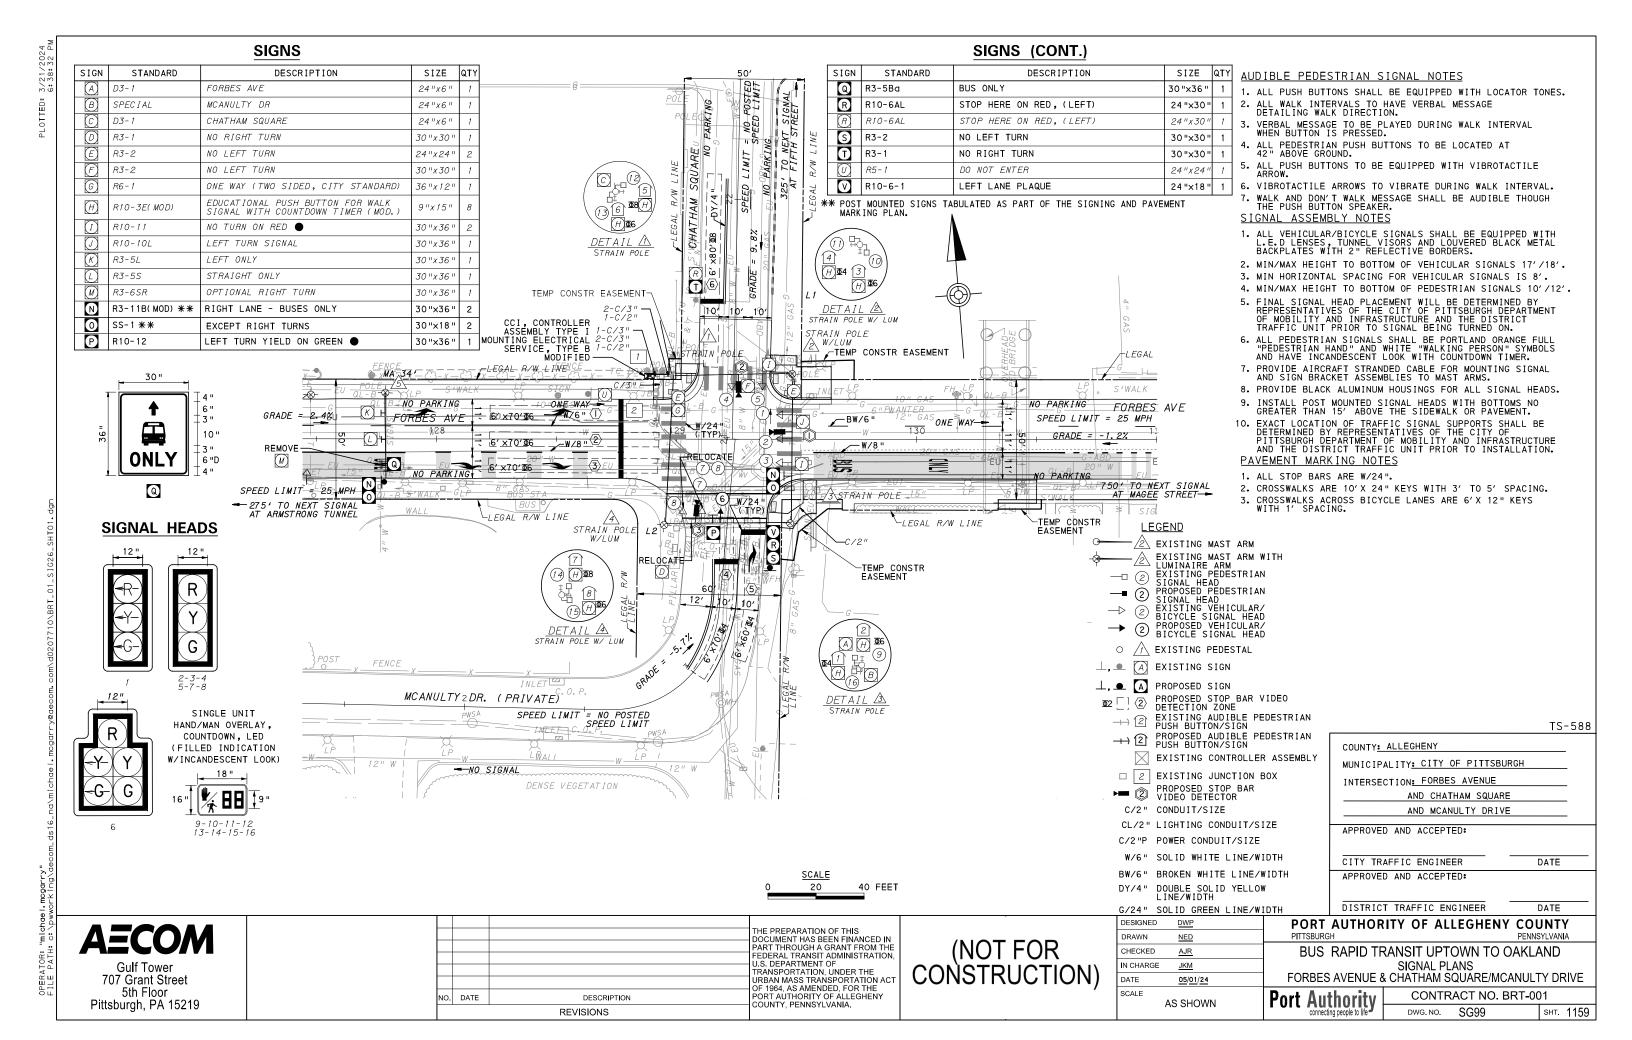

	PHASE 6						PHA	SE ·	4+8		PHASE 3+8									
	BU	US =					BUS-I						TT	-		E LASHIZG ELASHIZG				
		INT	ERV	ALS			INT	ERV	ALS			ΙNΊ	ERV.	ALS]Y				
SIGNAL	1	2	3	4	5	1	2	3	4	5	1	2	3	4	5					
1	-R-	- G-	- G-	- Y-	→R-	- R-	- R-	- R-	- R-	→R-	- R-	→R-	→R-	- R-		П				
2	R	G	G	Υ	R	R	R	R	R	R	R	R	R	R		R				
3	R	G	G	Υ	R	R	R	R	R	R	R	R	R	R		R				
4-5	R	R	R	R	R	R	G	G	Υ	R	R	R	R	R		R				
6	R	R	R	R	R	R	G	G	G	G	- G√G	- G√G	- Y-⁄Y	R		R				
7 - 8	R	R	R	R	R	R	G	G	G	G	G	G	Y	R		R				
11-12-15-16	W	W	FD	DW	DW	DW	DW	DW	DW	DW	DW	DW	DW	DW		OFF				
9-10	DW	DW	DW	DW	DW	W	W	FD	DW	DW	DW	DW	DW	DW		OFF				
13-14	DW	DW	DW	DW	DW	W	W	FD	DW	DW	W	FD	DW	DW		OFF				
FIXED	7		\geq	3.5	2.5	3		\leq	4	3		\geq	4	3		\Box				
MINIMUM	15 7				3															
PASSAGE		,	3				3 50					3								
FREE (MAX)		9	0									7				Щ				
PEDESTRIAN		7	12			7 12			7	12				\vdash						
MEMORY		MIN		L Call			PED RECA		CALL				REC	ALL		+				

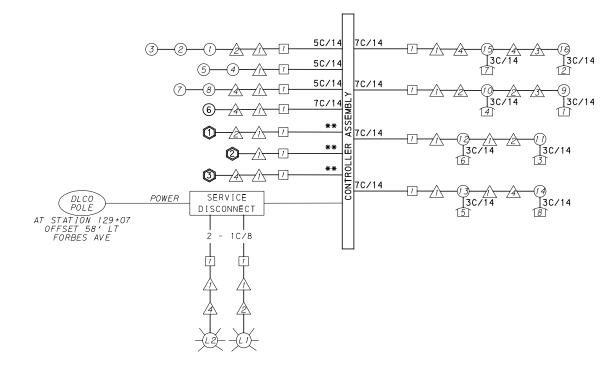

WIRING DIAGRAM

5C/14 - CABLE (NO. OF CONDUCTORS/SIZE AWG.)

EXISTING SIGNAL HEAD

1) PROPOSED SIGNAL HEAD

EXISTING AUDIBLE PEDESTRIAN INDICATOR

PROPOSED AUDIBLE PEDESTRIAN INDICATOR

EXISTING SIGNAL SUPPORT A

EXISTING JUNCTION BOX

PROPOSED SIGNAL SUPPORT
PROPOSED JUNCTION BOX

EXISTING JUNCTION BOX
EXISTING LUMINAIRE

PROPOSED LUMINAIRE

PROPOSED DETECTOR

INCIDENTAL TO ITEM 02895.001, AS PER MANUFACTURERS SPECIFICATIONS

DETECTOR ZONE INFORMATION

DETECTOR	DETECTION ZONE(S)		MODE	TYPE	ROUTE	PHASE	LOCATION MAST ARM
_							WAST AITW
	(1)\(2)\(3\) (6' x70')		(3) (6'x70') PRESENCE VIDEO (STOP BAR) FORBES AVENUE				
2	4	(6′×70′)	PRESENCE	VIDEO (STOP BAR)	MCANULTY DRIVE	4	
	5	(6′×60′)	FRESENCE	VIDEO (STOP BAK)	MCANULII DRIVE	4	
3			PRESENCE	VIDEO (STOP BAR)	CHATHAM SQUARE	8	34

GENERAL NOTES

THE CITY OF PITTSBURGH SHALL INSPECT THE NEW SIGNAL EQUIPMENT PRIOR TO ACTIVATION.

ALL TRAFFIC SIGNAL MAINTENANCE AND OPERATION RESPONSIBILITIES SHALL BE TURNED OVER TO THE CITY OF PITTSBURGH AFTER THE FOLLOWING CONDITIONS ARE IMPLEMENTED TO THE CITY'S SATISFACTION:

- 1. PERMIT "AS-BUILT" TRAFFIC SIGNAL DRAWINGS ARE SUBMITTED AND APPROVED.
- 2. ALL PUNCH LIST ITEMS ARE COMPLETED BY THE CONTRACTOR.
- 3. AFTER THE 30-DAY CONTINUOUS UNINTERRUPTED SIGNAL OPERATION WITHOUT MALFUNCTIONS.

CONSTRUCTION NOTES

- 1. ALL JUNCTION BOXES IN WALK AREAS TO BE CITY OF PITTSBURGH STANDARD CONCRETE JUNCTION BOX, TYPE 1.
- 2. ALL JUNCTION BOXES IN NON-WALK AREAS TO BE CITY STANDARD JB-2 WITH BOTTOM.
- 3. THERE SHALL BE NO SIGNAL WIRE OR FIBER CABLE SPLICING.
- 4. SERVICE WIRE FROM THE POWER SOURCE TO THE CONTROLLER CABINET SHALL BE PLACED IN SECONDARY SEPARATE CONDUIT.
- 5. STREET LIGHT CABLE IS NOT PERMITTED TO RUN THROUGH THE CONTROLLER CABINET AND SHALL BE PLACED IN SEPARATE CONDUIT.
- 6. TRAFFIC SIGNAL CABLE SHALL BE PLACED IN DEDICATED CONDUIT.
- 7. MOUNT DISCONNECT ON POLE NEAREST TO THE CONTROLLER CABINET EXCLUDING TYPE X POLES.
- 8. REMOVE AND DISPOSE OF ALL EXISTING SIGNAL WIRING NO LONGER IN USE.
- 9. REMOVE EXISTING SIGNAL EQUIPMENT NO LONGER IN USE AND RETURN TO THE CITY OF PITTSBURGH TRAFFIC CONTROL SHOP. COORDINATE DELIVERY OF EQUIPMENT WITH DELMAS MCELHANY, TRAFFIC CONTROL FOREMAN.

TS-588

_	AUTHORITY OF ALLECHENY	COLINITY
	DISTRICT TRAFFIC ENGINEER	DATE
	APPROVED AND ACCEPTED:	
	CITY TRAFFIC ENGINEER	DATE
	APPROVED AND ACCEPTED:	
	AND MCANULTY DRIVE	
	AND CHATHAM SQUARE	
	INTERSECTION: FORBES AVENUE	-
	MUNICIPALITY: CITY OF PITTSBUR	GH
	COUNTY: ALLEGHENY	
	ALL FOURNIX	

AECOM

TRANSIT PRIORITY PRE-EMPTION NOTES (TO BE INSTALLED BY OTHERS)

3. MAINTAIN ALL YELLOW CLEARANCES AT ALL TIMES.

 COORDINATE TRAFFIC CONTROLLER PROGRAMMING MODIFICATION WITH REPRESENTATIVES OF THE CITY OF PITTSBURGH AND DISTRICT TRAFFIC UNIT.

2. INCLUDE A TRANSIT PRIORITY PHASE THAT WILL EXTEND THE INDICATED PHASE A MAXIMUM OF 10 SECONDS WHEN ACTIVATED BY A PORT AUTHORITY VEHICLE. DO NOT VIOLATE SIDE STREET PEDESTRIAN MINIMUM TIMINGS.

4. PROCEED TO THE SUBSEQUENT INTERVAL AS DEFINED IN THE MOVEMENT, SEQUENCE AND TIMING DIAGRAM UPON COMPLETING THE GREEN EXTENSION INTERVAL.

5. ONCE A TRANSIT CALL IS PLACED AND SATISFIED, THE CONTROLLER WILL NOT SATISFY ANOTHER CALL FOR

6. LOCATION OF BUS DETECTORS ARE TO BE FIELD ADJUSTED TO ACHIEVE MAXIMUM OPERATION.

Gulf Tower 707 Grant Street 5th Floor Pittsburgh, PA 15219 THE PREPARATION OF THIS
DOCUMENT HAS BEEN FINANCED IN
PART THROUGH A GRANT FROM THE
FEDERAL TRANSIT ADMINISTRATION,
U.S. DEPARTMENT OF
TRANSPORTATION, UNDER THE
URBAN MASS TRANSPORTATION ACT
OF 1964, AS AMENDED, FOR THE
PORT AUTHORITY OF ALLEGHENY
COUNTY, PENNSYLVANIA.

(NOT FOR CONSTRUCTION)

ESIGNED	DWP	
RAWN	<u>NED</u>	
HECKED	<u>AJR</u>	
CHARGE	<u>JKM</u>	
ATE	05/01/24	
CALE		
	AS SHOWN	

PORT AUTHORITY OF ALLEGHENY COUNTY
PITTSBURGH

BUS RAPID TRANSIT UPTOWN TO OAKLAND

BUS RAPID TRANSIT UPTOWN TO OAKLAND SIGNAL PLANS WIRING, MOVEMENT, PHASING & SEQUENCE DIAGRAMS

Port Authority

CONTRACT NO. BRT-001

DWG. NO. SG100 SHT. 1160

FORBES AVENUE AND CHATHAM SQUARE AND MCANULTY DRIVE

I TEM NUMBER	MISC	ELLAN	EOUS	
UNIT	DESCRIPTION	QTY.	LOCATION	REMARKS
01882. 002	TRAFFIC SIGNAL TIMING MODIFICATIONS	2	СС	
EACH				
02890.	TRAFFIC SIGNAL CONTROLLER ASSEMBLY, TYPE 2070 LC IN EXISTING CABINET	1	СС	332 CONTROLLER CABINET 8" RISER
EACH				RE-ESTABLISH INTERCONNECT
02890.	ETHERNET SWITCH	1	CC	
EACH				
02890 . 005	GPS TIME CLOCK	1	СС	
EACH				
02894	RESET VEHICULAR SIGNAL HEAD	2	78	
EACH				
02894. 003 EACH	VEHICULAR SIGNAL HEAD, FIVE 12" SECTIONS	1	6	BLACK TUNNEL VISORS BLACK ALUMINUM HOUSINGS BLACK METAL LOUVERED BACKPLATE

DETECTORS

ITEM NUMBER	DESCRIPTION	SEN. NO.	QTY.	LOCATION
02895 . 001	VIDEO DETECTION	(1)	1	2 3
EACH				
02895 . 001	VIDEO DETECTION	(2)	1	1 /2
EACH				
02895. 001	VIDEO DETECTION	(3)	1	/3\/4\
EACH				

TRAFFIC SIGNAL SUPPORTS **

	≅a				NO		_		MAST ARM										PEDESTAL							
POLE NO.	ITEM	DESCRIPTION	QTY.	ROUTE	TATIO	SIDE	FFSE		ARI				ARM								Af	ARM "C"		SHAFT	SIG	NAL
					SI		吊	н	K		SIGN	IGNAL LOCATION		S	IGN	LOCA	AT I OI	N	w	G	x	7	Н	м	N	
	UNIT										М	N	0	Р	R	S	T	U	Y							
\triangle		TRAFFIC SIGNAL SUPPORT, 24' STRAIN POLE	1	FORBES AVE	128+99	L	26 '	24'	10 '	59 ′																
2		TRAFFIC SIGNAL SUPPORT, 24' STRAIN POLE WITH LUMINAIRE ARM	1	FORBES AVE	129+48	L	27 '	24'	10 '	47 ′	23′	11'			19 '	7′		1				30 ʻ	45°			
<u> </u>		TRAFFIC SIGNAL SUPPORT, 24' STRAIN POLE	1	MCANULTY DR	3+67	R	26 '	24'	10'	59 ′	43'	34 ′	24′		41'	22'	18′									
4		TRAFFIC SIGNAL SUPPORT, 24' STRAIN POLE WITH LUMINAIRE ARM	1	MCANULTY DR	3+62	L	26 '	24'	10 '	50′	23′	15'	7′		20′	9′						30 '	45°			
<u> </u>		TRAFFIC SIGNAL SUPPORT, 34' MAST ARM	1	FORBES AVE	127+79	R	19 '	17 '		34 ′					30′	18'	7′			0°						

** REFER TO TRAFFIC STANDARDS TC-8800 SERIES FOR LETTER DESIGNATION

TS-588

AECOM Gulf Tower 707 Grant Street 5th Floor Pittsburgh, PA 15219

		THE PREPARATION OF THIS DOCUMENT HAS BEEN FINANCED IN PART THROUGH A GRANT FROM TH FEDERAL TRANSIT ADMINISTRATION U.S. DEPARTMENT OF TRANSPORTATION, UNDER THE URBAN MASS TRANSPORTATION AC
DATE	DESCRIPTION	OF 1964, AS AMENDED, FOR THE PORT AUTHORITY OF ALLEGHENY COUNTY, PENNSYLVANIA.
	REVISIONS	COUNTY, FEMING FLVAINIA.

					15-588						
ESIGNED	<u>DWP</u>	PORT AUTHOR	ITY OF AL	LEGHENY COL	YTNU						
RAWN	<u>NED</u>	PITTSBURGH		PENN	SYLVAN I A						
HECKED	<u>AJR</u>	BUS RAPID TRANSIT UPTOWN TO OAKLAND									
CHARGE	<u>JKM</u>		SIGNAL PL								
ATE	<u>05/01/24</u>	TRAF	FIC SIGNAL T	ABULATIONS							
CALE	AS SHOWN	Port Authority CONTRACT NO. BRT-001									
	AS SHOWN	connecting people to life	DWG. NO.	SG101	sнт. 1161						

TRENCH, CONDUIT, JUNCTION BOX, ELECTRICAL ITEMS


DESCRIPTION	ELECTRICAL SERVICE TYPE B	AWG 8, UNDERGROUND CABLE, COPPER, 1 CONDUCTOR	SIGNAL CABLE, 14 AWG, 5 CONDUCTOR	SIGNAL CABLE, 14 AWG, 7 CONDUCTOR
ITEM NUMBER	02896	02900	02900	02900
TIEM NOMBER	002	001	002	003
UNIT	EACH	LF	LF	LF
LOCATION				
COMPLETE INTERSECTION	1	380	350	800
TOTAL	1	380	350	800

SIGNS

				010110						
SYMBOL	SERIES	SIZE	AREA EACH (SQ FT)	DESCRIPTION	QUANTITY	Post MOUNTED SIGNS, TYPE B	M POST MOUNTED SIGNS, TYPE F	STRUCTURE MOUNTED FLAT SHEET ALUMINUM SIGN WITH STIFFENERS	RESET STRUCTURE MOUNTED FLAT SHEET ALUMINUM SIGN WITH STIFFENERS	REMOVE STRUCTURE MOUNTED FLAT SHEET ALUMINUM SIGN
D	R3-1	30"x30"	6.3	NO RIGHT TURN	1				1	
M	R3-1	30"x36"	7.5	OPTIONAL RIGHT TURN	1					1
P	R10-12	30"x36"	7.5	LEFT TURN YIELD ON GREEN	1			7.5		
Q	R3-5Ba	30"x36"	7.5	BUS ONLY	1			7.5		
R	R10-6AL	24"x30"	5.0	STOP HERE ON RED, (LEFT)	1		5.0			
S	R3-2	30"x30"	6.3	NO LEFT TURN	1	6.3				
Ð	R3-1	30"x30"	6.3	NO RIGHT TURN	1		6.3			
\Diamond	R10-6-1	24"×18"	3.0	LEFT LANE PLAQUE	1		3.0			
	ı	1	1	TOTAL		6.3	14.3	15.0	1	1
1										

Gulf Tower 707 Grant Street 5th Floor Pittsburgh, PA 15219 THE PREPARATION OF THIS
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TRANSPORTATION, UNDER THE
URBAN MASS TRANSPORTATION ACT
OF 1964, AS AMENDED, FOR THE
PORT AUTHORITY OF ALLEGHENY
COUNTY, PENNSYLVANIA.

				15-588			
ESIGNED	<u>DWP</u>	PORT AUTHOR	ITY OF ALLEGHENY CO	UNTY			
RAWN	NED	PITTSBURGH	PENN	NSYLVANIA			
HECKED	<u>AJR</u>	BUS RAPID TE	RANSIT UPTOWN TO OAKL	.AND			
I CHARGE JKM SIGNAL PLANS							
ATE	05/01/24	TRAF	FIC SIGNAL TABULATIONS				
CALE	AS SHOWN	Port Authority	CONTRACT NO. BRT-0	01			
	AS SHOWN	connecting people to life	DWG. NO. SG102	sнт. 1162			

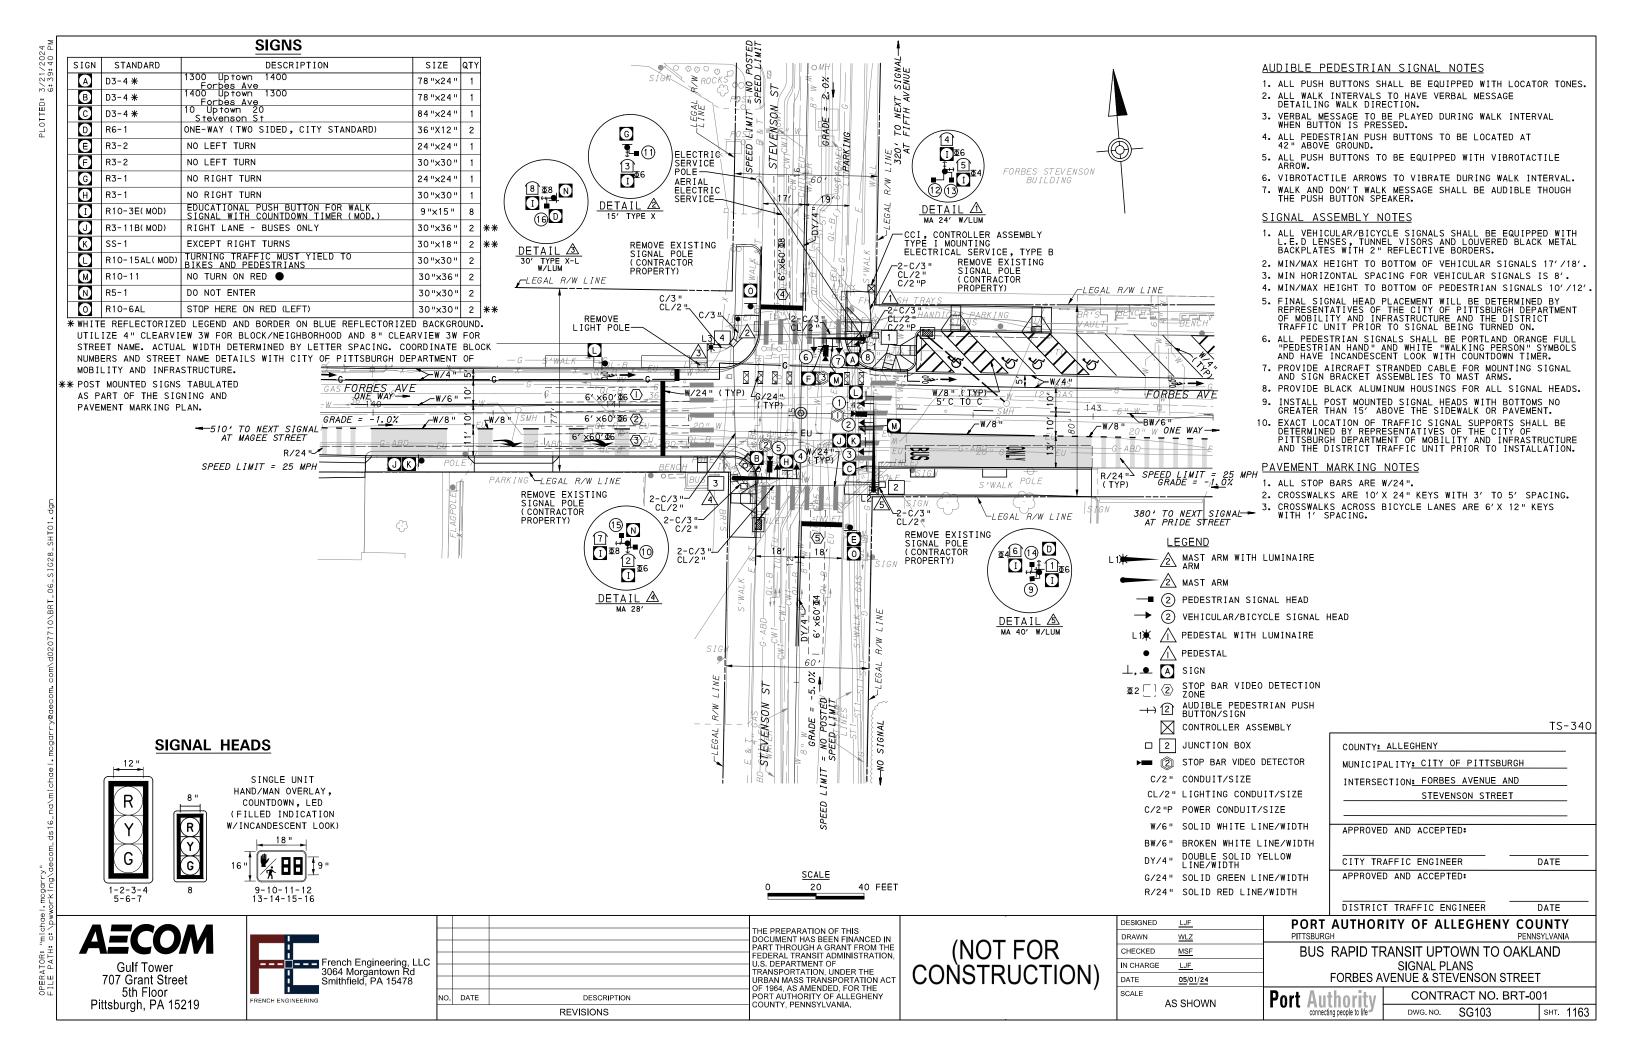


		PH	IASE	6			PHA	ASE	4+8						
	BIK		77	- <u>-</u>	-	BIK	٦i		 		MZMRMGMZCY MZMTMZG				
		INT	ERV.	ALS			INT	ΓERV	ALS		Ϋ́				
SIGNAL	1	2	3	4	5	1	2	3	4	5					
1-2-3	R	R G G			R	R	R	R	R	R	R				
4-5	R	R R R			R	R	R G		Υ	R	R				
6-7	R	R	R	R	R	R	R G		Y	R	R				
8	R	G	G	Υ	R	R	R R R		R	R	R				
9-10-11-12	W	W	FD	DW	DW	DW DW		DW	DW	DW	OFF				
13-14-15-16	DW	DW	DW	DW	DW	W W FD			DW	DW	OFF				
			L_												
FIXED	\geq	$\geq \leq$	\leq	3.5	2.5	\geq	$\geq \leq$	\leq	4	3					
MINIMUM			0					0							
PASSAGE		_	3				,	3							
FREE (MAX)		3	4				2	8							
PEDESTRIAN	3	4	13			3	4	14							
MEMORY		MIN	REC	ALL			PED	REC	ALL						

TRANSIT PRIORITY PRE-EMPTION NOTES (TO BE INSTALLED BY OTHERS)

- COORDINATE TRAFFIC CONTROLLER PROGRAMMING MODIFICATION WITH REPRESENTATIVES OF THE CITY OF PITTSBURGH AND DISTRICT TRAFFIC UNIT.
- 2. INCLUDE A TRANSIT PRIORITY PHASE THAT WILL EXTEND THE INDICATED PHASE A MAXIMUM OF 10 SECONDS WHEN ACTIVATED BY A PORT AUTHORITY VEHICLE. DO NOT VIOLATE SIDE STREET PEDESTRIAN MINIMUM TIMINGS.
- 3. MAINTAIN ALL YELLOW CLEARANCES AT ALL TIMES.
- 4. PROCEED TO THE SUBSEQUENT INTERVAL AS DEFINED IN THE MOVEMENT, SEQUENCE AND TIMING DIAGRAM UPON COMPLETING THE GREEN EXTENSION INTERVAL.
- 5. ONCE A TRANSIT CALL IS PLACED AND SATISFIED, THE CONTROLLER WILL NOT SATISFY ANOTHER CALL FOR
- 6. LOCATION OF BUS DETECTORS ARE TO BE FIELD ADJUSTED TO ACHIEVE MAXIMUM OPERATION.

DETECTOR ZONE INFORMATION

DETECTOR	DETECTION	MODE	TYPE	ROUTE	PHASE	LOCATION
DETECTOR	ZONE(S)	MODE	IIFC	ROUTE	FHASE	MAST ARM
0	1 2 3 (6' x60')	PRESENCE	VIDEO (STOP BAR)	FORBES AVENUE	6	Æ
0	<a>⟨4⟩ (6′ x60′)	PRESENCE	VIDEO (STOP BAR)	STEVENSON STREET	8	4
3	⟨5⟩ (6′ ×60′)	PRESENCE	VIDEO (STOP BAR)	STEVENSON STREET	4	\triangle

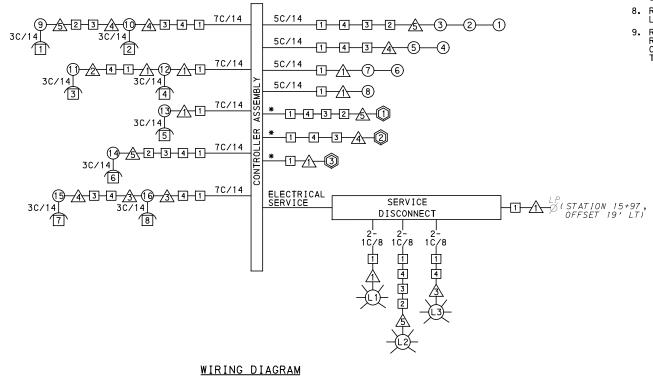

5C/14 - CABLE (NO. OF CONDUCTORS/SIZE AWG.)

PROPOSED DETECTOR 1) PROPOSED SIGNAL HEAD

PROPOSED AUDIBLE

PEDESTRIAN INDICATOR A PROPOSED SIGNAL SUPPORT

PROPOSED LUMINAIRE 1 PROPOSED JUNCTION BOX

3C/14 INCIDENTAL TO ITEM 02895.002

*INCIDENTAL TO ITEM 02895.001, AS PER MANUFACTURERS SPECIFICATIONS

AECOM

Gulf Tower 707 Grant Street 5th Floor Pittsburgh, PA 15219



THE PREPARATION OF THIS DOCUMENT HAS BEEN FINANCED IN PART THROUGH A GRANT FROM THE FEDERAL TRANSIT ADMINISTRATION U.S. DEPARTMENT OF TRANSPORTATION, UNDER THE URBAN MASS TRANSPORTATION ACT OF 1964 AS AMENDED FOR THE NO. DATE DESCRIPTION COUNTY, PENNSYLVANIA. REVISIONS

(NOT FOR CONSTRUCTION)

DESIGNED	<u>LJF</u>	
DRAWN	<u>WLZ</u>	
CHECKED	MSF	
N CHARGE	<u>LJF</u>	
DATE	05/01/24	
SCALE		
	AS SHOWN	

GENERAL NOTES

THE CITY OF PITTSBURGH SHALL INSPECT THE NEW SIGNAL EQUIPMENT PRIOR TO ACTIVATION.

ALL TRAFFIC SIGNAL MAINTENANCE AND OPERATION RESPONSIBILITIES SHALL BE TURNED OVER TO THE CITY OF PITTSBURGH AFTER THE FOLLOWING CONDITIONS ARE IMPLEMENTED TO THE CITY'S SATISFACTION:

- 1. PERMIT "AS-BUILT" TRAFFIC SIGNAL DRAWINGS ARE SUBMITTED AND APPROVED.
- 2. ALL PUNCH LIST ITEMS ARE COMPLETED BY THE CONTRACTOR.
- 3. AFTER THE 30-DAY CONTINUOUS UNINTERRUPTED SIGNAL OPERATION WITHOUT MALFUNCTIONS.

CONSTRUCTION NOTES

- 1. ALL JUNCTION BOXES IN WALK AREAS TO BE CITY OF PITTSBURGH STANDARD CONCRETE JUNCTION BOX, TYPE 1.
- 2. ALL JUNCTION BOXES IN NON-WALK AREAS TO BE CITY STANDARD JB-2 WITH BOTTOM.
- 3. THERE SHALL BE NO SIGNAL WIRE OR FIBER CABLE SPLICING.
- 4. SERVICE WIRE FROM THE POWER SOURCE TO THE CONTROLLER CABINET SHALL BE PLACED IN SECONDARY SEPARATE CONDUIT.
- 5. STREET LIGHT CABLE IS NOT PERMITTED TO RUN THROUGH THE CONTROLLER CABINET AND SHALL BE PLACED IN SEPARATE CONDUIT.
- 6. TRAFFIC SIGNAL CABLE SHALL BE PLACED IN DEDICATED
- 7. MOUNT DISCONNECT ON POLE NEAREST TO THE CONTROLLER CABINET EXCLUDING TYPE X POLES. 8. REMOVE AND DISPOSE OF ALL EXISTING SIGNAL WIRING NO
- 9. REMOVE EXISTING SIGNAL EQUIPMENT NO LONGER IN USE AND RETURN TO THE CITY OF PITTSBURGH TRAFFIC CONTROL SHOP. COORDINATE DELIVERY OF EQUIPMENT WITH DELMAS MCELHANY, TRAFFIC CONTROL FOREMAN.

TS-340 COUNTY: ALLEGHENY MUNICIPALITY: CITY OF PITTSBURGH INTERSECTION: FORBES AVENUE AND STEVENSON STREET APPROVED AND ACCEPTED: CITY TRAFFIC ENGINEER DATE APPROVED AND ACCEPTED:

DISTRICT TRAFFIC ENGINEER DATE PORT AUTHORITY OF ALLEGHENY COUNTY PITTSBURGH PENNSYLVANIA

BUS RAPID TRANSIT UPTOWN TO OAKLAND SIGNAL PLANS WIRING, MOVEMENT, PHASING & SEQUENCE DIAGRAMS

CONTRACT NO. BRT-001 Port Authority DWG. NO. SG104 sнт. 1164

FORBES AVENUE AND STEVENSON STREET

I TEM NUMBER	MISCELL	ANEO	US	
UNIT	DESCRIPTION	QTY.	LOCATION	REMARKS
01882. 002 EACH	TRAFFIC SIGNAL TIMING MODIFICATIONS	2	СС	
02212. 009 LF	POLE FOUNDATION DRILLING, LESS THAN 30" DIAMETER	15	2 3	
02212. 010 LF	POLE FOUNDATION DRILLING, 30" DIAMETER OR GREATER	36	1 4 5	
02889. 002 EACH	LED LUMINAIRE CITY STANDARD, BLACK	3	英女	<u> </u>
02890. 001 EACH	TRAFFIC SIGNAL CONTROLLER ASSEMBLY, TYPE 2070 LC WITH TYPE 332 BASE MOUNTED CABINET	1	СС	332 CONTROLLER CABINET 8 " RISER RE-ESTABLISH INTERCONNECT
02890. 003 EACH	ETHERNET SWITCH	1	СС	
02890. 005 EACH	GPS TIME CLOCK	1	СС	
02893. 001 EACH	REMOVE EXISTING POLE	1	STATION 141+37 OFFSET: 19' LT	EXISTING LIGHT POLE
02894. 001 EACH	VEHICULAR SIGNAL HEAD, THREE 12" SECTIONS	7	123 4567	BLACK TUNNEL VISORS BLACK ALUMINUM HOUSINGS BLACK METAL LOUVERED BACKPLATE
02894. 005 EACH	LED COUNTDOWN PEDESTRIAN SIGNAL HEAD, TYPE A	8	9000 13191516	BLACK TUNNEL VISORS BLACK ALUMINUM HOUSINGS
02894. 006 EACH	VEHICULAR SIGNAL HEAD, THREE 8 " SECTIONS	1	8	BLACK TUNNEL VISORS BLACK ALUMINUM HOUSINGS BLACK METAL LOUVERED BACKPLATE
02895. 002 EACH	ACCESSIBLE PEDESTRIAN SIGNALS	8	11234 5678	

DETECTORS

ITEM NUMBER	DESCRIPTION	SEN. NO.	QTY.	LOCATION
02895 . 001	VIDEO DETECTION		1	/ 5\
EACH		~		
02895 . 001	VIDEO DETECTION	②	1	A
EACH		~		<u> </u>
02895.	VIDEO DETECTION	(3)	1	\wedge
EACH		_		

TRAFFIC SIGNAL SUPPORTS **

	TRAFFIC SIGNAL SUFFORTS **																											
POLE	DESCRIPTION		EEN TOTAL OF THE EEN TO		DOUTE	NOI.	믬	SET							MAST											ESTAL		
POLE NO.	DESCRIPTION	ρ	ROUTE	STAT	SII	OFF	l l l							ARM			ARM "A"						AF	ARM "C	· ·	SHAFT	SIGN	AL
				ν			Н	K	SIGN	K SIGNAL LOCA		SIGNAL LOCATION				SIGN LOCATION			١	w	G	X	7	н	м	N		
	UNIT									М	N	0	Р	R	S	Т	U	Υ		L								
\triangle	02892. TRAFFIC SIGNAL SUPPORT, 24' MAST ARM WITH LUMINAIRE ARM (30' MOUNTING HEIGHT), EACH	1	STEVENSON ST	15+31	RT	25.5′	17′	10′	24′	20′	9′	ó		16′	12′			4′	0°	6′	30′	90°						
<u>^</u>	02892. 003 EACH TRAFFIC SIGNAL SUPPORT, 15' TYPE X, PAINTED BLACK	1	STEVENSON ST	15+39	LT	27′																	15′		10′			
<u>3</u>	02892. 005 EACH TRAFFIC SIGNAL SUPPORT, 30' TYPE X-L WITH LUMINAIRE ARM, PAINTED BLACK	1	FORBES AVE	141+40	LT	27′														6′	30′	0°	30′		10′			
<u> </u>	02892. 604 TRAFFIC SIGNAL SUPPORT, 28' MAST ARM, PAINTED BLACK	1	FORBES AVE	141+50	RT	27′	17′	10′	28′	25′	17′			21′				8′	270°									
Ś	02892. TRAFFIC SIGNAL SUPPORT, 40' MAST ARM WITH LUMINAIRE ARM (30' MOUNTING HEIGHT), EACH PAINTED BLACK	1	FORBES AVE	142+09	RT	32′	17′	10′	40′	35′	27′	15′		38′	24′	19′		9′	0°	6′	30′	0°						

^{**} REFER TO PENNDOT TC-8800 TRAFFIC STANDARDS-SIGNALS FOR LETTER DESIGNATION

TS-340

Gulf Tower 707 Grant Street 5th Floor Pittsburgh, PA 15219



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NO. DATE
DESCRIPTION
REVISIONS

THE PREPARATION OF THIS
POPARTMENT OF THIS
COUNTY, PENNSYLVANIA.

					12.	- 340						
DESIGNED	LJF	PORT AUTHOR	ITY OF AL	LEGHENY COL	JNT	7						
DRAWN	WLZ	PITTSBURGH		PENN	SYLVANI	Α						
CHECKED	MSF	BUS RAPID TE	RANSIT UPT	OWN TO OAKL	AND							
IN CHARGE	LJF	SIGNAL PLANS										
DATE	05/01/24	TRAF	FIC SIGNAL T	ABULATIONS								
SCALE	AS SHOWN	Port Authority	CONTR	ACT NO. BRT-00	01							
′	O OI IOVVIV	connecting people to life	DWG, NO.	SG105	SHT.	1165						

TRENCH, CONDUIT, JUNCTION BOX, ELECTRICAL ITEMS

DESCRIPTION	ELECTRICAL SERVICE TYPE B	CITY OF PITTSBURGH STANDARD CONCRETE JUNCTION BOX, TYPE 1	TRENCH AND BACKFILL, TYPE II	TRENCH AND BACKFILL, TYPE IV	2 INCH CONDUIT	3 INCH CONDUIT	AWG 8, UNDERGROUND CABLE, COPPER, 1 CONDUCTOR	SIGNAL CABLE, 14 AWG, 5 CONDUCTOR	SIGNAL CABLE, 14 AWG, 7 CONDUCTOR
ITEM NUMBER	02896	02897	02898	02898	02899	02899	02900	02900	02900
TTEM NOMBER	002	001	002	005	002	003	001	002	003
UNIT	EACH	EACH	LF	LF	LF	LF	LF	LF	LF
LOCATION									
CC TO 1		1	20		40	40			
1 TO 4		1	24	36	60	120			
2 TO 3		2	21	37	58	116			
3 TO 4			22	38	60	120			
то 1			5		10	10			
<u>∕2</u> TO 4			11			11			
<u>∕3</u> TO 4			11		11	11			
_4 то з			5		5	10			
			6		6	12			
COMPLETE INTERSECTION	1						970	710	995
TOTAL	1	4	125	111	250	450	970	710	995

SIGNS

SYMBOL	SERIES	SIZE	AREA EACH (SQ FT)	DESCRIPTION	QUANTITY	POST MOUNTED SIGNS, TYPE B	02891,003 POST MOUNTED SIGNS, TYPE F	02891,007 STRUCTURE MOUNTED FLAT SHEET ALUMINUM SIGNS WITH STIFFENERS
	D7 4 W	70 11 20 4 11	17.0	1300 Uptown 1400	•	SF	SF	SF 17 0
A	D3-4 *	78 "X24 "	13.0	Forbes Ave	1			13.0
В	D3-4 *	78 "X24 "	13.0	Forbes Ave	1			13.0
C	D3-4 *	84"X24"	14.0	10 Uptown 20 Stevenson St	1			14.0
D	R6-1	36 "X12 "	3.0	ONE-WAY (TWO SIDED, CITY STANDARD)	2		6.0	
E	R3-2	24"×24"	4.0	NO LEFT TURN	1		4.0	
F	R3-2	30"x30"	6.3	NO LEFT TURN	1			6.3
G	R3-1	24"×24"	4.0	NO RIGHT TURN	1		4.0	
Ð	R3-1	30"x30"	6.3	NO RIGHT TURN	1			6.3
1	R10-3E(MOD)	9"×15"	0.9	EDUCATIONAL PUSH BUTTON FOR WALK SIGNAL WITH COUNTDOWN TIMER (MOD.)	8		A	
J	R3-11B(MOD)	30"×36"	7.5	RIGHT LANE - BUSES ONLY	1			7.5
K	SS-1	30"×18"	3.8	EXCEPT BUSES	1			3.8
L	R10-15AL(MOD)	30"x30"	6.3	TURNING TRAFFIC MUST YIELD TO BIKES AND PEDESTRIANS	2	6.3		6.3
M	R10-11	30 "X36 "	7.5	NO TURN ON RED ●	2			15.0
N	R5-1	30"X30"	6.3	DO NOT ENTER	2		12.6	
				TOTAL		6.3	26.6	85.2

▲ - INCIDENTAL TO ITEM 02895.002

* WHITE REFLECTORIZED LEGEND AND BORDER ON BLUE REFLECTORIZED BACKGROUND.
UTILIZE 4" CLEARVIEW 3W FOR BLOCK/NEIGHBORHOOD AND 8" CLEARVIEW 3W FOR
STREET NAME. ACTUAL WIDTH DETERMINED BY LETTER SPACING. COORDINATE BLOCK
NUMBERS AND STREET NAME DETAILS WITH CITY OF PITTSBURGH DEPARTMENT OF
MOBILITY AND INFRASTRUCTURE.


AECOM Gulf Tower 707 Grant Street 5th Floor

Pittsburgh, PA 15219



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PORT AUTHORITY OF ALLEGHENY
COUNTY, PENNSYLVANIA. NO. DATE DESCRIPTION REVISIONS

					TS-340
ESIGNED	<u>LJF</u>	PORT AUTHOR	ITY OF ALLE	GHENY COL	JNTY
RAWN	<u>WLZ</u>	PITTSBURGH		PENNS	YLVANIA
HECKED	MSF	BUS RAPID TF	RANSIT UPTOW	/N TO OAKLA	AND
CHARGE	<u>LJF</u>		SIGNAL PLANS	S	
ATE	05/01/24	TRAF	FIC SIGNAL TABU	JLATIONS	
CALE	AS SHOWN	Port Authority	CONTRAC	T NO. BRT-00)1
	AS SHOWN	connecting people to life	DWG. NO. S(G106	sнт. 1166

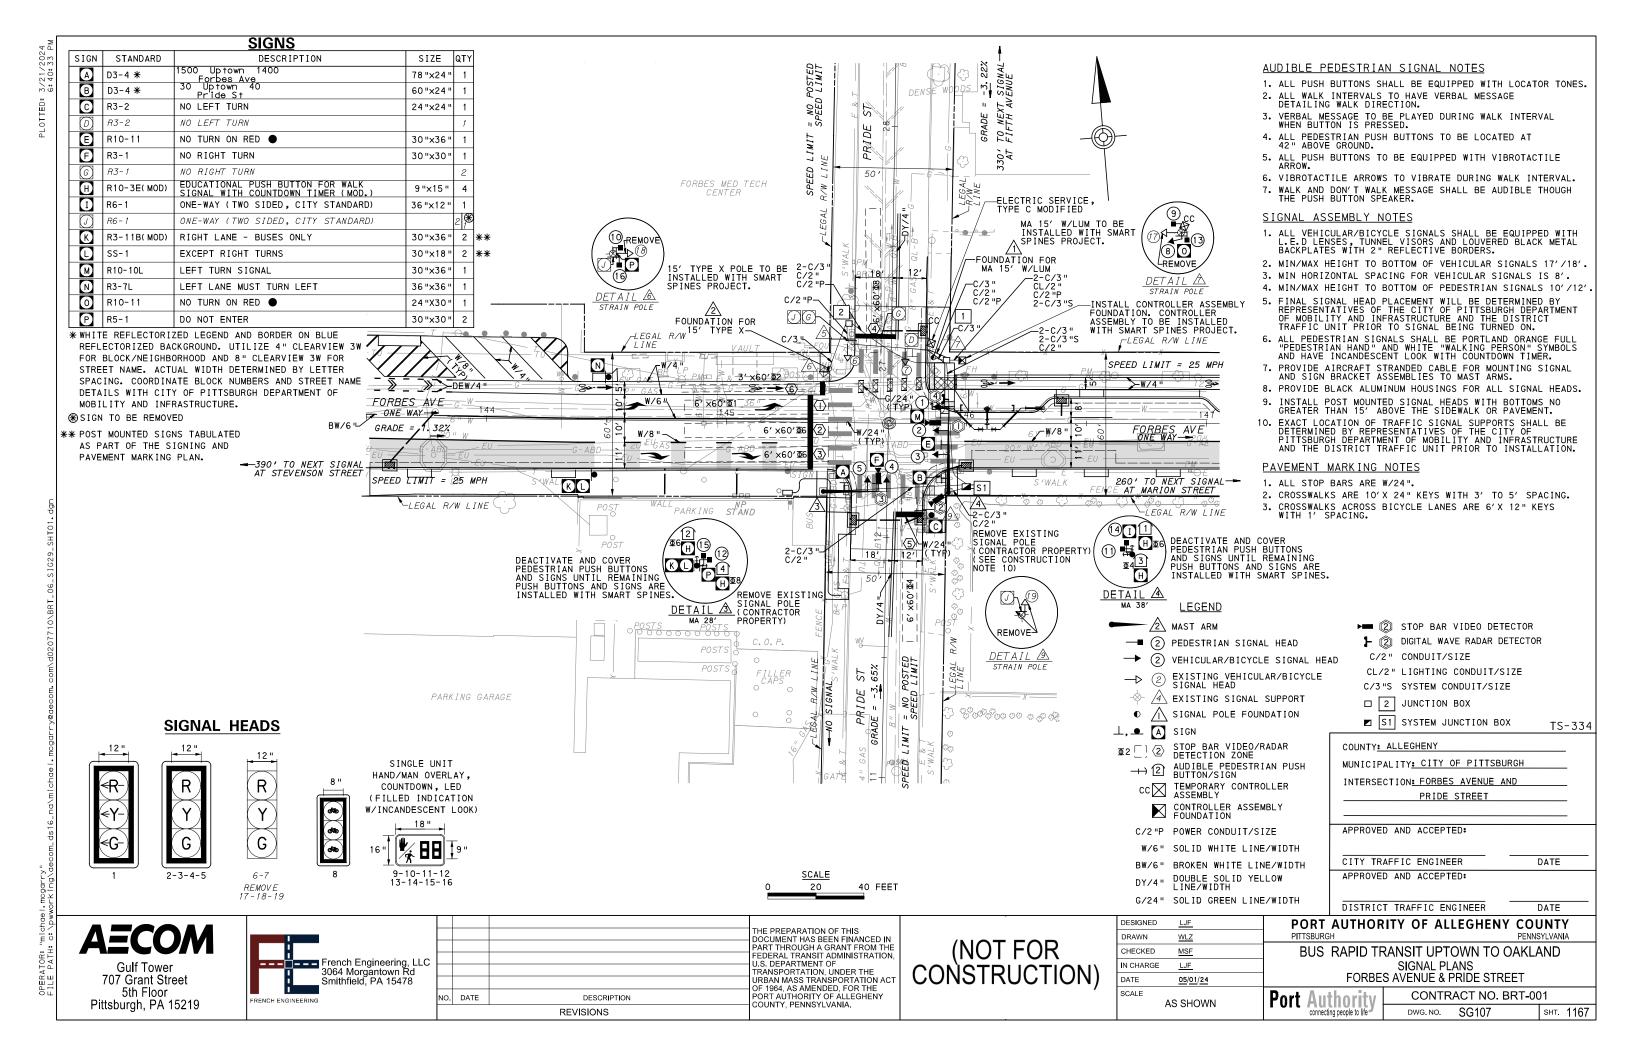

		PHA	SE	4+8			PHA	SE a	2+6			PHA	ASE	1+6		
	BIK	.E.T.I.I.I.I.I.I.I.I.I.I.I.I.I.I.I.I.I.I			L		ŘĒ— — US— – –	-}-		- -		/E- 		<i>)</i> = -	- -	HLANHIZG FLANHIZG
		INT	ERV.	ALS			INT	ERV	ALS			INI	TERV	ALS		Ϋ́
SIGNAL	1	2	3	4	5	1	2	3	4	5	1	2	3	4	5	
1	←R-	<r−< td=""><td>←R−</td><td>←R-</td><td>←R−</td><td>←R−</td><td>←R-</td><td>←R−</td><td>←R−</td><td></td><td>←G−</td><td>←G-</td><td>←Y−</td><td>←R−</td><td></td><td>0FF</td></r−<>	← R−	←R-	← R−	← R−	←R-	← R−	← R−		← G−	← G-	← Y−	← R−		0FF
2-3	R	R	R	R	R	G	G	ΥŒ	RÛ		G	G	Υ	R		R
4-5	R	G	G	Υ	R	R	R	R	R		R	R	R	R		R
6-7	R	G	G	Υ	R	R	R	R	R		R	R	R	R		R
8	R	R	R	R	R	G	G	Υ	R		R	R	R	R		R
9-10	DW	DW	DW	DW	DW	W	FD	DW	DW		DW	DW	DW	DW		0FF
11-12	DW	DW	DW	DW	DW	W	FD2	bw2	DWQ		W	FD	DW	DW		0FF
13-14-15-16	W	W	FD	DW	DW	DW	DW	DW	DW		DW	DW	DW	DW		0FF
FIXED		><	\leq	3.5	2.5	\wedge	\leq	3.5	2.5		\geq	\leq	3.5	2.5		
MINIMUM		1	0				5				1	0				
PASSAGE		3	3								3	3				
FREE (MAX)		2	1			5	7				4	7				1
]
PEDESTRIAN	3	4	12			7	10				7	10				
MEMORY		PED	REC	ALL			PED	REC	ALL			NON-	-LOC	KING	:]


- 1) G IF FOLLOWED BY 1+6.
- 2 W IF FOLLOWED BY 1+6.

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DETECTOR ZONE INFORMATION

DETECTOR	DETECTION ZONE(S)	MODE	TYPE	ROUTE	PHASE	LOCATION MAST ARM
	(6' x60')	PRESENCE	VIDEO (STOP BAR)	FORBES AVENUE	1	A
	②③ (6'x60')	PRESENCE	VIDEO (STOP BAR)	FORBES AVENUE	6	74
0	(5) (6'x60')	PRESENCE	VIDEO (STOP BAR)	PRIDE STREET	4	4
③	(4) (6' x60')	PRESENCE	VIDEO (STOP BAR)	PRIDE STREET	8	<u>A</u>
(4)	⑥ (3′x60′)	PRESENCE	RADAR (STOP BAR)	PRIDE STREET	2	4



WIRING DIAGRAM

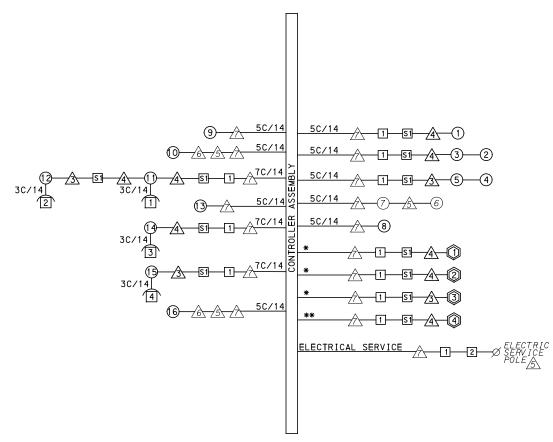5C/14 - CABLE (NO. OF CONDUCTORS/SIZE AWG.)

- PROPOSED DETECTOR
- 1) PROPOSED SIGNAL HEAD
- PEDESTRIAN INDICATOR
 - ↑ PROPOSED SIGNAL SUPPORT
- 1 PROPOSED JUNCTION BOX A EXISTING SIGNAL SUPPORT
- (1) EXISTING SIGNAL HEAD

3C/14 INCIDENTAL TO ITEM 02895.002

- *INCIDENTAL TO ITEM 02895.001, AS PER MANUFACTURERS SPECIFICATIONS
- ** INCIDENTAL TO ITEM 02895.005, AS PER MANUFACTURERS SPECIFICATIONS

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- 3. AFTER THE 30-DAY CONTINUOUS UNINTERRUPTED SIGNAL OPERATION WITHOUT MALFUNCTIONS.

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- 2. ALL JUNCTION BOXES IN NON-WALK AREAS TO BE CITY STANDARD JB-2 WITH BOTTOM.
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- 5. STREET LIGHT CABLE IS NOT PERMITTED TO RUN THROUGH THE CONTROLLER CABINET AND SHALL BE PLACED IN SEPARATE CONDUIT.
- 6. TRAFFIC SIGNAL CABLE SHALL BE PLACED IN DEDICATED
- 7. MOUNT DISCONNECT ON POLE NEAREST TO THE CONTROLLER CABINET EXCLUDING TYPE X POLES.
- 8. REMOVE AND DISPOSE OF ALL EXISTING SIGNAL WIRING NO
- 9. REMOVE EXISTING SIGNAL EQUIPMENT NO LONGER IN USE AND RETURN TO THE CITY OF PITTSBURGH TRAFFIC CONTROL SHOP. COORDINATE DELIVERY OF EQUIPMENT WITH DELMAS MCELHANY, TRAFFIC CONTROL FOREMAN.
- 10. SEE 01720 UTILITY COORDINATION FOR INFORMATION ON RELOCATION OF EXISTING SECURITY CAMERAS AND SHOT SPOTTERS.
- 11. PROVIDE ENOUGH CABLE SLACK IN JB #1 TO ENABLE FUTURE REWIRING OF SIGNAL BASED ON BASE MOUNTED CABINET FOUNDATION LOCATION.

TS-334 COUNTY: ALLEGHENY

0001111	
MUNICIPALITY: CITY OF PITTSBUR	GH
INTERSECTION: FORBES AVENUE AN	D
PRIDE STREET	
APPROVED AND ACCEPTED:	
CITY TRAFFIC ENGINEER	DATE
APPROVED AND ACCEPTED:	

DISTRICT TRAFFIC ENGINEER

DATE

PORT AUTHORITY OF ALLEGHENY COUNTY PITTSBURGH PENNSYLVANIA BUS RAPID TRANSIT UPTOWN TO OAKLAND

SIGNAL PLANS WIRING, MOVEMENT, PHASING & SEQUENCE DIAGRAMS

Port Authority

CONTRACT NO. BRT-001 DWG. NO. SG108 sнт. 1168

AECOM

Gulf Tower 707 Grant Street 5th Floor Pittsburgh, PA 15219



THE PREPARATION OF THIS DOCUMENT HAS BEEN FINANCED IN PART THROUGH A GRANT FROM THE FEDERAL TRANSIT ADMINISTRATION U.S. DEPARTMENT OF TRANSPORTATION, UNDER THE URBAN MASS TRANSPORTATION ACT OF 1964 AS AMENDED FOR THE NO. DATE DESCRIPTION COUNTY, PENNSYLVANIA. REVISIONS

(NOT FOR CONSTRUCTION) DESIGNED

CHECKED

N CHARGE

WLZ

MSF

LJF

05/01/24

AS SHOWN

RAWN

DATE

SCALE

ITEM NUMBER	MISCELL	.ANEO	US	
UNIT	DESCRIPTION	QTY.	LOCATION	REMARKS
01882. 002 EACH	TRAFFIC SIGNAL TIMING MODIFICATIONS	2	CC	
02212. 009 LF	POLE FOUNDATION DRILLING, LESS THAN 30" DIAMETER	6	<u> </u>	
02212. 010 LF	POLE FOUNDATION DRILLING, 30" DIAMETER OR GREATER	34	1\3\4	
01883. 002 EACH	TEMPORARY MODIFICATION OF EXISTING TRAFFIC SIGNAL	1		
02890. 003 EACH	ETHERNET SWITCH	1	СС	
02890. 004 EACH	TEMPORARY TRAFFIC SIGNAL CONTROLLER	1	СС	
02890. 005 EACH	GPS TIME CLOCK	1	СС	
02890. 006 EACH	TRAFFIC SIGNAL CONTROLLER ASSEMBLY FOUNDATION, FUTURE INSTALLATION OF TYPE 332 BASE MOUNTED CABINET AND 8" RISER	1		ONLY INSTALL A CONTROLLER CABINET FOUNDATION AND PROPOSED CONDUITS TO FIT A FUTURE TYPE 332 CABINET AND 8" RISER.
02894- 001 EACH	VEHICULAR SIGNAL HEAD, THREE 12" SECTIONS	5	12345	BLACK TUNNEL VISORS BLACK ALUMINUM HOUSINGS BLACK METAL LOUVERED BACKPLATE
02894. 004 EACH	BICYCLE SIGNAL HEAD, THREE 8 " SECTIONS	1	8	BLACK TUNNEL VISORS BLACK ALUMINUM HOUSINGS BLACK METAL LOUVERED BACKPLATE
02894. 005 EACH	LED COUNTDOWN PEDESTRIAN SIGNAL HEAD, TYPE A	8	9000 03005 03005	BLACK TUNNEL VISORS BLACK ALUMINUM HOUSINGS
02894. 031 EACH	REMOVE VEHICULAR SIGNAL HEAD	3	789	

I TEM NUMBER												
UNIT	DESCRIPTION	QTY.	LOCATION	REMARKS								
02895. 002 EACH	ACCESSIBLE PEDESTRIAN SIGNALS	4	11234									
02899. 007 EACH	INSTALL CONDUIT TO EXISTING TRAFFIC SIGNAL SUPPORT	1	À									

FORBES AVENUE AND PRIDE STREET

DETECTORS

ITEM NUMBER	DESCRIPTION	SEN. NO.	QTY.	LOCATION
02895 . 001	VIDEO DETECTION	<u> </u>	2	4
EACH				
02895 . 001	VIDEO DETECTION	3	1	/3\
EACH				
02895 . 005	DIGITAL WAVE RADAR DETECTION	4	1	4
EACH				

TRAFFIC SIGNAL SUPPORTS **

	EM R				NO		_							MAST A	ARM										STRA	IN P	DLE						PE	DESTAL	
POLE NO.	ITEM	DESCRIPTION	QΤΥ.	ROUTE	ATI	SIDE	FSE						ARM	"A "					ARM	"C "		SHAFT		SPAN	SI	GNAL	LOCA	TION	S	IGN	LOCA	TION	SHAFT	T SIGN	1AL
	UNIT				ST	0,	R	Н	К	L —	GNAL 1 N	LOCA	_	SI R	GN LOC	ATION		w	G X	Z	н	DESIGN TENSION	к	STRUCTURE TO STRUCTURE	L M	N	0	Р	R	S	т	U Y	Н	м	N
\triangle		TRAFFIC SIGNAL SUPPORT, 15' MAST ARM WITH LUMINAIRE ARM (30' MOUNTING HEIGHT), (FOUNDATION ONLY)	1	FORBES AVE	145+86	LT	27′				, , ,																								
2	02892. 008 EACH	TRAFFIC SIGNAL SUPPORT, 15' TYPE X, (FOUNDATION ONLY)	1	FORBES AVE	145+43	LT	22′																												
3	02892. 604 EACH	TRAFFIC SIGNAL SUPPORT, - 28' MAST ARM, PAINTED BLACK	1	PRIDE ST	12+19	LT	27′	17'	10′	28′ 26	5′ 18	,		22'			8′	0°																	
4	02892. 613 EACH	TRAFFIC SIGNAL SUPPORT, - 38' MAST ARM, PAINTED BLACK	1	FORBES AVE	145+92	RT	29′	17'	10′	38′ 39	5′ 25	151		32′ 1	9′		5′	0°																	
<u>\(\frac{1}{5} \)</u>		TRAFFIC SIGNAL SUPPORT STRAIN POLE		PRIDE ST	27 +09	LT	17 '																10'	<u>∕</u> 5 το <u>∕</u> 6	77' 0	,									
Â		TRAFFIC SIGNAL SUPPORT STRAIN POLE		FORBES AVE	145+42	LT	19'																10′												
À		TRAFFIC SIGNAL SUPPORT STRAIN POLE		PRIDE ST	27 +07	RT	16 '																10′	∕л то ∕ѕ .	33 ' 10	,			22'	7 '					
<u></u>		TRAFFIC SIGNAL SUPPORT STRAIN POLE		PRIDE ST	12+17	RT	16 '																												

** REFER TO PENNDOT TC-8800 TRAFFIC STANDARDS-SIGNALS FOR LETTER DESIGNATION

707 Grant Street 5th Floor Pittsburgh, PA 15219



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TRANSPORTATION, UNDER THE
URBAN MASS TRANSPORTATION ACT
OF 1964, AS AMENDED, FOR THE
PORT AUTHORITY OF ALLEGHENY
COUNTY, PENNSYLVANIA. DESCRIPTION REVISIONS

(NOT FOR CONSTRUCTION)

DESIGNED	<u>LJF</u>	
DRAWN	<u>WLZ</u>	
CHECKED	MSF	
IN CHARGE	<u>LJF</u>	
DATE	05/01/24	
SCALE		
	AS SHOWN	

TS-334 PORT AUTHORITY OF ALLEGHENY COUNTY PENNSYLVANIA

BUS RAPID TRANSIT UPTOWN TO OAKLAND

SIGNAL PLANS TRAFFIC SIGNAL TABULATIONS

Port Authority connecting people to life

CONTRACT NO. BRT-001 DWG.NO. SG109 sнт. **1169**

TRENCH, CONDUIT, JUNCTION BOX, ELECTRICAL ITEMS

DESCRIPTION	ELECTRICAL SERVICE, TYPE C (NEW)	CITY OF PITTSBURGH STANDARD CONCRETE JUNCTION BOX, TYPE 1	TRENCH AND BACKFILL, TYPE II	TRENCH AND BACKFILL, TYPE IV	2 INCH CONDUIT	3 INCH CONDUIT	2 INCH EXPOSED CONDUIT	3 INCH EXPOSED CONDUIT	SIGNAL CABLE, 14 AWG, 5 CONDUCTOR	SIGNAL CABLE, 14 AWG, 7 CONDUCTOR
ITEM NUMBER	02896	02897	02898	02898	02899	02899	02899	02899	02900	02900
TIEM NOMBER	004	001	002	005	002	003	004	005	002	003
UNIT	EACH	EACH	LF	LF	LF	LF	LF	LF	LF	LF
LOCATION										
FOUNDATION TO 1		1	7		14	28				
1 TO 2		1	12	34	92	92				
S1 TO 1			32	24	56	224				
			6			6				
			21			21				
<u></u> ₹ 10 S1			28	32	60	120				
<u>√</u> TO S1			8		8	16				
			9		18	9	30	10		
			9		9		30	20		
COMPLETE INTERSECTION	1								930	490
TOTAL	1	2	132	90	257	516	60	30	930	490

S1 - TABULATED ON SYSTEMS PLAN

SIGNS

				310113					
SYMBOL	SERIES	SIZE	AREA EACH (SQ FT)	DESCRIPTION	QUANTITY	02891,001 POST MOUNTED SIGNS, TYPE B	02891,003 POST MOUNTED SIGNS, TYPE F	02891,007 STRUCTURE MOUNTED FLAT SHEET ALUMINUM SIGNS WITH STIFFENERS	02891.032 REMOVE POST MOUNTED SIGNS, TYPE F
-				1500 115 +0.55 1400		SF	SF	SF	EACH
A	D3-4 *	78 "x24 "	13.0	1500 Uptown 1400 Forbes Ave	1			13.0	
В	D3-4 *	60"x24"	10.0	30 Uptown 40 Pride St	1			10.0	
C	R3-2	24"×24"	4.0	NO LEFT TURN	1	4.0			
E	R10-11	30"x36"	7.5	NO TURN ON RED ●	1			7.5	
F	R3-1	30"×30"	6.3	NO RIGHT TURN	1			6.3	
H	R10-3E(MOD)	9"×15"	0.9	EDUCATIONAL PUSH BUTTON FOR WALK SIGNAL WITH COUNTDOWN TIMER (MOD)	4		A		
1	R6-1	36"×12"	3.0	ONE-WAY (TWO SIDED, CITY STANDARD)	1		3.0		
	R6 - 1			ONE-WAY (TWO SIDED, CITY STANDARD)	1				1
K	R3-11B(MOD)	30"x36"	7.5	RIGHT LANE - BUSES ONLY	1		7.5		
	SS-1	30"×18"	3.8	EXCEPT RIGHT TURNS	1		3.8		
M	R10-10L	30"x36"	7.5	LEFT TURN SIGNAL	1			7.5	
N	R3-7L	36"×36"	9.0	LEFT LANE MUST TURN LEFT	1	9.0			
0	R10-11	24"×30"	5.0	NO TURN ON RED ●	1		5.0		
P	R5-1	30"×30"	6.3	DO NOT ENTER	2		12.6		
				TOTAL		13.0	31.9	44.3	1
	CIDENTAL TO IT	EN 0200E	003						

▲ - INCIDENTAL TO ITEM 02895.002

* WHITE REFLECTORIZED LEGEND AND BORDER ON BLUE REFLECTORIZED BACKGROUND.
UTILIZE 4" CLEARVIEW 3W FOR BLOCK/NEIGHBORHOOD AND 8" CLEARVIEW 3W FOR
STREET NAME. ACTUAL WIDTH DETERMINED BY LETTER SPACING. COORDINATE BLOCK
NUMBERS AND STREET NAME DETAILS WITH CITY OF PITTSBURGH DEPARTMENT OF
MOBILITY AND INFRASTRUCTURE.

Gulf Tower
707 Grant Street
5th Floor

Pittsburgh, PA 15219




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PORT AUTHORITY OF ALLEGHENY
COUNTY, PENNSYLVANIA.

(NOT FOR CONSTRUCTION)

				10 00 1
ESIGNED	<u>LJF</u>	PORT AUTHOR	ITY OF ALLEGHEN	NY COUNTY
DRAWN	WLZ	PITTSBURGH		PENNSYLVANIA
CHECKED	MSF	BUS RAPID TF	RANSIT UPTOWN TO	OAKLAND
N CHARGE	<u>LJF</u>		SIGNAL PLANS	
DATE	<u>05/01/24</u>	TRAF	FIC SIGNAL TABULATION	ONS
CALE	AS SHOWN	Port Authority	CONTRACT NO	. BRT-001
•	AO OHOWN	connecting people to life	DWG. NO. SG110	sнт. 1170

TS-334

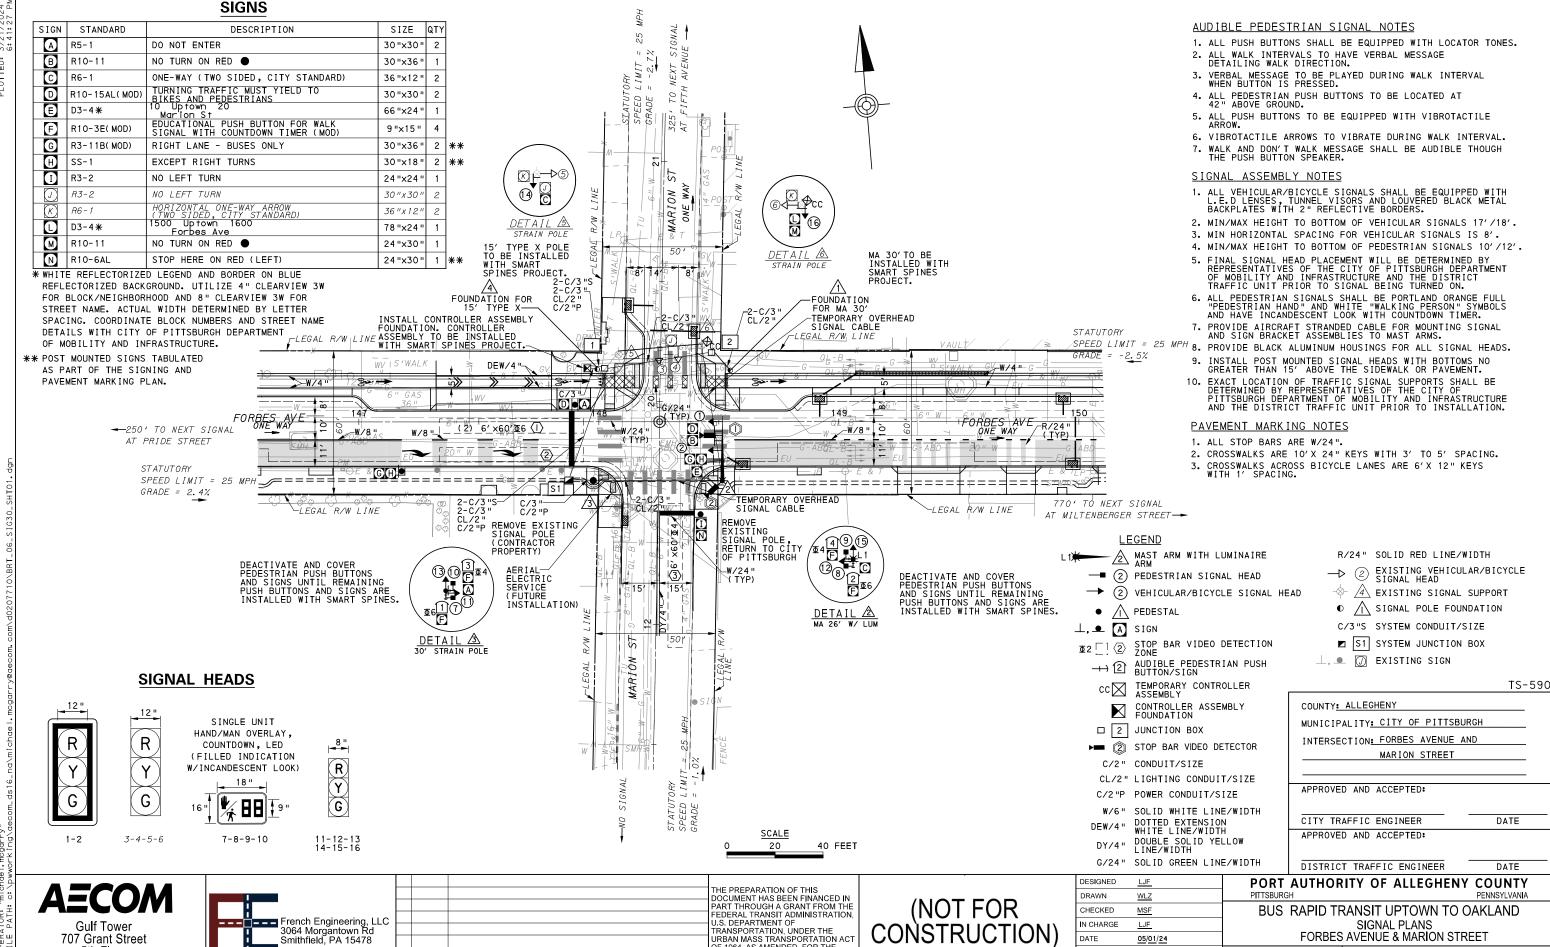

OF 1964 AS AMENDED FOR THE

COUNTY, PENNSYLVANIA.

SCALE

AS SHOWN

CONTRACT NO. BRT-001

sнт. **1171**

SG111

DWG NO

Port Authority

5th Floor

Pittsburgh, PA 15219

NO. DATE

DESCRIPTION

REVISIONS

		PL	IASE	6										
		- ' '	IAJL					IASE	7					
	BUS E						BIKE-							
		• • • •							1		HLANHHZG HLANHHZG			
		INI	ERV.	ALS			INI	ERV.	ALS		Υ			
SIGNAL	1	2	3	4	5	1	2	3	4	5				
1-2	G	G	Υ	R		R	R	R	R	R	R			
3-4	R	R	R	R		R	G	G	Υ	R	R			
5-6	G	G	Υ	R		R	R	R	R	R	R			
7-8	W	FDW	DW	DW		DW	DW	DW	DW	DW	0FF			
9-10	DW	DW	DW	DW		W	W	FDW	DW	DW	0FF			
11-12	G	G	Υ	R		R	R	R	R	R	R			
13-14-15-16	R	R	R	R		R	G	G	Υ	R	R			
FIXED	\setminus	<	3.5	2.5		//	><	<	3.5	2.5				
MINIMUM	1	0					1	0						
PASSAGE	,	3					,	3						
FREE (MAX)	4	6					1	7						
PEDESTRIAN	7	11				3	4	12						
MEMORY		MAX	REC	ALL		PED RECALL			ALL					
NOTES:														

NOTES:


- PEDESTRIAN SIGNAL HEADS 7 THROUGH 10 TO BE BAGGED AT THE CONCLUSION OF SUCCESSFUL 30-DAY TEST PERIOD.
- VEHICULAR SIGNAL HEADS 5-6 AND
 11 THROUGH 16 USED FOR PEDESTRIAN
 CROSSINGS DURING THE INTERIM
 CONDITION UNTIL THE INSTALLATION
 OF SMART SPINES EQUIPMENT.
- PHASE 4 LPI NOT TO BE IMPLEMENTED IN THE INTERIM CONDITION.

TRANSIT PRIORITY PRE-EMPTION NOTES (TO BE INSTALLED BY OTHERS)

- COORDINATE TRAFFIC CONTROLLER PROGRAMMING MODIFICATION WITH REPRESENTATIVES OF THE CITY OF PITTSBURGH AND DISTRICT TRAFFIC UNIT.
- 2. INCLUDE A TRANSIT PRIORITY PHASE THAT WILL EXTEND THE INDICATED PHASE A MAXIMUM OF 10 SECONDS WHEN ACTIVATED BY A PORT AUTHORITY VEHICLE. DO NOT VIOLATE SIDE STREET PEDESTRIAN MINIMUM TIMINGS.
- 3. MAINTAIN ALL YELLOW CLEARANCES AT ALL TIMES.
- 4. PROCEED TO THE SUBSEQUENT INTERVAL AS DEFINED IN THE MOVEMENT, SEQUENCE AND TIMING DIAGRAM UPON COMPLETING THE GREEN EXTENSION INTERVAL.
- 5. ONCE A TRANSIT CALL IS PLACED AND SATISFIED, THE CONTROLLER WILL NOT SATISFY ANOTHER CALL FOR
- 6. LOCATION OF BUS DETECTORS ARE TO BE FIELD ADJUSTED TO ACHIEVE MAXIMUM OPERATION.

DETECTOR ZONE INFORMATION

DETECTOR	DETECTION ZONE(S)	MODE	TYPE	ROUTE	PHASE	LOCATION MAST ARM
	1 2 (6' x60')	PRESENCE	VIDEO (STOP BAR)	FORBES AVENUE	6	À
②	⟨3⟩ (6′ ×60′)	PRESENCE	VIDEO (STOP BAR)	MARION STREET	4	2

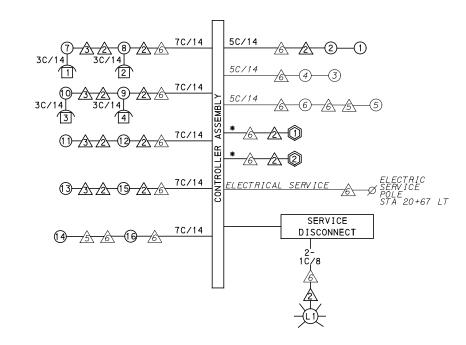

WIRING DIAGRAM

5C/14 - CABLE (NO. OF CONDUCTORS/SIZE AWG.)

PROPOSED DETECTOR

1) PROPOSED SIGNAL HEAD

PEDESTRIAN INDICATOR

↑ PROPOSED SIGNAL SUPPORT

PROPOSED LUMINAIRE

1 PROPOSED JUNCTION BOX

A EXISTING SIGNAL SUPPORT (1) EXISTING SIGNAL HEAD


3C/14 INCIDENTAL TO ITEM 02895.002

*INCIDENTAL TO ITEM 02895.001, AS PER MANUFACTURERS SPECIFICATIONS

AECOM

Gulf Tower 707 Grant Street 5th Floor Pittsburgh, PA 15219



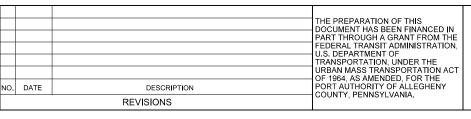

(NOT FOR CONSTRUCTION)

DESIGNED	<u>LJF</u>	
DRAWN	<u>WLZ</u>	
CHECKED	MSF	
IN CHARGE	<u>LJF</u>	
DATE	05/01/24	
SCALE		
	AS SHOWN	

GENERAL NOTES

THE CITY OF PITTSBURGH SHALL INSPECT THE NEW SIGNAL EQUIPMENT PRIOR TO ACTIVATION.

ALL TRAFFIC SIGNAL MAINTENANCE AND OPERATION RESPONSIBILITIES SHALL BE TURNED OVER TO THE CITY OF PITTSBURGH AFTER THE FOLLOWING CONDITIONS ARE IMPLEMENTED TO THE CITY'S SATISFACTION:

- 1. PERMIT "AS-BUILT" TRAFFIC SIGNAL DRAWINGS ARE SUBMITTED AND APPROVED.
- 2. ALL PUNCH LIST ITEMS ARE COMPLETED BY THE CONTRACTOR.
- 3. AFTER THE 30-DAY CONTINUOUS UNINTERRUPTED SIGNAL OPERATION WITHOUT MALFUNCTIONS.

CONSTRUCTION NOTES

- 1. ALL JUNCTION BOXES IN WALK AREAS TO BE CITY OF PITTSBURGH STANDARD CONCRETE JUNCTION BOX, TYPE 1.
- 2. ALL JUNCTION BOXES IN NON-WALK AREAS TO BE CITY STANDARD JB-2 WITH BOTTOM.
- 3. THERE SHALL BE NO SIGNAL WIRE OR FIBER CABLE SPLICING.
- 4. SERVICE WIRE FROM THE POWER SOURCE TO THE CONTROLLER CABINET SHALL BE PLACED IN SECONDARY SEPARATE CONDUIT.
- 5. STREET LIGHT CABLE IS NOT PERMITTED TO RUN THROUGH THE CONTROLLER CABINET AND SHALL BE PLACED IN SEPARATE CONDUIT.
- 6. TRAFFIC SIGNAL CABLE SHALL BE PLACED IN DEDICATED
- 7. MOUNT DISCONNECT ON POLE NEAREST TO THE CONTROLLER CABINET EXCLUDING TYPE X POLES.
- 8. REMOVE AND DISPOSE OF ALL EXISTING SIGNAL WIRING NO
- 9. REMOVE EXISTING SIGNAL EQUIPMENT NO LONGER IN USE AND RETURN TO THE CITY OF PITTSBURGH TRAFFIC CONTROL SHOP. COORDINATE DELIVERY OF EQUIPMENT WITH DELMAS MCELHANY, TRAFFIC CONTROL FOREMAN.

TS-590 COUNTY: ALLEGHENY MUNICIPALITY: CITY OF PITTSBURGH INTERSECTION: FORBES AVENUE AND MARION STREET APPROVED AND ACCEPTED: CITY TRAFFIC ENGINEER DATE APPROVED AND ACCEPTED: DISTRICT TRAFFIC ENGINEER DATE

PORT AUTHORITY OF ALLEGHENY COUNTY PITTSBURGH PENNSYLVANIA

sнт. 1172

BUS RAPID TRANSIT UPTOWN TO OAKLAND SIGNAL PLANS WIRING, MOVEMENT, PHASING & SEQUENCE DIAGRAMS

CONTRACT NO. BRT-001 **Port Authority** DWG. NO. SG112



ITEM NUMBER	MISCEL	LANEO	US	
UNIT	DESCRIPTION	QTY.	LOCATION	REMARKS
01882. 002 EACH	TRAFFIC SIGNAL TIMING MODIFICATIONS	2	СС	
02212. 009 LF	POLE FOUNDATION DRILLING, LESS THAN 30" DIAMETER	6	<u> </u>	
02212. 010 LF	POLE FOUNDATION DRILLING, 30" DIAMETER OR GREATER	35	1/2/3	
01883. 002 EACH	TEMPORARY MODIFICATION OF EXISTING TRAFFIC SIGNAL	1		
02889. 002 EACH	LED LUMINAIRE CITY STANDARD, BLACK	1	<u></u>	À
02890. 003 EACH	ETHERNET SWITCH	1	СС	
02890. 004 EACH	TEMPORARY TRAFFIC SIGNAL CONTROLLER	1	СС	
02890. 005 EACH	GPS TIME CLOCK	1	СС	
02890. 006 EACH	TRAFFIC SIGNAL CONTROLLER ASSEMBLY FOUNDATION, FUTURE INSTALLATION OF TYPE 332 BASE MOUNTED CABINET AND 8" RISER	1		ONLY INSTALL A CONTROLLER CABINET FOUNDATION AND PROPOSED CONDUITS TO FIT A FUTURE TYPE 332 CABINET AND 8" RISER.
02894. 001 EACH	VEHICULAR SIGNAL HEAD, THREE 12" SECTIONS	2	12	BLACK TUNNEL VISORS BLACK ALUMINUM HOUSINGS BLACK METAL LOUVERED BACKPLATE
02894. 005 EACH	LED COUNTDOWN PEDESTRIAN SIGNAL HEAD, TYPE A	4	7890	BLACK TUNNEL VISORS BLACK ALUMINUM HOUSINGS
02894. 006 EACH	VEHICULAR SIGNAL HEAD, THREE 8" SECTIONS	6	1123 1456	BLACK TUNNEL VISORS BLACK ALUMINUM HOUSINGS BLACK METAL LOUVERED BACKPLATE
02895. 002 EACH	ACCESSIBLE PEDESTRIAN SIGNALS	4	11234	
02896. 005 EACH	LUMINAIRE SERVICE DISCONNECT	1	Â	
005	LUMINAIRE SERVICE DISCONNECT	1		FFIC SIGNAL SUPPO

DETECTORS

ITEM NUMBER	DESCRIPTION	SEN. NO.	QTY.	LOCATION
02895 . 001	VIDEO DETECTION	Û	1	/2\
EACH				
02895 . 001	VIDEO DETECTION	2	1	/2\
EACH		_		

TRAFFIC SIGNAL TABULATION

FORBES AVENUE AND MARION STREET

	≥ Ш				NO		_								MAST	ARM	1							PEI	DESTA	.L
POLE NO.	I TEM NUMBER	DESCRIPTION	ΩTΥ.	ROUTE	ATI	SIDE	OFFSE							ARM	"A"						А	RM "	C "	SHAFT	SIG	NAL
					ST	"	9	Н	I K	K		SIGN	AL L	OCA	ATION SIGN LOCATION W G X Z						z	н	м	N		
	UNIT									_	М	N	0	Р	R	S	T	U	Υ				_			
\triangle	02892. 403 EACH	TRAFFIC SIGNAL SUPPORT, 30' MAST ARM, (FOUNDATION ONLY)	1	FORBES AVE	148+55	LŤ	21′																			
2	02892. 205 EACH	TRAFFIC SIGNAL SUPPORT, 26' MAST ARM WITH LUMINAIRE ARM (30' MOUNTING HEIGHT), PAINTED BLACK	1	FORBES AVE	148+51	RT	25′	17′	10′	26′	24'	12′			20′	16′	8′		3′	0°	6′	30′	0°			
<u>3</u>	02892. 011 EACH	2,000 POUNDS DESIGN TENSION, PAINTED	1	FORBES AVE	147+98	RT	24′																	30′	15′	10′
4	02892. 008 EACH	TRAFFIC SIGNAL SUPPORT, 15' TYPE X, (FOUNDATION ONLY)	1	FORBES AVE	147+99	LT	22′																			
<u>/\$</u>		TRAFFIC SIGNAL SUPPORT STRAIN POLE		MARION ST	20+19	LT	17 '		10′																	
<u>6</u>		TRAFFIC SIGNAL SUPPORT STRAIN POLE		MARION ST	20+23	RT	17 '		10′																	

** REFER TO PENNDOT TC-8800 TRAFFIC STANDARDS-SIGNALS FOR LETTER DESIGNATION

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DESIGNED	<u>LJF</u>	
DRAWN	<u>WLZ</u>	
CHECKED	MSF	
IN CHARGE	<u>LJF</u>	
DATE	05/01/24	
SCALE		
	AS SHOWN	

TS-590 PORT AUTHORITY OF ALLEGHENY COUNTY

BUS RAPID TRANSIT UPTOWN TO OAKLAND SIGNAL PLANS TRAFFIC SIGNAL TABULATIONS

CONTRACT NO. BRT-001 DWG. NO. SG113

Port Authority
connecting people to life

sнт. **1173**

FORBES AVENUE AND MARION STREET

TRENCH, CONDUIT, JUNCTION BOX, ELECTRICAL ITEMS

DESCRIPTION	CITY OF PITTSBURGH STANDARD CONCRETE JUNCTION BOX, TYPE 1	TRENCH AND BACKFILL, TYPE II	TRENCH AND BACKFILL, TYPE IV	2 INCH CONDUIT	3 INCH CONDUIT	SIGNAL CABLE, 14 AWG, 5 CONDUCTOR	SIGNAL CABLE, 14 AWG, 7 CONDUCTOR	AWG 8, ABOVE GROUND CABLE, COPPER, 1 CONDUCTOR
ITEM NUMBER	02897	02898	02898	02899	02899	02900	02900	02900
TIEM NOMBER	001	002	005	002	003	002	003	004
UNIT	EACH	LF	LF	LF	LF	LF	LF	LF
LOCATION								
FOUNDATION TO 1	1	7		14	28			
1 TO 2	1	23	22	45	90			
1 TO S1		25	24	98	196			
то 2		12		12	24			
<u></u> ₹0 51		30	36 [*]	66	132			
<u>₹</u> TO 51		10		10	10			
TO FOUNDATION		4			4			
COMPLETE INTERSECTION						475	680	225
TOTAL	2	111	46	245	484	475	680	225

^{*} TYPE IV TRENCH TABULATED AS PART OF THE SYSTEMS PLAN.

SIGNS

SERIES	SIZE	AREA EACH (SQ FT)	DESCRIPTION	QUANTITY	02891,001 POST MOUNTED SIGNS, TYPE B	02891,003 POST MOUNTED SIGNS, TYPE F	O2891,007 CN STRUCTURE MOUNTED FLAT SHEET ALUMINUM SIGNS WITH STIFFENERS
DE _ 1	301123011	6 3	DO NOT ENTER	2			31
					6.3	6.3	
R10-11	30"x36"	7.5		1			7.5
R6-1	36"×12"	3.0	(TWO SIDED, CITY STANDARD)	2		6.0	
R10-15AL(MOD)	30"×30"	6.3	TURNING TRAFFIC MUST YIELD TO BIKES AND PEDESTRIANS	2		6.3	6.3
D3-4*	66"x24"	11.0	Mar'ion St	1			11.0
R10-3E(MOD)	9"×15"	0.9	EDUCATIONAL PUSH BUTTON FOR WALK Signal With Countdown Timer (Mod)	4		•	
R3-11B(MOD)	30"x36"	7.5	RIGHT LANE - BUSES ONLY	1			7.5
SS-1	30"×18"	3.8	EXCEPT RIGHT TURNS	1			3.8
R3-2	24"x24"	4.0	NO LEFT TURN	1	4.0		
D3-4*	78 "x24 "	13.0	1500 Uptown 1600 Forbes Ave	1			13.0
R10-11	24"×30"	5.0	NO TURN ON RED	1		5.0	
			TOTAL		10.3	23.6	49.1
	R5-1 R10-11 R6-1 R10-15AL(MOD) D3-4* R10-3E(MOD) R3-11B(MOD) SS-1 R3-2 D3-4*	R5-1 30 "x30 " R10-11 30 "x36 " R6-1 36 "x12 " R10-15AL(MOD) 30 "x30 " D3-4* 66 "x24 " R10-3E(MOD) 9 "x15 " R3-11B(MOD) 30 "x36 " SS-1 30 "x18 " R3-2 24 "x24 " D3-4* 78 "x24 "	R5-1 30"x30" 6.3 R10-11 30"x36" 7.5 R6-1 36"x12" 3.0 R10-15AL(MOD) 30"x30" 6.3 D3-4* 66"x24" 11.0 R10-3E(MOD) 9"x15" 0.9 R3-11B(MOD) 30"x36" 7.5 SS-1 30"x18" 3.8 R3-2 24"x24" 4.0 D3-4* 78"x24" 13.0	R5-1 30"x30" 6.3 DO NOT ENTER R10-11 30"x36" 7.5 NO TURN ON RED ● R6-1 36"x12" 3.0 HORIZONTAL ONE-WAY ARROW (TWO SIDED, CITY STANDARD) R10-15AL(MOD) 30"x30" 6.3 TURNING TRAFFIC MUST YIELD TO BIKES AND PEDESTRIANS D3-4* 66"x24" 11.0 10 Uptown 20 Marion St R10-3E(MOD) 9"x15" 0.9 EDUCATIONAL PUSH BUTTON FOR WALK SIGNAL WITH COUNTDOWN TIMER (MOD) R3-11B(MOD) 30"x36" 7.5 RIGHT LANE - BUSES ONLY SS-1 30"x18" 3.8 EXCEPT RIGHT TURNS R3-2 24"x24" 4.0 NO LEFT TURN D3-4* 78"x24" 13.0 1500 Uptown 1600 Forbes Ave R10-11 24"x30" 5.0 NO TURN ON RED ●	R5-1 30"x30" 6.3 DO NOT ENTER 2 R10-11 30"x36" 7.5 NO TURN ON RED ● 1 R6-1 36"x12" 3.0 HORIZONTAL ONE-WAY ARROW (TWO SIDED, CITY STANDARD) 2 R10-15AL(MOD) 30"x30" 6.3 TURNING TRAFFIC MUST YIELD TO BIKES AND PEDESTRIANS 2 D3-4* 66"x24" 11.0 10 Uptown 20 1 R10-3E(MOD) 9"x15" 0.9 EDUCATIONAL PUSH BUTTON FOR WALK SIGNAL WITH COUNTDOWN TIMER (MOD) 4 R3-11B(MOD) 30"x36" 7.5 RIGHT LANE - BUSES ONLY 1 SS-1 30"x18" 3.8 EXCEPT RIGHT TURNS 1 R3-2 24"x24" 4.0 NO LEFT TURN 1 D3-4* 78"x24" 13.0 1500 Uptown 1600 Forbes Ave 1 R10-11 24"x30" 5.0 NO TURN ON RED ● 1	SERIES SIZE AREA EACH (SQ FT) DESCRIPTION DESCRIPTI	SERIES SIZE

^{▲ -} INCIDENTAL TO ITEM 02895.002

Gulf Tower
707 Grant Street
5th Floor
Pittsburgh, PA 15219



		THE PREPARATION OF THIS
		DOCUMENT HAS BEEN FINANCED IN
		PART THROUGH A GRANT FROM THE
		FEDERAL TRANSIT ADMINISTRATION, U.S. DEPARTMENT OF
		TRANSPORTATION, UNDER THE
		URBAN MASS TRANSPORTATION ACT OF 1964, AS AMENDED, FOR THE
E	DESCRIPTION	PORT AUTHORITY OF ALLEGHENY COUNTY, PENNSYLVANIA.
	REVISIONS	COUNTY, FEMINISTEVANIA.

						TS-	590			
	DESIGNED	<u>LJF</u>	PORT AUTHOR	ITY OF AL	LEGHENY COL	JNTY				
ſ	DRAWN	<u>WLZ</u>	PITTSBURGH		PENNS	SYLVANIA				
	CHECKED	MSF	BUS RAPID TRANSIT UPTOWN TO OAKLAND							
	IN CHARGE	<u>LJF</u>	SIGNAL PLANS							
	DATE	05/01/24	TRAFFIC SIGNAL TABULATIONS							
	SCALE AS SHOWN		Port Authority	CONTRACT NO. BRT-001						
	Α.	O O I IOVVIN	connecting people to life	DWG. NO.	SG114	sнт. 1	174			

S1 - TABULATED ON SYSTEMS PLAN

^{*} WHITE REFLECTORIZED LEGEND AND BORDER ON BLUE REFLECTORIZED BACKGROUND.
UTILIZE 4" CLEARVIEW 3W FOR BLOCK/NEIGHBORHOOD AND 8" CLEARVIEW 3W FOR
STREET NAME. ACTUAL WIDTH DETERMINED BY LETTER SPACING. COORDINATE BLOCK
NUMBERS AND STREET NAME DETAILS WITH CITY OF PITTSBURGH DEPARTMENT OF
MOBILITY AND INFRASTRUCTURE.

COUNTY, PENNSYLVANIA.

REVISIONS

SG115

DWG. NO.

sнт. 1175

DETECTOR ZONE INFORMATION

TYPE

VIDEO (STOP BAR)

VIDEO (STOP BAR)

VIDEO (STOP BAR)

PRESENCE VIDEO (STOP BAR)

ROUTE

VAN BRAAM ST.

FORBES AVE.

FORBES AVE.


VAN BRAAM ST.

						_		$\overline{}$			
		PH	IASE	6			PHA	SE	4+8		
BIKE						B1	HLANTHZG				
INTERVAL	1	2	3	4	5	1	2	3	4	5	
1-2	G	G	Υ	R		R	R	R	R	R	R
3-4-5-6	R	R	R	R		R	G	G	Υ	R	R
7	G	G	Υ	R		R	R	R	R	R	R
8-9-10-11	W	FD	DW	DW		DW	DW	DW	DW	DW	0FF
12-13-14-15	DW	DW	DW	DW		W	W	FD	DW	DW	0FF
FIXED	\geq	\leq	3.5	2.5			>><	\leq	3.5	2.5	
MINIMUM	1	0				1	0				
PASSAGE	;	3				3	3				
FREE (MAX)	4	6				17					
PEDESTRIAN	7	10				3	7	10			
MEMORY		PED	REC	ALL			PED	REC	ALL		

MODE

PRESENCE

PRESENCE

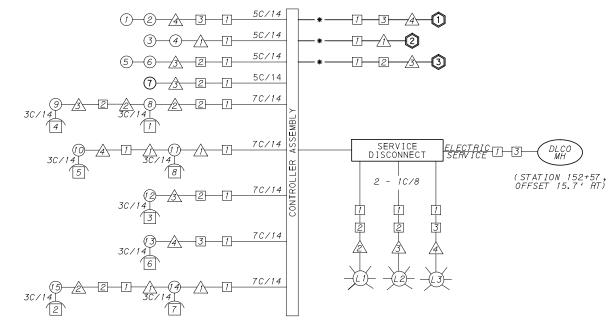

WIRING DIAGRAM

5C/14 - CABLE(NO. OF CONDUCTORS/SIZE AWG.)

SIGNAL HEAD

RADAR DETECTOR

AUDIBLE PEDESTRIAN __ JUNCTION BOX INDICATOR

LI LUMINAIRE

INCIDENTAL TO ITEM 02895.001, AS PER MANUFACTURERS SPECIFICATIONS

TS-72

COUNTY: ALLEGHENY	
MUNICIPALITY: CITY OF PITTSBURG	GH
INTERSECTION: FORBES AVENUE	
AND VAN BRAAM STREE	₹T
APPROVED AND ACCEPTED:	
CITY TRAFFIC ENGINEER	DATE
APPROVED AND ACCEPTED:	

AECOM

Gulf Tower 707 Grant Street 5th Floor Pittsburgh, PA 15219 ((₁DRIVE **ENGINEERING** 595 Skippack Pk, Suite 400

Blue Bell, PA 19422

THE PREPARATION OF THIS DOCUMENT HAS BEEN FINANCED IN PART THROUGH A GRANT FROM THE FEDERAL TRANSIT ADMINISTRATION U.S. DEPARTMENT OF TRANSPORTATION, UNDER THE URBAN MASS TRANSPORTATION ACT OF 1964 AS AMENDED FOR THE DESCRIPTION COUNTY, PENNSYLVANIA. REVISIONS

CONSTRUCTION

DESIGNED MW RAWN MW CHECKED EMC N CHARGE EMC DATE 05/01/24 SCALE AS SHOWN

DISTRICT TRAFFIC ENGINEER PORT AUTHORITY OF ALLEGHENY COUNTY PITTSBURGH PENNSYLVANIA

BUS RAPID TRANSIT UPTOWN TO OAKLAND SIGNAL PLANS WIRING, MOVEMENT, PHASING & SEQUENCE DIAGRAMS

Port Authority

GENERAL NOTES

CONSTRUCTION NOTES

THE CONTROLLER CABI SEPARATE CONDUIT.

THE CITY OF PITTSBURGH SHALL INSPECT THE NEW SIGNAL EQUIPMENT PRIOR TO ACTIVATION.

ALL TRAFFIC SIGNAL MAINTENANCE AND OPERATION RESPONSIBILITIES SHALL BE TURNED OVER TO THE CITY OF PITTSBURGH AFTER THE FOLLOWING CONDITIONS ARE IMPLEMENTED TO THE CITY'S SATISFACTION:

1. PERMIT "AS-BUILT" TRAFFIC SIGNAL DRAWINGS ARE SUBMITTED AND APPROVED. 2. ALL PUNCH LIST ITEMS ARE COMPLETED BY THE 3. AFTER THE 30-DAY CONTINUOUS UNINTERRUPTED SIGNAL OPERATION WITHOUT MALFUNCTIONS.

1. ALL JUNCTION BOXES IN WALK AREAS TO BE CITY OF PITTSBURGH STANDARD CONCRETE JUNCTION BOX, TYPE 1.

3. THERE SHALL BE NO SIGNAL WIRE OR FIBER CABLE SPLICING.

4. SERVICE WIRE FROM THE POWER SOURCE TO THE CONTROLLER CABINET SHALL BE PLACED IN SECONDARY SEPARATE CONDUIT.

9. REMOVE EXISTING SIGNAL EQUIPMENT NO LONGER IN USE AND RETURN TO THE CITY OF PITTSBURGH TRAFFIC CONTROL SHOP. COORDINATE DELIVERY OF EQUIPMENT WITH DELMAS MCELHANY, TRAFFIC CONTROL FOREMAN.

5. STREET LIGHT CABLE IS NOT PERMITTED TO RUN THROUGH THE CONTROLLER CABINET AND SHALL BE PLACED IN

6. TRAFFIC SIGNAL CABLE SHALL BE PLACED IN DEDICATED 7. MOUNT DISCONNECT ON POLE NEAREST TO THE CONTROLLER CABINET EXCLUDING TYPE X POLES. 8. REMOVE AND DISPOSE OF ALL EXISTING SIGNAL WIRING NO

2. ALL JUNCTION BOXES IN NON-WALK AREAS TO BE CITY STANDARD JB-2 WITH BOTTOM.

CONTRACT NO. BRT-001 DWG. NO. SG116 sнт. 1176

TRANSIT PRIORITY PRE-EMPTION NOTES (TO BE INSTALLED BY OTHERS)

- 2. INCLUDE A TRANSIT PRIORITY PHASE THAT WILL EXTEND THE INDICATED PHASE A MAXIMUM OF 10 SECONDS WHEN ACTIVATED BY A PORT AUTHORITY VEHICLE. DO NOT VIOLATE SIDE STREET

- 5. ONCE A TRANSIT CALL IS PLACED AND SATISFIED, THE CONTROLLER WILL NOT SATISFY ANOTHER CALL FOR
- 6. LOCATION OF BUS DETECTORS ARE TO BE FIELD ADJUSTED TO ACHIEVE MAXIMUM OPERATION.

NO. DATE

LOCATION

MAST ARM

3

4

4

 \triangle

PHASE

8

(NOT FOR

DETECTION ZONE(S)

 $\langle 1 \rangle$ (11' x 60')

(2) (6' × 60')

(3) (7' x 60')

(4) (11' x 60')

DETECTOR

0

2

COORDINATE TRAFFIC CONTROLLER PROGRAMMING MODIFICATION WITH REPRESENTATIVES OF THE CITY OF PITTSBURGH AND DISTRICT TRAFFIC UNIT.

PEDESTRIAN MINIMUM TIMINGS.

3. MAINTAIN ALL YELLOW CLEARANCES AT ALL TIMES.

4. PROCEED TO THE SUBSEQUENT INTERVAL AS DEFINED IN THE MOVEMENT, SEQUENCE AND TIMING DIAGRAM UPON COMPLETING THE GREEN EXTENSION INTERVAL.

<u>TRAFFIC</u>	SIGNAL	TABULATION

FORBES AVENUE AND VAN BRAAM STREET

ITEM NUMBER	MISCELLANEOUS										
UNIT	DESCRIPTION	QTY.	LOCATION	REMARKS							
01882 .002 EACH	TRAFFIC SIGNAL TIMING MODIFICATIONS	2	СС								
02890 . 003	ETHERNET SWITCH	1	СС								
EACH											
02891.	RESET STRUCTURE MOUNTED FLAT SHEET ALUMINIUM SIGN	1	4								
EACH	ALOMINION OTON										
02894. 021 EACH	RESET VEHICULAR SIGNAL HEAD	2	4								
02894. 006 EACH	VEHICULAR SIGNAL HEAD, THREE 8 " SECTIONS	1	7	BLACK TUNNEL VISORS BLACK ALUMINUM HOUSINGS							

DETECTORS

I TEM NUMBER	DESCRIPTION	SEN. NO.	QTY.	LOCATION
02895. 001 EACH	VIDEO DETECTION	000	3	<u> </u>

TRAFFIC SIGNAL SUPPORTS **

	THAT TO STONAL SUIT ONTO																										
	≅ R				NO		_	MAST ARM						PEDES		-											
POLE NO.	ITEM	DESCRIPTION	αΤΥ.	ROUTE	ROUTE I	ratio Side	FFSET	_		ARM "A"							ARM "C"			SHAFT	SIG	NAL					
	_				ST	"	R	Н	K	SIC		SIGNAL I		SIGNAL LOCATION		ON SIGN LOC			LOCATION			G	Х	z	Н	м	N
	UNIT									_	М	N	0	Р	R	S	T	U	Υ	. "	G	^		п	IVI		
\triangle		TRAFFIC SIGNAL SUPPORT, 28' MAST ARM		FORBES AVE.	152+29	RT	29 '	17 '	10'	28 '	24'	14'			19'				4'	90°							
2		TRAFFIC SIGNAL SUPPORT, TYPE X WITH LUMINAIRE ARM, 30' MOUNTING		FORBES AVE.	152+24	LT	21'														6′	30 '	45°	30 '		10'	
<u></u>		TRAFFIC SIGNAL SUPPORT, 20' MAST ARM WITH LUMINAIRE ARM, 30' MOUNTING		FORBES AVE.	152+74	LT	30 ′	17 '	10'	20 '	17 '	7'			14′	12'			3'	90°	6′	30 '	45°				
<u> </u>		TRAFFIC SIGNAL SUPPORT, 28' MAST ARM WITH LUMINAIRE ARM, 30' MOUNTING		FORBES AVE.	152+83	RT	23'	17 '	10'	28 '	21′	11′			25′	14′			6′	0°	6′	30 '	45°				

** REFER TO PENNDOT TC-8800 TRAFFIC STANDARDS - SIGNALS FOR LETTER DESIGNATION

AECOM

Gulf Tower 707 Grant Street 5th Floor Pittsburgh, PA 15219 ((* DRIVE ENGINEERING 595 Skippack Pk, Suite 400 Blue Bell, PA 19422

			THE PREPARATION OF THIS DOCUMENT HAS BEEN FINANCED IN
			PART THROUGH A GRANT FROM THE
			FEDERAL TRANSIT ADMINISTRATION,
			U.S. DEPARTMENT OF TRANSPORTATION, UNDER THE
			URBAN MASS TRANSPORTATION ACT OF 1964, AS AMENDED, FOR THE
NO.	DATE	DESCRIPTION	PORT AUTHORITY OF ALLEGHENY COUNTY, PENNSYLVANIA.
		REVISIONS	COUNTY, FERINGTEVANIA.

(NOT FOR CONSTRUCTION)

DESIGNED	MW	
DRAWN	MW	L
CHECKED	EMC	
IN CHARGE	<u>EMC</u>	
DATE	05/01/24	
SCALE		Ī
	AS SHOWN	

PORT AUTHORITY OF ALLEGHENY COUNTY PITTSBURGH PENNSYLVANIA BUS RAPID TRANSIT UPTOWN TO OAKLAND

SIGNAL PLANS
TRAFFIC SIGNAL TABULATIONS

Port Authority CO

CONTRACT NO. BRT-001

DWG. NO. SG117 SHT. 1177

DESCRIPTION	3 INCH CONDUIT	TRENCH AND BACKFILL, TYPE I	SIGNAL CABLE, 14 AWG, 5 CONDUCTOR
ITEM NUMBER	02899	02898	02900
TIEM NOMBER	003	001	002
UNIT	LF	LF	LF
LOCATION			
cc TO [51]	27	14	
TOTAL	27	14	159

S1 - TABULATED ON SYSTEMS PLAN

SIGNS

SYMBOL	SERIES	SIZE	AREA EACH (SQ FT)	DESCRIPTION	QUANTITY	MOUNTED SIGNS, TYPE B	M POST MOUNTED SIGNS,	STRUCTURE MOUNTED FLAT SHEET ALUMINUM SIGNS WITH STIFFENERS
В	R10-11	30 "X36 "	7.5	NO TURN ON RED	2			15
K	R10-15AL(MOD)	30 "X30 "	6.3	TURNING TRAFFIC MUST YIELD TO BIKES AND PEDS	2		6.3	6.3
D	R3-1	24 "X24 "	4	NO RIGHT TURN	1		4	
0	R3-2	24 "X24 "	4	NO LEFT TURN	1		4	
Ø	R5-1	30 "X30 "	6.3	DO NOT ENTER	1	6.3		
			6.3	14.3	21.3			


AECOM

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595 Skippack Pk, Suite 400 Blue Bell, PA 19422

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		U.S. DEPARTMENT OF
		TRANSPORTATION, UNDER THE URBAN MASS TRANSPORTATION ACT
		OF 1964, AS AMENDED, FOR THE
DATE	DESCRIPTION	PORT AUTHORITY OF ALLEGHENY COUNTY, PENNSYLVANIA.
	REVISIONS	COUNTY, FENNSTEVANIA.

DESIGNED	MW	PORT AUTHOR	ITY OF AL	LEGHENY CO	ידאט	Υ
DRAWN	<u>MW</u>	PITTSBURGH		PENN	ISYLVANI	lΑ
CHECKED	EMC	BUS RAPID TE	RANSIT UPT	TOWN TO OAKL	AND	
IN CHARGE	<u>EMC</u>		SIGNAL P	LANS		
DATE	05/01/24	TRAF	FIC SIGNAL 1	TABULATIONS		
SCALE	AS SHOWN	Port Authority	CONTR	RACT NO. BRT-0	01	
	AS SHOWIN	I OIC /tacilolity	DIMO NO	00110	OUT	1170

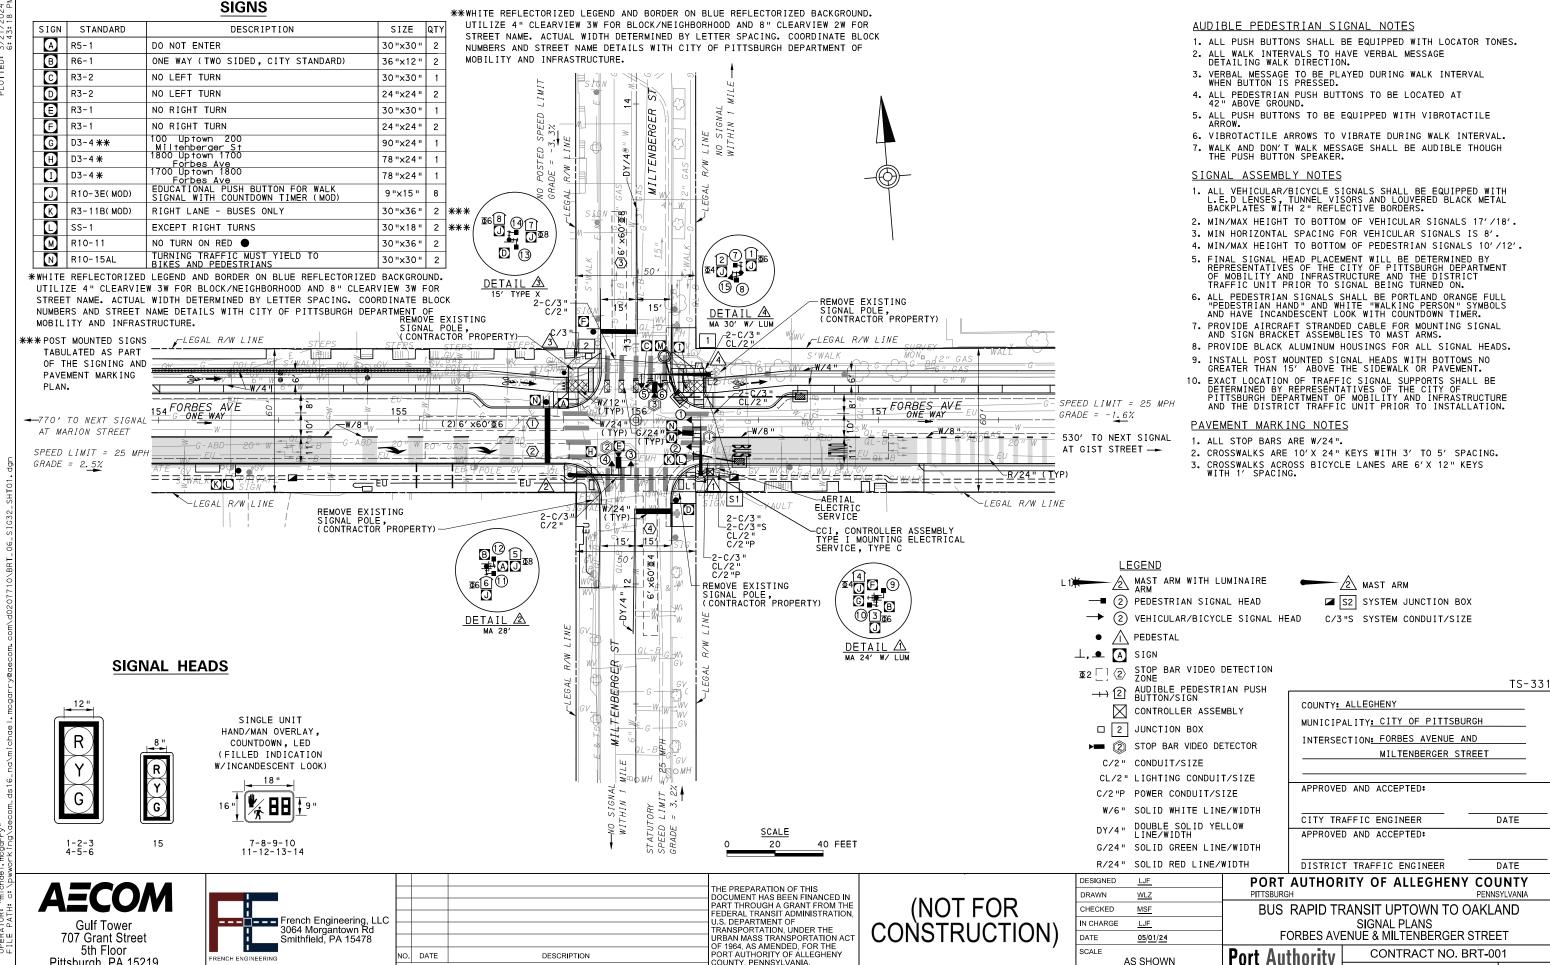

COUNTY, PENNSYLVANIA.

AS SHOWN

SG119

sнт. 1179

DWG NO

DESCRIPTION

REVISIONS

Pittsburgh, PA 15219


		PH	IASE	6			PHA	SE	4+8		
	B I K I	<u> </u>	 		•	B I K I	s l	ERV	 	-	HLANTIZG
SIGNAL	1	2	3	4	5	1	2	3	4	5	
1-2	G	G	Υ	R		R	R	R	R	R	R
3-4	R	R	R	R		R	G	G	Υ	R	R
5-6	R	R	R	R		R	G	G	Y	R	R
7-14	W	FD	DW	DW		DW	DW	DW	DW	DW	0FF
8-9	DW	DW	DW	DW		W	W	FD	DW	DW	OFF
10-11	W	FD	DW	DW		DW	DW	DW	DW	DW	OFF
12-13	DW	DW	DW	DW		W	W	FD	DW	DW	OFF
15	G	G	Υ	R		R	R	R	R	R	R
FIXED	\geq	\leq	3.5	2.5			><	\leq	3.5	2.5	
MINIMUM		0						0			
PASSAGE	7	3						3			
FREE (MAX)	4	6					1	7			
PEDESTRIAN	7	10				3	4	12			
MEMORY		MAX	REC	CALL			PED	REC	CALL		

TRANSIT PRIORITY PRE-EMPTION NOTES (TO BE INSTALLED BY OTHERS)

- COORDINATE TRAFFIC CONTROLLER PROGRAMMING MODIFICATION WITH REPRESENTATIVES OF THE CITY OF PITTSBURGH AND DISTRICT TRAFFIC UNIT.
- 2. INCLUDE A TRANSIT PRIORITY PHASE THAT WILL EXTEND THE INDICATED PHASE A MAXIMUM OF 10 SECONDS WHEN ACTIVATED BY A PORT AUTHORITY VEHICLE. DO NOT VIOLATE SIDE STREET PEDESTRIAN MINIMUM TIMINGS.
- 3. MAINTAIN ALL YELLOW CLEARANCES AT ALL TIMES.
- 5. ONCE A TRANSIT CALL IS PLACED AND SATISFIED, THE CONTROLLER WILL NOT SATISFY ANOTHER CALL FOR
- 6. LOCATION OF BUS DETECTORS ARE TO BE FIELD ADJUSTED TO ACHIEVE MAXIMUM OPERATION.

DETECTOR ZONE INFORMATION

DETECTOR	DETECTION ZONE(S)	MODE	TYPE	ROUTE	PHASE	LOCATION MAST ARM
0	1 2 (6′ x60′)	PRESENCE	VIDEO (STOP BAR)	FORBES AVENUE	6	\triangle
0	③ (6′ ×60′)	PRESENCE	VIDEO (STOP BAR)	MILTENBERGER STREET	8	2
3	⟨4⟩ (6′ ×60′)	PRESENCE	VIDEO (STOP BAR)	MILTENBERGER STREET	4	4

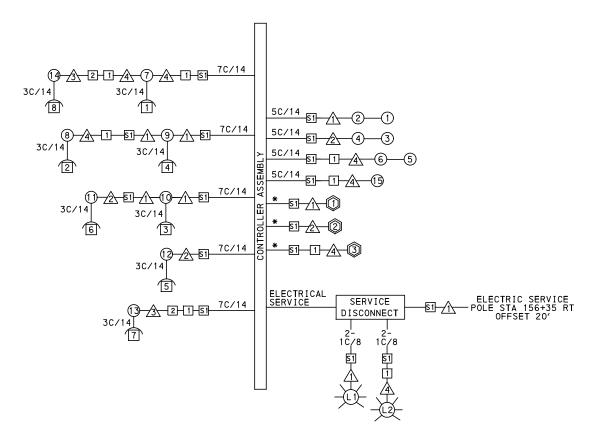

WIRING DIAGRAM

5C/14 - CABLE (NO. OF CONDUCTORS/SIZE AWG.)

PROPOSED DETECTOR 1) PROPOSED SIGNAL HEAD PEDESTRIAN INDICATOR ↑ PROPOSED SIGNAL SUPPORT PROPOSED LUMINAIRE

3C/14 INCIDENTAL TO ITEM 02895.002

1 PROPOSED JUNCTION BOX

*INCIDENTAL TO ITEM 02895.001 AS PER MANUFACTURERS SPECIFICATIONS

GENERAL NOTES

THE CITY OF PITTSBURGH SHALL INSPECT THE NEW SIGNAL EQUIPMENT PRIOR TO ACTIVATION.

ALL TRAFFIC SIGNAL MAINTENANCE AND OPERATION RESPONSIBILITIES SHALL BE TURNED OVER TO THE CITY OF PITTSBURGH AFTER THE FOLLOWING CONDITIONS ARE IMPLEMENTED TO THE CITY'S SATISFACTION:

- 1. PERMIT "AS-BUILT" TRAFFIC SIGNAL DRAWINGS ARE SUBMITTED AND APPROVED.
- 2. ALL PUNCH LIST ITEMS ARE COMPLETED BY THE
- 3. AFTER THE 30-DAY CONTINUOUS UNINTERRUPTED SIGNAL OPERATION WITHOUT MALFUNCTIONS.

CONSTRUCTION NOTES

- 1. ALL JUNCTION BOXES IN WALK AREAS TO BE CITY OF PITTSBURGH STANDARD CONCRETE JUNCTION BOX, TYPE 1.
- 2. ALL JUNCTION BOXES IN NON-WALK AREAS TO BE CITY STANDARD JB-2 WITH BOTTOM.
- 3. THERE SHALL BE NO SIGNAL WIRE OR FIBER CABLE SPLICING.
- 4. SERVICE WIRE FROM THE POWER SOURCE TO THE CONTROLLER CABINET SHALL BE PLACED IN SECONDARY SEPARATE CONDUIT.
- 5. STREET LIGHT CABLE IS NOT PERMITTED TO RUN THROUGH THE CONTROLLER CABINET AND SHALL BE PLACED IN THE CONTROLLER CAB: SEPARATE CONDUIT.
- 6. TRAFFIC SIGNAL CABLE SHALL BE PLACED IN DEDICATED
- 7. MOUNT DISCONNECT ON POLE NEAREST TO THE CONTROLLER CABINET EXCLUDING TYPE X POLES.
- 8. REMOVE AND DISPOSE OF ALL EXISTING SIGNAL WIRING NO
- 9. REMOVE EXISTING SIGNAL EQUIPMENT NO LONGER IN USE AND RETURN TO THE CITY OF PITTSBURGH TRAFFIC CONTROL SHOP. COORDINATE DELIVERY OF EQUIPMENT WITH DELMAS MCELHANY, TRAFFIC CONTROL FOREMAN.

COUNTY: ALLEGHENY

MUNICIPALITY: CITY OF PITTSBURGH INTERSECTION: FORBES AVENUE AND

APPROVED AND ACCEPTED:

CITY TRAFFIC ENGINEER APPROVED AND ACCEPTED:

DISTRICT TRAFFIC ENGINEER

DATE PORT AUTHORITY OF ALLEGHENY COUNTY

MILTENBERGER STREET

TS-33

DATE

PITTSBURGH PENNSYLVANIA BUS RAPID TRANSIT UPTOWN TO OAKLAND

SIGNAL PLANS WIRING, MOVEMENT, PHASING & SEQUENCE DIAGRAMS

Port Authority

CONTRACT NO. BRT-001 DWG. NO. SG120 sнт. 1180

4. PROCEED TO THE SUBSEQUENT INTERVAL AS DEFINED IN THE MOVEMENT, SEQUENCE AND TIMING DIAGRAM UPON COMPLETING THE GREEN EXTENSION INTERVAL.

AECOM **Gulf Tower**

707 Grant Street

5th Floor

Pittsburgh, PA 15219



THE PREPARATION OF THIS DOCUMENT HAS BEEN FINANCED IN PART THROUGH A GRANT FROM THE FEDERAL TRANSIT ADMINISTRATION U.S. DEPARTMENT OF TRANSPORTATION, UNDER THE URBAN MASS TRANSPORTATION ACT OF 1964 AS AMENDED FOR THE NO. DATE DESCRIPTION COUNTY, PENNSYLVANIA. REVISIONS

(NOT FOR **CONSTRUCTION** DESIGNED

CHECKED

N CHARGE

WLZ

MSF

LJF

05/01/24

AS SHOWN

RAWN

DATE

SCALE

FORBES AVENUE AND MILTENBERGER STREET

D = 1	$\Gamma \square \cap \Gamma$	rors
		IUNS

I TEM NUMBER	DESCRIPTION	SEN. NO.	QTY.	LOCATION
02895 . 001	VIDEO DETECTION	Û	1	\wedge
EACH		_		
02895 . 001	VIDEO DETECTION	2	1	/2\
EACH		_		
02895 . 001	VIDEO DETECTION	3	1	Â
EACH				

ITEM NUMBER	MISCELL	ANEO	US	
UNIT	DESCRIPTION	QTY.	LOCATION	REMARKS
01882. 002 EACH	TRAFFIC SIGNAL TIMING MODIFICATIONS	2	СС	
02212. 009 LF	POLE FOUNDATION DRILLING, LESS THAN 30" DIAMETER	6	<u> </u>	
02212. 010 LF	POLE FOUNDATION DRILLING, 30" DIAMETER OR GREATER	35	1/2/4	
02889. 002 EACH	LED LUMINAIRE CITY STANDARD, BLACK	2	\(\)	<u> </u>
02890. 001 EACH	TRAFFIC SIGNAL CONTROLLER ASSEMBLY, TYPE 2070 LC WITH TYPE 332 BASE MOUNTED CABINET	1	СС	332 CONTROLLER CABINET 8 " RISER RE-ESTABLISH INTERCONNECT
02890. 003 EACH	ETHERNET SWITCH	1	СС	
02890. 005 EACH	GPS TIME CLOCK	1	СС	
02894. 001 EACH	VEHICULAR SIGNAL HEAD, THREE 12" SECTIONS	6	123 456	BLACK TUNNEL VISORS BLACK ALUMINUM HOUSINGS BLACK METAL LOUVERED BACKPLATE
02894. 005 EACH	LED COUNTDOWN PEDESTRIAN SIGNAL HEAD, TYPE A	8	7890 0010	BLACK TUNNEL VISORS BLACK ALUMINUM HOUSINGS
02894. 006 EACH	VEHICULAR SIGNAL HEAD, THREE 8" SECTIONS	1	15	BLACK TUNNEL VISORS BLACK ALUMINUM HOUSINGS BLACK METAL LOUVERED BACKPLATE
02895. 002 EACH	ACCESSIBLE PEDESTRIAN SIGNALS	8	11234 5678	

TRAFFIC SIGNAL SUPPORTS **

	ITEM NUMBER		Å		NO		ET		MAST ARM				PEDESTAL		L										
POLE NO.	E W	DESCRIPTION	QTY.	ROUTE	ATI	SIDE	ES						ARM	"A"						_ A	RM "	C "	SHAFT	SIGN	1AL
	_				ST	0,	OF	Н	К		SIGN	IAL L	OCATIO	:	SIGN	LOC	AT I O	N	w	G	X	7	н	м	N.
	UNIT									_	М	N	0 P	R	S	T	U	Υ	"	G	^		г	M	IN
\triangle	02892. 204 EACH	TRAFFIC SIGNAL SUPPORT, 24' MAST ARM WITH LUMINAIRE ARM (30' MOUNTING HEIGHT), PAINTED BLACK	1	FORBES AVE	156+26	RT	22′	17′	10′	24′	21′	10′		18′	14′	6′		0′	0°	6′	30′	0°			
<u> </u>	02892. 604 EACH	TRAFFIC SIGNAL SUPPORT, 28' MAST ARM, PAINTED BLACK	1	FORBES AVE	155+71	RT	23′	17′	10′	28′	24′	16′		20′				8′	270	•					
<u> </u>	02892. 003 EACH	TRAFFIC SIGNAL SUPPORT, 15' TYPE X, PAINTED BLACK	1	FORBES AVE	155+69	LT	20′																15′		10′
4	02892. 207 EACH	TRAFFIC SIGNAL SUPPORT, 30' MAST ARM WITH LUMINAIRE ARM (30' MOUNTING HEIGHT), PAINTED BLACK	1	FORBES AVE	156+29	LT	19′	17′	10′	30′	27′	19′		23′	15′			10′	270	6′	30′	90°			

** REFER TO PENNDOT TC-8800 TRAFFIC STANDARDS-SIGNALS FOR LETTER DESIGNATION

Gulf Tower 707 Grant Street 5th Floor Pittsburgh, PA 15219



THE PREPARATION OF THIS
DOCUMENT HAS BEEN FINANCED IN
PART THROUGH A GRANT FROM THE
FEDERAL TRANSIT ADMINISTRATION,
U.S. DEPARTMENT OF
TRANSPORTATION, UNDER THE
URBAN MASS TRANSPORTATION ACT
OF 1964, AS AMENDED, FOR THE
PORT AUTHORITY OF ALLEGHENY
COUNTY, PENNSYLVANIA.

					12-	-331
DESIGNED	<u>LJF</u>	PORT AUTHOR	ITY OF AL	LEGHENY (COUNTY	,
DRAWN	<u>WLZ</u>	PITTSBURGH		F	PENNSYLVANIA	ı
CHECKED	MSF	BUS RAPID TE	RANSIT UPT	OWN TO OA	KLAND	
IN CHARGE	<u>LJF</u>		SIGNAL PI	_ANS		
DATE	05/01/24	TRAF	FIC SIGNAL T	ABULATIONS		
SCALE	AS SHOWN	Port Authority	CONTR	RACT NO. BR	T-001	
′	AU ULIOVVIA	connecting people to life	DWG. NO.	SG121	SHT.	1181

FORBES AVENUE AND MILTENBERGER STREET

TRENCH, CONDUIT, JUNCTION BOX, ELECTRICAL ITEMS

DESCRIPTION	ELECTRICAL SERVICE, TYPE C (NEW)	CITY OF PITTSBURGH STANDARD CONCRETE JUNCTION BOX, TYPE 1	TRENCH AND BACKFILL, TYPE II	TRENCH AND BACKFILL, TYPE IV	2 INCH CONDUIT	3 INCH CONDUIT	AWG 8, UNDERGROUND CABLE, COPPER, 1 CONDUCTOR	SIGNAL CABLE, 14 AWG, 5 CONDUCTOR	SIGNAL CABLE, 14 AWG, 7 CONDUCTOR
ITEM NUMBER	02896	02897	02898	02898	02899	02899	02900	02900	02900
TIEM NUMBER	004	001	002	005	002	003	001	002	003
UNIT	EACH	EACH	LF	LF	LF	LF	LF	LF	LF
LOCATION									
CC TO S1			10		20	40			
S1 T0 1		1	25	24	49	98			
1 TO 2		1	18	29	47	94			
<u>↑</u> TO 51			14		28	28			
<u>∕</u> 2 TO §1			34	*35	69	138			
<u>√3</u> TO 2			14			14			
<u>√4</u> TO 1			6		6	12			
COMPLETE INTERSECTION	1						370	505	790
TOTAL	1	2	121	53	219	424	370	505	790

^{*} TYPE IV TRENCH TABULATED AS PART OF THE SYSTEMS PLAN.

SIGNS

SYMBOL	SERIES	SIZE	AREA EACH (SQ FT)	DESCRIPTION	QUANTITY	02891,001 POST MOUNTED SIGNS, TYPE B	۵.	02891,007 STRUCTURE MOUNTED FLAT SHEET ALUMINUM SIGNS WITH STIFFENERS
						SF	SF	SF
A	R5-1	30"x30"	6.3	DO NOT ENTER	2		12.6	
В	R6-1R	36"x12"	3.0	ONE WAY (TWO SIDED, CITY STANDARD)	2		6.0	
C	R3-2	30"x30"	6.3	NO LEFT TURN	1			6.3
D	R3-2	24"x24"	4.0	NO LEFT TURN	2	4.0	4.0	
€	R3-1	30"x30"	6.3	NO RIGHT TURN	1			6.3
Ð	R3-1	24"x24"	4.0	NO RIGHT TURN	2	4.0	4.0	
G	D3-4**	90"x24"	15.0	100 Uptown 200 Miltenberger St	1			15.0
(1)	D3-4 *	78"×24"	13.0	1800 Uptown 1700 Forbes Ave	1			13.0
1	D3-4 *	78 "x24"	13.0	1700 Uptown 1800 Forbes Ave	1			13.0
O	R10-3E(MOD)	9"×15"	0.9	EDUCATIONAL PUSH BUTTON FOR WALK SIGNAL WITH COUNTDOWN TIMER (MOD)	8		A	
K	R3-11B(MOD)	30"x36"	7.5	RIGHT LANE - BUSES ONLY	1			7.5
0	SS-1	30"×18"	3.8	EXCEPT RIGHT TURNS	1			3.8
M	R10-11	30"x36"	7.5	NO TURN ON RED	2			15.0
N	R10-15AL	30"x30"	6.3	TURNING TRAFFIC MUST YIELD TO BIKE AND PEDESTRIANS	2	6.3		6.3
				TOTAL		14.3	26.6	86.2

▲ - INCIDENTAL TO ITEM 02895.002

- * WHITE REFLECTORIZED LEGEND AND BORDER ON BLUE REFLECTORIZED BACKGROUND.
 UTILIZE 4" CLEARVIEW 3W FOR BLOCK/NEIGHBORHOOD AND 8" CLEARVIEW 3W FOR
 STREET NAME. ACTUAL WIDTH DETERMINED BY LETTER SPACING. COORDINATE BLOCK
 NUMBERS AND STREET NAME DETAILS WITH CITY OF PITTSBURGH DEPARTMENT OF
 MOBILITY AND INFRASTRUCTURE.
- ** WHITE REFLECTORIZED LEGEND AND BORDER ON BLUE REFLECTORIZED BACKGROUND.
 UTILIZE 4" CLEARVIEW 3W FOR BLOCK/NEIGHBORHOOD AND 8" CLEARVIEW 2W FOR
 STREET NAME. ACTUAL WIDTH DETERMINED BY LETTER SPACING. COORDINATE BLOCK
 NUMBERS AND STREET NAME DETAILS WITH CITY OF PITTSBURGH DEPARTMENT OF
 MOBILITY AND INFRASTRUCTURE.

AECOM 707 Grant Street

5th Floor

Pittsburgh, PA 15219



THE PREPARATION OF THIS DOCUMENT HAS BEEN FINANCED IN PART THROUGH A GRANT FROM THE FEDERAL TRANSIT ADMINISTRATION, PEDERAL TRANSIT ADMINISTRATION,
U.S. DEPARTMENT OF
TRANSPORTATION, UNDER THE
URBAN MASS TRANSPORTATION ACT
OF 1964, AS AMENDED, FOR THE
PORT AUTHORITY OF ALLEGHENY
COUNTY, PENNSYLVANIA. NO. DATE DESCRIPTION REVISIONS

(NOT FOR CONSTRUCTION)

DESIGNED	<u>LJF</u>	
DRAWN	<u>WLZ</u>	
CHECKED	MSF	
IN CHARGE	<u>LJF</u>	
DATE	05/01/24	
SCALE		
	AS SHOWN	

TS-331 PORT AUTHORITY OF ALLEGHENY COUNTY

BUS RAPID TRANSIT UPTOWN TO OAKLAND SIGNAL PLANS TRAFFIC SIGNAL TABULATIONS

Port Authority

CONTRACT NO. BRT-001 DWG. NO. SG122 sнт. 1182

S1 - TABULATED ON SYSTEMS PLAN

Gulf Tower 707 Grant Street 5th Floor Pittsburgh, PA 15219

ENGINEERING 595 Skippack Pk,

Suite 400

Blue Bell, PA 19422

NO. DATE DESCRIPTION REVISIONS

COUNTY, PENNSYLVANIA.

N CHARGE EMC DATE 05/01/24 SCALE AS SHOWN

DATE PORT AUTHORITY OF ALLEGHENY COUNTY PENNSYLVANIA

TS-713

DATE

BUS RAPID TRANSIT UPTOWN TO OAKLAND SIGNAL PLANS


FORBES AVENUE & GIST STREET

CONTRACT NO. BRT-001 **Port Authority** SG123 sнт. 1183 DWG. NO.

FEDERAL TRANSIT ADMINISTRATION U.S. DEPARTMENT OF TRANSPORTATION, UNDER THE URBAN MASS TRANSPORTATION ACT OF 1964, AS AMENDED, FOR THE PORT AUTHORITY OF ALLEGHENY

CONSTRUCTION

		HOVEMENT & THASTNO AND SEC									
		PH	IASE	6			PHA	SE	4+8		
		BIKE BUS BIKE								HLANHIZG FLANHIZG	
SIGNAL	1	2	3	4	5	1	2	3	4	5	
1-2-7	G	G	Υ	R		R	R	R	R	R	R
3-4-5-6	R	R	R	R		R	G	G	Υ	R	R
8-9-10-11	W	FD	DW	DW		DW	DW	DW	DW	DW	0FF
12-13-14-15	DW	DW	DW	DW		W	W	FD	DW	DW	OFF
FIXED	>	\leq	3.5	2.5			><	\leq	4.0	2.0	
MINIMUM	15						7				
PASSAGE	3						3				
FREE (MAX)	60						25				
PEDESTRIAN	7	10				3	4	12			
MEMORY		PED	REC	CALL			PED	REC	CALL		

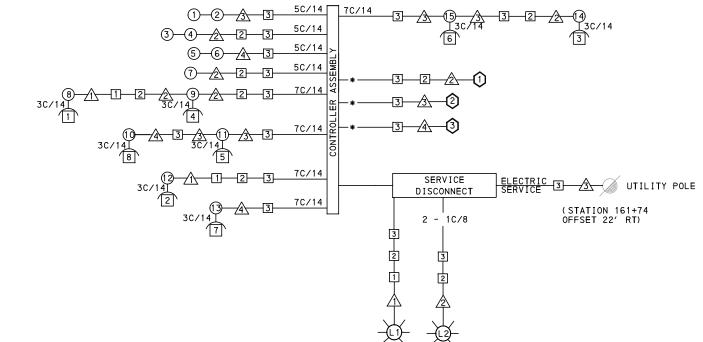

DETECTOR ZONE INFORMATION

DETECTOR	DETECTION ZONE(S)	MODE	TYPE	ROUTE	PHASE	LOCATION MAST ARM
1	(1) (11' x 60')	PRESENCE	VIDEO (STOP BAR)	GIST ST.	4	2
2	② (6' × 60')	PRESENCE	VIDEO (STOP BAR)	FORBES AVE.	6	<u>\$</u>
2	③ (7'× 60')	PRESENCE	VIDEO (STOP BAR)	FORBES AVE.	6	<u>3</u>
3	⟨4⟩ (6′ × 60′)	PRESENCE	VIDEO (STOP BAR)	GIST ST.	8	4

WIRING DIAGRAM

5C/14 - CABLE(NO. OF CONDUCTORS/SIZE AWG.)

SIGNAL HEAD

∧ SIGNAL SUPPORT

RADAR DETECTOR

AUDIBLE PEDESTRIAN | JUNCTION BOX

-LU-LUMINAIRE

INCIDENTAL TO ITEM 02895.001, AS PER MANUFACTURERS SPECIFICATIONS 3C/14 INCIDENTAL TO ITEM 02895.002

GENERAL NOTES

THE CITY OF PITTSBURGH SHALL INSPECT THE NEW SIGNAL EQUIPMENT PRIOR TO ACTIVATION.

ALL TRAFFIC SIGNAL MAINTENANCE AND OPERATION RESPONSIBILITIES SHALL BE TURNED OVER TO THE CITY OF PITTSBURGH AFTER THE FOLLOWING CONDITIONS ARE IMPLEMENTED TO THE CITY'S SATISFACTION:

- 1. PERMIT "AS-BUILT" TRAFFIC SIGNAL DRAWINGS ARE SUBMITTED AND APPROVED.
- 2. ALL PUNCH LIST ITEMS ARE COMPLETED BY THE CONTRACTOR.
- 3. AFTER THE 30-DAY CONTINUOUS UNINTERRUPTED SIGNAL OPERATION WITHOUT MALFUNCTIONS.

CONSTRUCTION NOTES

- 1. ALL JUNCTION BOXES IN WALK AREAS TO BE CITY OF PITTSBURGH STANDARD CONCRETE JUNCTION BOX, TYPE 1.
- 2. ALL JUNCTION BOXES IN NON-WALK AREAS TO BE CITY STANDARD JB-2 WITH BOTTOM.
- 3. THERE SHALL BE NO SIGNAL WIRE OR FIBER CABLE SPLICING.
- 4. SERVICE WIRE FROM THE POWER SOURCE TO THE CONTROLLER CABINET SHALL BE PLACED IN SECONDARY SEPARATE CONDUIT.
- 5. STREET LIGHT CABLE IS NOT PERMITTED TO RUN THROUGH THE CONTROLLER CABINET AND SHALL BE PLACED IN SEPARATE CONDUIT.
- 6. TRAFFIC SIGNAL CABLE SHALL BE PLACED IN DEDICATED CONDUIT.
- 7. MOUNT DISCONNECT ON POLE NEAREST TO THE CONTROLLER CABINET EXCLUDING TYPE X POLES.
- 8. REMOVE AND DISPOSE OF ALL EXISTING SIGNAL WIRING NO LONGER IN USE.
- 9. REMOVE EXISTING SIGNAL EQUIPMENT NO LONGER IN USE AND RETURN TO THE CITY OF PITTSBURGH TRAFFIC CONTROL SHOP. COORDINATE DELIVERY OF EQUIPMENT WITH DELMAS MCELHANY, TRAFFIC CONTROL FOREMAN.

COUNTY: ALLEGHENY

10. CONTRACTOR IS TO MAINTAIN VEHICULAR SIGNAL HEAD VISIBILITY AT ALL TIMES DURING CONSTRUCTION.

TRANSIT PRIORITY PRE-EMPTION NOTES (TO BE INSTALLED BY OTHERS)

- COORDINATE TRAFFIC CONTROLLER PROGRAMMING MODIFICATION WITH REPRESENTATIVES OF THE CITY OF PITTSBURGH AND DISTRICT TRAFFIC UNIT.
- 2. INCLUDE A TRANSIT PRIORITY PHASE THAT WILL EXTEND THE INDICATED PHASE A MAXIMUM OF 10 SECONDS WHEN ACTIVATED BY A PORT AUTHORITY VEHICLE. DO NOT VIOLATE SIDE STREET PEDESTRIAN MINIMUM TIMINGS.
- 3. MAINTAIN ALL YELLOW CLEARANCES AT ALL TIMES.
- 4. PROCEED TO THE SUBSEQUENT INTERVAL AS DEFINED IN THE MOVEMENT, SEQUENCE AND TIMING DIAGRAM UPON COMPLETING THE GREEN EXTENSION INTERVAL.
- 5. ONCE A TRANSIT CALL IS PLACED AND SATISFIED, THE CONTROLLER WILL NOT SATISFY ANOTHER CALL FOR
- 6. LOCATION OF BUS DETECTORS ARE TO BE FIELD ADJUSTED TO ACHIEVE MAXIMUM OPERATION.

AECOM

Gulf Tower 707 Grant Street 5th Floor Pittsburgh, PA 15219 ((₁DRIVE **ENGINEERING** 595 Skippack Pk, Suite 400

Blue Bell, PA 19422

THE PREPARATION OF THIS DOCUMENT HAS BEEN FINANCED IN PART THROUGH A GRANT FROM THE FEDERAL TRANSIT ADMINISTRATION U.S. DEPARTMENT OF TRANSPORTATION, UNDER THE URBAN MASS TRANSPORTATION ACT OF 1964 AS AMENDED FOR THE NO. DATE DESCRIPTION COUNTY, PENNSYLVANIA. REVISIONS

(NOT FOR CONSTRUCTION)

MW	
MW	
<u>EMC</u>	
<u>EMC</u>	
05/01/24	
AS SHOWN	
	MW EMC EMC 05/01/24

PITTSBURGH

DISTRICT TRAFFIC ENGINEER DATE PORT AUTHORITY OF ALLEGHENY COUNTY PENNSYLVANIA

MUNICIPALITY: CITY OF PITTSBURGH

INTERSECTION: FORBES AVENUE AND GIST STREET

APPROVED AND ACCEPTED:

CITY TRAFFIC ENGINEER

APPROVED AND ACCEPTED:

BUS RAPID TRANSIT UPTOWN TO OAKLAND SIGNAL PLANS WIRING, MOVEMENT, PHASING & SEQUENCE DIAGRAMS

Port Authority

CONTRACT NO. BRT-001 DWG. NO. SG124 sнт. 1184

TS-713

DATE

TRAFFIC	SIGNAL	TABULATION
	FORBES AVE	

DETECTORS

I TEM NUMBER	DESCRIPTION	SEN. NO.	QTY.	LOCATION
02895 . 001	VIDEO DETECTION	000	3	2 3 4
EACH		~ ~ ~		

ITEM NUMBER	MISCELLA	NEOU	S	
UNIT	DESCRIPTION	QTY.	LOCATION	REMARKS
01882 .002 EACH	TRAFFIC SIGNAL TIMING MODIFICATIONS	2	СС	
02890. 001 EACH	TRAFFIC SIGNAL CONTROLLER ASSEMBLY, TYPE 2070 LC, WITH TYPE 332 BASE MOUNTED CABINET	1	СС	332 CONTROLLER CABINET 8" RISER
02890. 003 EACH	ETHERNET SWITCH	1	СС	
02890. 005 EACH	GPS TIME CLOCK	1	СС	
02894. 001 EACH	VEHICULAR SIGNAL HEAD, THREE 12" SECTIONS	6	123 456	BLACK TUNNEL VISORS BLACK ALUMINUM HOUSINGS BLACK METAL LOUVERED BACKPLATE
02894. 005 EACH	LED COUNTDOWN PEDESTRIAN SIGNAL HEAD, TYPE A	8	8901 12131315	BLACK TUNNEL VISORS BLACK ALUMINUM HOUSINGS
02894. 006 EACH	VEHICULAR SIGNAL HEAD, THREE 8 " SECTIONS	1	7	BLACK TUNNEL VISORS BLACK ALUMINUM HOUSINGS
02895. 002 EACH	ACCESSIBLE PEDESTRIAN SIGNALS	8	11234 5678	
02889. 002 EACH	LED LUMINAIRE CITY STANDARD, BLACK	2	\(\)	<u> </u>
02212. 009 EACH	POLE FOUNDATION DRILLING, LESS THAN 30" DIAMETER	9	\triangle	
02212. 010 EACH	POLE FOUNDATION DRILLING, 30" DIAMETER OR GREATER	34	234	

TRAFFIC SIGNAL SUPPORTS **

	WZ W				NO		_							MAST	ARM									PEDE	≣STAL	-
POLE NO.	ITEM	DESCRIPTION	QΤΥ.	ROUTE	ΑŢΙ	SIDE	FFSE							ARM	"A "						Al	RM "(2"	SHAFT	SIG	NAL
					ST		9P	н	K	ı	SIG	NAL	LOCA	TION	5	SIGN	LOCA	0174	N	w	G	x	Z	Н	м	N
	UNIT									_	М	N	0	Р	R	S	T	U	Υ							
\triangle	02892. 005 EACH	TRAFFIC SIGNAL SUPPORT, 30' TYPE X-L WITH LUMINAIRE ARM, PAINTED BLACK	1	FORBES AVE.	161+12	LŤ	26′														6′	30′	90°	30′		10'
2	02892. 202 EACH	TRAFFIC SIGNAL SUPPORT, 20' MAST ARM WITH LUMINAIRE ARM, 30' MOUNTING, PAINTED BLACK	1	FORBES AVE.	161+55	LT	30′	17′	10′	20′	17′	7′			14′	10′			2′	270°	6′	30′	0°			
3	02892. 611 EACH	TRAFFIC SIGNAL SUPPORT, 30' MAST ARM, PAINTED BLACK	1	FORBES AVE.	161+68	RT	24'	17′	10′	30′	23′	12′			20′	8′			3′	0°						
4	02892. 611 EACH	TRAFFIC SIGNAL SUPPORT, 30' MAST ARM, PAINTED BLACK	1	FORBES AVE.	161+09	RT	22′	17′	10′	30′	26′	14′			23′				7	270°						

^{**} REFER TO PENNDOT TC-8800 TRAFFIC STANDARDS - SIGNALS FOR LETTER DESIGNATION

AECOM

Gulf Tower 707 Grant Street 5th Floor Pittsburgh, PA 15219 ((* DRIVE ENGINEERING 595 Skippack Pk, Suite 400 Blue Bell, PA 19422

			PART THROUGH A GRANT FROM THE FEDERAL TRANSIT ADMINISTRATION, U.S. DEPARTMENT OF TRANSPORTATION, UNDER THE URBAN MASS TRANSPORTATION ACT OF 1964. AS AMENDED. FOR THE
NO.	DATE	DESCRIPTION	PORT AUTHORITY OF ALLEGHENY
		REVISIONS	COUNTY, PENNSYLVANIA.

ESIGNED	MW	PORT AUTHOR	ITY OF A	LLEGHENY CO	UNT
RAWN	MW	PITTSBURGH		PENI	ISYLVANI
HECKED	EMC	BUS RAPID TF	RANSIT UP	TOWN TO OAKL	.AND
I CHARGE	EMC		SIGNAL P	LANS	
ATE	05/01/24	TRAF	FIC SIGNAL	TABULATIONS	
CALE	AS SHOWN	Port Authority	CONTI	RACT NO. BRT-0	01
,	AU ULIUVIII	connecting people to life	DWG. NO.	SG125	SHT.

TRENCH, CONDUIT, JUNCTION BOX, ELECTRICAL ITEMS

	KENCH	, 0011	, 1100	00110	11011			RICAL	. 115	
DESCRIPTION	2 INCH CONDUIT	3 INCH CONDUIT	TRENCH AND BACKFILL, TYPE I	TRENCH AND BACKFILL, TYPE II	TRENCH AND BACKFILL, TYPE IV	AWG 8, UNDERGROUND CABLE, COPPER, 1 CONDUCTOR	SIGNAL CABLE, 14 AWG, 5 CONDUCTOR	SIGNAL CABLE, 14 AWG, 7 CONDUCTOR	ELECTRICAL SERVICE TYPE C (NEW)	CITY OF PITTSBURGH STANDARD CONCRETE JUNCTION BOX, TYPE 1
ITEM NUMBER	02899	02899	02898	02898	02898	02900	02900	02900	02896	02897
TTEM NOMBER	002	003	001	002	005	001	002	003	004	001
UNIT	LF	LF	LF	LF	LF	LF	LF	LF	EACH	EACH
LOCATION										
CC TO 3	10	10	5							1
3 TO 2	53	106	29		24					1
2 TO 1	60	120	30		30					1
	7	7	7							
<u>∕2</u> TO 2	10	20	10							
<u>∕</u> 3 то 3	14	14	14							
<u>4</u> TO 3	30	60	30		35					
CC TO S1		18	9							
ELECTRICAL SERVICE (STA 161+74, TO 3 OFFSET 22' RT)										
COMPLETE INTERSECTION						345	556	894	1	
TOTAL	220	355	134		89	345	556	894	1	3

S1 - TABULATED ON SYSTEMS PLAN

TRAFFIC SIGNAL TABULATION

FORBES AVENUE AND GIST STREET

SIGNS

SERIES SIZE AREA DESCRIPTION SUBJECT SUBJEC									
A R10-11 30"×36" 7.5 NO TURN ON RED 2 15 A D R10-3E(MOD) 9"×15" .9 EDUCATIONAL PUSH BUTTON FOR WALK SIGNAL WITH COUNTDOWN TIMER 8 A E R10-15AL 30"×30" 6.3 TURNING TRAFFIC MUST YIELD TO 2 6.3 6.3 H R10-11B(MOD) 30"×36" 7.5 RIGHT LANE - BUSES ONLY 1 7.5 I R3-2 30"×30" 6.3 NO LEFT TURN 1 6.3 I R3-1 30"×30" 6.3 NO RIGHT TURN 1 6.3 I SS-1 30"×18" 3.8 EXCEPT RIGHT TURN 1 3.8 I D3-4* 72"×24" 12 100 UPTOWN 200 GIST ST 1 12 I D3-4* 72"×24" 12 1800 UPTOWN 1900 FORBES AVE 1 12 I D3-4* 72"×24" 12 1900 UPTOWN 1800 FORBES AVE 1 12 I R5-1 30"×30" 6.3 DO NOT ENTER 2 12.6 I R3-2 24"×24" 4	SYMBOL	SERIES	SIZE	EACH	DESCRIPTION	QUANTITY	02891, OC POST MOUNTED TYPE B	POST	
▲ ① R10-3E(MOD) 9 "×15" .9 EDUCATIONAL PUSH BUTTON FOR WALK SIGNAL WITH COUNTDOWN TIMER 8 ▲ E R10-15AL 30 "×30" 6.3 TURNING TRAFFIC MUST YIELD TO 2 6.3 6.3 H R10-11B(MOD) 30 "×36" 7.5 RIGHT LANE - BUSES ONLY 1 7.5 I R3-2 30 "×30" 6.3 NO LEFT TURN 1 6.3 I R3-1 30 "×30" 6.3 NO RIGHT TURN 1 6.3 I SS-1 30 "×18" 3.8 EXCEPT RIGHT TURN 1 3.8 I D3-4* 72 "×24" 12 100 UPTOWN 200 GIST ST 1 12 I D3-4* 72 "×24" 12 1800 UPTOWN 1900 FORBES AVE 1 12 I D3-4* 72 "×24" 12 1900 UPTOWN 1800 FORBES AVE 1 12 I R5-1 30 "×30" 6.3 DO NOT ENTER 2 12.6 I R3-2 24 "×24" 4 NO LEFT TURN 1 4 I R3-1 24 "×24" 4 NO LEF							SF	SF	
R10-15AL 30 "x30" 6.3 SIGNAL WITH COUNTDOWN TIMER 6.3 G.3 G.3		R10-11	30 "x36 "	7.5	NO TURN ON RED	2			15
R10-15AL 30"x30" 6.3 BIKES AND PEDS 2 6.3 6.3 R10-11B(MOD)30"x36" 7.5 RIGHT LANE - BUSES ONLY 1 7.5 R3-2 30"x30" 6.3 NO LEFT TURN 1 6.3 R3-1 30"x30" 6.3 NO RIGHT TURN 1 6.3 S5-1 30"x18" 3.8 EXCEPT RIGHT TURN 1 3.8 N	▲ D	R10-3E(MOD)	9"x15"	. 9	SIGNAL WITH COUNTDOWN TIMER	8			A
□ R3-2 30"x30" 6.3 NO LEFT TURN 1 6.3 □ R3-1 30"x30" 6.3 NO RIGHT TURN 1 6.3 □ SS-1 30"x18" 3.8 EXCEPT RIGHT TURN 1 3.8 □ D3-4* 72"x24" 12 100 UPTOWN 200 GIST ST 1 12 □ D3-4* 72"x24" 12 1800 UPTOWN 1900 FORBES AVE 1 12 □ D3-4* 72"x24" 12 1900 UPTOWN 1800 FORBES AVE 1 12 □ R5-1 30"x30" 6.3 DO NOT ENTER 2 12.6 □ R3-2 24"x24" 4 NO LEFT TURN 1 4 □ R3-1 24"x24" 4 NO RIGHT TURN 1 4 □ R3-1 24"x24" 4 NO RIGHT TURN 1 4	E	R10-15AL	30 "x30 "	6.3	TURNING TRAFFIC MUST YIELD TO BIKES AND PEDS	2		6.3	6.3
R3-1 30 "x30" 6.3 NO RIGHT TURN 1 6.3	\oplus	R10-11B(MOD	30"×36"	7.5	RIGHT LANE - BUSES ONLY	1	7.5		
SS-1 30 "x18 " 3.8 EXCEPT RIGHT TURN 1 3.8 N	O O	R3-2	30"×30"	6.3	NO LEFT TURN	1			6.3
N	K	R3-1	30"×30"	6.3	NO RIGHT TURN	1			6.3
D3-4* 72 "x24" 12 GIST ST 1 12 1800 UPTOWN 1900 1 12 12 12 12 12 13 13		SS-1	30"×18"	3.8		1		3.8	
D3-4* 72 x24 12 FORBES AVE	N	D3-4*	72 "x24 "	12	GIST ST	1			12
□ R5-1 30"x30" 6.3 DO NOT ENTER 2 12.6 □ R3-2 24"x24" 4 NO LEFT TURN 1 4 □ R3-1 24"x24" 4 NO RIGHT TURN 1 4 TOTAL 15.5 22.7 69.9	P	D3-4*	72 "x24 "	12	FORBES AVE	1			12
NO LEFT TURN	R	D3-4**	72 "x24 "	12	1900 UPTOWN 1800 FORBES AVE	1			12
V R3-1 24"x24" 4 NO RIGHT TURN 1 4 TOTAL 15.5 22.7 69.9	1	R5-1	30 "x30 "	6.3	DO NOT ENTER	2		12.6	
TOTAL 15.5 22.7 69.9	0	R3-2	24"x24"	4	NO LEFT TURN	1	4		
1070 2077 1070	\bigcirc	R3-1	24 "x24 "	4		1	4		
							15.5	22.7	69.9

▲ - INCIDENTAL TO ITEM #02895.002

* WHITE REFLECTORIZED LEGEND AND BORDER ON BLUE REFLECTORIZED BACKGROUND.
UTILIZE 4" CLEARVIEW 3W FOR BLOCK/NEIGHBORHOOD AND 8" CLEARVIEW 3W FOR
STREET NAME. ACTUAL WIDTH DETERMINED BY LETTER SPACING. COORDINATE BLOCK
NUMBERS AND STREET NAME DETAILS WITH CITY OF PITTSBURGH DEPARTMENT OF
MOBILITY AND INFRASTRUCTURE.



Gulf Tower 707 Grant Street 5th Floor Pittsburgh, PA 15219



Blue Bell, PA 19422

\vdash			THE PREPARATION OF THIS
			DOCUMENT HAS BEEN FINANCED IN PART THROUGH A GRANT FROM THE
			FEDERAL TRANSIT ADMINISTRATION, U.S. DEPARTMENT OF
			TRANSPORTATION, UNDER THE
			URBAN MASS TRANSPORTATION ACT OF 1964, AS AMENDED, FOR THE
NO.	DATE	DESCRIPTION	PORT AUTHORITY OF ALLEGHENY COUNTY, PENNSYLVANIA.
		REVISIONS	COUNTY, FERRIST EVARIA.

DESIGNED	MW	PORT AUTHOR	ITY OF AL	LEGHENY COL	YTNL
DRAWN	<u>MW</u>	PITTSBURGH		PENNS	SYLVANIA
CHECKED	<u>EMC</u>	BUS RAPID TF	RANSIT UPT	OWN TO OAKLA	AND
IN CHARGE	<u>EMC</u>		SIGNAL PI		
DATE	<u>05/01/24</u>	TRAF	FIC SIGNAL T	ABULATIONS	
SCALE	AS SHOWN	Port Authority	CONTR	RACT NO. BRT-00)1
	AS SHOWN	connecting people to life	DWG. NO.	SG126	sнт. 1186


REVISIONS

SG127

sнт. 1187

DWG NO

						_						
	PHASE 6						PHASE 4+8					
	BIKE TO THE STATE OF THE STATE						BIKE-II II					
INTERVAL	1	2	3	4		1	2	3	4	5		
1-2-7	G	G	Υ	R		R	R	R	R	R	R	
3-4-5-6	R	R	R	R		R	G	G	Υ	R	R	
8-9-10-11	W	FD	DW	DW		DW	DW	DW	DW	DW	OFF	
12-13-14-15	DW	DW	DW	DW		W	W	FD	DW	DW	0FF	
FIXED	\wedge	<	3.5	2.5		$/ \setminus$	><	<	4	2		
MINIMUM	1	0					1	0				
PASSAGE	1.7	3					177	3				
FREE (MAX)	4	4					1	9				
PEDESTRIAN	7	11				3	4	10				
MEMORY		PED	REC	ALL			PED	REC	ALL			

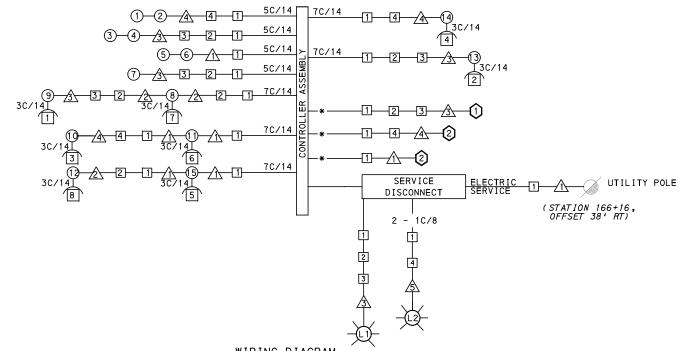

DETECTOR ZONE INFORMATION

DETECTOR	DETECTION ZONE(S)	MODE	TYPE	ROUTE	PHASE	LOCATION MAST ARM
1	(1) (11'× 60')	PRESENCE	VIDEO (STOP BAR)	JUMONVILLE ST.	4	3
2	② (6' × 60')	PRESENCE	VIDEO (STOP BAR)	FORBES AVE.	6	4
2	③ (7'× 60')	PRESENCE	VIDEO (STOP BAR)	FORBES AVE.	6	4
3	(4) (7' × 60')	PRESENCE	VIDEO (STOP BAR)	JUMONVILLE ST.	8	\triangle
3	⟨5⟩ (8′× 60′)	PRESENCE	VIDEO (STOP BAR)	JUMONVILLE ST.	8	\triangle

WIRING DIAGRAM

5C/14 - CABLE(NO. OF CONDUCTORS/SIZE AWG.)

SIGNAL HEAD

∧ SIGNAL SUPPORT

AUDIBLE PEDESTRIAN INDICATOR

☐ JUNCTION BOX

() RADAR DETECTOR

—(L1)—LUMINAIRE

3C/14 INCIDENTAL TO ITEM 02895.002 INCIDENTAL TO ITEM 02895.001 AS PER MANUFACTURERS SPECIFICATIONS

3C/14 INCIDENTAL TO ITEM 02895.002

GENERAL NOTES

THE CITY OF PITTSBURGH SHALL INSPECT THE NEW SIGNAL EQUIPMENT PRIOR TO ACTIVATION.

ALL TRAFFIC SIGNAL MAINTENANCE AND OPERATION RESPONSIBILITIES SHALL BE TURNED OVER TO THE CITY OF PITTSBURGH AFTER THE FOLLOWING CONDITIONS ARE IMPLEMENTED TO THE CITY'S SATISFACTION:

- 1. PERMIT "AS-BUILT" TRAFFIC SIGNAL DRAWINGS ARE SUBMITTED AND APPROVED.
- 2. ALL PUNCH LIST ITEMS ARE COMPLETED BY THE CONTRACTOR.
- 3. AFTER THE 30-DAY CONTINUOUS UNINTERRUPTED SIGNAL OPERATION WITHOUT MALFUNCTIONS.

CONSTRUCTION NOTES

- 1. ALL JUNCTION BOXES IN WALK AREAS TO BE CITY OF PITTSBURGH STANDARD CONCRETE JUNCTION BOX, TYPE 1.
- 2. ALL JUNCTION BOXES IN NON-WALK AREAS TO BE CITY STANDARD JB-2 WITH BOTTOM.
- 3. THERE SHALL BE NO SIGNAL WIRE OR FIBER CABLE SPLICING.
- 4. SERVICE WIRE FROM THE POWER SOURCE TO THE CONTROLLER CABINET SHALL BE PLACED IN SECONDARY SEPARATE CONDUIT.
- 5. STREET LIGHT CABLE IS NOT PERMITTED TO RUN THROUGH THE CONTROLLER CABINET AND SHALL BE PLACED IN SEPARATE CONDUIT.
- 6. TRAFFIC SIGNAL CABLE SHALL BE PLACED IN DEDICATED
- 7. MOUNT DISCONNECT ON POLE NEAREST TO THE CONTROLLER CABINET EXCLUDING TYPE X POLES.
- 8. REMOVE AND DISPOSE OF ALL EXISTING SIGNAL WIRING NO
- 9. REMOVE EXISTING SIGNAL EQUIPMENT NO LONGER IN USE AND RETURN TO THE CITY OF PITTSBURGH TRAFFIC CONTROL SHOP. COORDINATE DELIVERY OF EQUIPMENT WITH DELMAS MCELHANY, TRAFFIC CONTROL FOREMAN.
- 10. CONTRACTOR IS TO MAINTAIN VEHICULAR SIGNAL HEAD VISIBILITY AT ALL TIMES DURING CONSTRUCTION.

TRANSIT PRIORITY PRE-EMPTION NOTES (TO BE INSTALLED BY OTHERS)

- COORDINATE TRAFFIC CONTROLLER PROGRAMMING MODIFICATION WITH REPRESENTATIVES OF THE CITY OF PITTSBURGH AND DISTRICT TRAFFIC UNIT.
- 2. INCLUDE A TRANSIT PRIORITY PHASE THAT WILL EXTEND THE INDICATED PHASE A MAXIMUM OF 10 SECONDS WHEN ACTIVATED BY A PORT AUTHORITY VEHICLE. DO NOT VIOLATE SIDE STREET PEDESTRIAN MINIMUM TIMINGS.
- 3. MAINTAIN ALL YELLOW CLEARANCES AT ALL TIMES.
- 4. PROCEED TO THE SUBSEQUENT INTERVAL AS DEFINED IN THE MOVEMENT, SEQUENCE AND TIMING DIAGRAM UPON COMPLETING THE GREEN EXTENSION INTERVAL.
- 5. ONCE A TRANSIT CALL IS PLACED AND SATISFIED, THE CONTROLLER WILL NOT SATISFY ANOTHER CALL FOR
- 6. LOCATION OF BUS DETECTORS ARE TO BE FIELD ADJUSTED TO ACHIEVE MAXIMUM OPERATION.

AECOM

Gulf Tower 707 Grant Street 5th Floor Pittsburgh, PA 15219

ENGINEERING 595 Skippack Pk, Suite 400

THE PREPARATION OF THIS DOCUMENT HAS BEEN FINANCED IN PART THROUGH A GRANT FROM THE FEDERAL TRANSIT ADMINISTRATION U.S. DEPARTMENT OF TRANSPORTATION, UNDER THE URBAN MASS TRANSPORTATION ACT OF 1964 AS AMENDED FOR THE NO. DATE DESCRIPTION COUNTY, PENNSYLVANIA. REVISIONS

(NOT FOR CONSTRUCTION)

DESIGNED	MW	
DRAWN	MW	
CHECKED	EMC	
IN CHARGE	<u>EMC</u>	
DATE	05/01/24	
SCALE		
	AS SHOWN	

PORT AUTHORITY OF ALLEGHENY COUNTY PITTSBURGH

COUNTY: ALLEGHENY

BUS RAPID TRANSIT UPTOWN TO OAKLAND SIGNAL PLANS WIRING, MOVEMENT, PHASING & SEQUENCE DIAGRAMS

MUNICIPALITY: CITY OF PITTSBURGH

AND JUMONVILLE STREET

INTERSECTION: FORBES AVENUE

APPROVED AND ACCEPTED:

CITY TRAFFIC ENGINEER

APPROVED AND ACCEPTED:

DISTRICT TRAFFIC ENGINEER

Port Authority

CONTRACT NO. BRT-001 DWG. NO. SG128 sнт. 1188

TS-550

DATE

DATE

PENNSYLVANIA

Blue Bell, PA 19422

FORBES AVENUE AND JUMONVILLE STREET

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ITEM NUMBER	DESCRIPTION	SEN. NO.	QTY.	LOCATION
02895. 001 FACH	VIDEO DETECTION	000	3	1 3 4

ITEM NUMBER MISCELLANEOUS UNIT DESCRIPTION LOCATION REMARKS QTY. 01882 .002 TRAFFIC SIGNAL TIMING MODIFICATIONS CC EACH 02890. 001 TRAFFIC SIGNAL CONTROLLER ASSEMBLY, TYPE 2070 LC, WITH TYPE 332 BASE MOUNTED CABINET 332 CONTROLLER CABINET 8" RISER CC 02890. 003 ETHERNET SWITCH CC EACH 02890. CC 005 GPS TIME CLOCK EACH 02894. 001 VEHICULAR SIGNAL HEAD, THREE 12" SECTIONS BLACK TUNNEL VISORS BLACK ALUMINUM HOUSINGS BLACK METAL LOUVERED BACKPLATE 123 456 02894-005 EACH LED COUNTDOWN PEDESTRIAN SIGNAL HEAD, TYPE A 89101) 12131415 BLACK TUNNEL VISORS BLACK ALUMINUM HOUSINGS 02894**.** 006 VEHICULAR SIGNAL HEAD, THREE 8" SECTIONS BLACK TUNNEL VISORS BLACK ALUMINUM HOUSINGS 7 EACH 02895. 11234 5678 ACCESSIBLE PEDESTRIAN SIGNALS FACH 02889. \ ₫ & ₺ 002 LED LUMINAIRE CITY STANDARD, BLACK EACH 02212. 009 POLE FOUNDATION DRILLING, LESS THAN 30" DIAMETER 2 6 EACH 02212. 010 POLE FOUNDATION DRILLING, 30" DIAMETER $1\sqrt{3}$

TRAFFIC SIGNAL SUPPORTS **

	Ω Ω				NO		_							MAST	ARN	И								PEDE	ESTAL	-
POLE NO.	ITEM	DESCRIPTION	QTY.	ROUTE	ATIC	SIDE	FFSE							ARM	"A"						Α	₹M "	C "	SHAFT	SIG	NAL
	_				ST	0,	- R	н	К		SIG	NAL I	_OCA	TION		SIGN	LOC	ATIO	N	w	G	x	z	н	м	N
	UNIT										М	N	0	Р	R	S	Т	U	Y	ļ						
\triangle	02892. 604 EACH	TRAFFIC SIGNAL SUPPORT, 28' MAST ARM, PAINTED BLACK	1	FORBES AVE.	166+04	RT	23′	17′	10′	28′	28′	20′			23′	17′			8′	270°						
2	02892. 003 EACH	TRAFFIC SIGNAL SUPPORT, 15' TYPE X, PAINTED BLACK	1	FORBES AVE.	166+07	LT	26′																	15′		10′
3	02892. 203 EACH	TRAFFIC SIGNAL SUPPORT, 22' MAST ARM WITH LUMINAIRE ARM, 30' MOUNTING, PAINTED BLACK	1	FORBES AVE.	166+48	LT	31′	17′	10′	22′	15′	5′			19′	10′			2′	270°	6′	30′	0°			
4	02892. 209 EACH	TRAFFIC SIGNAL SUPPORT, 34' MAST ARM WITH LUMINAIRE ARM, 30' MOUNTING, PAINTED BLACK	1	FORBES AVE.	166+54	RT	33′	17′	10′	34′	32′	21′			28′	17′			12′	0°	6′	30′	0°			

** REFER TO PENNDOT TC-8800 TRAFFIC STANDARDS - SIGNALS FOR LETTER DESIGNATION

AECOM

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ENGINEERING 595 Skippack Pk, Suite 400

Blue Bell, PA 19422

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			URBAN MASS TRANSPORTATION ACT OF 1964, AS AMENDED, FOR THE
NO.	DATE	DESCRIPTION	PORT AUTHORITY OF ALLEGHENY COUNTY, PENNSYLVANIA.
		REVISIONS	COONTT, FENNSTEVANIA.

(NOT FOR CONSTRUCTION)

DESIGNED	MW	PO
DRAWN	MW	PITT
CHECKED	<u>EMC</u>	
IN CHARGE	<u>EMC</u>	
DATE	<u>05/01/24</u>	
SCALE	AS SHOWN	Port

ORT AUTHORITY OF ALLEGHENY COUNTY TTSBURGH PENNSYLVANIA BUS RAPID TRANSIT UPTOWN TO OAKLAND

SIGNAL PLANS TRAFFIC SIGNAL TABULATIONS

Authority

CONTRACT NO. BRT-001 DWG. NO. SG129 sнт. 1189

FORBES AVENUE AND JUMONVILLE STREET

TRENCH, CONDUIT, JUNCTION BOX, ELECTRICAL ITEMS

DESCRIPTION	ELECTRICAL SERVICE TYPE C (EXISTING)	CITY OF PITTSBURGH STANDARD CONCRETE JUNCTION BOX, TYPE 1	TRENCH AND BACKFILL, TYPE I	TRENCH AND BACKFILL, TYPE IV	2 INCH CONDUIT	3 INCH CONDUIT	AWG 8, UNDERCROUND CABLE, COPPER, 1 CONDUCTOR	SIGNAL CABLE, 14 AWG, 5 CONDUCTOR	SIGNAL CABLE, 14 AWG, 7 CONDUCTOR
ITEM NUMBER	02896	02897	02898	02898	02899	02899	02900	02900	02900
	003	001	001	005	002	003	001	002	003
UNIT	EACH	EACH	LF	LF	LF	LF	LF	LF	LF
LOCATION									
CC TO 1		1	6		12	24			
1 TO 4		1	18	*	53	106			
1 TO 2		1	16	24	40	80			
2 TO 3		1	32	32	64	128			
то □			5		10	10			
<u>∕</u> 2 TO 2			18			18			
<u></u> ₹ то 3			29		29	58			
<u></u> ★ TO 4			13		13	26			
S1 TO 1			5			10			
ELECTRICAL SERVICE (STA 166+16, TO OFFSET 38' RT)									
COMPLETE INTERSECTION	1						371	732	1010
TOTAL	1	4	142	56	221	460	371	732	1010

* - TYPE IV TRENCH TABULATED AS PART OF THE SYSTEMS PLAN

S1 - TABULATED ON SYSTEMS PLAN

SERIES	SIZE	AREA EACH (SQ FT)	DESCRIPTION	QUANTITY	POST MOUNTED SIGNS, TYPE B	POST MOUNTED SIGNS,	STRUCTURE MOUNTED FLAT SHEET ALUMINUM SIGNS WITH STIFFENERS
R10-11	30"×36"	7.5	NO TURN ON RED ●	3			22.5
R10-3E(MOD)	9"×15"	. 9	EDUCATIONAL PUSH BUTTON FOR WALK Signal with countdown timer	8			A
R6-1	36"×12"	3	ONE-WAY (TWO SIDED, CITY STANDARD)	2			6
SS-1	30"×18"	3.8	EXCEPT RIGHT TURNS	1		3.8	
R3-2	30"×30"	6.3	NO LEFT TURN	4		12.6	12.6
R3-1	30"x30"	6.3	NO RIGHT TURN	2		6.3	6.3
	R10-11 R10-3E(MOD) R6-1 SS-1 R3-2	R10-11 30 "x36 " R10-3E(MOD) 9 "x15 " R6-1 36 "x12 " SS-1 30 "x18 " R3-2 30 "x30 "	SERIES SIZE EACH (SQ FT) R10-11 30"x36" 7.5 R10-3E(MOD) 9"x15" .9 R6-1 36"x12" 3 SS-1 30"x18" 3.8 R3-2 30"x30" 6.3	SERIES SIZE EACH (SQ FT) R10-11 30"x36" 7.5 NO TURN ON RED R10-3E(MOD) 9"x15" .9 EDUCATIONAL PUSH BUTTON FOR WALK SIGNAL WITH COUNTDOWN TIMER R6-1 36"x12" 3 ONE-WAY (TWO SIDED, CITY STANDARD) SS-1 30"x18" 3.8 EXCEPT RIGHT TURNS R3-2 30"x30" 6.3 NO LEFT TURN	SERIES SIZE AREA EACH (SQ FT) DESCRIPTION SQ FT) DESCRIPTION SQ FT)	SERIES SIZE AREA EACH SQ FT) DESCRIPTION	SF SF SF SF SF SF SF SF

SIGNS

▲ - INCIDENTAL TO ITEM #02895.002

D3-4* 72"×24"

R5-1

D3-4*

D3-4*

M

P

R

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* WHITE REFLECTORIZED LEGEND AND BORDER ON BLUE REFLECTORIZED BACKGROUND.
UTILIZE 4" CLEARVIEW 3W FOR BLOCK/NEIGHBORHOOD AND 8" CLEARVIEW 3W FOR
STREET NAME. ACTUAL WIDTH DETERMINED BY LETTER SPACING. COORDINATE BLOCK
NUMBERS AND STREET NAME DETAILS WITH CITY OF PITTSBURGH DEPARTMENT OF
MOBILITY AND INFRASTRUCTURE.

R3-11B(MOD) 30"x36" 7.5 RIGHT LANE - BUSES ONLY

12

12

12

DO NOT ENTER

100 UPTOWN 200 JUMONVILLE ST

1900 UPTOWN 2000 FORBES AVE

2000 UPTOWN 1900 FORBES AVE

TOTAL

30"x30" 6.3

72 "x24 "

72 "x24 "



Gulf Tower 707 Grant Street 5th Floor Pittsburgh, PA 15219 ((* DRIVE ENGINEERING 595 Skippack Pk, Suite 400

Blue Bell, PA 19422

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			OF 1964, AS AMENDED, FOR THE
NO.	DATE	DESCRIPTION	PORT AUTHORITY OF ALLEGHENY COUNTY, PENNSYLVANIA.
		REVISIONS	COONTY, FEMNOTEVANIA.

(NOT FOR CONSTRUCTION)

DESIGNED	MW	PORT AUTHOR	ITY OF AL	LEGHENY C	OUNTY
DRAWN	MW	PITTSBURGH		Р	ENNSYLVANIA
CHECKED	EMC	BUS RAPID TF	RANSIT UPT	OWN TO OAI	KLAND
IN CHARGE	EMC		SIGNAL PL		
DATE	05/01/24	TRAF	FIC SIGNAL T	ABULATIONS	
SCALE	AS SHOWN	Port Authority	CONTR	ACT NO. BRT	-001
	AS SHOWN	connecting people to life	DWG. NO.	SG130	sнт. 119

1 7.5

4 18.9 6.3

12

12

12

26.4 29 83.4

707 Grant Street 595 Skippack Pk, 5th Floor Suite 400 Pittsburgh, PA 15219 Blue Bell, PA 19422

URBAN MASS TRANSPORTATION ACT OF 1964 AS AMENDED FOR THE NO. DATE DESCRIPTION COUNTY, PENNSYLVANIA. REVISIONS

CONSTRUCTION)

SIGNED	MW	
NWA	MW	
IECKED	EMC	
CHARGE	<u>EMC</u>	
TE	05/01/24	
ALE		
	AS SHOWN	

PORT AUTHORITY OF ALLEGHENY COUNTY PENNSYLVANIA

BUS RAPID TRANSIT UPTOWN TO OAKLAND SIGNAL PLANS

FORBES AVENUE & MOULTRIE STREET

CONTRACT NO. BRT-001 **Port Authority** SG131 DWG. NO. sнт. **1191**

		PHASE 6 PHASE 4+8									
	B I KI BUS	=	\ <u>\</u>	· 	3 I K E	l	KE_ US —		 	3 I K E	HL40H1ZG HL40H1ZG
INTERVAL	1	2	3	4	5	1	2	3	4	5	
1-2	G	G	Υ	R		R	R	R	R	R	R
3-4-5-6	R	R	R	R		R	G	G	Υ	R	R
7	G	G	Υ	R		R	R	R	R	R	R
8-9-10-11	W	FD	DW	DW		DW	DW	DW	DW	DW	0FF
12-13-14-15	DW	DW	DW	DW		W	W	FD	DW	DW	OFF
5.1VED		<u> </u>	4 0	2.0					4 5	2.5	
FIXED	15	$\overline{}$	4.0	2.0		_	7	\geq	4. 5	2.5	
MINIMUM	3	_					3				
PASSAGE	60						25				
FREE (MAX)						 		10			
PEDESTRIAN	7	14				3	4	10	<u> </u>		
MEMORY		PED	REC	CALL			PED	REC	CALL		

1	
72' *	ILITY POLE
WIRING DIAGRAM	

DETECTOR ZONE INFORMATION

DETECTOR	DETECTION ZONE(S)	MODE	TYPE	ROUTE	PHASE	LOCATION MAST ARM
①	(7' × 60')	PRESENCE	VIDEO (STOP BAR)	MOULTRIE ST.	4	<u> </u>
2	② (7′× 60′)	PRESENCE	VIDEO (STOP BAR)	FORBES AVE.	6	3
2	⟨3⟩ (8′× 60′)	PRESENCE	VIDEO (STOP BAR)	FORBES AVE.	6	<u> 3</u>
3	⟨4⟩ (7′ × 60′)	PRESENCE	VIDEO (STOP BAR)	MOULTRIE ST.	8	4

5C/14 - CABLE(NO. OF CONDUCTORS/SIZE AWG.)

SIGNAL HEAD

 $\hfill \square$ AUDIBLE PEDESTRIAN $\hfill \square$ JUNCTION BOX INDICATOR

—L1)—LUMINAIRE RADAR DETECTOR

INCIDENTAL TO ITEM 02895.001, AS PER MANUFACTURERS SPECIFICATIONS 3C/14 INCIDENTAL TO ITEM 02895.002

GENERAL NOTES

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- 2. ALL JUNCTION BOXES IN NON-WALK AREAS TO BE CITY STANDARD JB-2 WITH BOTTOM.
- 3. THERE SHALL BE NO SIGNAL WIRE OR FIBER CABLE SPLICING.
- 4. SERVICE WIRE FROM THE POWER SOURCE TO THE CONTROLLER CABINET SHALL BE PLACED IN SECONDARY SEPARATE CONDUIT.
- 5. STREET LIGHT CABLE IS NOT PERMITTED TO RUN THROUGH THE CONTROLLER CABINET AND SHALL BE PLACED IN SEPARATE CONDUIT.
- 6. TRAFFIC SIGNAL CABLE SHALL BE PLACED IN DEDICATED
- 7. MOUNT DISCONNECT ON POLE NEAREST TO THE CONTROLLER CABINET EXCLUDING TYPE X POLES.
- 8. REMOVE AND DISPOSE OF ALL EXISTING SIGNAL WIRING NO
- 9. REMOVE EXISTING SIGNAL EQUIPMENT NO LONGER IN USE AND RETURN TO THE CITY OF PITTSBURGH TRAFFIC CONTROL SHOP. COORDINATE DELIVERY OF EQUIPMENT WITH DELMAS MCELHANY, TRAFFIC CONTROL FOREMAN.

COUNTY: ALLEGHENY

TRANSIT PRIORITY PRE-EMPTION NOTES (TO BE INSTALLED BY OTHERS)

- COORDINATE TRAFFIC CONTROLLER PROGRAMMING MODIFICATION WITH REPRESENTATIVES OF THE CITY OF PITTSBURGH AND DISTRICT TRAFFIC UNIT.
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- 6. LOCATION OF BUS DETECTORS ARE TO BE FIELD ADJUSTED TO ACHIEVE MAXIMUM OPERATION.

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(NOT FOR CONSTRUCTION)

DESIGNED	MW	
DRAWN	<u>MW</u>	
CHECKED	EMC	
IN CHARGE	EMC	
DATE	05/01/24	
SCALE		
	AS SHOWN	

PORT AUTHORITY OF ALLEGHENY COUNTY PENNSYLVANIA BUS RAPID TRANSIT UPTOWN TO OAKLAND

MUNICIPALITY: CITY OF PITTSBURGH

AND MOULTRIE STREET

INTERSECTION: FORBES AVENUE

APPROVED AND ACCEPTED:

CITY TRAFFIC ENGINEER

APPROVED AND ACCEPTED:

DISTRICT TRAFFIC ENGINEER

SIGNAL PLANS WIRING, MOVEMENT, PHASING & SEQUENCE DIAGRAMS

Port Authority

CONTRACT NO. BRT-001 DWG NO SG132 sнт. 1192

TS-XXX

DATE

DATE

ITEM NUMBER	MISCELLA	NEOU	S				
UNIT	DESCRIPTION	QTY.	LOCATION	REMARKS			
01882	TRAFFIC SIGNAL TIMING MODIFICATIONS	2	СС				
EACH							
02890 . 001	TRAFFIC SIGNAL CONTROLLER ASSEMBLY, TYPE 2070 LC, WITH TYPE 332 BASE	1	cc	332 CONTROLLER CABINET			
EACH	MOUNTED CABINET		00	8" RISER			
02890 . 003	ETHERNET SWITCH	1	СС				
EACH							
02890 . 005	GPS TIME CLOCK	1	СС				
EACH							
02894 . 001	VEHICULAR SIGNAL HEAD, THREE 12" SECTIONS	6	1003	BLACK TUNNEL VISORS BLACK ALUMINUM HOUSINGS			
EACH	THIREE 12 SECTIONS		456	BLACK METAL LOUVERED BACKPLATE			
02894 . 004	BICYCLE SIGNAL HEAD, THREE 8" SECTIONS	1	7	BLACK TUNNEL VISORS BLACK ALUMINUM HOUSINGS			
EACH	1111/2E 0 3E0110113		,	BLACK METAL LOUVERED BACKPLATE			
02894 . 005	LED COUNTDOWN PEDESTRIAN SIGNAL HEAD,	8	8901 12131313	 BLACK TUNNEL VISORS BLACK ALUMINUM HOUSINGS			
EACH	TIFE A			BLACK ALUMINUM HOUSINGS			
02895. 002	ACCESSIBLE PEDESTRIAN SIGNALS	8	11213141 151161171181				

2

47

LED LUMINAIRE CITY STANDARD, BLACK

POLE FOUNDATION DRILLING, LESS THAN 30" DIAMETER

02212. 010 0R GREATER

TRAFFIC SIGNAL TABULATION

FORBES AVENUE AND MOULTRIE STREET

DETECTORS

ITEM NUMBER	DESCRIPTION	SEN. NO.	QTY.	LOCATION
02895. 001 EACH	VIDEO DETECTION	000	3	234

TRAFFIC SIGNAL SUPPORTS **

	¥ E E	DESCRIPTION		ROUTE	STATION	ATI	SIDE OFFSET	<u>.</u>		MAST ARM										PEDE	≣STAL	-				
POLE NO.	ITEM		QΤΥ.						ARM				"A"	"A "					ARM "C"		C "	SHAFT	SIG	NAL		
								н	K		SIG	NAL	LOCA	TION	:	SIGN	LOC	OITA	N	w	G	x	z	Н	м	N
	UNIT									_	М	N	0	Р	R	S	T	U	Υ	<u> </u>			_			
\triangle	02892. 005 EACH	TRAFFIC SIGNAL SUPPORT, 30'TYPE X-L WITH LUMINAIRE ARM, PAINTED BLACK	1	FORBES AVE.	175+08	LT	27′														6′	30′	0°	30′		10'
2	02892. 603 EACH	TRAFFIC SIGNAL SUPPORT, 24' MAST ARM, PAINTED BLACK	1	FORBES AVE.	175+56	LT	28′	17′	10′	24′	22′	12′			17′	6′			1′	270°						
3	02892. 605 EACH	TRAFFIC SIGNAL SUPPORT, 34, PAINTED BLACK	1	FORBES AVE.	175+60	RT	29′	17′	10′	34′	29′	17′			27′	20′			9′	0°						
4	02892. 204 EACH	TRAFFIC SIGNAL SUPPORT, 24' MAST ARM WITH LUMINAIRE ARM, 30' MOUNTING, PAINTED BLACK	1	FORBES AVE.	175+08	RT	27′	17′	10′	24′	23′	13′			19′				10′	270°	6′	30′	270°			

^{**} REFER TO PENNDOT TC-8800 TRAFFIC STANDARDS - SIGNALS FOR LETTER DESIGNATION

₩<u>₩</u>

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2/3/4

AECOM

EACH

EACH

707 Grant Street 5th Floor Pittsburgh, PA 15219

((DRIVE ENGINEERING 595 Skippack Pk, Suite 400 Blue Bell, PA 19422

			THE PREPARATION OF THIS DOCUMENT HAS BEEN FINANCED IN
			PART THROUGH A GRANT FROM THE
			FEDERAL TRANSIT ADMINISTRATION,
			U.S. DEPARTMENT OF TRANSPORTATION, UNDER THE
			URBAN MASS TRANSPORTATION ACT
			OF 1964, AS AMENDED, FOR THE
NO.	DATE	DESCRIPTION	PORT AUTHORITY OF ALLEGHENY COUNTY, PENNSYLVANIA.
		REVISIONS	COUNTY, PENNSTEVANIA.

(NOT FOR CONSTRUCTION)

DESIGNED	MW	PORT A
DRAWN	MW	PITTSBURGH
CHECKED	<u>EMC</u>	BUS R
N CHARGE	EMC	
DATE	<u>05/01/24</u>	
SCALE	AS SHOWN	Port Auth

AUTHORITY OF ALLEGHENY COUNTY RAPID TRANSIT UPTOWN TO OAKLAND SIGNAL PLANS TRAFFIC SIGNAL TABULATIONS

CONTRACT NO. BRT-001

DWG. NO. SG133 sнт. 1193

Authority connecting people to life

FORBES AVENUE AND MOULTRIE STREET

	INCINCII	,	,					INTOAL	
DESCRIPTION	2 INCH CONDUIT	3 INCH CONDUIT	TRENCH AND BACKFILL, TYPE I	TRENCH AND BACKFILL, TYPE IV	AWG 8, UNDERGROUND CABLE, COPPER, 1 CONDUCTOR	SIGNAL CABLE, 14 AWG, 5 CONDUCTOR	SIGNAL CABLE, 14 AWG, 7 CONDUCTOR	ELECTRICAL SERVICE TYPE C (NEW)	CITY OF PITTSBURGH STANDARD CONCRETE JUNCTION BOX, TYPE 1
ITEM NUMBER	02899	02899	02898	02898	02900	02900	02900	02896	02897
TIEM NOMBER	002	003	001	005	001	002	003	004	001
UNIT	LF	LF	LF	LF	LF	LF	LF	EACH	EACH
LOCATION									
CC TO 1	12	12	6						1
1 TO 2	55	96	24	31					1
2 TO 3	46	92	24	22					1
то [3]	2	2	2						
<u>∕2</u> TO 2	7	14	7						
<u>∕3</u> TO 1	2	4	2						
<u> </u>	54	108	30	24					
S1 TO CC		10	5						
ELECTRICAL SERVICE (STA 175+56, TO 1 OFFSET 20.2' RT)	12		12						
COMPLETE INTERSECTION					309	416	877	1	
TOTAL	190	338	112	77	309	416	877	1	3
	•	•	•	•		•	•	•	

SIGNS

				210112				
SYMBOL	SERIES	SIZE	AREA EACH (SQ FT)	DESCRIPTION	QUANTITY	02891,001 POST MOUNTED SIGNS, TYPE B	02891.003 POST MOUNTED SIGNS, TYPE F	02891,007 STRUCTURE MOUNTED FLAT SHEET ALUMINUM SIGNS WITH STIFFENERS
						SF	SF	SF
	R3-2	30 "x30 "	6.3	NO LEFT TURN	1			6.3
B	R10-11	30"x36"	7.5	NO TURN ON RED	2			15
	R3-1	30"x30"	6.3	NO RIGHT TURN	1			6.3
A D	R10-3E(MOD)	9"×15"	. 9	EDUCATIONAL PUSH BUTTON FOR WALK Signal With countdown timer	8			A
E	D3-4**	72 "x24 "	12	2100 UPTOWN 2200 FORBES AVE	1			12
<u>o</u>	D3-4*	72 "x24 "	12	OOO UPTOWN MOULTRIE ST	1			12
\oplus	R3-2	24"x24"	4	NO LEFT TURN	2		8	
O)	R3-1	24"×24"	4	NO RIGHT TURN	1	4		
K	R3-7R	30"×30"	7.5	RIGHT LANE - BUSES ONLY	1	7.5		
	SS-1	30"×18"	3.8	EXCEPT RIGHT TURN	1		3.8	
M	R10-15AL(MOD)	30"×30"	6.3	TURNING TRAFFIC MUST YIELD TO BIKES AND PEDS	2	6.3		6.3
N	D3-4*	72 "x24 "	12	BIKES AND PEDS 2200 UPTOWN 2100 FORBES AVE	1			12
R	R5-1	30"x30"	6.3	DO NOT ENTER	2	6.3	6.3	
	•	,		TOTAL		24.1	18.1	69.9

▲ - INCIDENTAL TO ITEM #02895.002

* WHITE REFLECTORIZED LEGEND AND BORDER ON BLUE REFLECTORIZED BACKGROUND.
UTILIZE 4" CLEARVIEW 3W FOR BLOCK/NEIGHBORHOOD AND 8" CLEARVIEW 3W FOR
STREET NAME. ACTUAL WIDTH DETERMINED BY LETTER SPACING. COORDINATE BLOCK
NUMBERS AND STREET NAME DETAILS WITH CITY OF PITTSBURGH DEPARTMENT OF
MOBILITY AND INFRASTRUCTURE.


AECOM

Gulf Tower 707 Grant Street 5th Floor Pittsburgh, PA 15219 ((DRIVE ENGINEERING 595 Skippack Pk, Suite 400

Blue Bell, PA 19422

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		U.S. DEPARTMENT OF
		TRANSPORTATION, UNDER THE
		URBAN MASS TRANSPORTATION AC
		OF 1964, AS AMENDED, FOR THE
DATE	DESCRIPTION	PORT AUTHORITY OF ALLEGHENY COUNTY, PENNSYLVANIA.
	REVISIONS	COUNTY, FENNSTEVANIA.

DESIGNED	MW	PORT AUTHOR	ITY OF AL	LEGHENY COL	JNTY				
DRAWN	MW	PITTSBURGH		PENNS	SYLVANIA				
CHECKED	EMC	BUS RAPID TRANSIT UPTOWN TO OAKLAND							
IN CHARGE	<u>EMC</u>	SIGNAL PLANS							
DATE	05/01/24	TRAF	FIC SIGNAL T	ABULATIONS					
SCALE AS SHOWN		Port Authority	CONTRACT NO. BRT-001						
^	SOLOWIN	connecting people to life	DWG. NO.	SG134	sнт. 11 9	94			

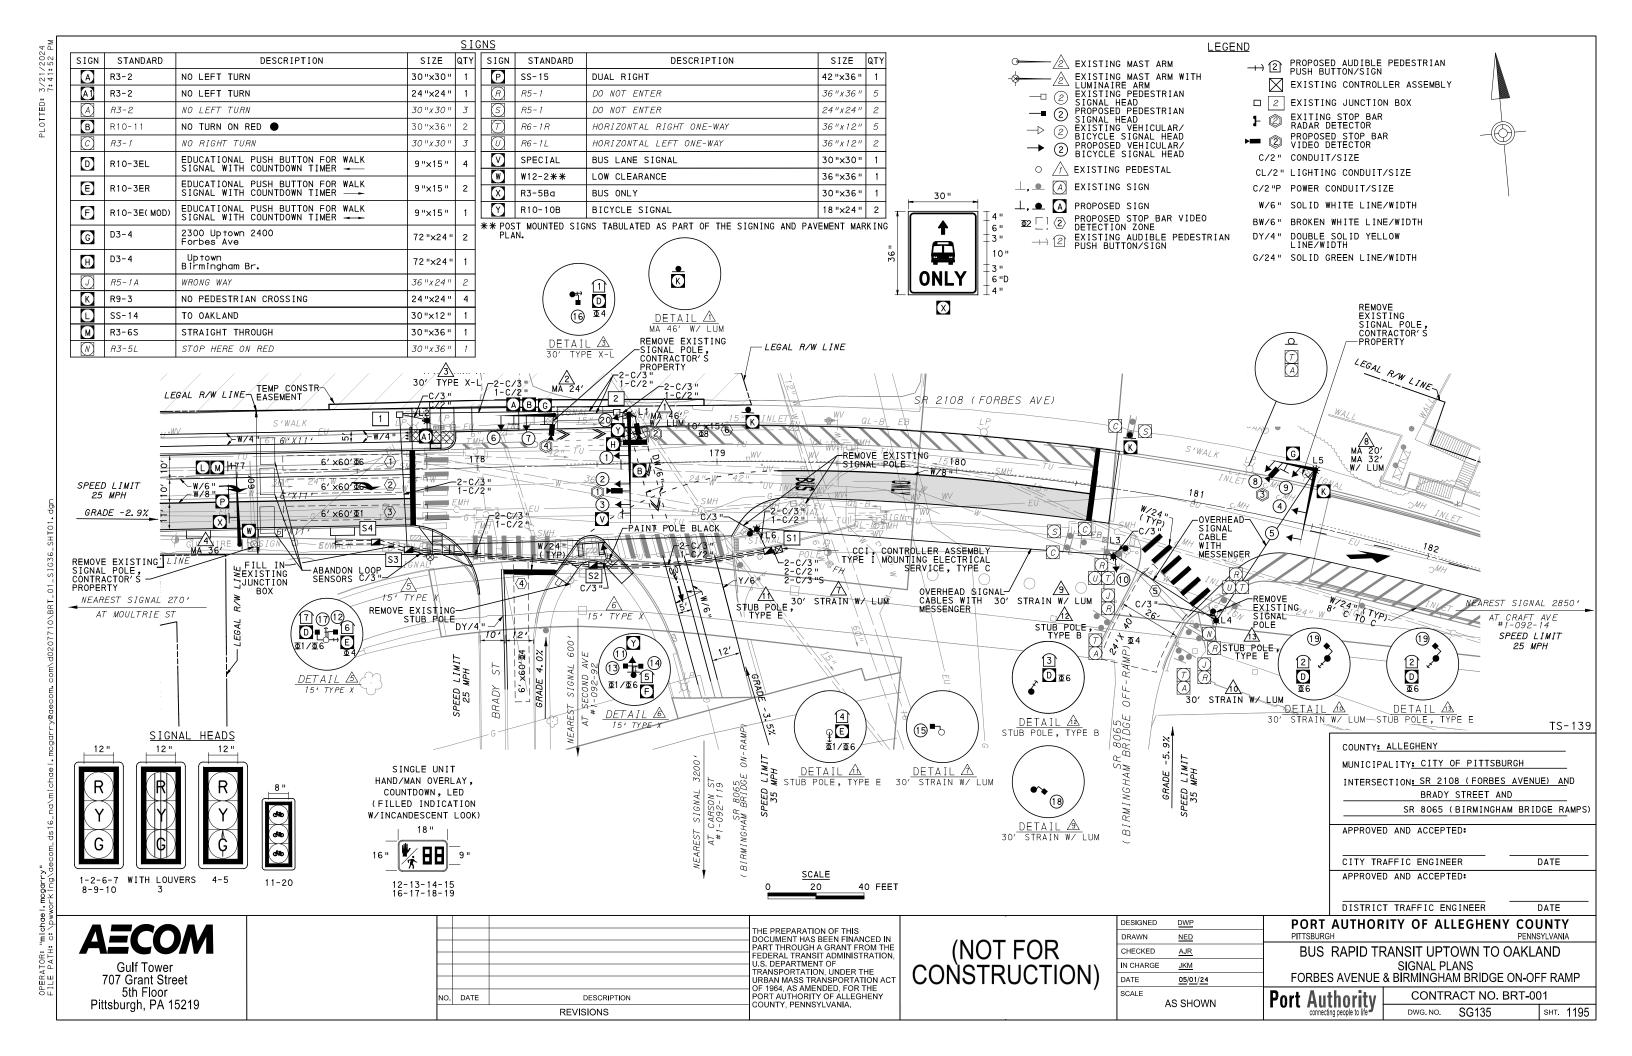

	MOVEMENT ; THASTNO AND SEQUENCE CHART																				
		PH (BUS	IASE S PH	1 ASE)			Pł	HASE	6		(B	PH ICY(IASE CLE	8 PHAS	SE)	PHASE 4					
	B I K E	\exists	- T	- 7		B I K E				- Ē	B I K <u>-</u> BUS-		_\ _B ,	J.	Γ	BIKI BUS	≓ ∃ ∃ ∃ 	h	- BUS−	+	HLANIHZG BZHIMPHH
SIGNAL	1	2	3			1	2	3	4		1	2	3			1	2	3	4		
1-2	R	R	R			G	G	Υ	R		R	R	R			R	R	R	R		R
3	G	Υ	R			R	R	R	R		R	R	R			R	R	R	R		R
4-5	G	G	G			G	G	Υ	R		R	R	R			R	R	R	R		R
6-7	R	R	R			R	R	R	R		R	R	R			G	G	Υ	R		R
8-9-10	R	R	R			R	R	R	R		R	R	R			G	G	Υ	R		R
11-20	R	R	R			R	R	R	R		G	Υ	R			R	R	R	R		0FF
12-13-14-15	W	W	W			W	FD	DW	DW		DW	DW	DW			DW	DW	DW	DW		0FF
16-17	DW	DW	DW			DW	DW	DW	DW		DW	DW	DW			W	FD	DW	DW		0FF
18-19	W	W	W			W	FD	DW	DW		DW	DW	DW			DW	DW	DW	DW		0FF
FIXED	X	3	2			>	\geq	3.5	2.5		\times	3	2			>		4	4		\vdash
MINIMUM	5										5					,	5				
PASSAGE																	4				
FREE (MAX)	10					9	0				5					2	2				
PEDESTRIAN	*	*				7	33									7	15				
MEMORY		NON	LOC	KING			MAX	REC	CALL			NON	LOC	KING	;		PED	REC	ALL		
* PEDESTRIAN PHASE STARTS HERE ONLY WHEN PHASE 1 IS CALLED AND WILL TERMINATE IN PHASE 6.																					

7C/14 51 A G A 51 52 A G A 62 53 7 2 1 53 52 51 5C/14 3 1 2 1 53 52 51 5C/14 5 4 8 10 9 A 51 5C/14 6 7 <u>2</u> 2 1 53 52 51 5C/14 51 52 53 <u>5</u> 0 <u>5</u> 53 11 <u>3</u> 6 3 5C/14 8 9 8 10 9 5C/14 ① 6 52 51 5C/14 (2) <u>A</u> 2 1 5 5 5 **

SERVICE POWER DISCONNECT AT STATION 479+36 OFFSET 18' RT 18' 2 - 1C/8 FORBES AVE S 1 51 51 52 /7\

GENERAL NOTES

THE CITY OF PITTSBURGH SHALL INSPECT THE NEW SIGNAL EQUIPMENT PRIOR TO ACTIVATION.

ALL TRAFFIC SIGNAL MAINTENANCE AND OPERATION RESPONSIBILITIES SHALL BE TURNED OVER TO THE CITY OF PITTSBURGH AFTER THE FOLLOWING CONDITIONS ARE IMPLEMENTED TO THE CITY'S SATISFACTION: 75\ 3C/14 17

- 1. PERMIT "AS-BUILT" TRAFFIC SIGNAL DRAWINGS ARE SUBMITTED AND APPROVED.
- 2. ALL PUNCH LIST ITEMS ARE COMPLETED BY THE CONTRACTOR.
- 3. AFTER THE 30-DAY CONTINUOUS UNINTERRUPTED SIGNAL OPERATION WITHOUT MALFUNCTIONS.

CONSTRUCTION NOTES

- 1. ALL JUNCTION BOXES IN WALK AREAS TO BE CITY OF PITTSBURGH STANDARD CONCRETE JUNCTION BOX, TYPE 1.
- 2. ALL JUNCTION BOXES IN NON-WALK AREAS TO BE CITY STANDARD JB-2 WITH BOTTOM.
- 3. THERE SHALL BE NO SIGNAL WIRE OR FIBER CABLE SPLICING.
- 4. SERVICE WIRE FROM THE POWER SOURCE TO THE CONTROLLER CABINET SHALL BE PLACED IN SECONDARY SEPARATE CONDUIT.
- 5. STREET LIGHT CABLE IS NOT PERMITTED TO RUN THROUGH THE CONTROLLER CABINET AND SHALL BE PLACED IN
- THE CONTROLLER CAB SEPARATE CONDUIT. 6. TRAFFIC SIGNAL CABLE SHALL BE PLACED IN DEDICATED
- 7. MOUNT DISCONNECT ON POLE NEAREST TO THE CONTROLLER CABINET EXCLUDING TYPE X POLES.
- 8. REMOVE AND DISPOSE OF ALL EXISTING SIGNAL WIRING NO
- REMOVE EXISTING SIGNAL EQUIPMENT NO LONGER IN USE AND RETURN TO THE CITY OF PITTSBURGH TRAFFIC CONTROL SHOP. COORDINATE DELIVERY OF EQUIPMENT WITH DELMAS MCELHANY, TRAFFIC CONTROL FOREMAN.

WIRING DIAGRAM

AUDIBLE PEDESTRIAN SIGNAL NOTES

- 1. ALL PUSH BUTTONS SHALL BE EQUIPPED WITH LOCATOR TONES.
- 2. ALL WALK INTERVALS TO HAVE VERBAL MESSAGE DETAILING WALK DIRECTION.
- 3. VERBAL MESSAGE TO BE PLAYED DURING WALK INTERVAL WHEN BUTTON IS PRESSED.
- 4. ALL PEDESTRIAN PUSH BUTTONS TO BE LOCATED AT 42" ABOVE GROUND.
- 5. ALL PUSH BUTTONS TO BE EQUIPPED WITH VIBROTACTILE
- 6. VIBROTACTILE ARROWS TO VIBRATE DURING WALK INTERVAL.
- 7. WALK AND DON'T WALK MESSAGE SHALL BE AUDIBLE THOUGH THE PUSH BUTTON SPEAKER.

PAVEMENT MARKING NOTES


- 1. ALL STOP BARS ARE W/24".
- 2. CROSSWALKS ARE 10'X 24" KEYS WITH 3' TO 5' SPACING.
- 3. CROSSWALKS ACROSS BICYCLE LANES ARE 6'X 12" KEYS WITH 1' SPACING.

TRANSIT PRIORITY PRE-EMPTION NOTES (TO BE INSTALLED BY OTHERS)

- COORDINATE TRAFFIC CONTROLLER PROGRAMMING MODIFICATION WITH REPRESENTATIVES OF THE CITY OF PITTSBURGH AND DISTRICT TRAFFIC UNIT.
- 2. INCLUDE A TRANSIT PRIORITY PHASE THAT WILL EXTEND THE INDICATED PHASE A MAXIMUM OF 10 SECONDS WHEN ACTIVATED BY A PORT AUTHORITY VEHICLE. DO NOT VIOLATE SIDE STREET PEDESTRIAN MINIMUM TIMINGS.
- 3. MAINTAIN ALL YELLOW CLEARANCES AT ALL TIMES.
- 4. PROCEED TO THE SUBSEQUENT INTERVAL AS DEFINED IN THE MOVEMENT, SEQUENCE AND TIMING DIAGRAM UPON COMPLETING THE GREEN EXTENSION INTERVAL.
- 5. ONCE A TRANSIT CALL IS PLACED AND SATISFIED, THE CONTROLLER WILL NOT SATISFY ANOTHER CALL FOR
- 6. LOCATION OF BUS DETECTORS ARE TO BE FIELD ADJUSTED TO ACHIEVE MAXIMUM OPERATION.

5C/14 - CABLE (NO. OF CONDUCTORS/SIZE AWG.)

- EXISTING SIGNAL HEAD
- 1) PROPOSED SIGNAL HEAD
- EXISTING AUDIBLE PEDESTRIAN INDICATOR
- PROPOSED AUDIBLE PEDESTRIAN INDICATOR \triangle PROPOSED SIGNAL SUPPORT
- EXISTING SIGNAL SUPPORT 1 EXISTING JUNCTION BOX

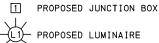

———— EXISTING LUMINAIRE **(1)** PROPOSED DETECTOR

INCIDENTAL TO ITEM 02895.001, AS PER MANUFACTURERS SPECIFICATIONS

3C/14 INCIDENTAL TO ITEM 02895.002

SIGNAL ASSEMBLY NOTES

- 1. ALL VEHICULAR/BICYCLE SIGNALS SHALL BE EQUIPPED WITH L.E.D LENSES, TUNNEL_VISORS AND LOUVERED BLACK METAL BACKPLATES WITH 2" REFLECTIVE BORDERS.
- 2. MIN/MAX HEIGHT TO BOTTOM OF VEHICULAR SIGNALS 17'/18'.
- 3. MIN HORIZONTAL SPACING FOR VEHICULAR SIGNALS IS 8'.
- 4. MIN/MAX HEIGHT TO BOTTOM OF PEDESTRIAN SIGNALS 10'/12'
- 5. FINAL SIGNAL HEAD PLACEMENT WILL BE DETERMINED BY REPRESENTATIVES OF THE CITY OF PITTSBURGH DEPARTMENT OF MOBILITY AND INFRASTRUCTURE AND THE DISTRICT TRAFFIC UNIT PRIOR TO SIGNAL BEING TURNED ON.
- 6. ALL PEDESTRIAN SIGNALS SHALL BE PORTLAND ORANGE FULL "PEDESTRIAN HAND" AND WHITE "WALKING PERSON" SYMBOLS AND HAVE INCANDESCENT LOOK WITH COUNTDOWN TIMER. 7. PROVIDE AIRCRAFT STRANDED CABLE FOR MOUNTING SIGNAL
- AND SIGN BRACKET ASSEMBLIES TO MAST ARMS. 8. PROVIDE BLACK ALUMINUM HOUSINGS FOR ALL SIGNAL HEADS.
- 9. INSTALL POST MOUNTED SIGNAL HEADS WITH BOTTOMS NO GREATER THAN 15' ABOVE THE SIDEWALK OR PAVEMENT.
- 10. EXACT LOCATION OF TRAFFIC SIGNAL SUPPORTS SHALL BE DETERMINED BY REPRESENTATIVES OF THE CITY OF PITTSBURGH DEPARTMENT OF MOBILITY AND INFRASTRUCTURE AND THE DISTRICT TRAFFIC UNIT PRIOR TO INSTALLATION.

DETECTOR ZONE INFORMATION

DETECTOR ZONE THI ORIMATION										
DETECTOR	DETECTION ZONE(S)	MODE	TYPE	ROUTE	PHASE	LOCATION MAST ARM				
(1)	(1)(2) (6'x60')	PRESENCE	VIDEO (STOP BAR)	FORBES AVENUE	6	A				
	③ (6′×60′)	PRESENCE	VIDEO (STOP BAR)	FORBES AVENUE	1					
2	⟨6⟩ (10′×15′)	PRESENCE	VIDEO (STOP BAR)	BRADY STREET	4	\triangle				
3	⑤ (24′×40′)	PRESENCE	VIDEO (STOP BAR)	BIRMINGHAM BRIDGE OFF-RAMP	4	<u> </u>				
4	⟨ 4 ⟩ (6′×60′)	PRESENCE	VIDEO (STOP BAR)	FORBES AVENUE	8	2				

TS-139

COUNTY: ALLEGHENY MUNICIPALITY: CITY OF PITTSBURGH INTERSECTION: SR 2108 (FORBES AVENUE) AND BRADY STREET AND SR 8065 (BIRMINGHAM BRIDGE RAMPS) APPROVED AND ACCEPTED: CITY TRAFFIC ENGINEER DATE APPROVED AND ACCEPTED: DISTRICT TRAFFIC ENGINEER DATE

AECOM

Gulf Tower 707 Grant Street 5th Floor Pittsburgh, PA 15219

THE PREPARATION OF THIS DOCUMENT HAS BEEN FINANCED IN PART THROUGH A GRANT FROM THE FEDERAL TRANSIT ADMINISTRATION U.S. DEPARTMENT OF TRANSPORTATION, UNDER THE URBAN MASS TRANSPORTATION ACT OF 1964 AS AMENDED FOR THE NO. DATE DESCRIPTION COUNTY, PENNSYLVANIA. REVISIONS

(NOT FOR CONSTRUCTION)

DESIGNED	<u>DWP</u>	
DRAWN	<u>NED</u>	
CHECKED	<u>AJR</u>	
IN CHARGE	<u>JKM</u>	
DATE	05/01/24	
SCALE		
	AS SHOWN	

PORT AUTHORITY OF ALLEGHENY COUNTY PITTSBURGH PENNSYLVANIA

BUS RAPID TRANSIT UPTOWN TO OAKLAND SIGNAL PLANS WIRING, MOVEMENT, PHASING & SEQUENCE DIAGRAMS

Port Authority

CONTRACT NO. BRT-001 SG136 DWG NO sнт. 1196

ITEM NUMBER											
UNIT	DESCRIPTION	QTY.	LOCATION	REMARKS							
01882. 002 EACH	TRAFFIC SIGNAL TIMING MODIFICATIONS	2	сс								
02212. 009 LF	POLE FOUNDATION DRILLING, LESS THAN 30" DIAMETER	17		<u> </u>							
02212. 010 LF	POLE FOUNDATION DRILLING, GREATER THAN 30" DIAMETER	91		1 2 4 1 8 9 1							
02889. 002 EACH	LED LUMINAIRE CITY STANDARD, BLACK	6	000	1 3 9 1 8 1							
02890. 001 EACH	TRAFFIC SIGNAL CONTROLLER ASSEMBLY, TYPE 2070 LC, WITH TYPE 332 BASE MOUNTED CABINET	1	СС								
02890. 003 EACH	ETHERNET SWITCH	1	СС								
02890. 005 EACH	GPS TIME CLOCK	1	СС								

ITEM NUMBER	R MISCELLANEOUS (CONT.)										
UNIT	DESCRIPTION QTY. LOCATION REMARKS										
02894. 001 EACH	VEHICULAR SIGNAL HEAD, THREE 12" SECTIONS	9	1245 67890	BLACK TUNNEL VISORS BLACK ALUMINUM HOUSINGS BLACK METAL LOUVERED BACKPLATE							
02894. 001 EACH	VEHICULAR SIGNAL HEAD, THREE 12" SECTIONS	1	3	BLACK TUNNEL VISORS BLACK ALUMINUM HOUSINGS BLACK METAL LOUVERED BACKPLATE SIGNAL LOUVERS (9)							
02894. 004 EACH	BICYCLE SIGNAL HEAD, THREE 8 " SECTIONS	2	000	BLACK TUNNEL VISORS BLACK ALUMINUM HOUSINGS BLACK METAL LOUVERED BACKPLATE							
02894. 005 EACH	LED COUNTDOWN PEDESTRIAN SIGNAL HEAD, TYPE A	8	12131413 16171819	BLACK TUNNEL VISORS BLACK ALUMINUM HOUSINGS							
02895. 002 EACH	ACCESSIBLE PEDESTRIAN SIGNALS	7	11234 567								
02899. 007 EACH	INSTALL CONDUIT CONNECTION TO EXISTING TRAFFIC SIGNAL SUPPORT	3									

SR 2108 (FORBES AVENUE) AND BRADY STREET AND SR 8065 (BIRMINGHAM BRIDGE RAMPS)

TRAFFIC SIGNAL SUPPORTS **

	≥ Ш		MAST ARM				PEC	DESTA	۱L																	
POLE NO.	1TEM NUMBER	DESCRIPTION	aty.	ROUTE	STATION	SIDE	OFFSET							ARM	"A "						AF	RM "C	C "	SHAFT	SIG	NAL
	_				ST	0,	P	Н	К		SIGN	SIGNAL LOCATION SIGN				IGN	LOCA	OCATION		w	G	x	z	н	м	N
	UNIT										М	N	0	Р	R	S	Т	U	Υ	"	<u> </u>			·''	IVI	IN
\triangle	02892. 214 EACH	TRAFFIC SIGNAL SUPPORT, 46' MAST ARM WITH LUMINAIRE ARM (30' MOUNTING HEIGHT), PAINTED BLACK	1	FORBES AVE	178+63	L	21′	17′	10′	46′	38′	29′	17′		41′	21′	2′		10′	0°	6′	30′	0°			
2	02892. 603 EACH	TRAFFIC SIGNAL SUPPORT, 24' MAST ARM, PAINTED BLACK	1	FORBES AVE	178+33	L	21′	17′		24′	22′	12′			17′	8′			4′	270°						
3	02892. 005 EACH	TRAFFIC SIGNAL SUPPORT, 30' TYPE X-L WITH LUMINAIRE ARM, PAINTED BLACK	1	FORBES AVE	177+80	L	20′														6′	30′	0°	30′		10′
4	02892. 605 EACH	TRAFFIC SIGNAL SUPPORT, 36' MAST ARM, PAINTED BLACK	1	FORBES AVE	177+00	R	29′	17′		36′					33′	23′	11′			1°						
<u> </u>		TRAFFIC SIGNAL SUPPORT, 15' TYPE X	1	FORBES AVE	177+80	R	<i>37 '</i>																	15'		10'
Â		TRAFFIC SIGNAL SUPPORT, 15' TYPE X	1	FORBES AVE	178+53	R	41'																	15'	12'	10'
A	02892. 012 EACH	TRAFFIC SIGNAL SUPPORT, STRAIN POLE WITH LUMINAIRE ARM (30' MOUNTING HEIGHT), 4,000 LBS DESIGN TENSION, PAINTED BLACK	1	FORBES AVE	179+17	R	28′														6′	30′	0°	30′		10′
	02892.	TRAFFIC SIGNAL SUPPORT, 20' MAST ARM AND 32' MAST ARM WITH LUMINAIRE ARM (30'	1	FORBES AVE	181+47	L	23′	17/		20′	17′	6′			12′					270°		30′	0°	30′		10'
<u>/8\</u>	EACH	MOUNTING HEIGHT), PAINTED BLACK		FURBES AVE	101141	_	23	<u> </u>		32′	30′	19′								0°	- U	50		<u>50</u>		10
<u>\$</u>	02892. 012 EACH	TRAFFIC SIGNAL SUPPORT, STRAIN POLE WITH LUMINAIRE ARM (30' MOUNTING HEIGHT), 4,000 LBS DESIGN TENSION, PAINTED BLACK	1	FORBES AVE	180+68	R	28′														6′	30′	0°	30′		10′
13	02892. 012 EACH	TRAFFIC SIGNAL SUPPORT, STRAIN POLE WITH LUMINAIRE ARM (30' MOUNTING HEIGHT), 4,000 LBS DESIGN TENSION, PAINTED BLACK	1	FORBES AVE	181+28	R	47′														6′	30′	0°	30′		10′
\triangle	02892. 021 EACH	PEDESTRIAN STUB POLE, TYPE E, PAINTED BLACK	1	FORBES AVE	179+15	L	31′																	5′		
Λž	02892. 020 EACH	PEDESTRIAN STUB POLE, TYPE B, PAINTED BLACK	1	FORBES AVE	180+73	R	24′						1		1									5′		
A	02892. 021 EACH	PEDESTRIAN STUB POLE, TYPE E, PAINTED BLACK	1	FORBES AVE	181+19	R	45′																	5′		

DETECTORS

ITEM NUMBER	DESCRIPTION	SEN. NO.	QTY.	LOCATION
02895 . 001	VIDEO DETECTION	(1)	1	\bigwedge
EACH				
02895 . 001	VIDEO DETECTION	(2)	1	↑
EACH				_
02895 . 001	VIDEO DETECTION	(3)	1	/8\
EACH				
02895 . 001	VIDEO DETECTION	4	1	/2\
EACH				

** REFER TO TRAFFIC STANDARDS TC-8800 SERIES FOR LETTER DESIGNATION

AECOM

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(NOT FOR CONSTRUCTION)

DESIGNED	<u>DWP</u>	
DRAWN	NED	
CHECKED	<u>AJR</u>	
IN CHARGE	<u>JKM</u>	
DATE	05/01/24	
SCALE		
	AS SHOWN	

PORT AUTHORITY OF ALLEGHENY COUNTY PITTSBURGH PENNSYLVANIA

BUS RAPID TRANSIT UPTOWN TO OAKLAND SIGNAL PLANS TRAFFIC SIGNAL TABULATIONS

Port Authority -

CONTRACT NO. BRT-001

DWG. NO. SG137 SHT. 1197

SR 2108 (FORBES AVENUE) AND BRADY STREET AND SR 8065 (BIRMINGHAM BRIDGE RAMPS)

TRENCH, CONDUIT, JUNCTION BOX, ELECTRICAL ITEMS

DESCRIPTION	ELECTRICAL SERVICE TYPE C (NEW)	CITY OF PITTSBURGH STANDARD CONCRETE JUNCTION BOX, TYPE 1	TRENCH AND BACKFILL, TYPE I	TRENCH AND BACKFILL, TYPE II	TRENCH AND BACKFILL, TYPE IV	2 INCH CONDUIT	3 INCH CONDUIT	AWG 8, UNDERCOUND CABLE, COPPER, 1 CONDUCTOR	SIGNAL CABLE, 14 AWG, 5 CONDUCTOR	SIGNAL CABLE, 14 AWG, 7 CONDUCTOR
ITEM NUMBER	02896	02897	02898	02898	02898	02899	02899	02900	02900	02900
TIEM NOMBER	004	001	001	002	005	002	003	001	002	003
UNIT	EACH	EACH	LF	LF	LF	LF	LF	LF	LF	LF
LOCATION										
СС ТО [51]		1		3		6	12			
S1 TO A				8		8	16			
S1 T0 S2		1	29		42	71	142			
§2 TO <u>♠</u>			4				4			
S2 T0 S3		1	35		40	75	150			
§3 то ∕₅			7				7			
S3 T0 1		1	24		30	54	112			
1 то 🛐			10			10	10			
1 TO 2		1	49	39		88	176			
2 то 🖄				25		25	50			
2 то ∱				4		4	8			
COMPLETE INTERSECTION	1							2160	2290	890
TOTAL	1	5	158	79	112	341	687	2160	2290	890

S1,S2,S3 - TABULATED ON THE SYSTEMS PLAN.

SIGNS

				SIGNS				
SYMBOL	SERIES	SIZE	AREA EACH (SQ FT)	DESCRIPTION	QUANTITY	02891,001 POST MOUNTED SIGNS, TYPE B	02891,003 POST MOUNTED SIGNS, TYPE F	02891, 007 STRUCTURE MOUNTED FLAT SHEET ALUMINUM SIGN WITH STIFFENERS
	97.0	70 11/70 11		NO LEST THON		SF	SF	SF
<u> </u>	R3-2	30 "X30 "	6.3	NO LEFT TURN	1			6.3
<u>A1</u>	R3-2	24"X24"	4.0	NO LEFT TURN	1		4.0	
В	R10-11	30 "X36 "	7.5	NO TURN ON RED ●	2			15.0
D	R10-3EL	9 "X15 "	0.9	EDUCATIONAL PUSH BUTTON FOR WALK SIGNAL WITH COUNTDOWN TIMER -	4		A	
(R10-3ER	9 "X15 "	0.9	EDUCATIONAL PUSH BUTTON FOR WALK SIGNAL WITH COUNTDOWN TIMER —	2		•	
F	R10-3E(MOD)	9 "X15 "	0.9	EDUCATIONAL PUSH BUTTON FOR WALK SIGNAL WITH COUNTDOWN TIMER	1		•	
G	D3-4	72 "X24 "	12.0	2300 Uptown 2400 Forbes Ave	1			12.0
Ð	D3-4	72 "X24 "	12.0	Uptown Birmingham Br.	1			12.0
K	R9-3	24"X24"	4.0	NO PEDESTRIAN CROSSING	4	4.0	12.0	
L	SS-14	30 "X12 "	2.5	TO OAKLAND	1			2.5
M	R3-6S	30 "X36 "	7.5	STRAIGHT THROUGH	1			7.5
P	SS-15	42 "X36 "	10.5	DUAL RIGHT	1			10.5
V	SPECIAL	30 "X30 "	6.3	BUS LANE SIGNAL	1			6.3
$\overline{\mathbb{X}}$	R3-5Ba	30 "X36 "	7.5	BUS ONLY	1			7.5
Y	R10-10B	18 "X24 "	3.0	BICYCLE SIGNAL	2		6.0	
				TOTAL		4.0	22.0	79.6

▲ - INCIDENTAL TO ITEM 02895.002

* WHITE REFLECTORIZED LEGEND AND BORDER ON BLUE REFLECTORIZED BACKGROUND.
UTILIZE 4" CLEARVIEW 3W FOR BLOCK/NEIGHBORHOOD AND 8" CLEARVIEW 3W FOR
STREET NAME. ACTUAL WIDTH DETERMINED BY LETTER SPACING. COORDINATE BLOCK
NUMBERS AND STREET NAME DETAILS WITH CITY OF PITTSBURGH DEPARTMENT OF
MOBILITY AND INFRASTRUCTURE.

AECOM 707 Grant Street 5th Floor Pittsburgh, PA 15219

			THE PREPARATION OF THIS
			DOCUMENT HAS BEEN FINANCED IN PART THROUGH A GRANT FROM THE
			FEDERAL TRANSIT ADMINISTRATION,
			U.S. DEPARTMENT OF TRANSPORTATION, UNDER THE
			URBAN MASS TRANSPORTATION ACT
			OF 1964. AS AMENDED. FOR THE
NO.	DATE	DESCRIPTION	PORT AUTHORITY OF ALLEGHENY COUNTY, PENNSYLVANIA.
		REVISIONS	COUNTY, PENNSTEVANIA.


(NOT FOR CONSTRUCTION)

DESIGNED	DWP	
DRAWN	<u>NED</u>	
CHECKED	<u>AJR</u>	
IN CHARGE	<u>JKM</u>	
DATE	<u>05/01/24</u>	
SCALE		D
	AS SHOWN	Г


DWG. NO. SG138

TS-139

sнт. 1198

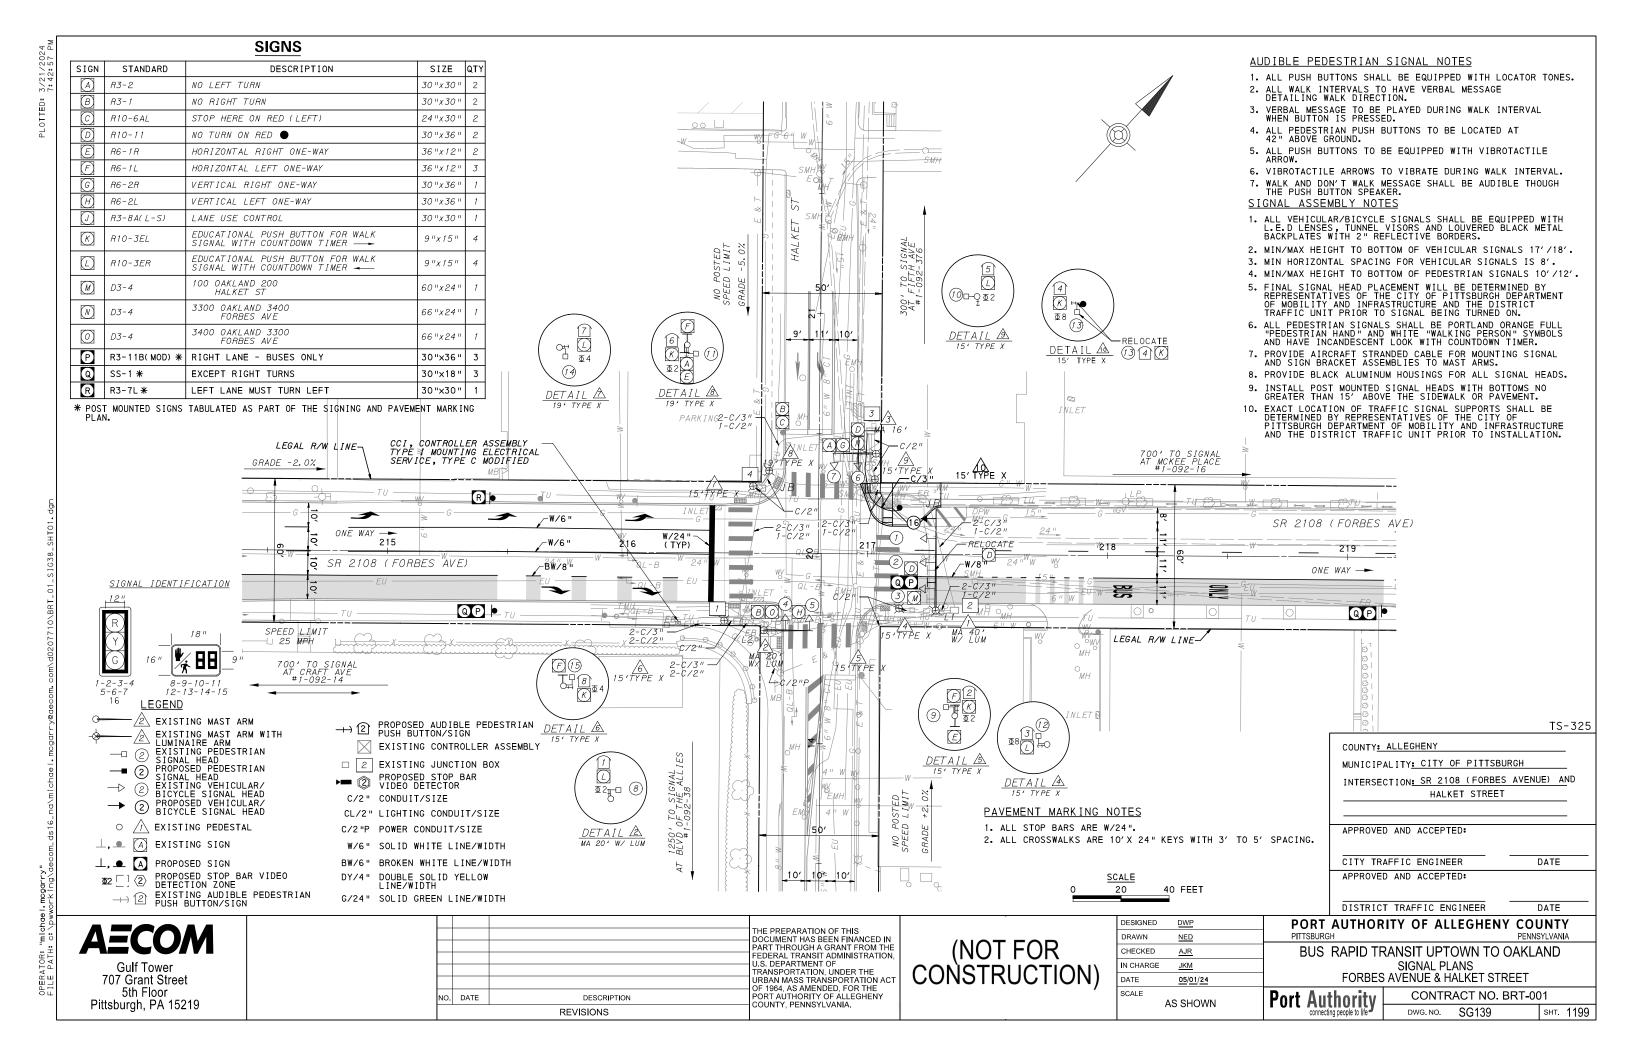

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		PH	IASE	2			PH	IASE	4+8	3	
	BUS		<u>}</u> 	_	-	== BUS	1111			-	ℍ⅀ℍ℆ℿ℮ℿ⅀℮ ℍ⅃℄ⅅℿℍℤ℧
SIGNAL	1	2	3	4	5	1	2	3	4	5	
1-2-3-16	R	G	G	Υ	R	R	R	R	R	R	R
4-5	R	R	R	R	R	R	G	G	Υ	R	R
6-7	R	R	R	R	R	R	G	G	Υ	R	R
8-9-10-11	W	W	FD	DW	DW	DW	DW	DW	DW	DW	0FF
12-13-14-15	DW	DW	DW	DW	DW	W	W	FD	DW	DW	0FF
FIXED		\wedge	<	3.5	2.5		\wedge	<	3.5	2.5	
MINIMUM		1	5					7			
PASSAGE		3.	0				3.	. 0			
FREE (MAX)											
PEDESTRIAN	3	4 15				3	4	15			
MEMORY		PED	REC	ALL			PED	REC	ALL		

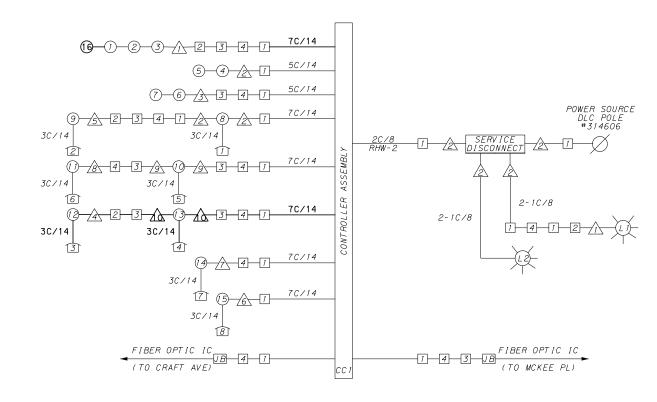

WIRING DIAGRAM

5C/14 - CABLE (NO. OF CONDUCTORS/SIZE AWG.)

EXISTING SIGNAL HEAD

(1) PROPOSED SIGNAL HEAD

EXISTING AUDIBLE PEDESTRIAN INDICATOR

PROPOSED AUDIBLE
PEDESTRIAN INDICATOR

EXISTING SIGNAL SUPPORT

PROPOSED SIGNAL SUPPORT
PROPOSED JUNCTION BOX

EXISTING JUNCTION BOX

PROPOSED LUMINAIRE

PROPOSED DETECTOR

3C/14 INCIDENTAL TO ITEM 02894.022

** INCIDENTAL TO ITEM 02895.001, AS PER MANUFACTURERS SPECIFICATIONS

GENERAL NOTES

THE CITY OF PITTSBURGH SHALL INSPECT THE NEW SIGNAL EQUIPMENT PRIOR TO ACTIVATION.

ALL TRAFFIC SIGNAL MAINTENANCE AND OPERATION RESPONSIBILITIES SHALL BE TURNED OVER TO THE CITY OF PITTSBURGH AFTER THE FOLLOWING CONDITIONS ARE IMPLEMENTED TO THE CITY'S SATISFACTION:

- 1. PERMIT "AS-BUILT" TRAFFIC SIGNAL DRAWINGS ARE SUBMITTED AND APPROVED.
- 2. ALL PUNCH LIST ITEMS ARE COMPLETED BY THE CONTRACTOR.
- 3. AFTER THE 30-DAY CONTINUOUS UNINTERRUPTED SIGNAL OPERATION WITHOUT MALFUNCTIONS.

CONSTRUCTION NOTES

- 1. ALL JUNCTION BOXES IN WALK AREAS TO BE CITY OF PITTSBURGH STANDARD CONCRETE JUNCTION BOX, TYPE 1.
- 2. ALL JUNCTION BOXES IN NON-WALK AREAS TO BE CITY STANDARD JB-2 WITH BOTTOM.
- 3. THERE SHALL BE NO SIGNAL WIRE OR FIBER CABLE SPLICING.
- 4. SERVICE WIRE FROM THE POWER SOURCE TO THE CONTROLLER CABINET SHALL BE PLACED IN SECONDARY SEPARATE CONDUIT.
- 5. STREET LIGHT CABLE IS NOT PERMITTED TO RUN THROUGH THE CONTROLLER CABINET AND SHALL BE PLACED IN SEPARATE CONDUIT.
- 6. TRAFFIC SIGNAL CABLE SHALL BE PLACED IN DEDICATED CONDUIT.
- 7. MOUNT DISCONNECT ON POLE NEAREST TO THE CONTROLLER CABINET EXCLUDING TYPE X POLES.
- 8. REMOVE AND DISPOSE OF ALL EXISTING SIGNAL WIRING NO LONGER IN USE.
- 9. REMOVE EXISTING SIGNAL EQUIPMENT NO LONGER IN USE AND RETURN TO THE CITY OF PITTSBURGH TRAFFIC CONTROL SHOP. COORDINATE DELIVERY OF EQUIPMENT WITH DELMAS MCELHANY, TRAFFIC CONTROL FOREMAN.

TS-325

_	AUTHODITY OF ALLECHENY	COLINITY
	DISTRICT TRAFFIC ENGINEER	DATE
	APPROVED AND ACCEPTED:	
	CITY TRAFFIC ENGINEER	DATE
	AFFROVED AND ACCEPTED:	
	APPROVED AND ACCEPTED:	
	HALKET STREET	
	INTERSECTION: SR 2108 (FORBES)	<u>AVENUE) AN</u> D
	MUNICIPALITY: CITY OF PITTSBUR	
	COUNTY: ALLEGHENY	

AECOM

Gulf Tower 707 Grant Street 5th Floor Pittsburgh, PA 15219 THE PREPARATION OF THIS
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TRANSPORTATION, UNDER THE
URBAN MASS TRANSPORTATION ACT
OF 1964, AS AMENDED, FOR THE
NO. DATE
DESCRIPTION
REVISIONS

THE PREPARATION OF THIS
COUNTY, PENNSYLVANIA.

(NOT FOR CONSTRUCTION)

ESIGNED	<u>DWP</u>	
RAWN	<u>NED</u>	
HECKED	<u>AJR</u>	
CHARGE	<u>JKM</u>	
ATE	05/01/24	
CALE		
	AS SHOWN	

PORT AUTHORITY OF ALLEGHENY COUNTY
PENNSYLVANIA

BUS RAPID TRANSIT UPTOWN TO OAKLAND SIGNAL PLANS WIRING, MOVEMENT, PHASING & SEQUENCE DIAGRAMS

Port Authority

CONTRACT NO. BRT-001

DWG. NO. SG140 SHT. 1200

				1
I TEM NUMBER	MISC	ELLAN	EOUS	
UNIT	DESCRIPTION	QTY.	LOCATION	REMARKS
01882 . 002	TRAFFIC SIGNAL TIMING MODIFICATIONS	2	СС	
EACH				
02212 . 009	POLE FOUNDATION DRILLING, LESS THAN	6	Δ	
LF	5 5 7 ME 12 N			
02894.	VEHICULAR SIGNAL HEAD,	1	(6)	BLACK TUNNEL VISORS BLACK ALUMINUM HOUSING
EACH	THINEE 12 SECTIONS		9	BLACK METAL LOUVERED BACKPLATE
02894 . 022	RESET PEDESTRIAN SIGNAL HEAD	1	(3)	
EACH				
02895 . 004	RESET ACCESSIBLE PEDESTRIAN SIGNAL	1	4	INCLUDES (L) AND 3C/14
EACH			_	
02897 . 011	CONNECT TO EXISTING JUNCTION BOX	1	3	
EACH				

TRENCH, CONDUIT, JUNCTION BOX, ELECTRICAL ITEMS

DESCRIPTION	TRENCH AND BACKFILL, TYPE II	3 INCH CONDUIT	SIGNAL CABLE, 14 AWG, 7 CONDUCTOR
ITEM NUMBER	02898	02899	02900
TIEM NOMBER	002	003	003
TINU	LF	LF	LF
LOCATION			
3 10 ⚠	41	41	
COMPLETE INTERSECTION			410
TOTAL	41	41	410

TRAFFIC SIGNAL TABULATION

SR 2108 (FORBES AVENUE) AND HALKET STREET

SIGNS

SYMBOL	SERIES	SIZE	AREA EACH (SQ FT)	DESCRIPTION	QUANTITY	STRUCTURE MOUNTED FLAT SHEET ALUMINUM SIGNS WITH STIFFENERS	RESET STRUCTURE MOUNTED P FLAT SHEET ALUMINUM SIGN WITH STIFFENERS
0	R10-11	30"x36"		NO TURN ON RED	1		1
P	R3-11B(MOD)	30"x36"	7.5	RIGHT LANE MUST TURN RIGHT	1	7.5	
Q	SS-1	30"×18"	3.8	EXCEPT BUSES	1	3.8	
				TOTAL		11.3	1

TRAFFIC SIGNAL SUPPORTS **

	2111				z		_								MAST	ARM								PED	ESTA	
POLE NO.	ITEM	DESCRIPTION	QΤΥ.	ROUTE	ROUTE NOTE NOTE NOTE NOTE NOTE NOTE NOTE NO						AF	M "(C "	SHAFT	SIG	1AL										
	_				ST	IS	ō	Н	K	SIGNAL LOCATION			ON SIGN LOCATION W				w	G	Х	z	Н	М	N			
	UNIT										М	N	0	Р	R	S	Ť	U	Y							
\triangle		TRAFFIC SIGNAL SUPPORT, 40' MAST ARM WITH LUMINAIRE ARM, (30' MOUNTING HEIGHT) PAINTED BLACK	1	FORBES AVE	217+29	R	23'	17 '		40 '	37′	29 ′	19'	8 '	15′	10′			3'	0°	6′	30 ʻ	0°			
2		TRAFFIC SIGNAL SUPPORT, 20' MAST ARM WITH LUMINAIRE ARM, (30' MOUNTING HEIGHT) PAINTED BLACK	1	FORBES AVE	216+57	R	32'	17 '	10 '	20 '	19'	9'			14'	5′	0'		3'	0°	6′	30 ʻ	45°			
<u> </u>		TRAFFIC SIGNAL SUPPORT, 16' MAST ARM, PAINTED BLACK	1	FORBES AVE	217+03	L	42′	17′	10 '	16 '	15'	4 '			12'	5 ′	0'		2'	0°						
4		TRAFFIC SIGNAL SUPPORT, 15' TYPE X	1	FORBES AVE	217+14	R	23'																	15'		10'
<u>\(\frac{1}{5} \)</u>		TRAFFIC SIGNAL SUPPORT, 15' TYPE X	1	FORBES AVE	216+98	R	33'																	15'		10'
<u>6</u>		TRAFFIC SIGNAL SUPPORT, 15' TYPE X	1	FORBES AVE	216+40	R	28 ′													- 1				15'		10'
À		TRAFFIC SIGNAL SUPPORT, 15' TYPE X	1	FORBES AVE	216+52	L	27 '																	15'		10'
8		TRAFFIC SIGNAL SUPPORT, 19' TYPE X	1	FORBES AVE	216+59	L	34'																	19'		10'
<u></u>		TRAFFIC SIGNAL SUPPORT, 15' TYPE X	1	FORBES AVE	217+04	L	30 '													- 1				15'		10'
\triangle	02892. 003 EACH	TRAFFIC SIGNAL SUPPORT, 15' TYPE X, PAINTED BLACK	1	FORBES AVE	217+13	L	19′								-					1				15′		10′

** REFER TO PENNDOT TC-8800 TRAFFIC STANDARDS - SIGNALS FOR LETTER DESIGNATION

AECOM

707 Grant Street 5th Floor Pittsburgh, PA 15219

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TRANSPORTATION, UNDER THE
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OF 1964, AS AMENDED, FOR THE
PORT AUTHORITY OF ALLEGHENY
COUNTY, PENNSYLVANIA. NO. DATE DESCRIPTION REVISIONS

(NOT FOR CONSTRUCTION)

DESIGNED	DWP	
DRAWN	NED	
CHECKED	<u>AJR</u>	
IN CHARGE	<u>JKM</u>	
DATE	05/01/24	
SCALE		
	AS SHOWN	

TS-325 PORT AUTHORITY OF ALLEGHENY COUNTY

BUS RAPID TRANSIT UPTOWN TO OAKLAND SIGNAL PLANS TRAFFIC SIGNAL TABULATIONS

CONTRACT NO. BRT-001 DWG. NO. SG141 sнт. 1201

Port Authority connecting people to life

→ ② EXISTING AUDIBLE PEDESTRIAN PUSH BUTTON/SIGN

☐ 2 EXISTING JUNCTION BOX

C/2" EXISTING CONDUIT/SIZE

W/6" SOLID WHITE LINE/WIDTH

BW/6" BROKEN WHITE LINE/WIDTH

G/24" SOLID GREEN LINE/WIDTH

DEW/4" DOTTED WHITE PAVEMENT MARKING/WIDTH

SIGNAL HEADS

DY/4" DOUBLE SOLID YELLOW LINE/WIDTH

AECOM

Gulf Tower

707 Grant Street

5th Floor

Pittsburgh, PA 15219

C/3"P EXISTING POWER CONDUIT/SIZE

PROPOSED STOP BAR RADAR DETECTOR

CL/2" EXISTING LIGHTING CONDUIT/SIZE

EXISTING CONTROLLER ASSEMBLY

<u>SIGNS</u>

SIGN	STANDARD	DESCRIPTION	SIZE	QTY	SIGN	STANDARD	DESCRIPTION	SIZE	QTY
A	R3-2	NO LEFT TURN	30"x30"	2	P	R1-1	STOP	30"x30"	1
B	R10-11	NO TURN ON RED	30"x36"	3	R	R3-5R	RIGHT TURN	30"x30"	2
	R3-1	NO RIGHT TURN	30"x30"	1	<u>(S)</u>	R3-101P (MOD)	EXCEPT BIKES	24"x18"	1
(D)	R10-3EL	EDUCATIONAL PUSH BUTTON FOR WALK	9"x15"	2	1	SPECIAL	BUS LANE SIGNAL	30"x30"	1
	KIU-JEL	SIGNAL WITH COUNTDOWN TIMER -	9"X15"		(V)	R10-10R	RIGHT TURN SIGNAL	30"x36"	2
	R10-3ER	EDUCATIONAL PUSH BUTTON FOR WALK	9"x15"	2		R10-15L (MOD)	(LEF1)	30"x30"	1
E	KIU-JEK	SIGNAL WITH COUNTDOWN TIMER ——	9"X15"	-	\bigcirc	R10-15R (MOD)	TURNING TRAFFIC MUST YIELD TO BIKES (RIGHT)	30"x30"	1
Ē	D3-4*	OAKLAND 400 SCHENLEY DR EXT.	90"x24"	1	\square	D3-4*	4300 OAKLAND 4300 FORBES AVE	66"x24"	1
<u>(G)</u>	R5-1	DO NOT ENTER	30"x30"	2	AA	R10-15AL(MÖĎ)	TURNING TRAFFIC MUST YIELD TO BIKES AND PEDS	30"X30"	1
\mathcal{H}	R6-1R	HORIZONTAL RIGHT ONE WAY	36"x12"	1	₿₿	R10-10B	BICYCLE SIGNAL	18"×24"	1
\bigcirc	R6-1L	HORIZONTAL LEFT ONE WAY	36"x12"	2		1		,	لـــــا
\mathcal{C}	R10-6AI	STOP HERE ON RED	24"x30"	2]				

*WHITE REFLECTORIZED LEGEND AND BORDER ON BLUE REFLECTORIZED BACKGROUND.
UTILIZE 4" CLEARVIEW 3W FOR BLOCK/NEIGHBORHOOD AND 8"CLEARVIEW 3W FOR
STREET NAME. ACTUAL WIDTH DETERMINED BY LETTER SPACING. COORDINATE BLOCK NUMBERS AND STREET NAME DETAILS WITH CITY OF PITTSBURGH DEPARTMENT OF MOBILITY AND INFRASTRUCTURE.

** POST MOUNTED SIGNS TABULATED AS PART OF THE SIGNING AND PAVEMENT MARKING PLAN-



AUDIBLE PEDESTRIAN SIGNAL NOTES

- 1. ALL PUSH BUTTONS SHALL BE EQUIPPED WITH LOCATOR TONES.
- 2. ALL WALK INTERVALS TO HAVE VERBAL MESSAGE DETAILING WALK DIRECTION.
- 3. VERBAL MESSAGE TO BE PLAYED DURING WALK INTERVAL WHEN BUTTON IS PRESSED.
- 4. ALL PEDESTRIAN PUSH BUTTONS TO BE LOCATED AT 42" ABOVE GROUND.
- 5. ALL PUSH BUTTONS TO BE EQUIPPED WITH VIBROTACTILE ARROW.
- 6. VIBROTACTILE ARROWS TO VIBRATE DURING WALK INTERVAL.
- 7. WALK AND DON'T WALK MESSAGE SHALL BE AUDIBLE THOUGH THE PUSH BUTTON SPEAKER.

SIGNAL ASSEMBLY NOTES

- 1. ALL VEHICULAR/BICYCLE SIGNALS SHALL BE EQUIPPED WITH L.E.D LENSES, TUNNEL VISORS AND LOUVERED BLACK METAL BACKPLATES WITH 2" REFLECTIVE BORDERS.
- 2. MIN/MAX HEIGHT TO BOTTOM OF VEHICULAR SIGNALS 17'/18'.
- 3. MIN HORIZONTAL SPACING FOR VEHICULAR SIGNALS IS 8'.
- 4. MIN/MAX HEIGHT TO BOTTOM OF PEDESTRIAN SIGNALS 10'/12'.
- 5. FINAL SIGNAL HEAD PLACEMENT WILL BE DETERMINED BY REPRESENTATIVES OF THE CITY OF PITTSBURGH DEPARTMENT OF MOBILITY AND INFRASTRUCTURE AND THE DISTRICT TRAFFIC UNIT PRIOR TO SIGNAL BEING TURNED ON.
- 6. ALL PEDESTRIAN SIGNALS SHALL BE PORTLAND ORANGE FULL "PEDESTRIAN HAND" AND WHITE "WALKING PERSON" SYMBOLS AND HAVE INCANDESCENT LOOK WITH COUNTDOWN TIMER.
- PROVIDE AIRCRAFT STRANDED CABLE FOR MOUNTING SIGNAL AND SIGN BRACKET ASSEMBLIES TO MAST ARMS.
- 8. PROVIDE BLACK ALUMINUM HOUSINGS FOR ALL SIGNAL HEADS.
- 9. INSTALL POST MOUNTED SIGNAL HEADS WITH BOTTOMS NO GREATER THAN 15' ABOVE THE SIDEWALK OR PAVEMENT.
- 10. EXACT LOCATION OF TRAFFIC SIGNAL SUPPORTS SHALL BE DETERMINED BY REPRESENTATIVES OF THE CITY OF PITTSBURGH DEPARTMENT OF MOBILITY AND INFRASTRUCTURE AND THE DISTRICT TRAFFIC UNIT PRIOR TO INSTALLATION.

PAVEMENT MARKING NOTES

- 1. ALL STOP BARS ARE W/24".
- 2. CROSSWALKS ARE 10'X 24" KEYS WITH 3' TO 5' SPACING.
- 3. CROSSWALKS ACROSS BICYCLE LANES ARE 6'X 12" KEYS WITH 1' SPACING.


DETAIL A

400' TO NEXT SIGNAL AT BELLEFIELD AVE -

TS-336

DATE

PENNSYLVANIA

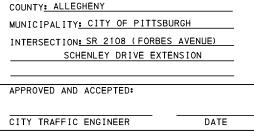

APPROVED AND ACCEPTED:

DISTRICT TRAFFIC ENGINEER

FEDERAL TRANSIT ADMINISTRATION U.S. DEPARTMENT OF TRANSPORTATION, UNDER THE URBAN MASS TRANSPORTATION ACT

40 FEET

MA 28'

743

Z(A)(U)(B)(U)(B)

CL/2"

,09×

I**Σ**4 1(3)

SCHENL. EXTENS

20

GRADE

RELOCATE EXISTING -

SIGNS (F)

G/24<u>"</u> (TYP)

249

-DEW/6

LEGAL R/W LINE

-/4\ MA

2

(3)

<u>~Y/6"</u>

°,−BW/6"

~BW/6"

XW/6"

LEGAL R/W LLNE

5' BIKE L

250

DESIGNED MW CHECKED EMC N CHARGE EMC DATE 05/01/24 SCALE

AS SHOWN


PORT AUTHORITY OF ALLEGHENY COUNTY

BUS RAPID TRANSIT UPTOWN TO OAKLAND SIGNAL PLANS

FORBES AVENUE & SCHENLEY DRIVE EXTENSION

Port Authority

CONTRACT NO. BRT-001 DWG. NO. SG142 sнт. 1202

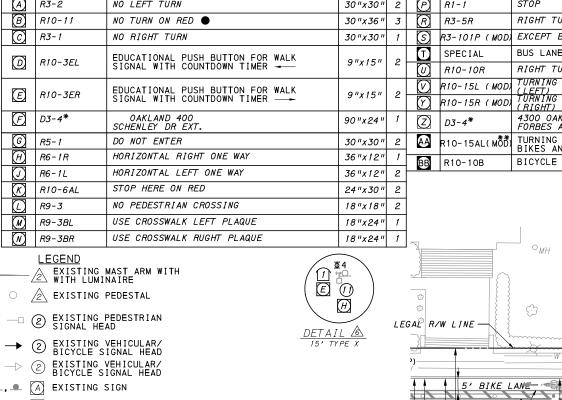

SPEED LIMIT = 25 MPH

GRADE = 2.0%

SR 2108 (FORBES AVE)


405' TO NEXT SIGNAL → AT BIGELOW BLVD. #1-092-21

LEGAL R/W LINE -

DETAIL A

₩

SINGLE UNIT HAND/MAN OVERLAY, COUNTDOWN, LED (FILLED INDICATION W/INCANDESCENT LOOK)

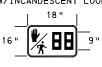

ELETRICAL SERVICE

RESET SIGNS "K" AND "G"

SERVICE, TYPE C

2-C/3"-CL/2"

CCI, CONTROLLER ASSEMBLY
TYPE I MOUNTING ELECTRICAL

2-0/31

C/3"


CL/2" C/2"P

9-10-11-12

WITH LOUVERS

Suite 400 Blue Bell, PA 19422

∕(∙DRIVE **ENGINEERING** 595 Skippack Pk,

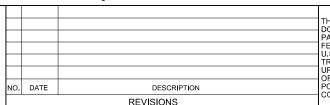

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 $(G)_{G}$

(TYP)

−W/LÛŴૐ

[™]Y/6

~W/6 "Ò

-W/6"ò

① = **3** 1-8' ×60

BIKE LANE


16

8' C TO C

(NOT FOR **CONSTRUCTION**

DETAIL 🖎

	(PH BUS	ASE PH	1 ASE)			PH	ASE	6			PH	IASE	4		
	BUS		==		3 I K E - :	BU	<u> </u>	<u></u>	— — П	<u>B</u> IKE - -	BUS BIKI	11111		H	3 <u>1 K</u> E	HL40HHZG HL40HHZG
INTERVAL	1	2	3			1	2	3	4		1	2	3	4	5	
1-2-3	R	R	R			G	G	Υ	R		R	R	R	R	R	R
4	G	Υ	R			R	R	R	R		R	R	R	R	R	R
5-6	-R -	-R-	-R-			-R-	-R-	-R-	-R-		-R -	-G -	-G -	-Y -	-R-	-R -
7	G	G	G			G	G	Υ	R		R	R	R	R	R	R
8-9	W	W	W			W	FD	DW	DW		DW	DW	DW	DW	DW	0FF
10-11	DW	DW	DW			DW	DW	DW	DW		W	W	FD	DW	DW	0FF
FIXED	\times	3	2			\setminus	<	3	3		$\backslash \backslash$	>><	<	3	3	
MINIMUM	5					1	3					1	3			
PASSAGE						,	3						3			
FREE (MAX)	5															
PEDESTRIAN						7	16				3	7	16			
MEMORY	NON	1- L O	CKI	NG		PEI) RE	CALI	_		PE	RE	CALI	_		

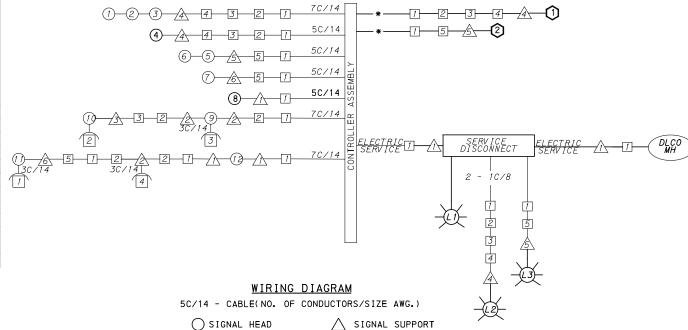

DETECTOR ZONE INFORMATION

DETECTOR	DETECTION ZONE(S)	MODE	TYPE	ROUTE	PHASE	LOCATION MAST ARM
1	(8' × 60')	PRESENCE	VIDEO (STOP BAR)	FORBES AVE.	1	4
②	② (5' x 60')	PRESENCE	VIDEO (STOP BAR)	SCHENLEY DR EXT.	4	<u>A</u>
2	⟨3⟩ (6′ × 60′)	PRESENCE	VIDEO (STOP BAR)	SCHENLEY DR EXT.	4	<u> </u>


TRANSIT PRIORITY PRE-EMPTION NOTES (TO BE INSTALLED BY OTHERS)

- 2. INCLUDE A TRANSIT PRIORITY PHASE THAT WILL EXTEND THE INDICATED PHASE A MAXIMUM OF 10 SECONDS WHEN ACTIVATED BY A PORT AUTHORITY VEHICLE. DO NOT VIOLATE SIDE STREET PEDESTRIAN MINIMUM TIMINGS.
- 4. PROCEED TO THE SUBSEQUENT INTERVAL AS DEFINED IN THE MOVEMENT, SEQUENCE AND TIMING DIAGRAM UPON COMPLETING THE GREEN EXTENSION INTERVAL.
- 5. ONCE A TRANSIT CALL IS PLACED AND SATISFIED, THE CONTROLLER WILL NOT SATISFY ANOTHER CALL FOR
- 6. LOCATION OF BUS DETECTORS ARE TO BE FIELD ADJUSTED TO ACHIEVE MAXIMUM OPERATION.

AECOM

Gulf Tower 707 Grant Street 5th Floor Pittsburgh, PA 15219



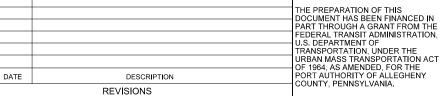

(NOT FOR CONSTRUCTION)

DESIGNED	MW	
DRAWN	MW	
CHECKED	EMC	
IN CHARGE	<u>EMC</u>	
DATE	05/01/24	
SCALE		
	AS SHOWN	

BUS RAPID TRANSIT UPTOWN TO OAKLAND SIGNAL PLANS

MUNICIPALITY: CITY OF PITTSBURGH

INTERSECTION: SR 2108 (FORBES AVENUE)

TS-336

DATE

DATE

APPROVED AND ACCEPTED:

APPROVED AND ACCEPTED:

PENNSYLVANIA

WIRING, MOVEMENT, PHASING & SEQUENCE DIAGRAMS CONTRACT NO. BRT-001

L1 LUMINAIRE

CONSTRUCTION NOTES 1. ALL JUNCTION BOXES IN WALK AREAS TO BE CITY OF PITTSBURGH STANDARD CONCRETE JUNCTION BOX, TYPE 1.

GENERAL NOTES

THE CITY OF PITTSBURGH SHALL INSPECT THE NEW SIGNAL EQUIPMENT PRIOR TO ACTIVATION.

ALL TRAFFIC SIGNAL MAINTENANCE AND OPERATION RESPONSIBILITIES SHALL BE TURNED OVER TO THE CITY OF PITTSBURGH AFTER THE FOLLOWING CONDITIONS ARE IMPLEMENTED TO THE CITY'S SATISFACTION:

1. PERMIT "AS-BUILT" TRAFFIC SIGNAL DRAWINGS ARE SUBMITTED AND APPROVED. 2. ALL PUNCH LIST ITEMS ARE COMPLETED BY THE CONTRACTOR. 3. AFTER THE 30-DAY CONTINUOUS UNINTERRUPTED SIGNAL OPERATION WITHOUT MALFUNCTIONS.

2. ALL JUNCTION BOXES IN NON-WALK AREAS TO BE CITY

3. THERE SHALL BE NO SIGNAL WIRE OR FIBER CABLE SPLICING. 4. SERVICE WIRE FROM THE POWER SOURCE TO THE CONTROLLER CABINET SHALL BE PLACED IN SECONDARY SEPARATE CONDUIT.

5. STREET LIGHT CABLE IS NOT PERMITTED TO RUN THROUGH THE CONTROLLER CABINET AND SHALL BE PLACED IN SEPARATE CONDUIT.

6. TRAFFIC SIGNAL CABLE SHALL BE PLACED IN DEDICATED

7. MOUNT DISCONNECT ON POLE NEAREST TO THE CONTROLLER CABINET EXCLUDING TYPE X POLES.

8. REMOVE AND DISPOSE OF ALL EXISTING SIGNAL WIRING NO

9. REMOVE EXISTING SIGNAL EQUIPMENT NO LONGER IN USE AND RETURN TO THE CITY OF PITTSBURGH TRAFFIC CONTROL SHOP. COORDINATE DELIVERY OF EQUIPMENT WITH DELMAS MCELHANY, TRAFFIC CONTROL FOREMAN.

A SIGNAL SUPPORT

AUDIBLE PEDESTRIAN __ JUNCTION BOX INDICATOR

RADAR DETECTOR

INCIDENTAL TO ITEM 02895.001, AS PER MANUFACTURERS SPECIFICATIONS

COUNTY: ALLEGHENY

SCHENLEY DRIVE EXTENSION

CITY TRAFFIC ENGINEER

DISTRICT TRAFFIC ENGINEER

PORT AUTHORITY OF ALLEGHENY COUNTY

Port Authority

DWG.NO. SG143 sнт. 1203

COORDINATE TRAFFIC CONTROLLER PROGRAMMING MODIFICATION WITH REPRESENTATIVES OF THE CITY OF PITTSBURGH AND DISTRICT TRAFFIC UNIT.

3. MAINTAIN ALL YELLOW CLEARANCES AT ALL TIMES.

NO. DATE Blue Bell, PA 19422

02894**.** 001

EACH

VEHICULAR SIGNAL HEAD, THREE 12" SECTIONS

ITEM NUMBER MISCELLANEOUS UNIT DESCRIPTION QTY. LOCATION REMARKS BLACK TUNNEL VISORS BLACK ALUMINUM HOUSINGS BLACK METAL LOUVERED BACKPLATE SIGNAL LOUVERS 02894**.** 001 VEHICULAR SIGNAL HEAD, THREE 12" SECTIONS 4 EACH 02891. RESET STRUCTURE MOUNTED FLAT SHEET ALUMINIUM SIGN 4 EACH

8

DETECTORS

I TEM NUMBER	DESCRIPTION	SEN. NO.	QTY.	LOCATION
02895. 001 EACH	VIDEO DETECTION	1 2	2	4

TRAFFIC SIGNAL SUPPORTS **

	ER ER	Σ ω	QTY.	ROUTE	STATION	ATION	ET	MAST ARM PEDES										ESTAI	L							
POLE NO.	I TEM NUMBER	DESCRIPTION					ES.		ARM "A"					Al	ARM "C"		SHAFT	SIG	SNAL							
					S		PP.	⁵ H		L	SIG	NAL	LOCA	TION	ON SIGN LOCATION				W	G	х	Z	н	м	N	
	UNIT									_	М	N	0	Р	R	S	Т	U	Υ	"						
\triangle		TRAFFIC SIGNAL SUPPORT, TYPE X WITH LUMINAIRE ARM, 30' MOUNTING		FORBES AVE.	248+32	RT	30 '															30 '	0°	30′	15′	10'
2		TRAFFIC SIGNAL SUPPORT, 19' TYPE X		FORBES AVE.	248+45	RT	33 '																	19'		10 '
<u>/3</u>		TRAFFIC SIGNAL SUPPORT, 15' TYPE X		FORBES AV E.	249+12	RT	31 '																	15'		10'
4		TRAFFIC SIGNAL SUPPORT, 52' MAST ARM WITH LUMINAIRE ARM, 30' MOUNTING		FORBES AV E.	249+27	RT	31 '	17 '		52'	50 ′	38 '	28 '	8′	32'	11′			9′	o°		30 '	o°			
<u>\(\frac{1}{5} \)</u>		TRAFFIC SIGNAL SUPPORT, 28' MAST ARM WITH LUMINAIRE ARM, 30' MOUNTING		FORBES AV E.	248+70	LT	39 '	17 '		28 '	19'	9'			27 ′	22'	17 '	12'	9'	90°		30 '	270°			
<u>6</u>		TRAFFIC SIGNAL SUPPORT, 19' TYPE X		FORBES AV E.	248+46	LT	32'																	19 '	15'	104

** REFER TO PENNDOT TC-8800 TRAFFIC STANDARDS - SIGNALS FOR LETTER DESIGNATION

AECOM

Gulf Tower 707 Grant Street 5th Floor Pittsburgh, PA 15219 ((DRIVE ENGINEERING 595 Skippack Pk, Suite 400 Blue Bell, PA 19422

			THE PREPARATION OF THIS
			DOCUMENT HAS BEEN FINANCED IN PART THROUGH A GRANT FROM THE
			FEDERAL TRANSIT ADMINISTRATION, U.S. DEPARTMENT OF
			TRANSPORTATION, UNDER THE
			URBAN MASS TRANSPORTATION ACT OF 1964. AS AMENDED. FOR THE
NO.	DATE	DESCRIPTION	PORT AUTHORITY OF ALLEGHENY COUNTY, PENNSYLVANIA.
		REVISIONS	COUNTY, PENNSTEVANIA.

BLACK TUNNEL VISORS BLACK ALUMINUM HOUSINGS

(NOT FOR CONSTRUCTION)

DESIGNED	<u>MW</u>	
DRAWN	<u>MW</u>	
CHECKED	<u>EMC</u>	
IN CHARGE	<u>EMC</u>	
DATE	05/01/24	
SCALE		
	AS SHOWN	

PORT AUTHORITY OF ALLEGHENY	COUNTY
PITTSBURGH	PENNSYLVANIA
BUS RAPID TRANSIT UPTOWN TO O	AKLAND
SIGNAL PLANS	

TRAFFIC SIGNAL TABULATIONS

Port Authority
connecting people to life

CONTRACT NO. BRT-001

DWG. NO. SG144 sнт. 1204

TRENCH, CONDUIT, JUNCTION BOX, ELECTRICAL ITEMS

DESCRIPTION	SIGNAL CABLE, 14 AWG, 5 CONDUCTOR
ITEM NUMBER	02900
TIEW NOMBER	002
UNIT	LF
LOCATION	
COMPLETE INTERSECTION	263
TOTAL	263

SIGNS


					316N3			
SYMBOL	SERIES	SIZE	AREA EACH (SQ FT)		DESCRIPTION	QUANTITY	STRUCTURE MOUNTED FLAT SHEET ALUMINUM SIGNS WITH STIFFENERS	
T)	SPECIAL	30 "x30 "	6.3	BUS LAN	IE SIGNAL	1	6.3	
TOTAL								


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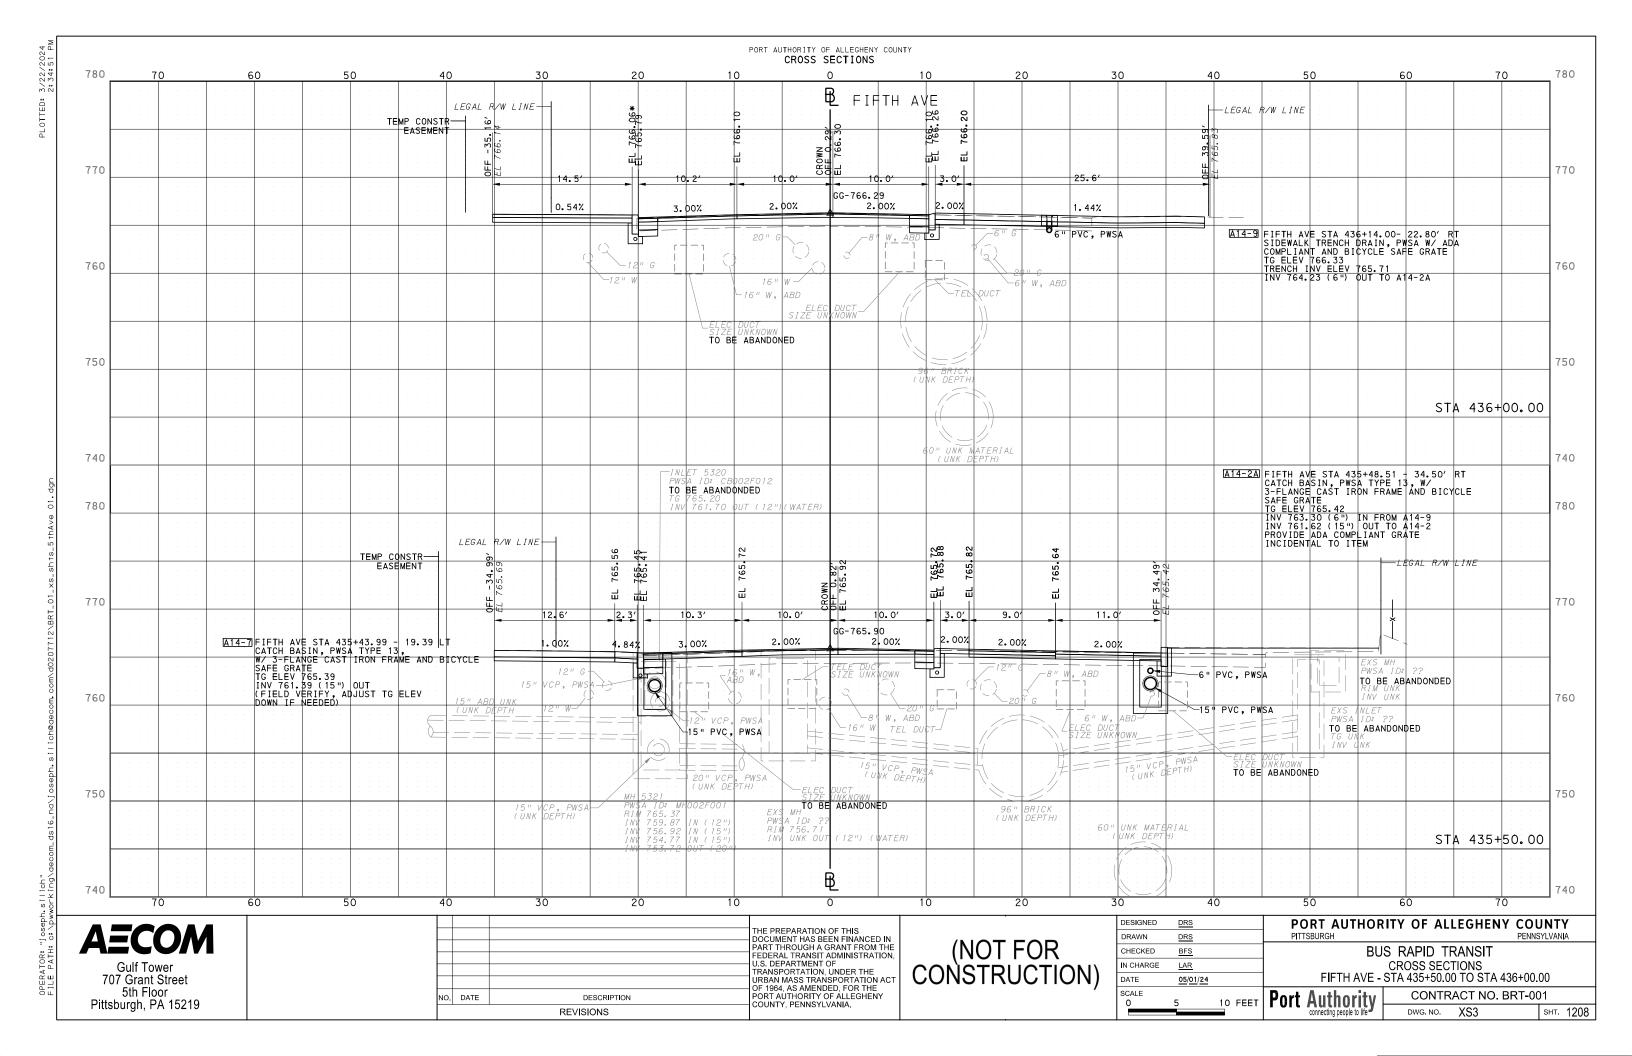
Gulf Tower 707 Grant Street 5th Floor Pittsburgh, PA 15219 ((* DRIVE ENGINEERING 595 Skippack Pk, Suite 400 Blue Bell, PA 19422


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		TRANSPORTATION, UNDER THE
		URBAN MASS TRANSPORTATION ACT OF 1964, AS AMENDED, FOR THE
DATE	DESCRIPTION	PORT AUTHORITY OF ALLEGHENY COUNTY, PENNSYLVANIA.
	REVISIONS	COUNTY, FEMINGTEVANIA.


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DRAWN	MW	PITTSBURGH		PENNS	SYLVANIA		
CHECKED	<u>EMC</u>	BUS RAPID TRANSIT UPTOWN TO OAKLAND					
IN CHARGE	<u>EMC</u>		SIGNAL PL				
DATE	<u>05/01/24</u>	TRAFFIC SIGNAL TABULATIONS					
AS SHOWN		Port Authority	ACT NO. BRT-00)1			
		connecting people to life	DWG. NO.	SG145	sнт. 120:		




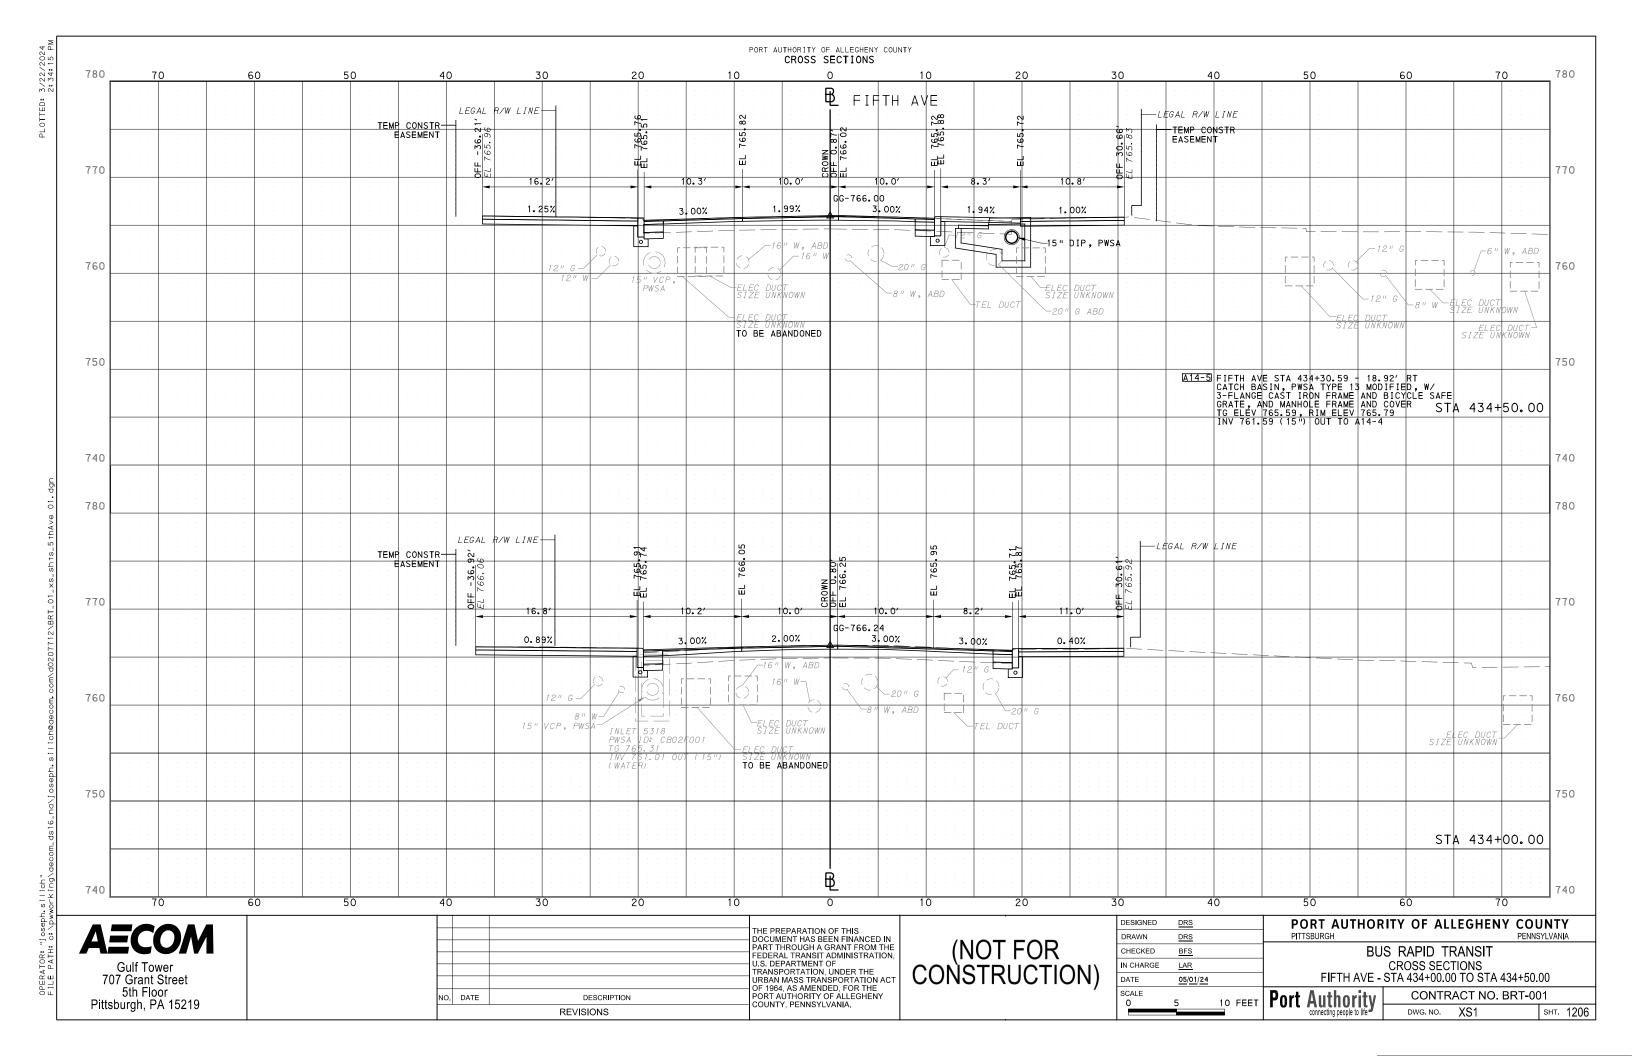


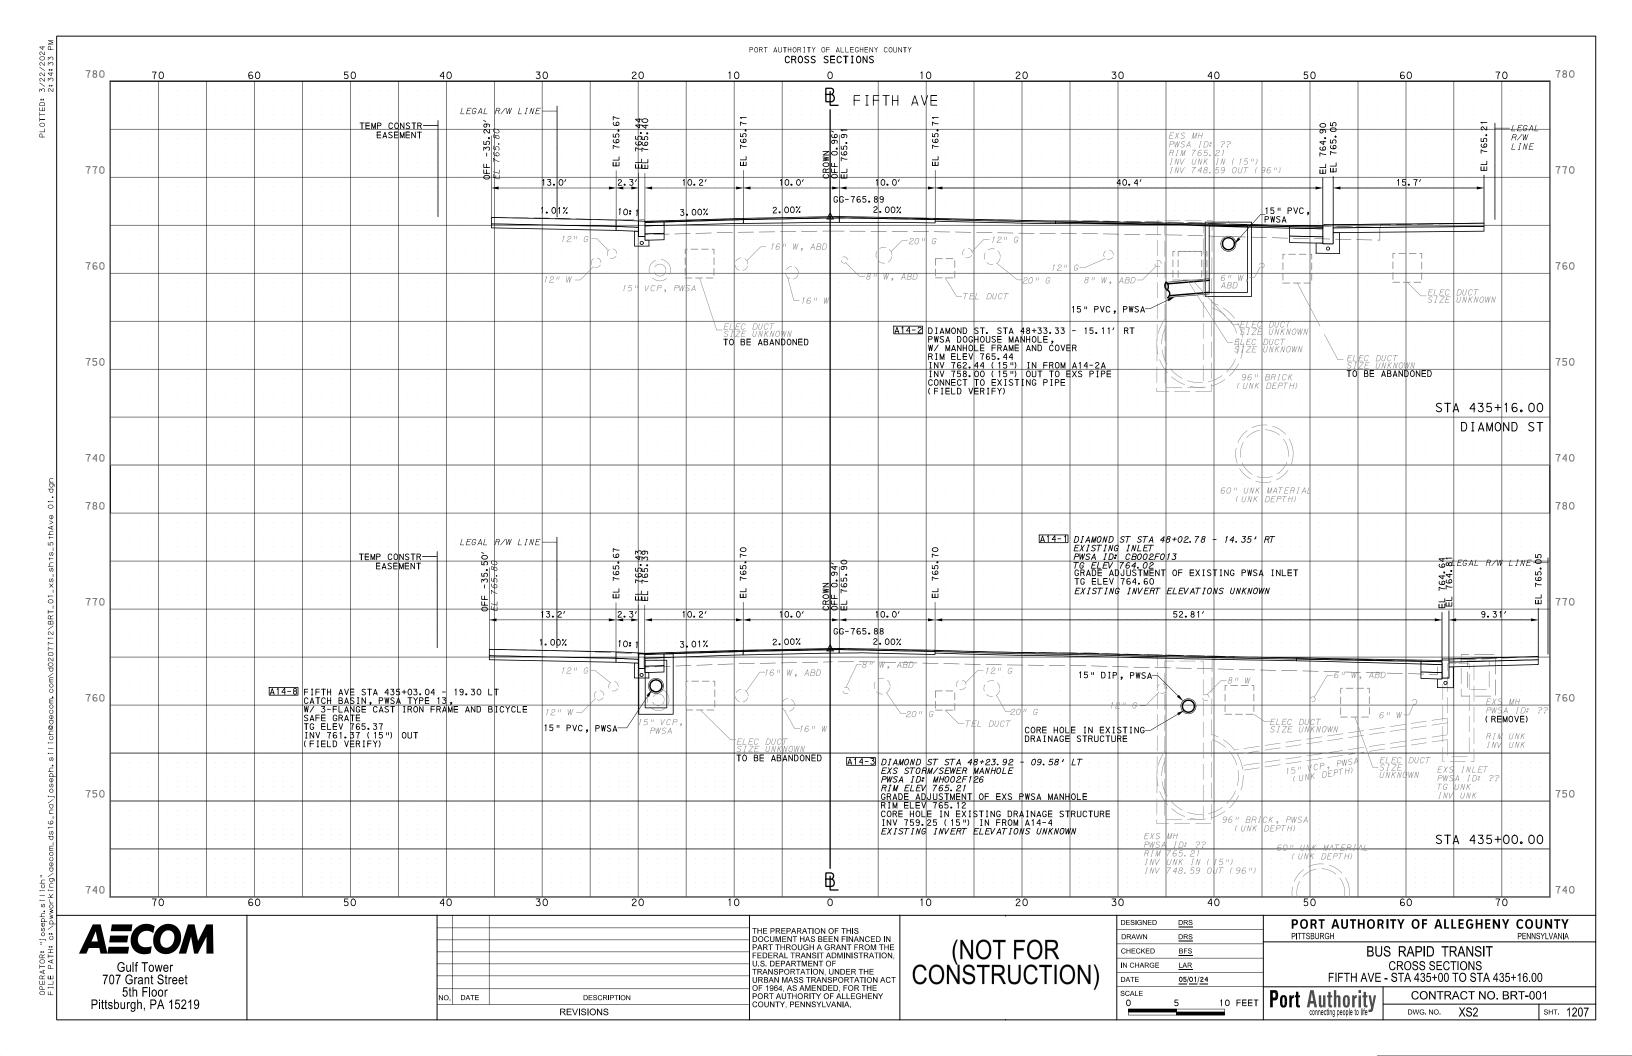


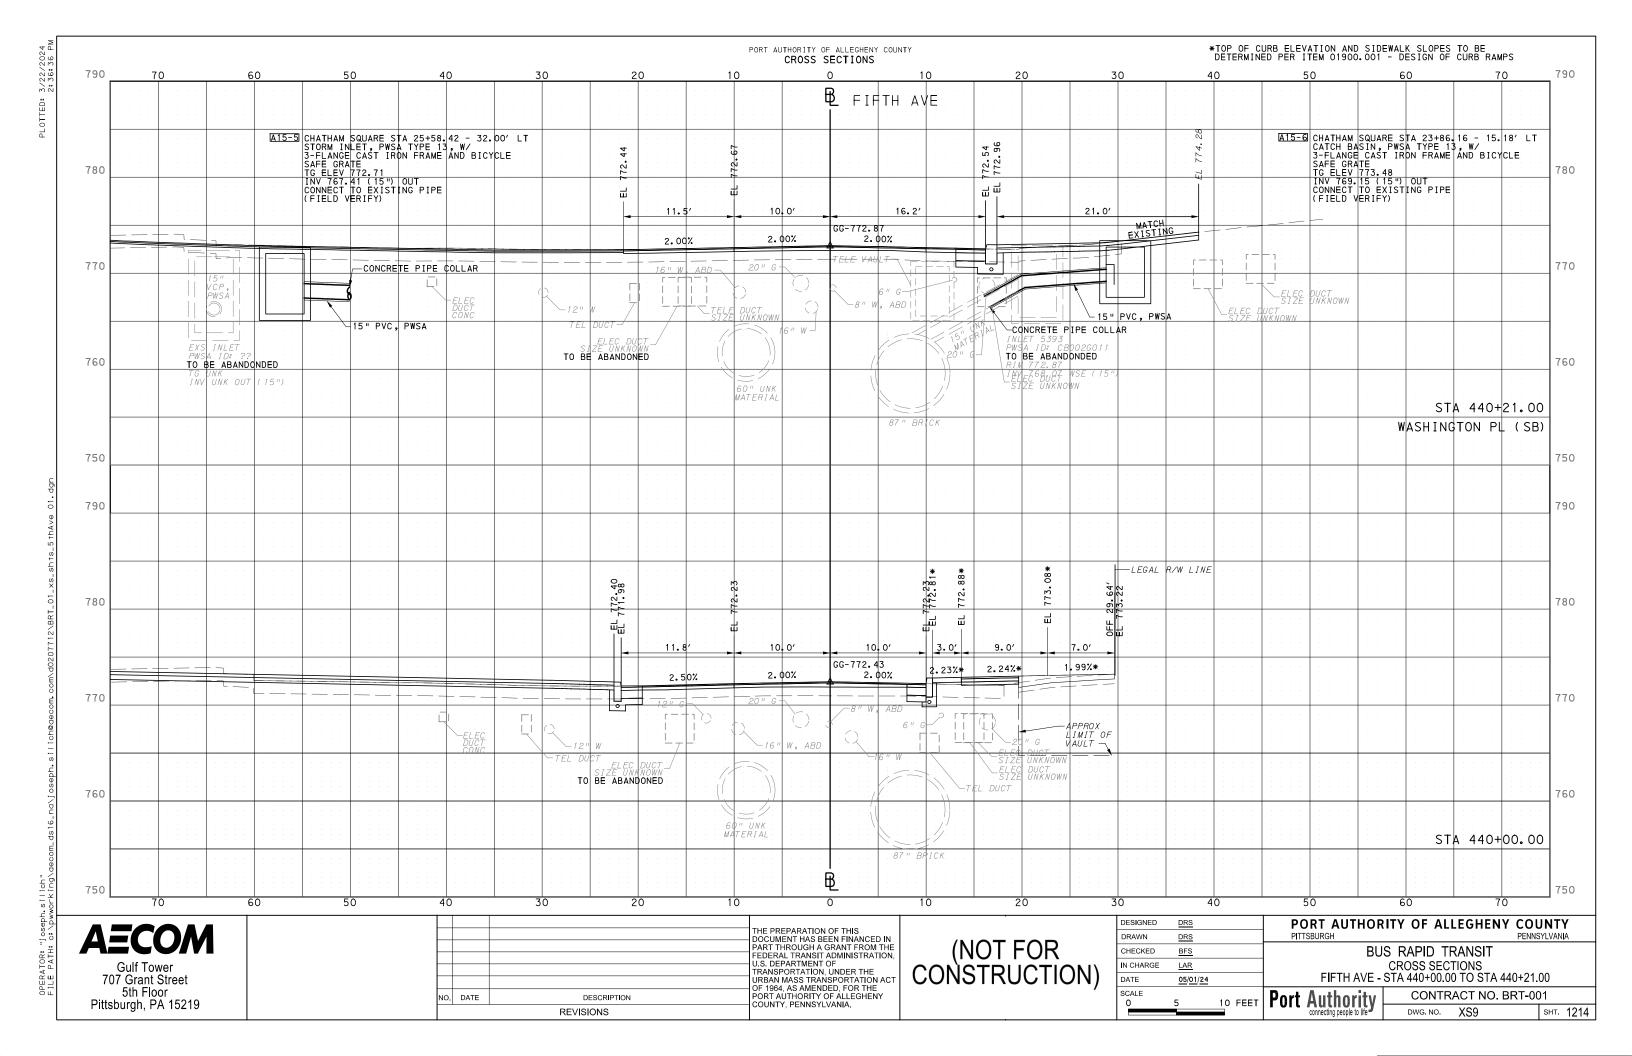


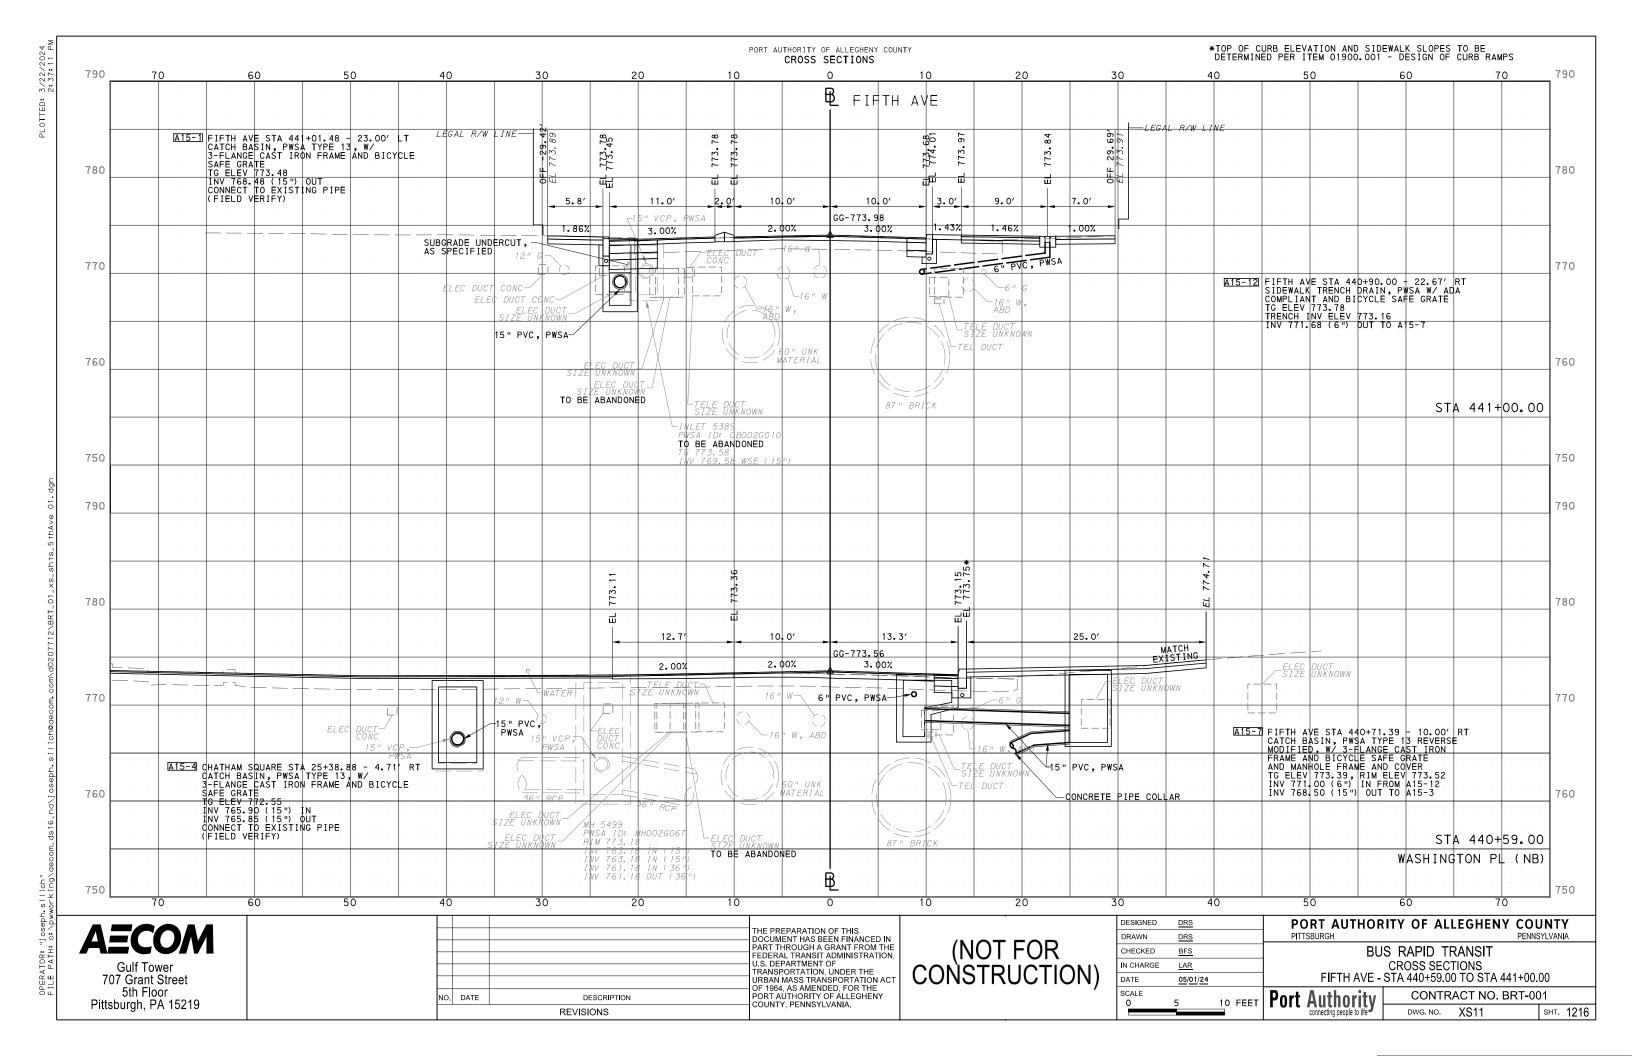


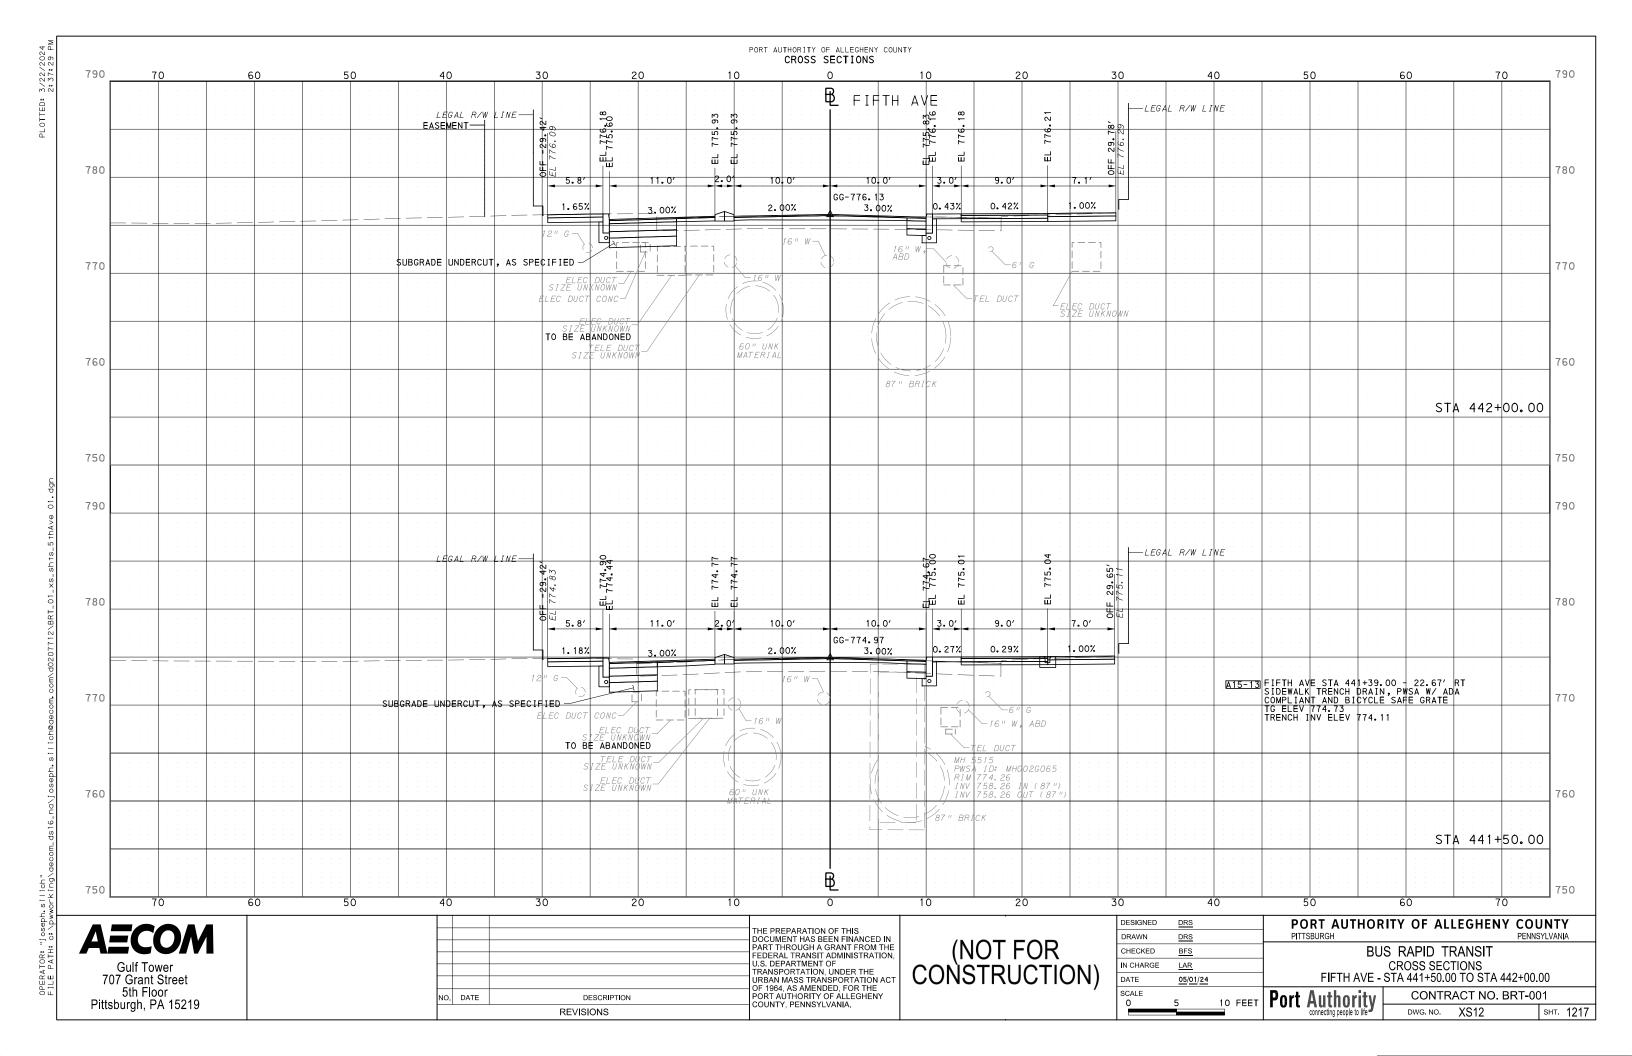


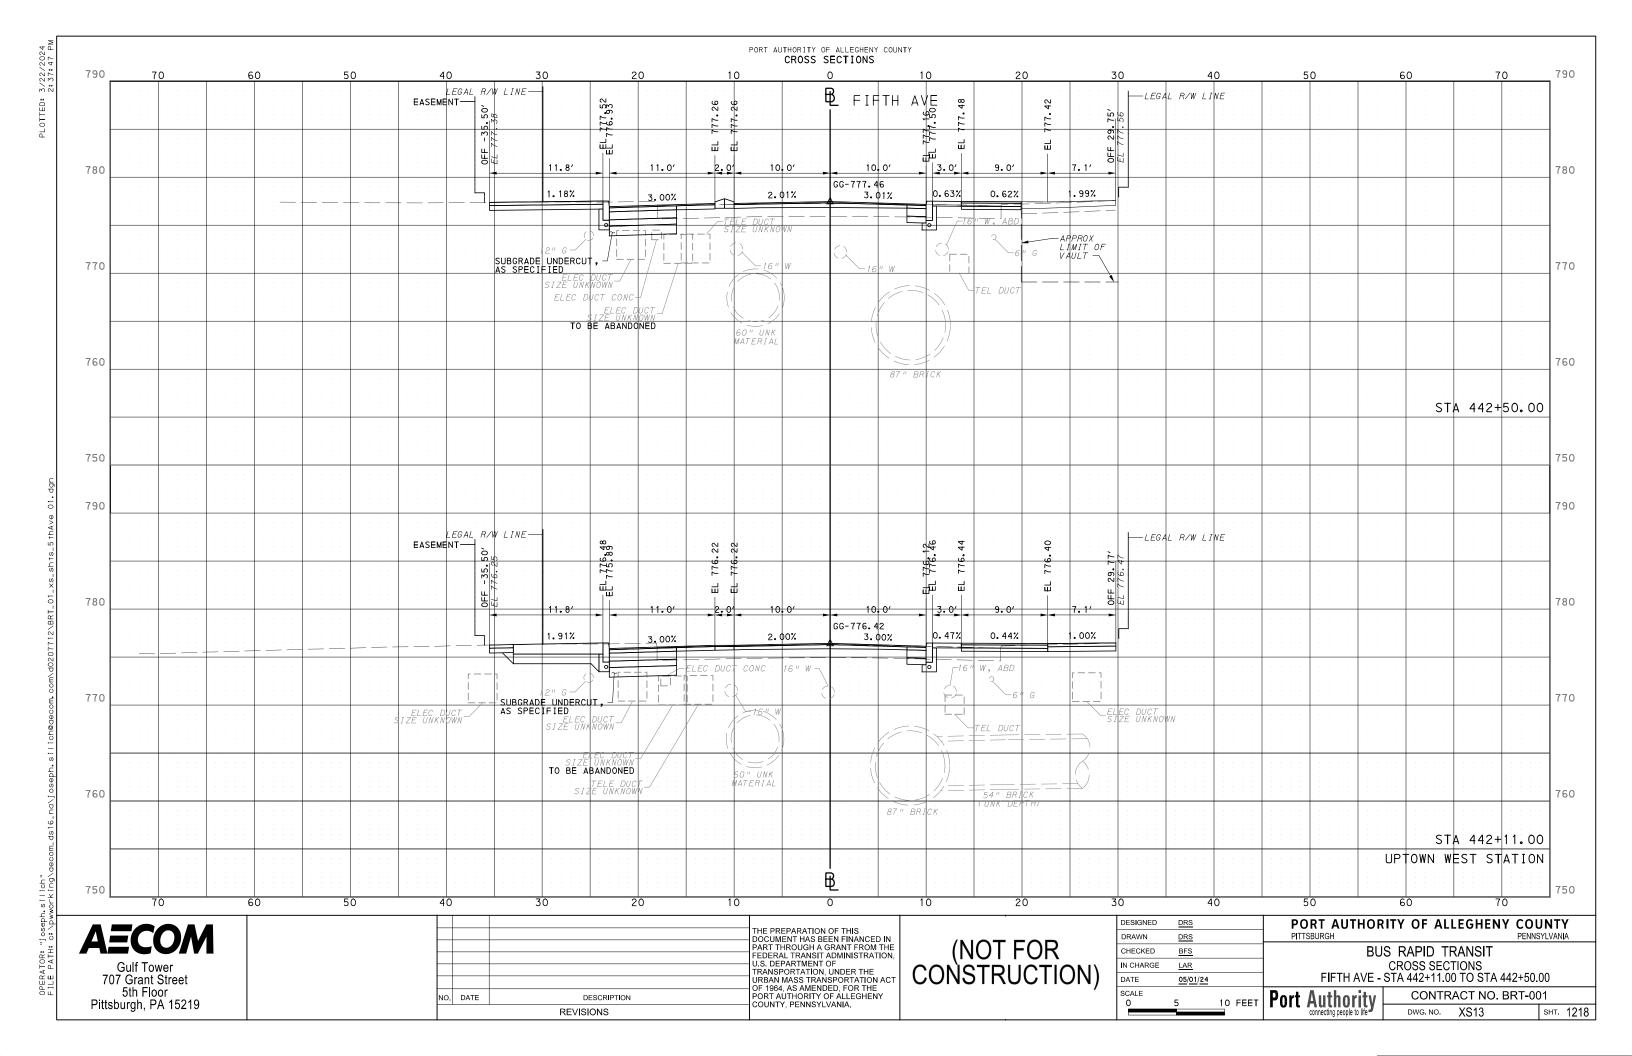


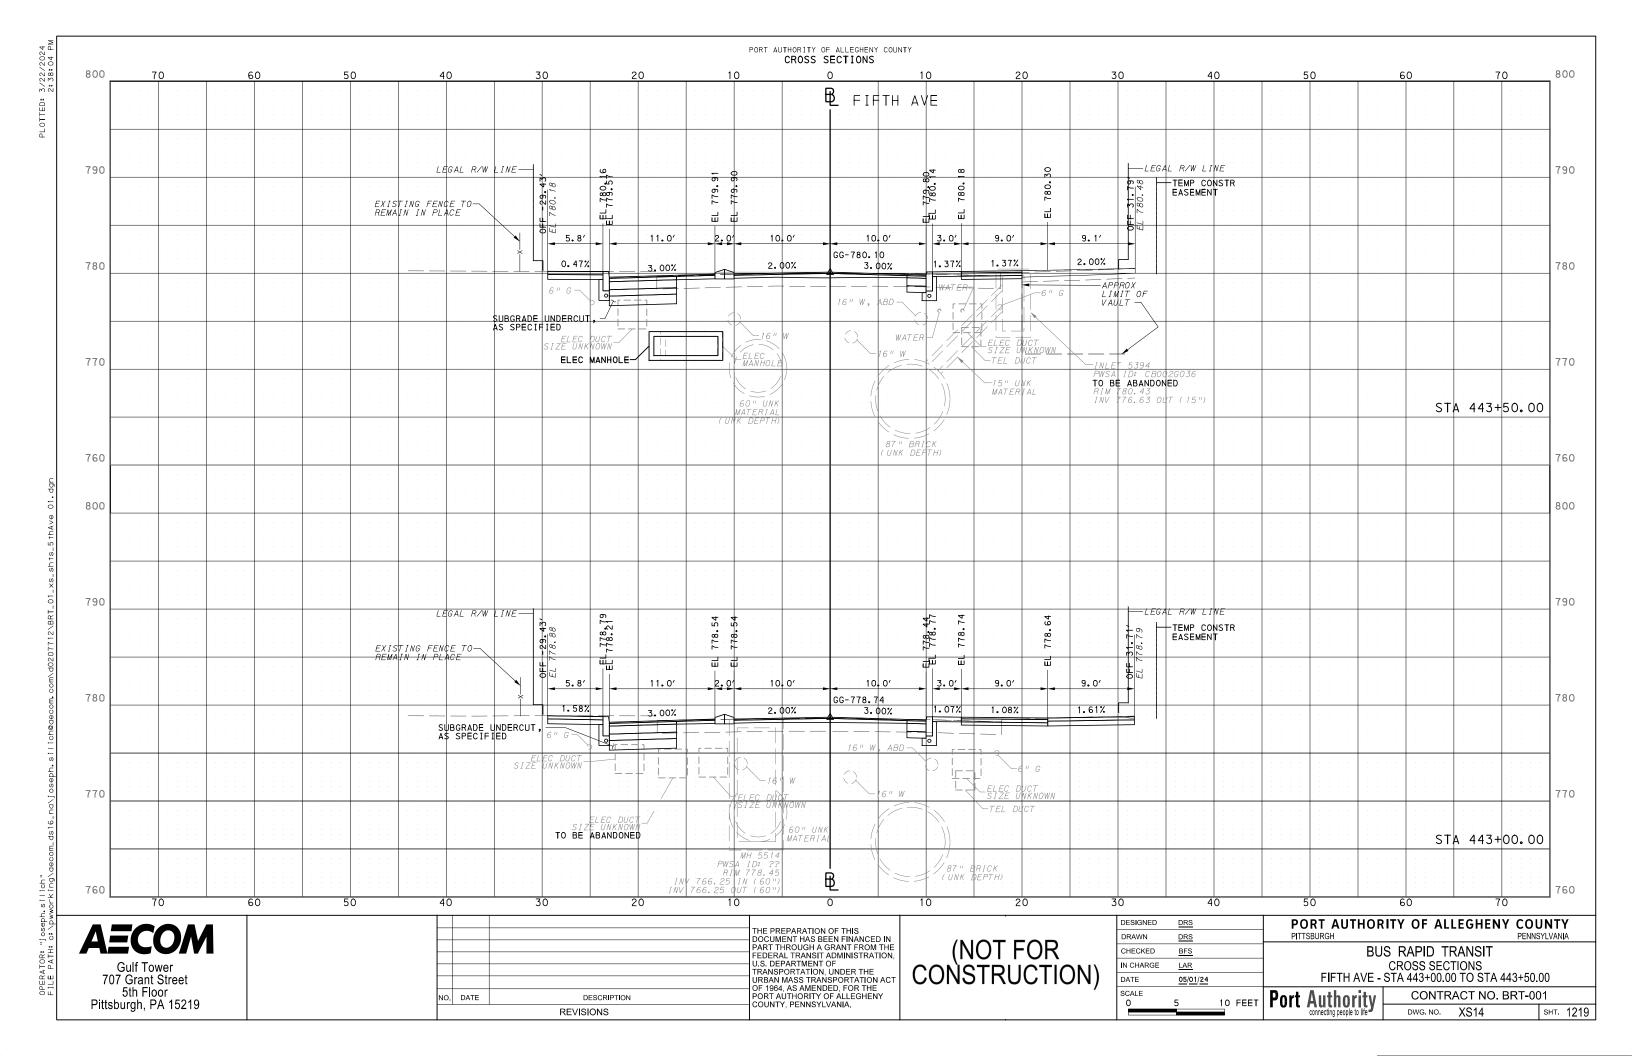


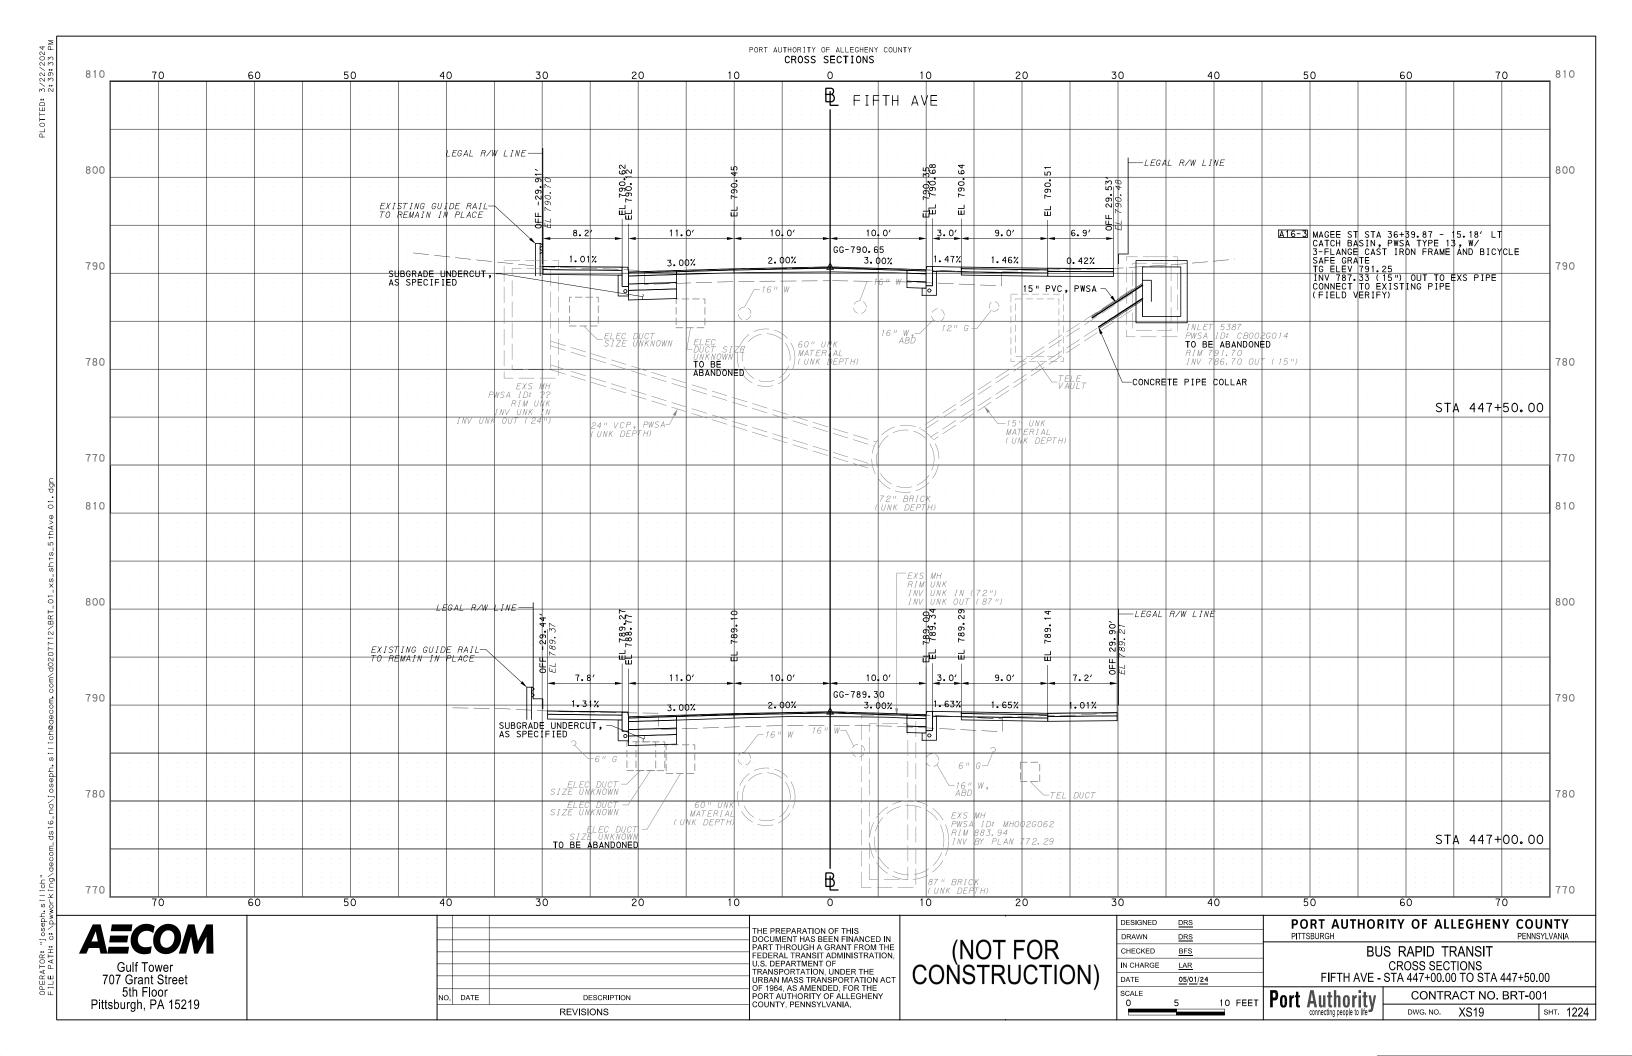


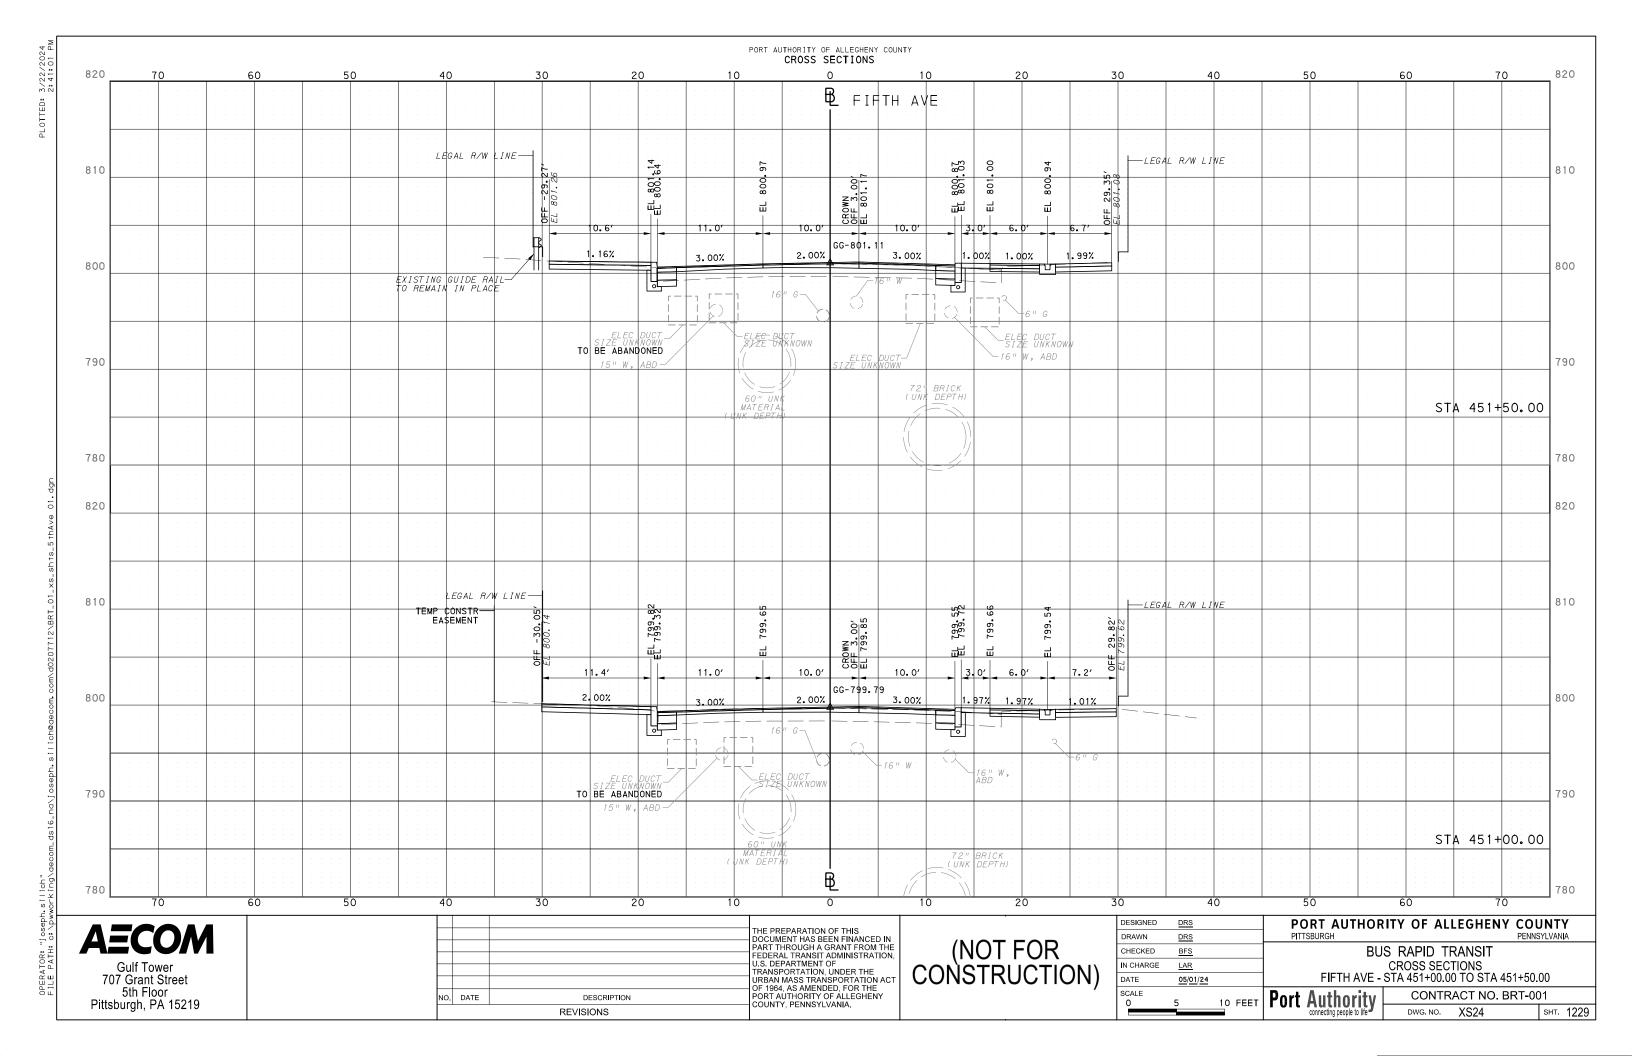


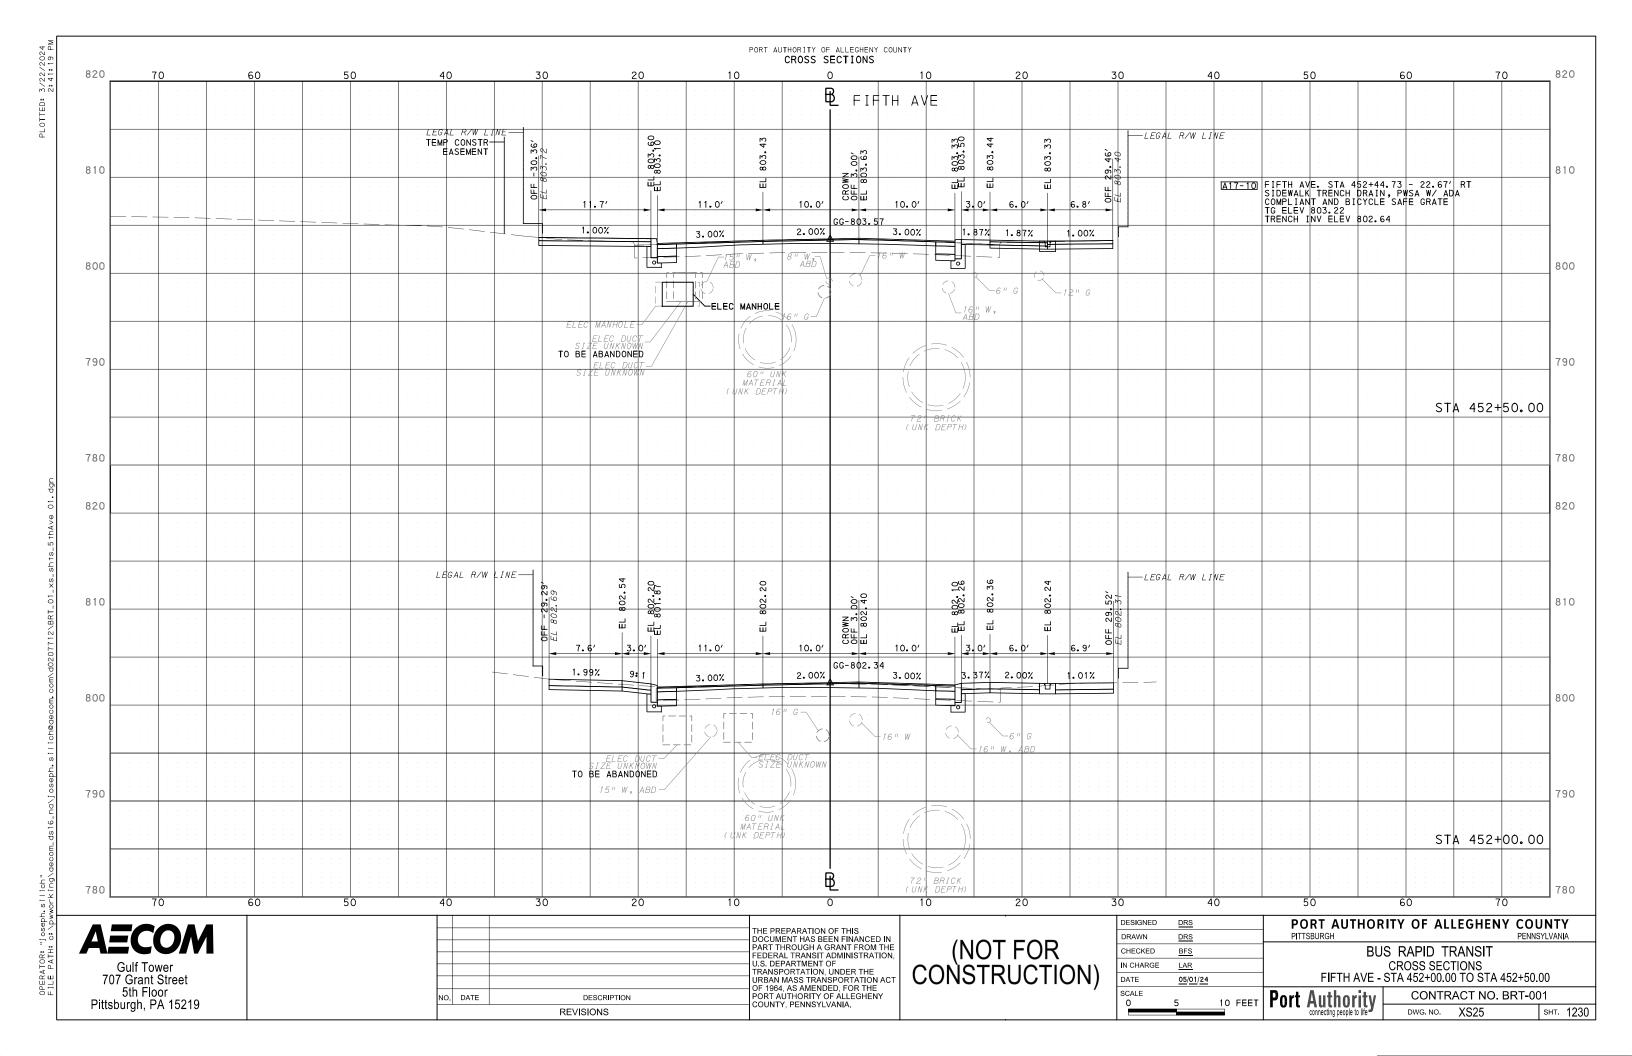


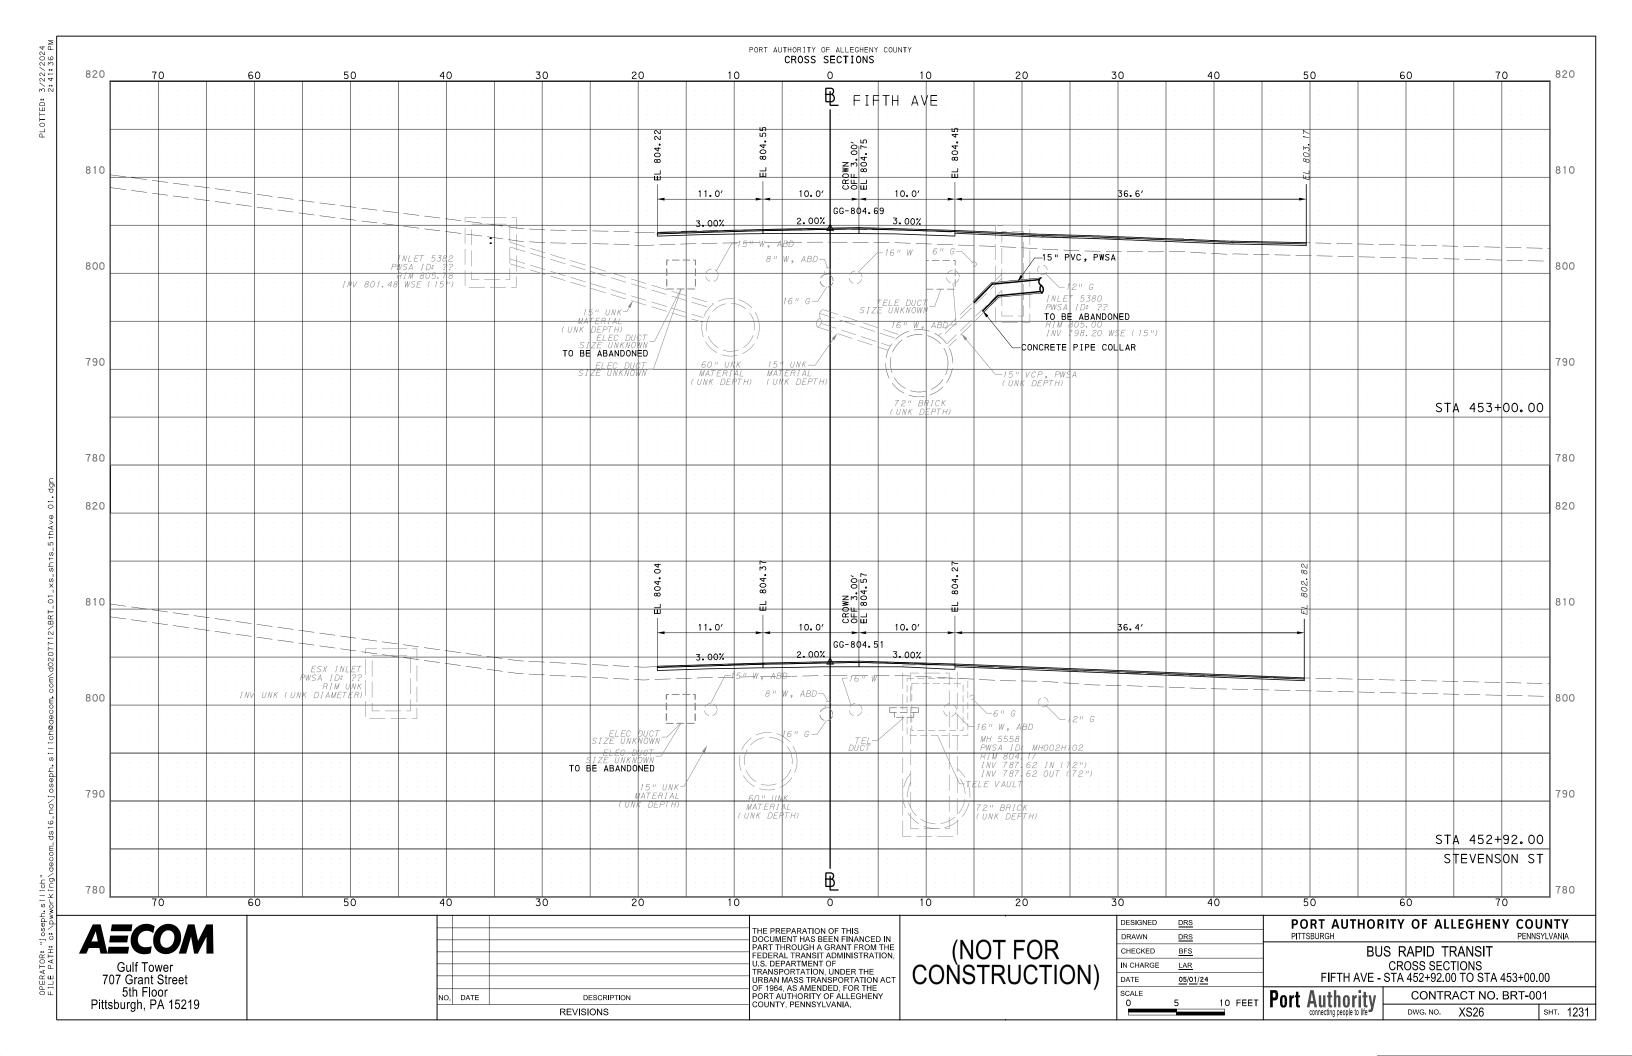


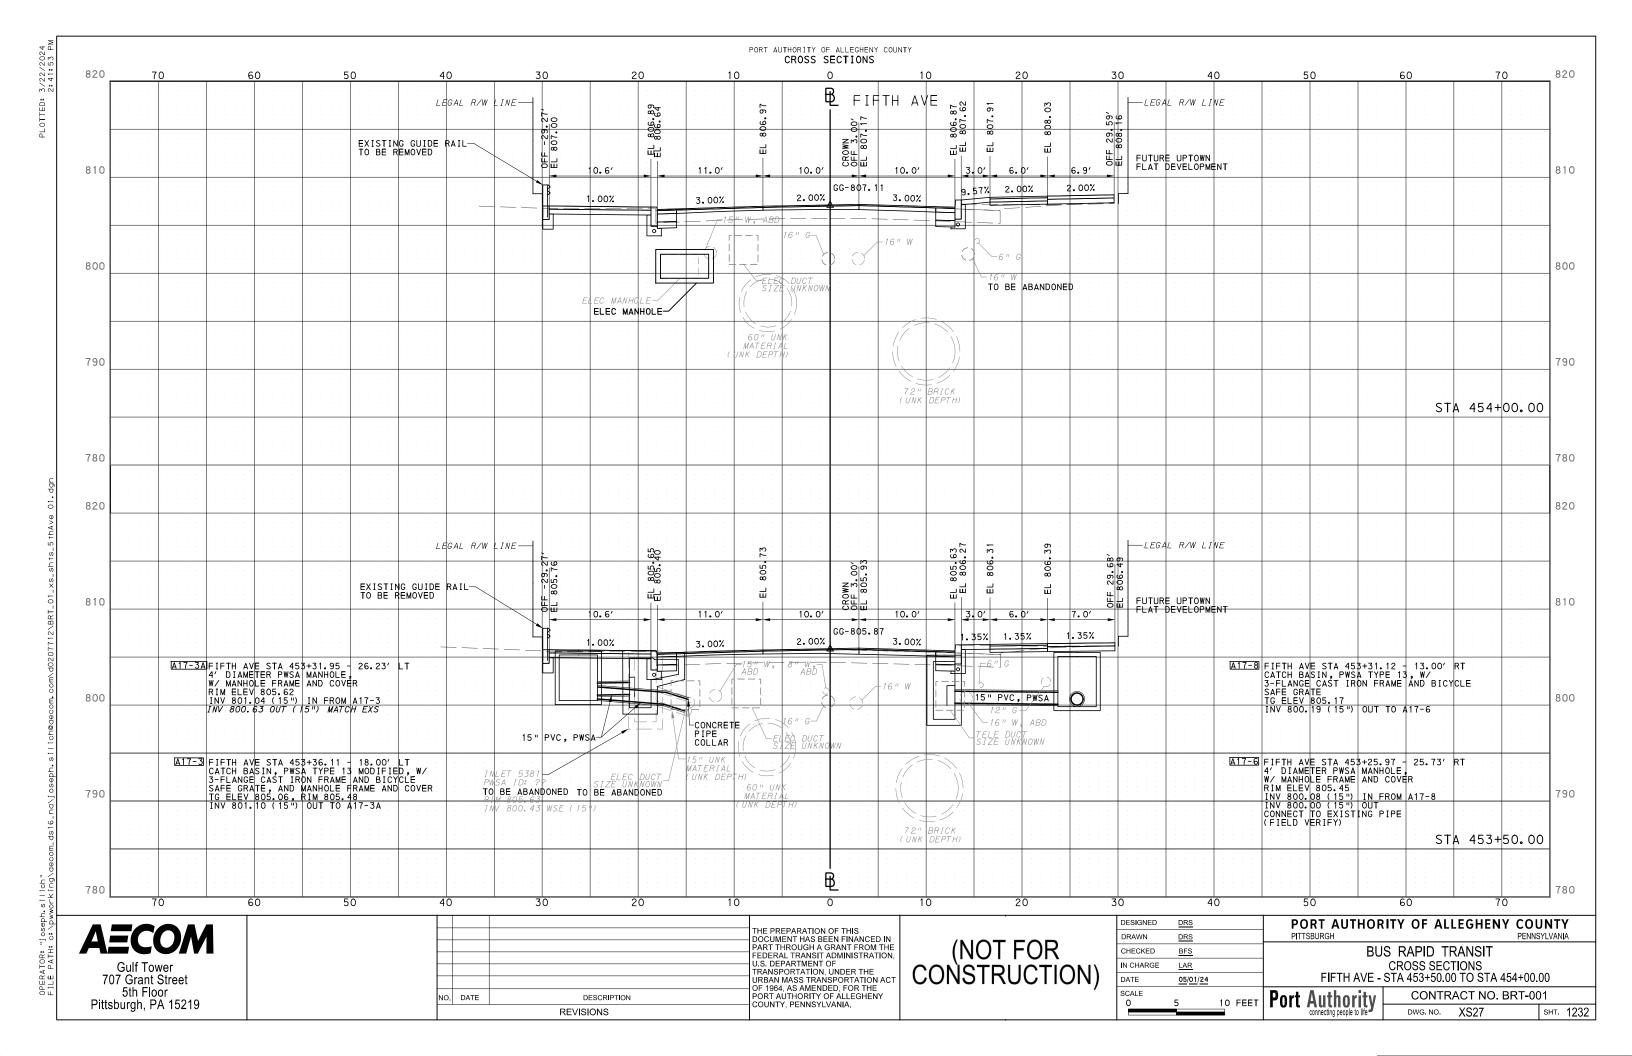


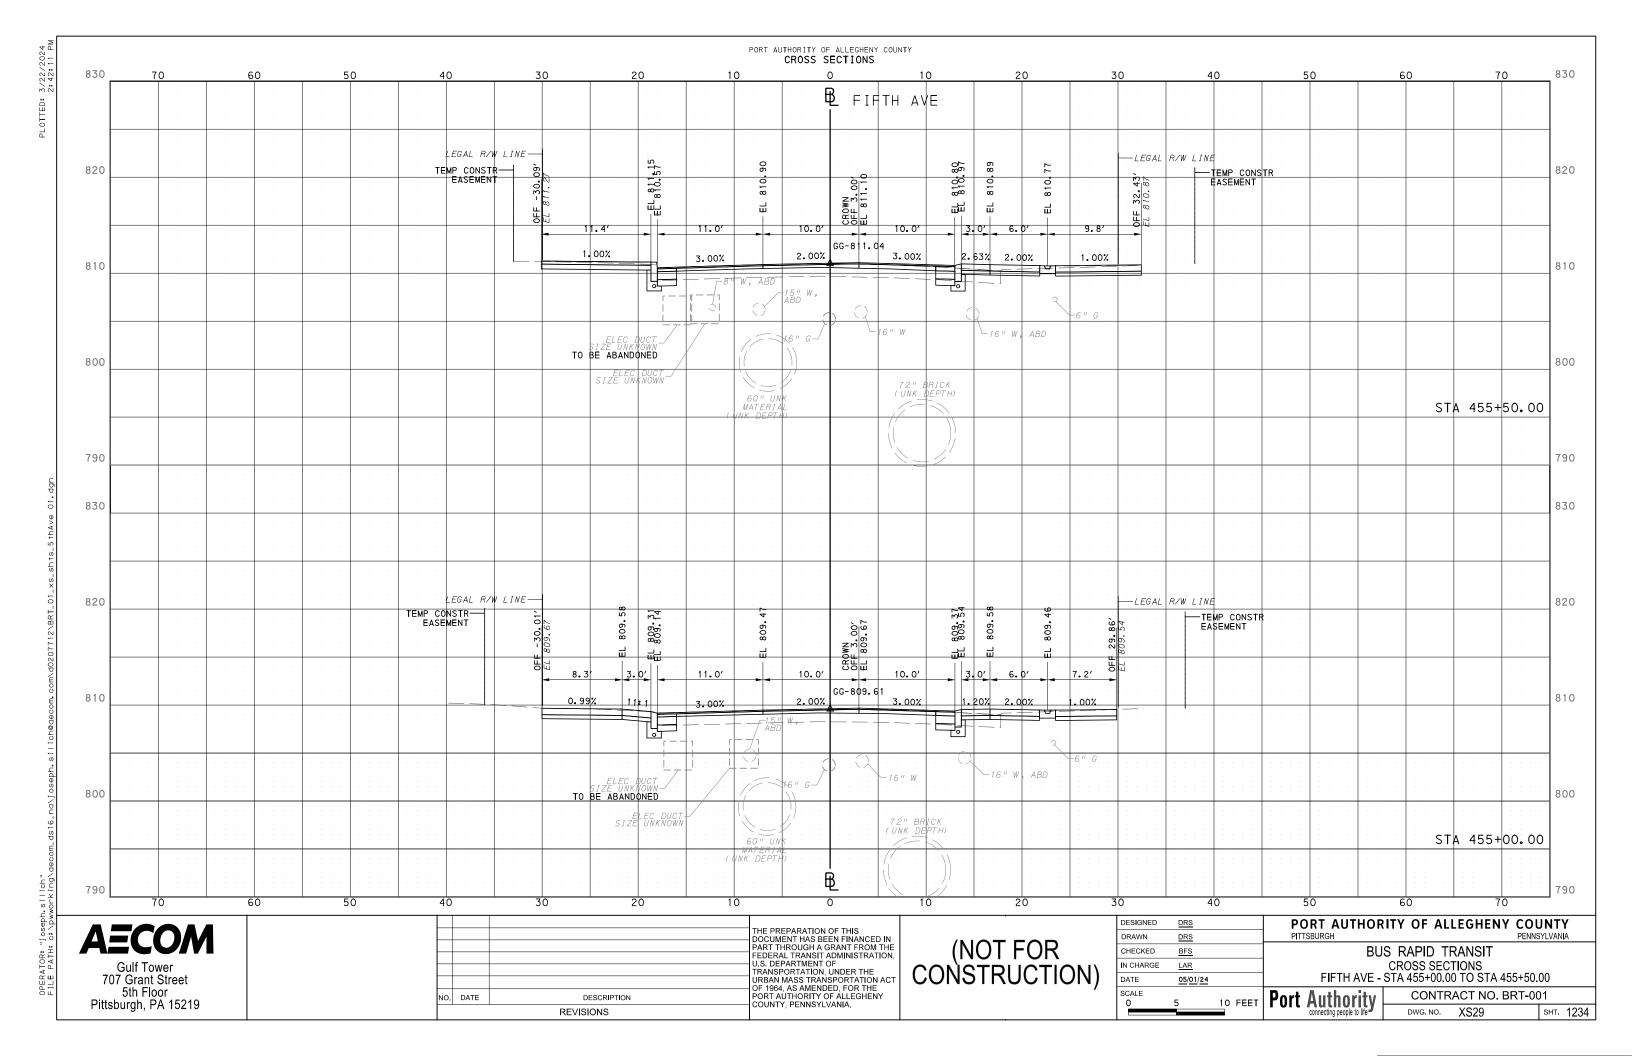


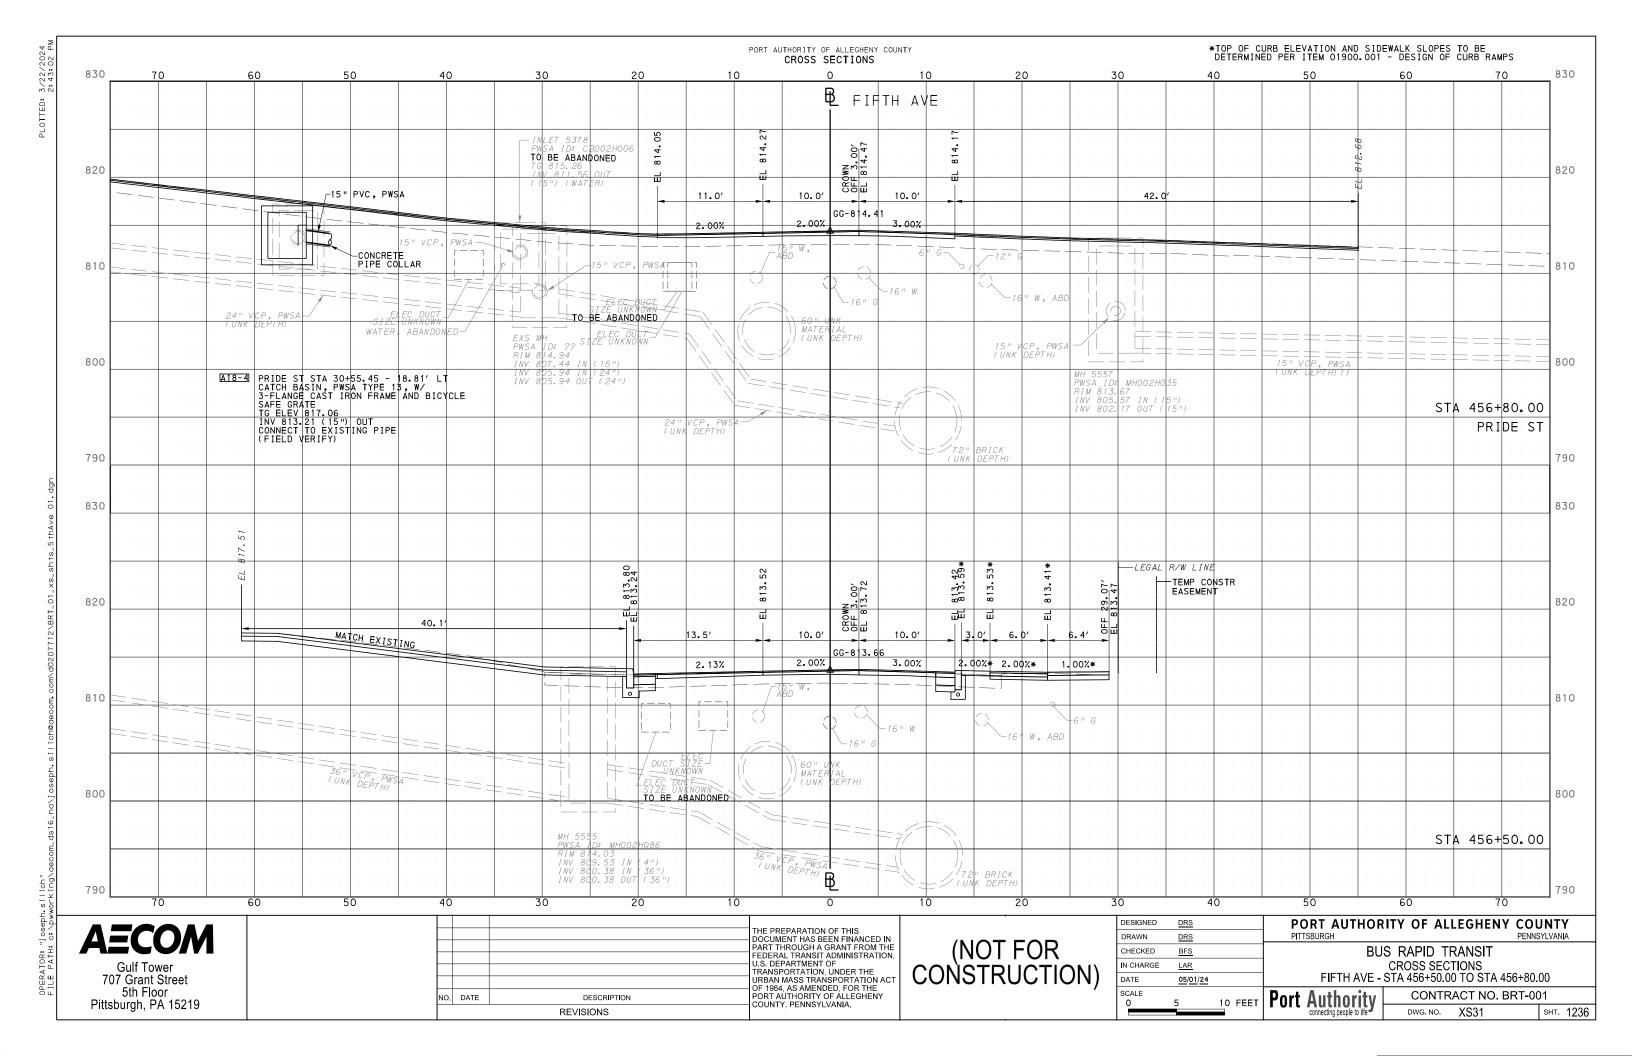


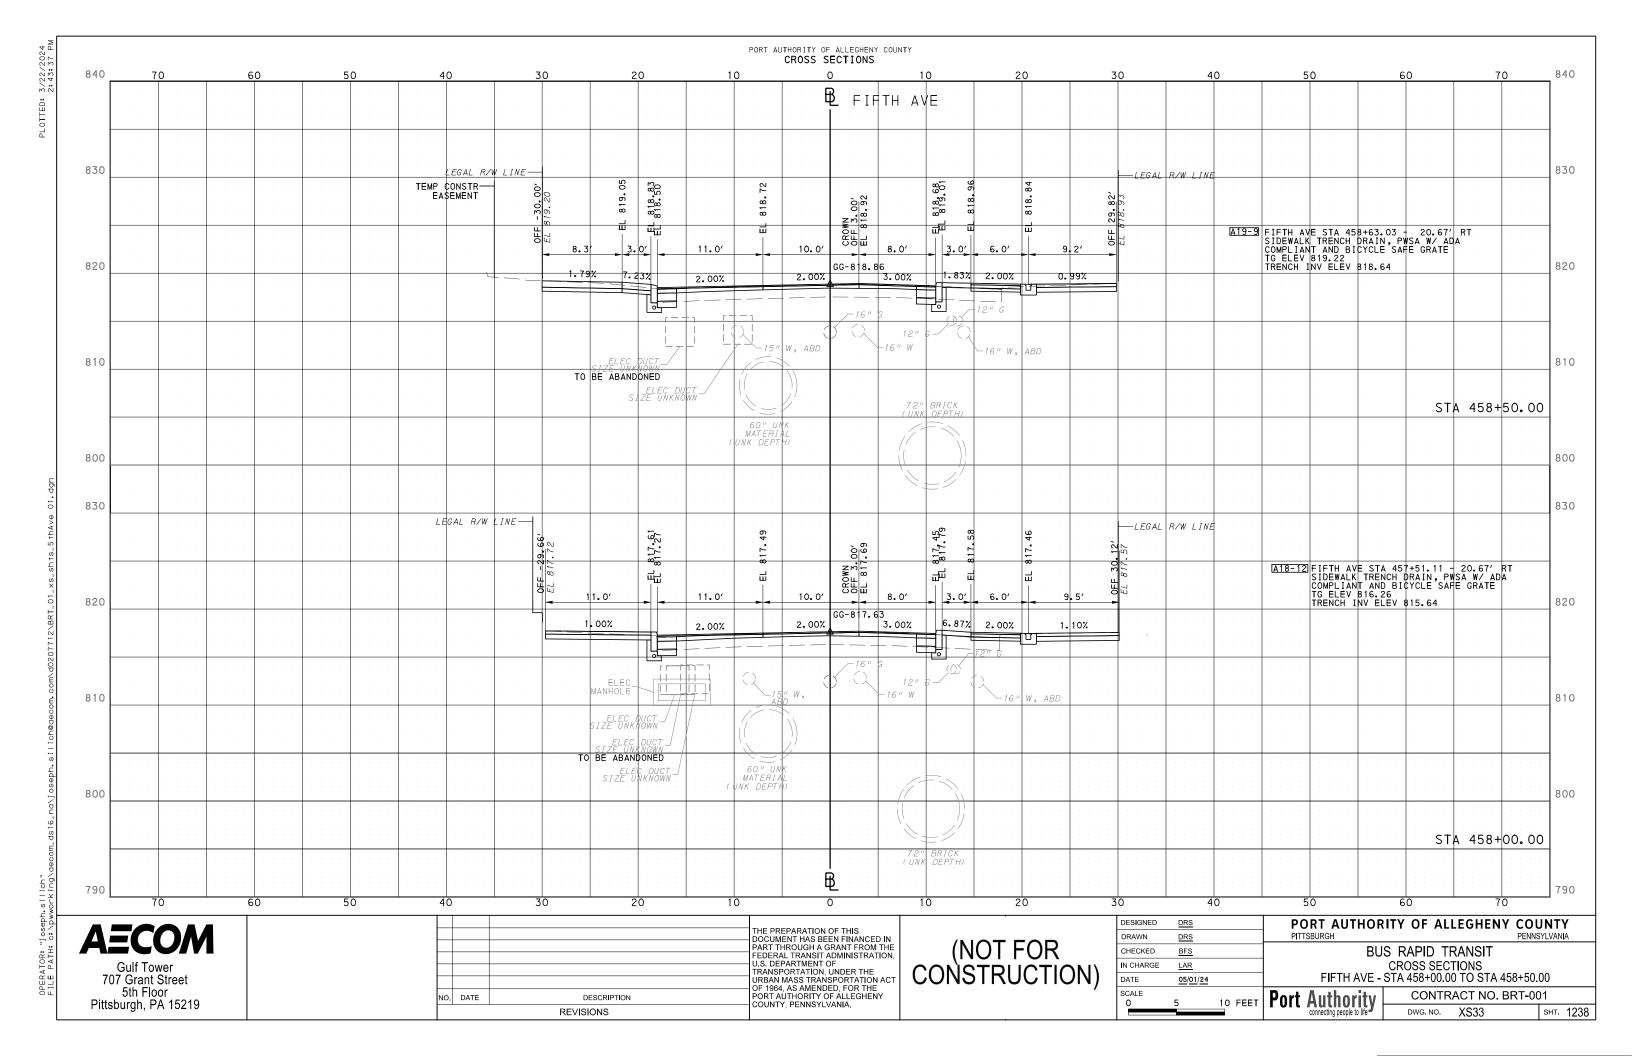


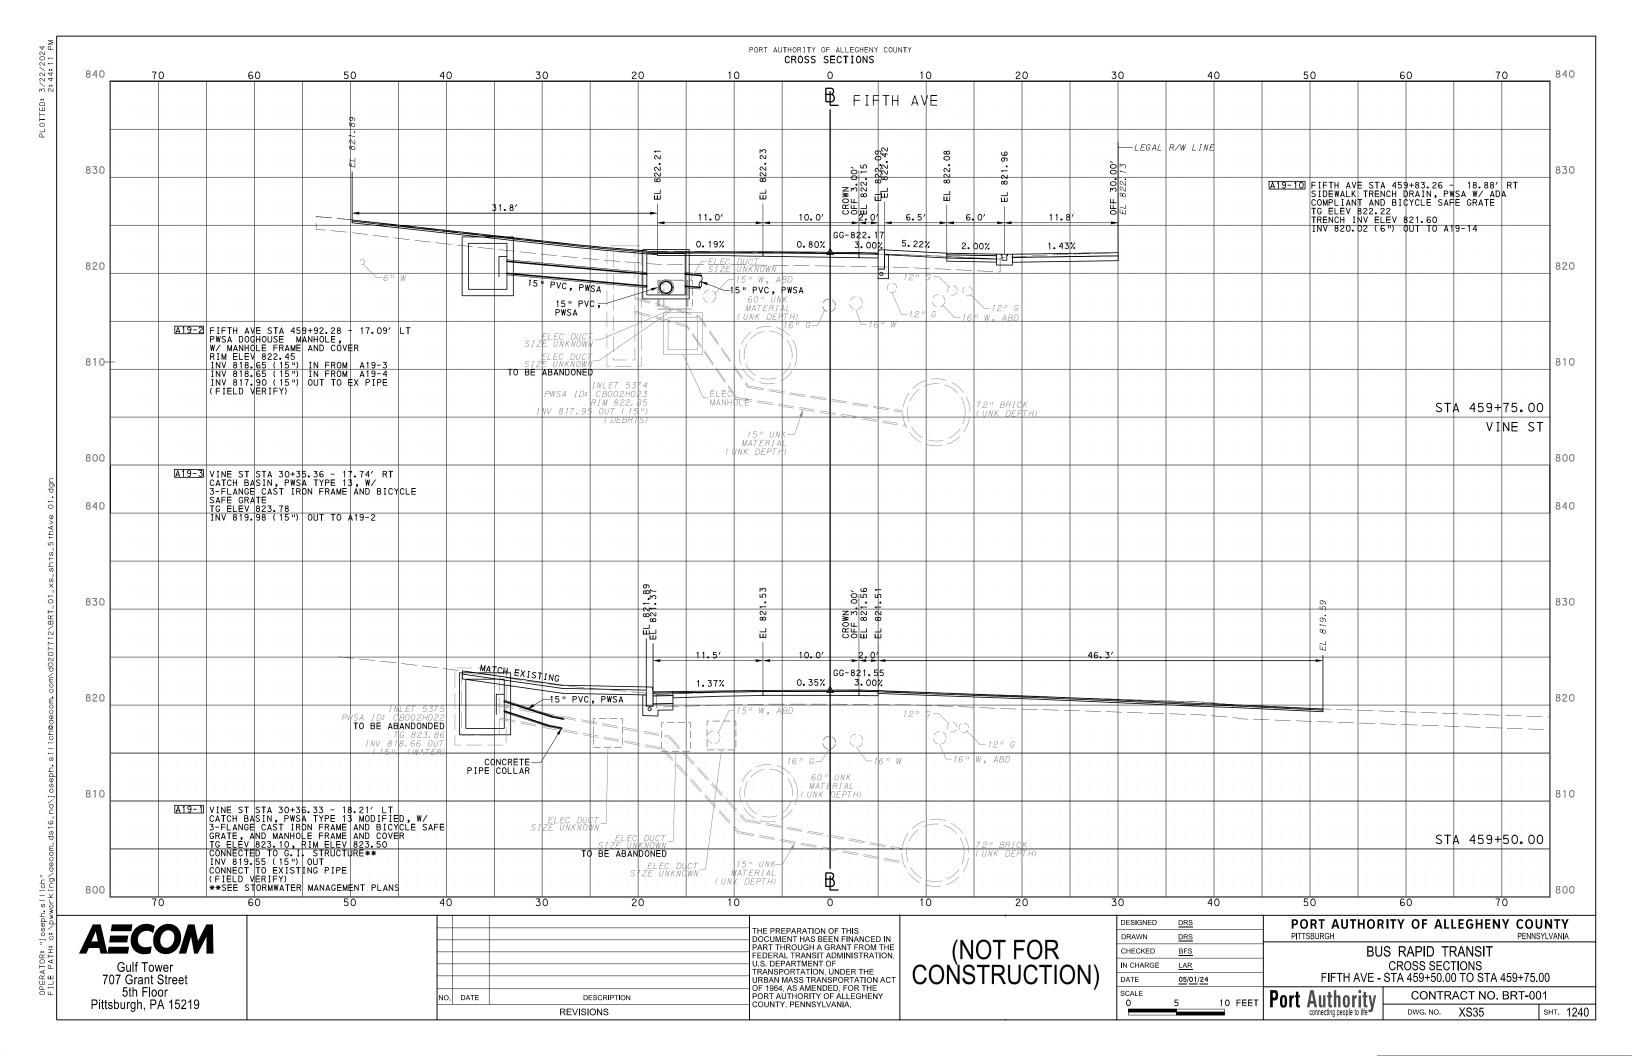


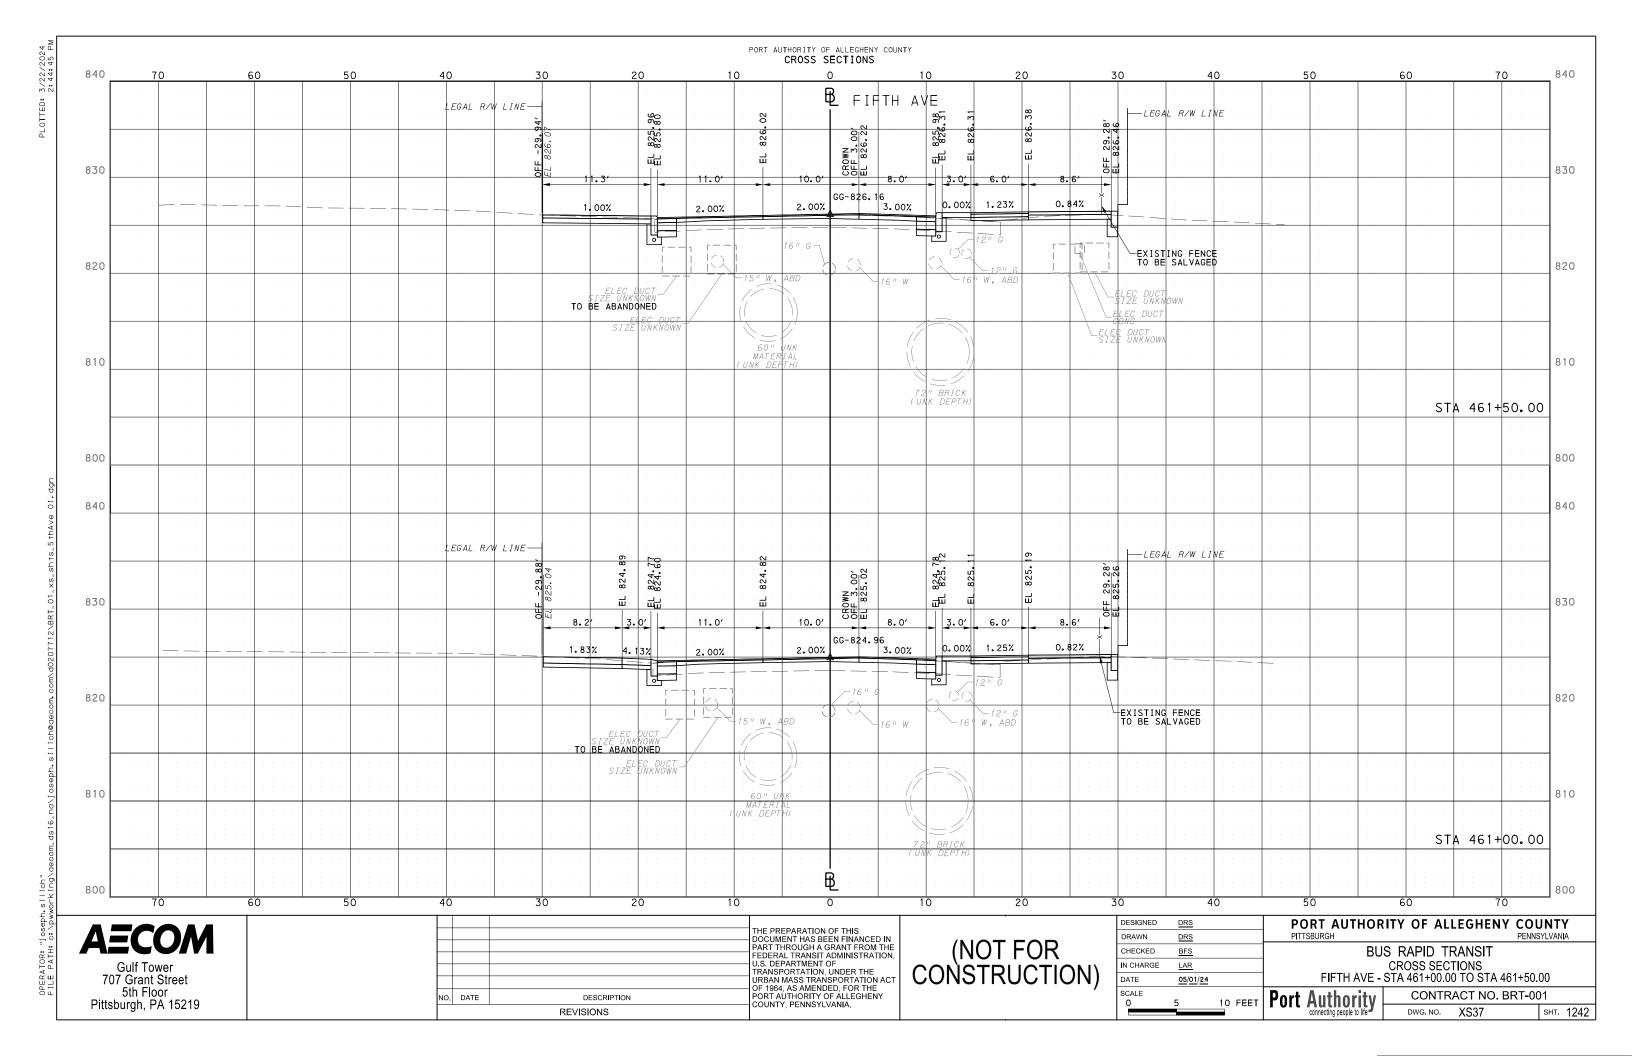


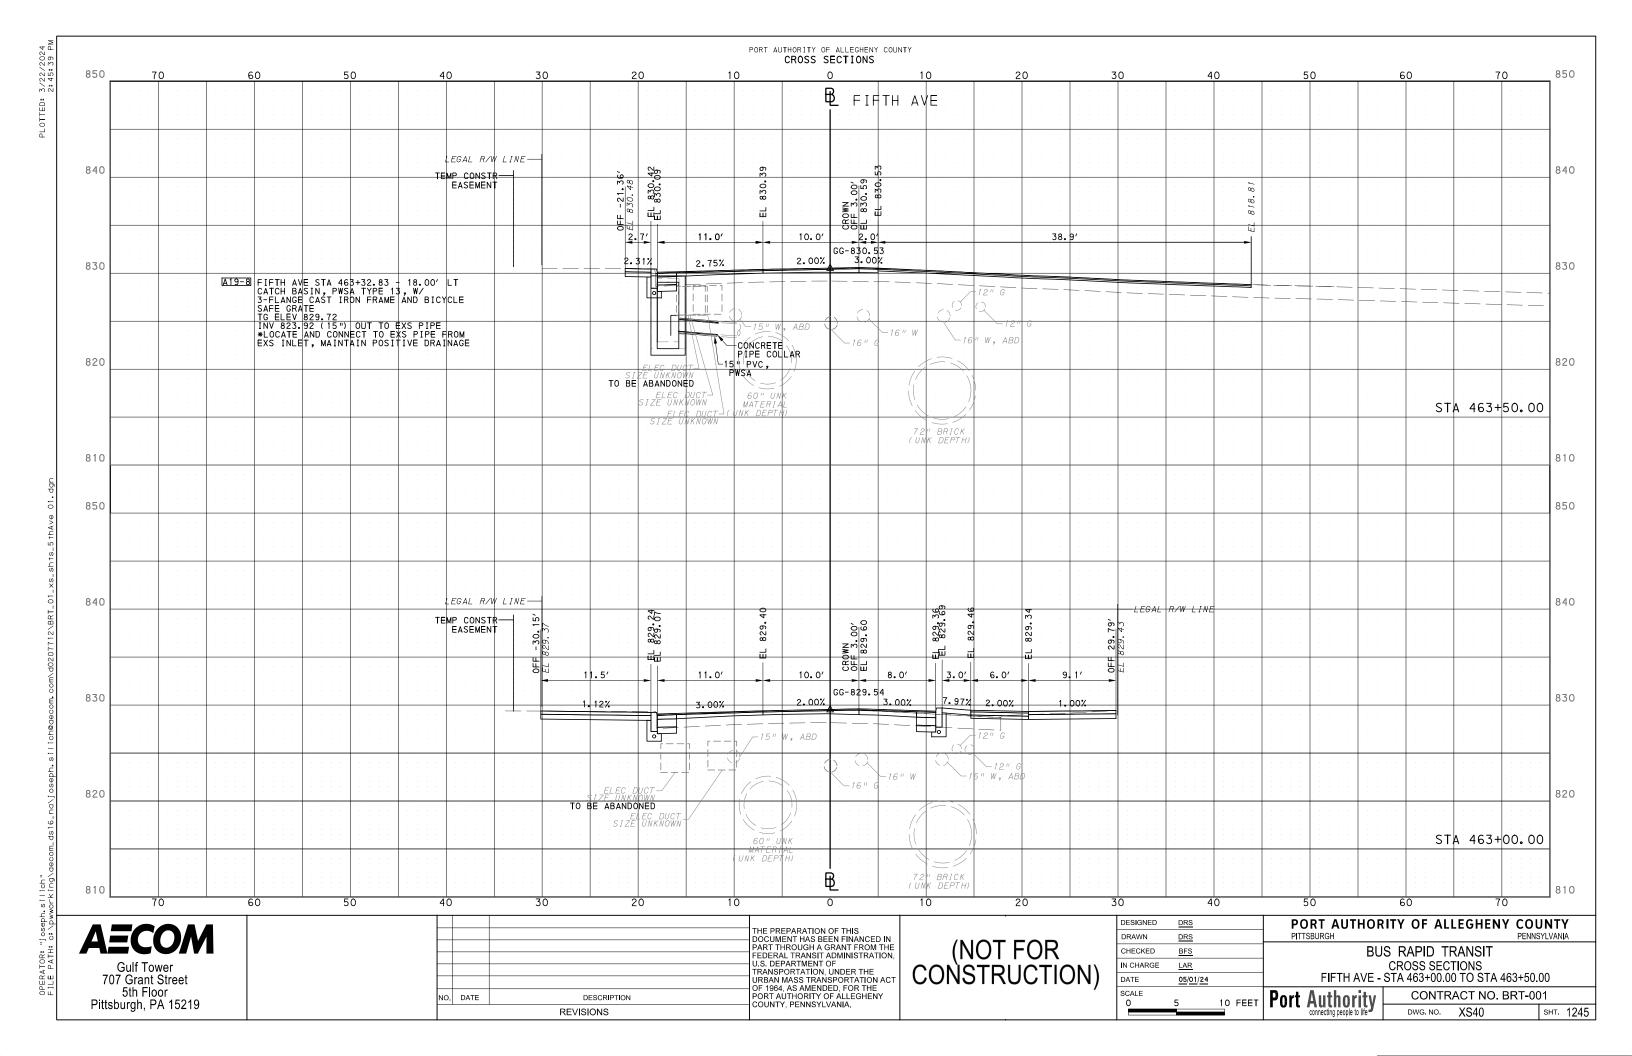


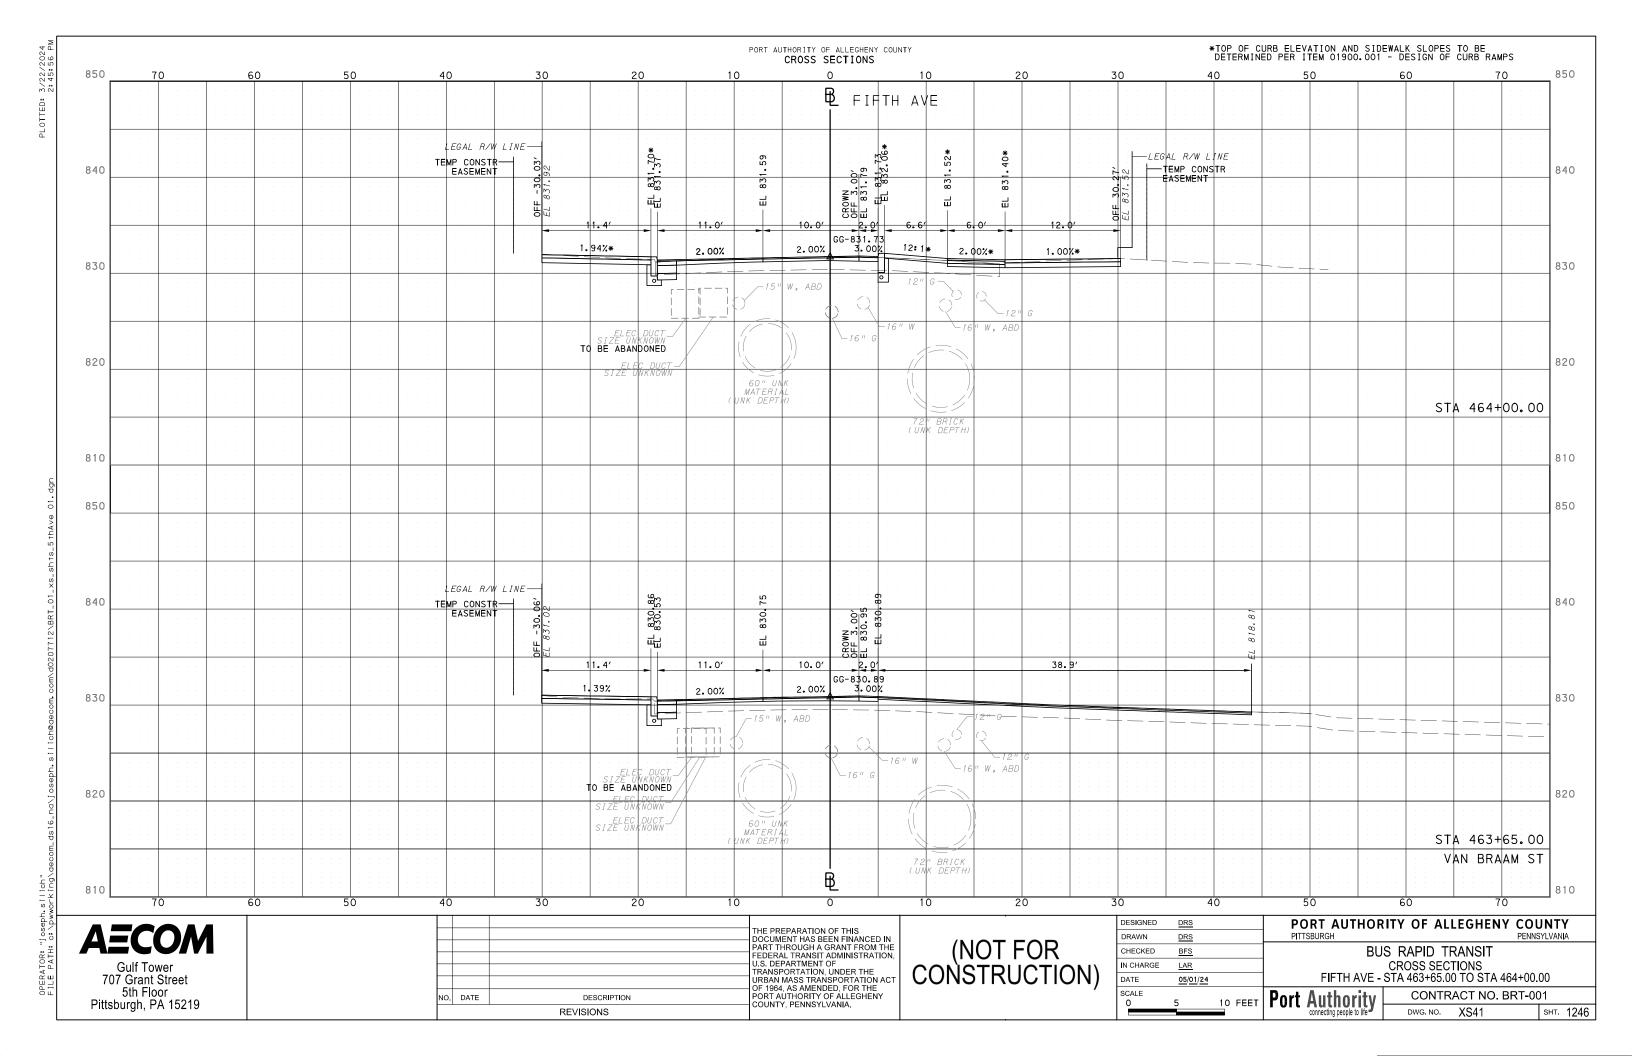


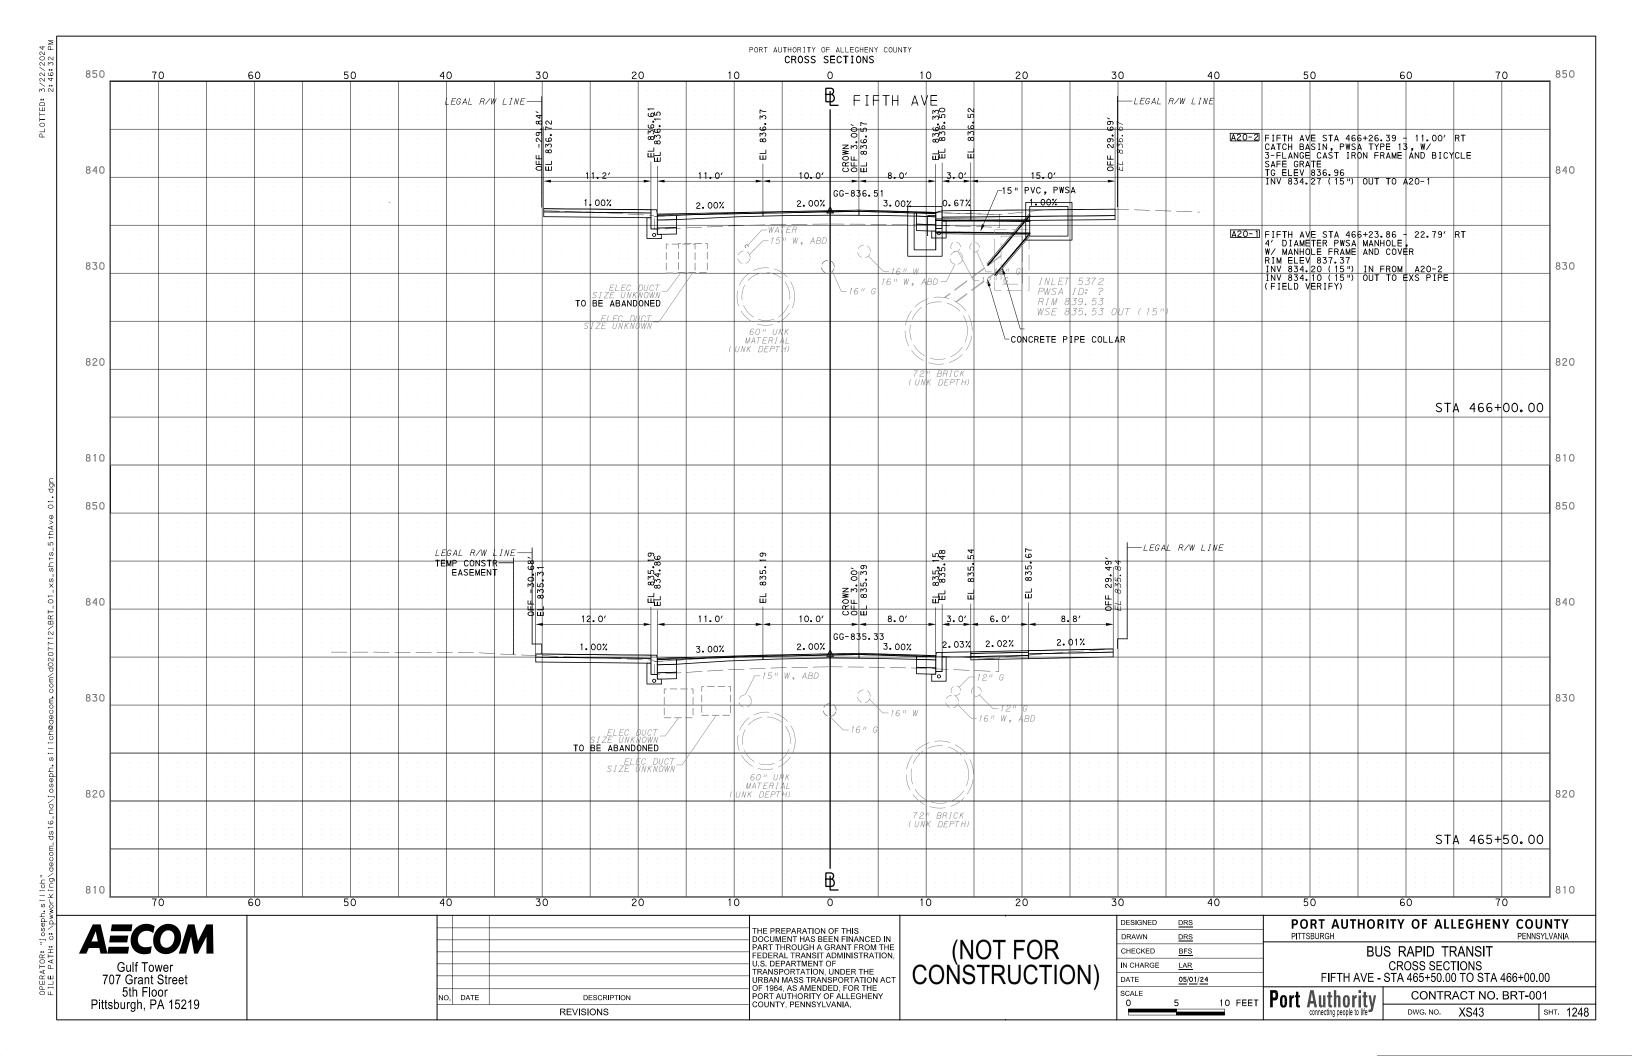


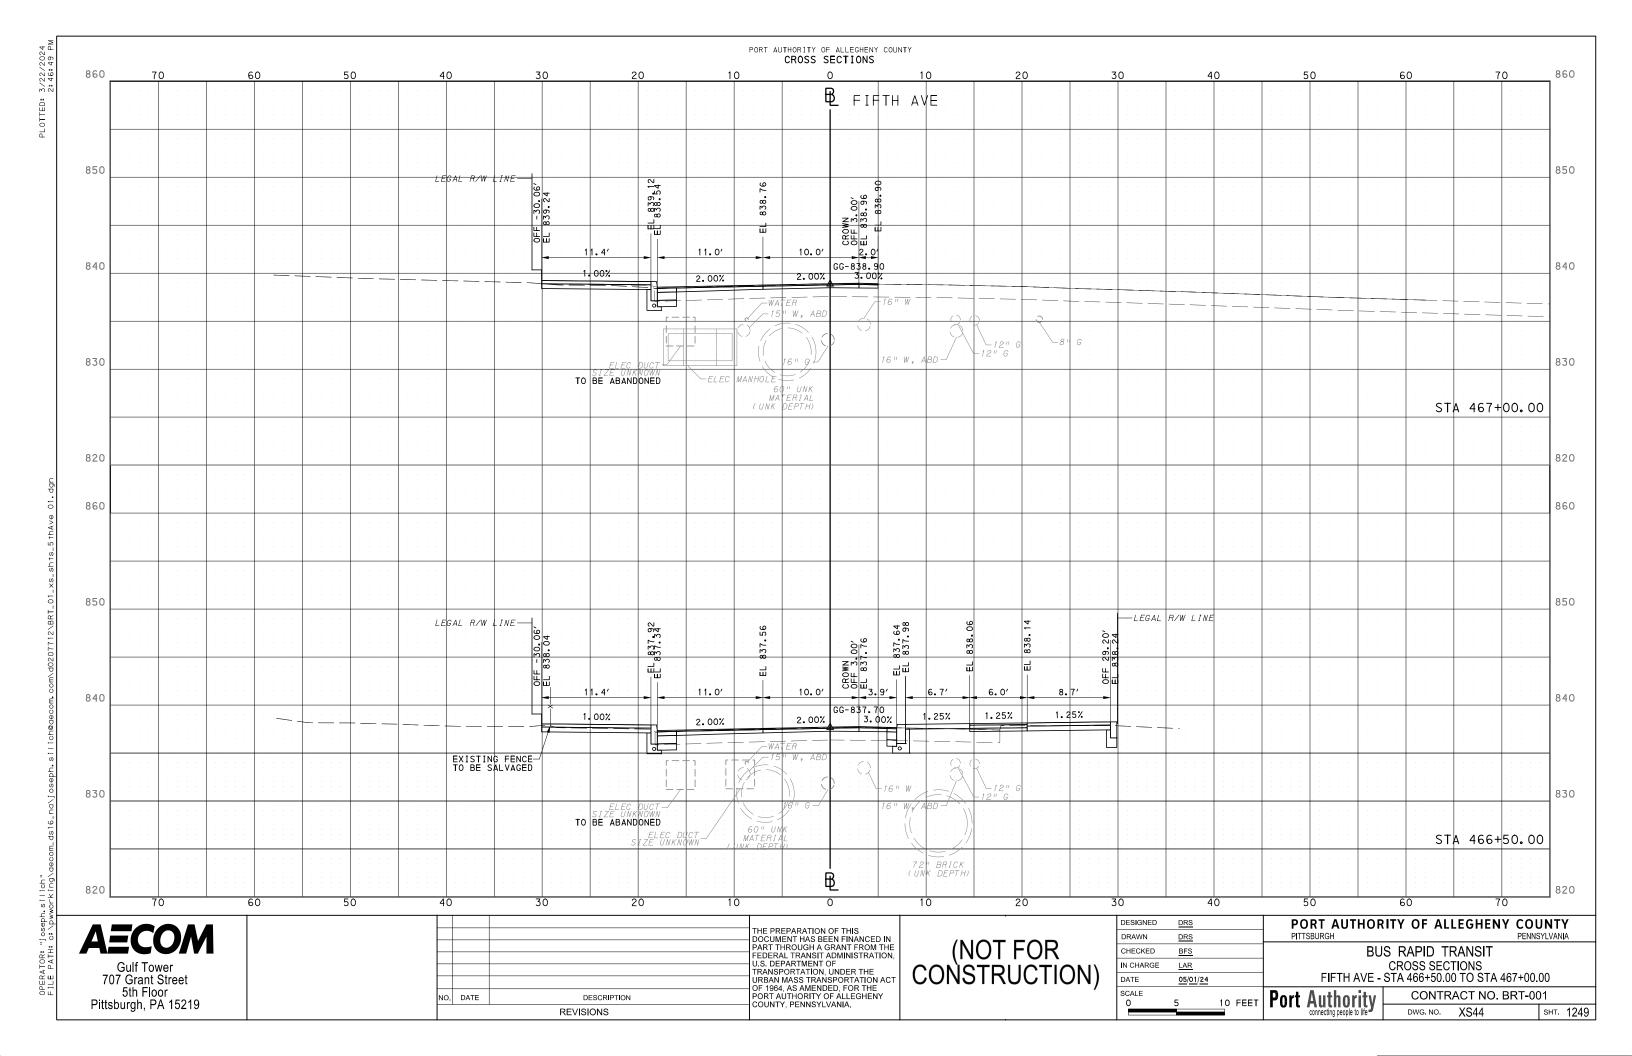


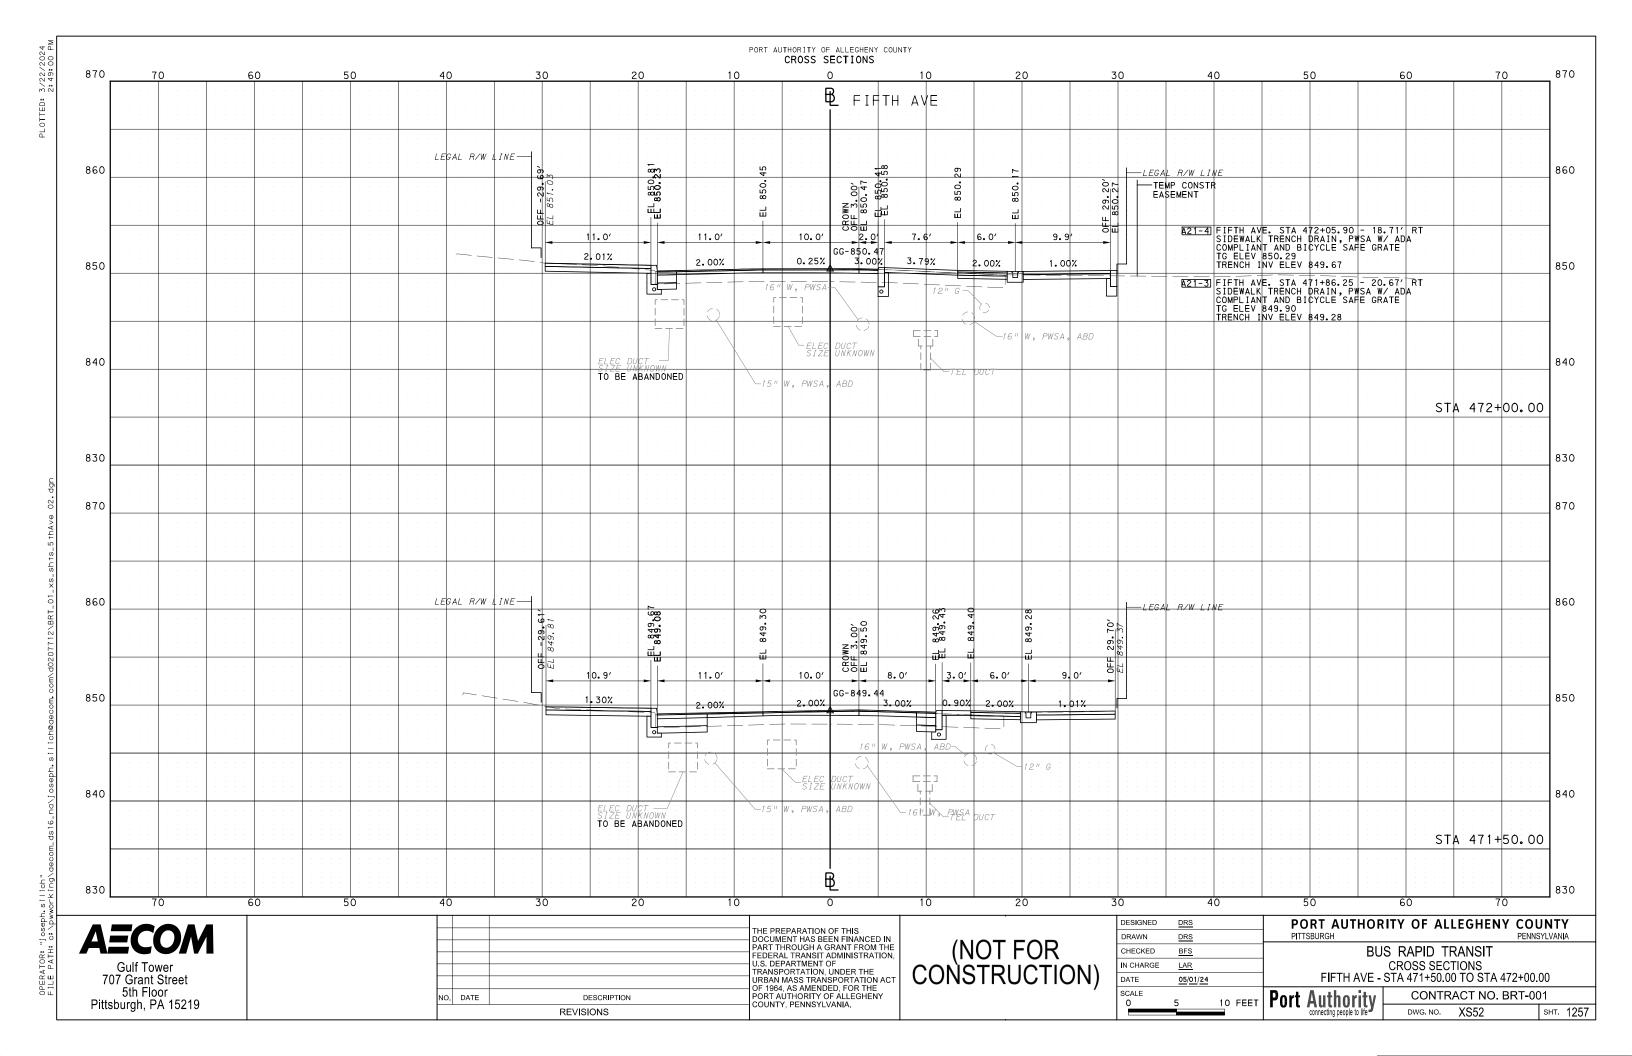


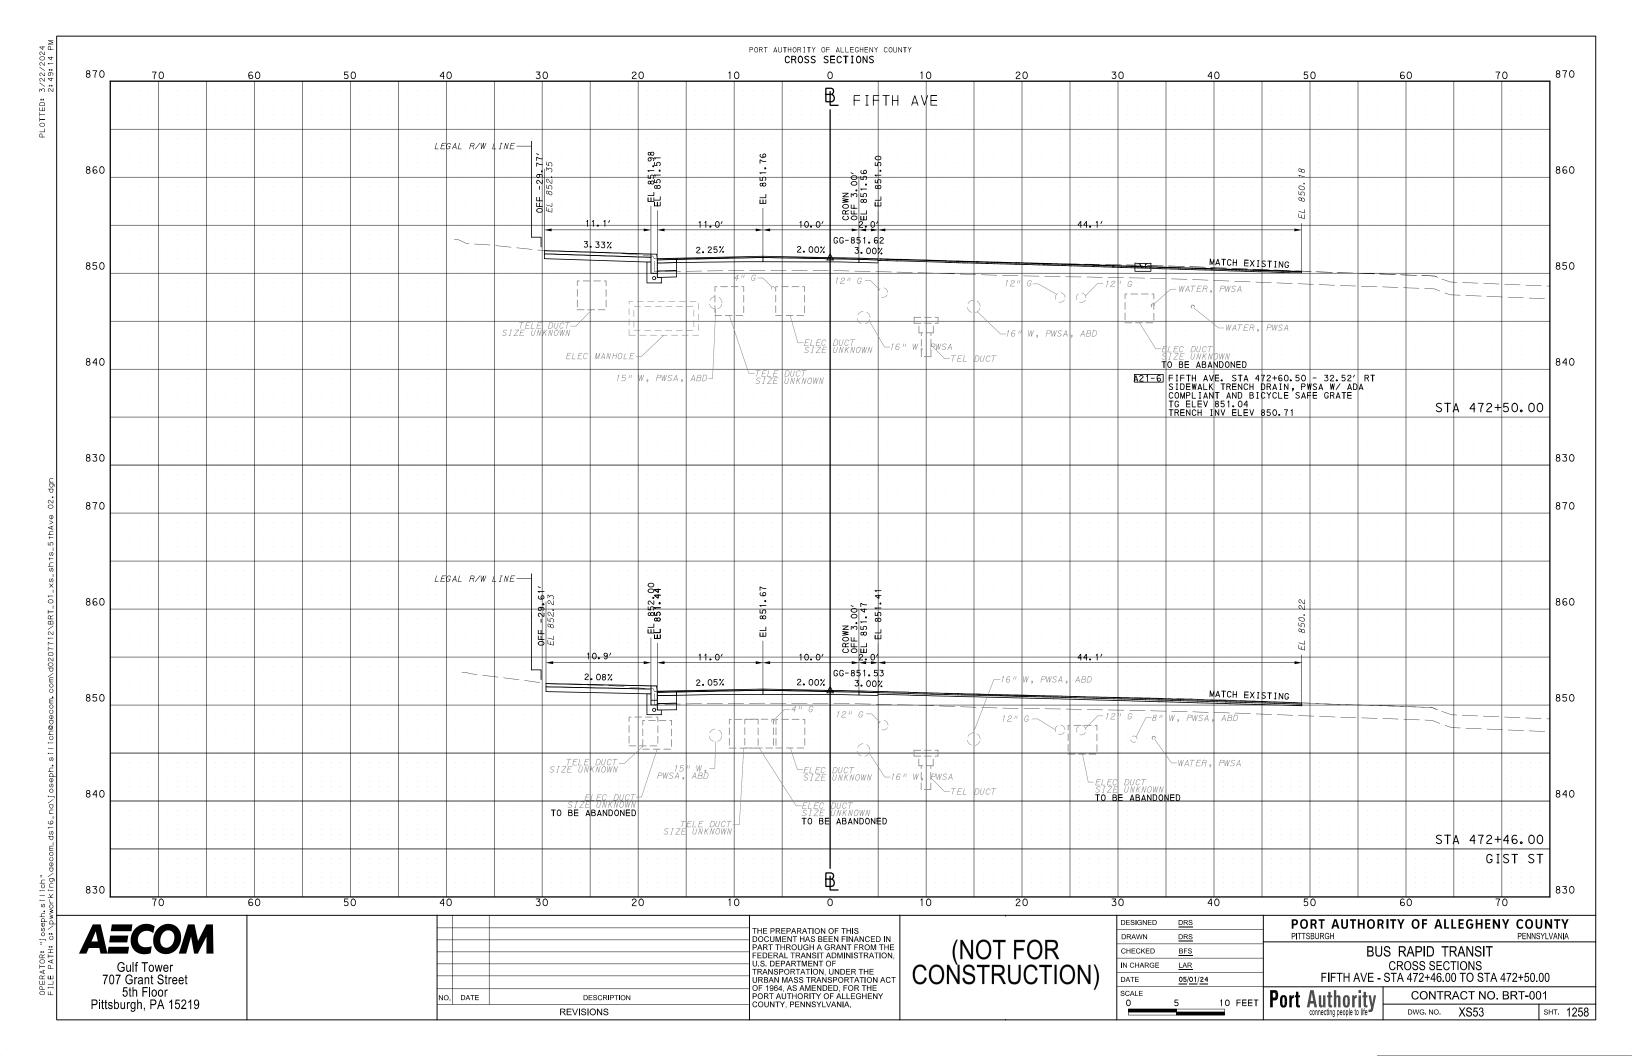


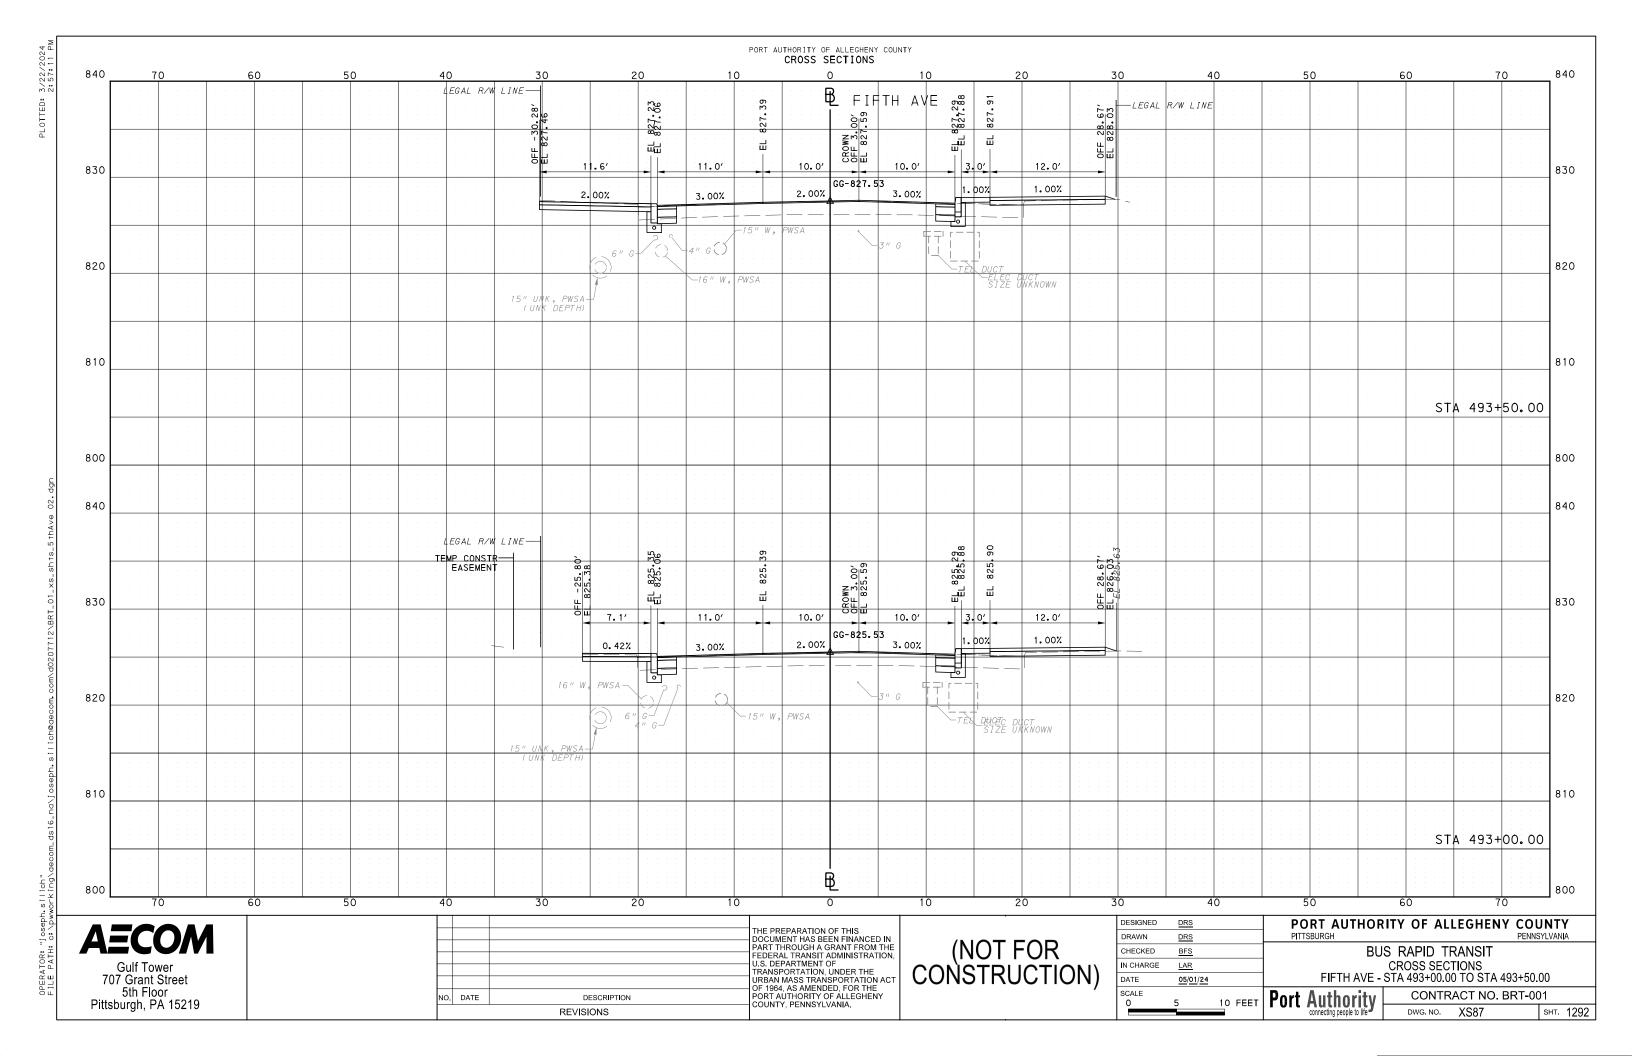


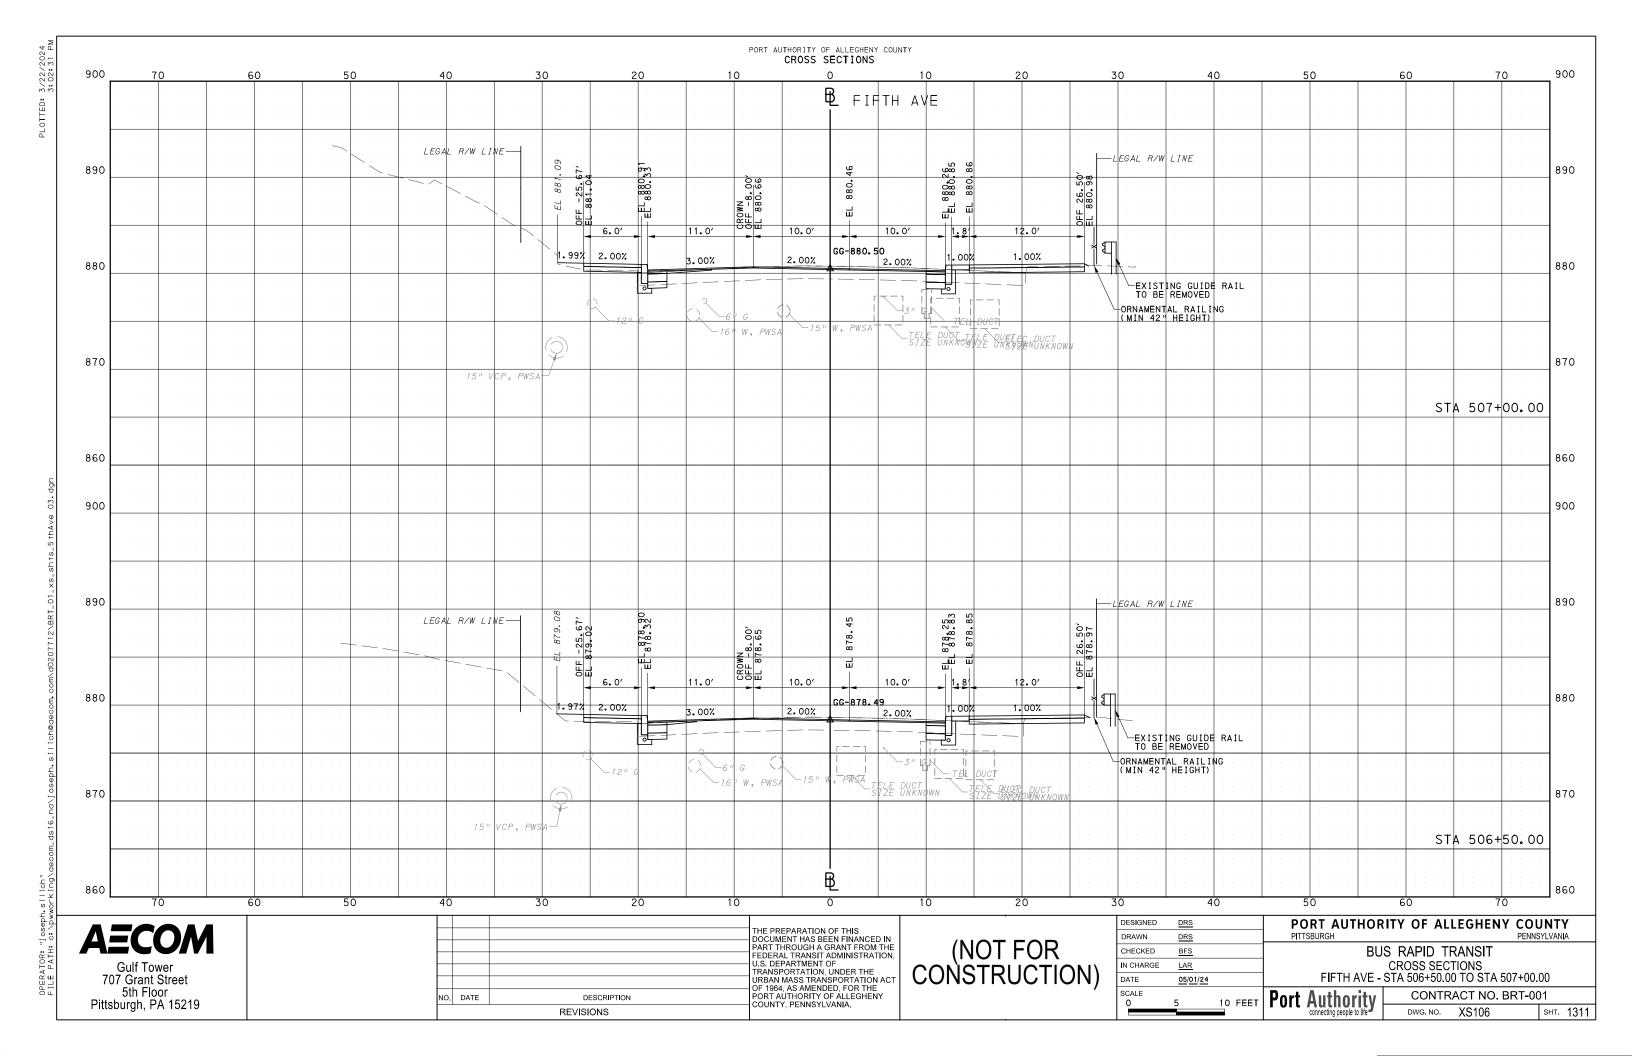


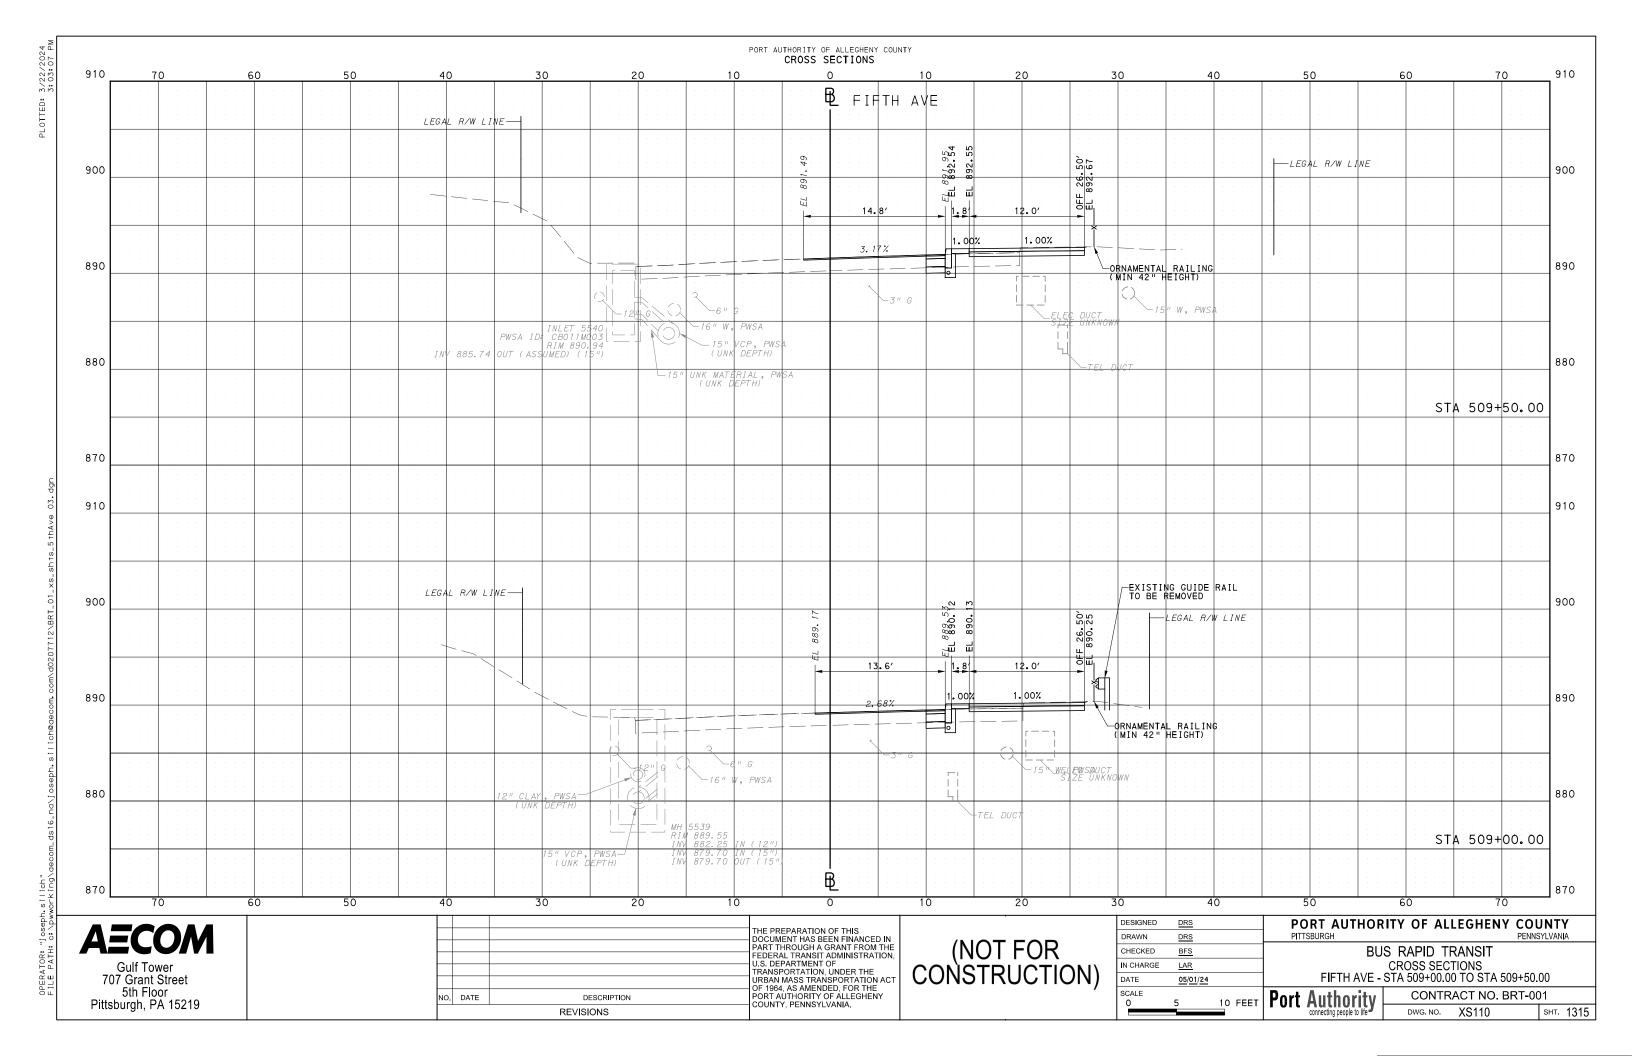


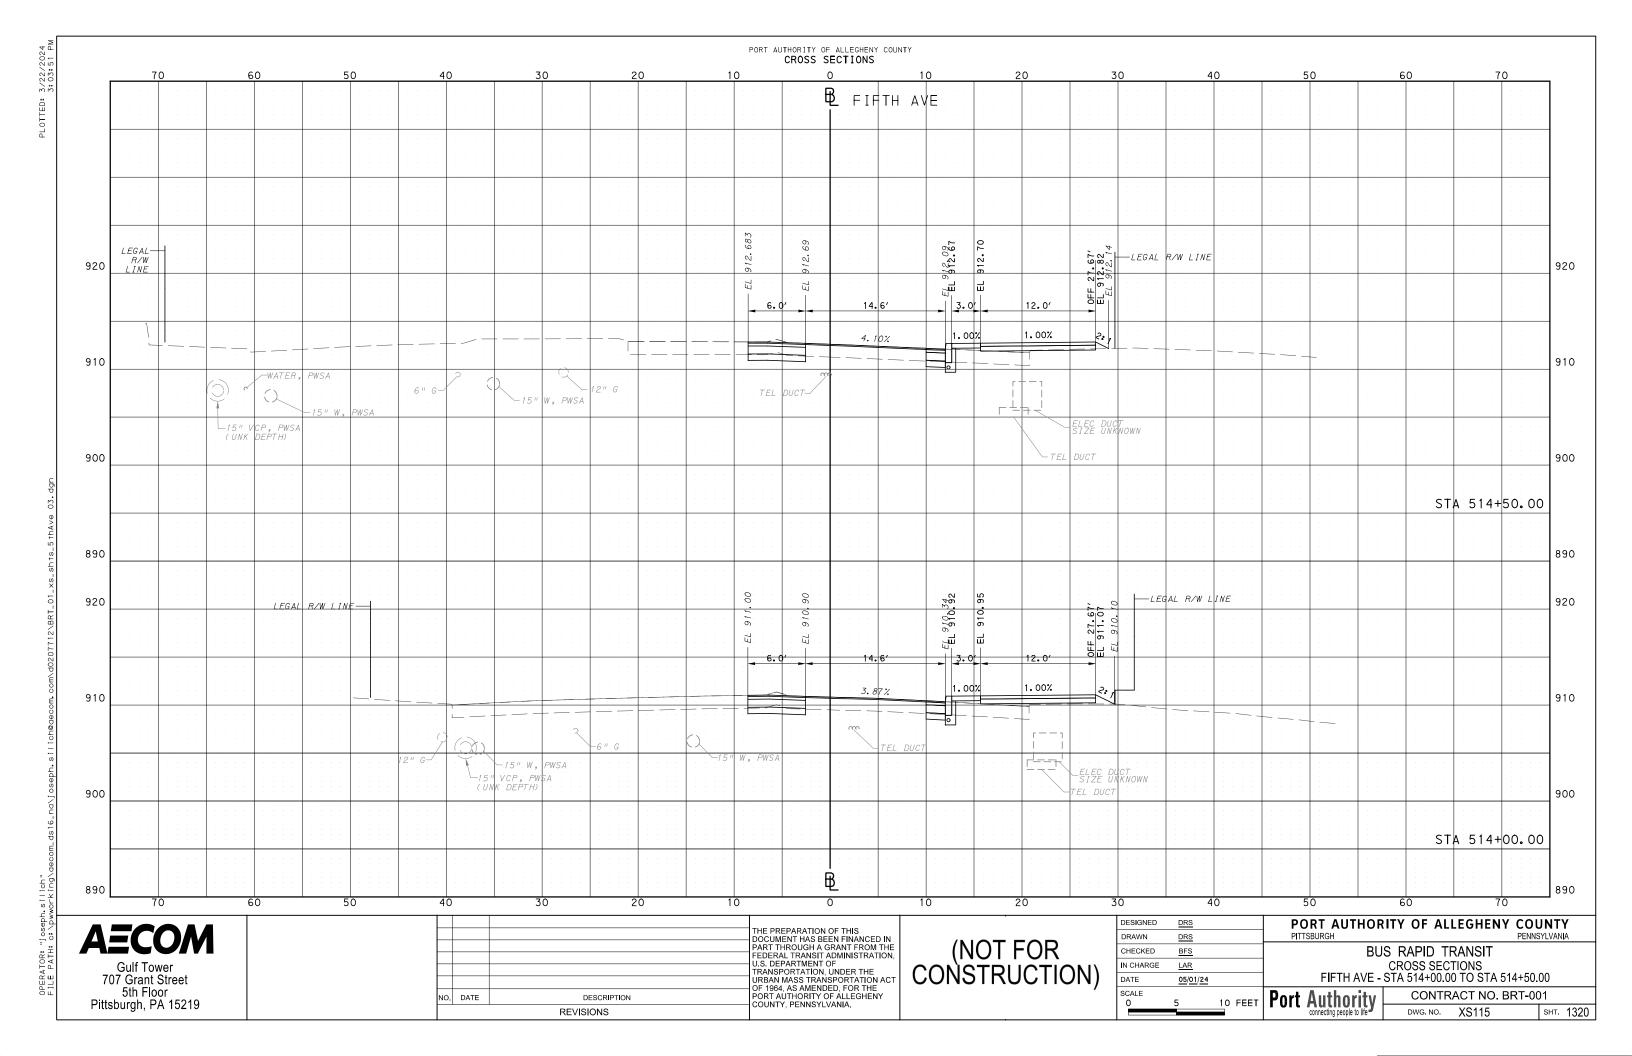


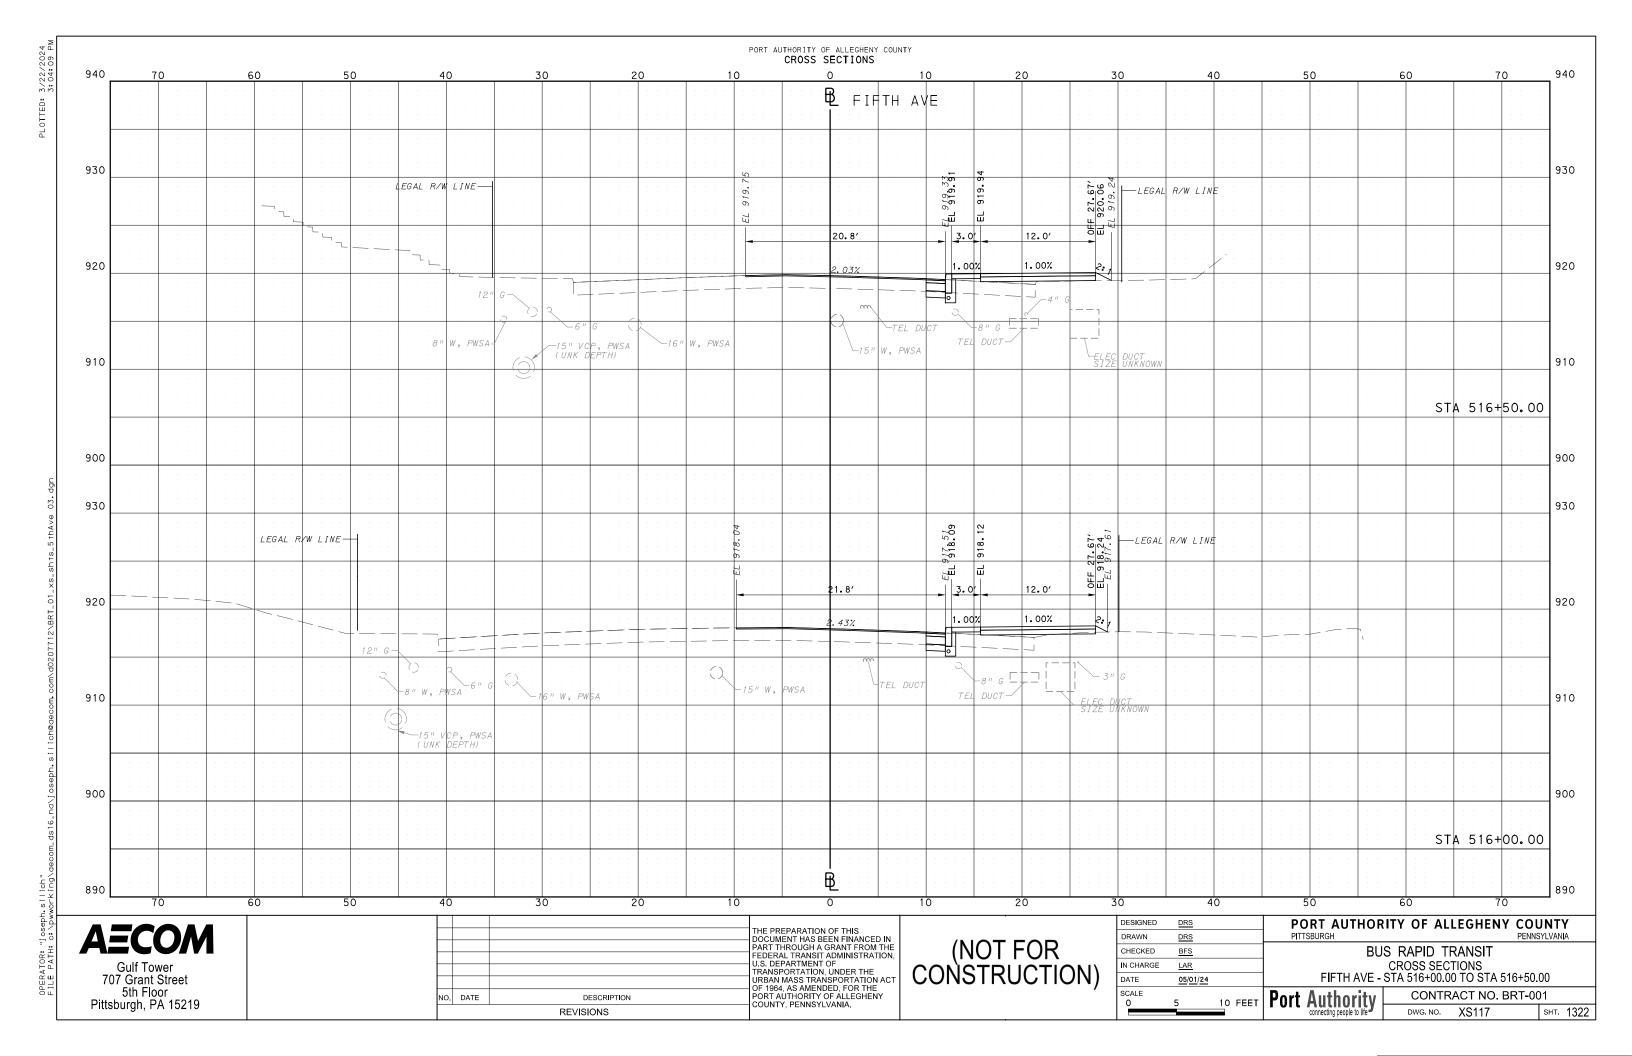


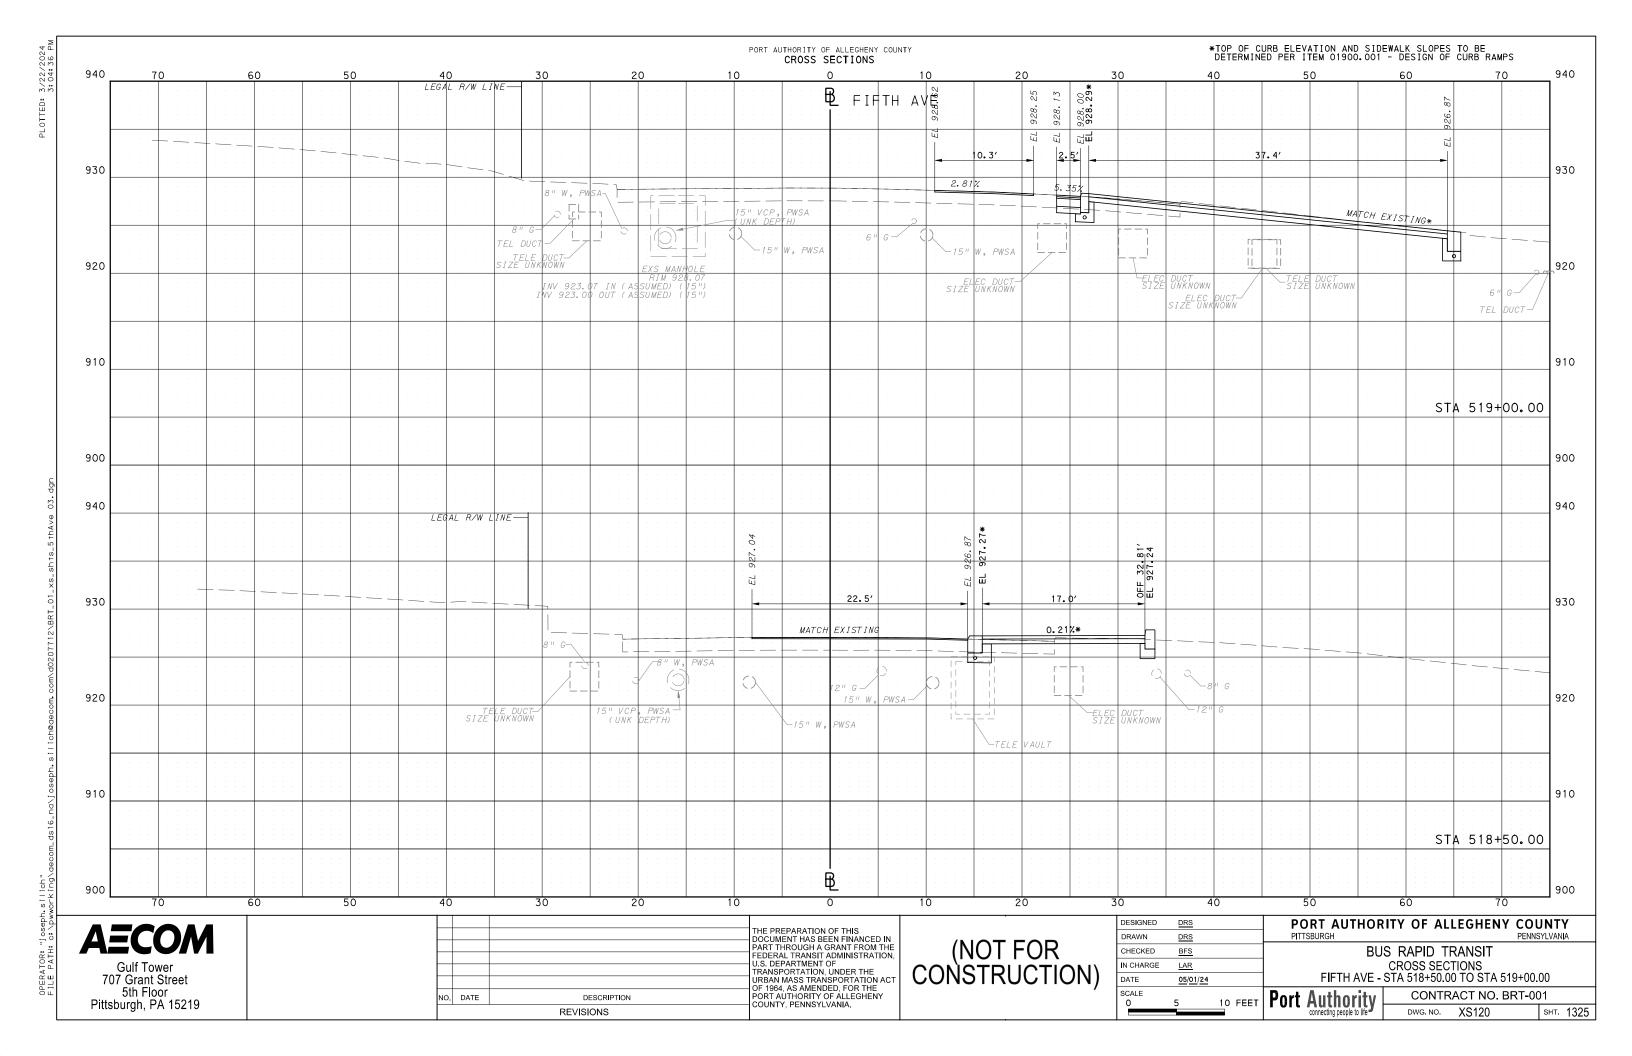


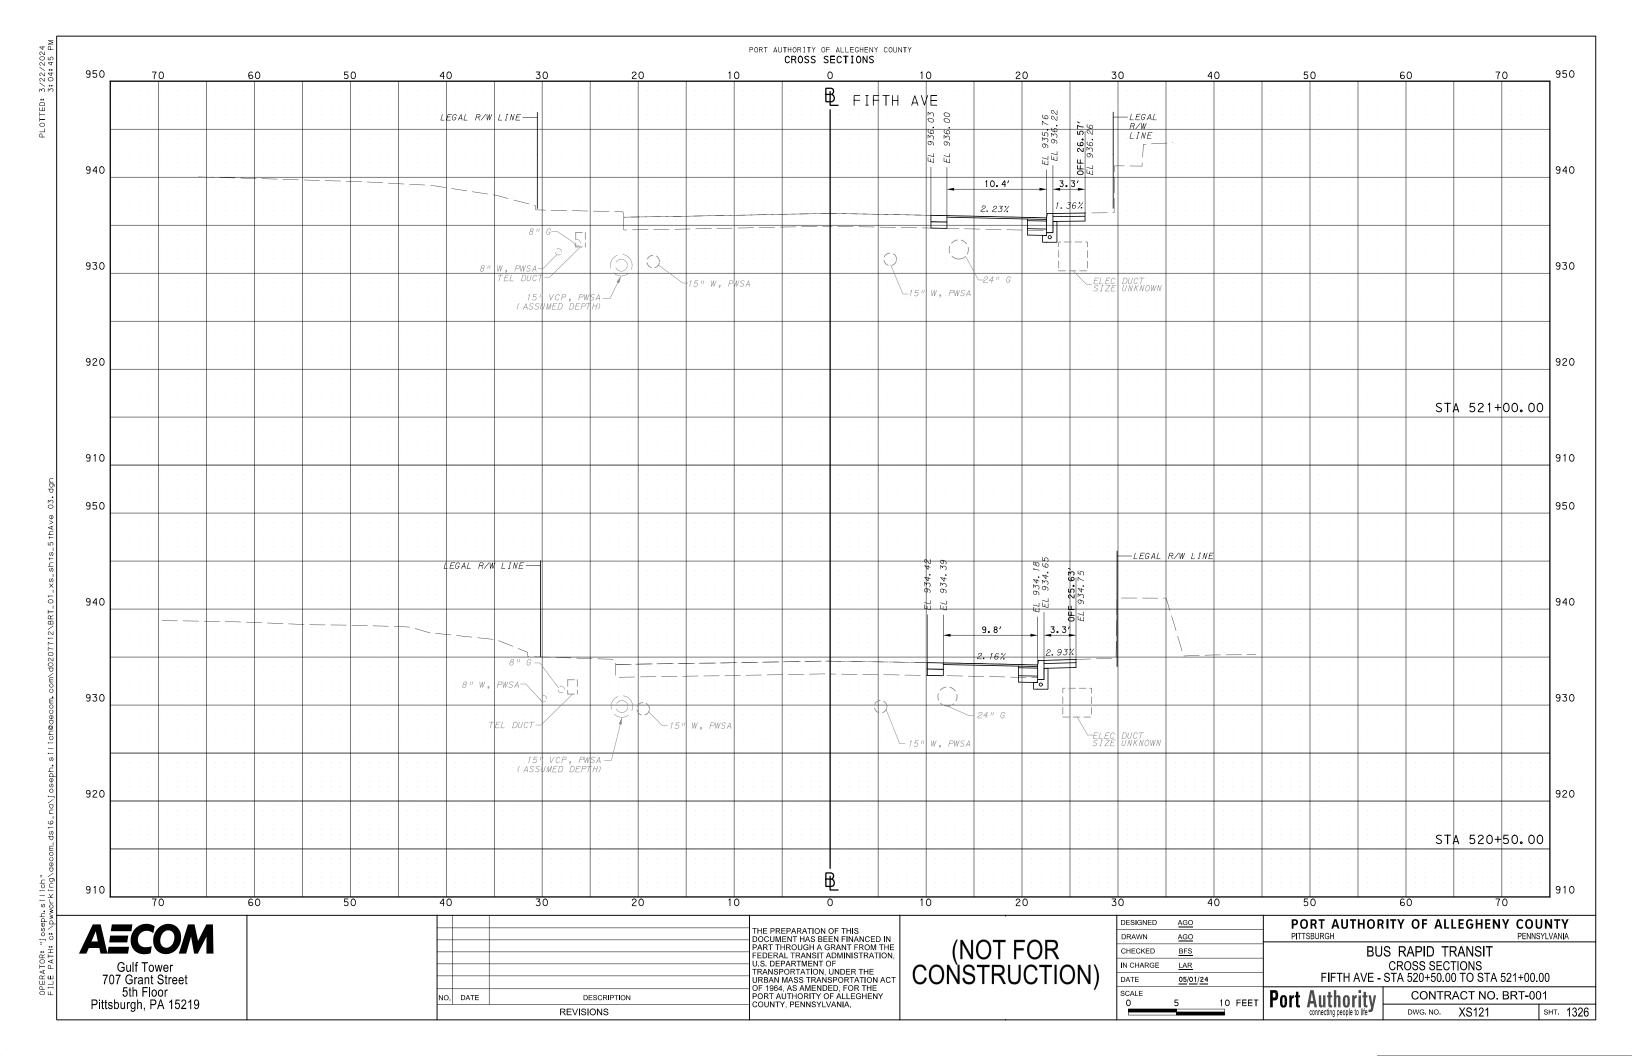


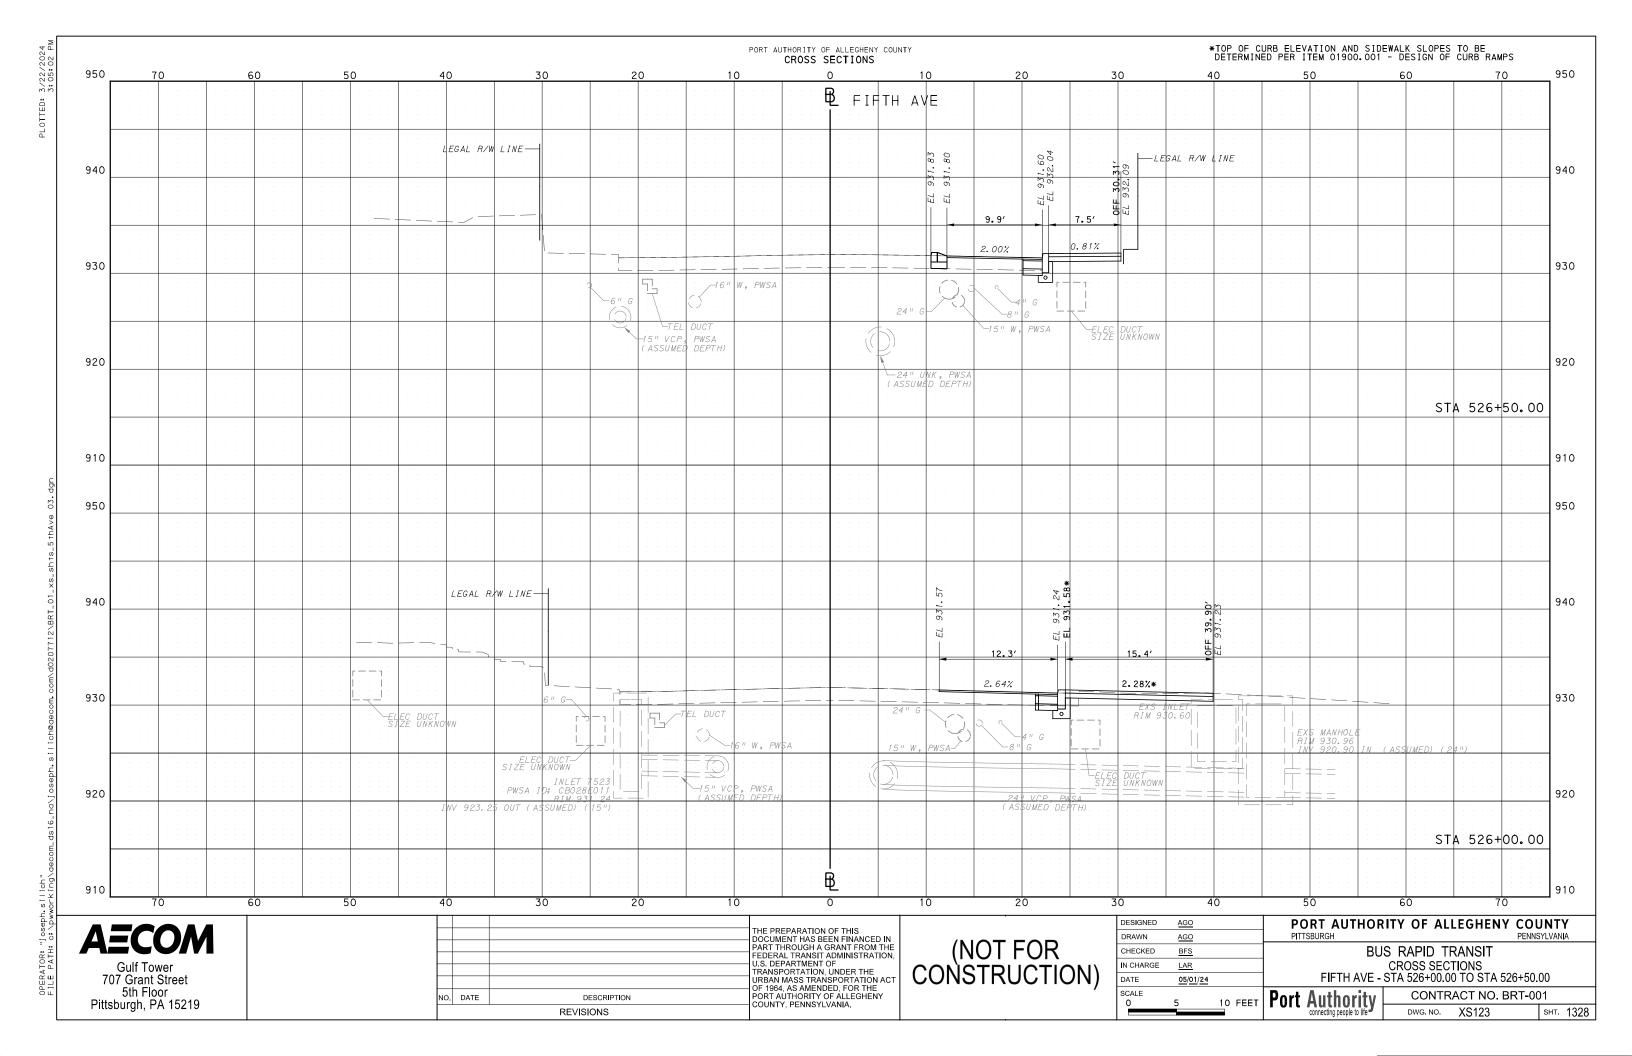


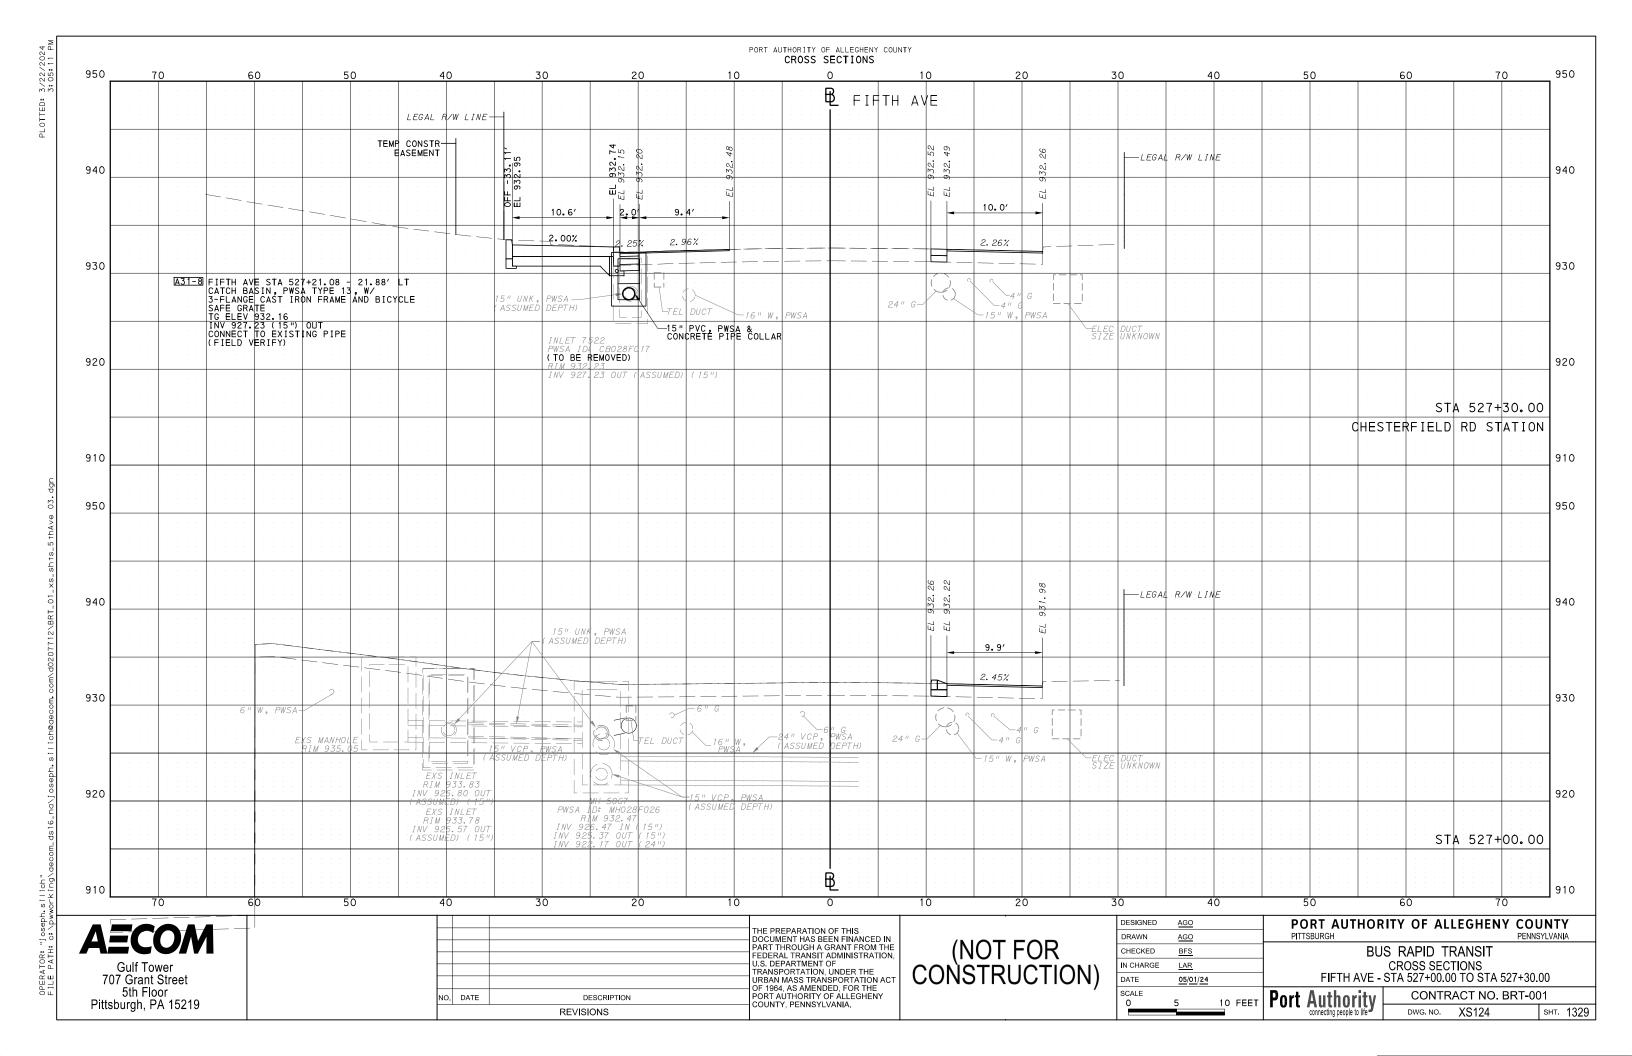


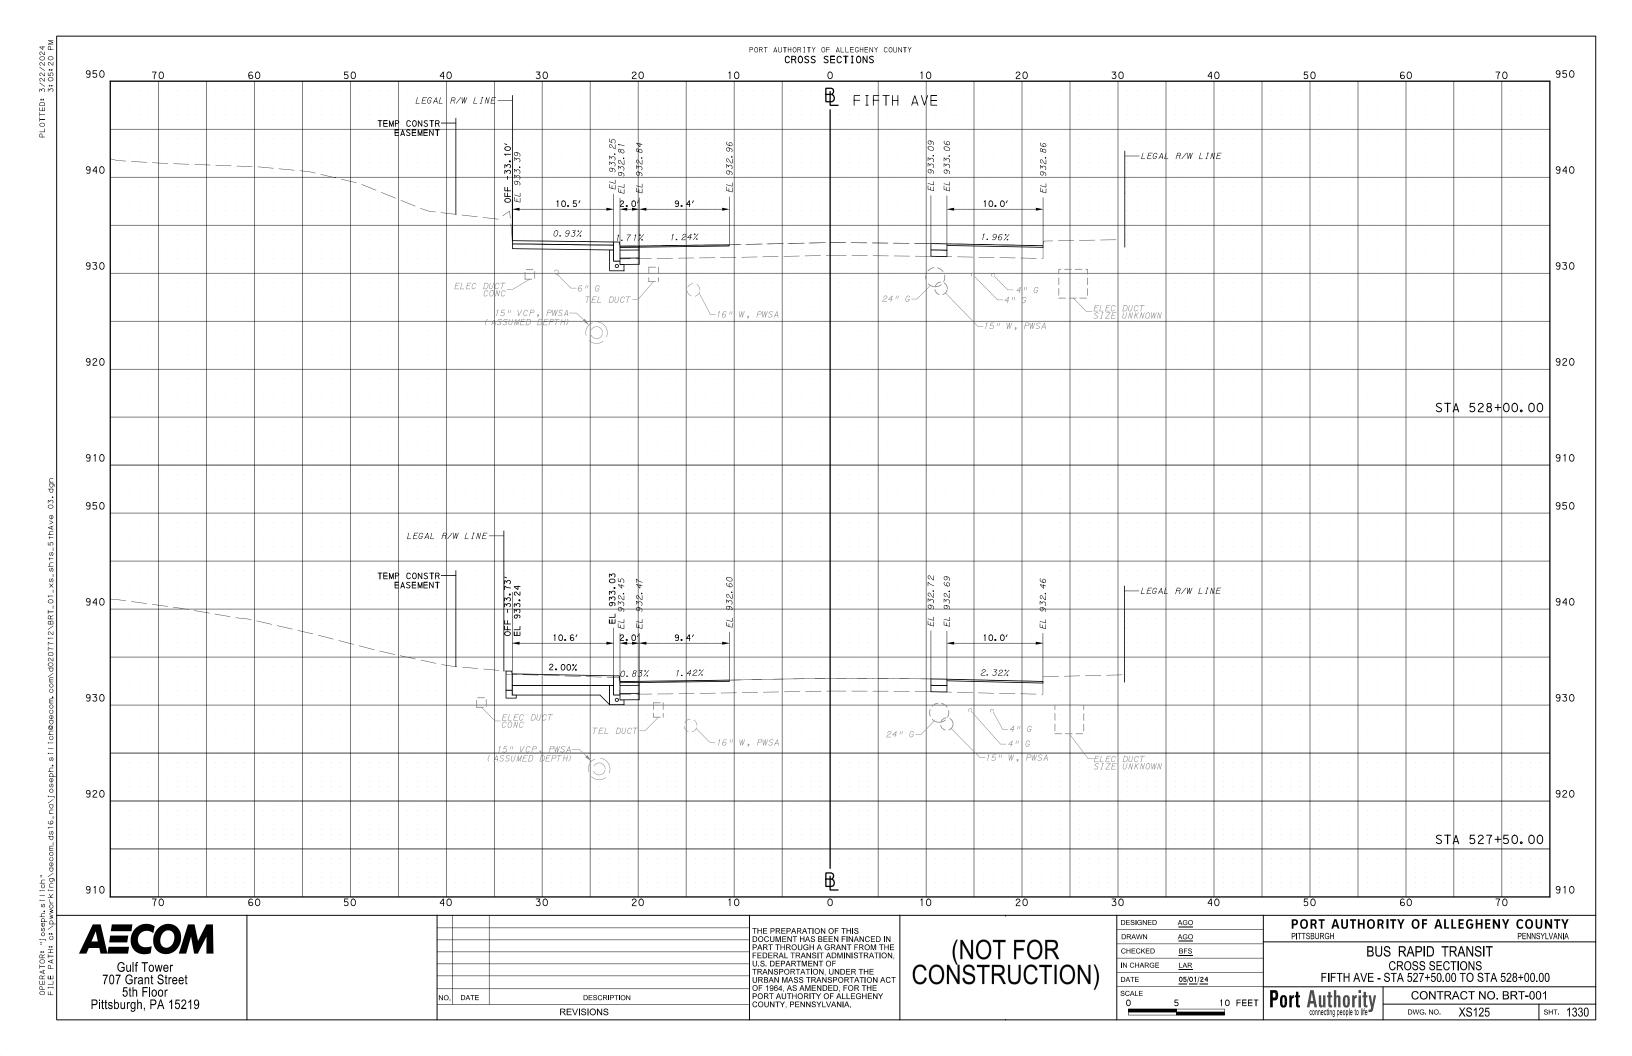


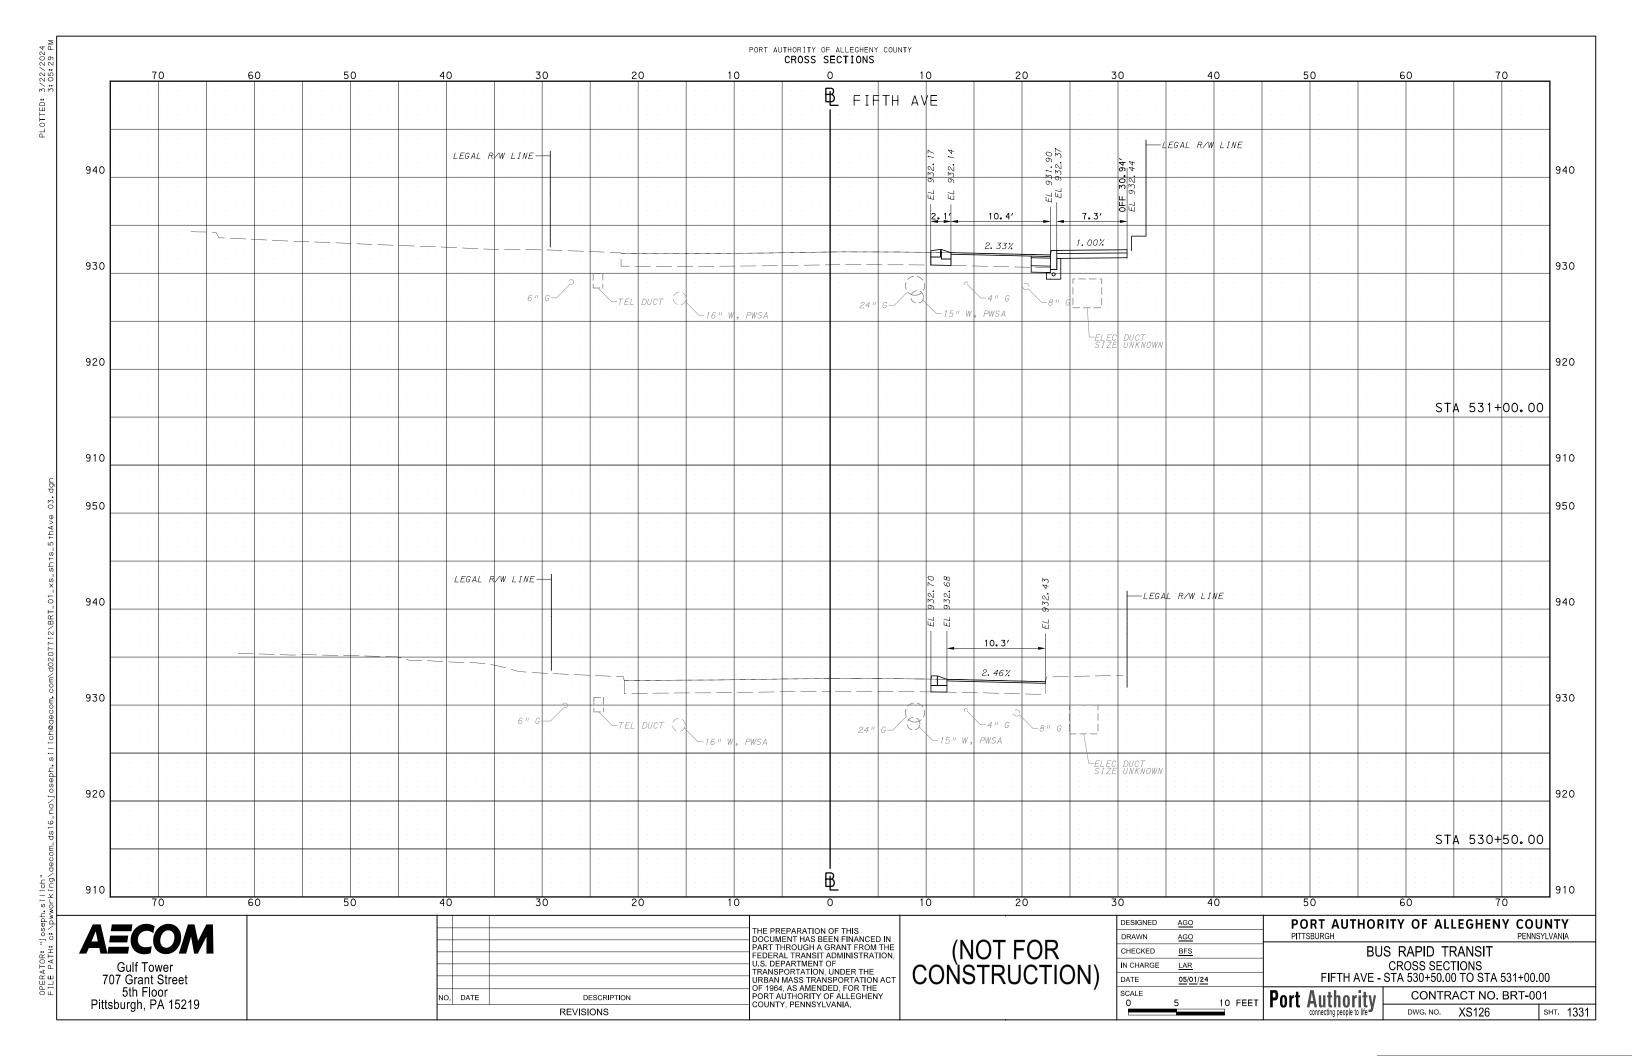


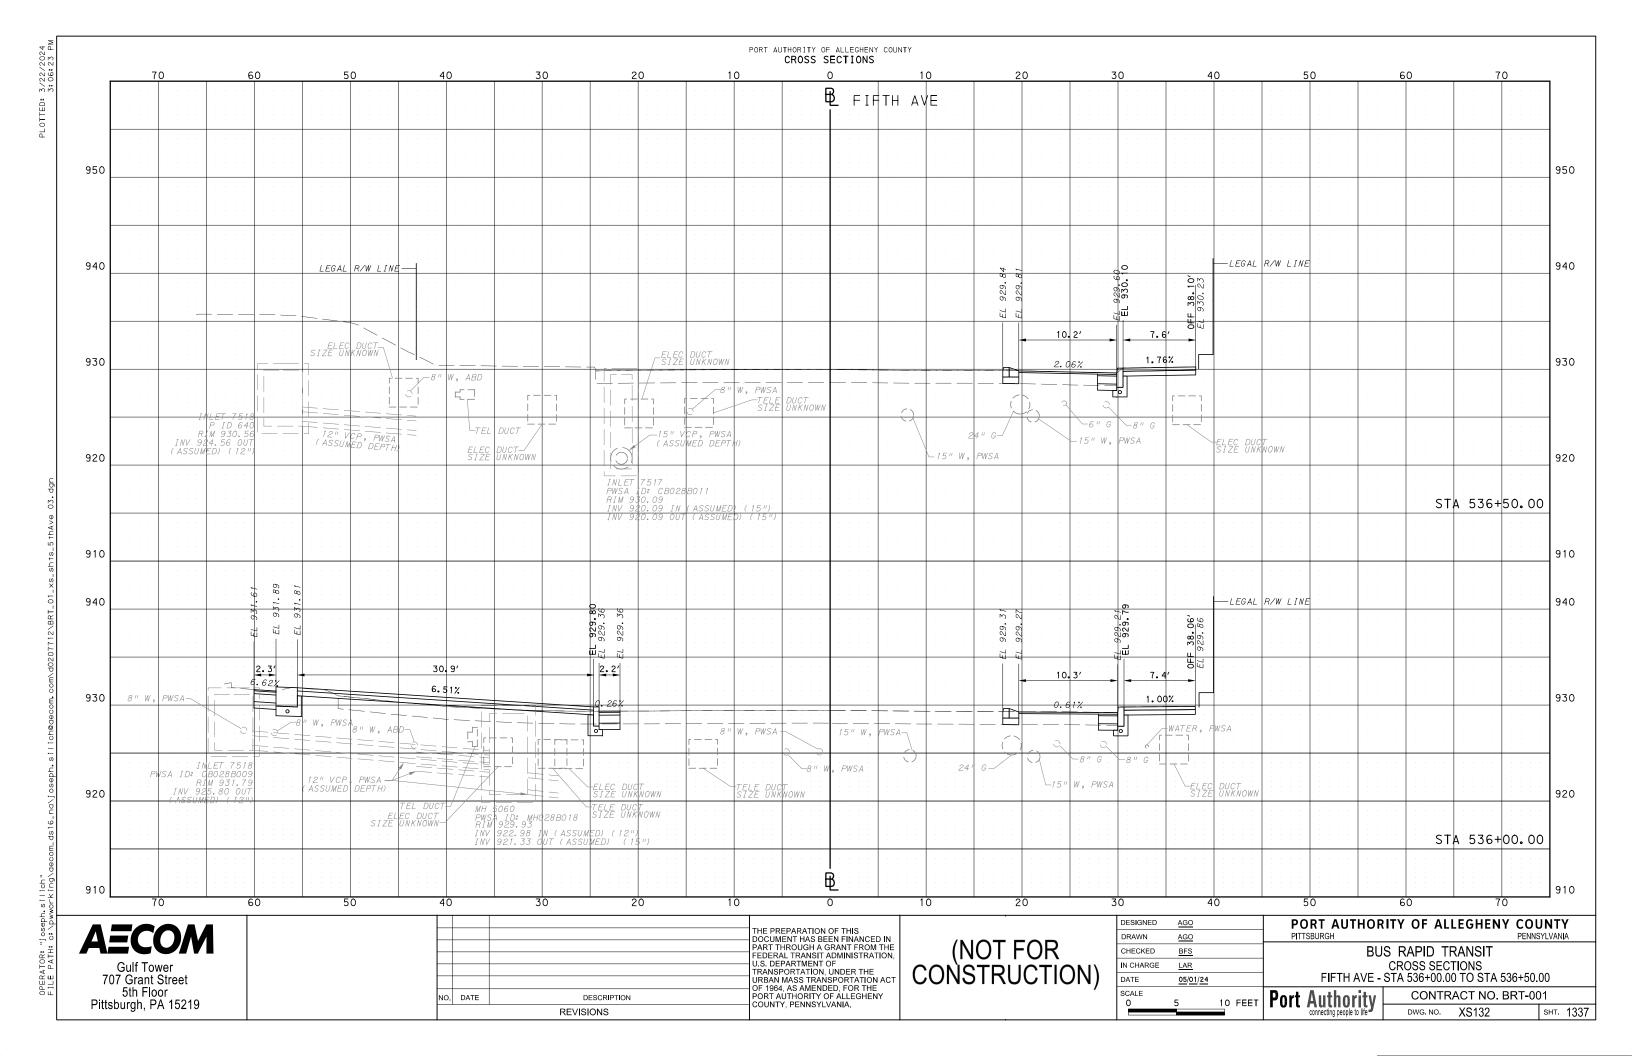


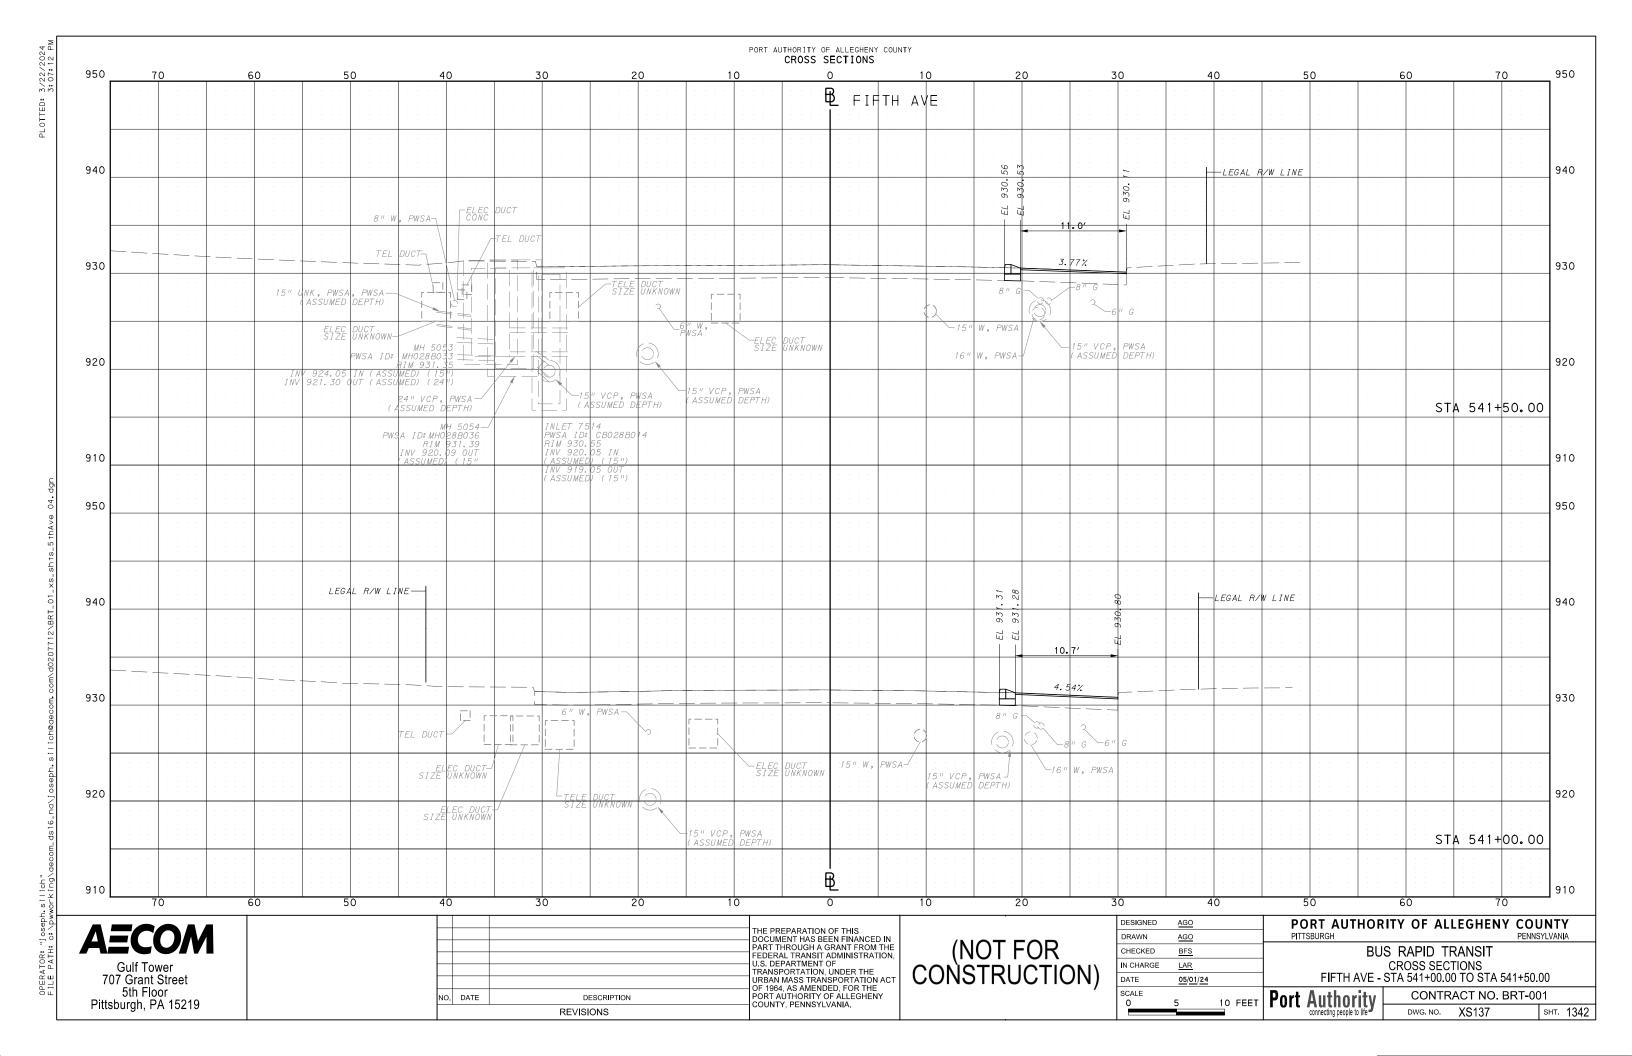


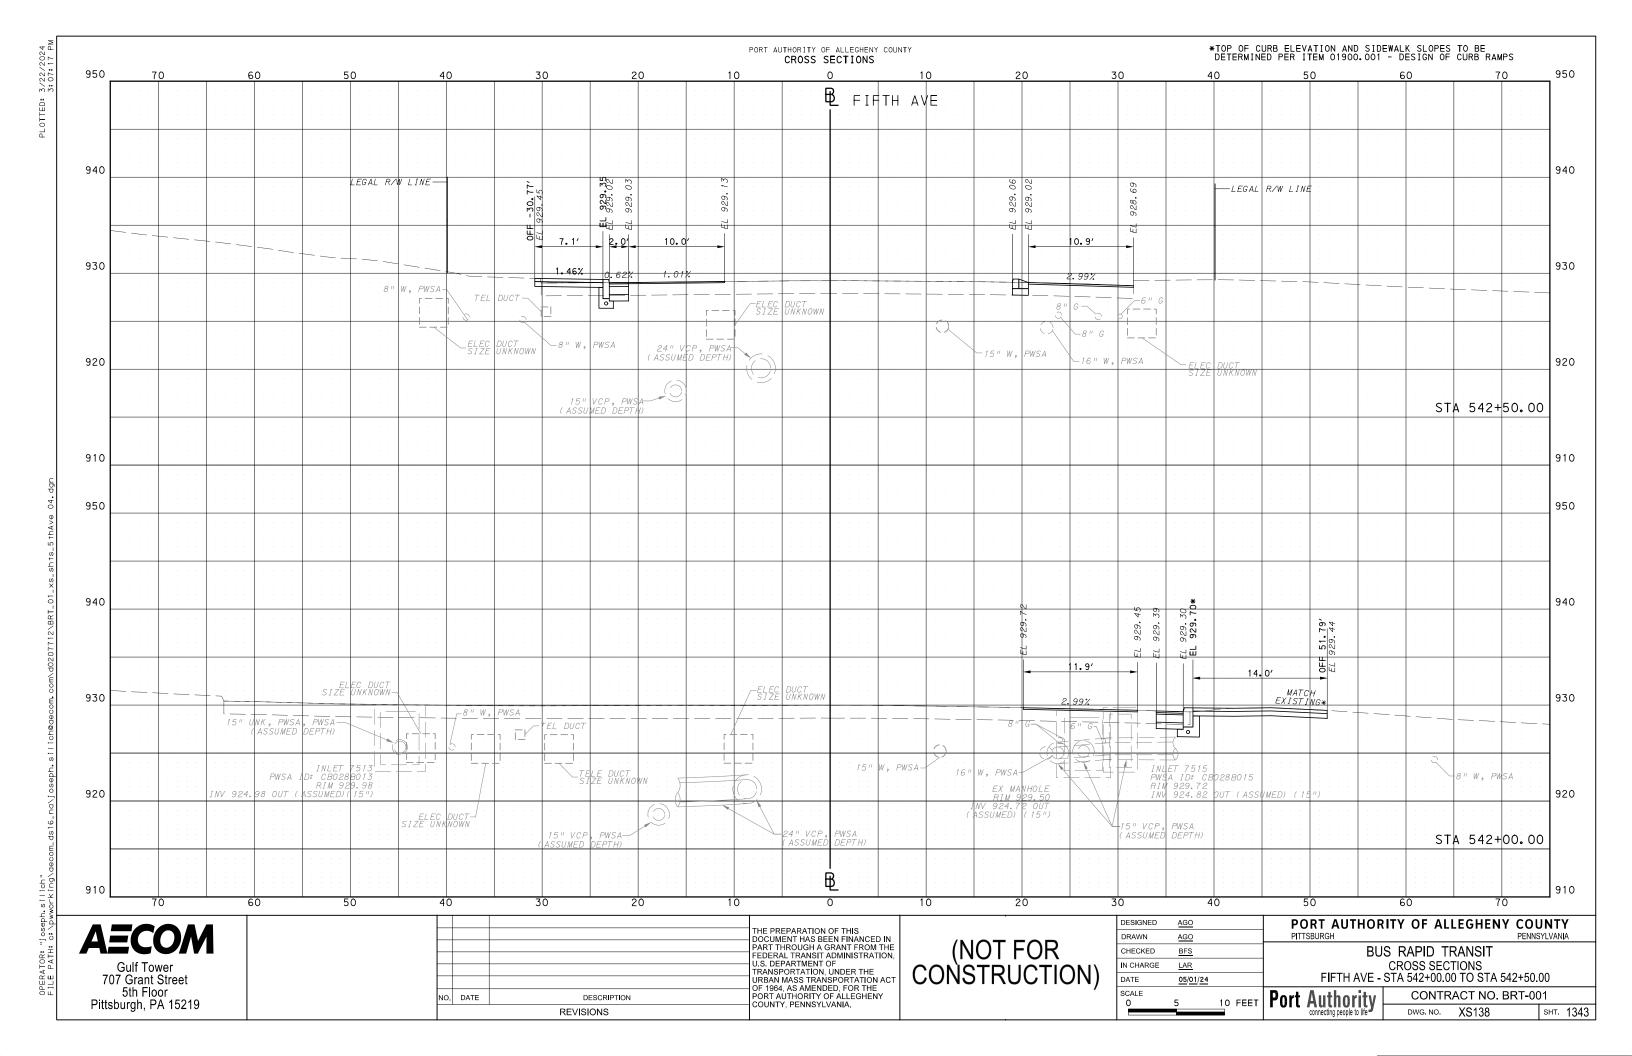


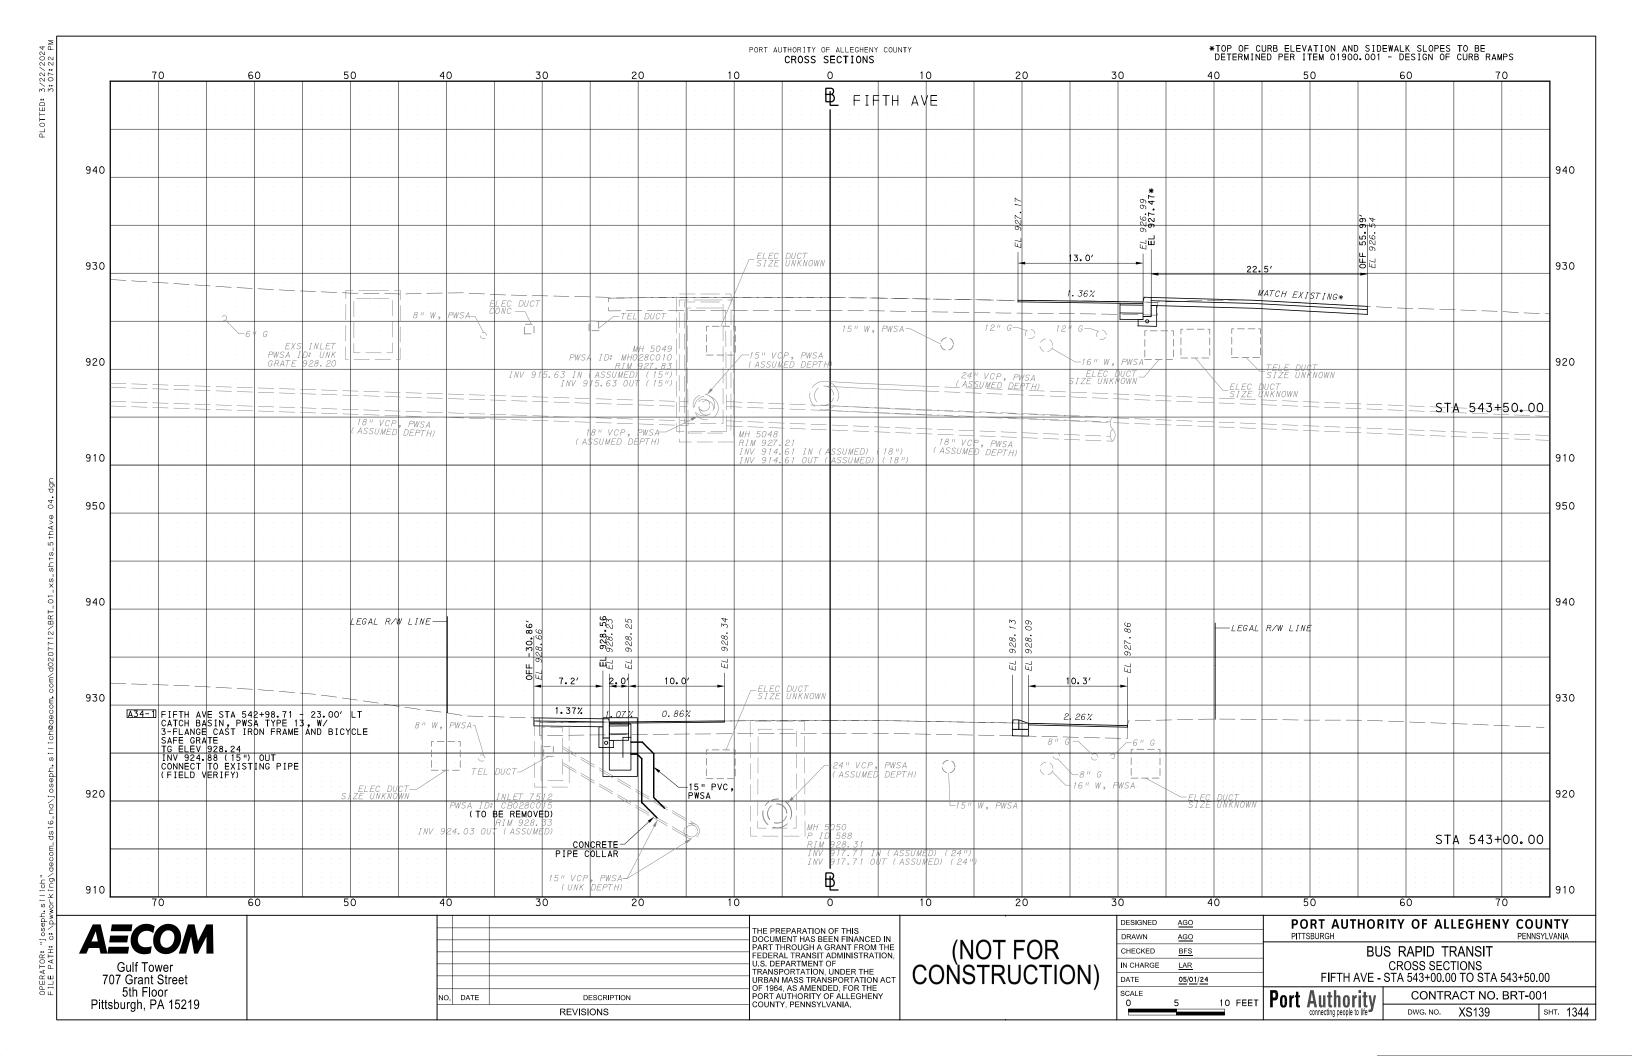


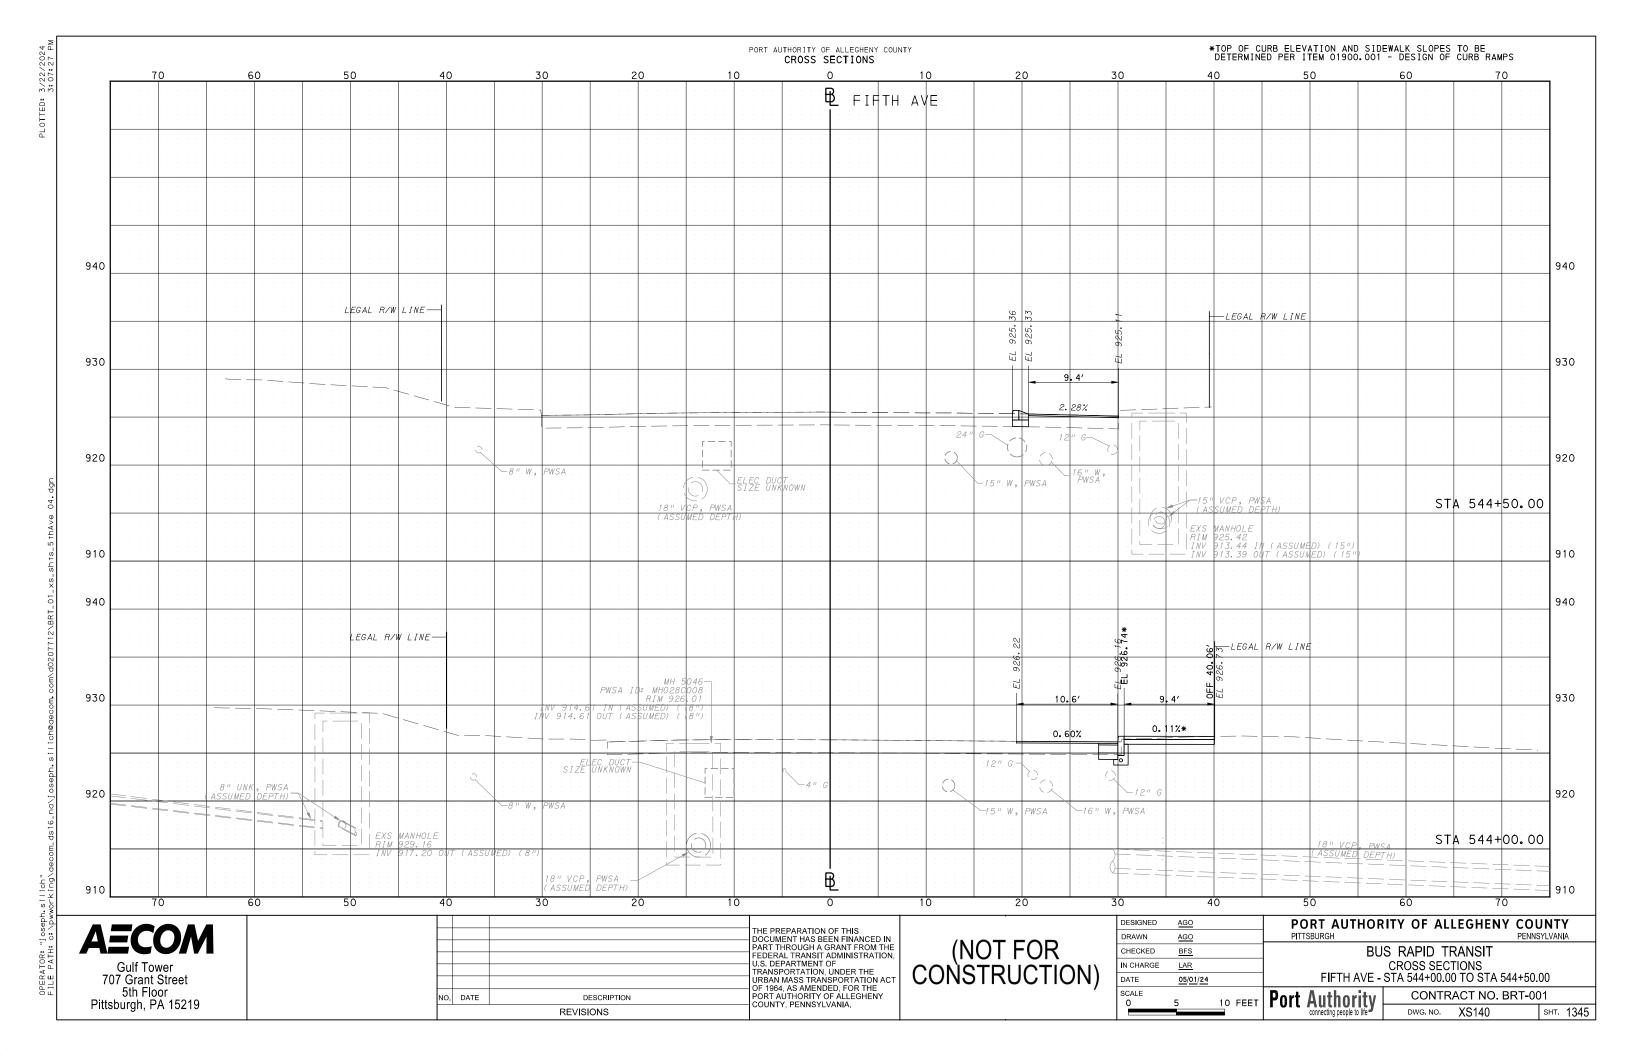


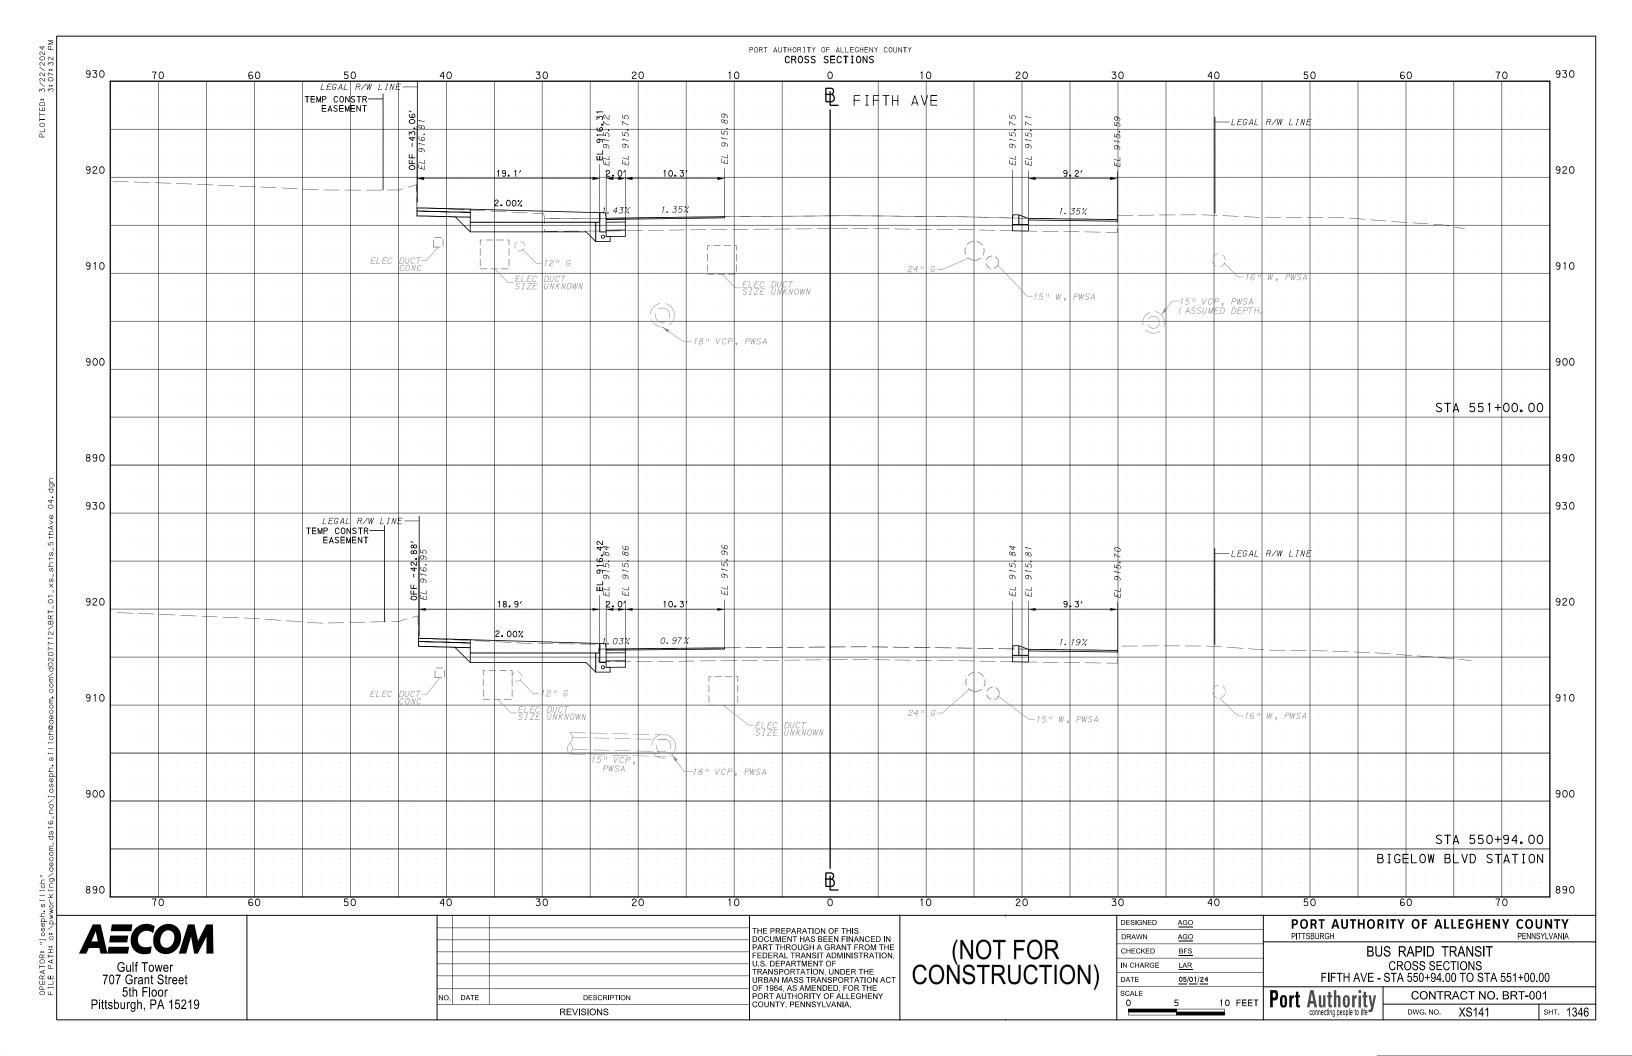


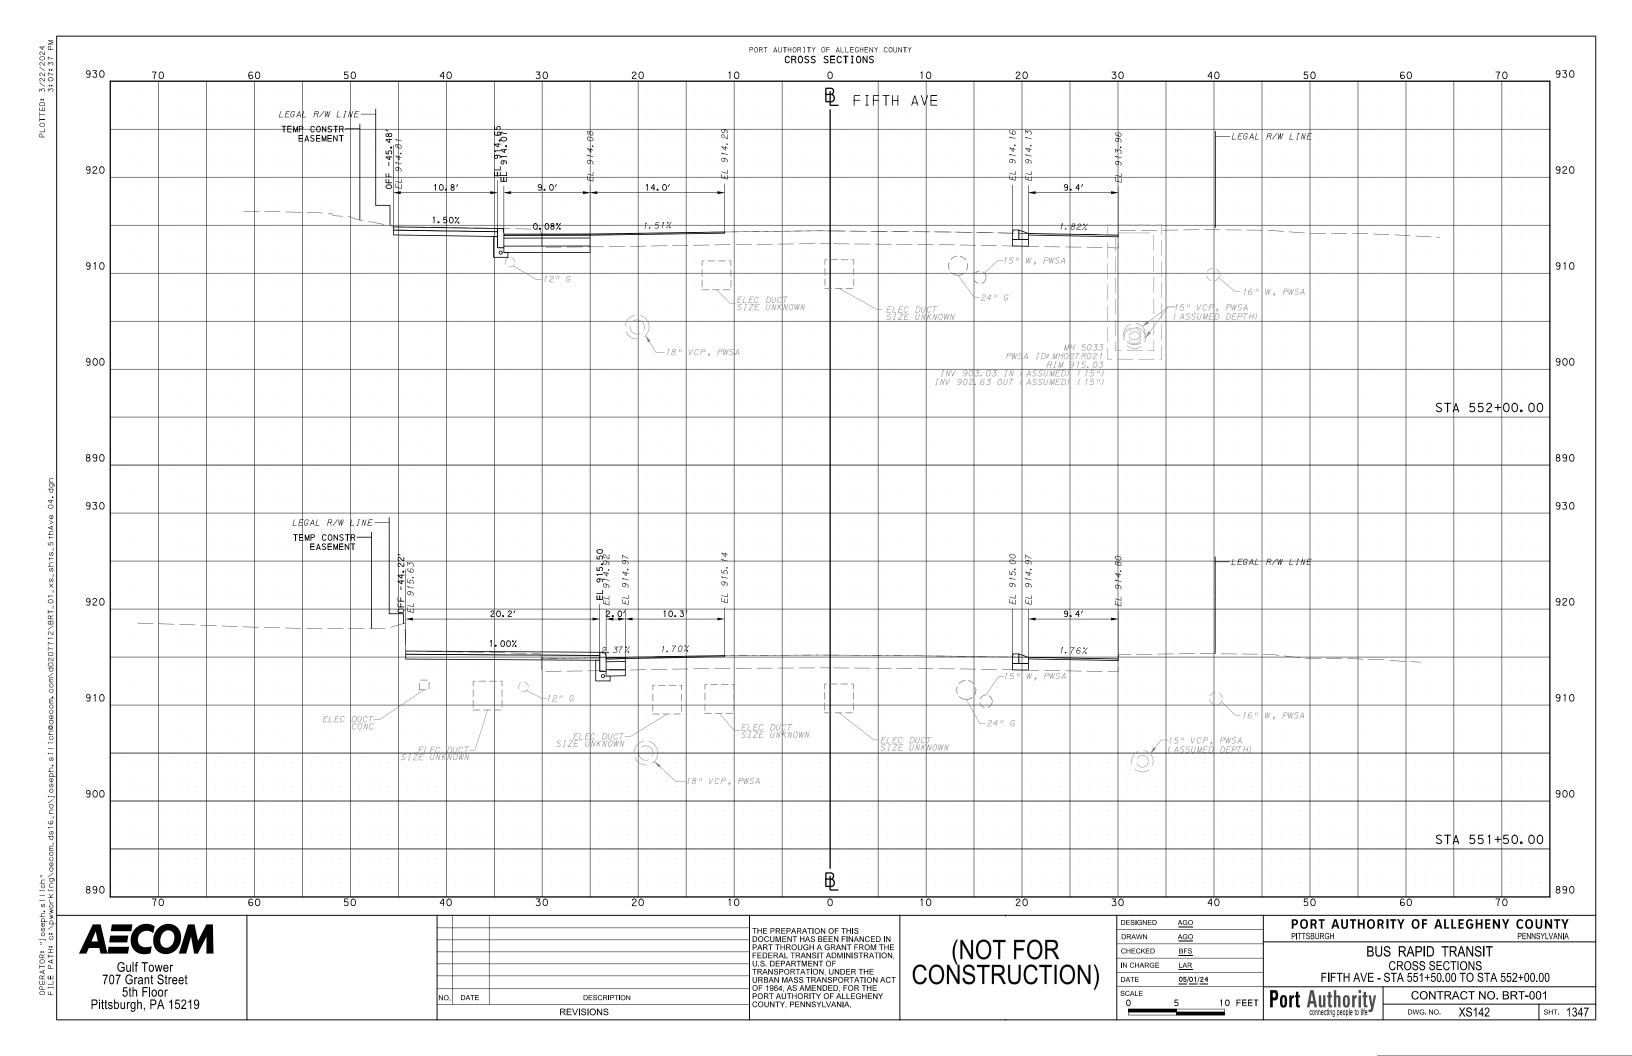


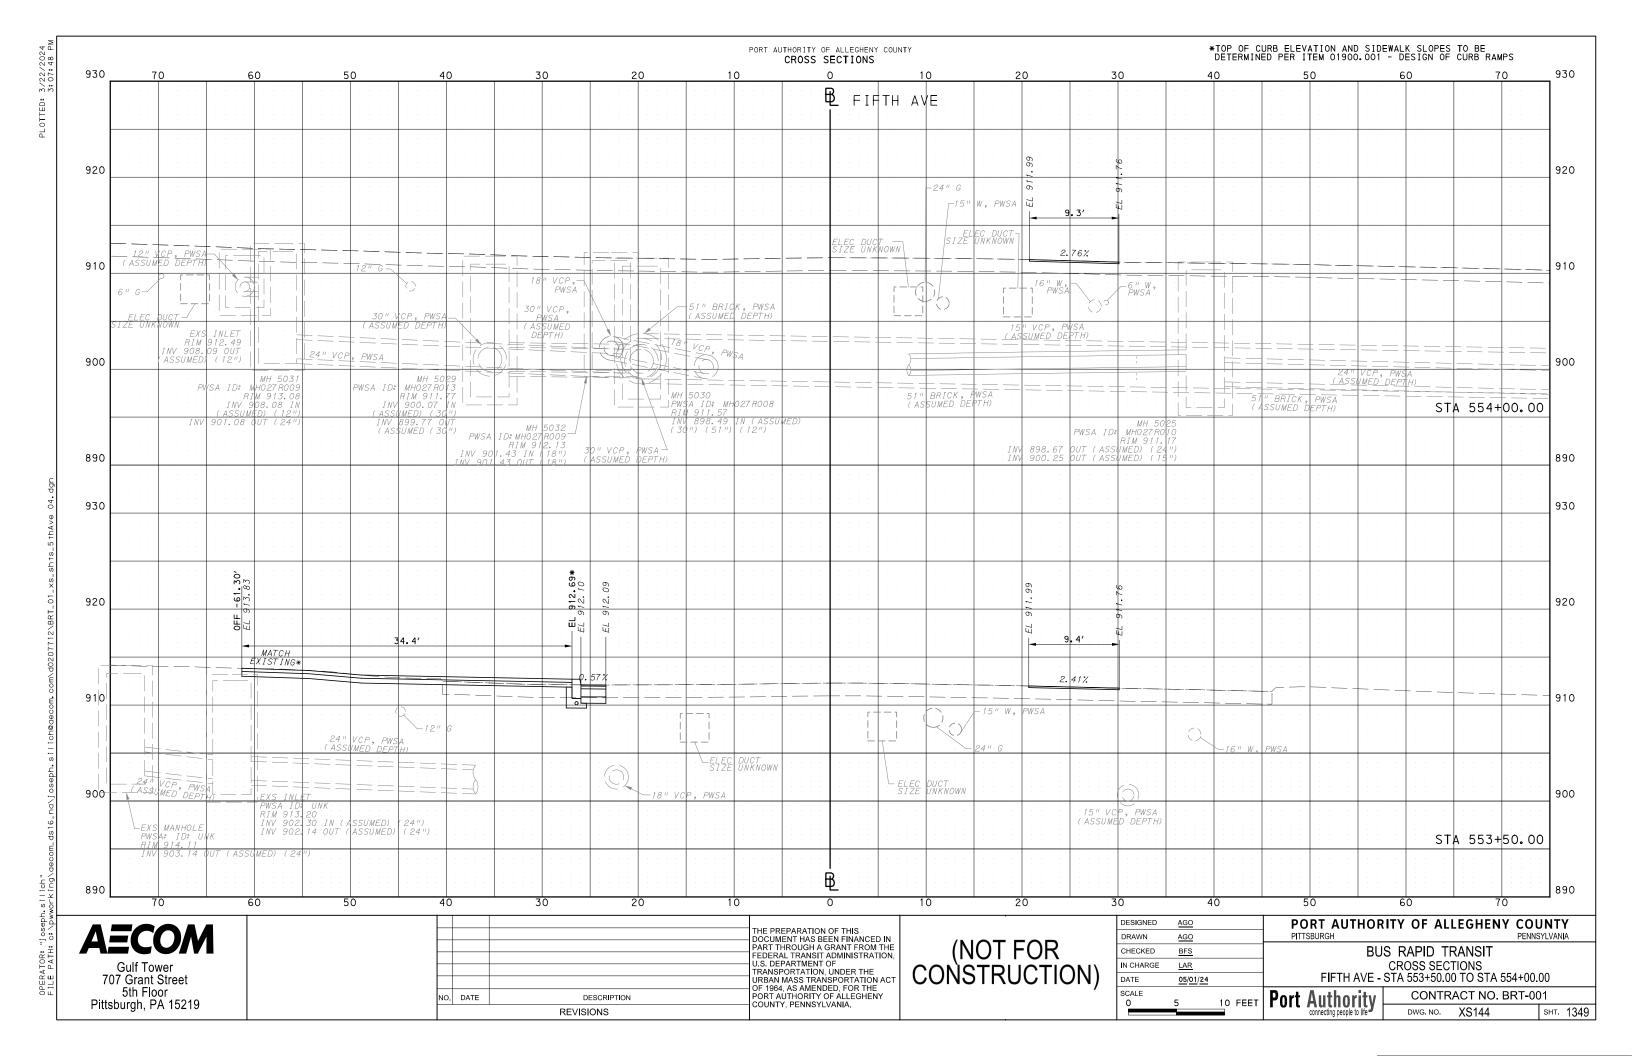


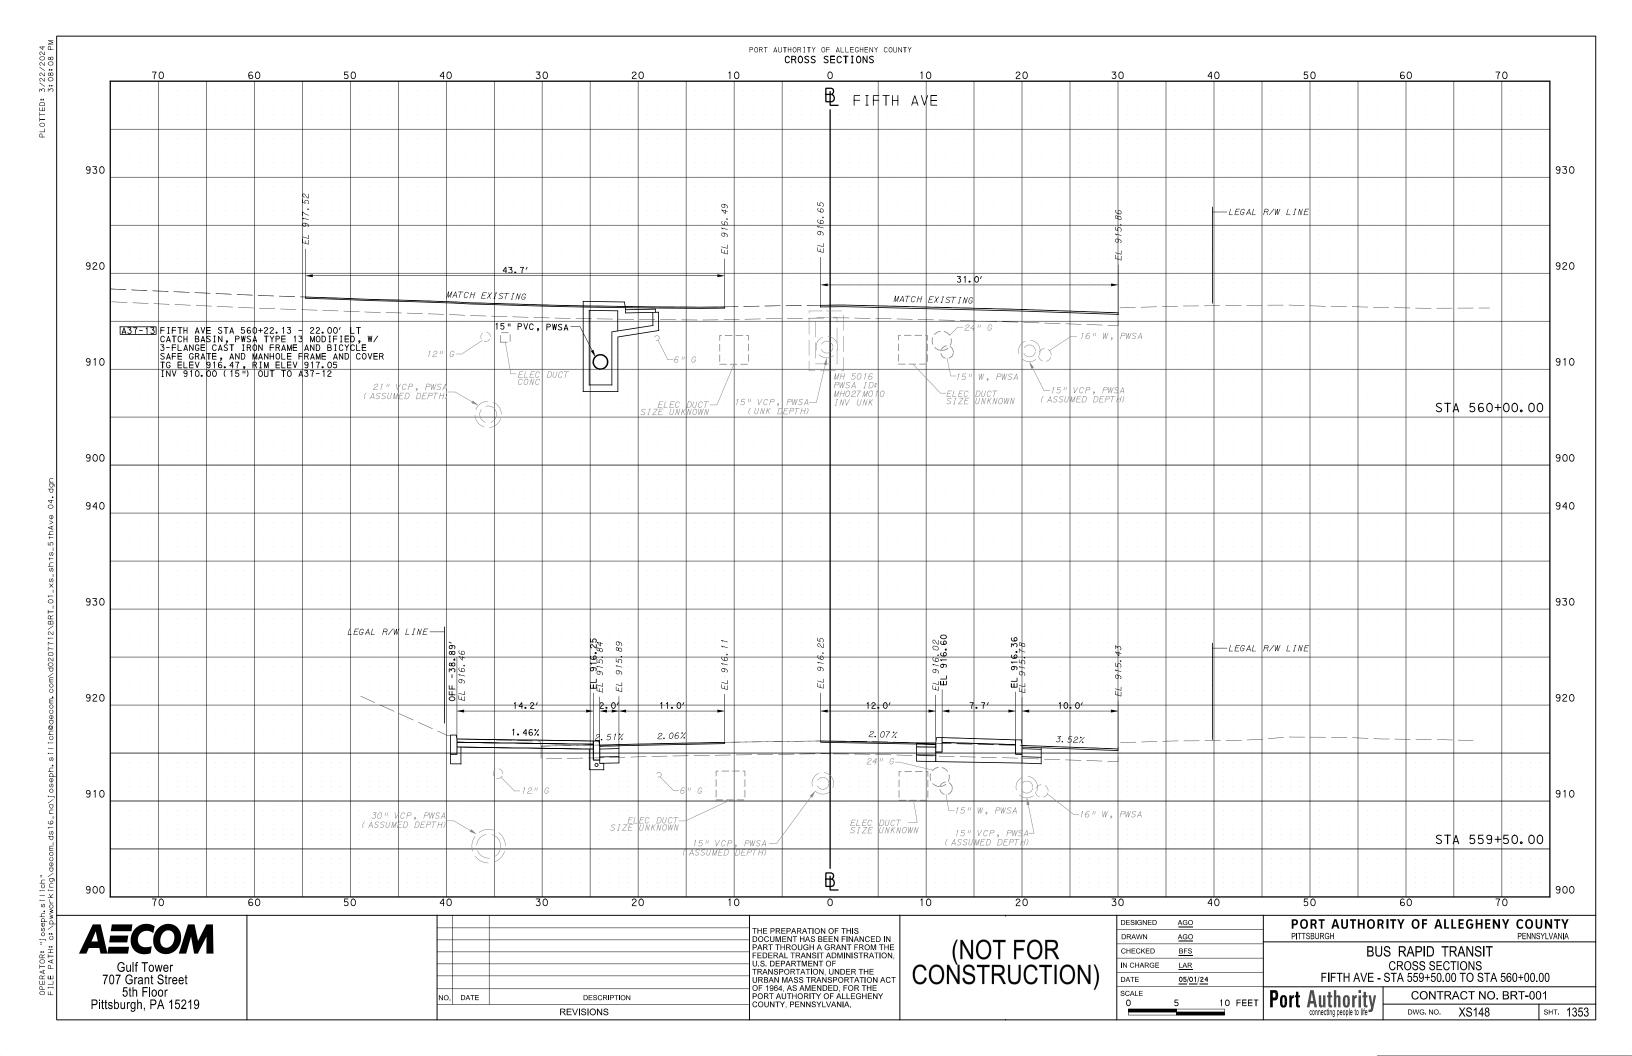


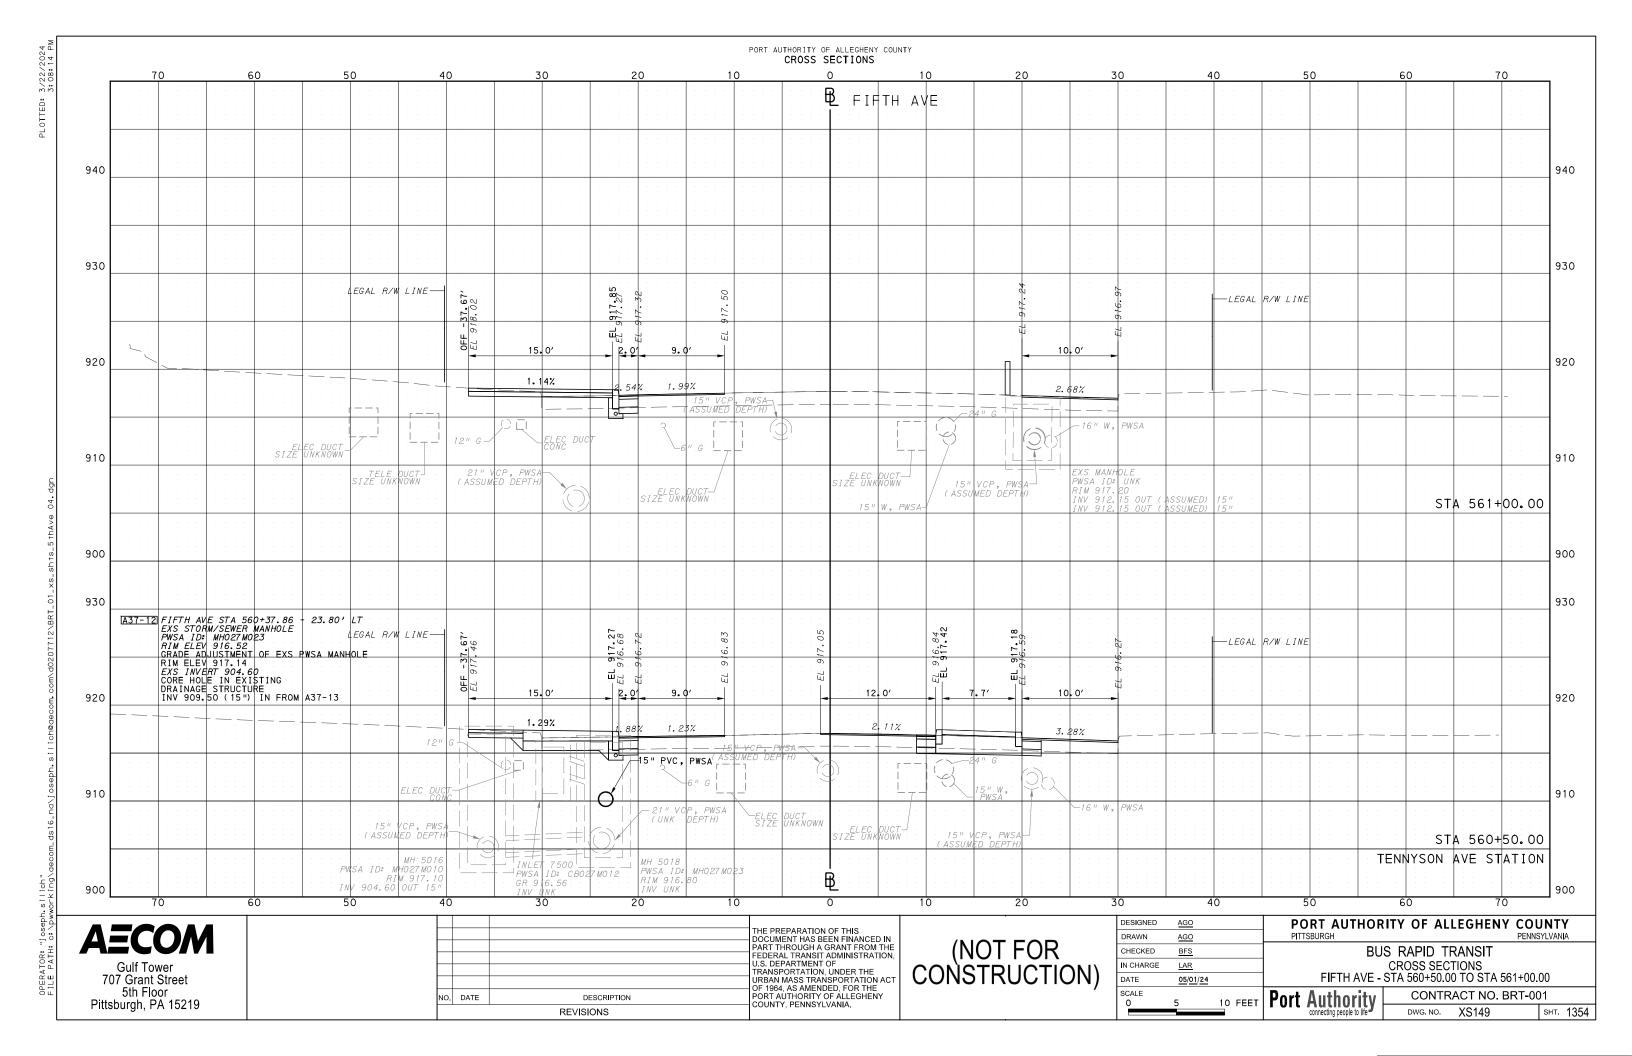


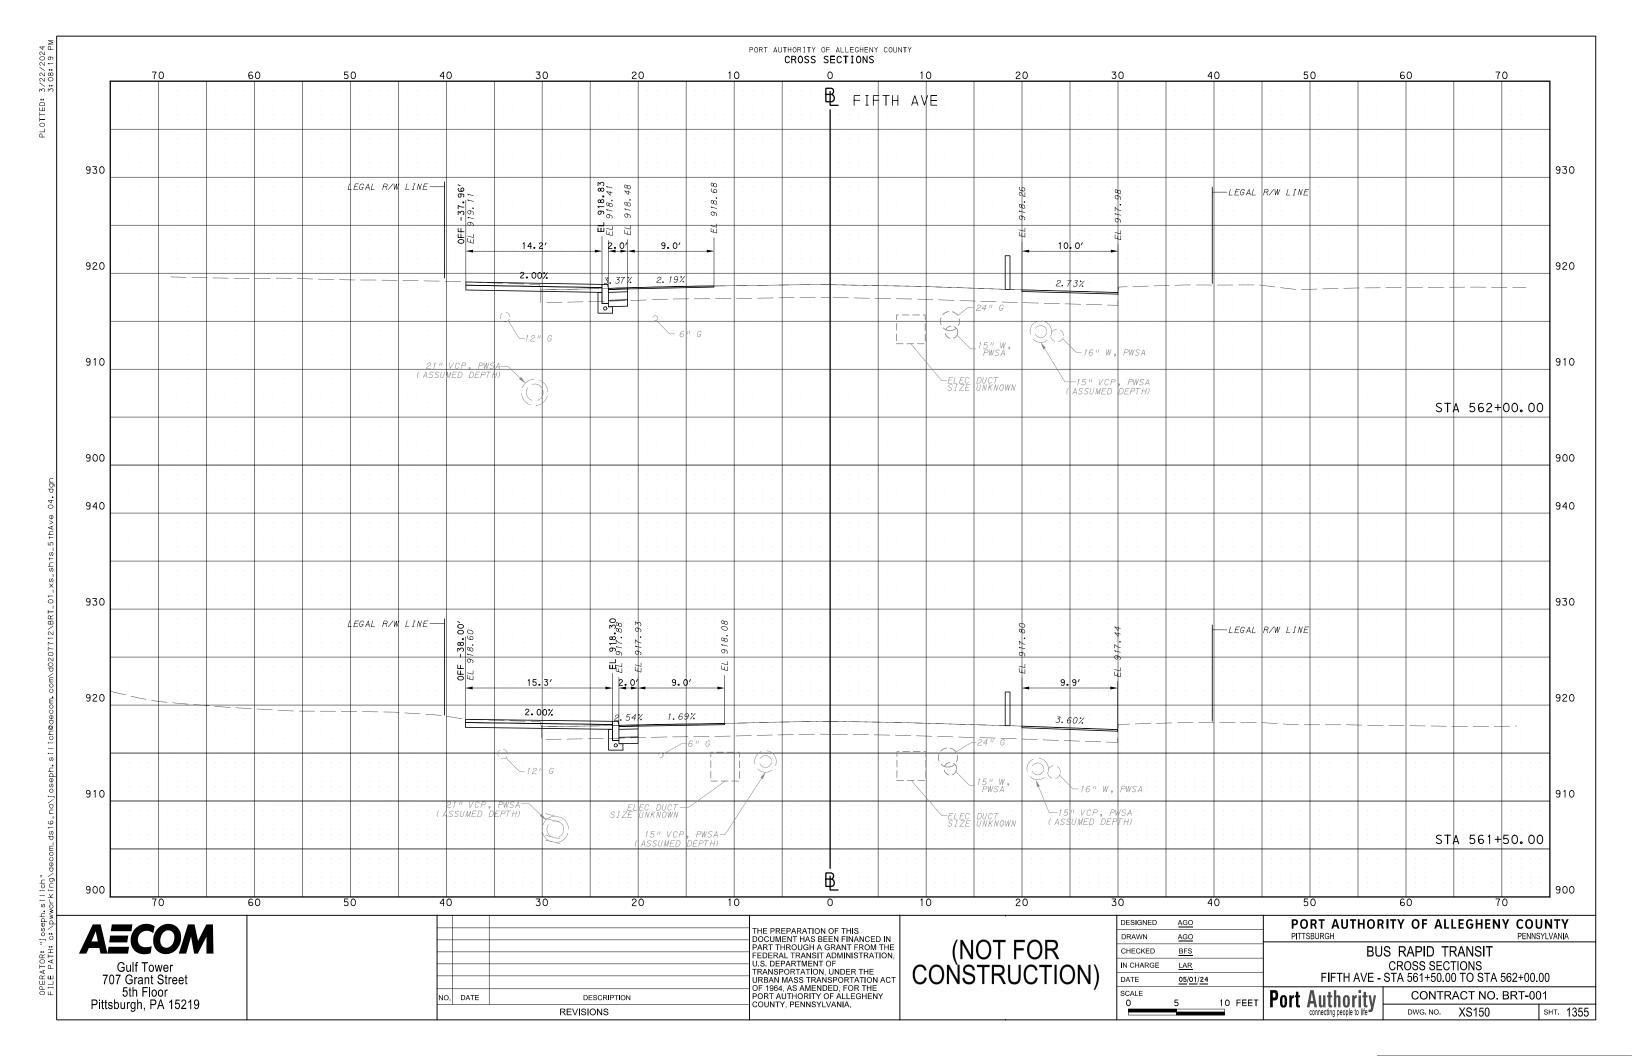


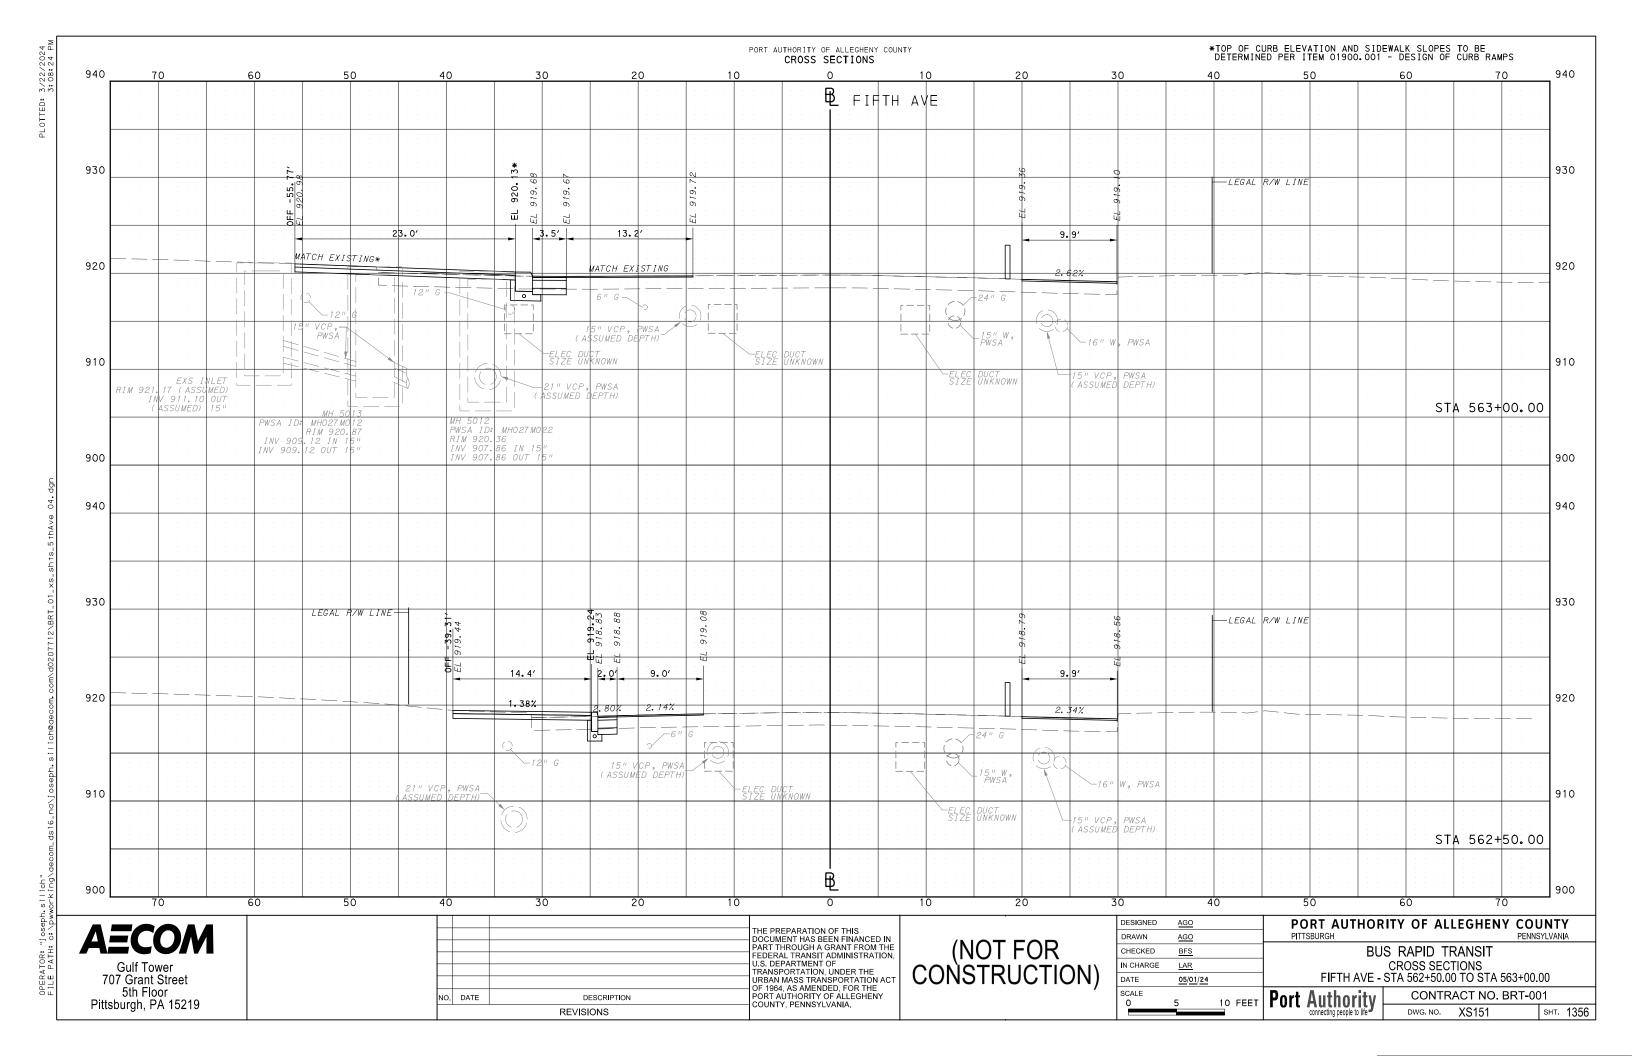


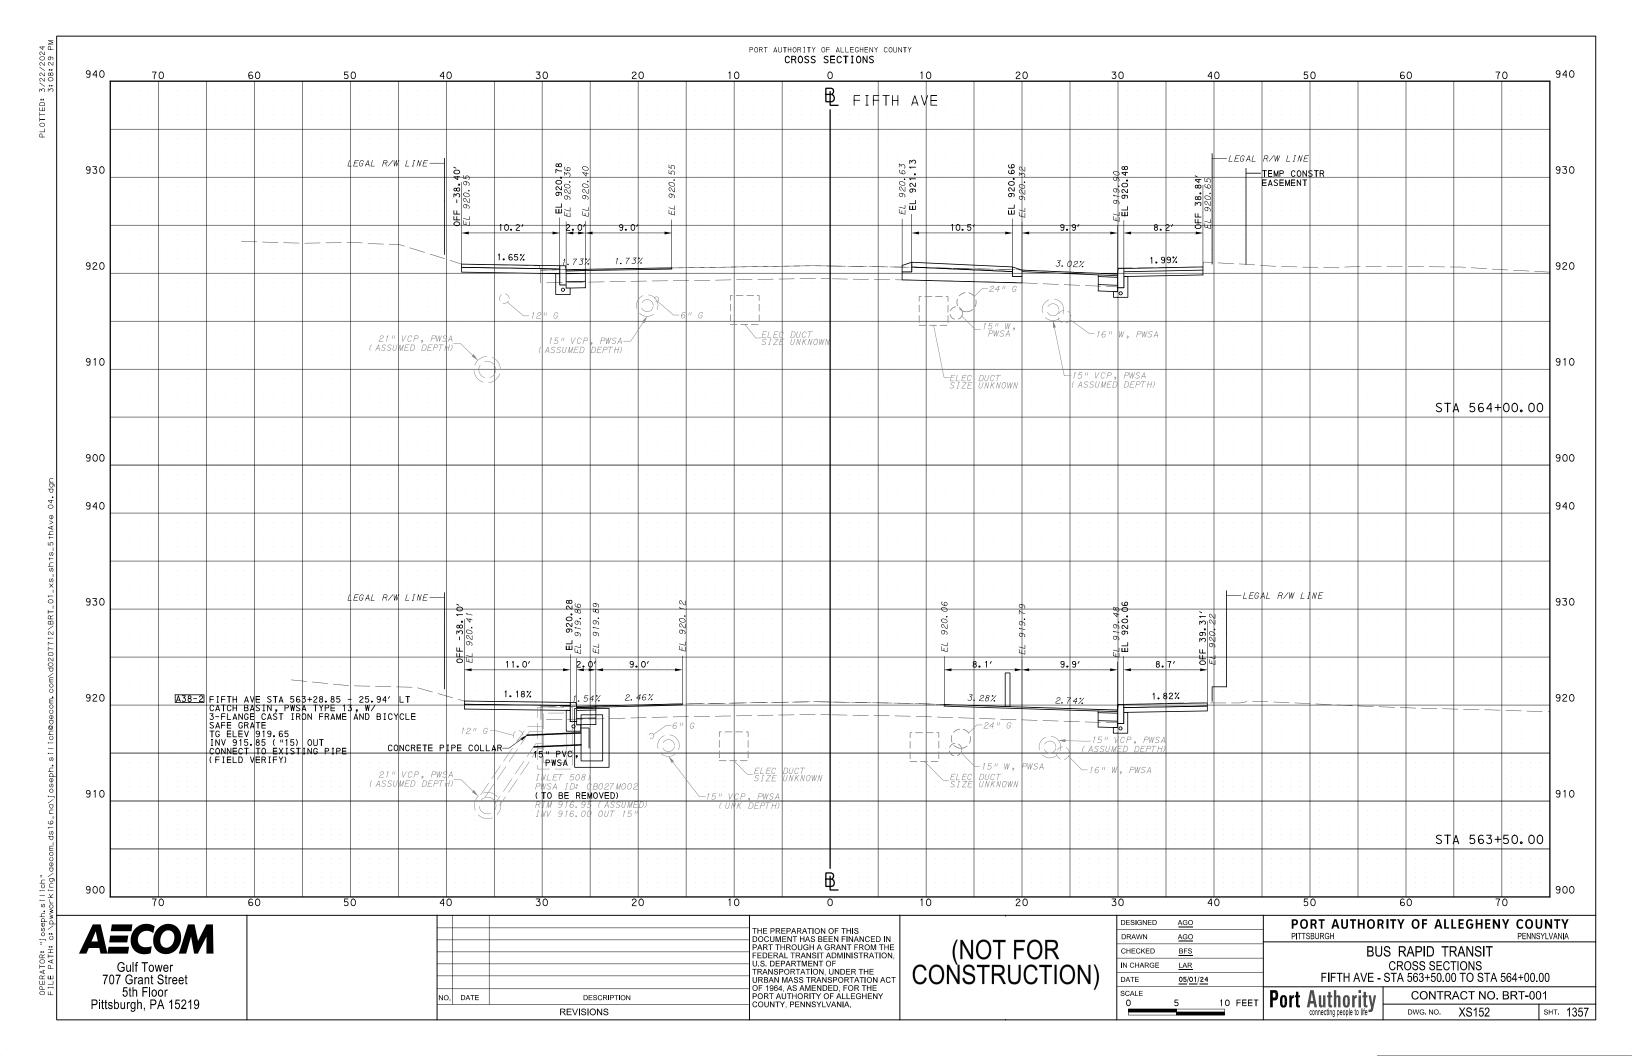


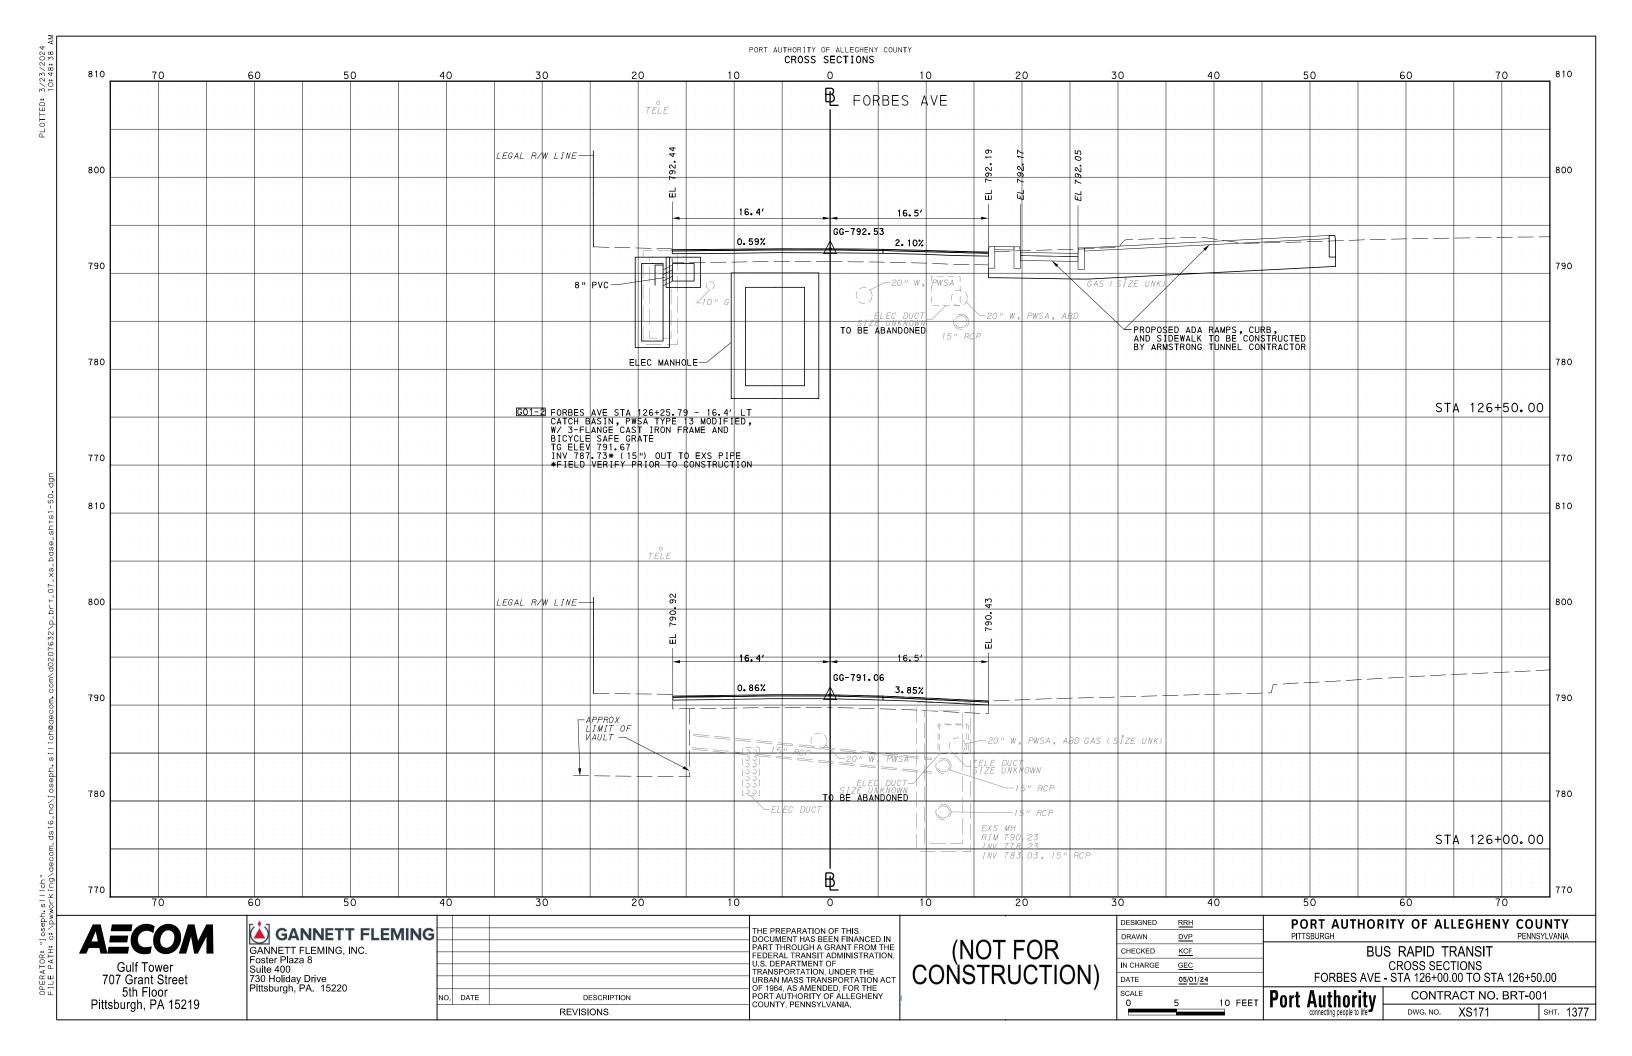


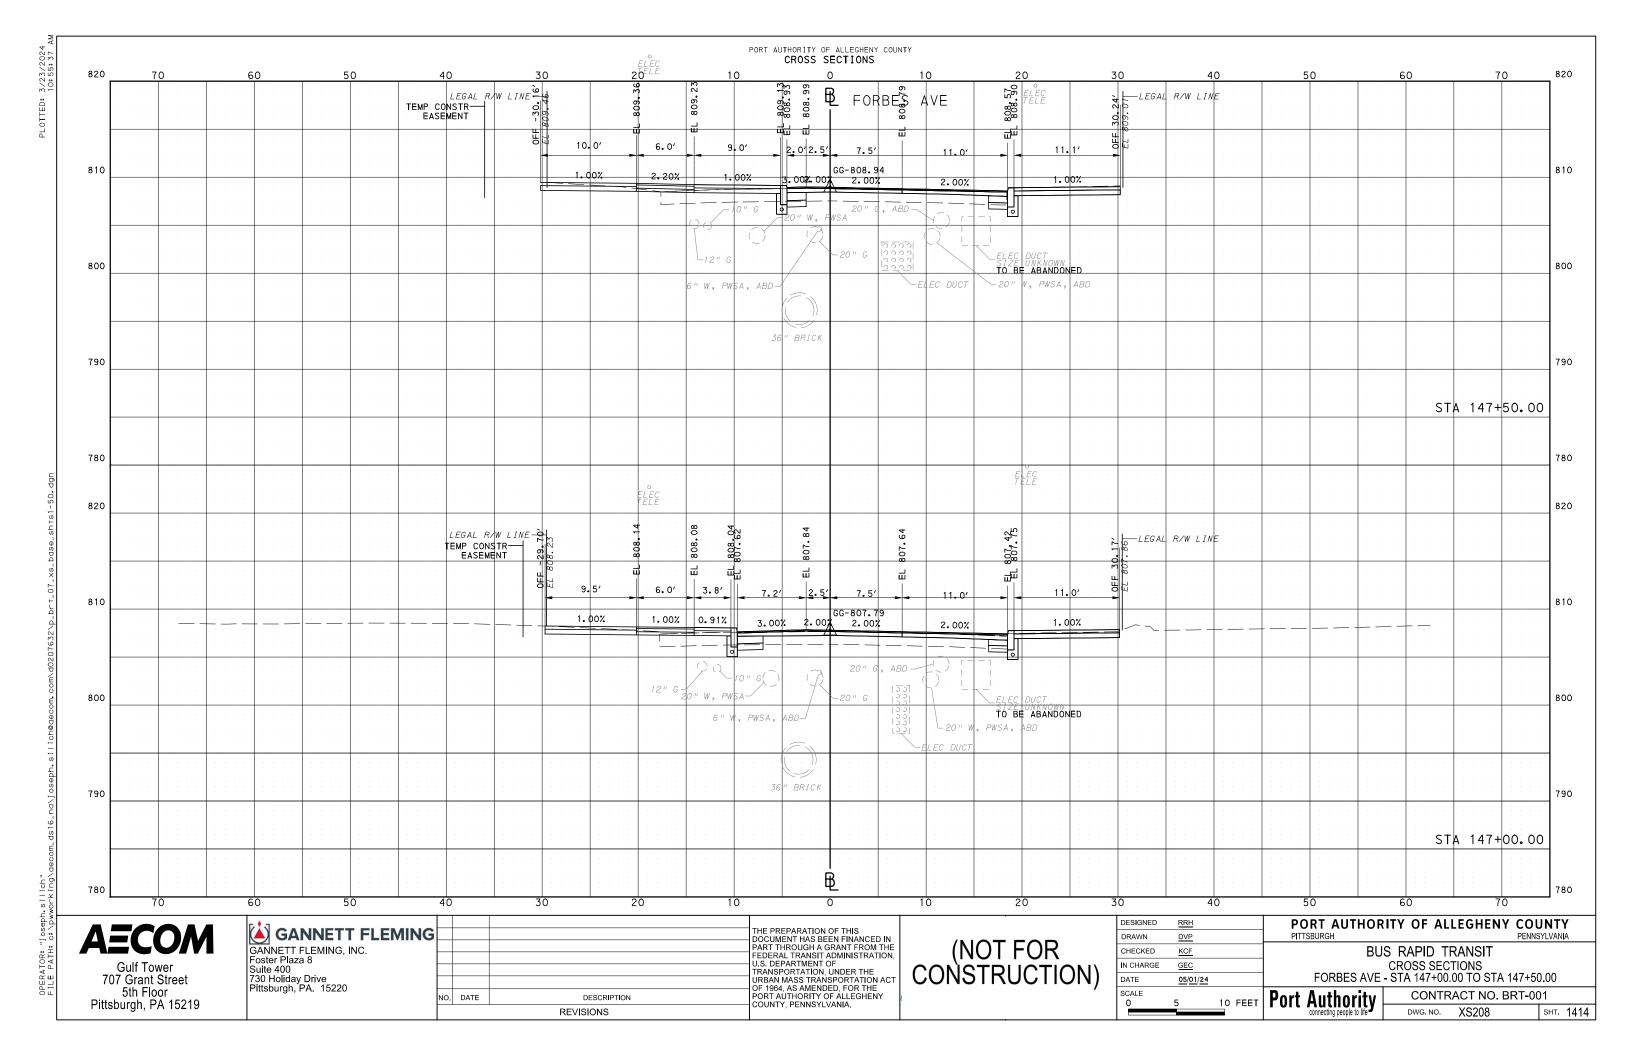


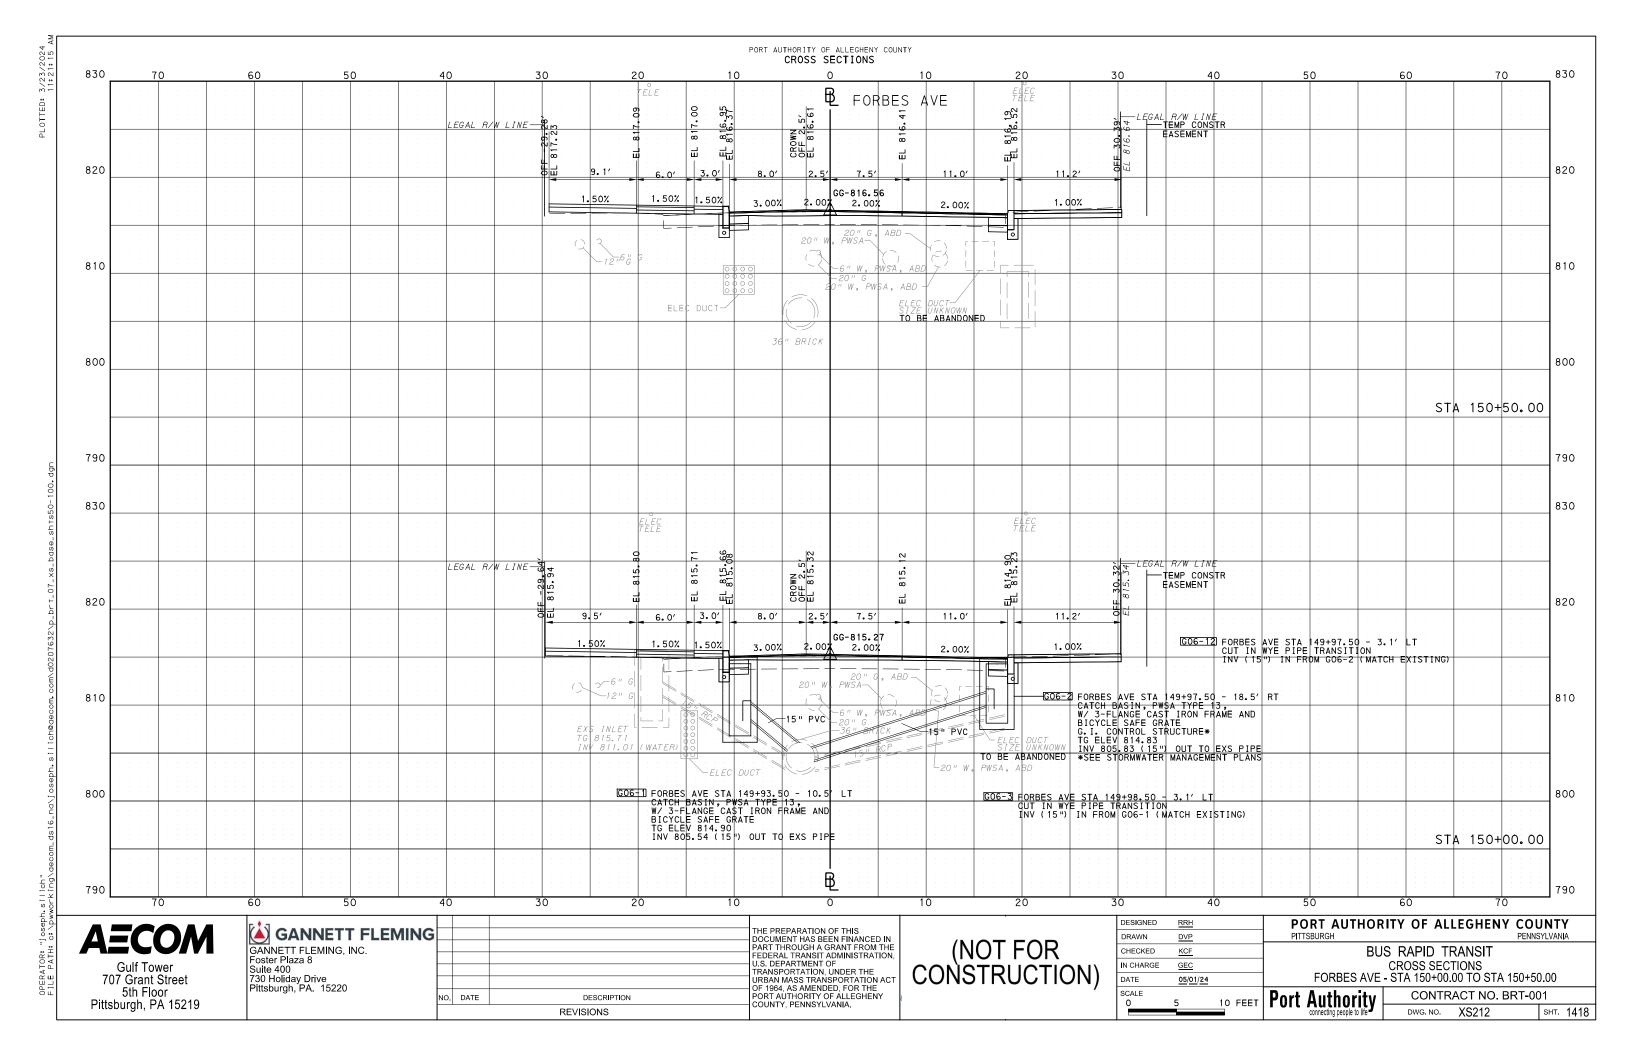


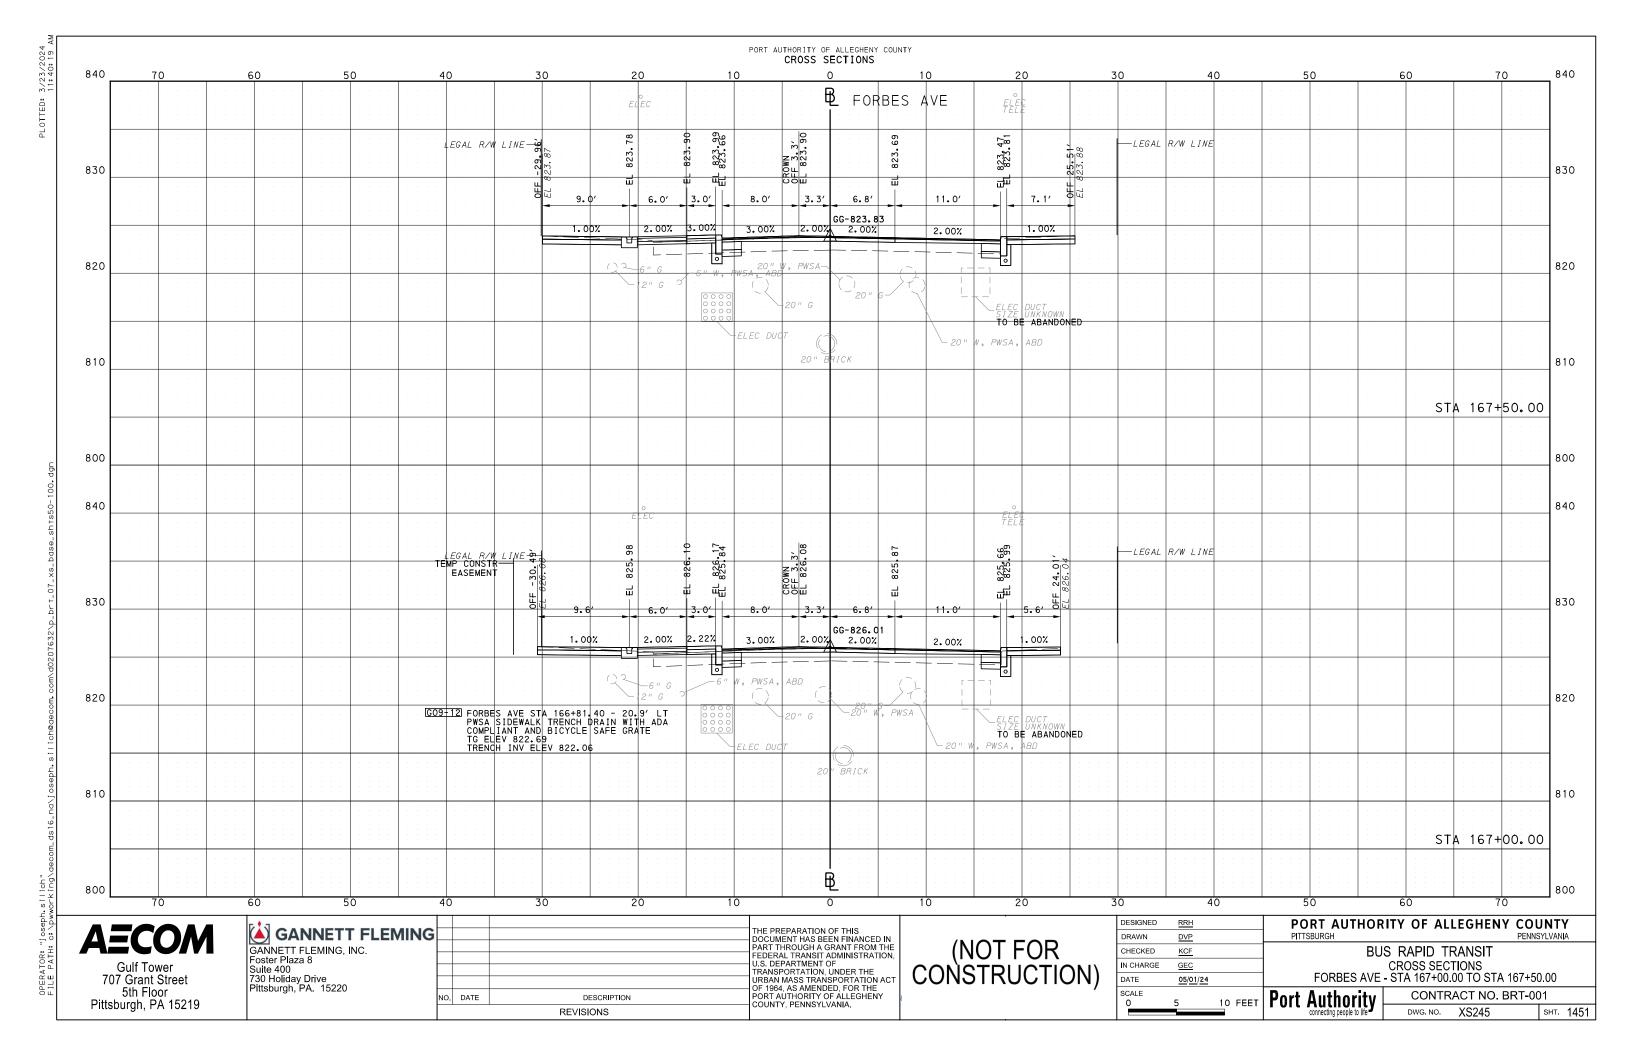


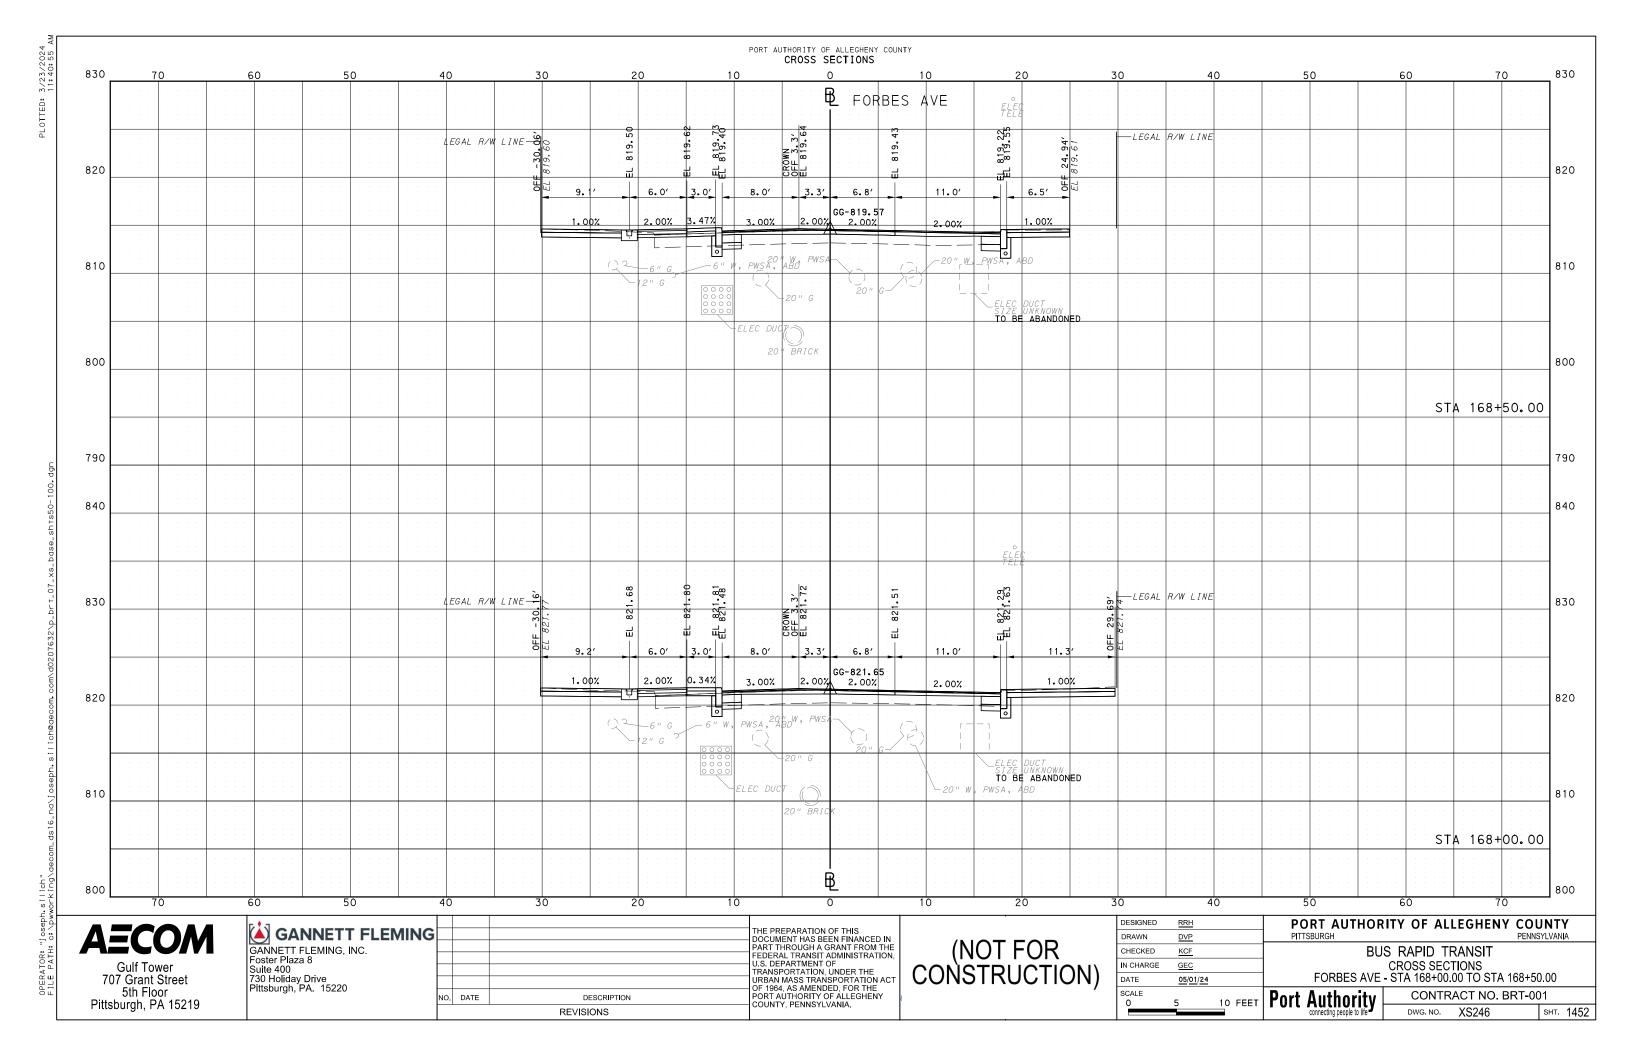


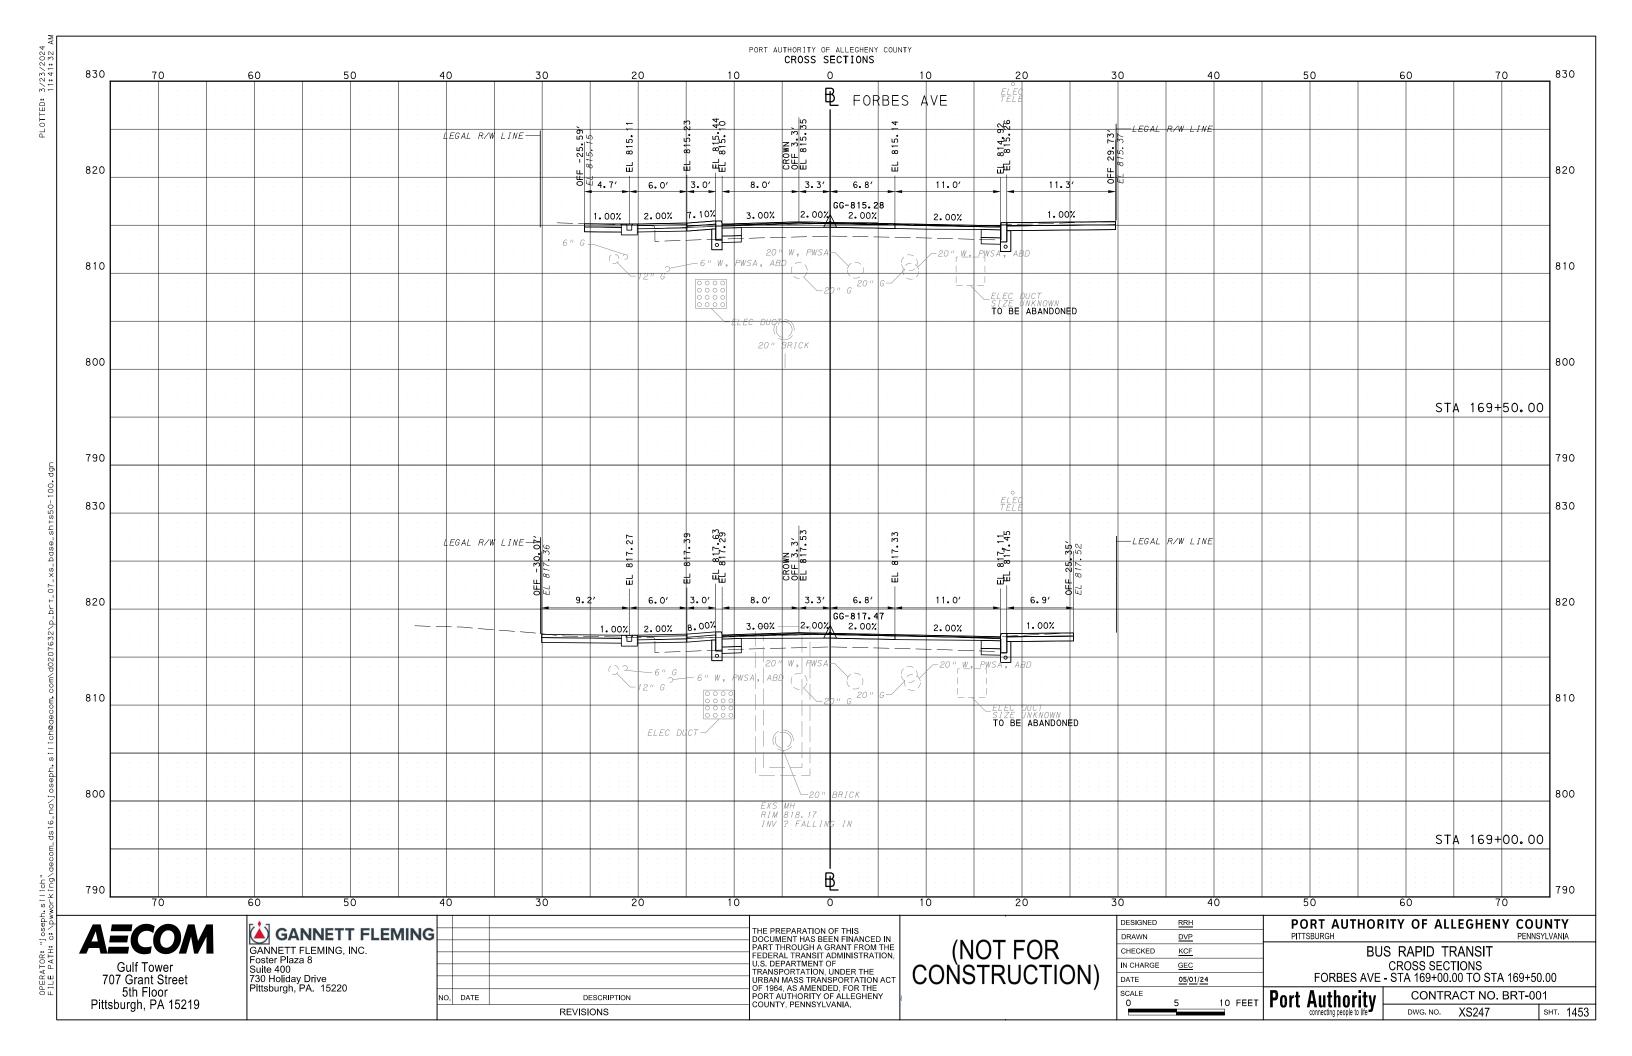


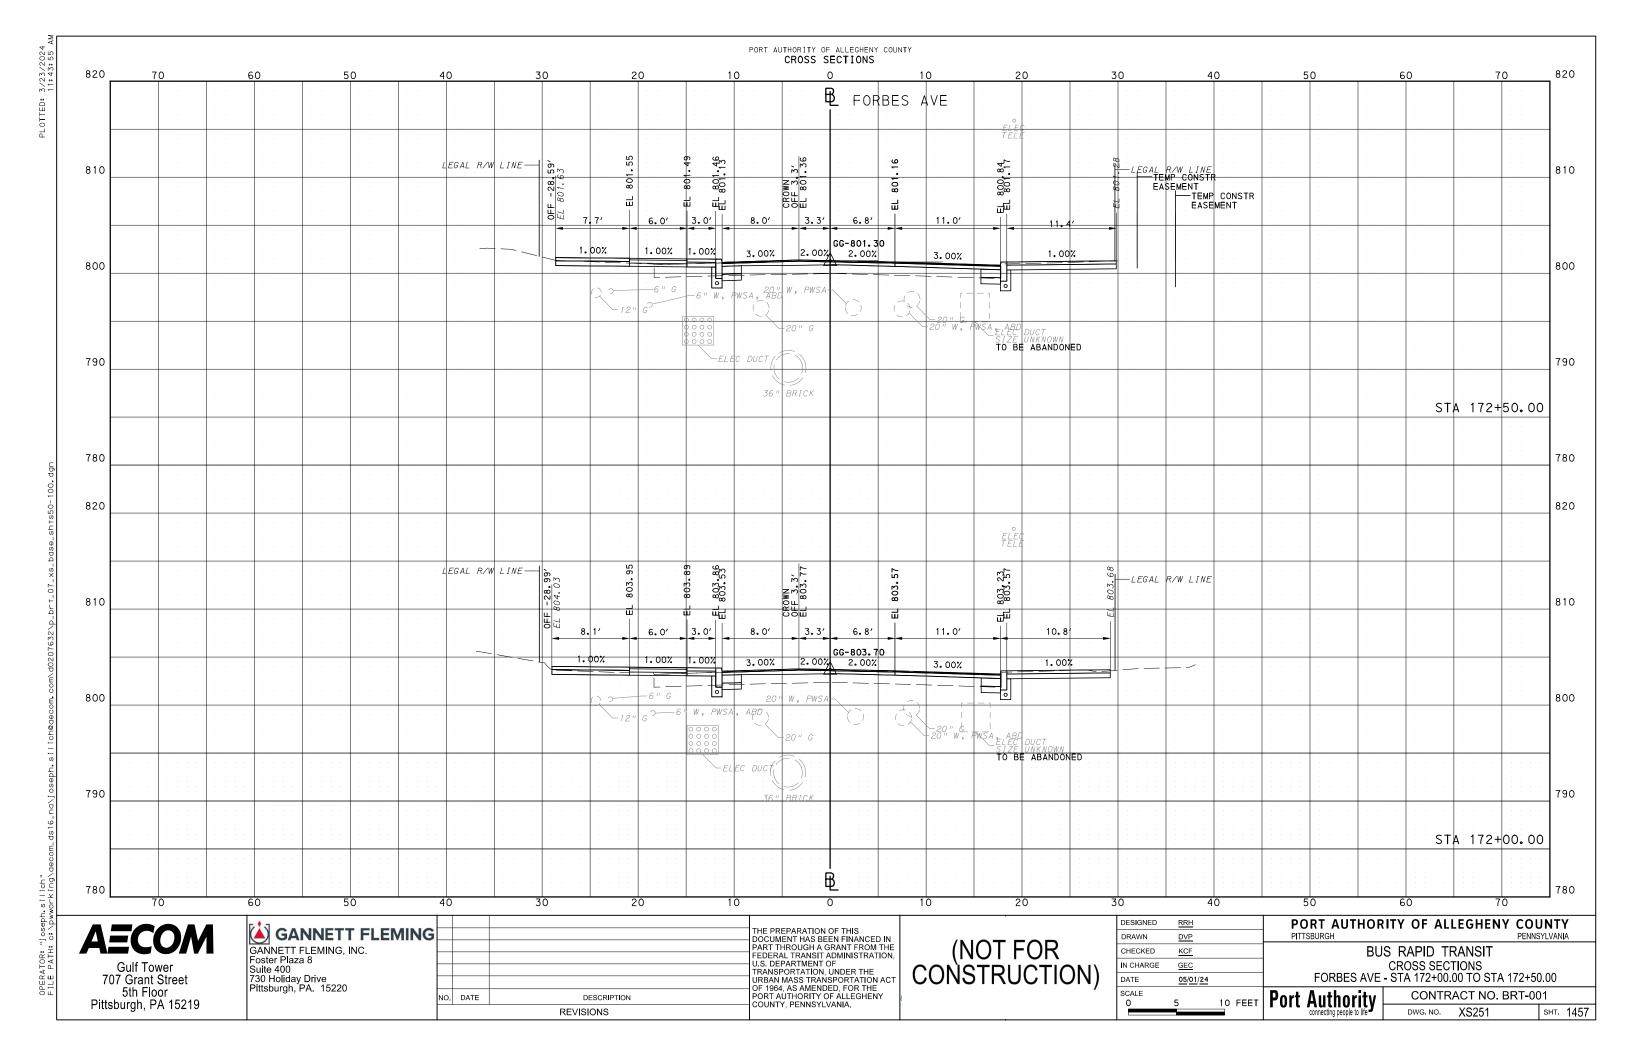


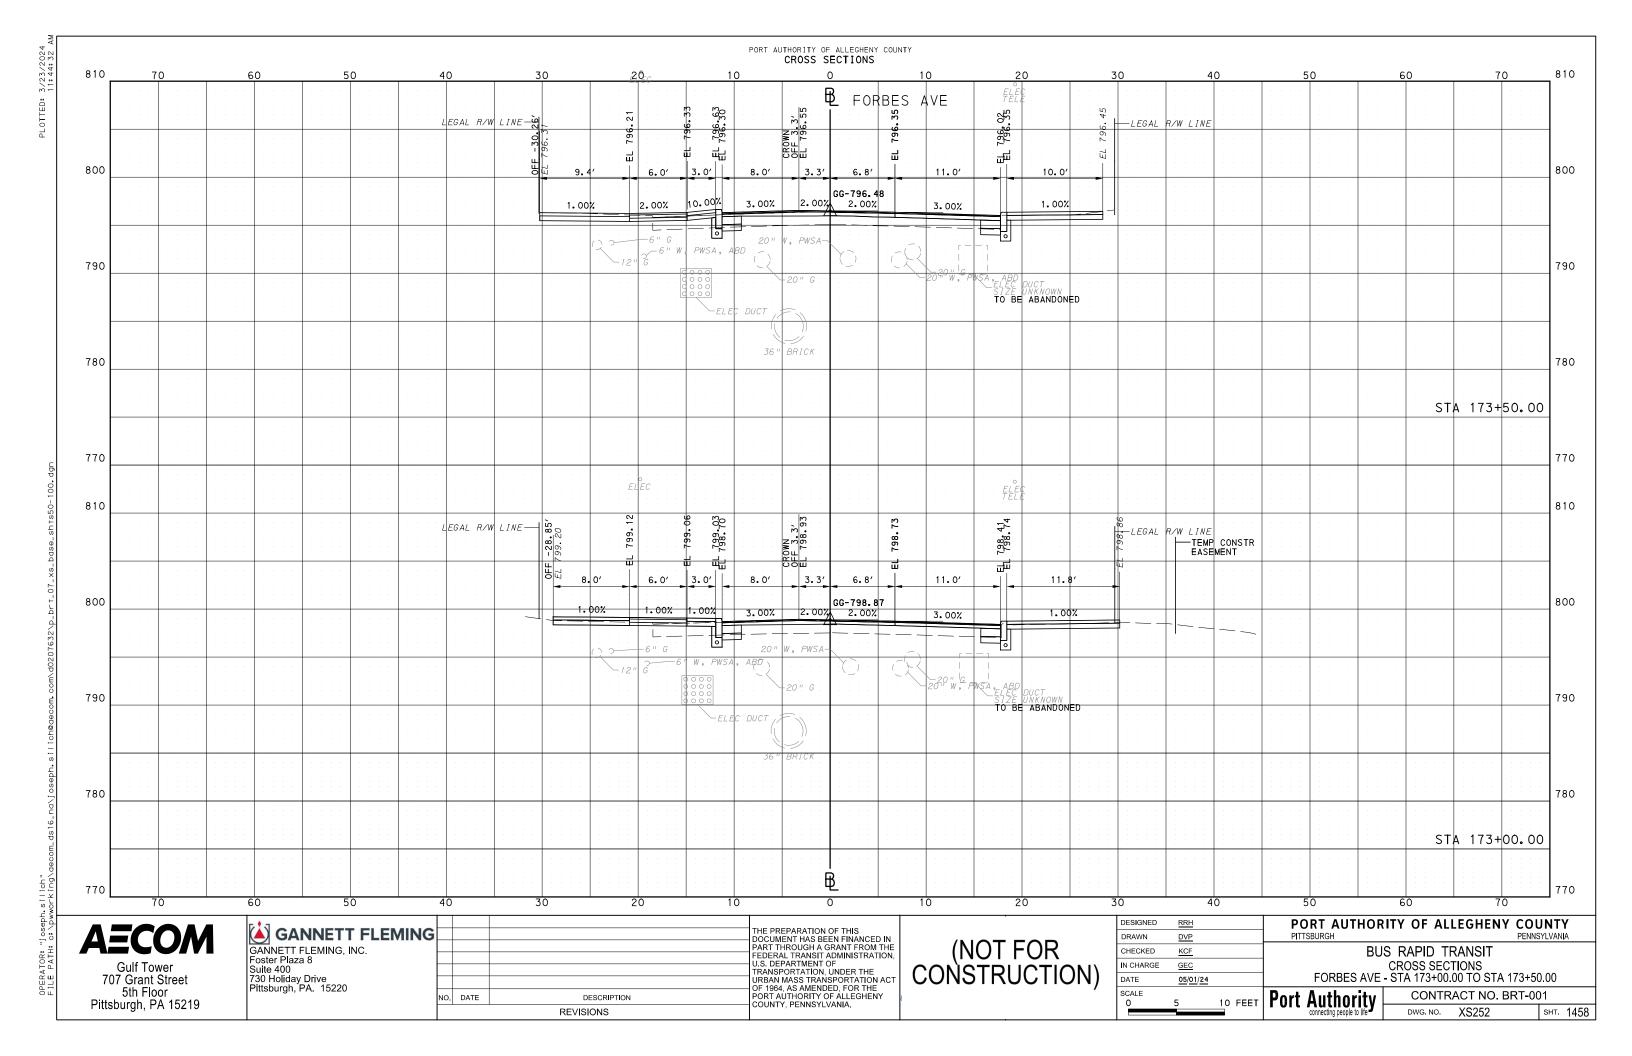


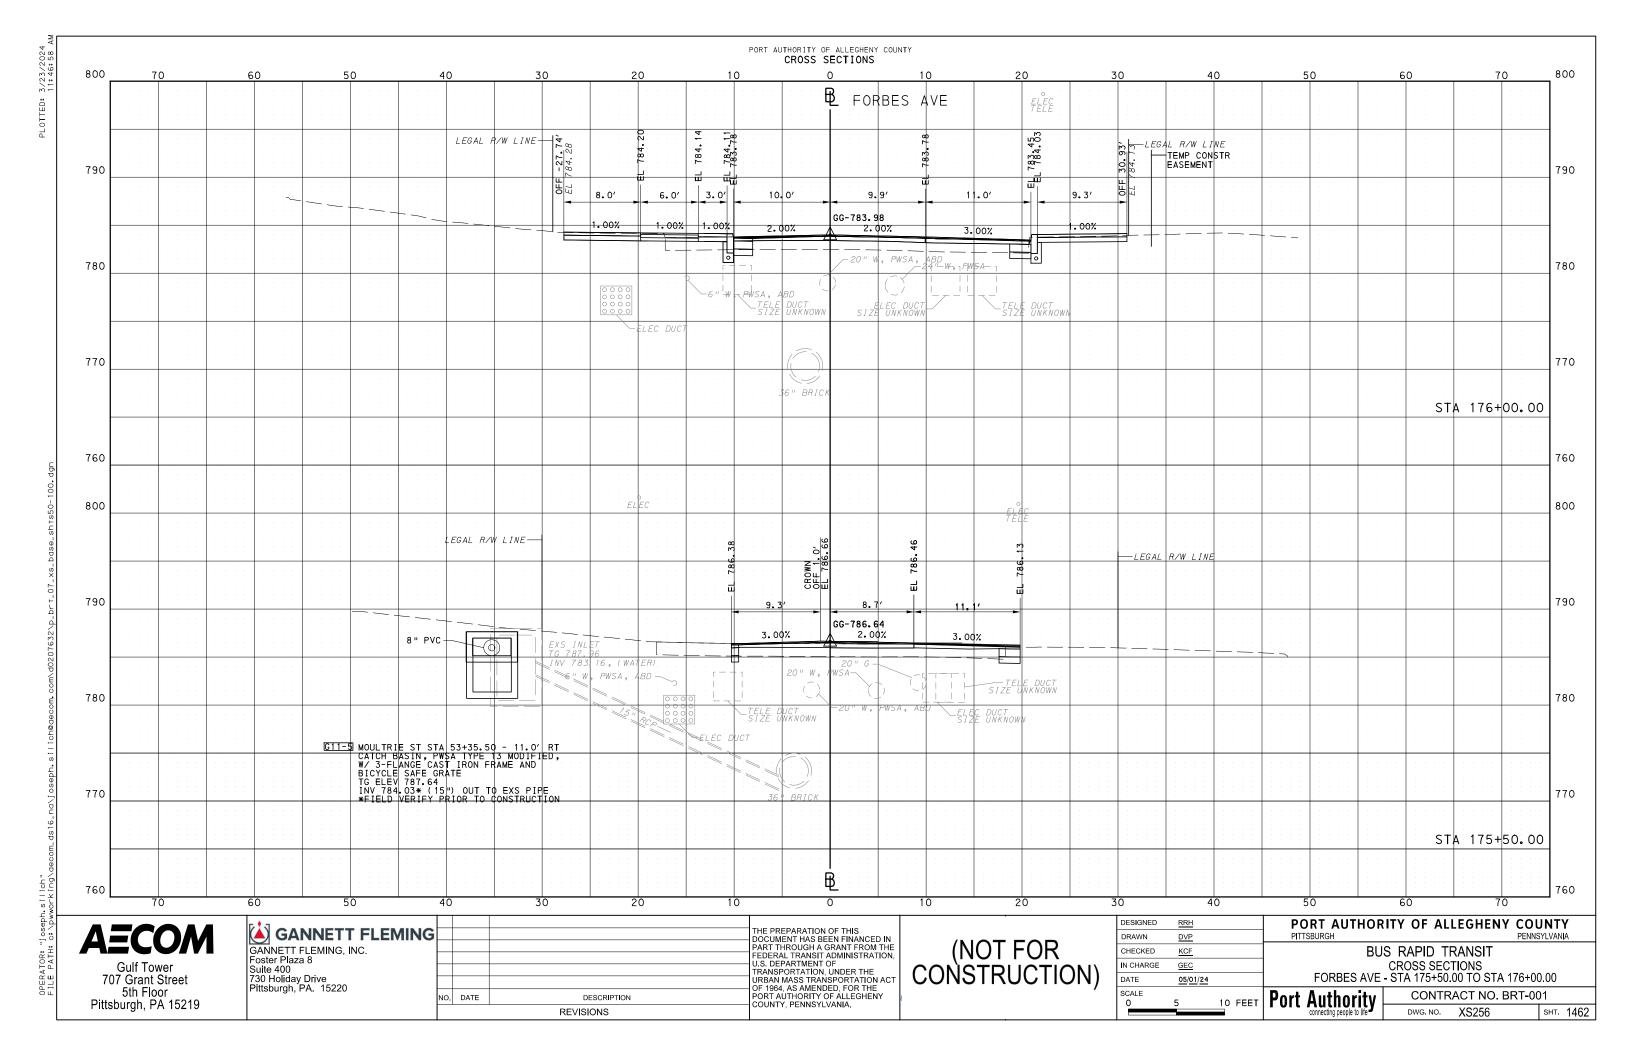


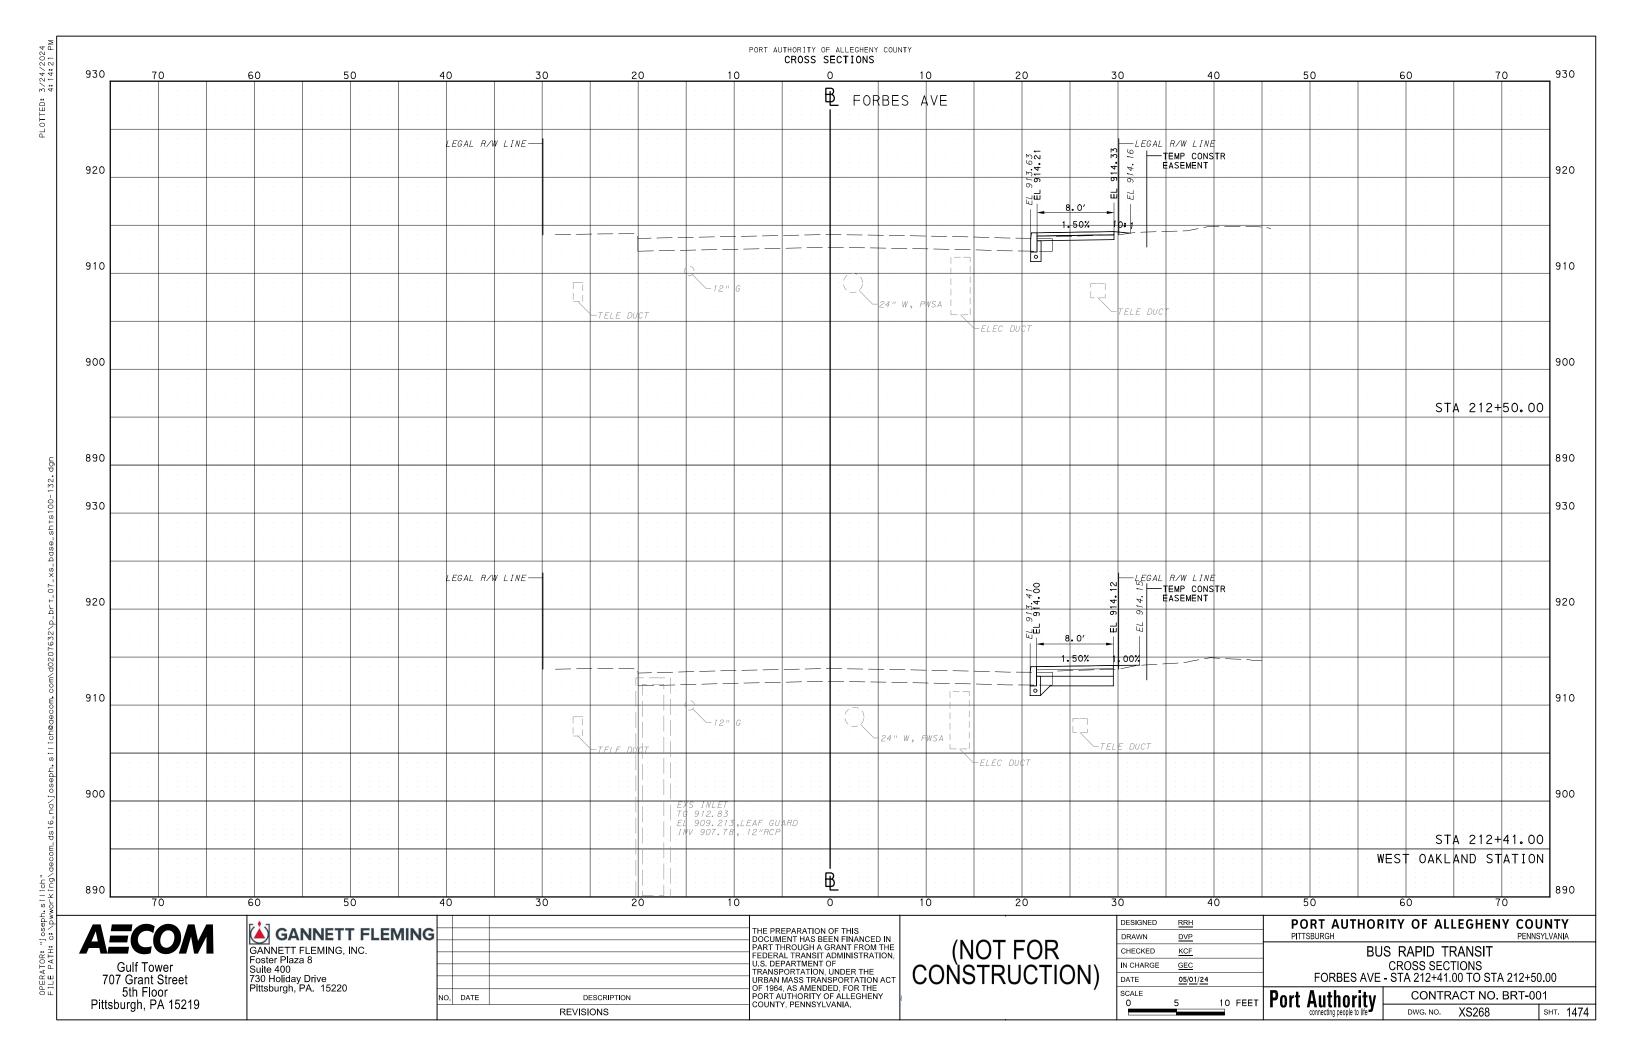


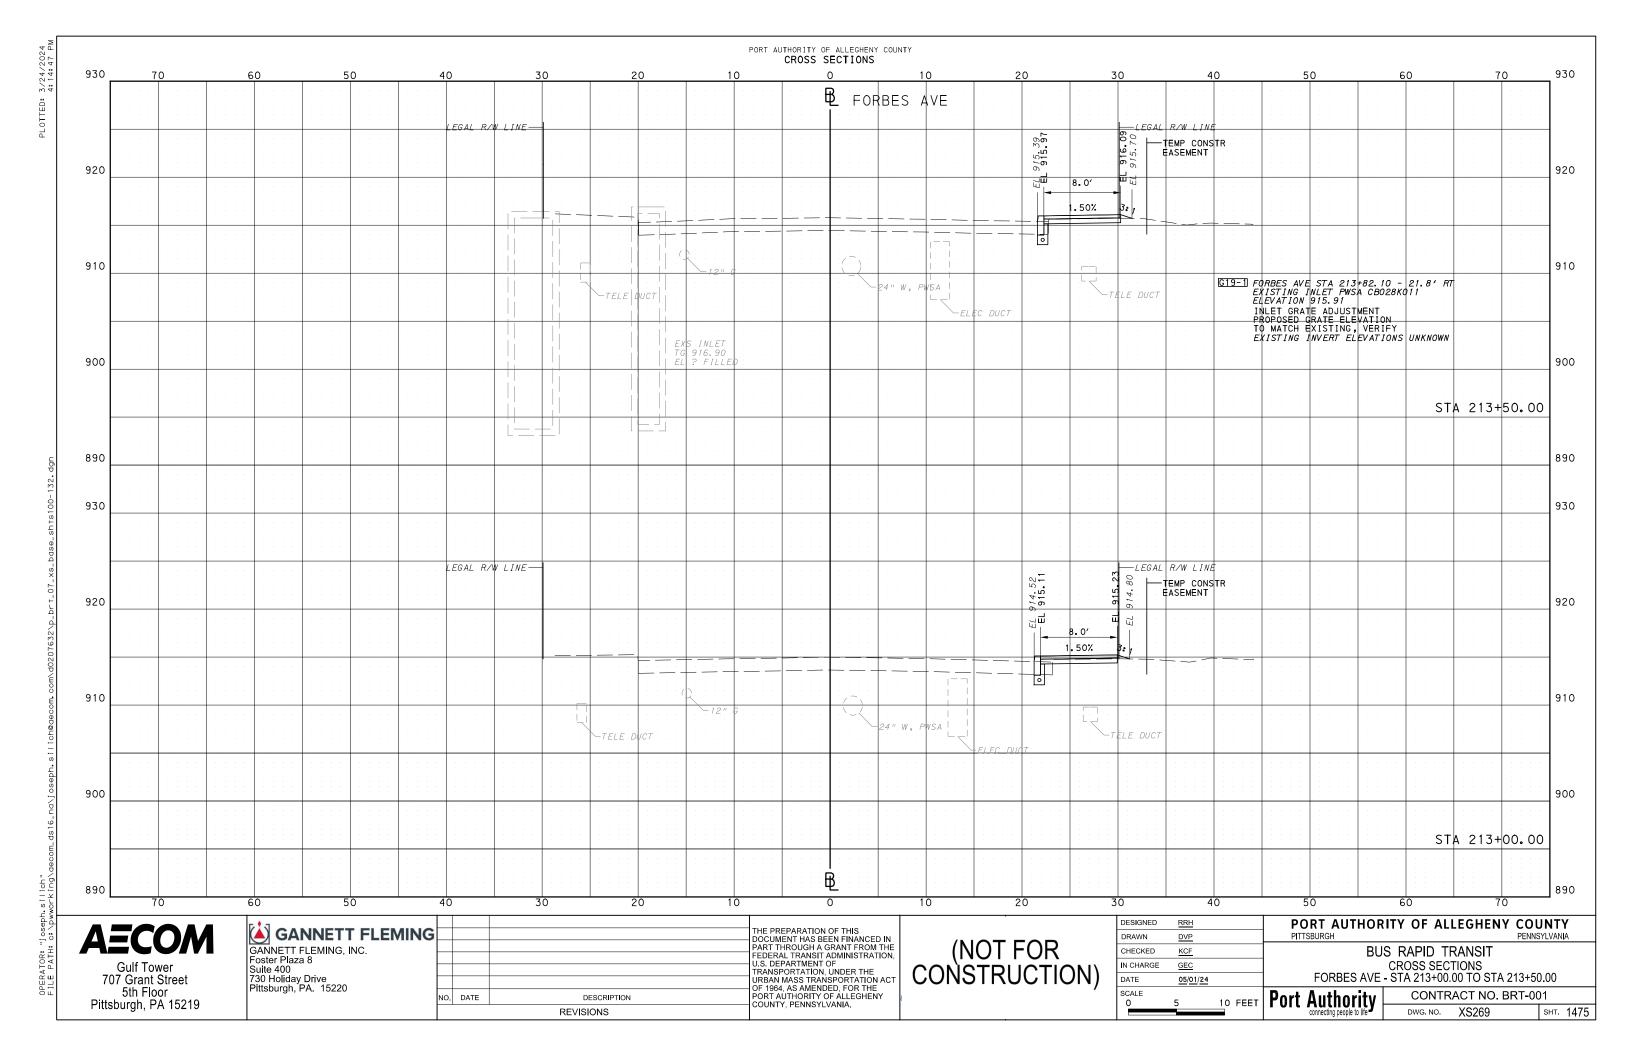


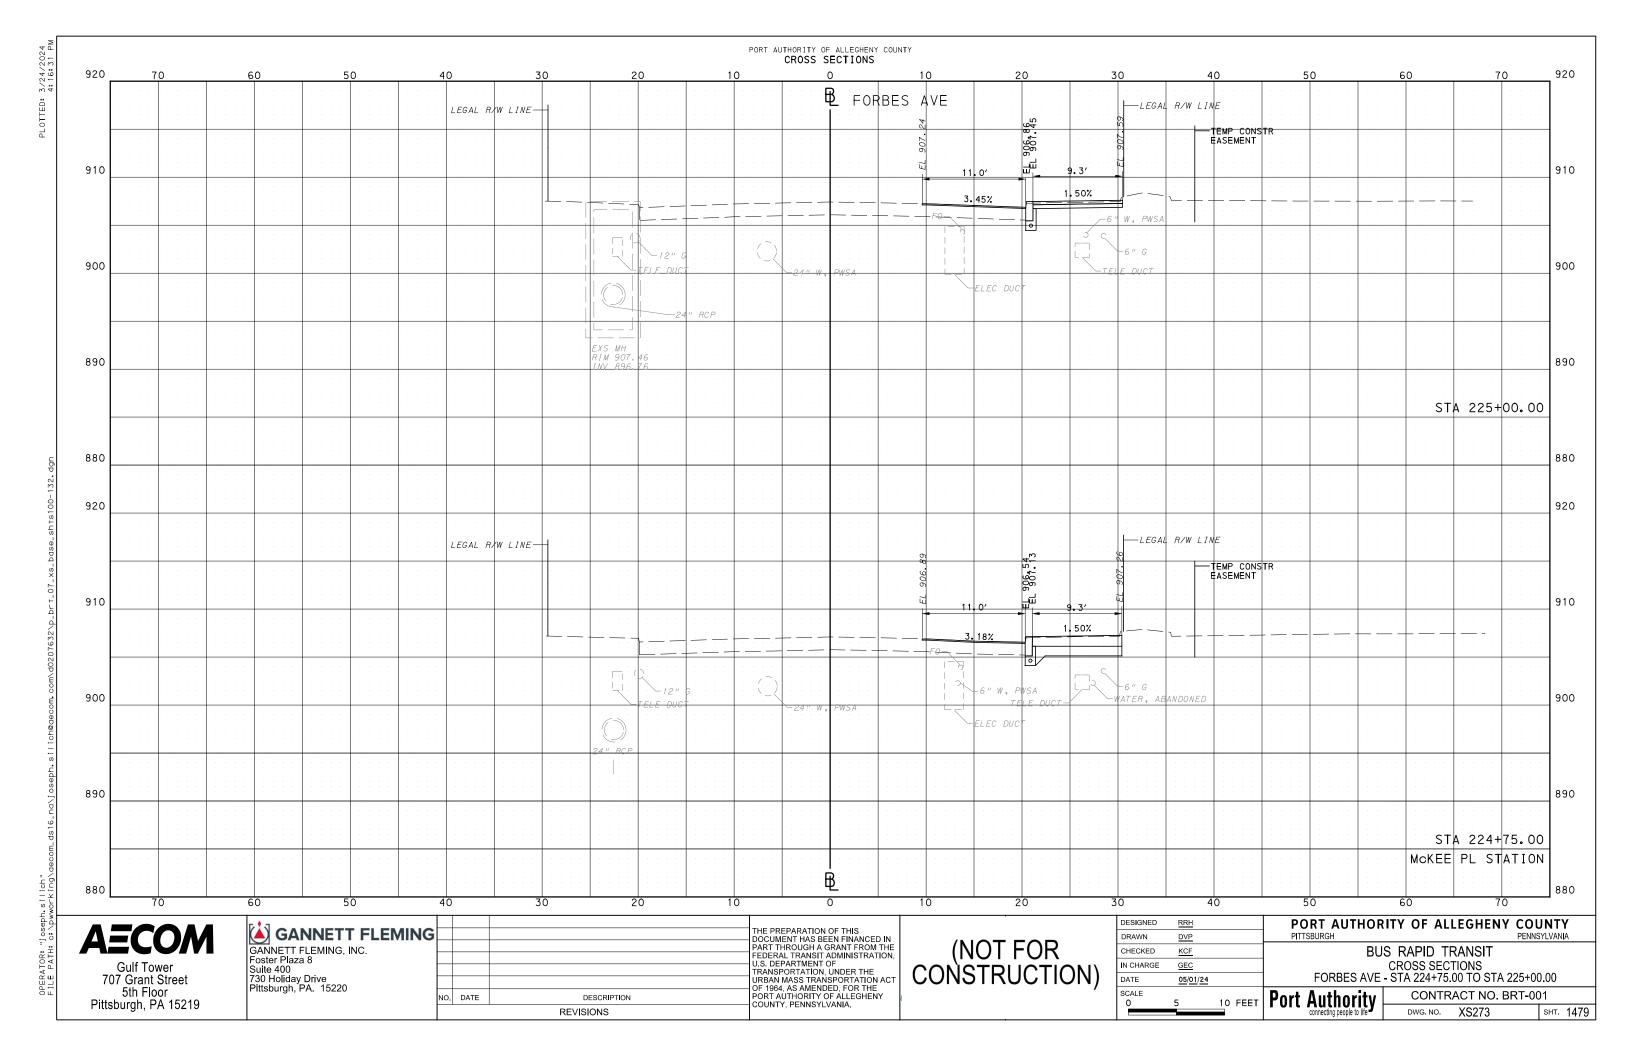


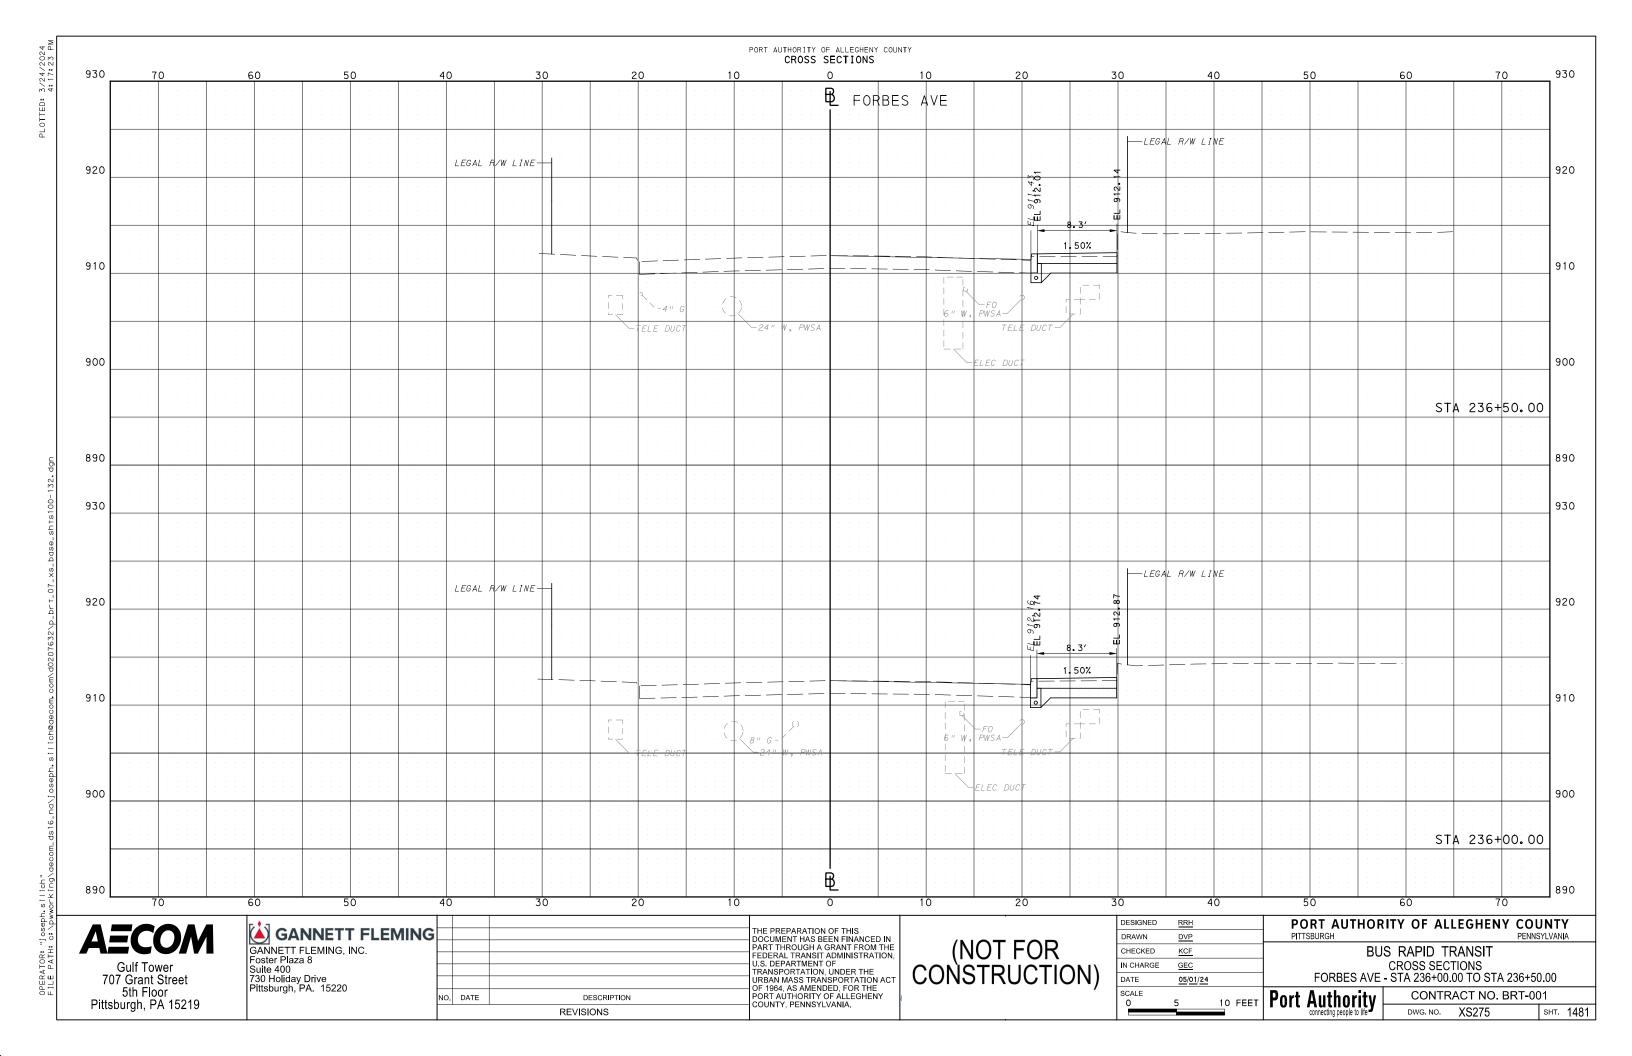


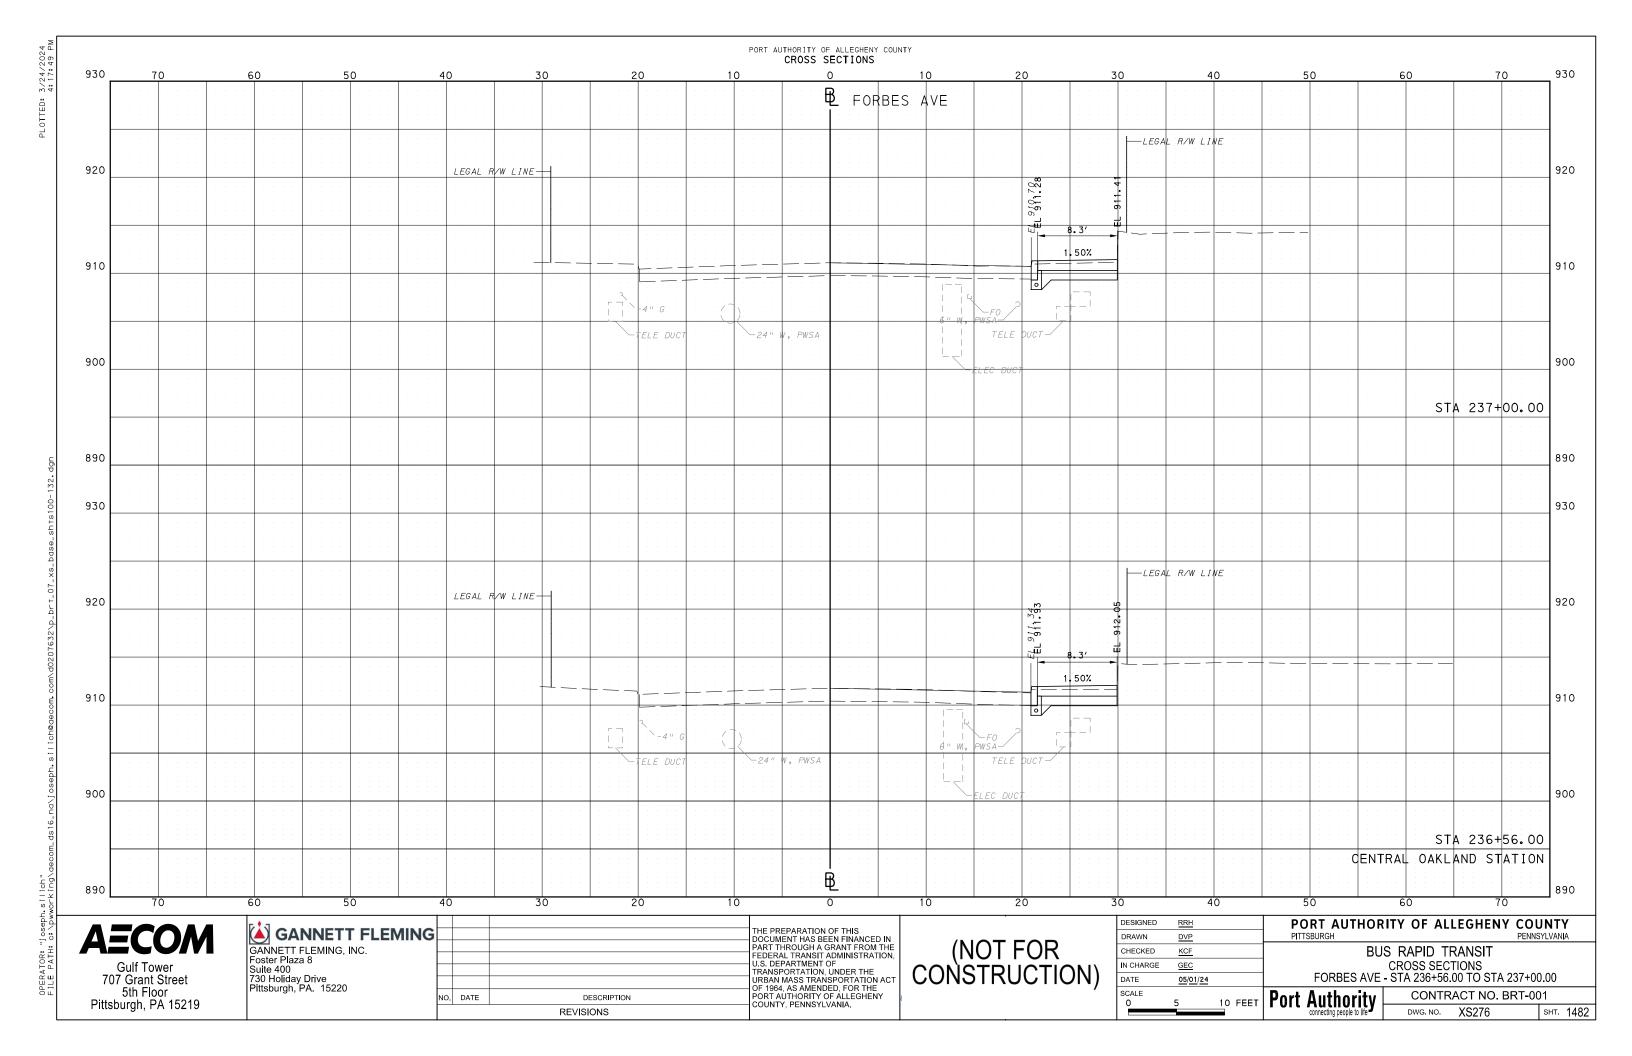

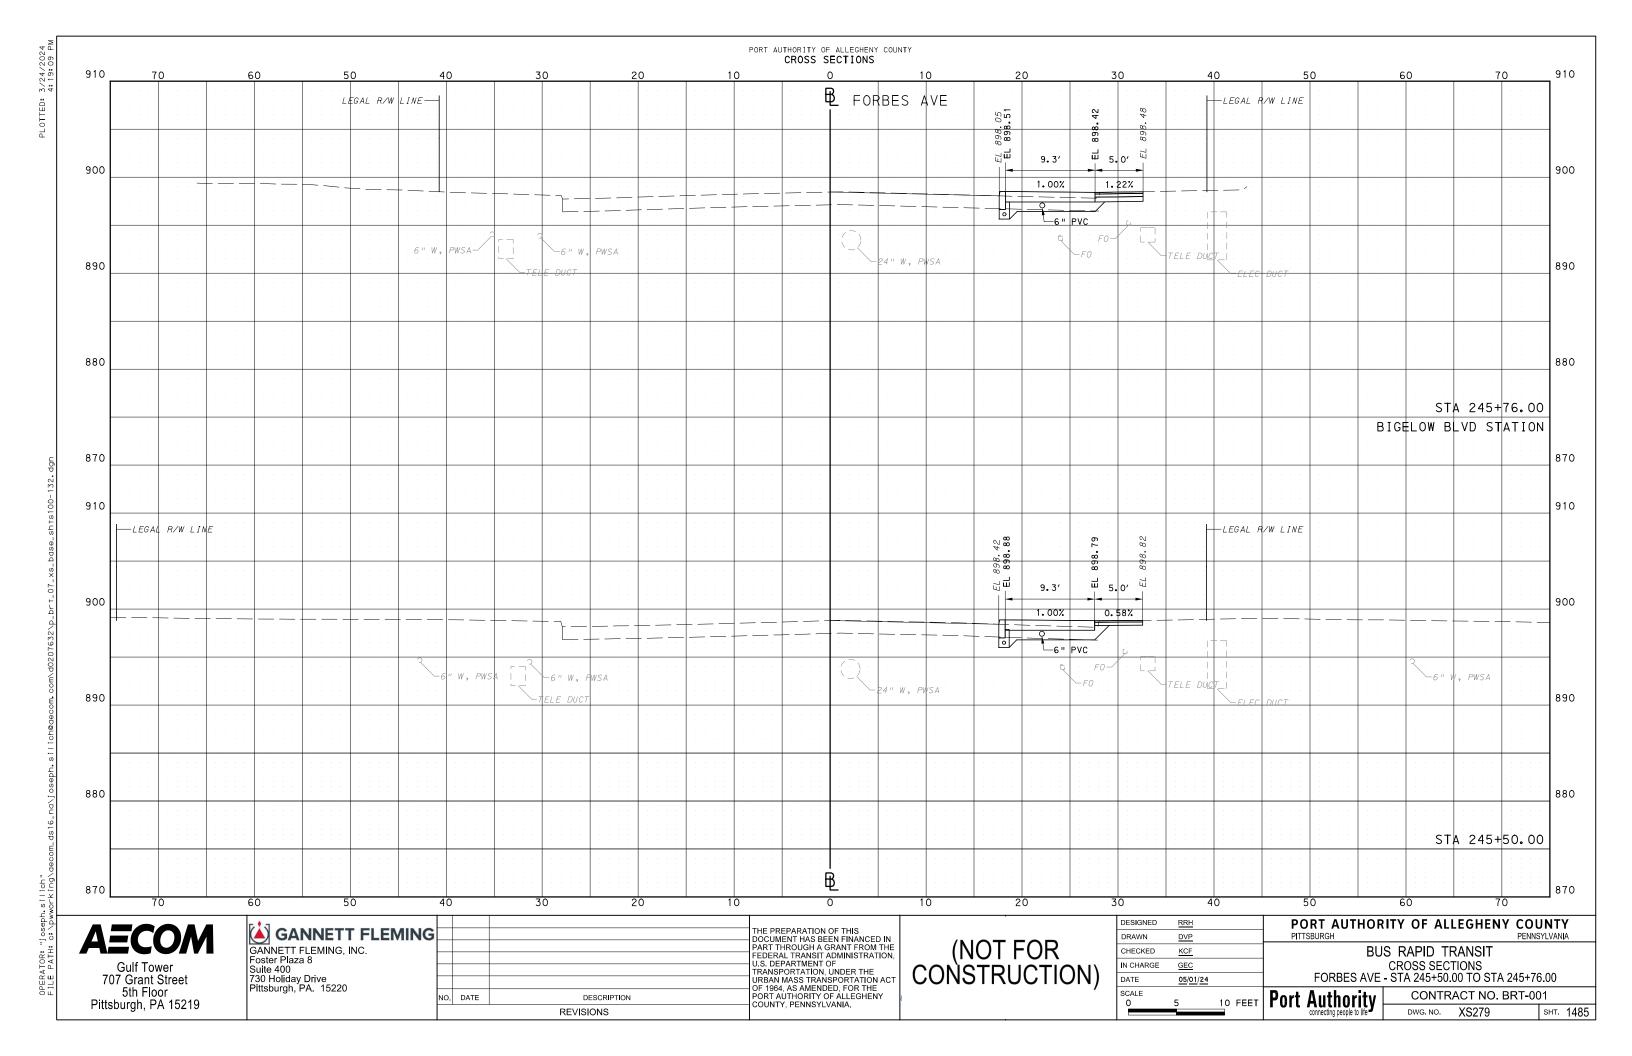

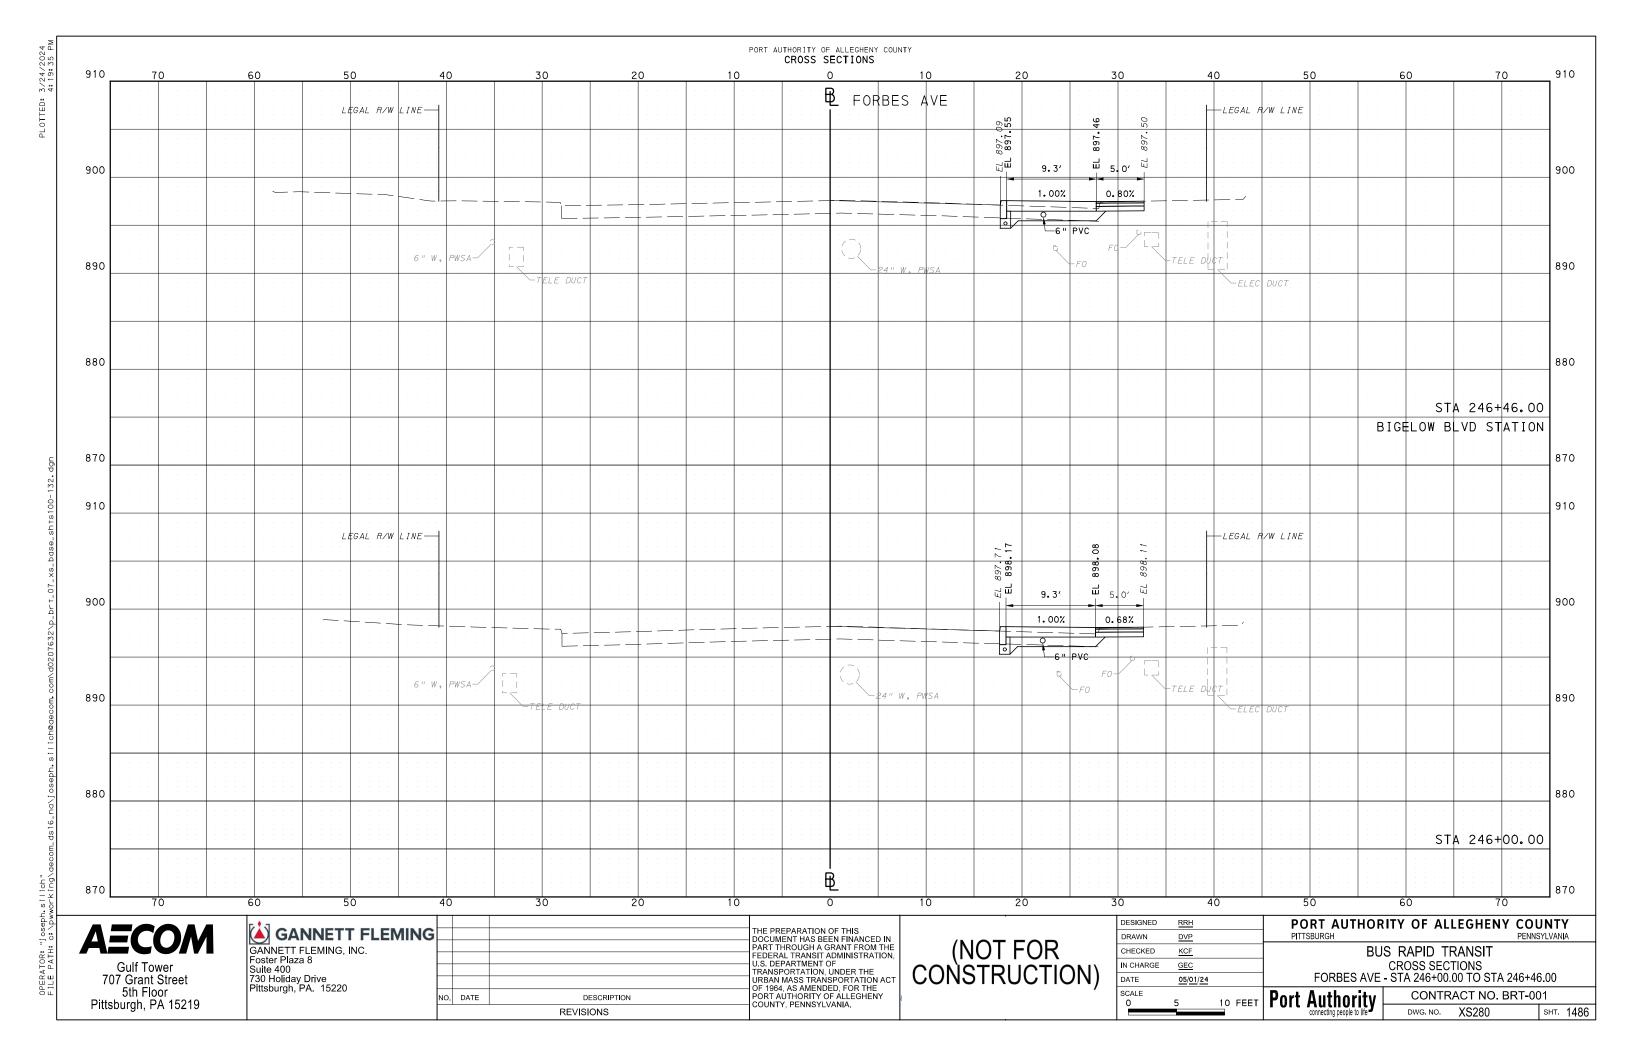

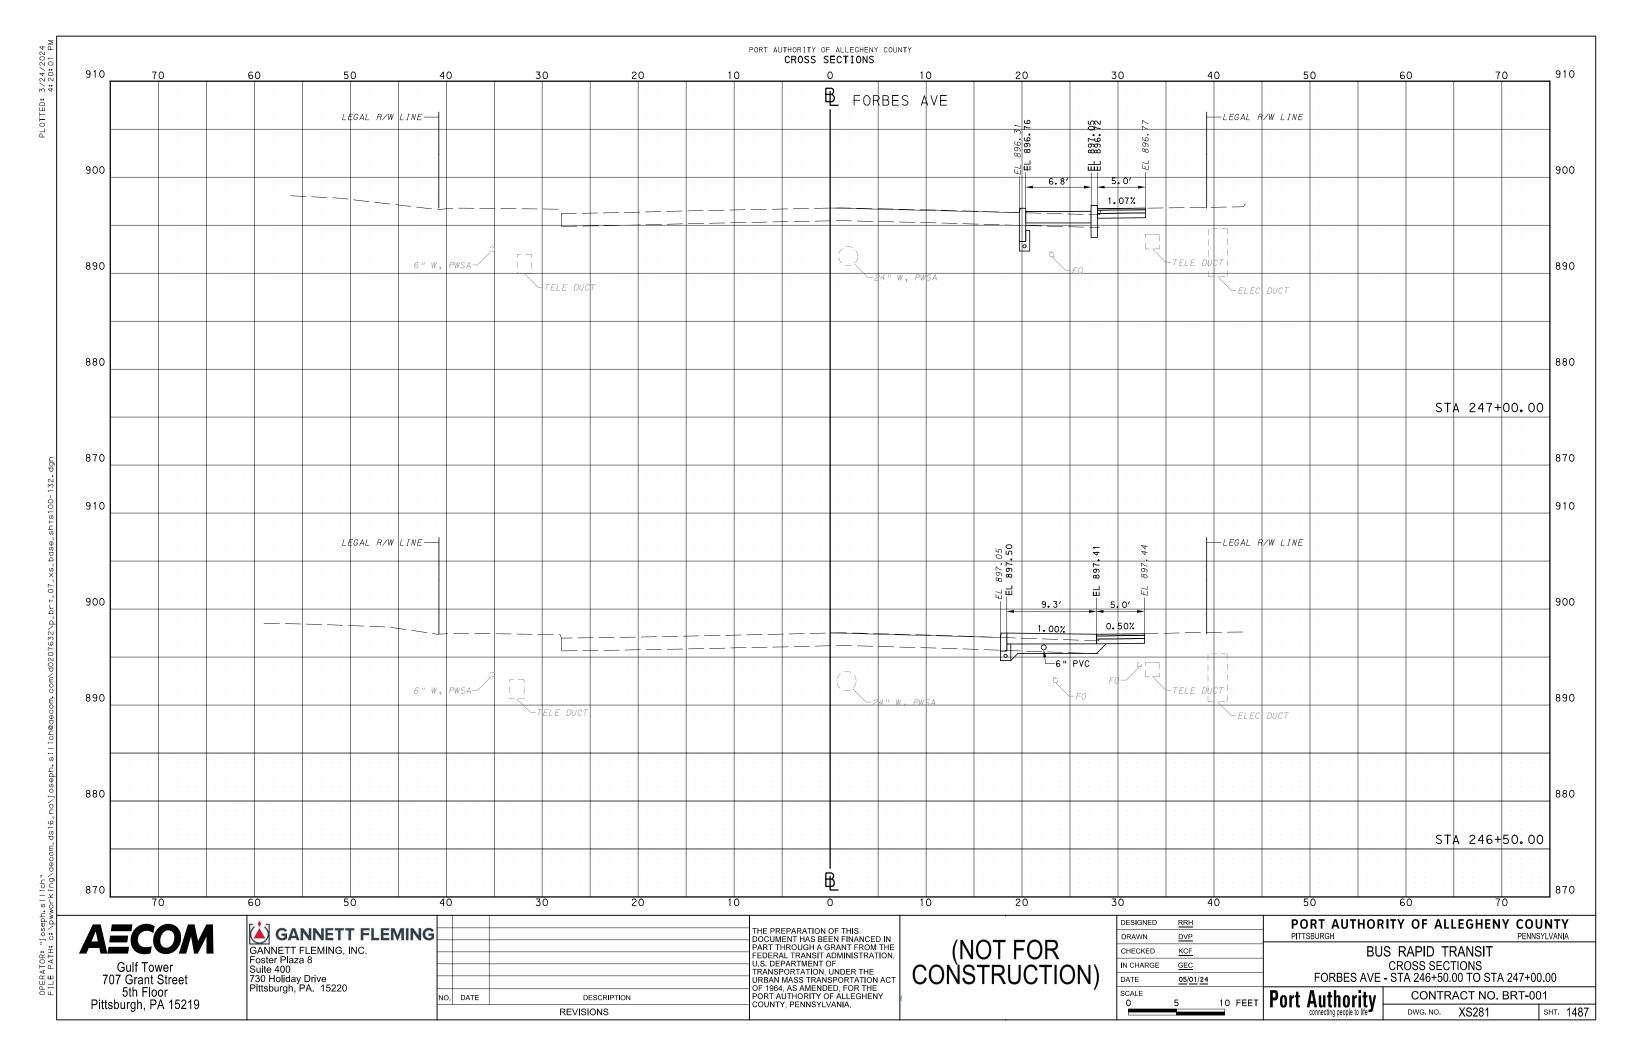

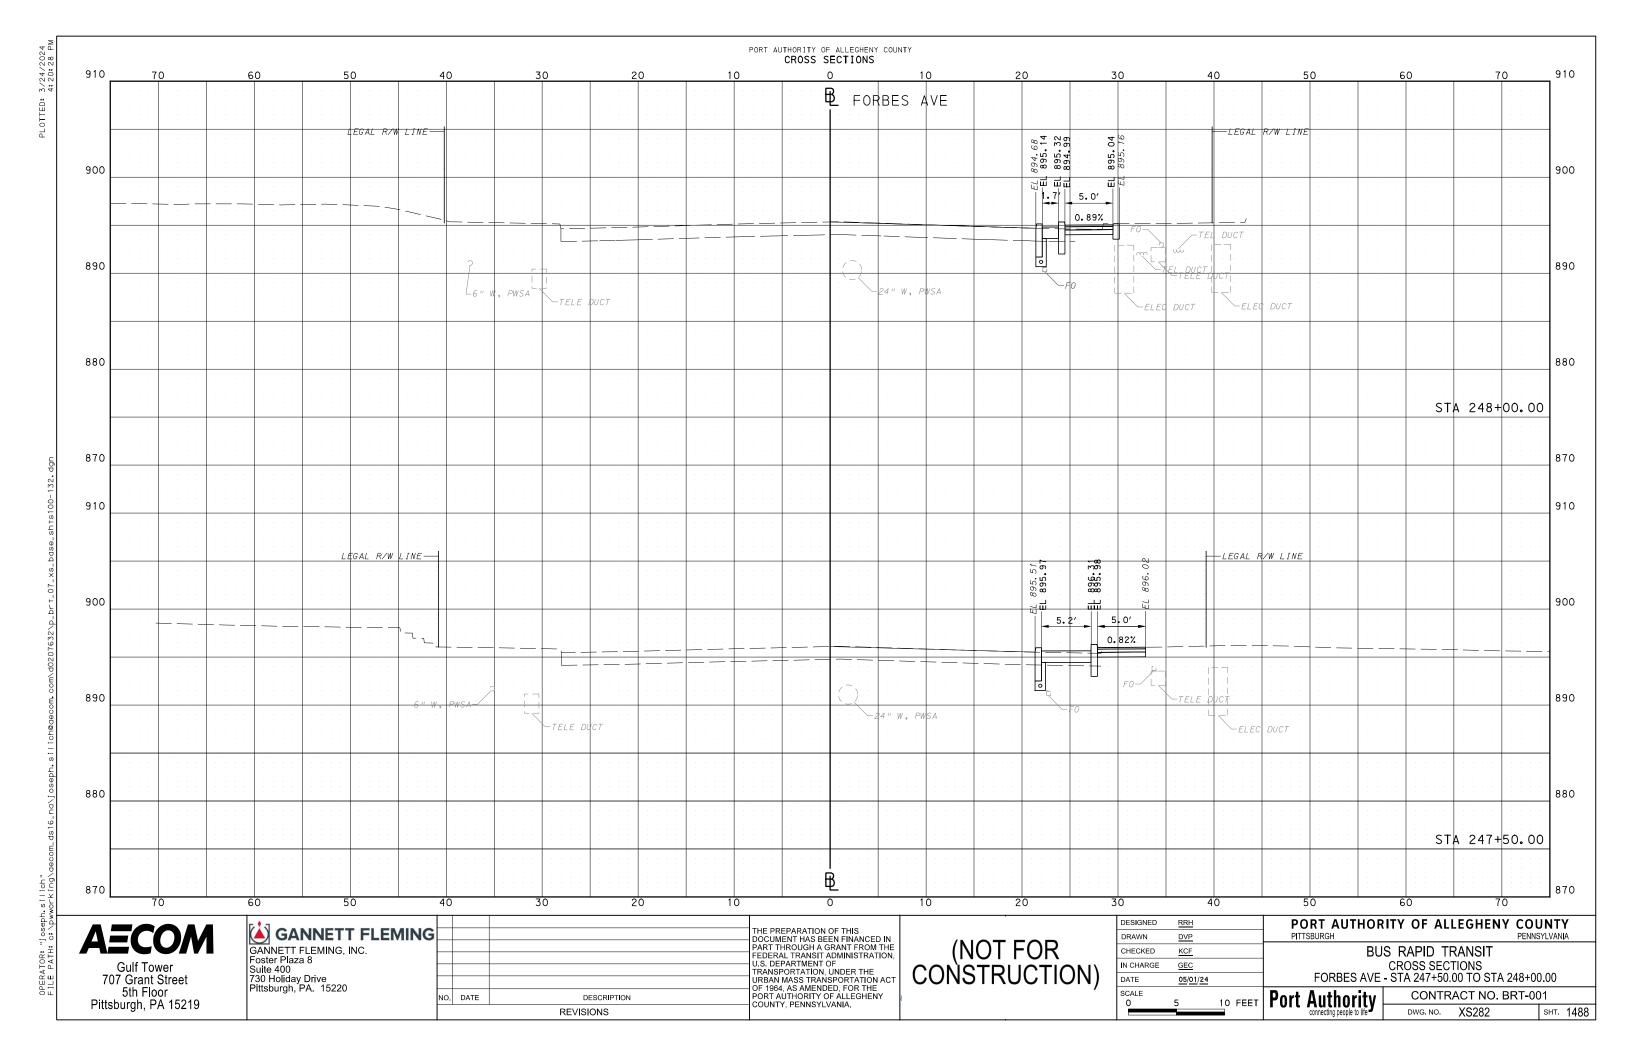

GREEN INFRASTRUCTURE NOTES

GENERAL STORMWATER NOTES:

1.. THE CONTRACTOR SHALL VERIFY BY FIELD MEASUREMENT THE EXISTING AND REQUIRED LOCATIONS OF ALL PIPES, FITTINGS, DUCT BANKS, SITE UTILITIES, EQUIPMENT AND STRUCTURES TO ASSURE PROPER CLEARANCE AND SPACING PRIOR TO FABRICATION OR INSTALLATION.

- 2. PRIOR TO REMOVING ANY EXISTING PIPING, EQUIPMENT, STRUCTURES, FACILITIES OR WORK FROM SERVICE, THE CONTRACTOR SHALL DEMONSTRATE THAT ALL NEW ITEMS AND WORK ARE AVAILABLE FOR CONSTRUCTION AND INSTALLATION. ONCE EXISTING ITEMS ARE REMOVED FROM SERVICE, THE CONTRACTOR SHALL WORK DILIGENTLY AND CONTINUOUSLY IN ACCORDANCE WITH ITS APPROVED CONSTRUCTION SCHEDULE TO MINIMIZE THE TIME PERIOD THAT ANY EXISTING ITEM IS OUT OF SERVICE. EXISTING ITEMS SHALL BE RETURNED TO SERVICE AS QUICKLY AS POSSIBLE.
- 3. THE CONTRACTOR SHALL COORDINATE WITH UTILITY COMPANIES TO CONFIRM ALL UTILITIES SHOWN AS ABANDONED ARE NO LONGER ACTIVE UTILITIES PRIOR TO REMOVAL.
- 4. ALL COSTS ASSOCIATED WITH COMPLIANCE WITH THESE GENERAL NOTES SHALL BE INCLUDED IN THE VARIOUS CONTRACT ITEMS AND NO SEPARATE PAYMENT WILL BE MADE THEREFORE.
- 5. THE CONTRACTOR SHALL TAKE NECESSARY PRECAUTIONS TO AVOID DAMAGE TO EXISTING UTILITIES. IF ANY UNDERGROUND UTILITY IS DAMAGED, THE CONTRACTOR SHALL IMMEDIATELY NOTIFY THE ENGINEER. ANY DAMAGE SUSTAINED TO UTILITIES ABOVE AND BELOW GROUND SHALL BE REPAIRED BY CONTRACTOR AT ITS OWN EXPENSE TO THE SATISFACTION OF THE ENGINEER.
- 6. EXISTING PAVEMENT COMPOSITION AND DEPTH VARIES THROUGHOUT PITTSBURGH. THE CONTRACTOR SHALL REMOVE AND DISPOSE VARYING TYPES AND DEPTHS OF EXISTING PAVEMENT AS NECESSARY. NO ADDITIONAL COMPENSATION WILL BE PAID FOR REMOVING AND DISPOSING VARYING PAVEMENT COMPOSITION AND DEPTH.
- 7. ANY UNCHARTED FOOTINGS, STRUCTURES, UTILITIES, ETC. ENCOUNTERED DURING EXCAVATION SHALL BE BROUGHT TO THE ATTENTION OF THE ENGINEER BEFORE ANY ACTION IS TAKEN. ANY WORK REQUIRED FOR THESE UNCHARTED ITEMS IS PART OF THE BASIC DEMOLITION WORK.
- 8. ALL WORK SHALL BE PERFORMED ACCORDING TO PWSA AND CITY OF PITTSBURGH STANDARDS UNLESS OTHERWISE SPECIFIED.
- 9. THE CONTRACTOR IS RESPONSIBLE FOR REMOVAL AND LEGAL DISPOSAL OF ALL DEBRIS RESULTING FROM DEMOLITION AND SITE CLEARING.
- 10. THE CONTRACTOR SHALL NOTIFY THE ENGINEER OF ANY DEVIATION FROM THESE PLANS PRIOR TO ANY CHANGES BEING MADE. ANY DEVIATIONS FROM THESE PLANS WITHOUT WRITTEN CONSENT FROM THE OWNER WILL BE THE SOLE RESPONSIBILITY OF THE CONTRACTOR.
- 11. POSITIVE DRAINAGE SHALL BE MAINTAINED DURING ALL PHASES OF CONSTRUCTION. PONDING OR STANDING WATER WILL NOT BE PERMITTED.
- 12. UPON INSTALLATION, KEEP ALL DRAINAGE STRUCTURES, PRETREATMENT DEVICES (E.G., TRASH RACKS AND SUMPS), AND STORMWATER IMPROVEMENTS IN CLEAN AND WORKING ORDER. TRANSPORT AND DISPOSAL OF ACCUMULATED SEDIMENT OFF-SITE SHALL BE IN ACCORDANCE WITH APPLICABLE LOCAL, STATE AND FEDERAL GUIDELINES AND REGULATIONS.
- 13. THE CONTRACTOR SHALL MAINTAIN ALL EXISTING WATER AND SEWERAGE FACILITIES IN OPERATION DURING THE WORK. THE CONTRACTOR IS OBLIGED TO COMMUNICATE AND COORDINATE TO ENSURE SMOOTH, CONTINUOUS DAILY OPERATION OF THE SEWER SYSTEM. THE CONTRACTOR SHALL CONTINUALLY UPDATE ITS PROPOSED PLAN AND SCHEDULE FOR TEMPORARY FLOW CONTROLS AND SHALL OBTAIN APPROVAL FROM PWSA PRIOR TO IMPLEMENTING ANY ACTIVITIES WHICH AFFECT OPERATION OF THE SEWER SYSTEM AT LEAST 24 HOURS PRIOR TO SUCH ACTIVITY.
- 14. EXCAVATION FOR STORMWATER TRENCHES IS COVERED BY PAY ITEM 02976.03 IS INCIDENTAL TO AASHTO #57 STONE AND IS DEFINED IN THE TECHNICAL PROVISIONS, PWSA SECTION 02976 SUBSURFACE STORAGE BEDS.

EROSION AND SEDIMENT CONTROL NOTES:

1. INFILTRATION SYSTEM CONSTRUCTION:
UNLESS OTHERWISE NOTED, THE IN-SITU SOILS SHALL NOT BE DISTURBED
OR COMPACTED WITHIN 12 INCHES OF THE FINAL DESIGN EXCAVATION OF
THE BOTTOM OF ANY INFILTRATION OR UNLINED TRENCH. IF THE
SUB-GRADE IS IMPACTED THE IMPACTED AREA SHALL BE TILLED TO A
DEPTH OF 12-INCHES BELOW THE BOTTOM OF THE RESERVOIR LAYER.
INFILTRATION TESTS SHALL BE PERFORMED PRIOR TO THE INSTALLATION
OF INFILTRATION TRENCHES TO ENSURE THE INFILTRATION RATE IS STILL
ACCEPTABLE. IF THERE IS A LOSS IN INFILTRATION RATE, DEEP TILLING
AND/OR OTHER RESTORATION PRACTICES WILL BE REQUIRED TO RESTORE
THE RATE.

2. UNLESS OTHERWISE NOTED, KEEP THE STORMWATER IMPROVEMENTS OFF-LINE UNTIL CONSTRUCTION IS COMPLETE. PREVENT SEDIMENT FROM ENTERING THE STORMWATER IMPROVEMENTS BY USING SUPER SILT FENCE, COIR LOGS, DIVERSION BERMS, SAND BAGS OR OTHER MEANS.

SWM1 SWM2	GREEN INFRASTRUCTURE NOTES AND INDEX KEY PLAN
SWM3	KEY PLAN
SWM4	GI DETAILS GI DETAILS
SWM5	
SWM6	GI DETAILS
SWM7	GI DETAILS
SWM8	GI DETAILS
SWM9	GI DETAILS
SWM10	GI DETAILS
SWM11	GI DETAILS
SWM12	GI DETAILS
SWM13	STRUCTURE TABLE - FIFTH AVENUE
SWM14	STRUCTURE TABLE - FORBES AVENUE
SWM15	FIFTH AVE - STA 456+50 TO STA 458+50
SWM16	FIFTH AVE - STA 458+50 TO STA 460+00
SWM17	FIFTH AVE - STA 470+50 TO STA 472+50
SWM18	FIFTH AVE - STA 474+50 TO STA 477+50
SWM19	FIFTH AVE - STA 484+50 TO STA 486+50
SWM2Ø	FIFTH AVE - STA 488+00 TO STA 491+00
SWM21	FIFTH AVE - STA 491+50 TO STA 493+50
SWM22	FORBES AVE - STA 142+00 TO STA 144+00
SWM23	FORBES AVE - STA 145+50 TO STA 147+50
SWM24	FORBES AVE - STA 145+50 TO STA 147+50
SWM25	FORBES AVE - STA 148+00 TO STA 150+50
SWM26	FORBES AVE - STA 156+50 TO STA 158+00
SWM27	FORBES AVE - STA 164+50 TO STA 166+50
SWM28	FORBES AVE - STA 169+50 TO STA 171+50
SWM29	FORBES AVE - STA 246+50 TO STA 248+50
SWM3Ø	BIOSWALE GRADING PLANS
SWM31	BIOSWALE GRADING PLANS
SWM32	LANDSCAPE PLANS
SWM33	LANDSCAPE PLANS
SWM34	LANDSCAPE PLANS
SWM35	LANDSCAPE PLANS
SWM36	LANDSCAPE PLANS

STORMWATER MANAGMENT PLANS INDEX

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Э.	DATE	DESCRIPTION	
	•	REVISIONS	COUNTY, PENNSYLVANIA.

NOT FOR CONSTRUCTION

APPROVED

SIGNATURE

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CHECKED	<u>DPW</u>	
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DATE	05/01/24	
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DATE

PORT AUTHORITY OF ALLEGHENY COUNTY
PITTSBURGH


BUS RAPID TRANSIT UPTOWN TO OAKLAND
STORMWATER MANAGEMENT PLANS
GREEN INFRASTRUCTURE NOTES AND INDEX


Port Authority Connecting people to life


CONTRACT NO. BRT-001

DWG. NO. SWM1 SHT.

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SEE BRT PLAN SET FOR ROADWAY DRAWINGS

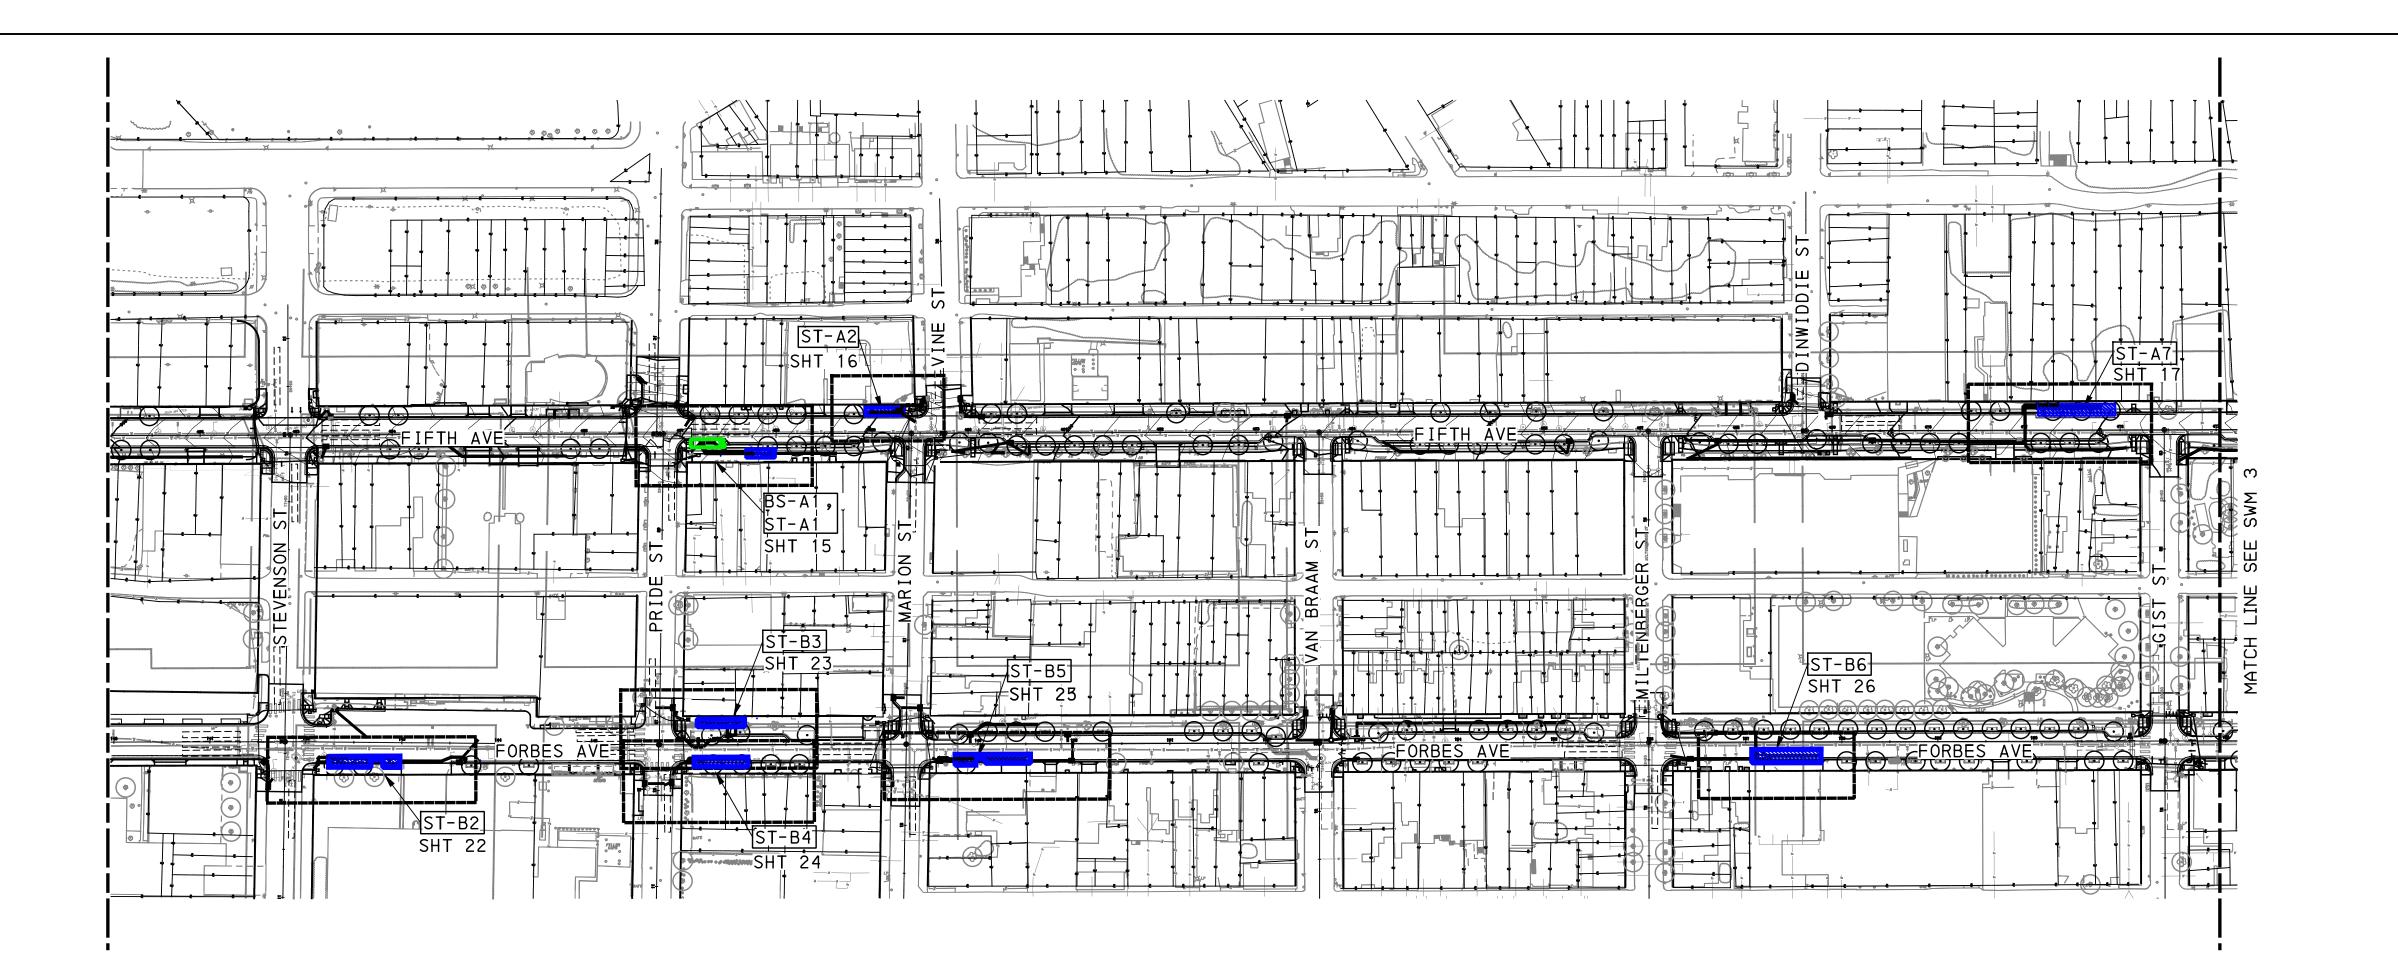PORT AUTHORITY OF ALLEGHENY COUNTY

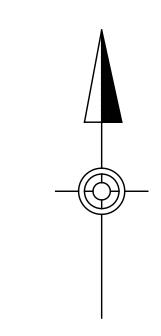
PITTSBURGH

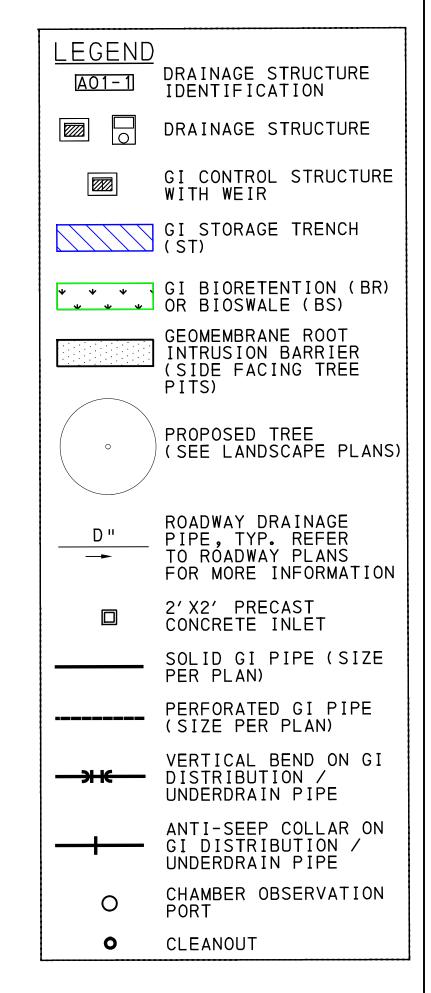
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BUS RAPID TRANSIT UPTOWN TO OAKLAND STORMWATER MANAGEMENT PLANS KEY PLAN

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VIL	connecting people to life	DWG. NO. SWM2	SH



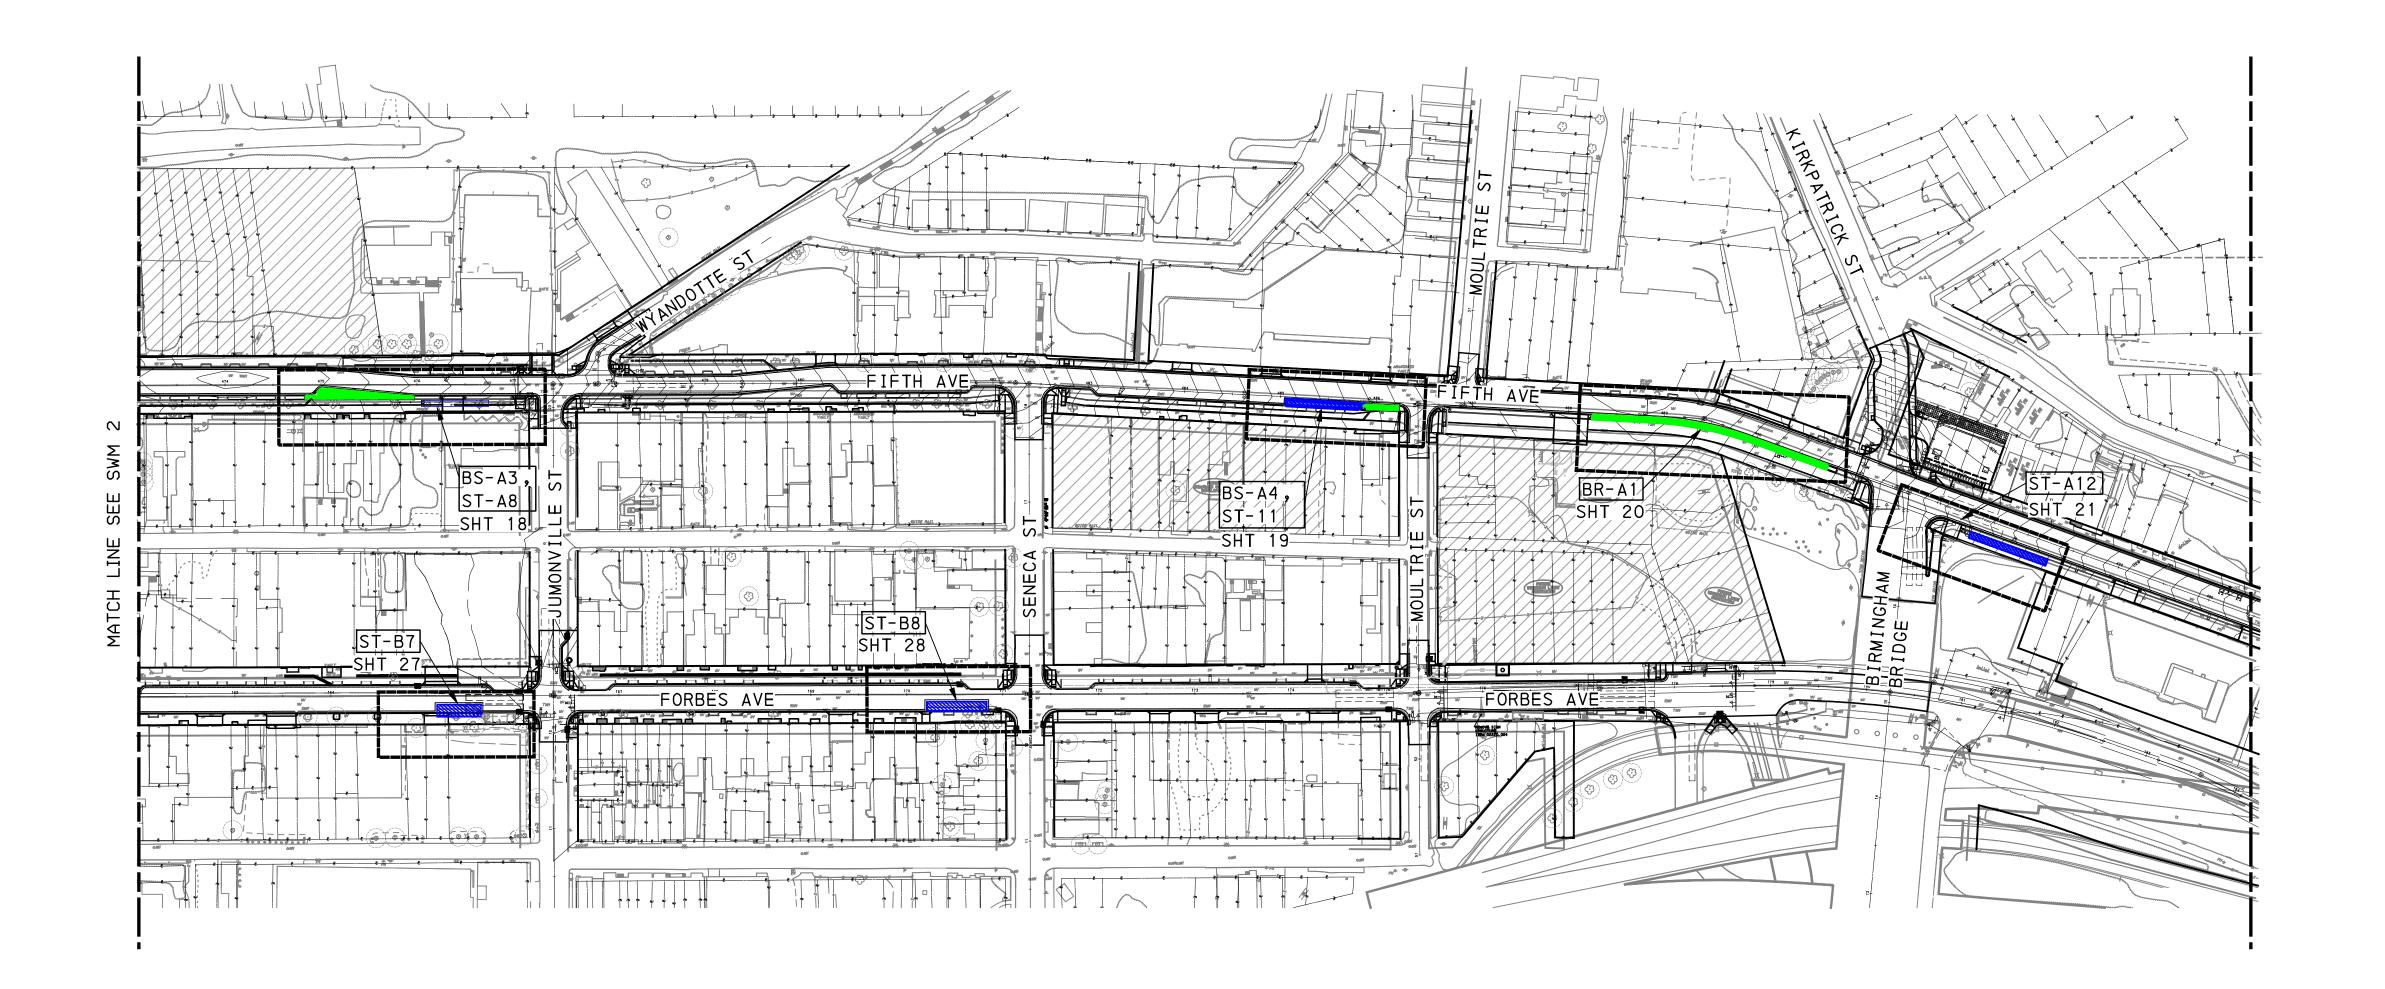

FORBES AVE AND SCHENLEY DRIVE IN OAKLAND
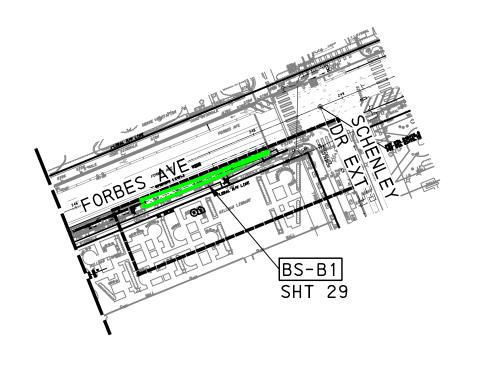
<u>LEGEND</u> DRAINAGE STRUCTURE IDENTIFICATION DRAINAGE STRUCTURE GI CONTROL STRUCTURE WITH WEIR GI STORAGE TRENCH (ST) GI BIORETENTION (BR)
OR BIOSWALE (BS) GEOMEMBRANE ROOT INTRUSION BARRIER (SIDE FACING TREE PITS) PROPOSED TREE (SEE LANDSCAPE PLANS) ROADWAY DRAINAGE PIPE, TYP. REFER TO ROADWAY PLANS FOR MORE INFORMATION 2'X2' PRECAST CONCRETE INLET SOLID GI PIPE (SIZE PER PLAN) PERFORATED GI PIPE (SIZE PER PLAN) VERTICAL BEND ON GID DISTRIBUTION / UNDERDRAIN PIPE ANTI-SEEP COLLAR ON GI DISTRIBUTION / UNDERDRAIN PIPE CHAMBER OBSERVATION 200 FEET CLEANOUT 0

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SEE BRT PLAN SET FOR ROADWAY DRAWINGS PORT AUTHORITY OF ALLEGHENY COUNTY PENNSYLVANIA


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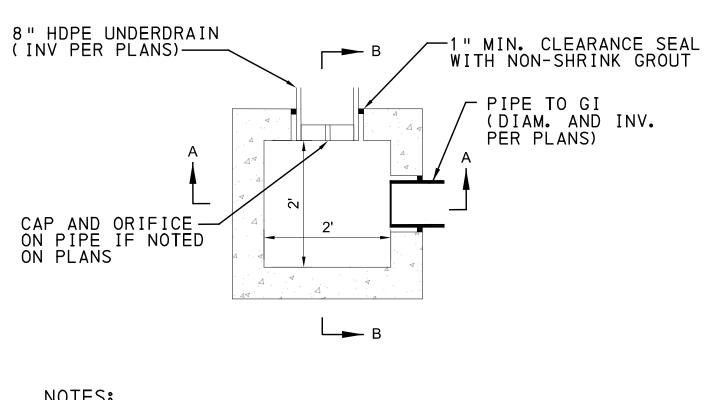
BUS RAPID TRANSIT UPTOWN TO OAKLAND STORMWATER MANAGEMENT PLANS KEY PLAN

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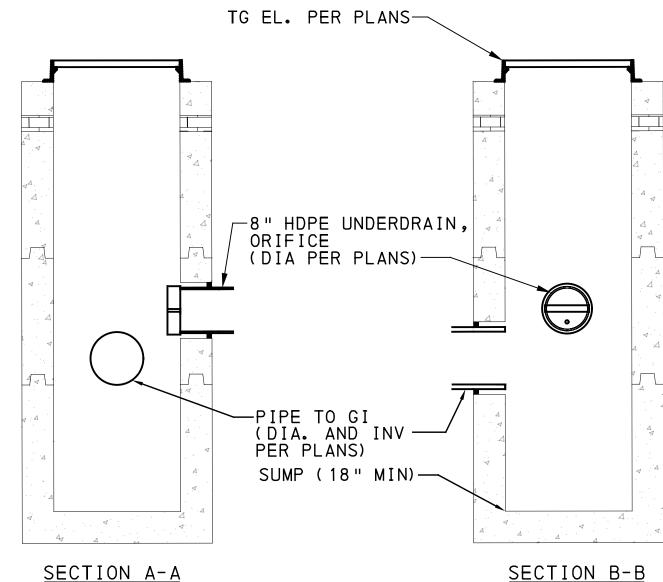
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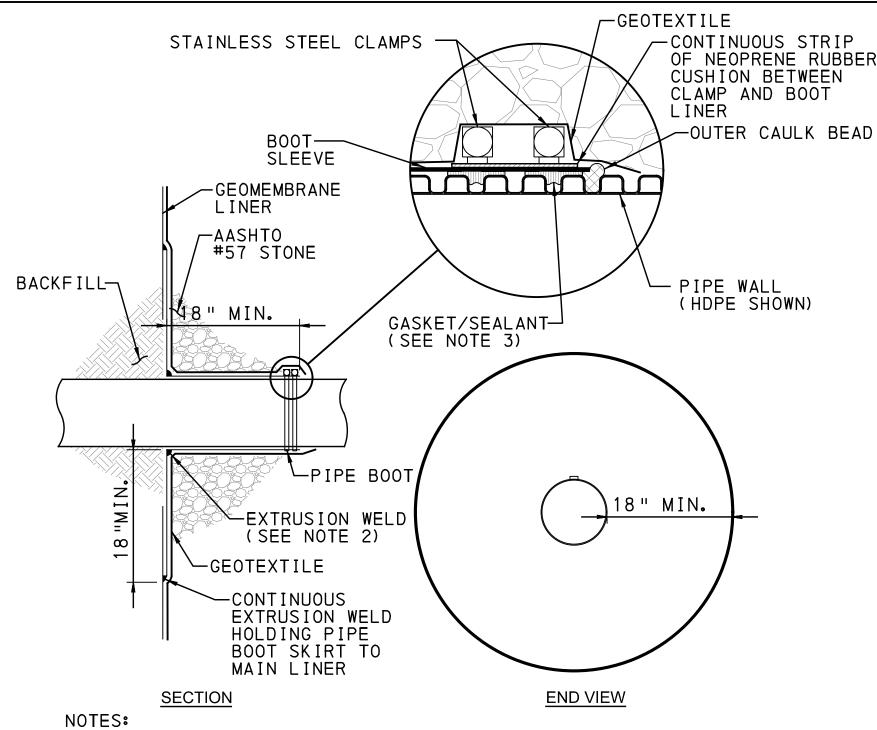
1. 2'X2' JUNCTION BOX WITH LOCKABLE STEEL FRAME AND HS-20 COVER OR GRATE; SEE PLANS AND SPECIFICATIONS. 2. INLET / OUTLET PIPES TO BE LOCATED AS INDICATED ON 3. TOTAL EXTENSION OF PIPE AND CAP ASSEMBLY INTO INLET TO BE 0'-3" FROM INLET WALL TO END OF CAP



2'X 2' PRECAST CONCRETE INLET

NOT TO SCALE

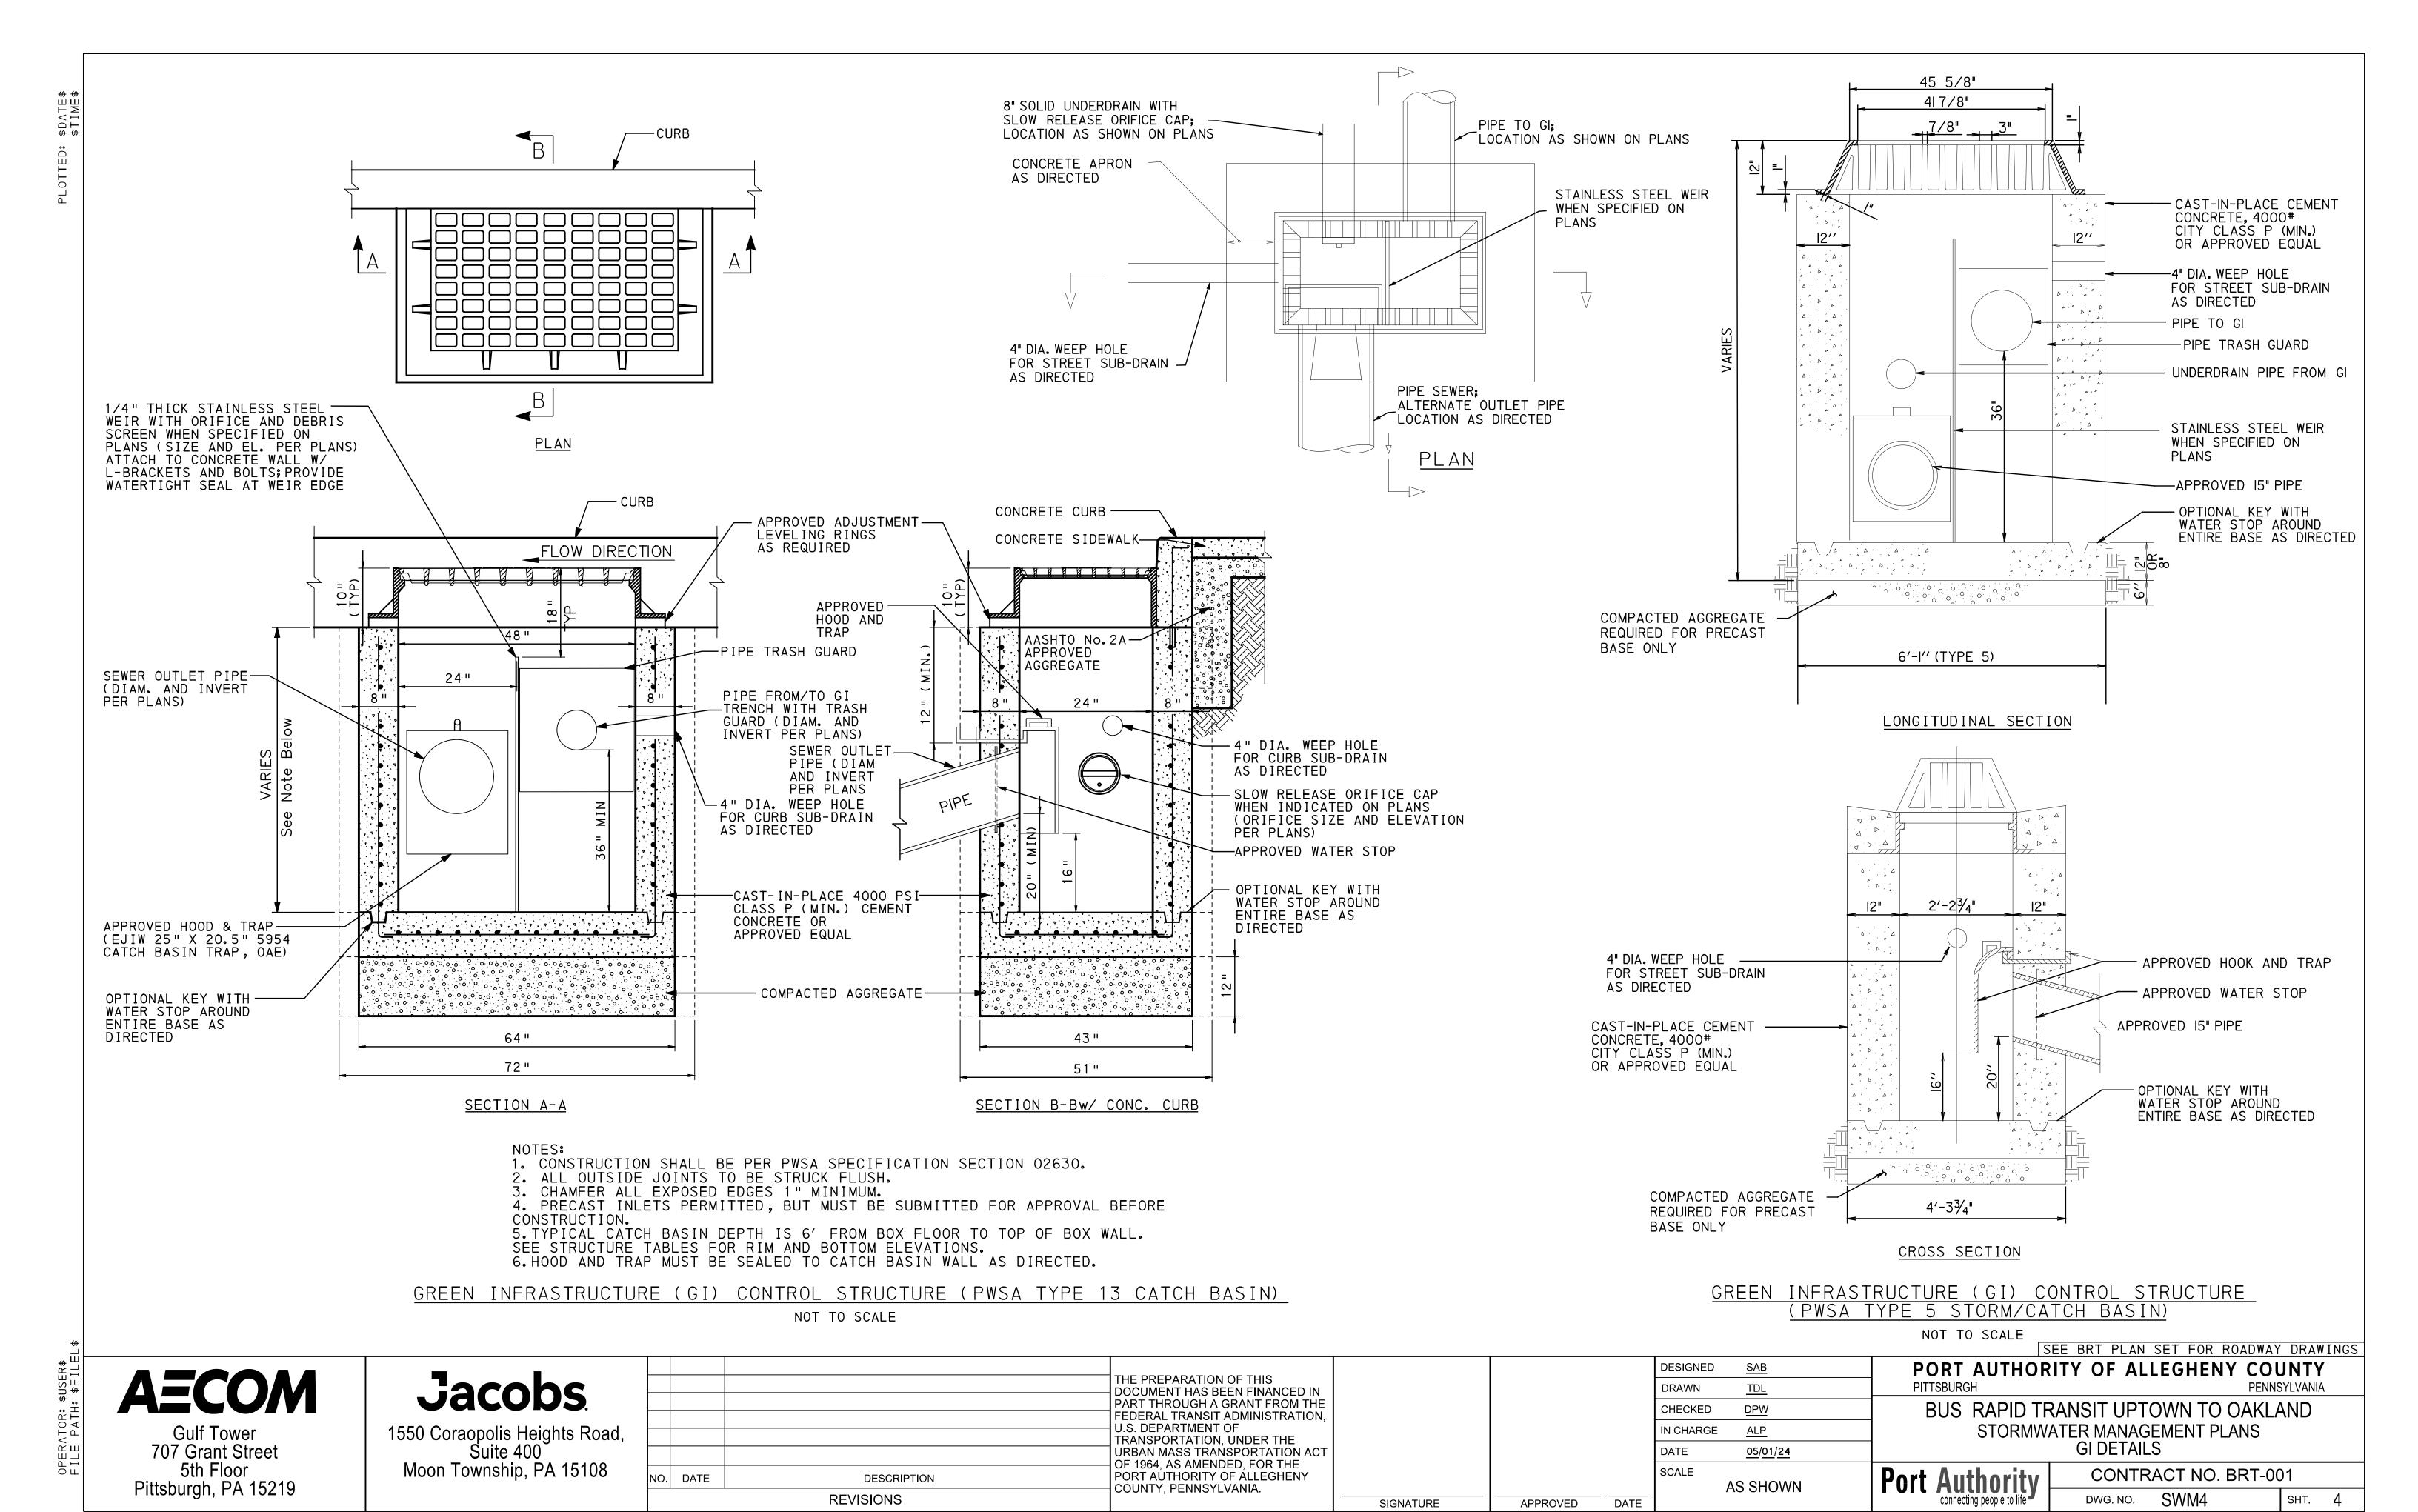
-DUAL WALL CLEANOUT SIZED AS REQUIRED FOR PIPE SIZES THREADED END PLUG WITH RECESSED -DRILL SLOW HANDLE RELEASE ORIFICE WHEN SPECIFIED ON PLANS (DIAMETER 0.5" UNLESS OTHERWIŚE NOTED) PIPE INVERT




1. THIS DETAIL APPLIES TO ALL PIPE PENETRATIONS THROUGH GEOMEMBRANE LINER. SEE PLANS FOR LOCATION, PIPE SIZE, PIPE MATERIAL, AND PIPE 2. WELD CONNECTING PIPE BOOT TO SKIRT NOT NECESSARY IF PREFABRICATED. 3. FOR CORRUGATED PIPE, INSERT PIPE ADAPTERS TO CREATE SMOOTH SURFACE FOR CLAMPS.

GEOMEMBRANE PIPE PENETRATION


NOT TO SCALE

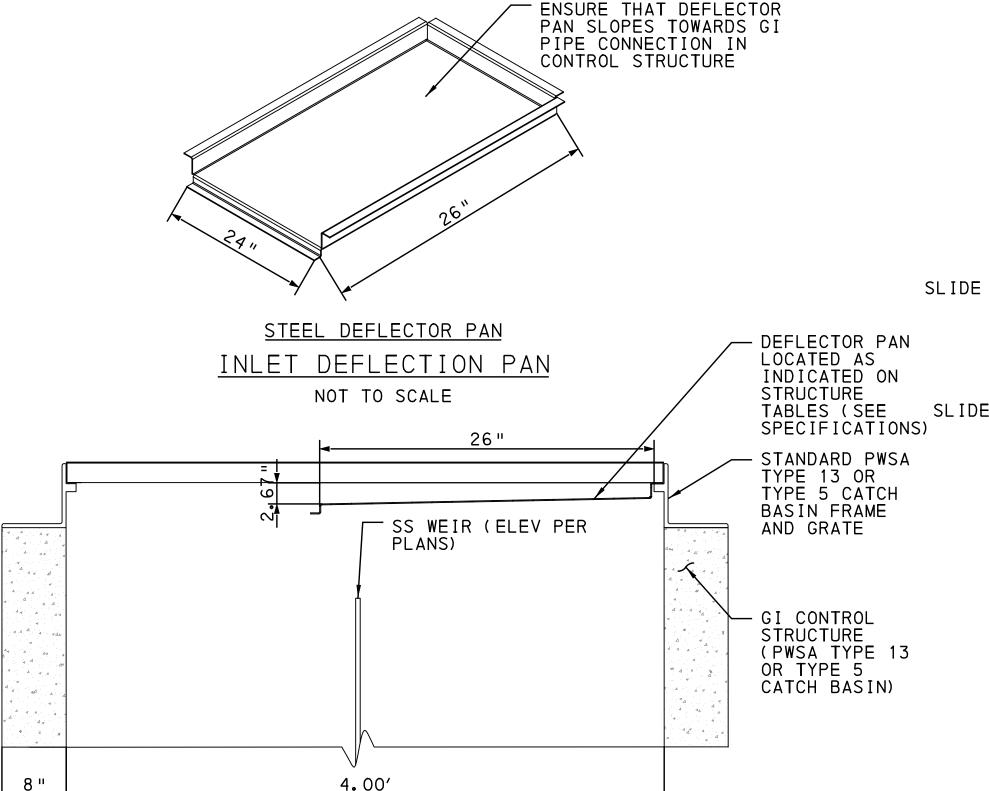

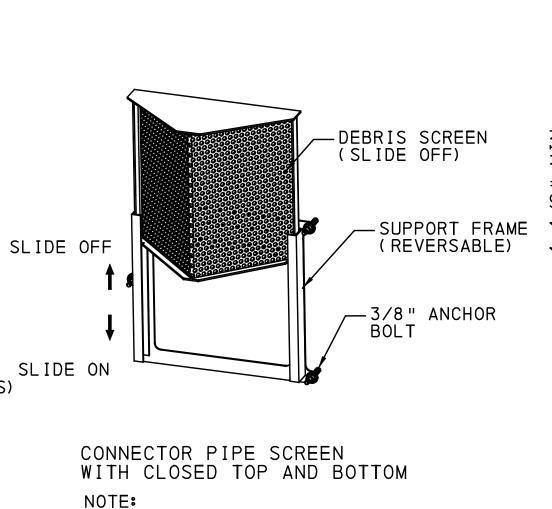

TRASH GUARD TO BE SIZED TO FIT OVER DISTRIBUTION PIPES, SEE PLANS FOR PIPE SIZE (VARY FROM 6" TO 12" DIAM)

> PIPE TRASH GUARD NOT TO SCALE

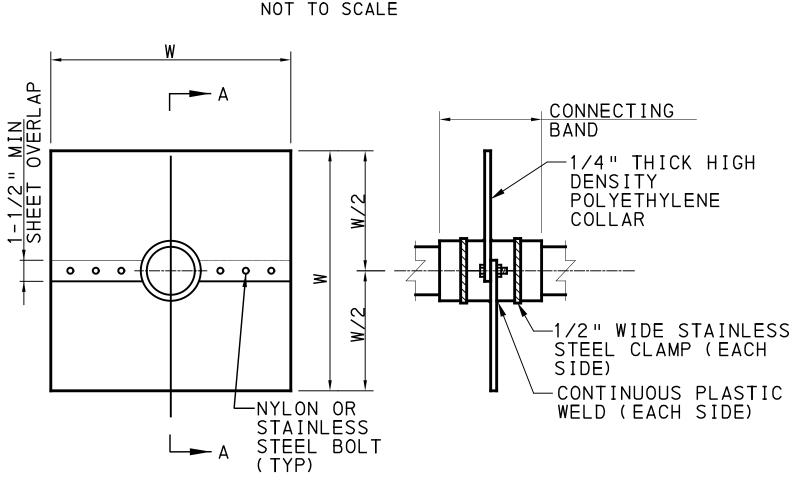

SLOW RELEASE ORIFICE CAP

<u>UPSTREAM ELEVATION</u>

SECTION A-A

DATE

APPROVED

NOTES

- DIMENSION "W" SHALL BE THREE TIMES THE DIAMETER OF THE INTERSECTING PIPE.
- CONNECTING BAND SHALL BE SEALED AT BOTH
- ENDS WITH NON-SHRINK GROUT.


 COLLAR MATERIAL SHALL BE RIGID POLYETHYLENE
- SHEET MATERIAL.
- STAINLESS STEEL SHALL BE GRADE 304 OR

SIGNATURE

AS MANUFACTURED BY LANE ENTERPRISES, OR APPROVED EQUAL. TO BE INSTALLED PER MANUFACTURERS RECOMMENDATIONS.

ANTI-SEEP COLLAR

NOT TO SCALE

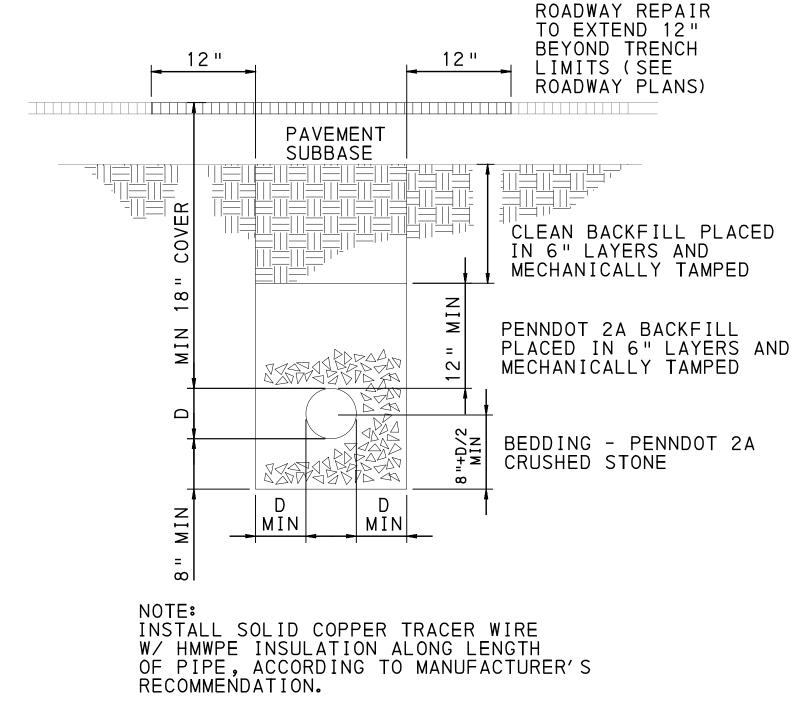

SOLID STORM PIPE TRENCHING

(UNDER PAVEMENT)

NOT TO SCALE

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<u>PLAN</u>

SECTION VIEW IN GI CONTROL STRUCTURE


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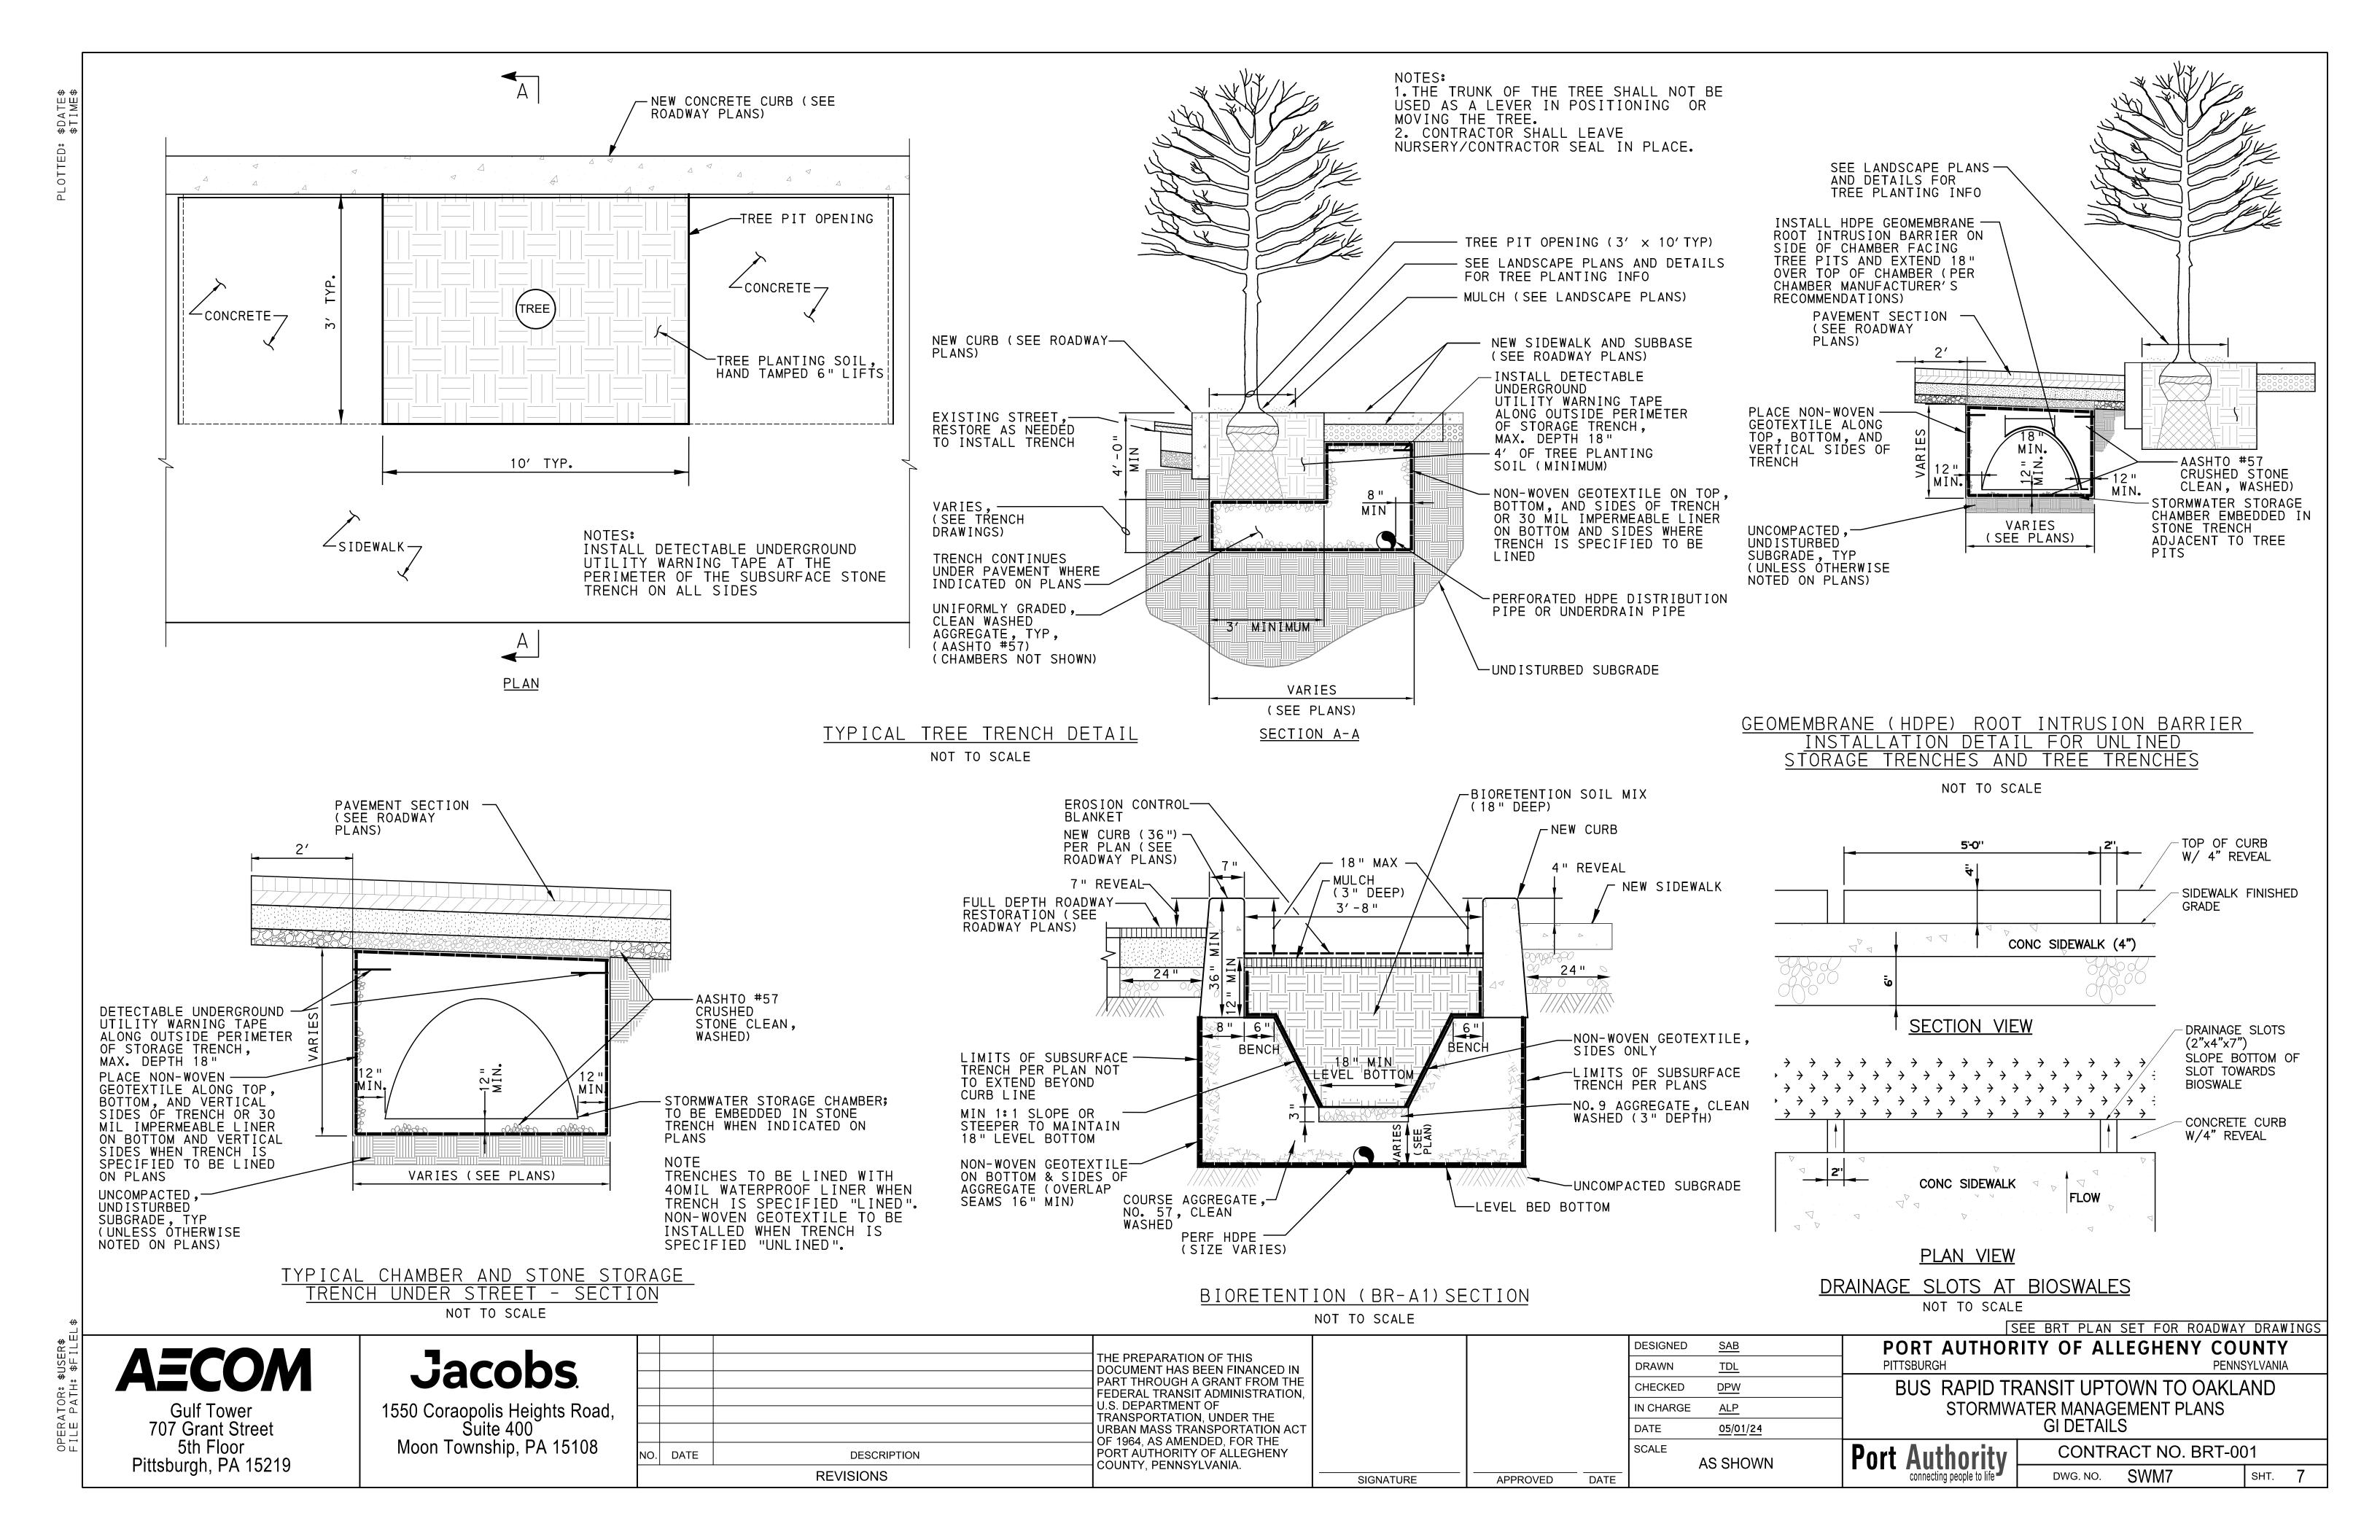
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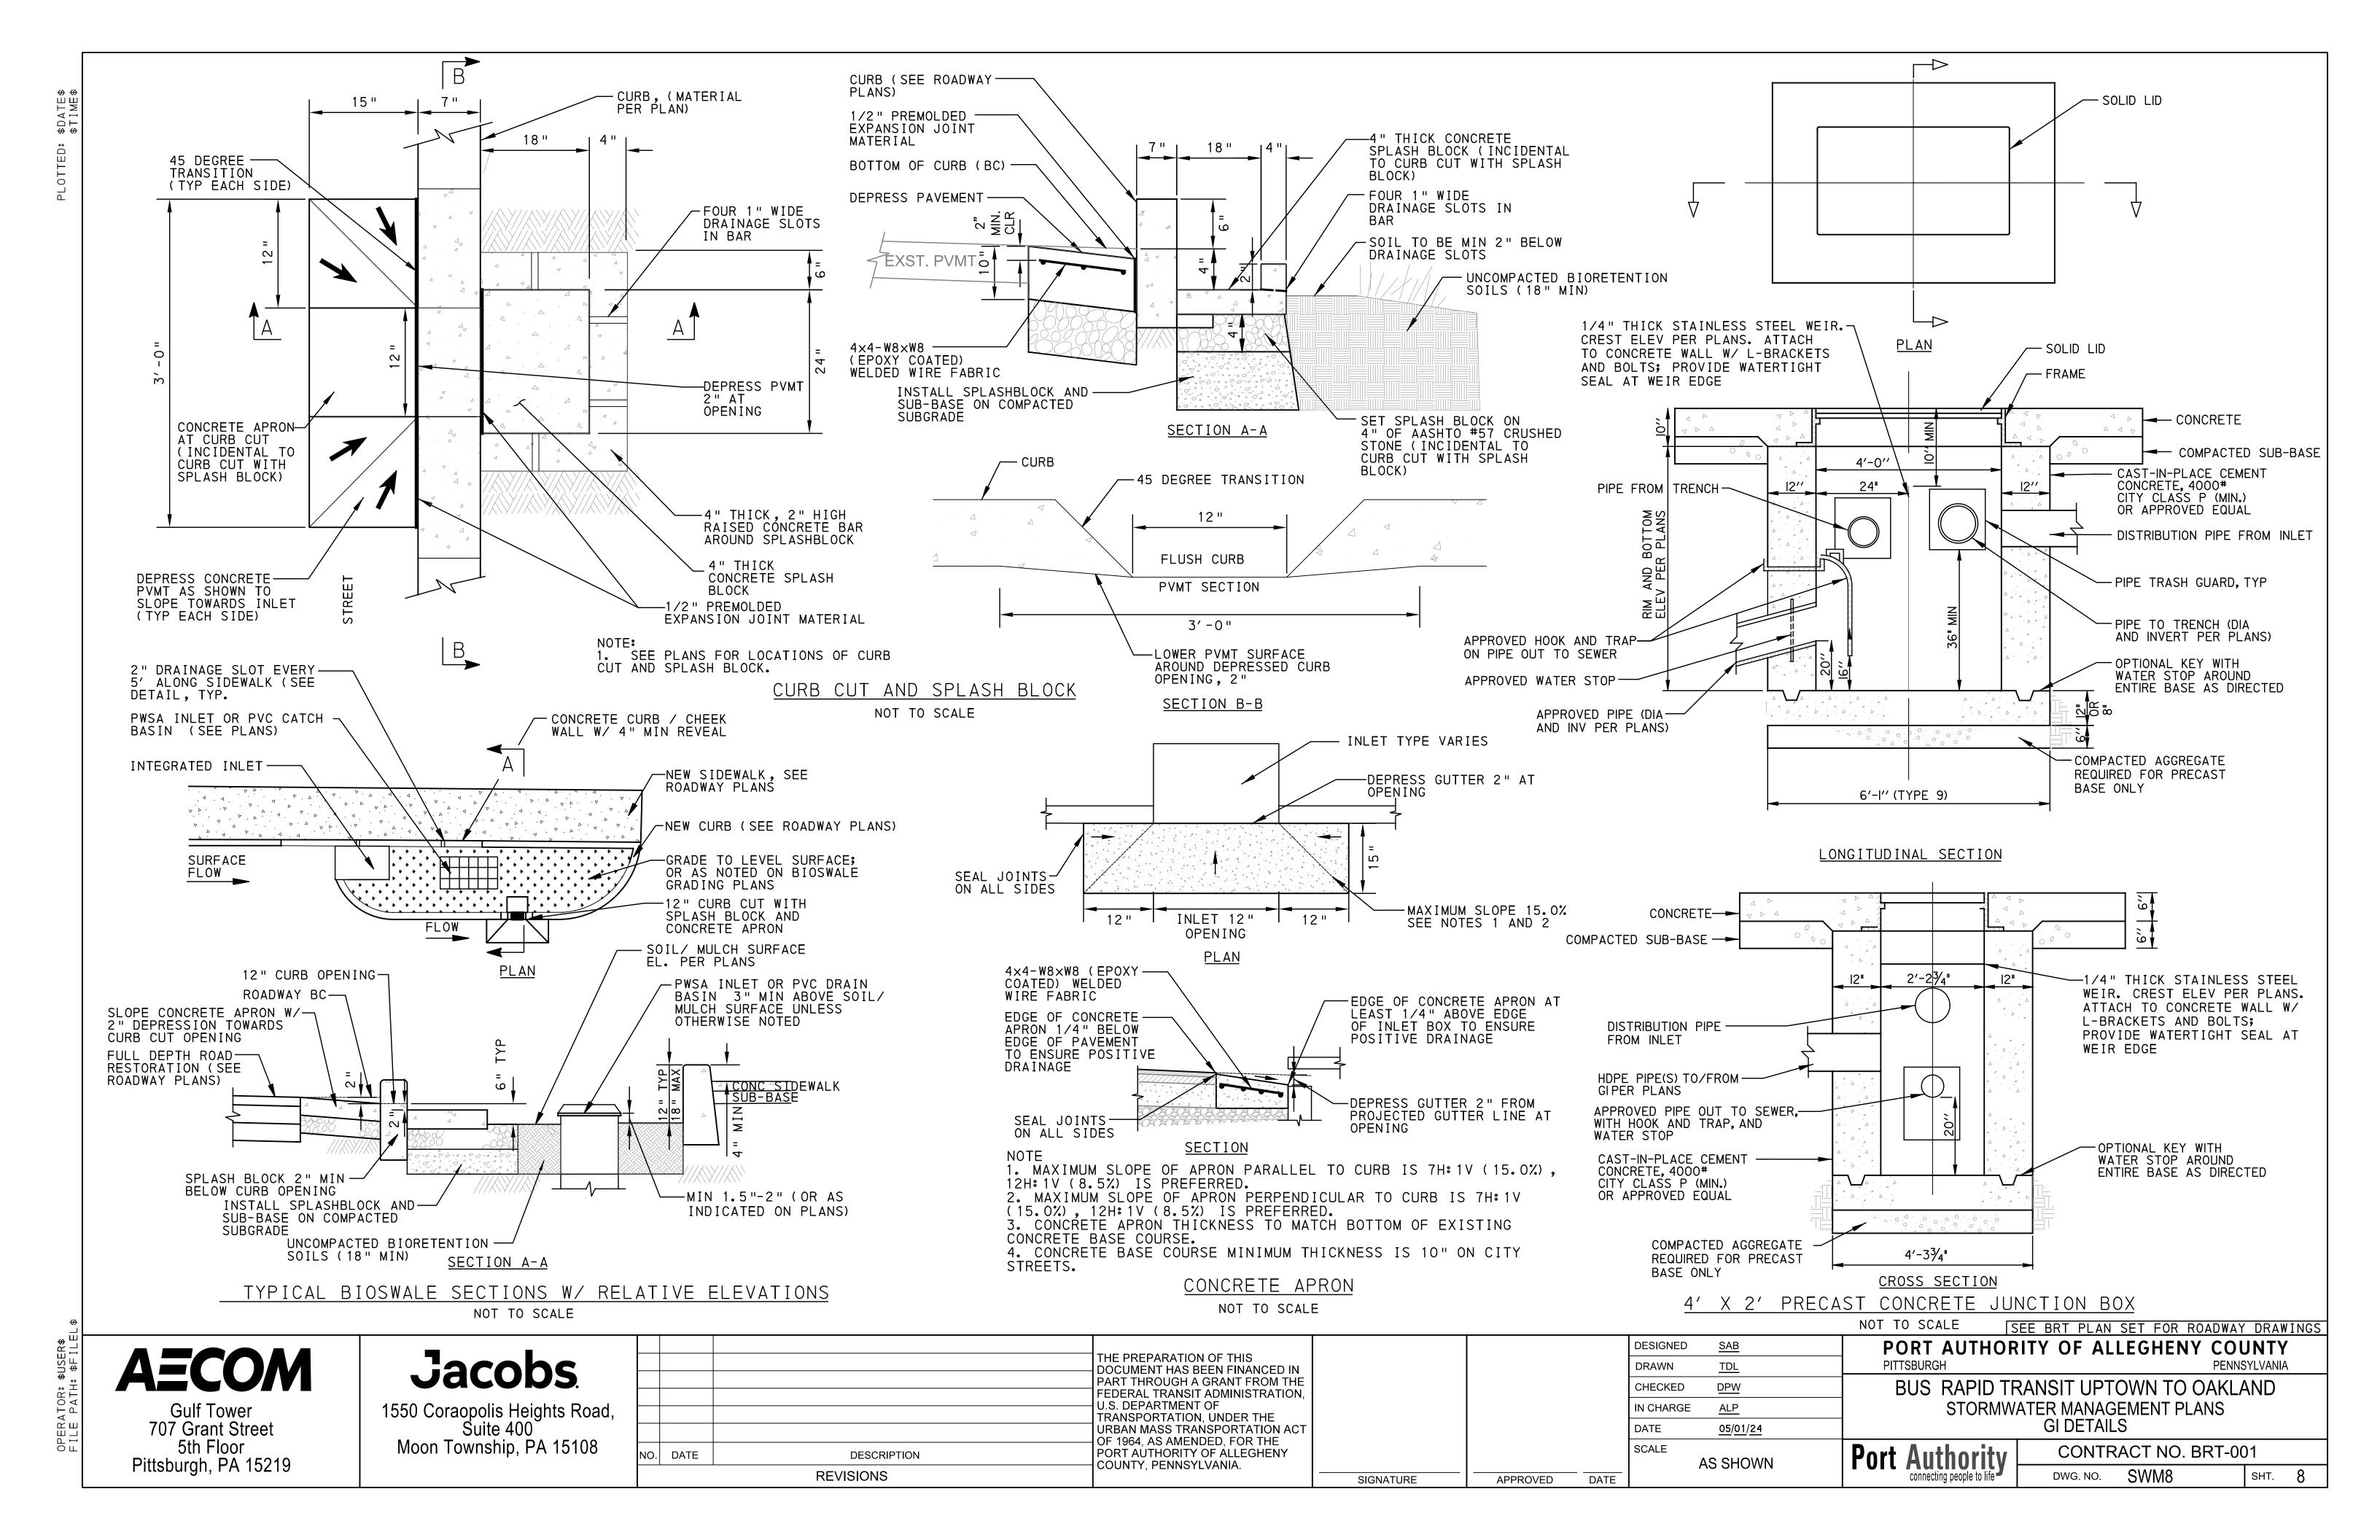
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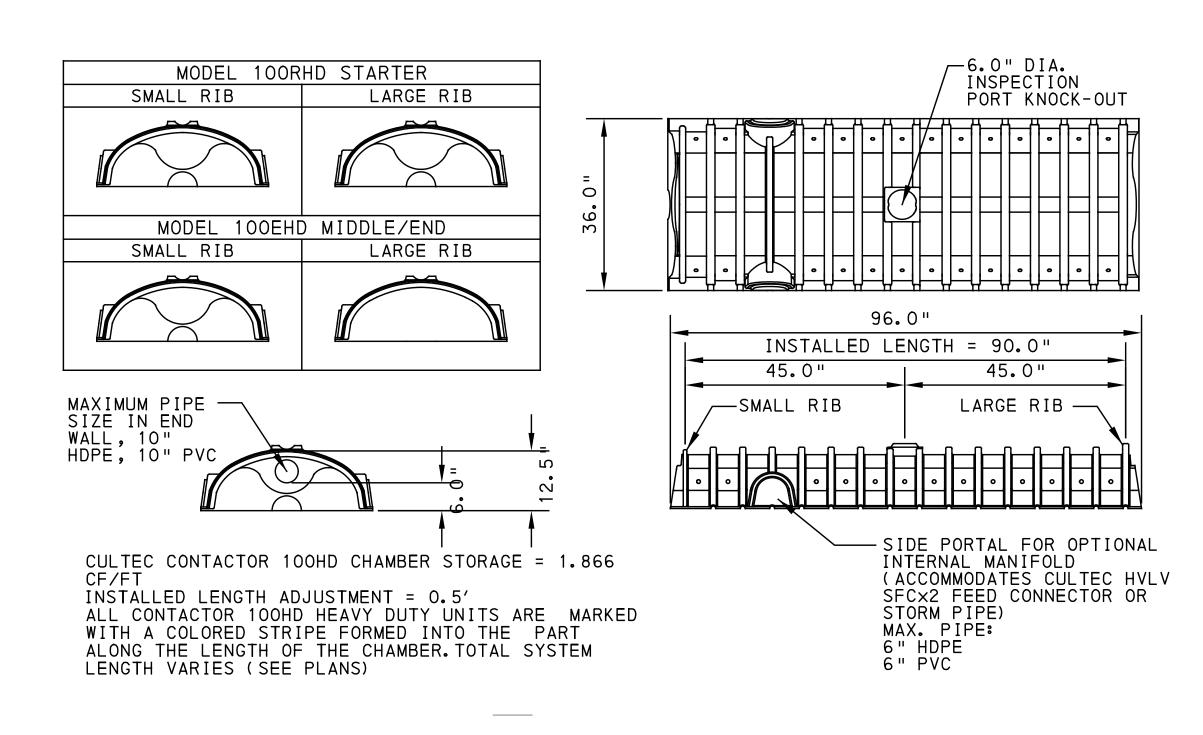
SEE BRT PLAN SET FOR ROADWAY DRAWINGS PORT AUTHORITY OF ALLEGHENY COUNTY **PITTSBURGH PENNSYLVANIA** BUS RAPID TRANSIT UPTOWN TO OAKLAND STORMWATER MANAGEMENT PLANS GI DETAILS

CONTRACT NO. BRT-001 SWM5 SHT. 5 DWG. NO.








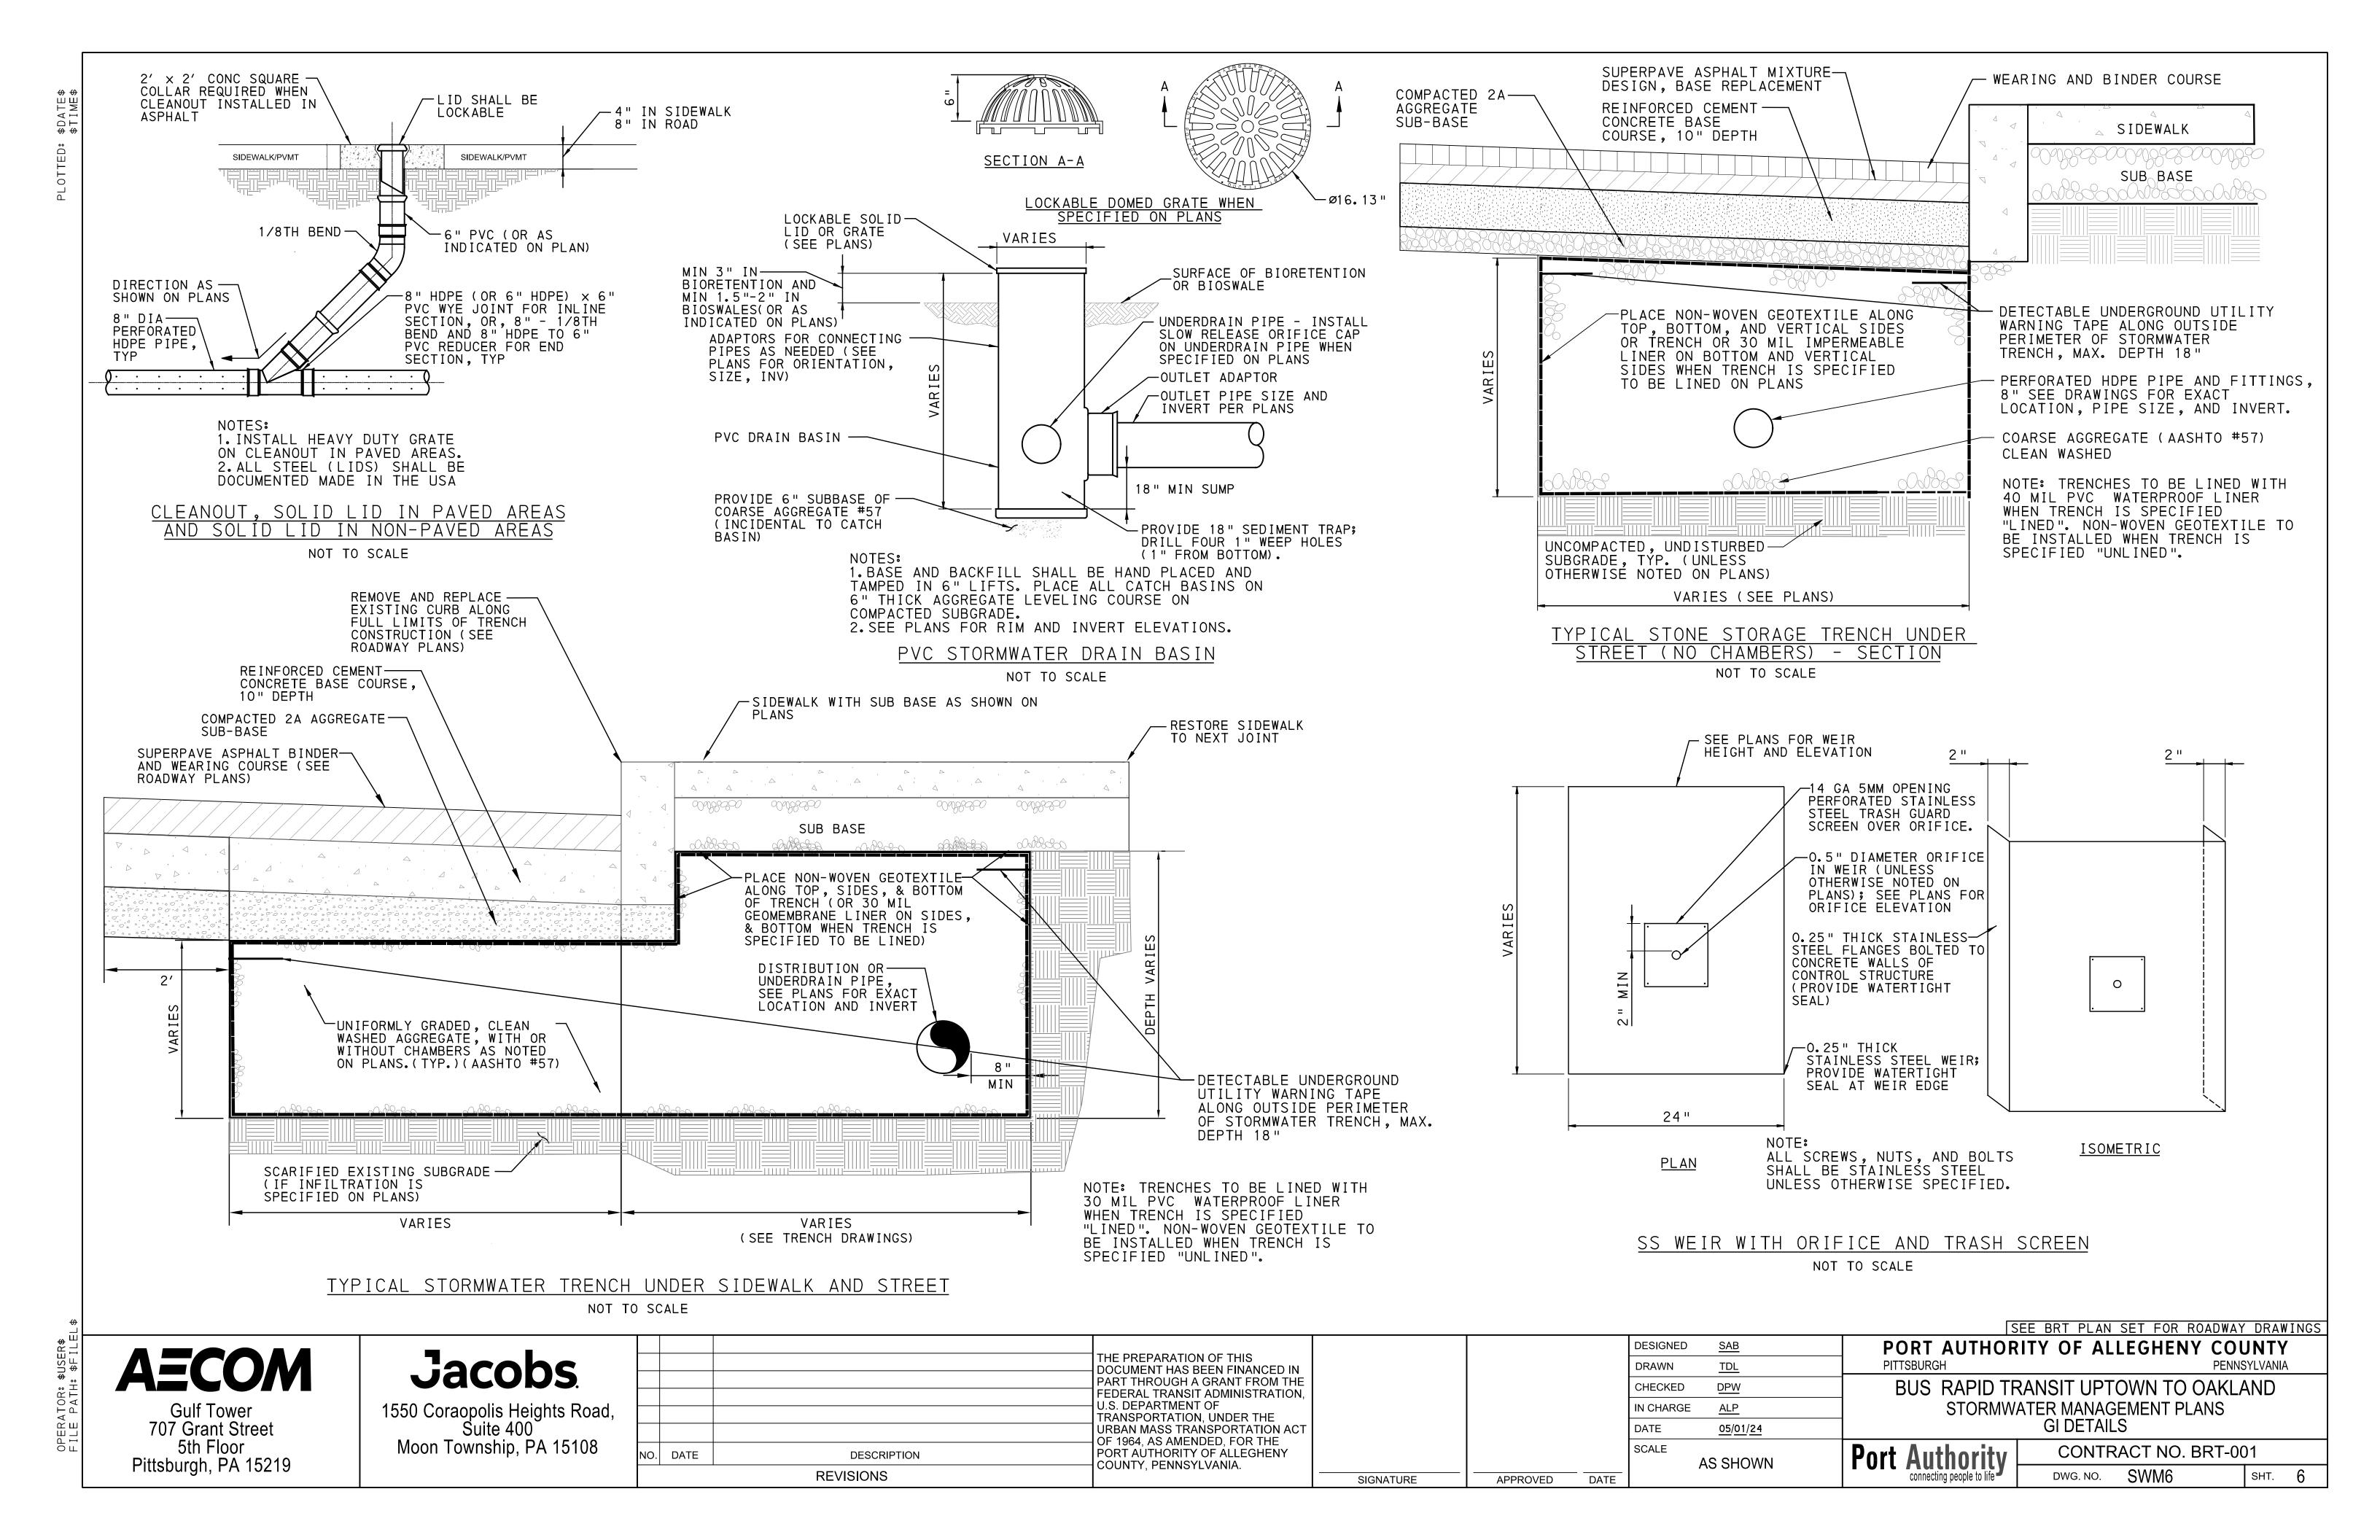

12" HEAVY DUTY CHAMBER UNIT THREE VIEW (CULTEC CONTACTOR 100HD, OAE) NOT TO SCALE

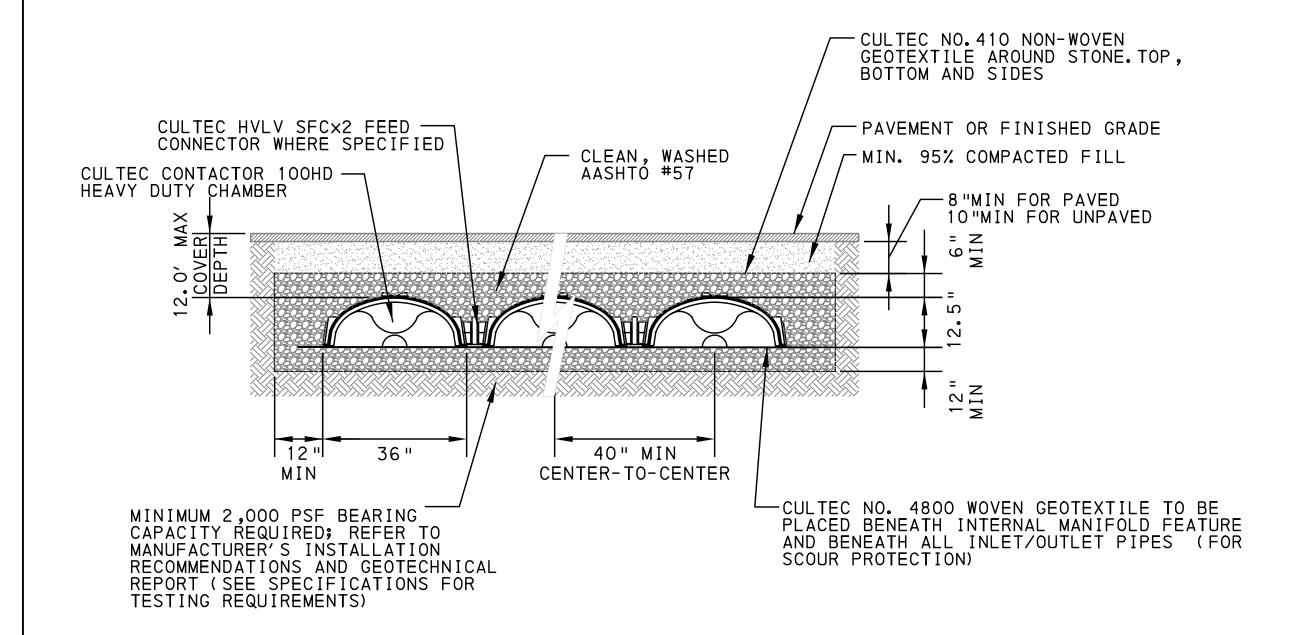

12" HEAVY DUTY CHAMBER UNIT SYSTEM CROSS SECTION (CULTEC CONTACTOR 100HD, OAE)

NOT TO SCALE

CHAMBER SYSTEM NOTES: INDIVIDUAL SYSTEMS MAY BE DESIGNED WITH SINGLE OR MULTIPLE ROWS OF CHAMBERS. WHEN TRENCH IS SPECIFIED AS "LINED, TRENCH SLOW RELEASE SYSTEMS SHALL BE COMPLETELY WRAPPED IN IMPERMEABLE MEMBRANE.
TOP AND SIDES OF CHAMBERS TO BE LINED WITH HDPE GEOMEMBRANE ROOT-INTRUSION

BARRIER IN TREE TRENCHES AS SPECIFIED ON PLANS. SEE DETAIL ON DWG SWM7

MODEL 150XLRHD STAND ALONE

MODEL 150XLSHD STARTER

MODEL 150XLIHD INTERMEDIATE

MODEL 150XLEHD END

CULTEC RECHARGER 150XLHD CHAMBER

INSTALLED LENGTH ADJUSTMENT = 0.75' TOTAL SYSTEM LENGTH VARIES (SEE PLANS)

LARGE RIB

LARGE RIB

LARGE RIB

LARGE RIB

SMALL RIB

SMALL RIB

SMALL RIB

SMALL RIB


STORAGE = 2.65 CF/FT

18" HEAVY DUTY CHAMBER UNIT THREE VIEW (CULTEC RECHARGER 150XLHD, OAE) NOT TO SCALE

MAXIMUM PIPE SIZE

IN END WALL:

15" PVC

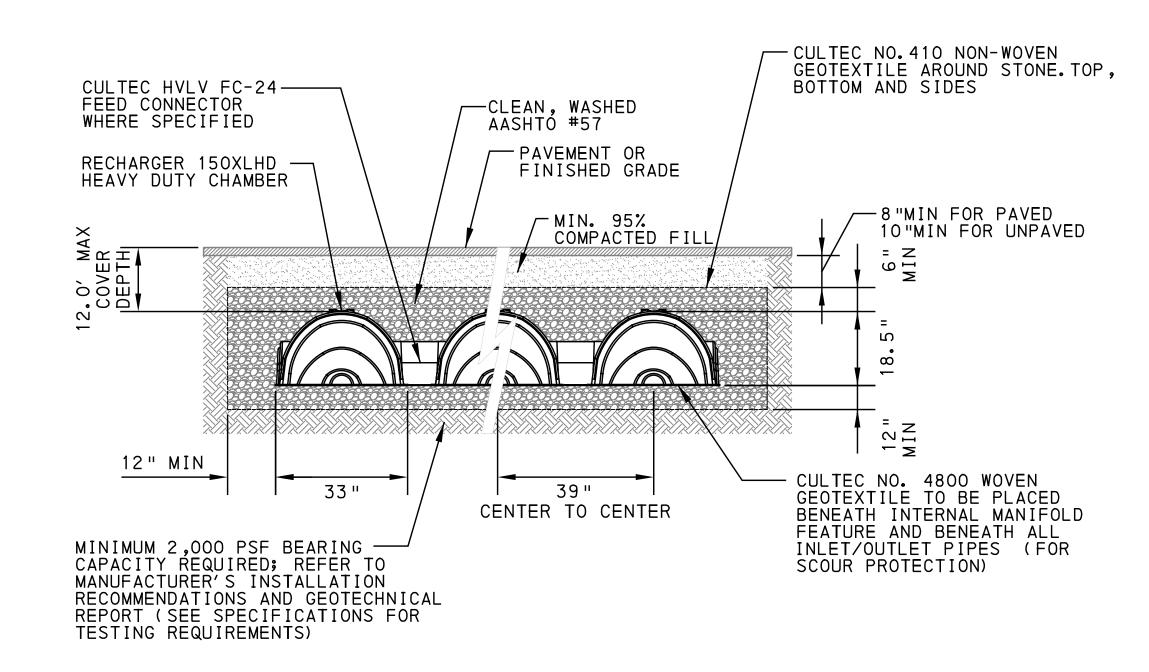

18" HEAVY DUTY CHAMBER UNIT SYSTEM CROSS SECTION (CULTEC RECHARGER 150XLHD, OAE)

NOT TO SCALE

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	REVISIONS	COUNTY, PENNSYLVANIA.

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<u>SAB</u> TDL <u>DPW</u> <u>ALP</u> <u>05/01/24</u>

132 "

INSTALLED LENGTH = 123"

ထံ

20.5"

62.5"

SMALL RIB

PORT KNOCK-OUT

59.5"

INTERNAL MANIFOLD (ACCOMMODATES CULTEC

HVLV FC-24 FEED

MAX. PIPE:

10" HDPE

10" PVC

LARGE RIB —

SIDE PORTAL FOR OPTIONAL

CONNECTOR OR STORM PIPE)

SEE BRT PLAN SET FOR ROADWAY DRAWINGS PORT AUTHORITY OF ALLEGHENY COUNTY **PENNSYLVANIA**


PITTSBURGH BUS RAPID TRANSIT UPTOWN TO OAKLAND STORMWATER MANAGEMENT PLANS GI DETAILS

CONTRACT NO. BRT-001 SWM9 DWG. NO.

SIGNATURE

AS SHOWN

SHT. 9

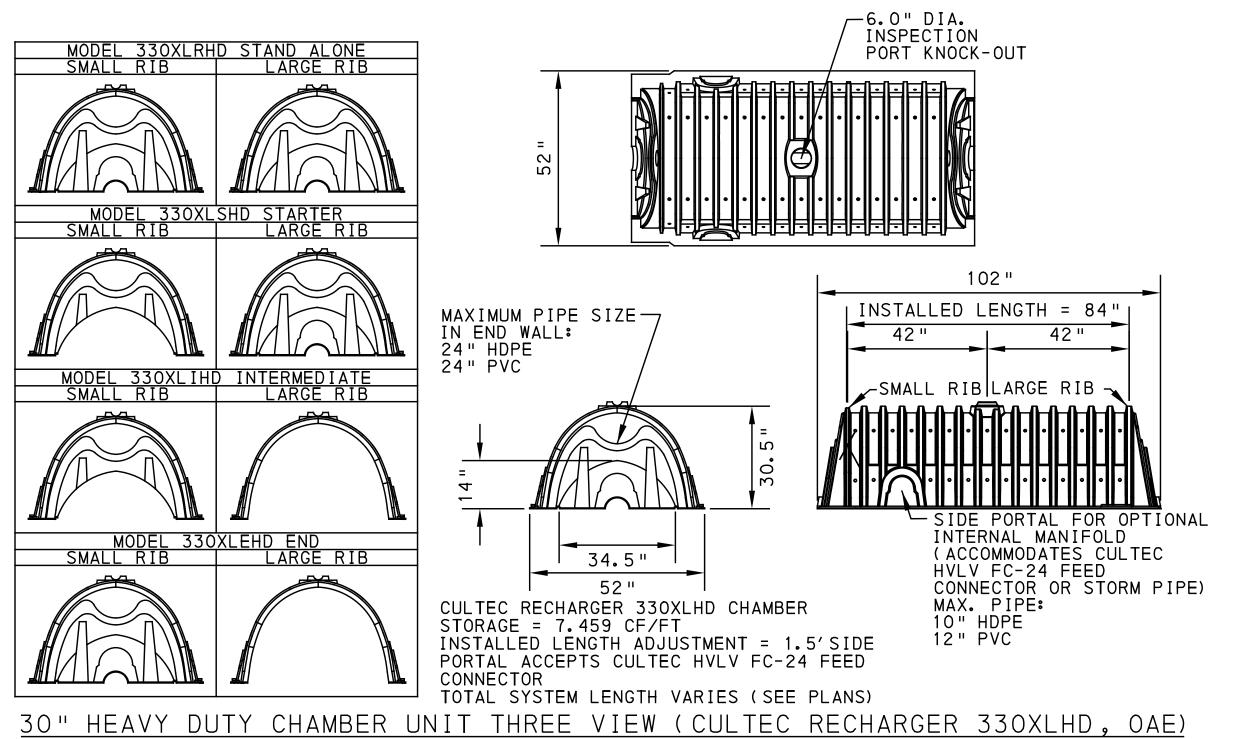

NOT TO SCALE

- AASHTO HS-25 RATED CAST IRON FRAME AND SOLID COVER - FIELD PLACED CLASS FIELD PLACED CLASS -"C" CONCRETE COLLAR 24" MIN "C" CONCRETE COLLAR (OPTION 1) 1.50" (OPTION 2) FLUSH | 13**.**5"| BELOW PAVEMENT WITH PAVEMENT - PAVEMENT OR FINISHED PAVEMENT OR — FINISHED GRADE 12" X 6" CULTEC INLINE DRAIN / CLEAN-OUT BASIN w/ GASKETED SDR-35 CONNECTION 6" PVC SCREW-IN CAP MIN. 95% -COMPACTED GRANULAR FILL -6" SDR-35 RISER (LENGTH VARIES) 6.25" HOLE TO BE CUT w/ HOLE SAW CENTERED 6" SDR-35 BELL END CUT ON CORRUGATION CREST FOR 6" OF INSERTED PIPE


> PAVEMENT FINISH OPTIONS: OPTION 1 - ASPHALT PAVEMENT (ROAD/BIKE LANE) OPTION 2 - CONCRETE PAVEMENT (SIDEWALK)


CHAMBER SYSTEM INSPECTION PORT -ZOOM DETAIL NOT TO SCALE

-PIPE SIZE AND ELEVATION AS SPECIFIED. THE USE OF THE MAX. PIPE SIZE PER CHAMBER MODEL IS RECOMMENDED. — PAVEMENT OR FINISHED GRADE · INSPECTION PORT (SEE PLANS FOR LOCATIONS ┌─1-2 INCH WASHED, CRUSHED STONE -CULTEC 410 NON-WOVEN GEOTEXTILE AROUND STONE. TOP, BOTTOM AND -MINIMUM 95% COMPACTED FILL -INLET CULTEC HEAVY-DUTY CHAMBER IN STRUCTURE SEPARATOR ROW CONFIGURATION 36" MIN. SUMF -- ENTIRE SEPARATOR ROW TO BE COVERED WITH CULTEC NO. 410 NON-WOVEN GEOTEXTILE - PLACE 1 LAYER OF CULTEC NO. 4800 WOVEN GEOTEXTILE (7.5- WIDE ROLL) UNDER ALL SEPARATOR ROW CHAMBERS

TYPICAL SEPARATOR ROW CONFIGURATION CROSS SECTION WITH INSPECTION PORT

NOT TO SCALE

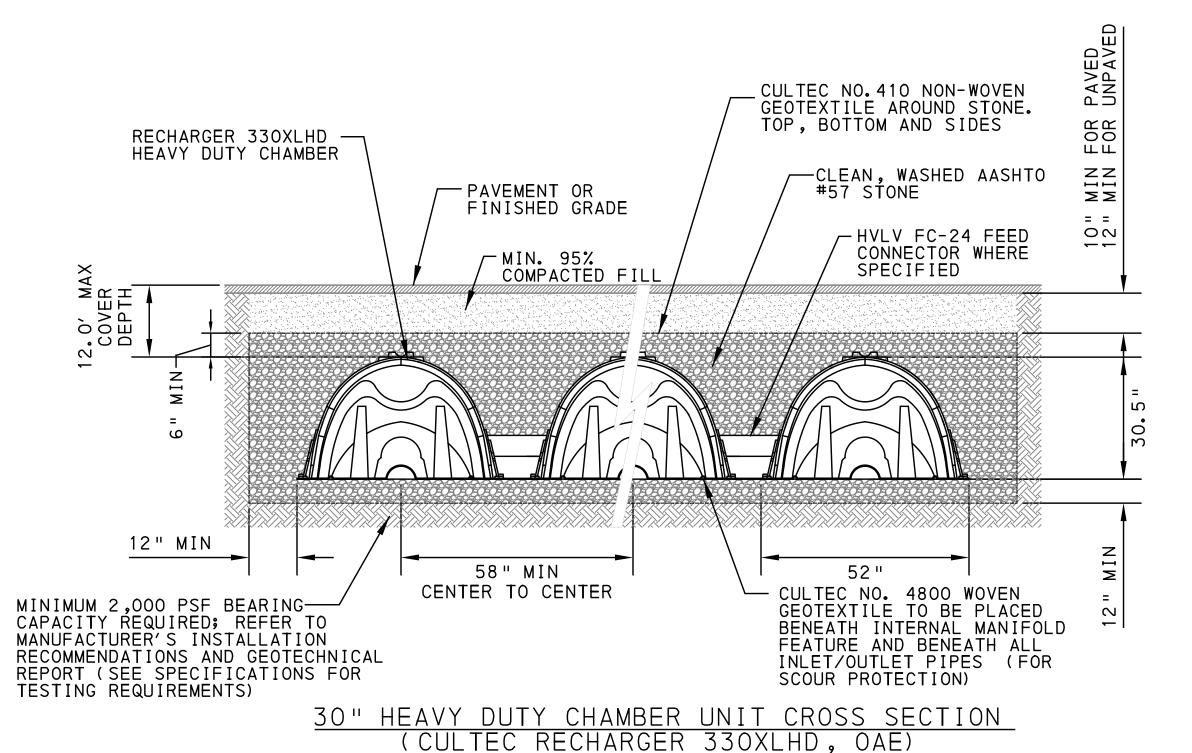

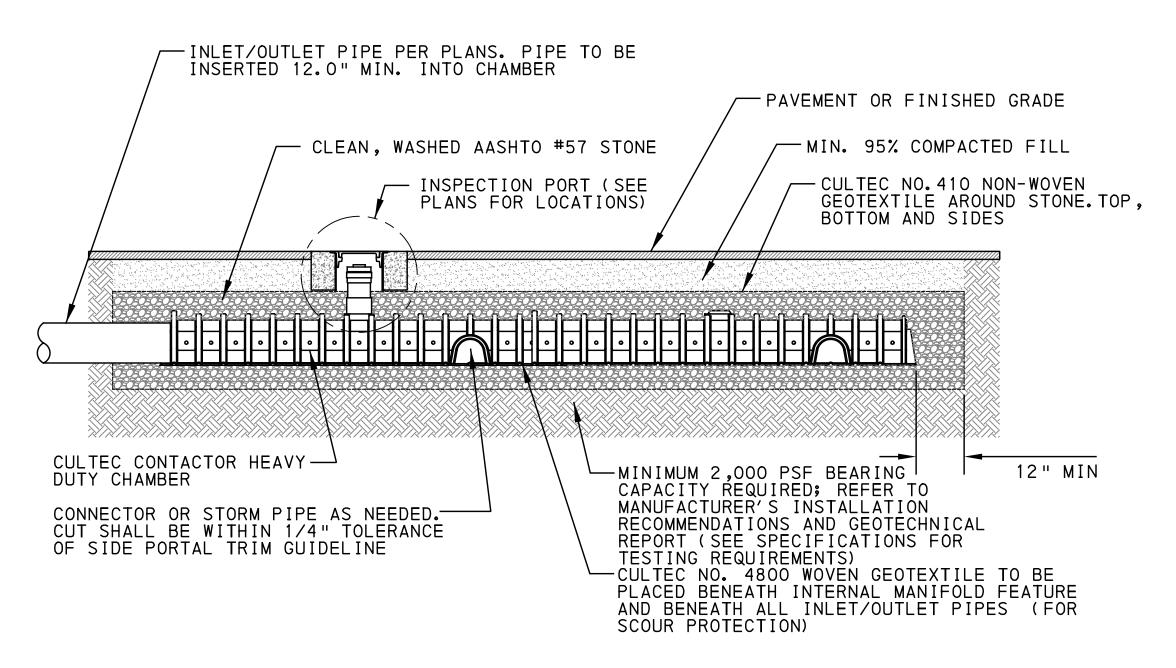

CHAMBER SYSTEM MANIFOLD - TYPICAL PROFILE

SIGNATURE

NOT TO SCALE

CHAMBER SYSTEM NOTES: INDIVIDUAL SYSTEMS MAY BE DESIGNED WITH SINGLE OR MULTIPLE ROWS OF CHAMBERS. WHEN TRENCH IS SPECIFIED AS "LINED, TRENCH SLOW RELEASE SYSTEMS SHALL BE COMPLETELY WRAPPED IN IMPERMEABLE MEMBRANE. TOP AND SIDES OF CHAMBERS TO BE LINED WITH HDPE GEOMEMBRANE ROOT-INTRUSION BARRIER IN TREE TRENCHES AS SPECIFIED ON PLANS. SEE DETAIL ON DWG SWM7.

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		U.S. DEPARTMENT OF TRANSPORTATION, UNDER THE
		URBAN MASS TRANSPORTATION ACT OF 1964, AS AMENDED, FOR THE
DATE	DESCRIPTION	PORT AUTHORITY OF ALLEGHENY COUNTY, PENNSYLVANIA.
	REVISIONS	COUNTY, PENNSTEVANIA.

	DESIGNED
	DRAWN
	CHECKED
	IN CHARGE
	DATE
	SCALE
APPROVED DATE	

PITTSBURGH TDL <u>DPW</u> <u>ALP</u> <u>05/01/24</u> AS SHOWN


SEE BRT PLAN SET FOR ROADWAY DRAWINGS PORT AUTHORITY OF ALLEGHENY COUNTY **PENNSYLVANIA**

BUS RAPID TRANSIT UPTOWN TO OAKLAND STORMWATER MANAGEMENT PLANS GI DETAILS

CONTRACT NO. BRT-001

DWG. NO.

SWM10 sнт. **10**

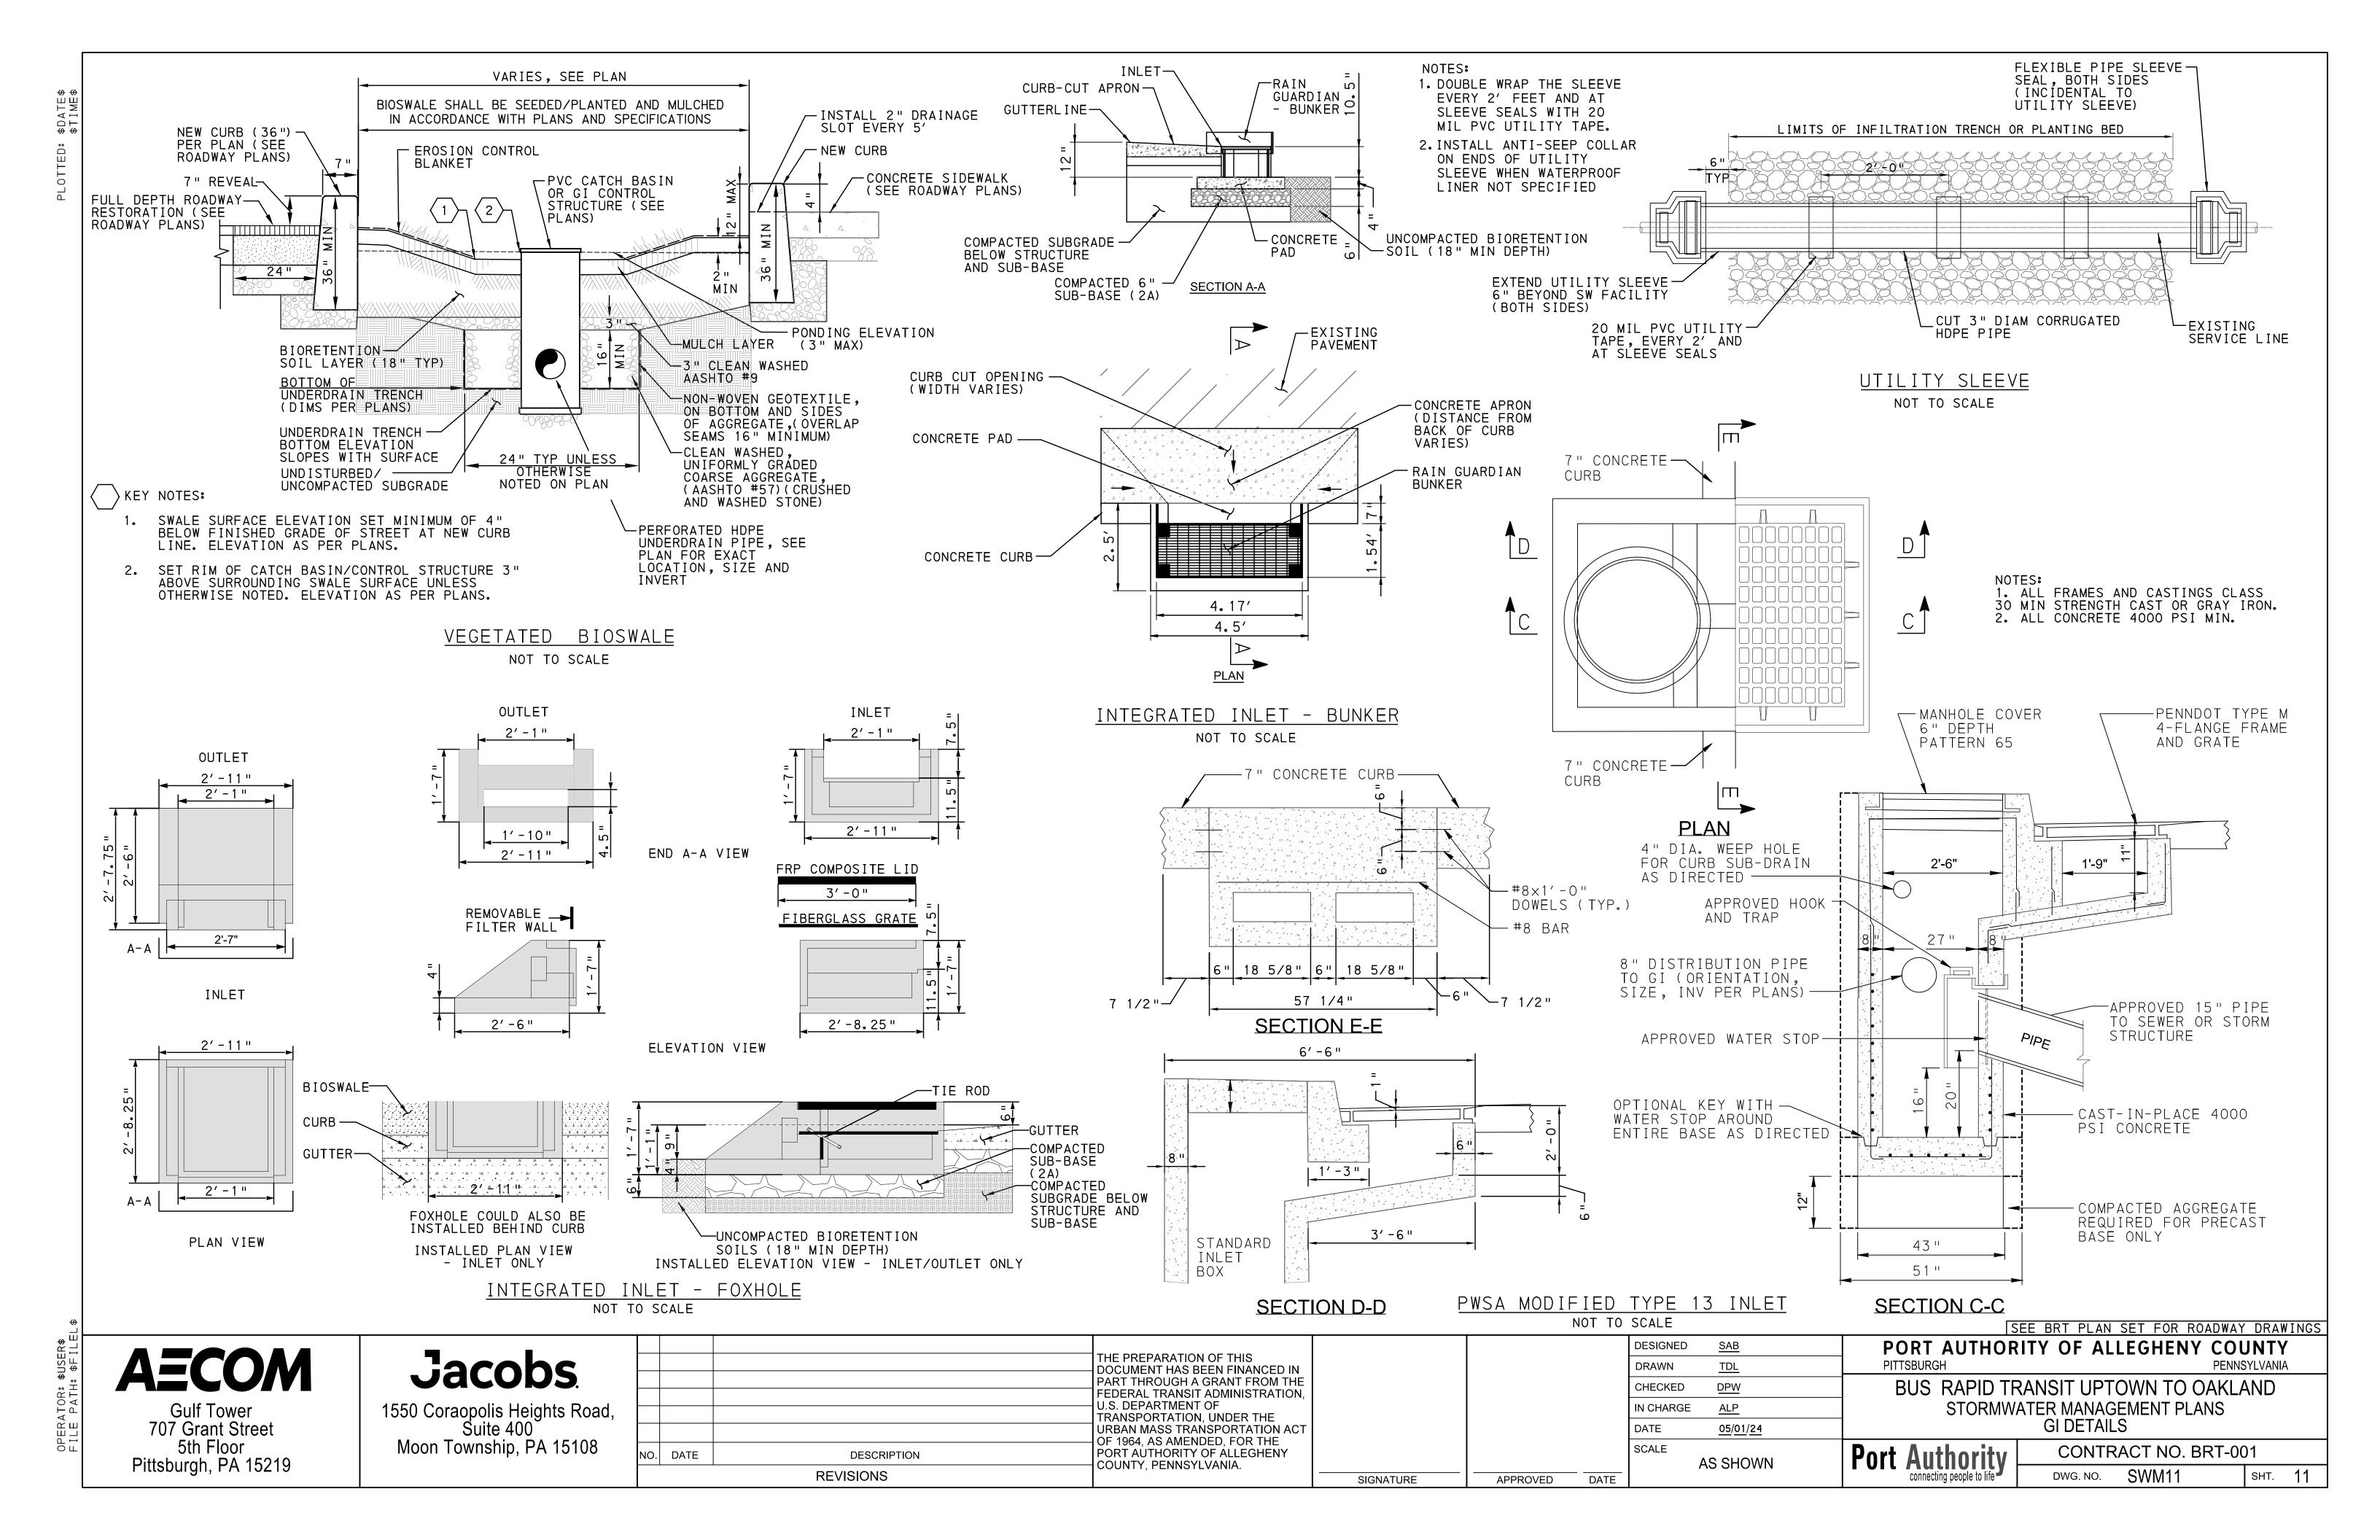

TRENCH DRAIN DETAILS NOT TO SCALE

CONNECTION. SECTION A-A

NOTES:

GASKETED JOINT -

SEALANT GEO-TAPE

1. REINFORCEMENT WILL BE EPOXY COATED.

PROVIDE FITTINGS

AS NEEDED TO MAKE

TRENCH DRAIN

~ OW

TOP OF GRATE ELEV

CENTERLINE.

-APPROVED WATERSTOP

TRENCH INV ELEV

∕8" DIA SDR-26 PVC

FLOW

- REFERENCE POINTS ON DRAINAGE

DATA CALLOUTS REPRESENT THE ENDPOINT ON THE TRENCH

-TOP OF PIPE

OPENING TO

BELOW SIDEWALK

BE 6" MIN

SUBGRADE

INV ELEV (6") OUT

AS NEEDED TO ACCOMODATE PIPE

SLOPE ON PIPE

(MIN)

ADJUST IN THE FIELD

FITTINGS, MAINTAIN 2%

(DESIRABLE) OR 0.5%

- 2. SCUPPER/DRAIN COMPONENTS WILL BE GALVANIZED.
- 3. CAST IN PLACE CONCRETE f'c = 4,000 PSI.
- 4. CONSTRUCTION JOINTS ARE TO BE PROVIDED AT INTERVALS NOT EXCEEDING 30 FEET. EXPANSION JOINTS ARE TO BE PROVIDED AT INTERVALS NOT EXCEEDING 90 FEET. WHEN EXPANSION JOINTS ARE USED, WATERSTOPS ARE REQUIRED.
- 5. PLACE BEDDING AT 12" MINIMUM DEPTH BELOW BOTTOM OF TRENCH DRAIN.
- 6. SOME TRENCHES WILL OUTLET TO CURB GUTTER INSTEAD OF AN OUTLET PIPE. IN THOSE CASES, USE SOLID COVER INSTEAD OF GRATE ON THE PORTION BETWEEN THE VALLEY OF SIDEWALK AND CURB AS DIRECTED. CUT LOWERMOST COVER STRAIGHT AND FLUSH WITH FACE OF CURB. GRIND SMOOTH.
- 7. PROVIDE CLOSED, PLAIN TEXTURED SOLID COVER AS DIRECTED WHERE TRENCH TRAVERSES FROM SIDEWALK GUTTER TO CURB.

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		DATE
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DESIGNED	<u>SAB</u>	
DRAWN	<u>TDL</u>	
CHECKED	DPW	
IN CHARGE	<u>ALP</u>	
DATE	05/01/24	
SCALE		
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SEE BRT PLAN SET FOR ROADWAY DRAWINGS PORT AUTHORITY OF ALLEGHENY COUNTY

BUS RAPID TRANSIT UPTOWN TO OAKLAND STORMWATER MANAGEMENT PLANS GI DETAILS

CONTRACT NO. BRT-001 **Port Authority** DWG. NO. SWM12 sнт. 12

8" DIA SDR-26 PVC—

TRENCH DRAIN

PLAN VIEW

APPRO

SIGNATURE

AS SHOWN

GI ID 1	GI ID 2		Structure ID	Structure Type	Station - Offset	Top Type	Rim Elevation [ft] **Refer to roadway plans	Invert Elevation out to Sewer [ft] **Refer to roadway plans	Elevation	Invert Elevation in from GI [ft]	BR/BS Underdrain Invert Elevation [ft]	Inv Elev IN from Structure [ft]	Structure Bottom Elevation [ft]	Weir Elevation [ft]	Deflection Pan (Covered side of inlet)	Slow release orifice cap (on pipe direction)	Orifice Diameter (in)	Orifice Elevation (ft)
BS-A1	ST-A1	15	A18-1	GI CONTROL STRUCTURE (TYPE 5)	457+22.92 - 9.53' RT	GRATE	**	**	811.48	810.33	812.99	N/A	808.48	813.02	Y (west)	Y (south west)	0.5	810.50
ST-A2		16	GI-A1	4' x 2' JUNCTION BOX WITH WEIR	459+31.40 - 24.33' LT	SOLID	821.40	815.17	817.28	815.34	N/A	817.32	813.51	819.32	N	N	0.5	815.51
ST-A2		16	A19-1	PWSA MODIFIED TYPE 13 INLET	30+36.33 - 18.21' LT	GRATE	**	**	818.84	N/A	N/A	N/A	815.84	N/A	N	N	N/A	N/A
ST-A7	. 7720	17	GI-A7	PWSA TYPE 13 CATCH BASIN	471+00.00 - 14.21' RT	GRATE	848.00	845.36	846.46	845.36	N/A	N/A	842.36	N/A	N	Y (north west)	0.5	845.53
ST-A7		17	GI-A7A	PWSA MODIFIED TYPE 13 INLET	471+00.00 - 11.00' RT	GRATE	848.25	845.36	845.36	845.36	N/A	N/A	842.36	N/A	N	Y (west)	0.5	845.53
BS-A3	ST-A8	18	GI-A8	24" PVC DRAIN BASIN WITH SOLID LID	475+72.12 - 11.94' RT	SOLID	850.58	N/A	847.23	847.75	847.75	N/A	845.73	N/A	N	N	N/A	N/A
BS-A3	ST-A8	18	A22-2	GI CONTROL STRUCTURE (TYPE 13)	477+17.51 - 11.83' RT	GRATE	8.8	**	843.58	843.58	N/A	N/A	840.58	846.66	Y (east)	Y (south east)	0.5	843.74
BS-A3	ST-A8	18	GI-A9	2' X 2' PRECAST CONCRETE INLET	476+5.87 - 18.79' RT	SOLID	850.45	N/A	843.58	845.38	N/A	N/A	842.08	N/A	N	N	N/A	N/A
BS-A4	ST-A11	19	GI-A13	2' X 2' PRECAST CONCRETE INLET	485+78.38 - 5.93' RT	GRATE	815.40	N/A	811.26	811.26	811.26	N/A	809.76	N/A	N		N/A	N/A
BS-A4	ST-A11	19	A24-2	GI CONTROL STRUCTURE (TYPE 5)	486+04.27 - 6.09' RT	SOLID	**	**	811.26	810.26	811.26	N/A	807.26	812.80	Y (east)	Y (west)	0.5	810.42
BR-A1		20	GI-A14	2' X 2' PRECAST CONCRETE INLET	488+82.14 - 4.25' RT	GRATE	809.50	806.53	805.33	805.33	805.33	N/A	803.83	N/A	N	N	N/A	N/A
BR-A1	35 - 35 7 11 - 35	20	GI-A15	2' X 2' PRECAST CONCRETE INLET	489+58.12 - 5.21' RT	SOLID	810.70	N/A	805.33	807.78	807.78	N/A	803.83	N/A	N	N	N/A	N/A
BR-A1	7/67	20	GI-A16	GI CONTROL STRUCTURE (TYPE 13)	488+82.73 - 18.87 LT	GRATE	809.64	805.65	806.64	806.64	N/A	N/A	803.64	808.14	Y (east)	Y (west)	0.5	805.50
ST-A12		21	A25-6	RECESS CATCH BASIN	492+34.12 - 19.22' RT	GRATE	**	**	N/A	819.28	N/A	N/A	816.28	N/A	Y (west)	Y (east)	N/A	N/A
ST-A12	0.20	21	GI-A17	4' x 2' JUNCTION BOX WITH WEIR	492+41.07 - 20.45 RT	SOLID	823.60	819.31	820.56	819.31	N/A	N/A	817.56	822.60	N	N	0.5	819.48
ST-A12		21	GI-A18	24" CONCRETE TRENCH DRAIN	492+41.07 - 16.71 RT	GRATE	TC ELEV	N/A	821.60	N/A	N/A	N/A	VARIES	N/A	N	N	N/A	N/A

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		REVISIONS	COUNTY, FEINING LEVAINIA.

	S	EE BRT PLAN S	ET FOR ROADWAY	Y DRAWINGS			
DESIGNED <u>SAB</u>	PORT AUTHOR	ITY OF ALL	EGHENY CO	UNTY			
DRAWN <u>TDL</u>	PITTSBURGH		PENN	SYLVANIA			
CHECKED <u>DPW</u>	BUS RAPID TRANSIT UPTOWN TO OAKLAND						
N CHARGE <u>ALP</u>	STORMWATER MANAGEMENT PLANS						
DATE <u>05/01/24</u>	STRUCTURE TABLES - FIFTH AVENUE						
SCALE AS SHOWN	Port Authority	CONTRA	CT NO. BRT-0	01			
ACCITOVIN	connecting people to life	DWG. NO.	SWM13	sнт. 13			

APPROVED

SIGNATURE

DATE

GI ID 1	SWM Sheet	Structure ID	Structure Type	Station - Offset	Top Type	Rim Elevation [ft] **Refer to roadway plans	Sewer [ft]	Elevation	in from GI	BR/BS Underdrain Invert Elevation [ft]	IN from Structure	Bottom	Weir Elevation [ft]	The Association Conference of the	Slow release orifice cap (on pipe direction)	Orifice Diameter (in)	Orifice Elevation (ft)
ST-B2	22	GI-B7A	PWSA TYPE 13 CATCH BASIN	143+66.46 - 19.6' RT	GRATE	801.42	N/A	797.42	N/A	N/A	N/A	794.42	N/A	N	N	N/A	N/A
ST-B2	22	GI-B7	GI CONTROL STRUCTURE (TYPE 13)	142+13.93 - 20.5' RT	GRATE	800.00	796.25	796.57	795.46	N/A	N/A	793.57	798.50	Y [west]	Y [north]	SOLID CAP	N/A
ST-B3	23	G05-7	PWSA TYPE 13 CATCH BASIN	146+39.65 - 10.5' LT	GRATE	**	**	N/A	800.41	N/A	803.53	794.33	N/A	N	Y [north]	0.50	800.58
ST-B3	23	GI-B5	2' X 2' PRECAST CONCRETE INLET	146+05.46 - 20.5' LT	SOLID	805.90	N/A	802.66	N/A	N/A	N/A	801.16	N/A	N	N	N/A	N/A
ST-B3	23	GI-B5A	GI CONTROL STRUCTURE (TYPE 13)	146+43.65 - 10.5' LT	GRATE	806.20	803.53	804.15	N/A	N/A	N/A	801.15	804.70	Y [west]	N	N/A	N/A
ST-B4	24	G05-5	GI CONTROL STRUCTURE (TYPE 13)	146+00.00 - 18.5' RT	GRATE	**	**	801.26	800.26	N/A	N/A	798.26	803.35	Y (west)	Y (north)	Solid cap	N/A
ST-B5	25	G05-12	GI CONTROL STRUCTURE (TYPE 13)	148+60.00 - 18.5' RT	GRATE	**	**	808.17	807.17	N/A	N/A	805.03	810.21	Y (west)	Y (north)	0.50	807.34
ST-B5	25	G06-2	GI CONTROL STRUCTURE (TYPE 13)	149+97.50 - 18.5' RT	GRATE	**	**	809.21	N/A	N/A	N/A	804.16	810.21	Y (east)	N	N/A	N/A
ST-B6	26	GI-B1	PWSA TYPE 13 CATCH BASIN	157+10.34 - 8.2' LT	GRATE	831.81	N/A	829.64	N/A	N/A	N/A	826.64	N/A	N	N	N/A	N/A
ST-B6	26	GI-B2	GI CONTROL STRUCTURE (TYPE 13)	157+10.34 - 15.7' RT	GRATE	831.47	825.93	827.01	825.93	N/A	829.52	824.01	829.97	Y (west)	Y (south)	0.63	826.10
ST-B6	26	G07-4	PWSA TYPE 13 CATCH BASIN	156+42.00 - 18.3' RT	GRATE	*8	**	N/A	825.93	N/A	N/A	**	N/A	N	N	N/A	N/A
ST-B7	27	G09-4	GI CONTROL STRUCTURE (TYPE 13)	165+96.50 - 18.0' RT	GRATE	**	**	825.84	822.76	N/A	N/A	821.09	827.50	Y (east)	Y (north)	0.50	822.93
ST-B8	28	G10-3	GI CONTROL STRUCTURE (TYPE 13)	170+95.00 - 17.8' RT	GRATE	**	**	805.61	802.41	N/A	N/A	800.75	807.15	Y (east)	Y (north)	0.50	802.58
BS-B1	29	GI-B4	24" PVC DRAIN BASIN WITH DOMED GRATE	247+66.00 - 25.0' RT	GRATE	894.75	891.74	N/A	891.91	891.91	N/A	890.25	N/A	N	Y (west)	0.50	892.17
BS-B1	29	GI-B6	2' X 2' PRECAST CONCRETE INLET	246+59.04 - 22.3' RT	SOLID	897.25	N/A	894.25	N/A	894.25	N/A	892.45	N/A	N	N	N/A	N/A

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	DESIGNED	<u>SAB</u>
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	SCALE	AS SHOWN
DATE		

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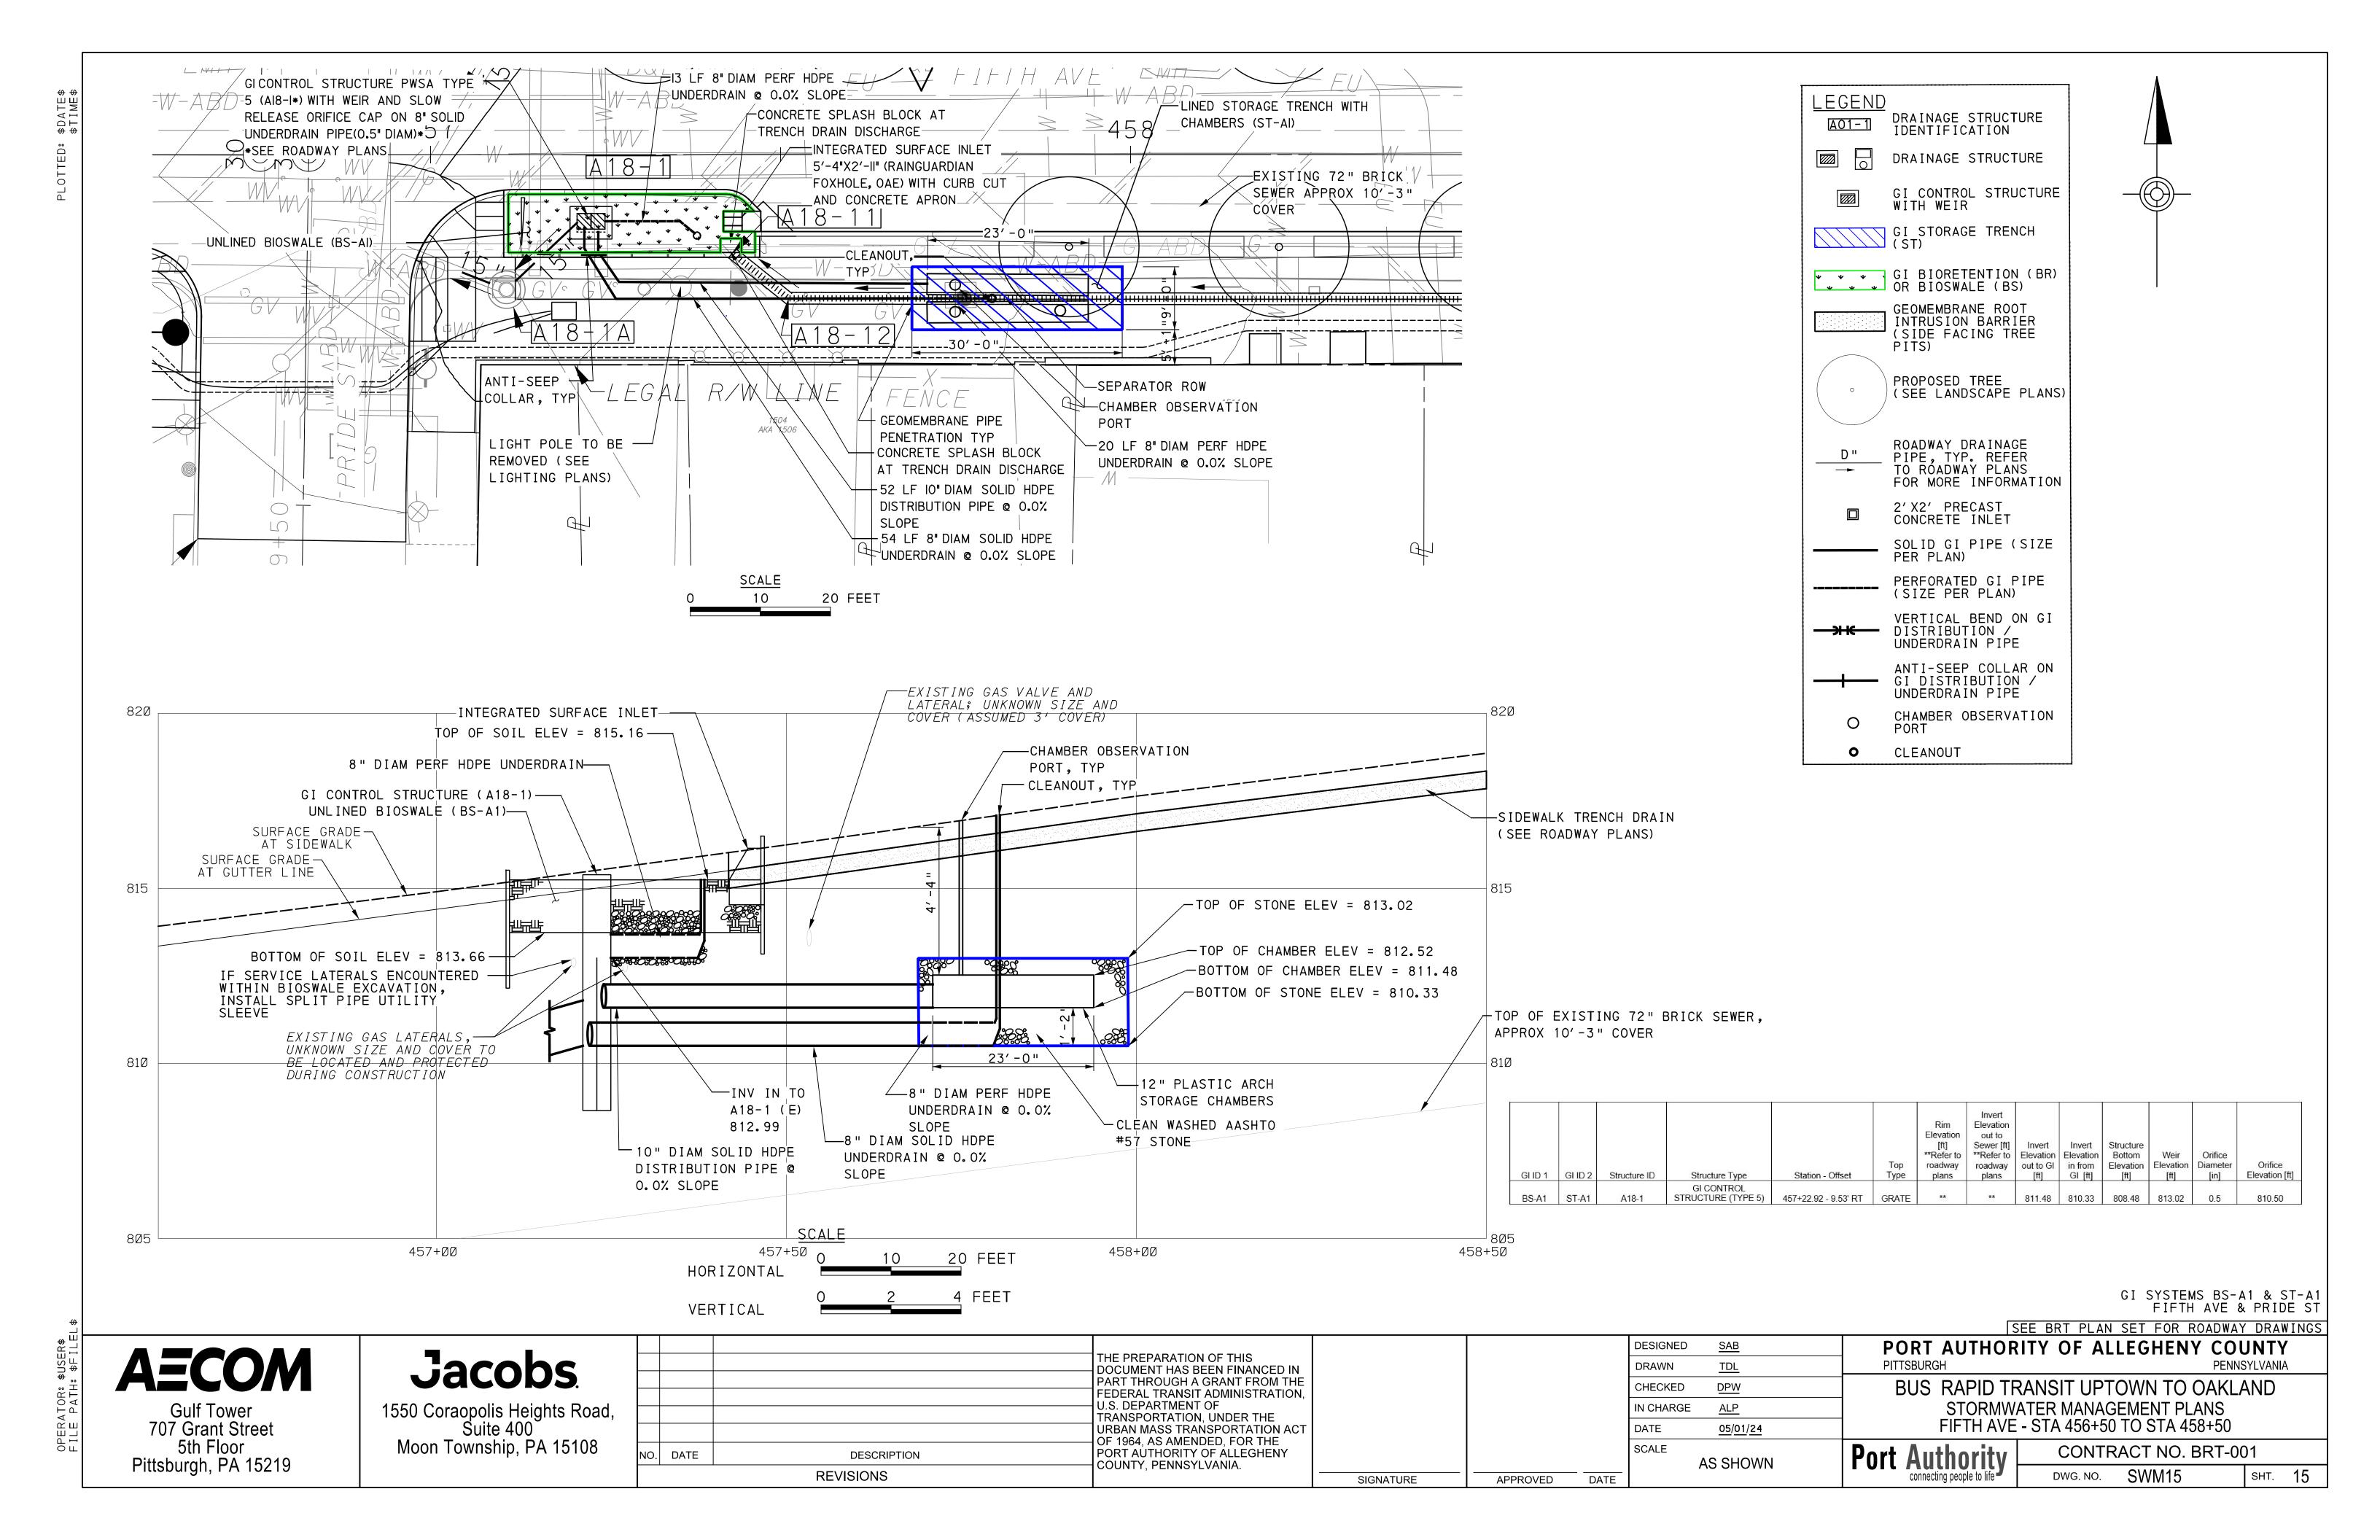
SEE BRT PLAN SET FOR ROADWAY DRAWINGS
PORT AUTHORITY OF ALLEGHENY COUNTY
PITTSBURGH
PENNSYLVANIA


BUS RAPID TRANSIT UPTOWN TO OAKLAND STORMWATER MANAGEMENT PLANS STRUCTURE TABLES - FORBES AVENUE


Port Authority CONTRACT NO.


contract No. BRT-001

DWG. NO. SWM14 SHT. 14



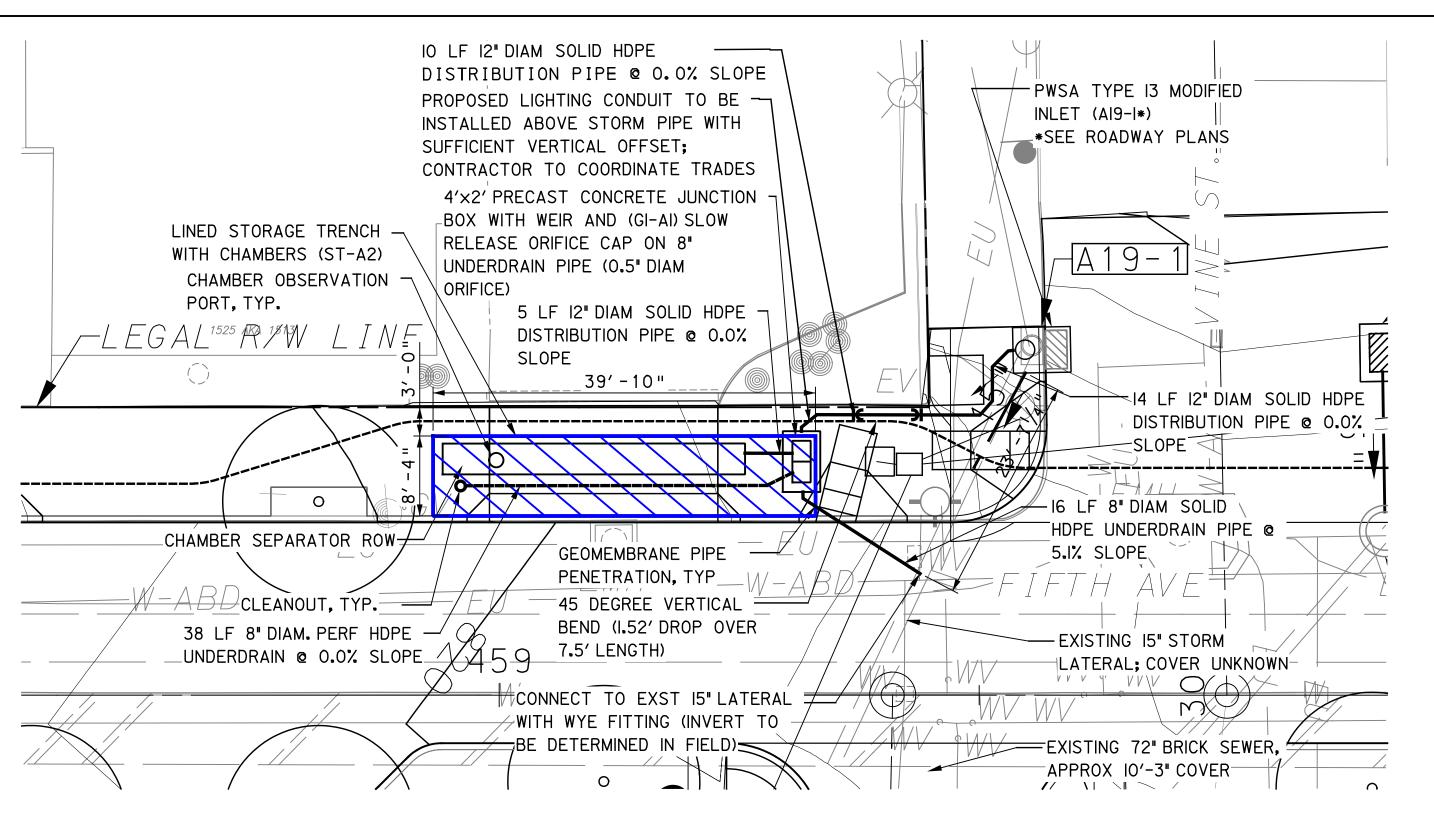

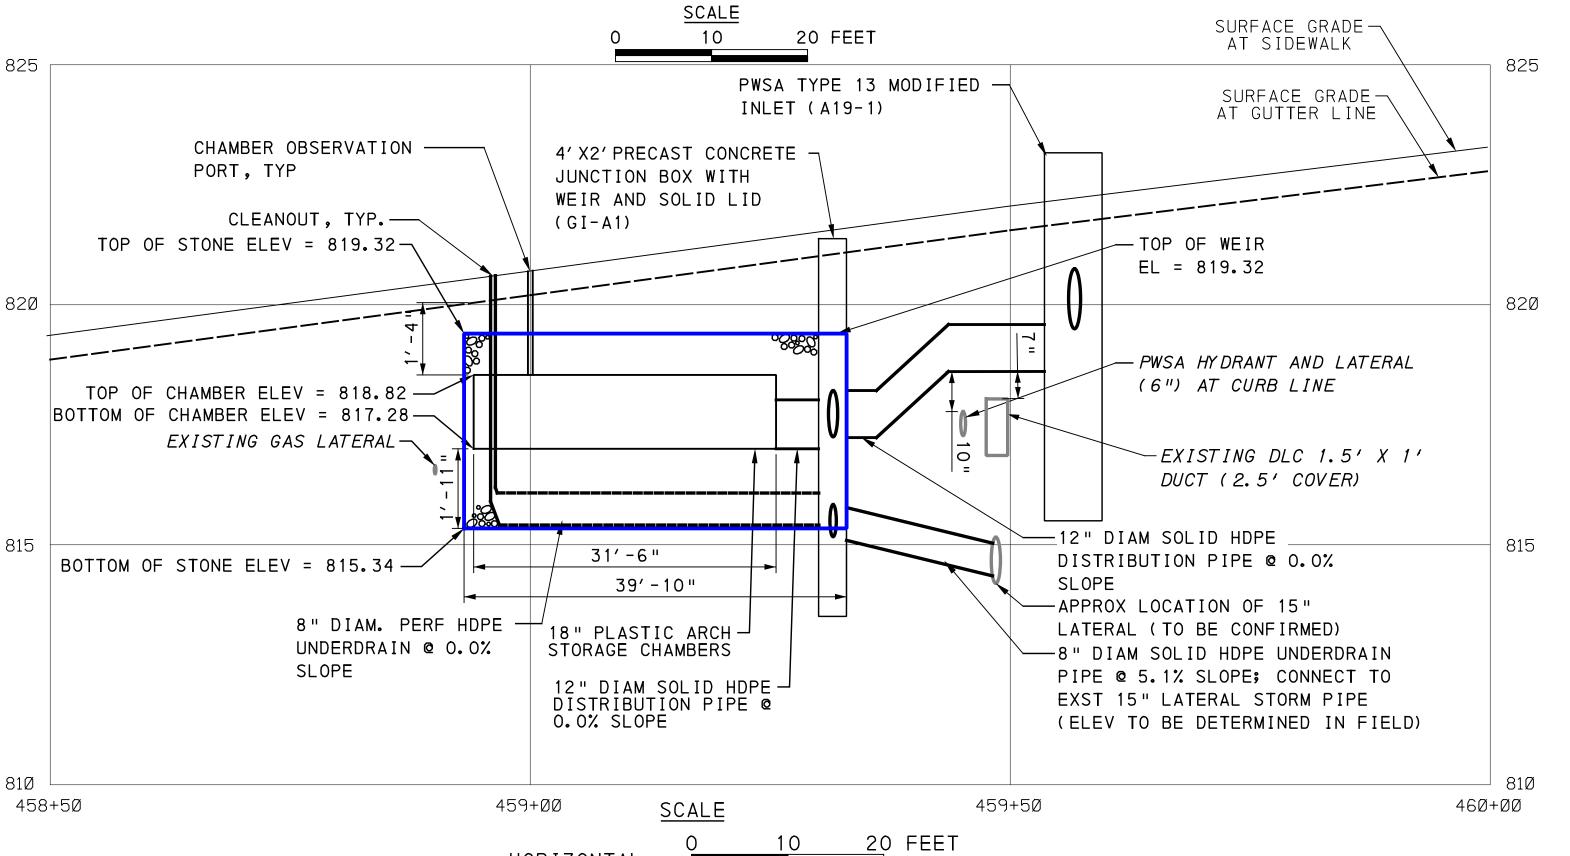

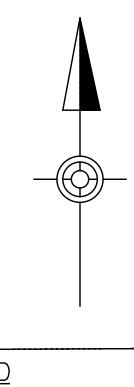

LEGEND A01-1	DRAINAGE STRUCTURE IDENTIFICATION
	DRAINAGE STRUCTURE
	GI CONTROL STRUCTURE WITH WEIR
	GI STORAGE TRENCH (ST)
* * * *	GI BIORETENTION (BR) OR BIOSWALE (BS)
	GEOMEMBRANE ROOT INTRUSION BARRIER (SIDE FACING TREE PITS)
0	PROPOSED TREE (SEE LANDSCAPE PLANS)
	ROADWAY DRAINAGE PIPE, TYP. REFER TO ROADWAY PLANS FOR MORE INFORMATION
	2'X2' PRECAST CONCRETE INLET
	SOLID GI PIPE (SIZE PER PLAN)
	PERFORATED GI PIPE (SIZE PER PLAN)
>-K	VERTICAL BEND ON GI DISTRIBUTION / UNDERDRAIN PIPE
	ANTI-SEEP COLLAR ON GI DISTRIBUTION / UNDERDRAIN PIPE
0	CHAMBER OBSERVATION PORT
0	CLEANOUT

GI ID 1	GI ID 2	Structure ID	Structure Type	Station - Offset	Top Type	Rim Elevation [ft] **Refer to roadway plans	Invert Elevation out to Sewer [ft] **Refer to roadway plans	Invert Elevation out to GI [ft]	Invert Elevation in from GI [ft]	Invert Elev in from Structure A19-1 [ft]	Structure Bottom Elevation [ft]	Weir Elevation [ft]	Orifice Diameter [in]	Orifice Elevation [ft]
ST-A2	-	GI-A1	4' x 2' JUNCTION BOX WITH WEIR	459+31.40 - 24.33' LT	SOLID	821.40	815.17	817.28	815.34	817.32	813.51	819.32	0.50	815.51
ST-A2	3-3	A19-1	PWSA MODIFIED TYPE 13 INLET	30+36.33 - 18.21' LT	GRATE	**	**	818.84	N/A	ão P	815.84	N/A	N/A	N/A

GI SYSTEM ST-A2 FIFTH AVE & VINE ST

SEE BRT PLAN SET FOR ROADWAY DRAWINGS

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HORIZONTAL

VERTICAL


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APPROVED D	ATE		AS SHOWN


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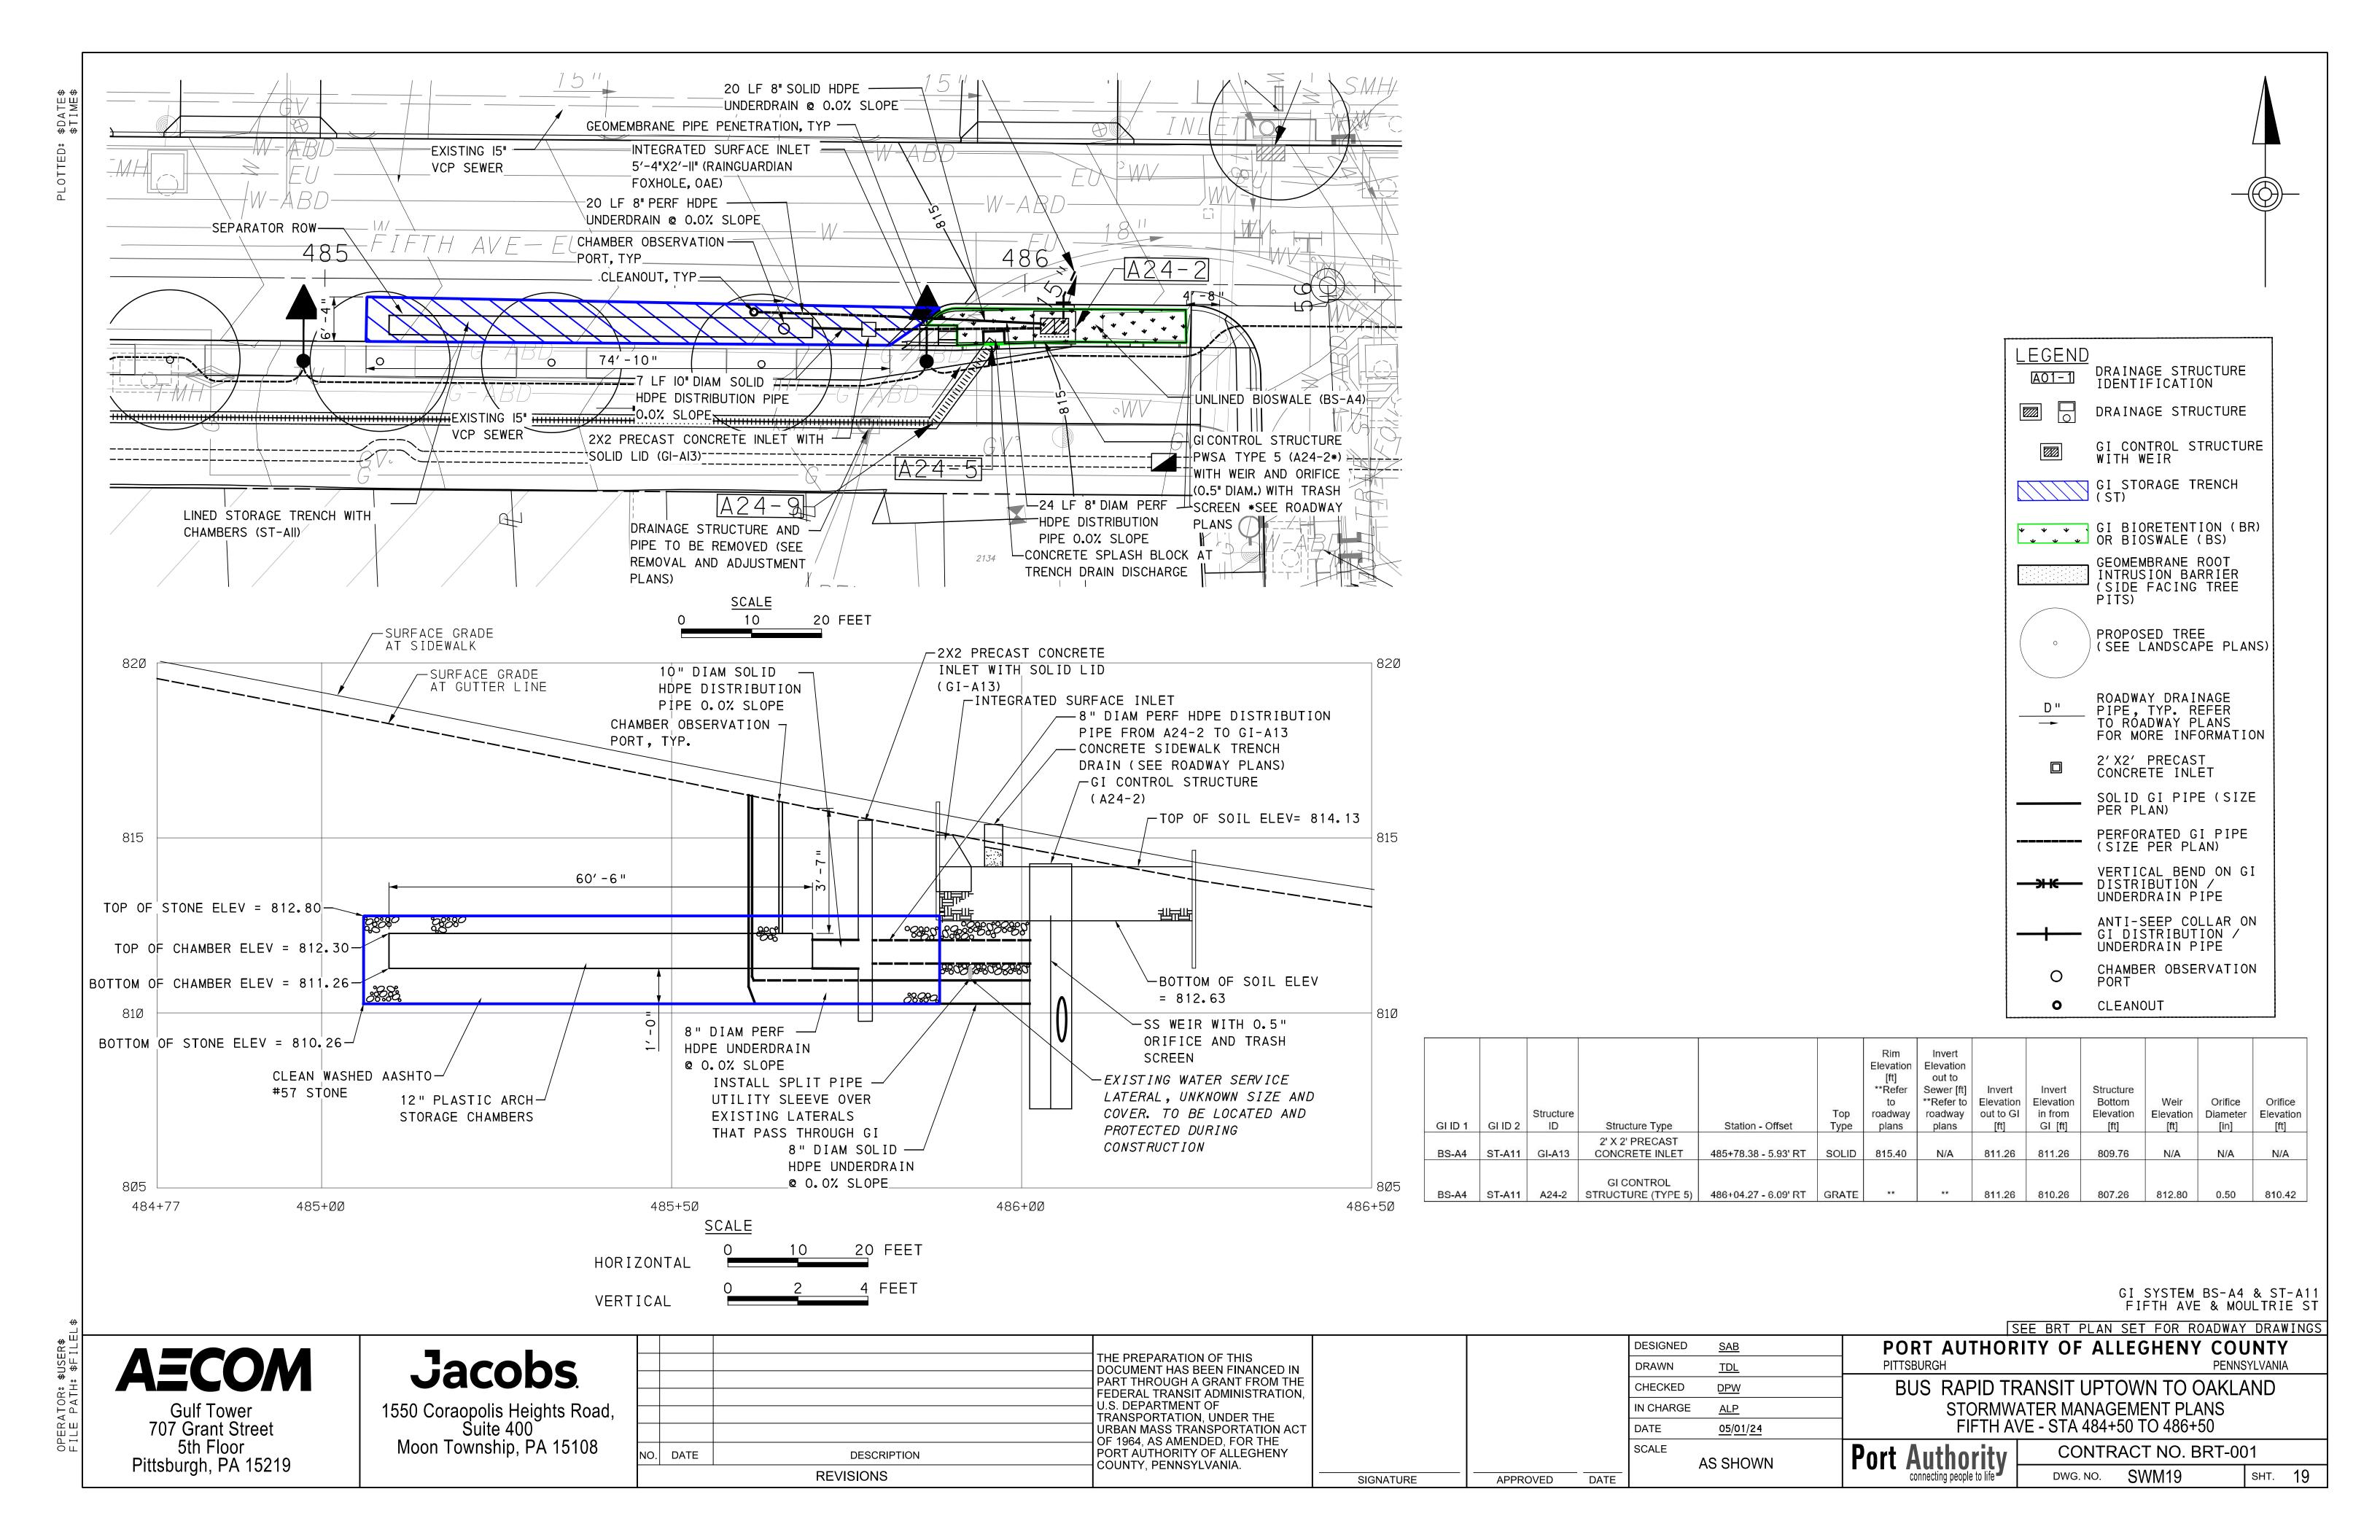
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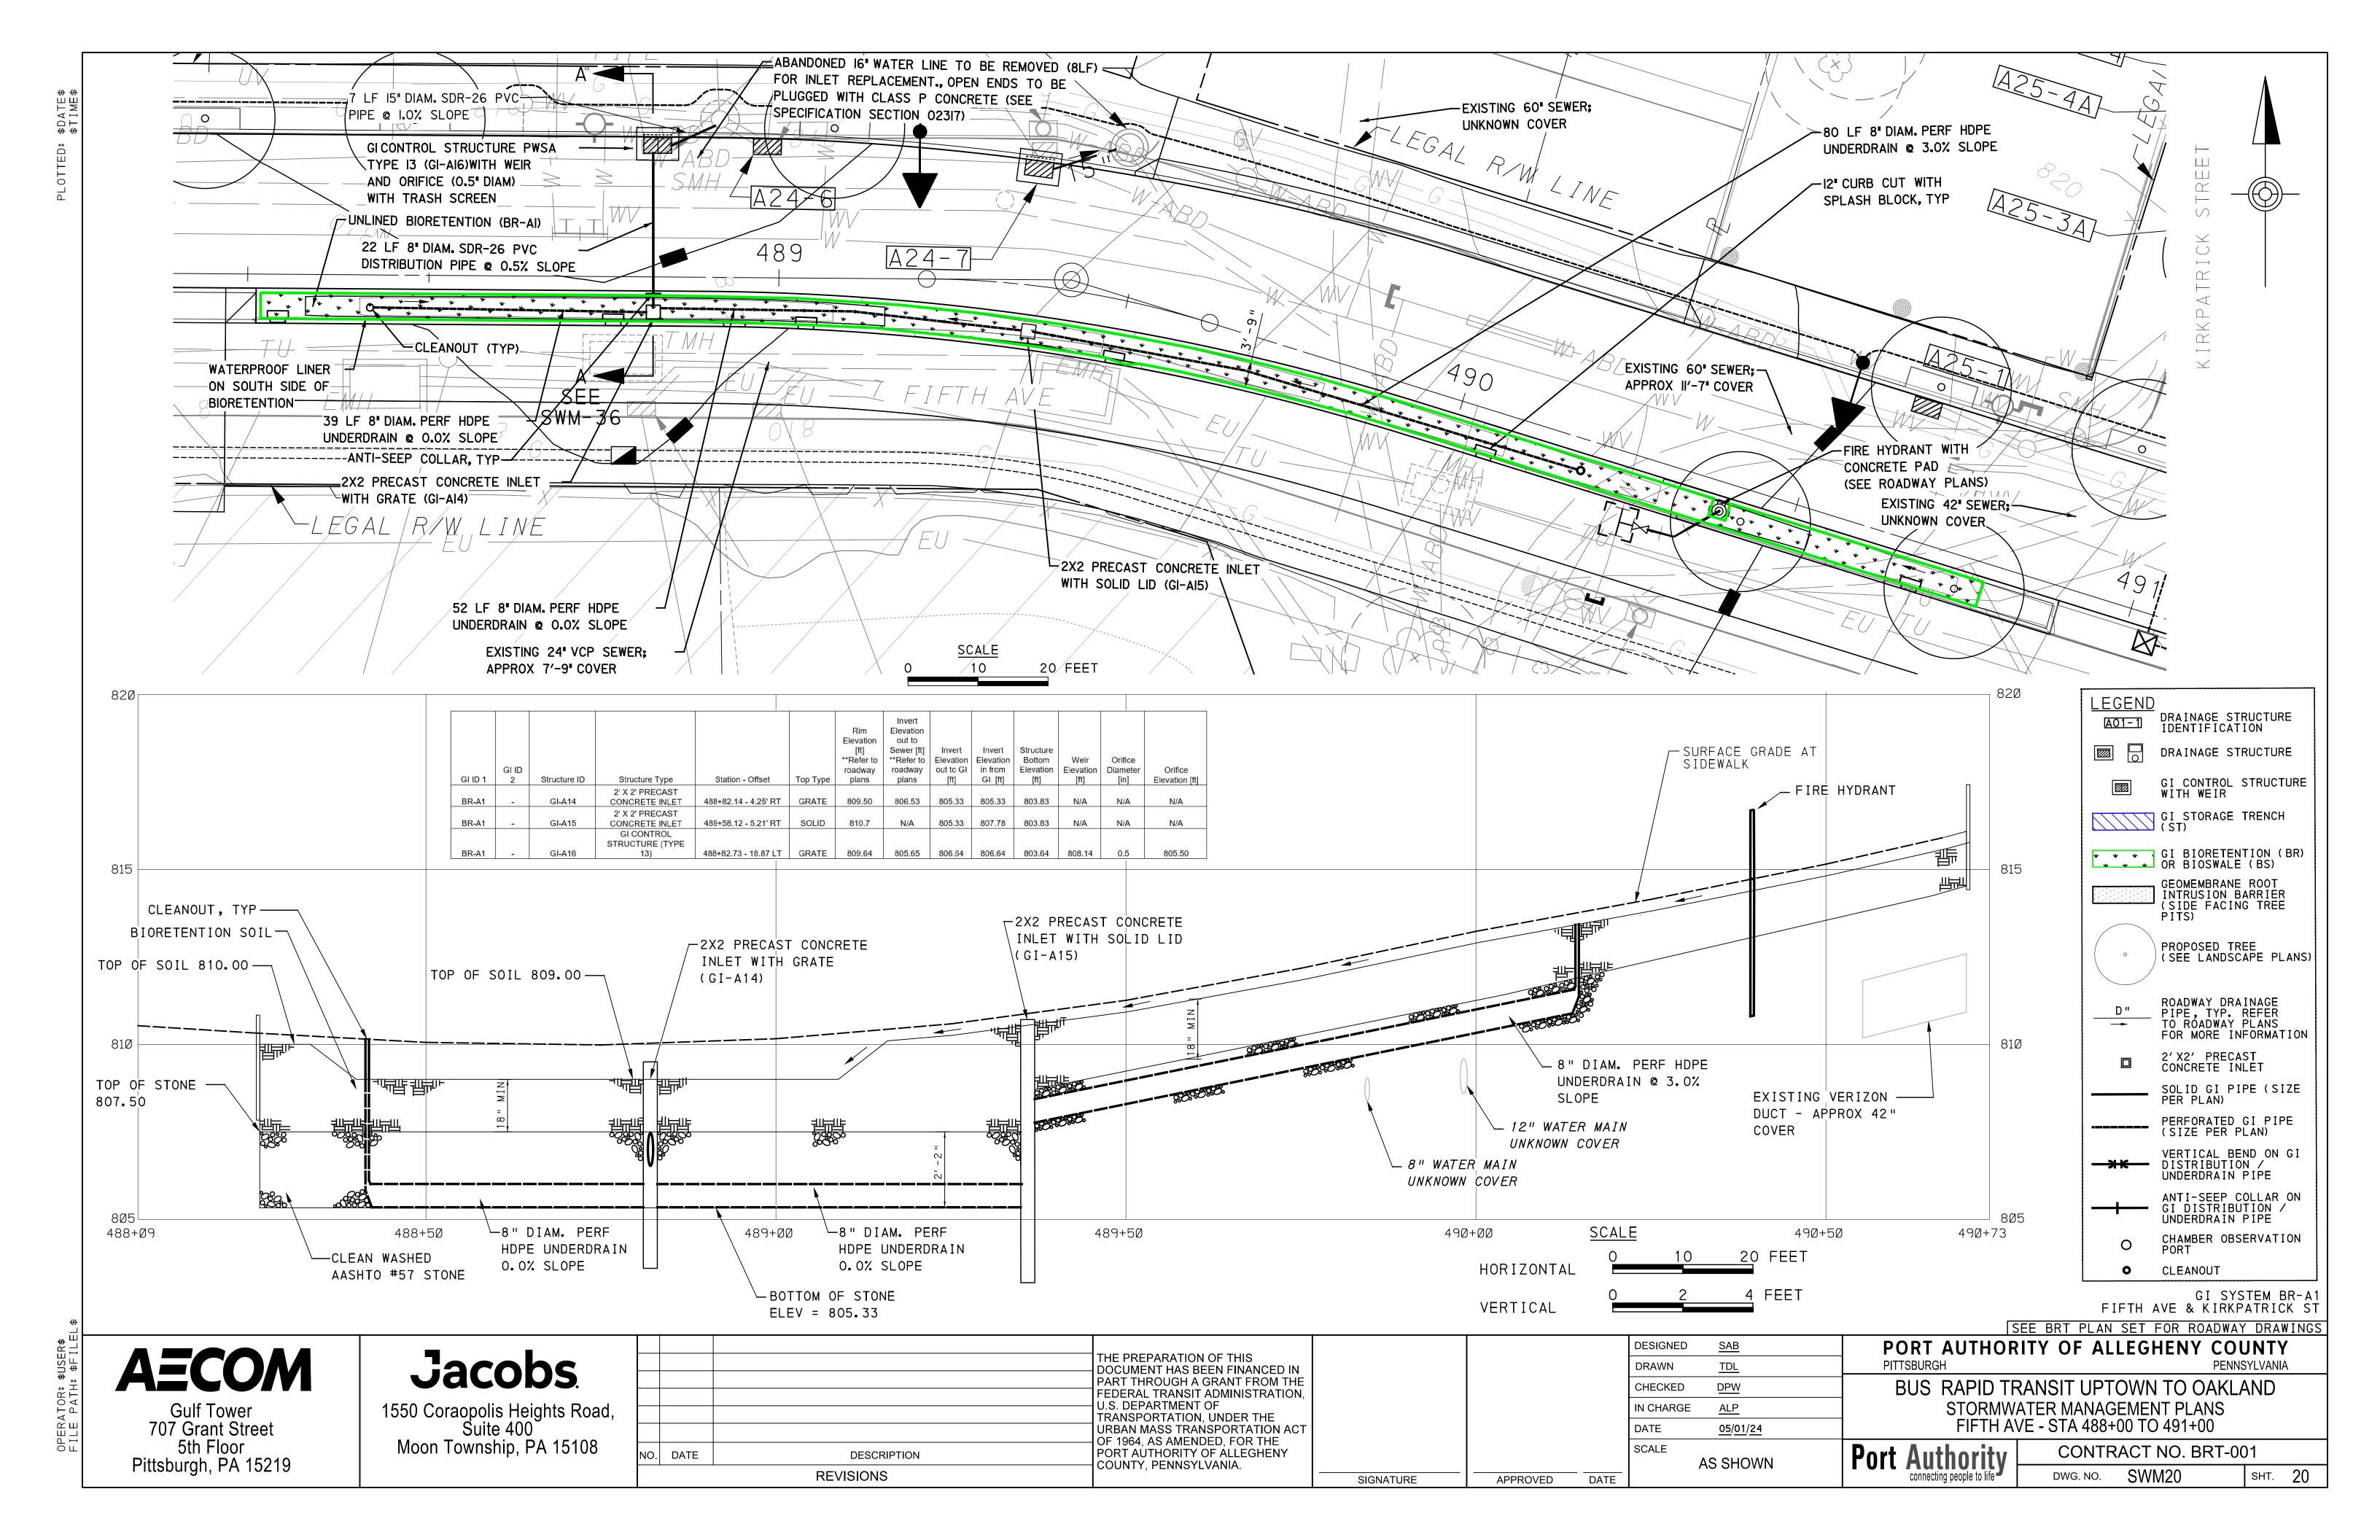
PITTSBURGH PENNSYLVANIA BUS RAPID TRANSIT UPTOWN TO OAKLAND STORMWATER MANAGEMENT PLANS FIFTH AVE - STA 458+50 TO STA 460+00


CONTRACT NO. BRT-001 SWM16 sнт. **16** DWG. NO.







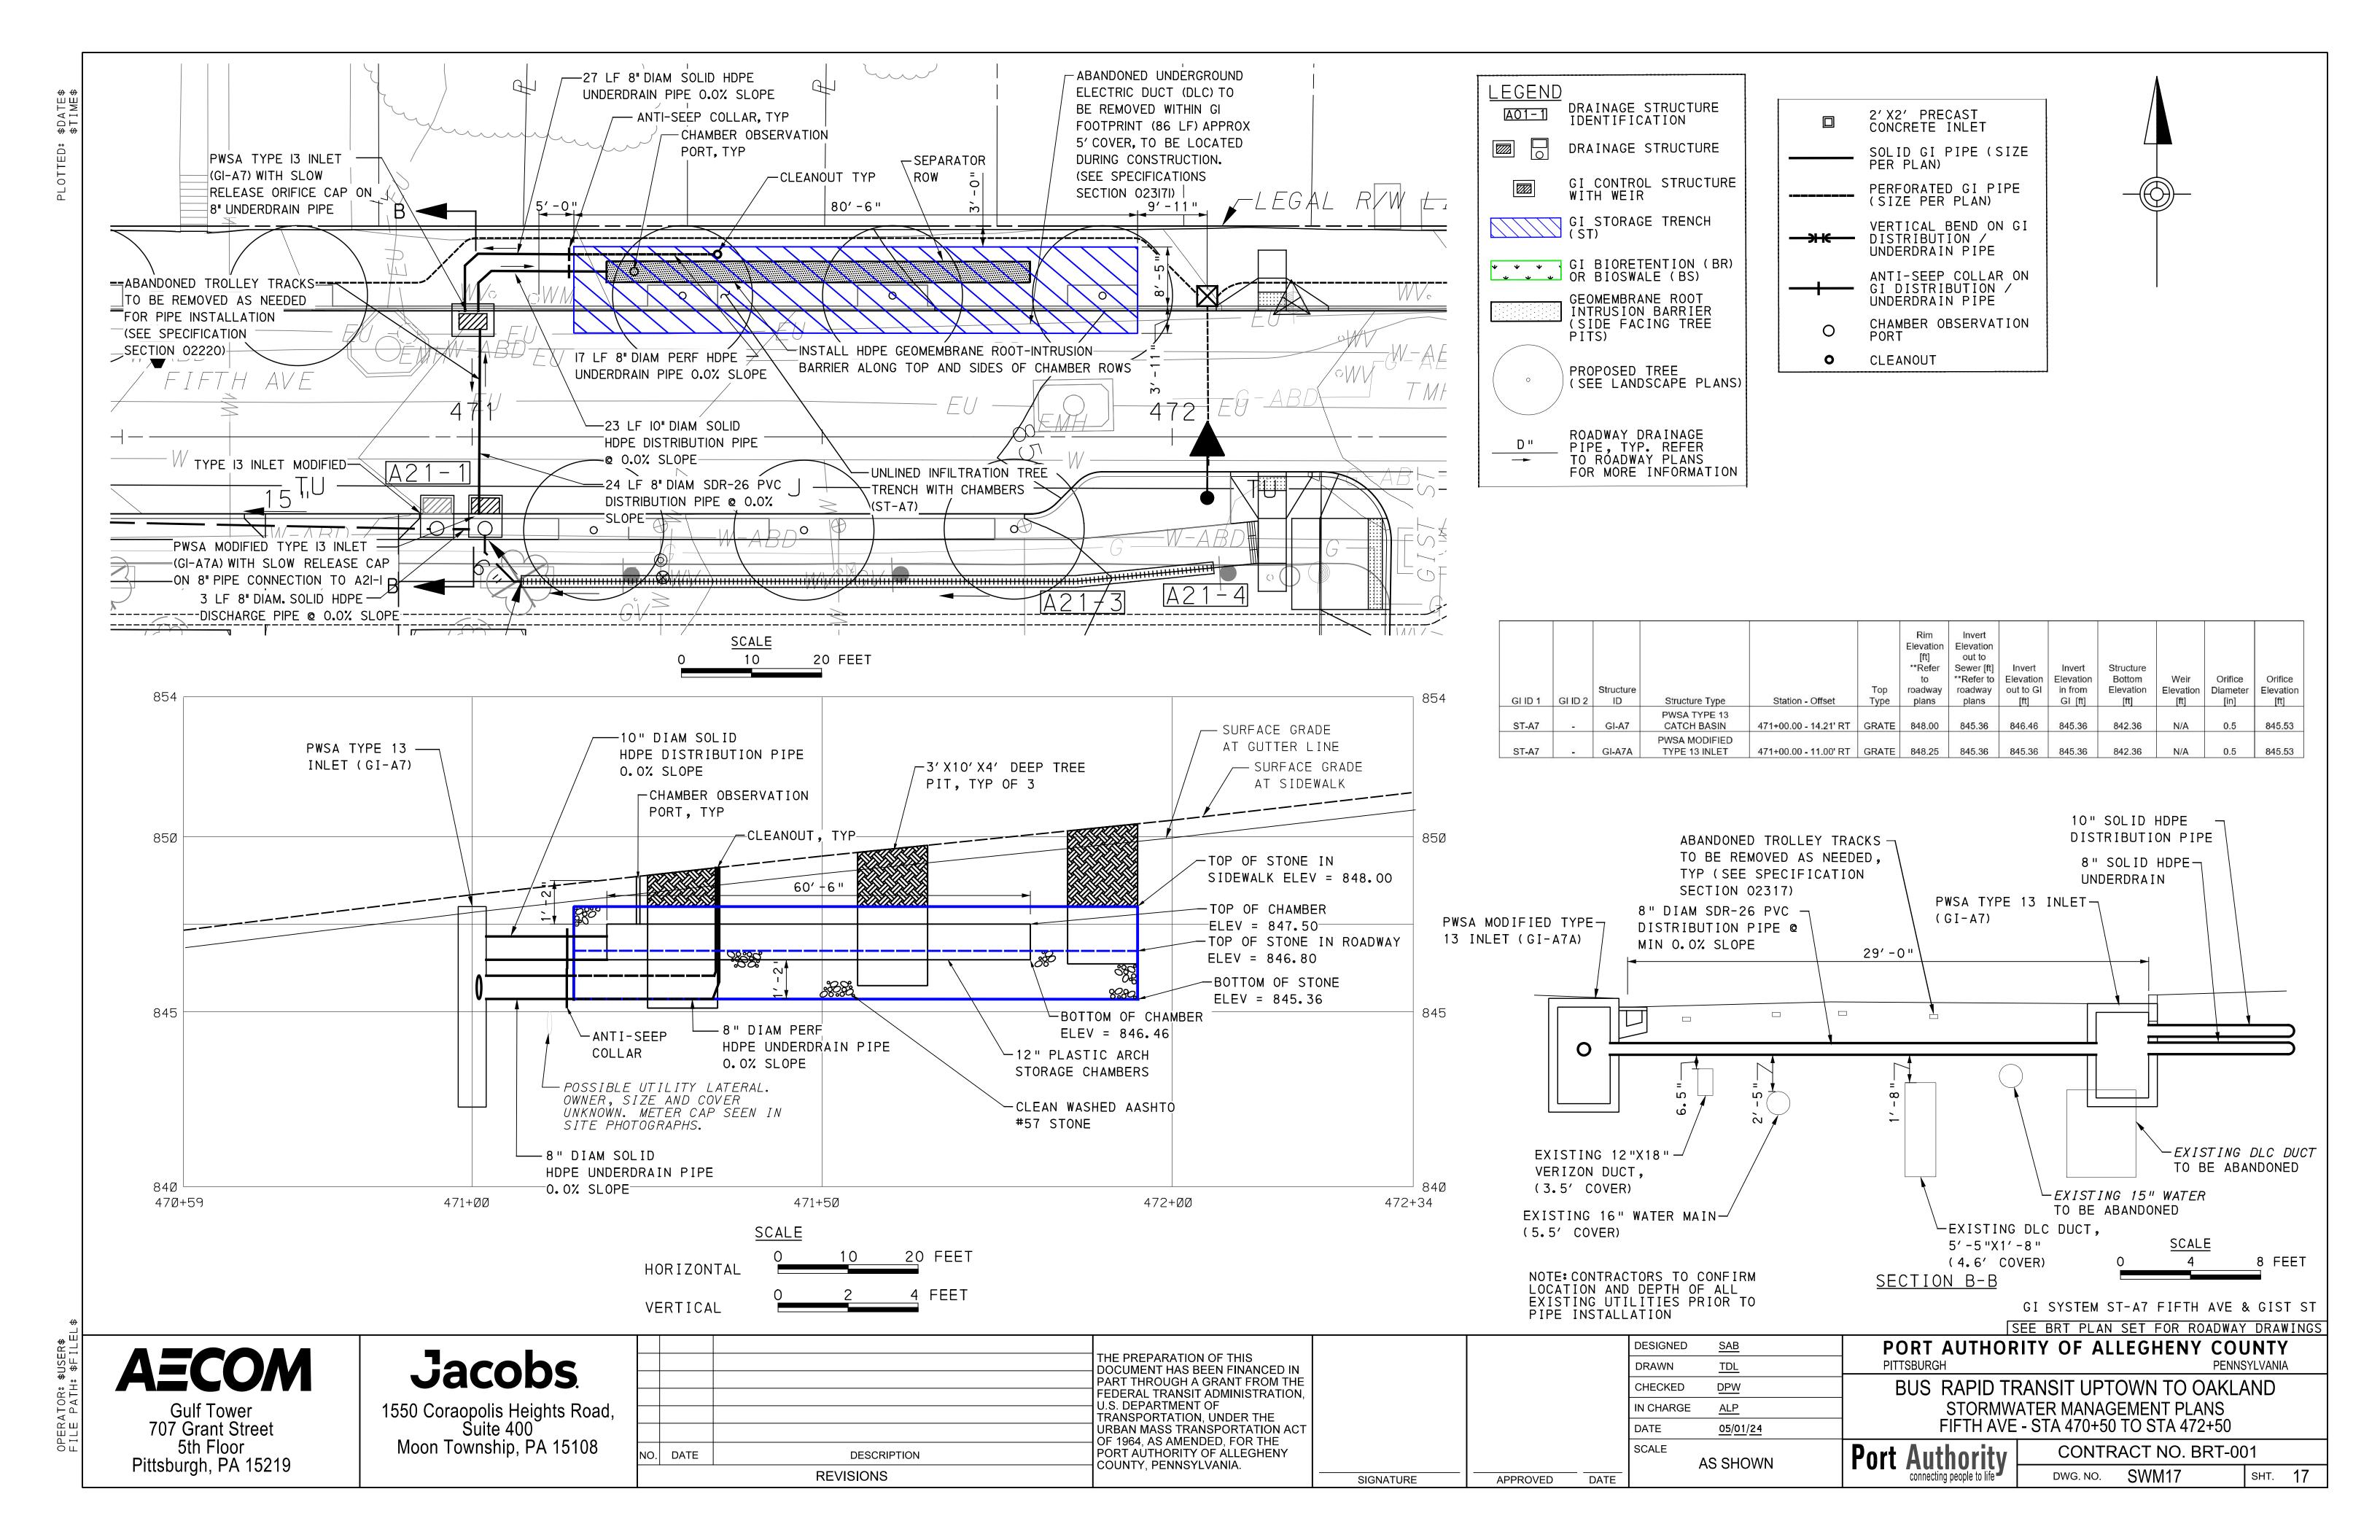


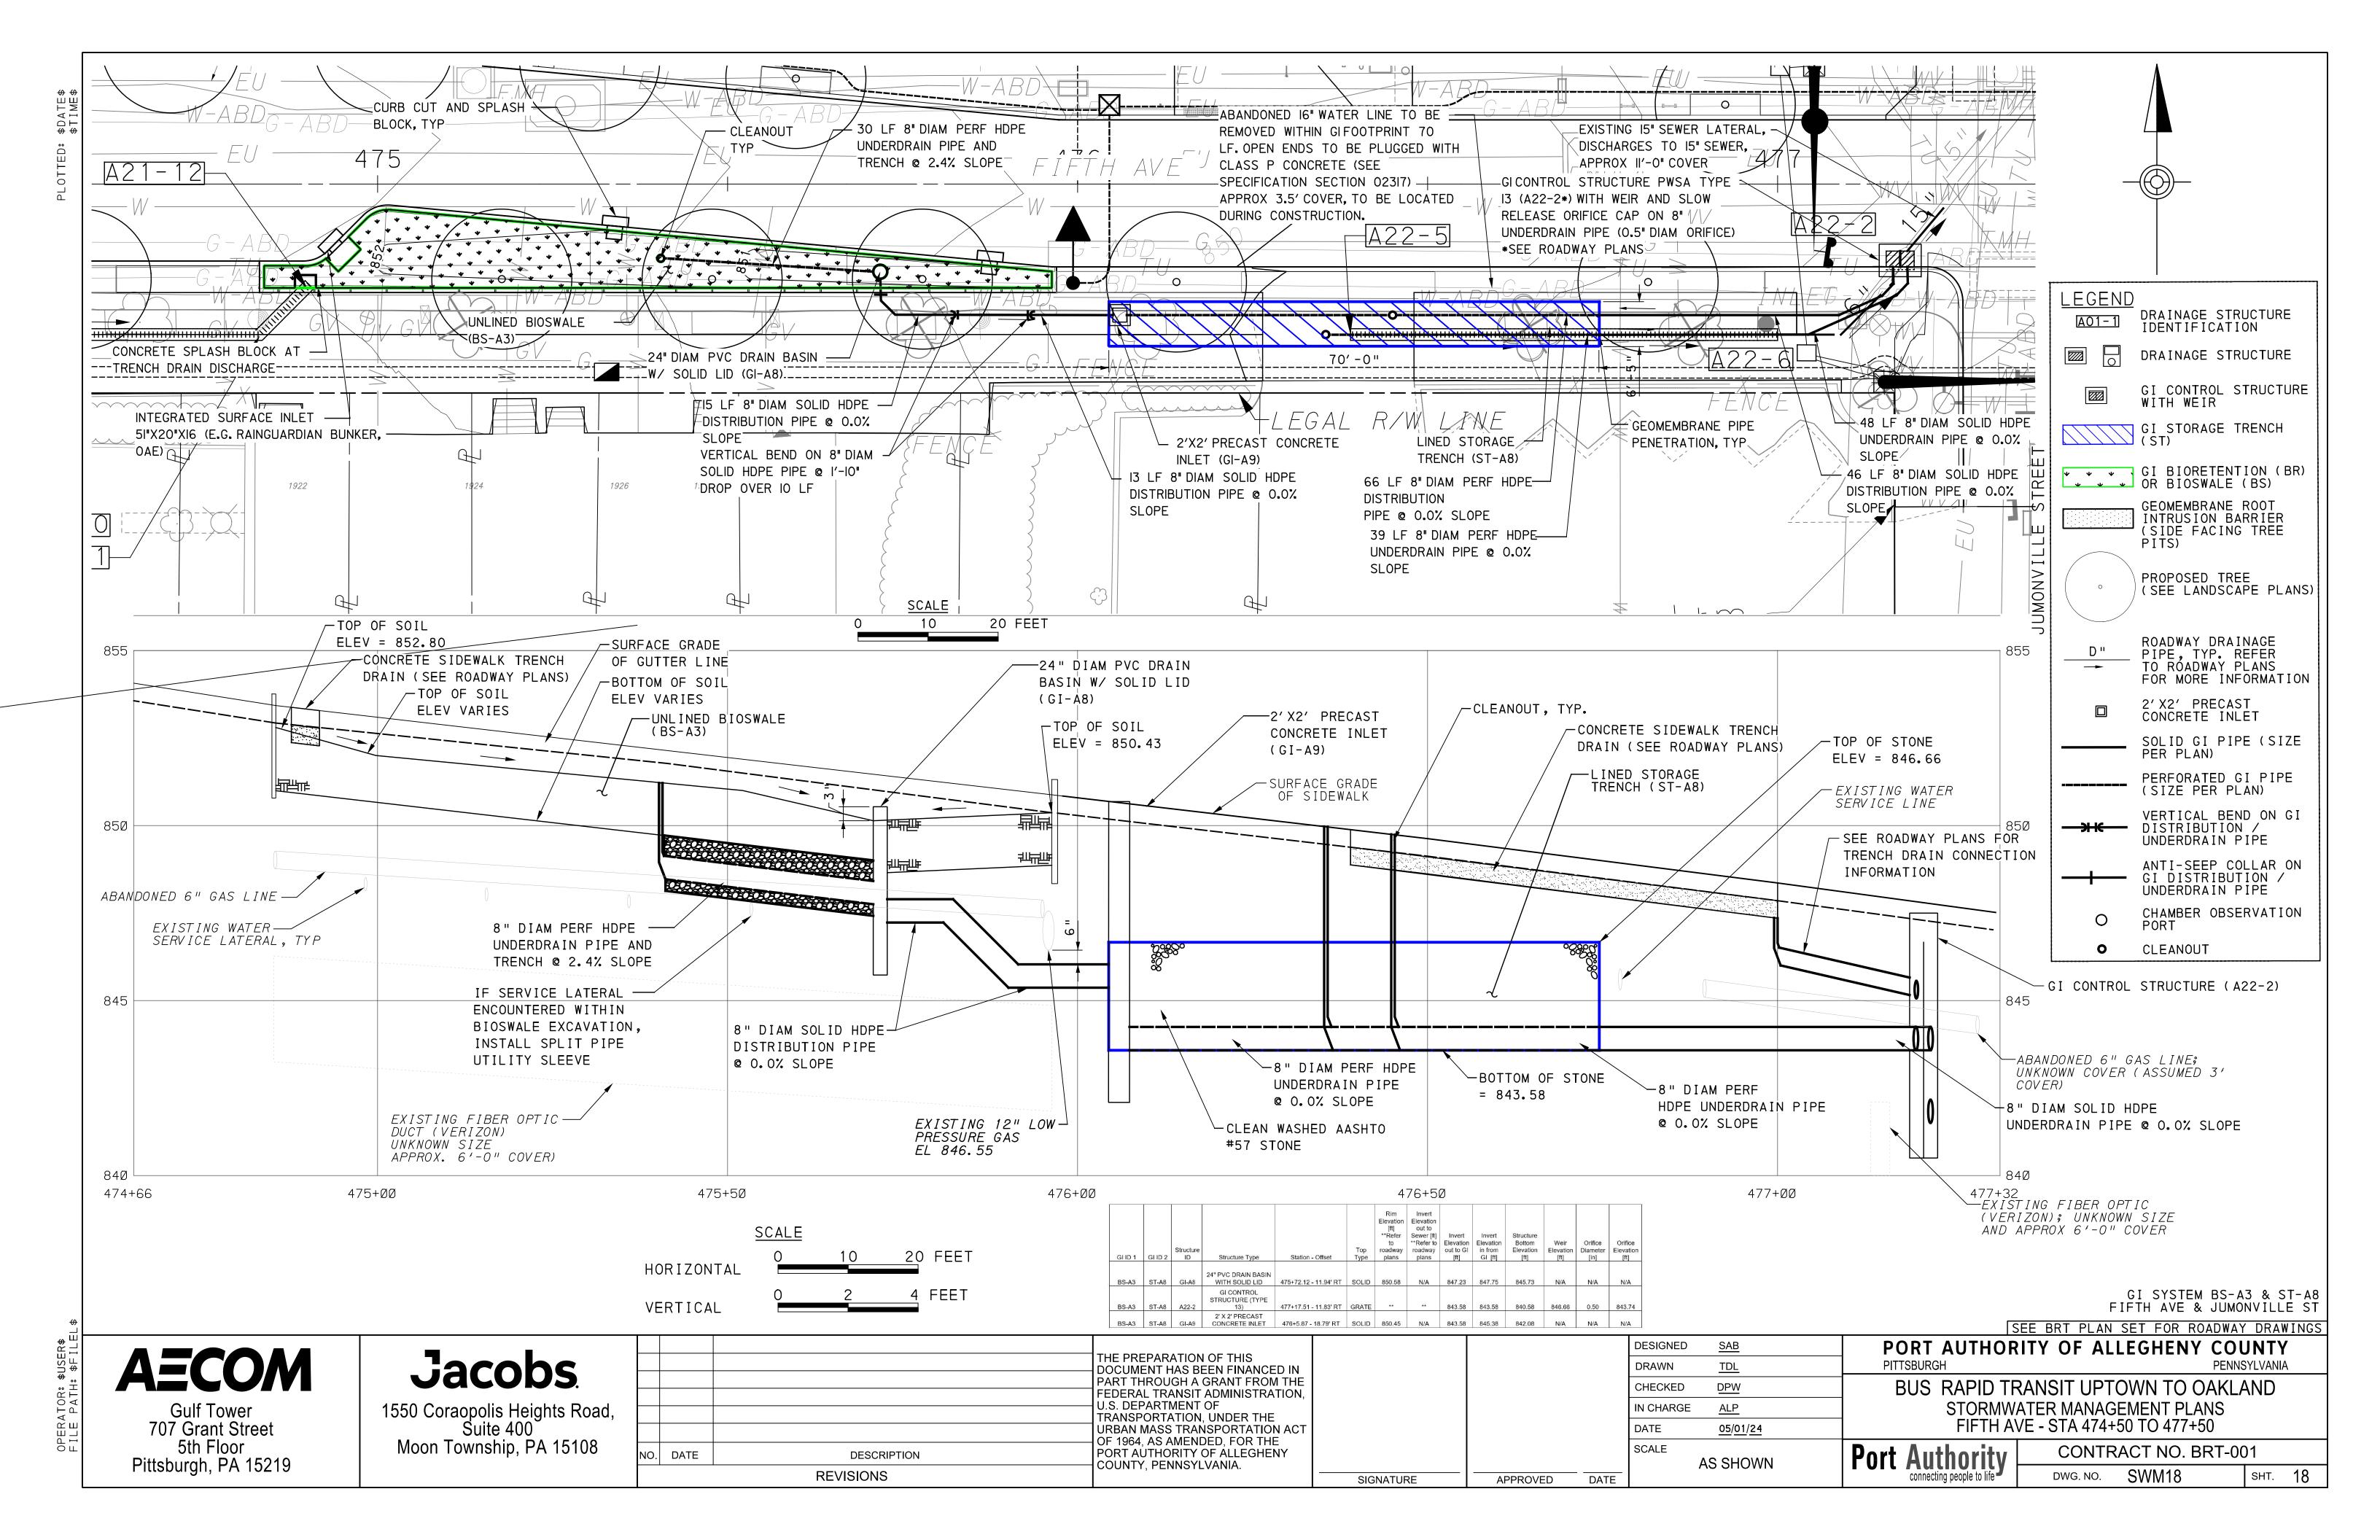


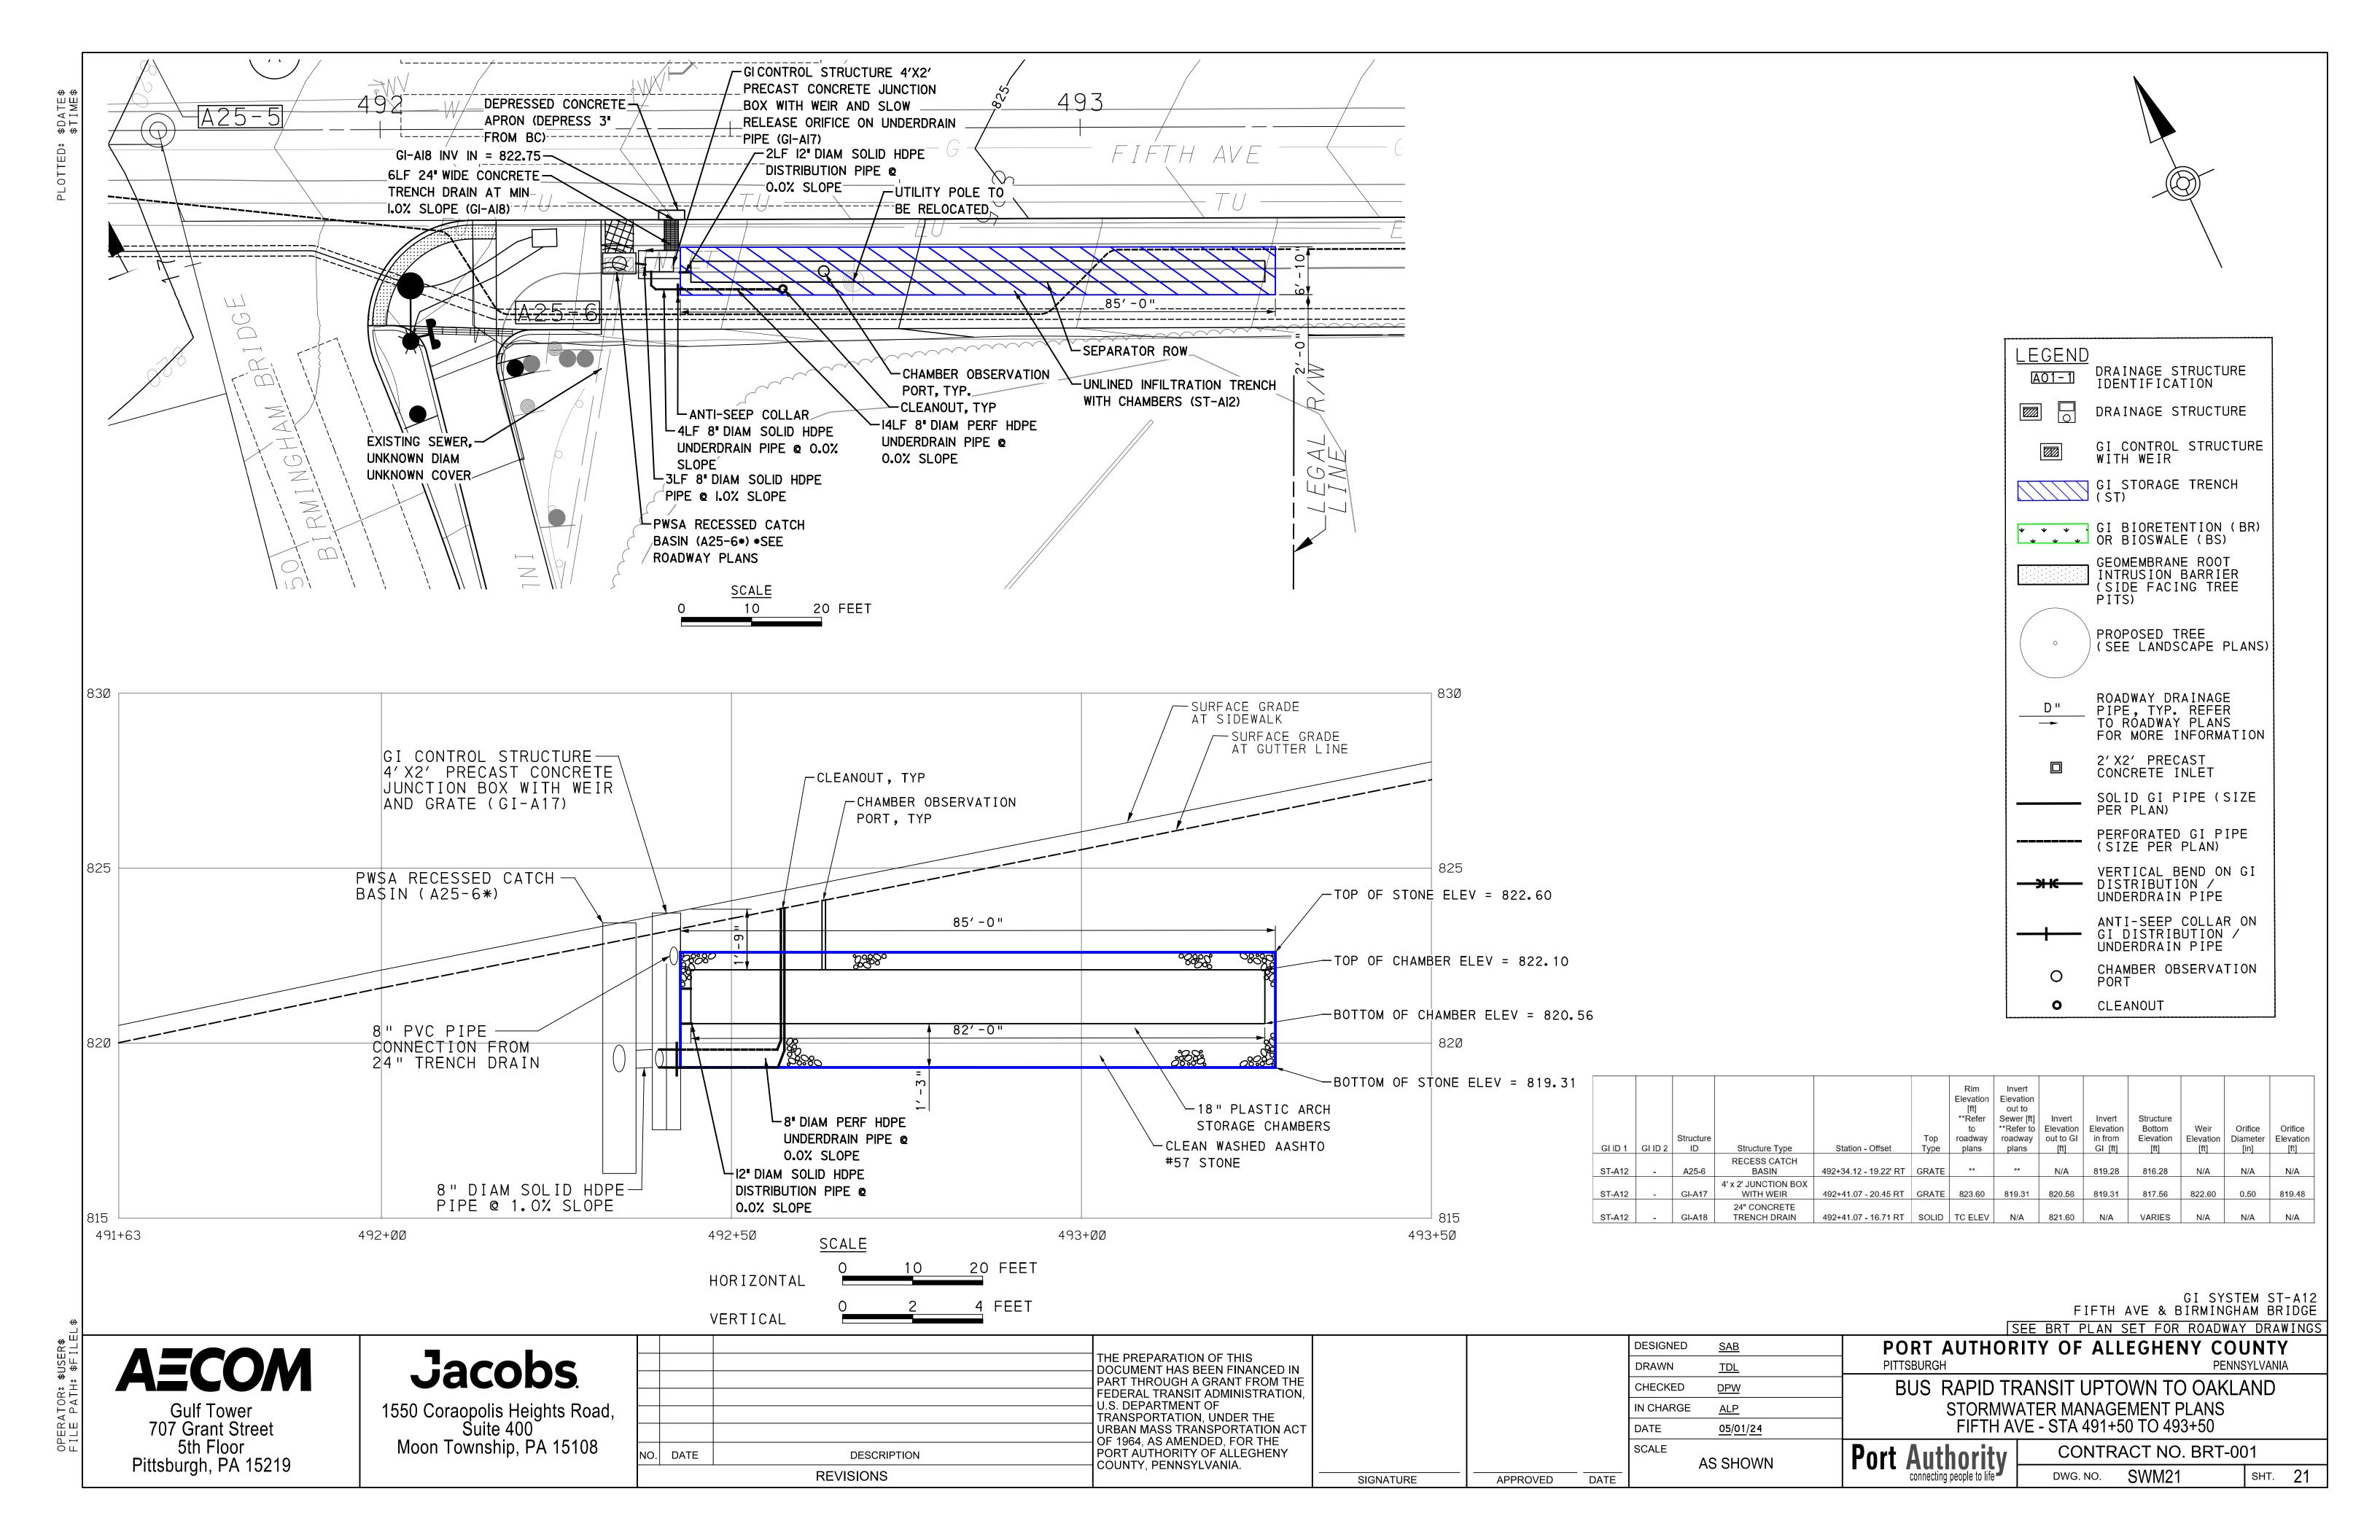


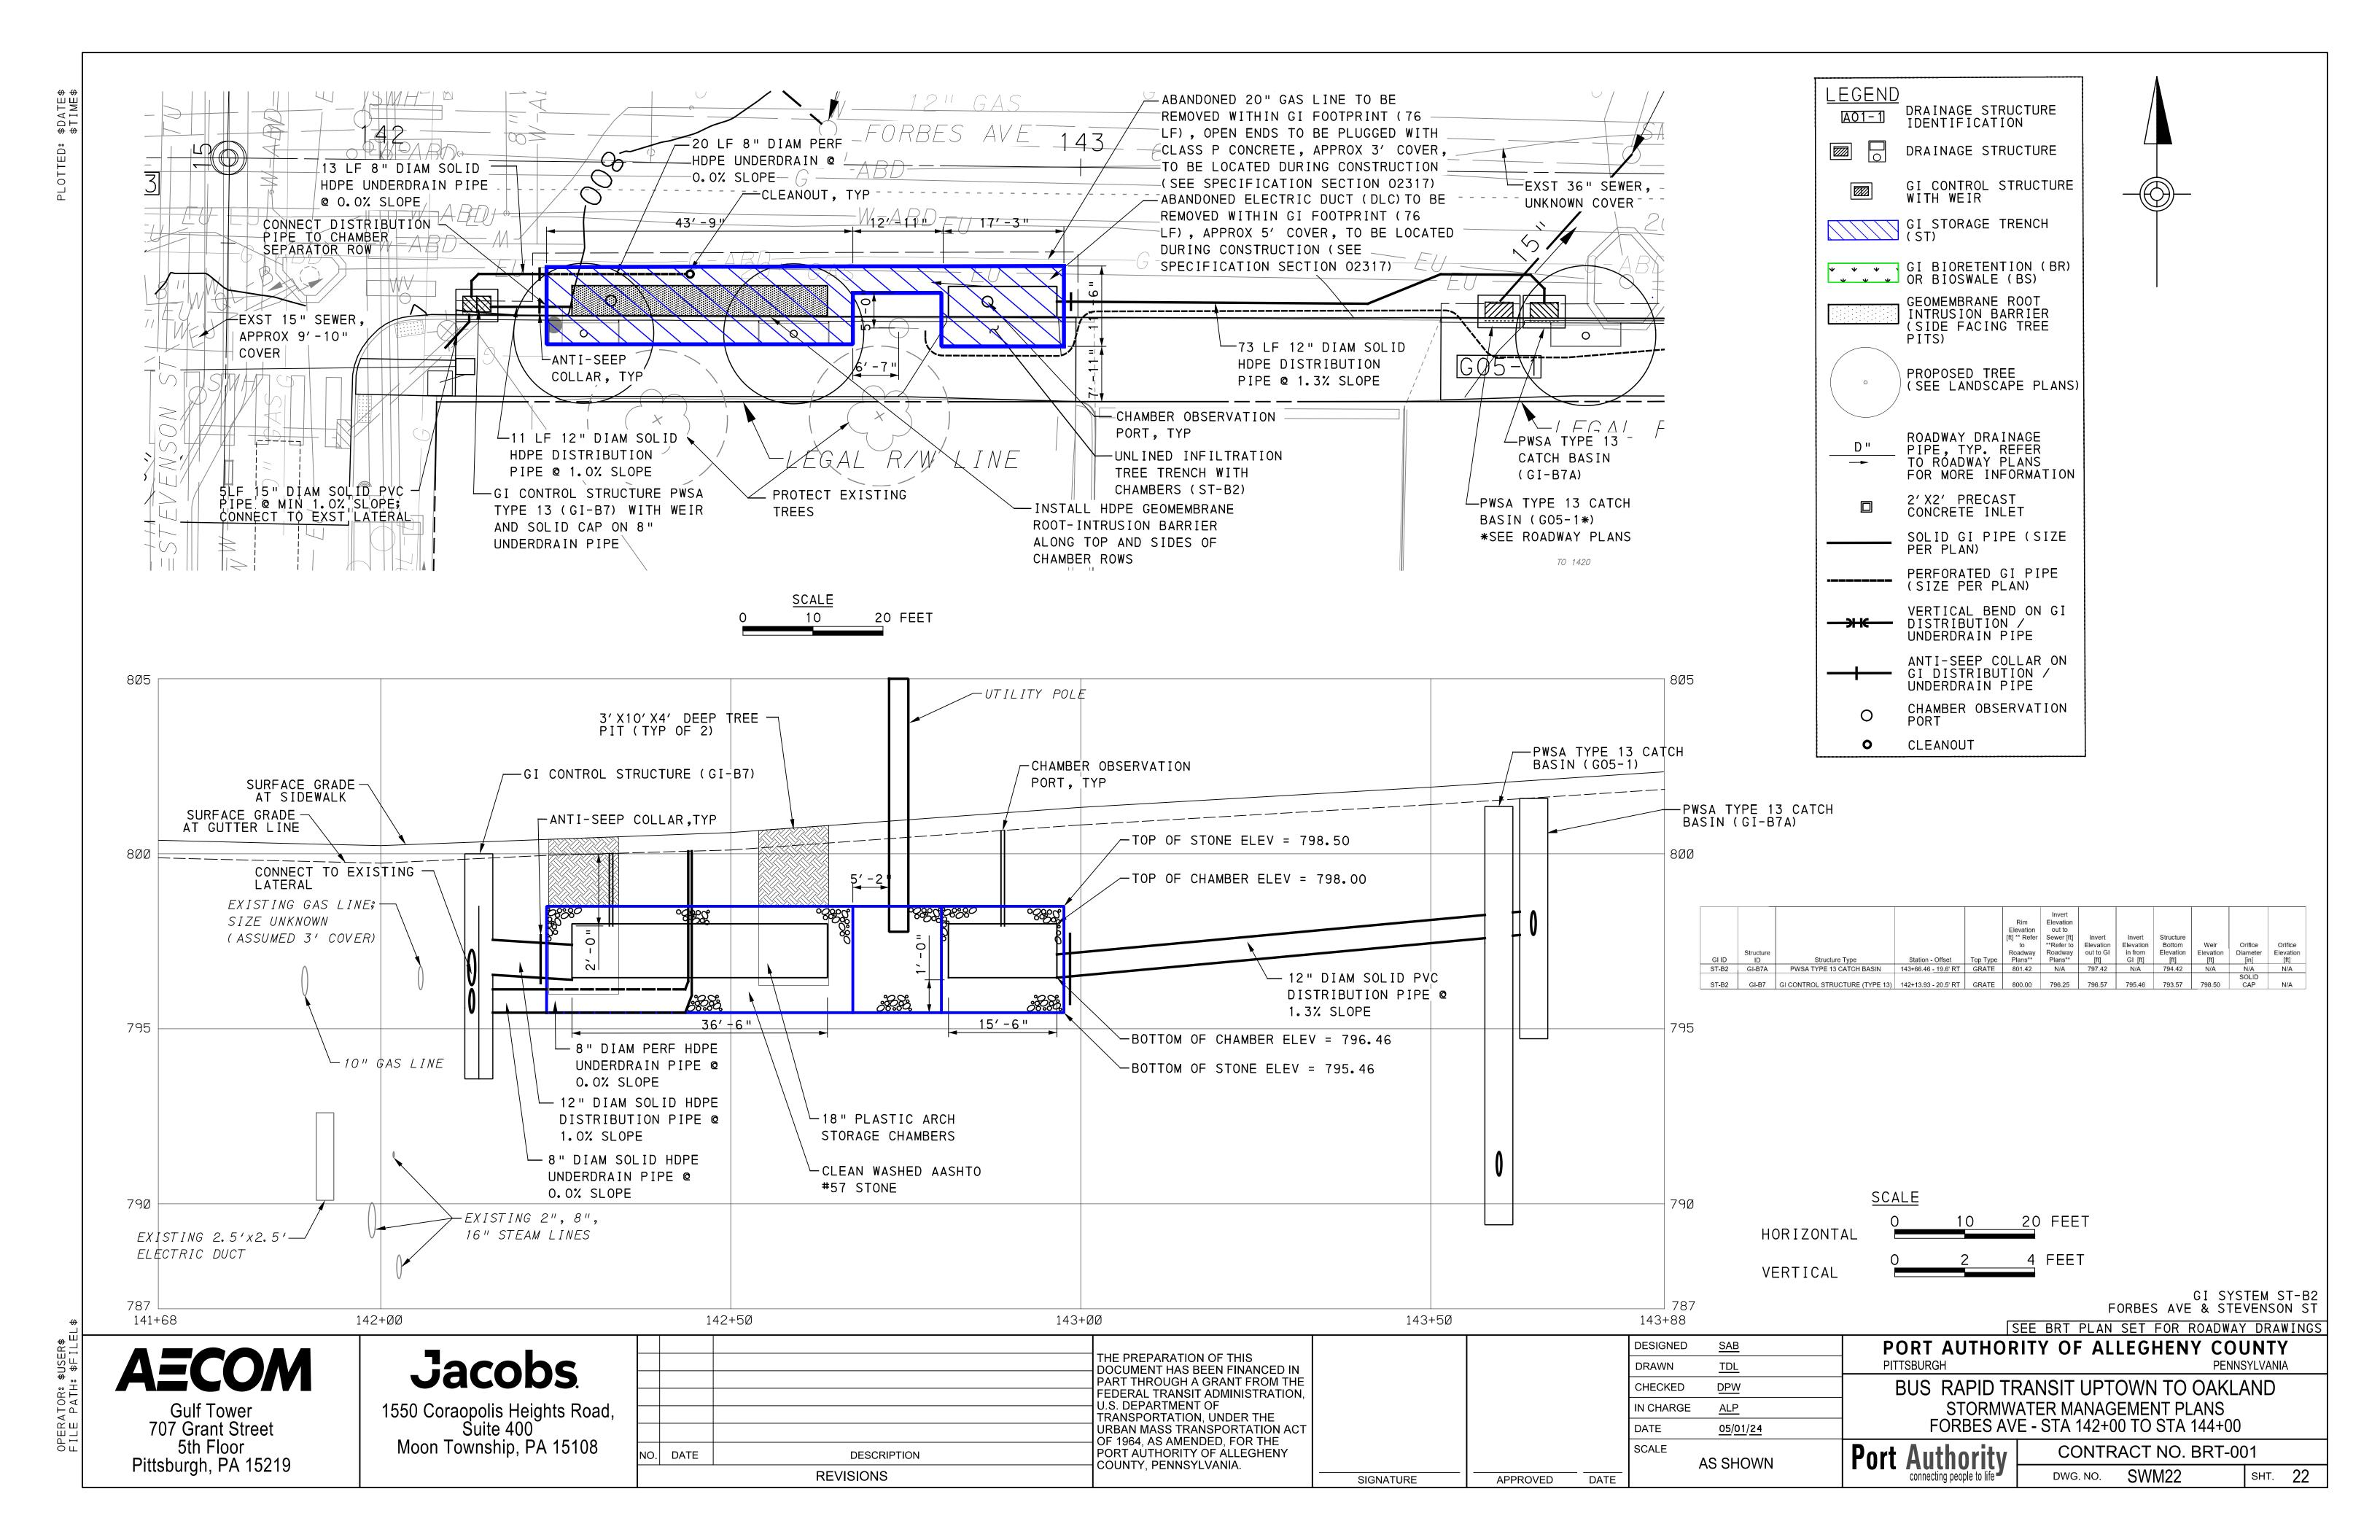


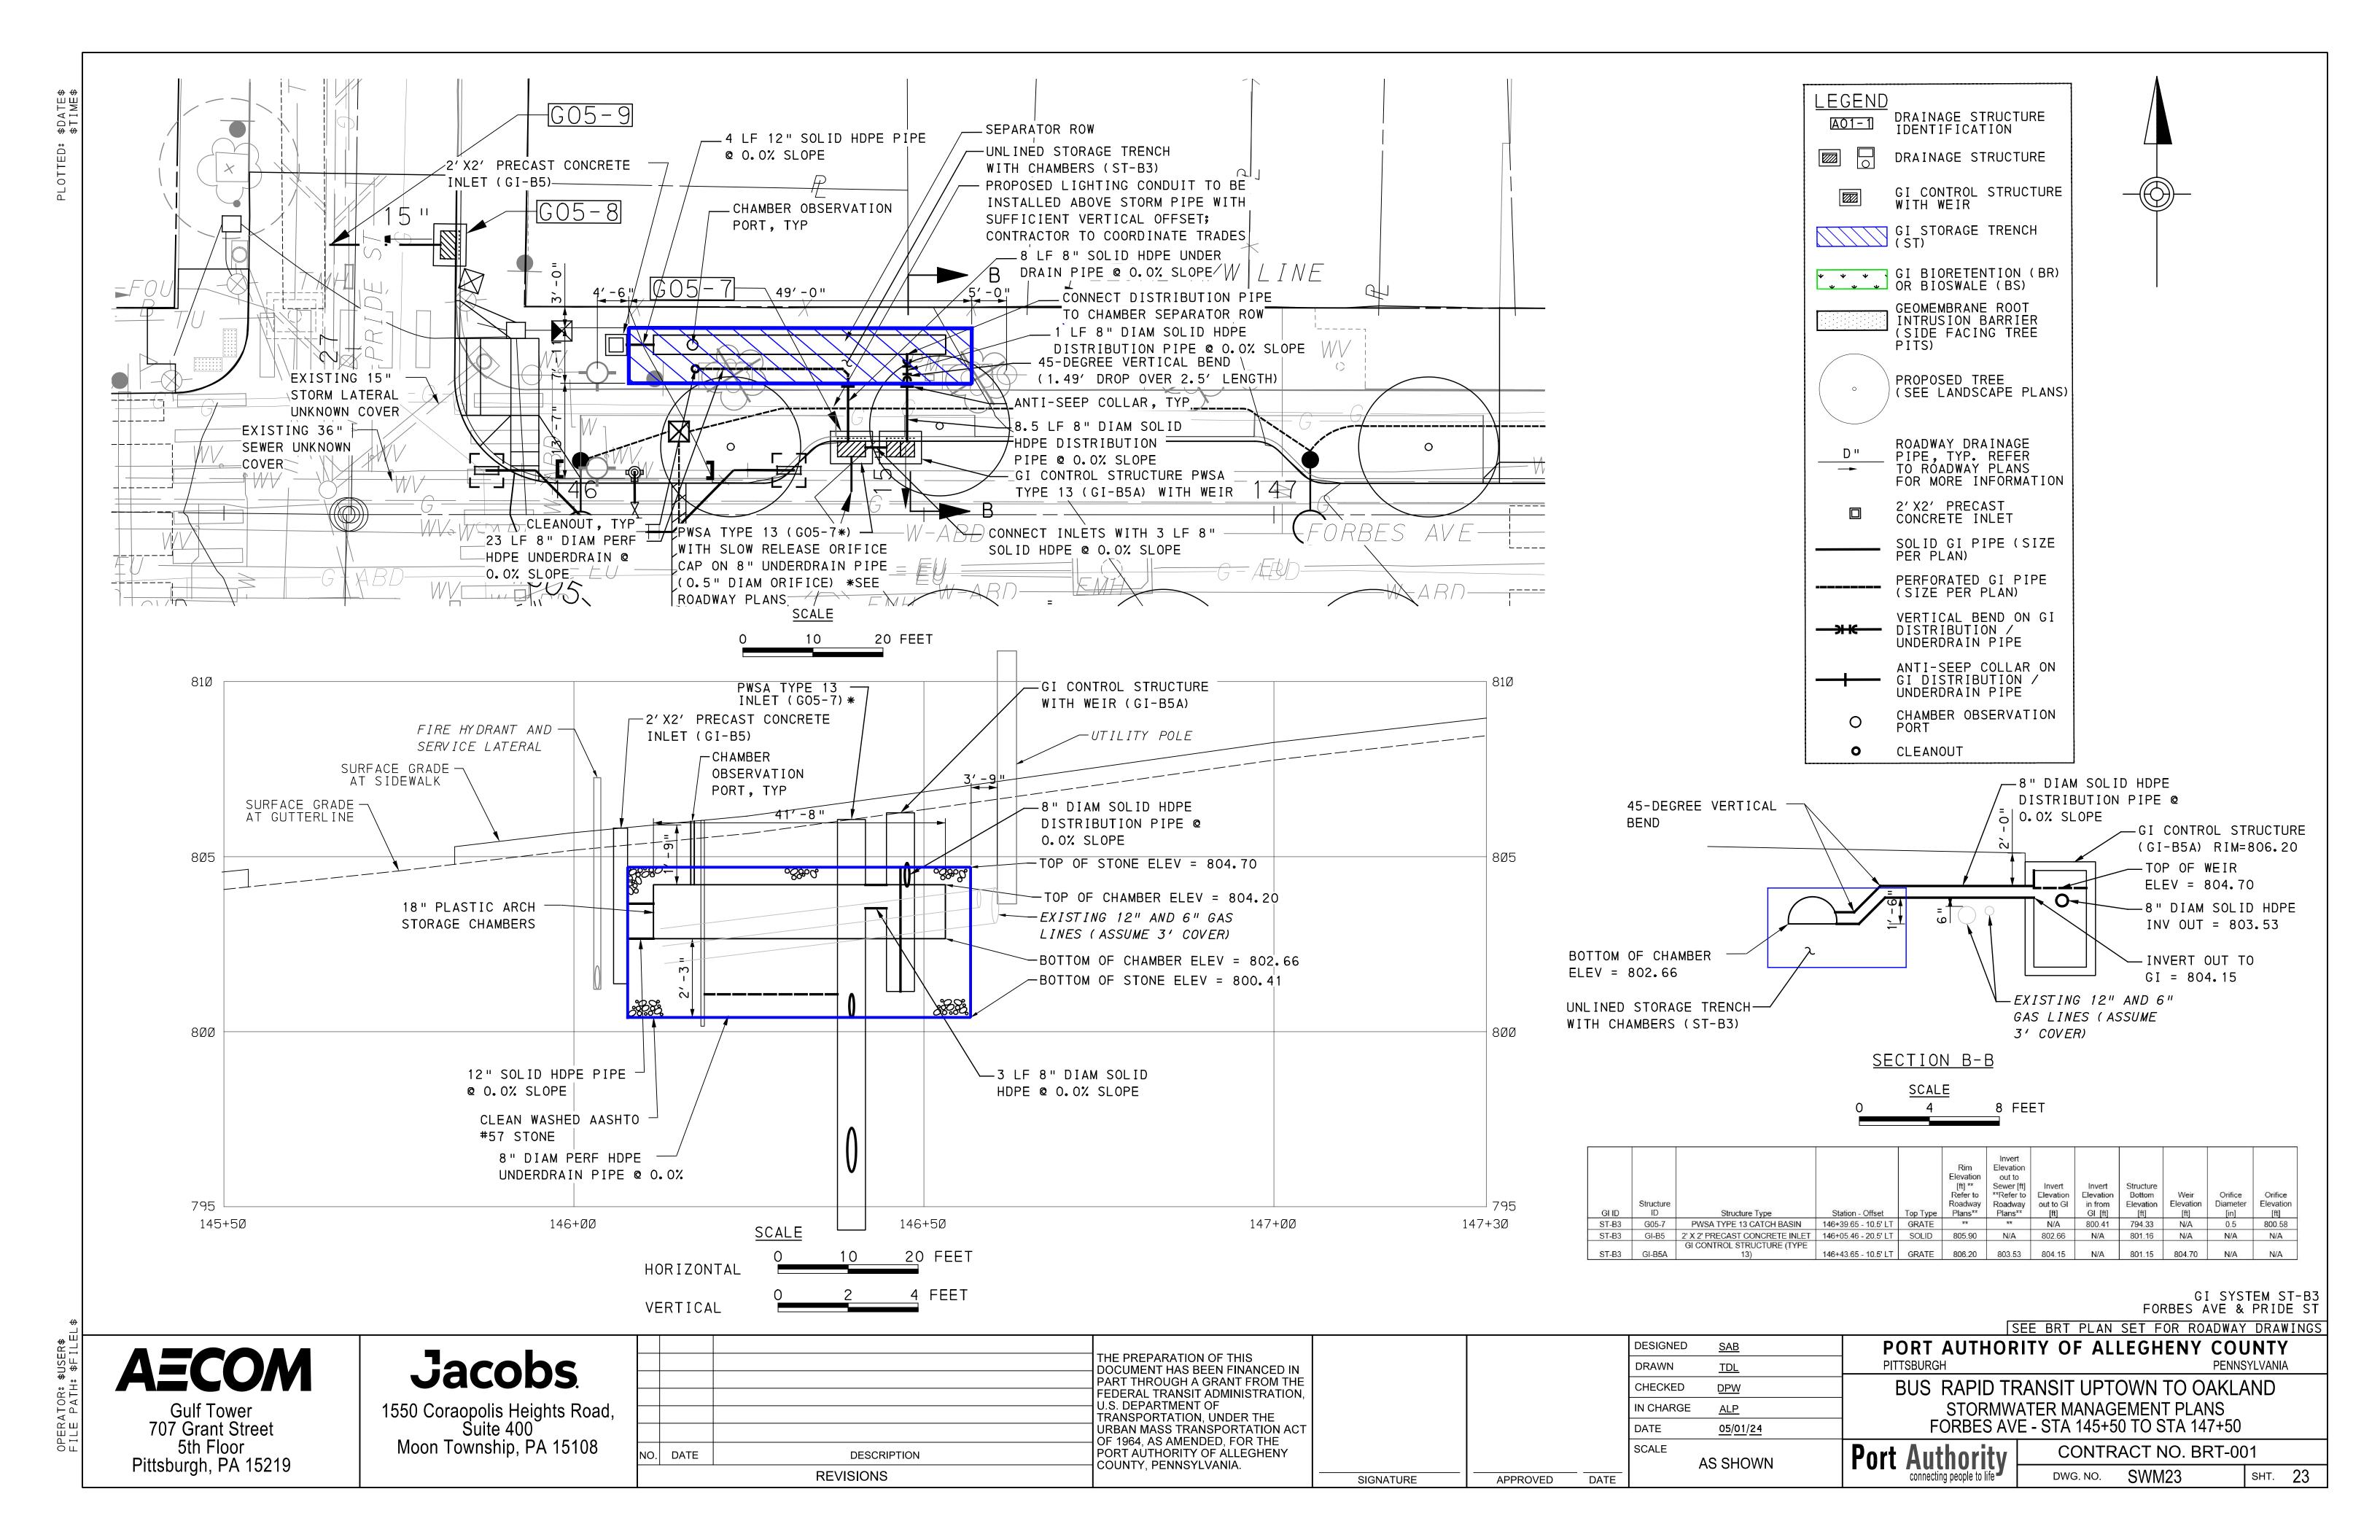


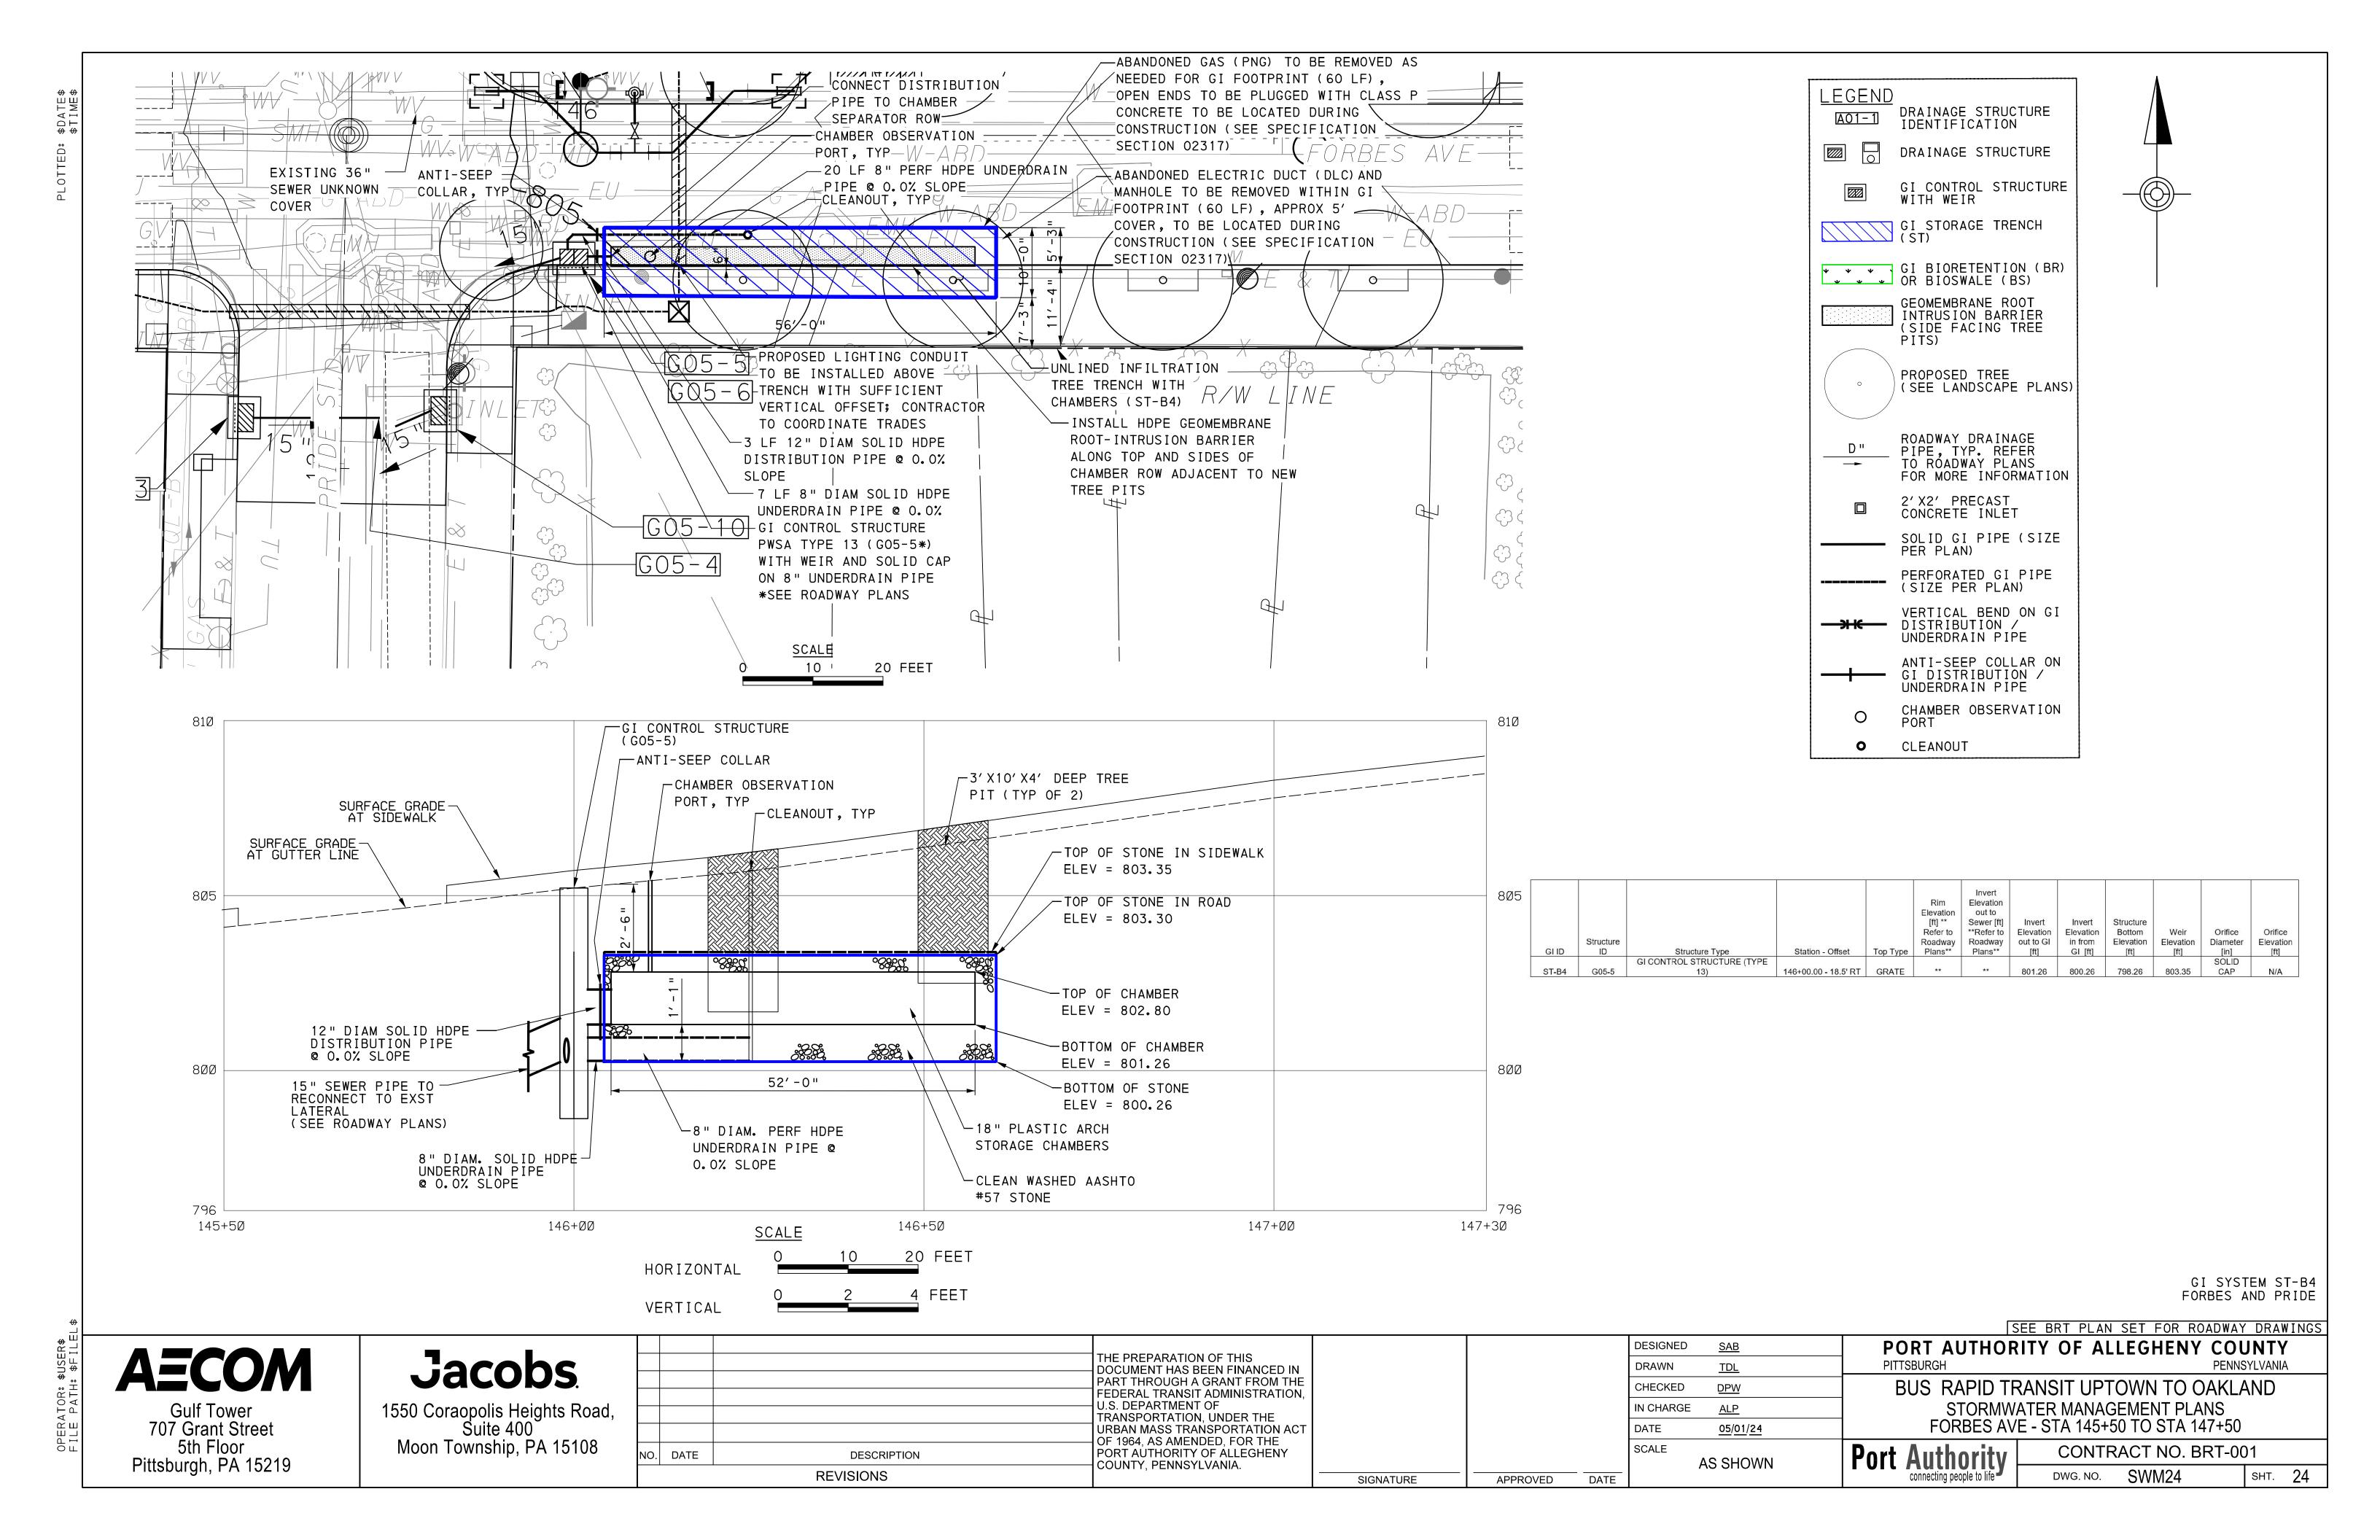


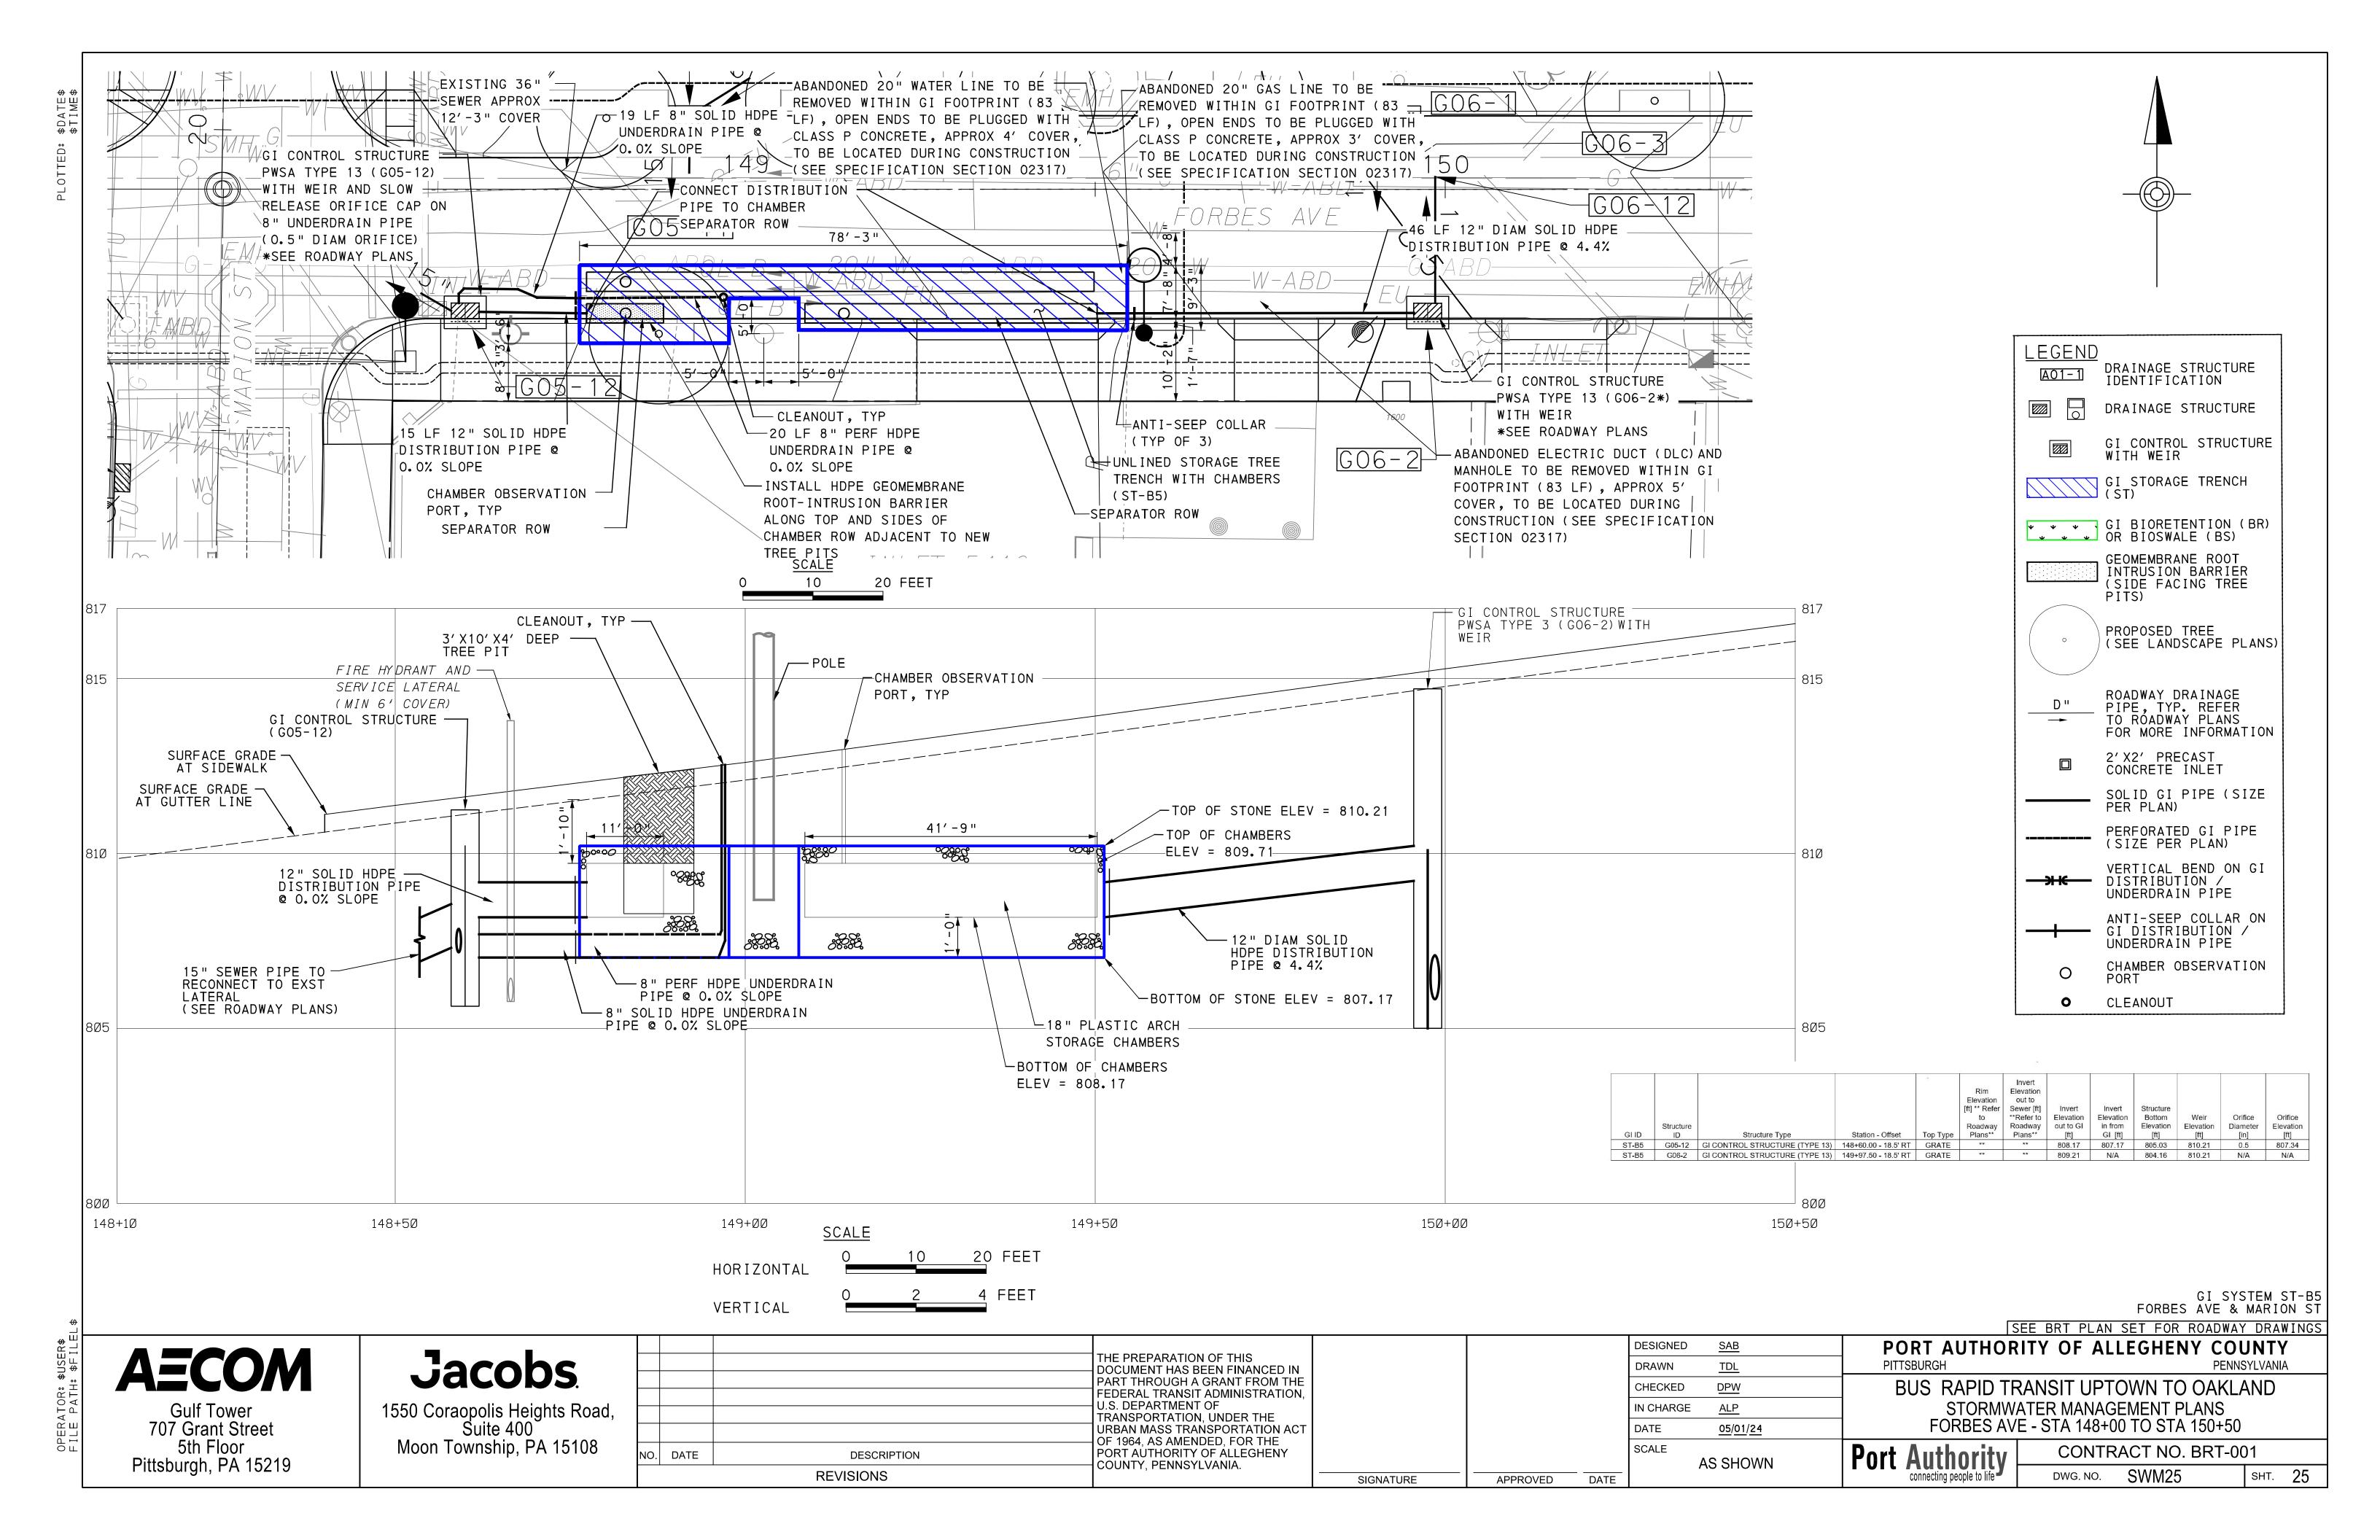


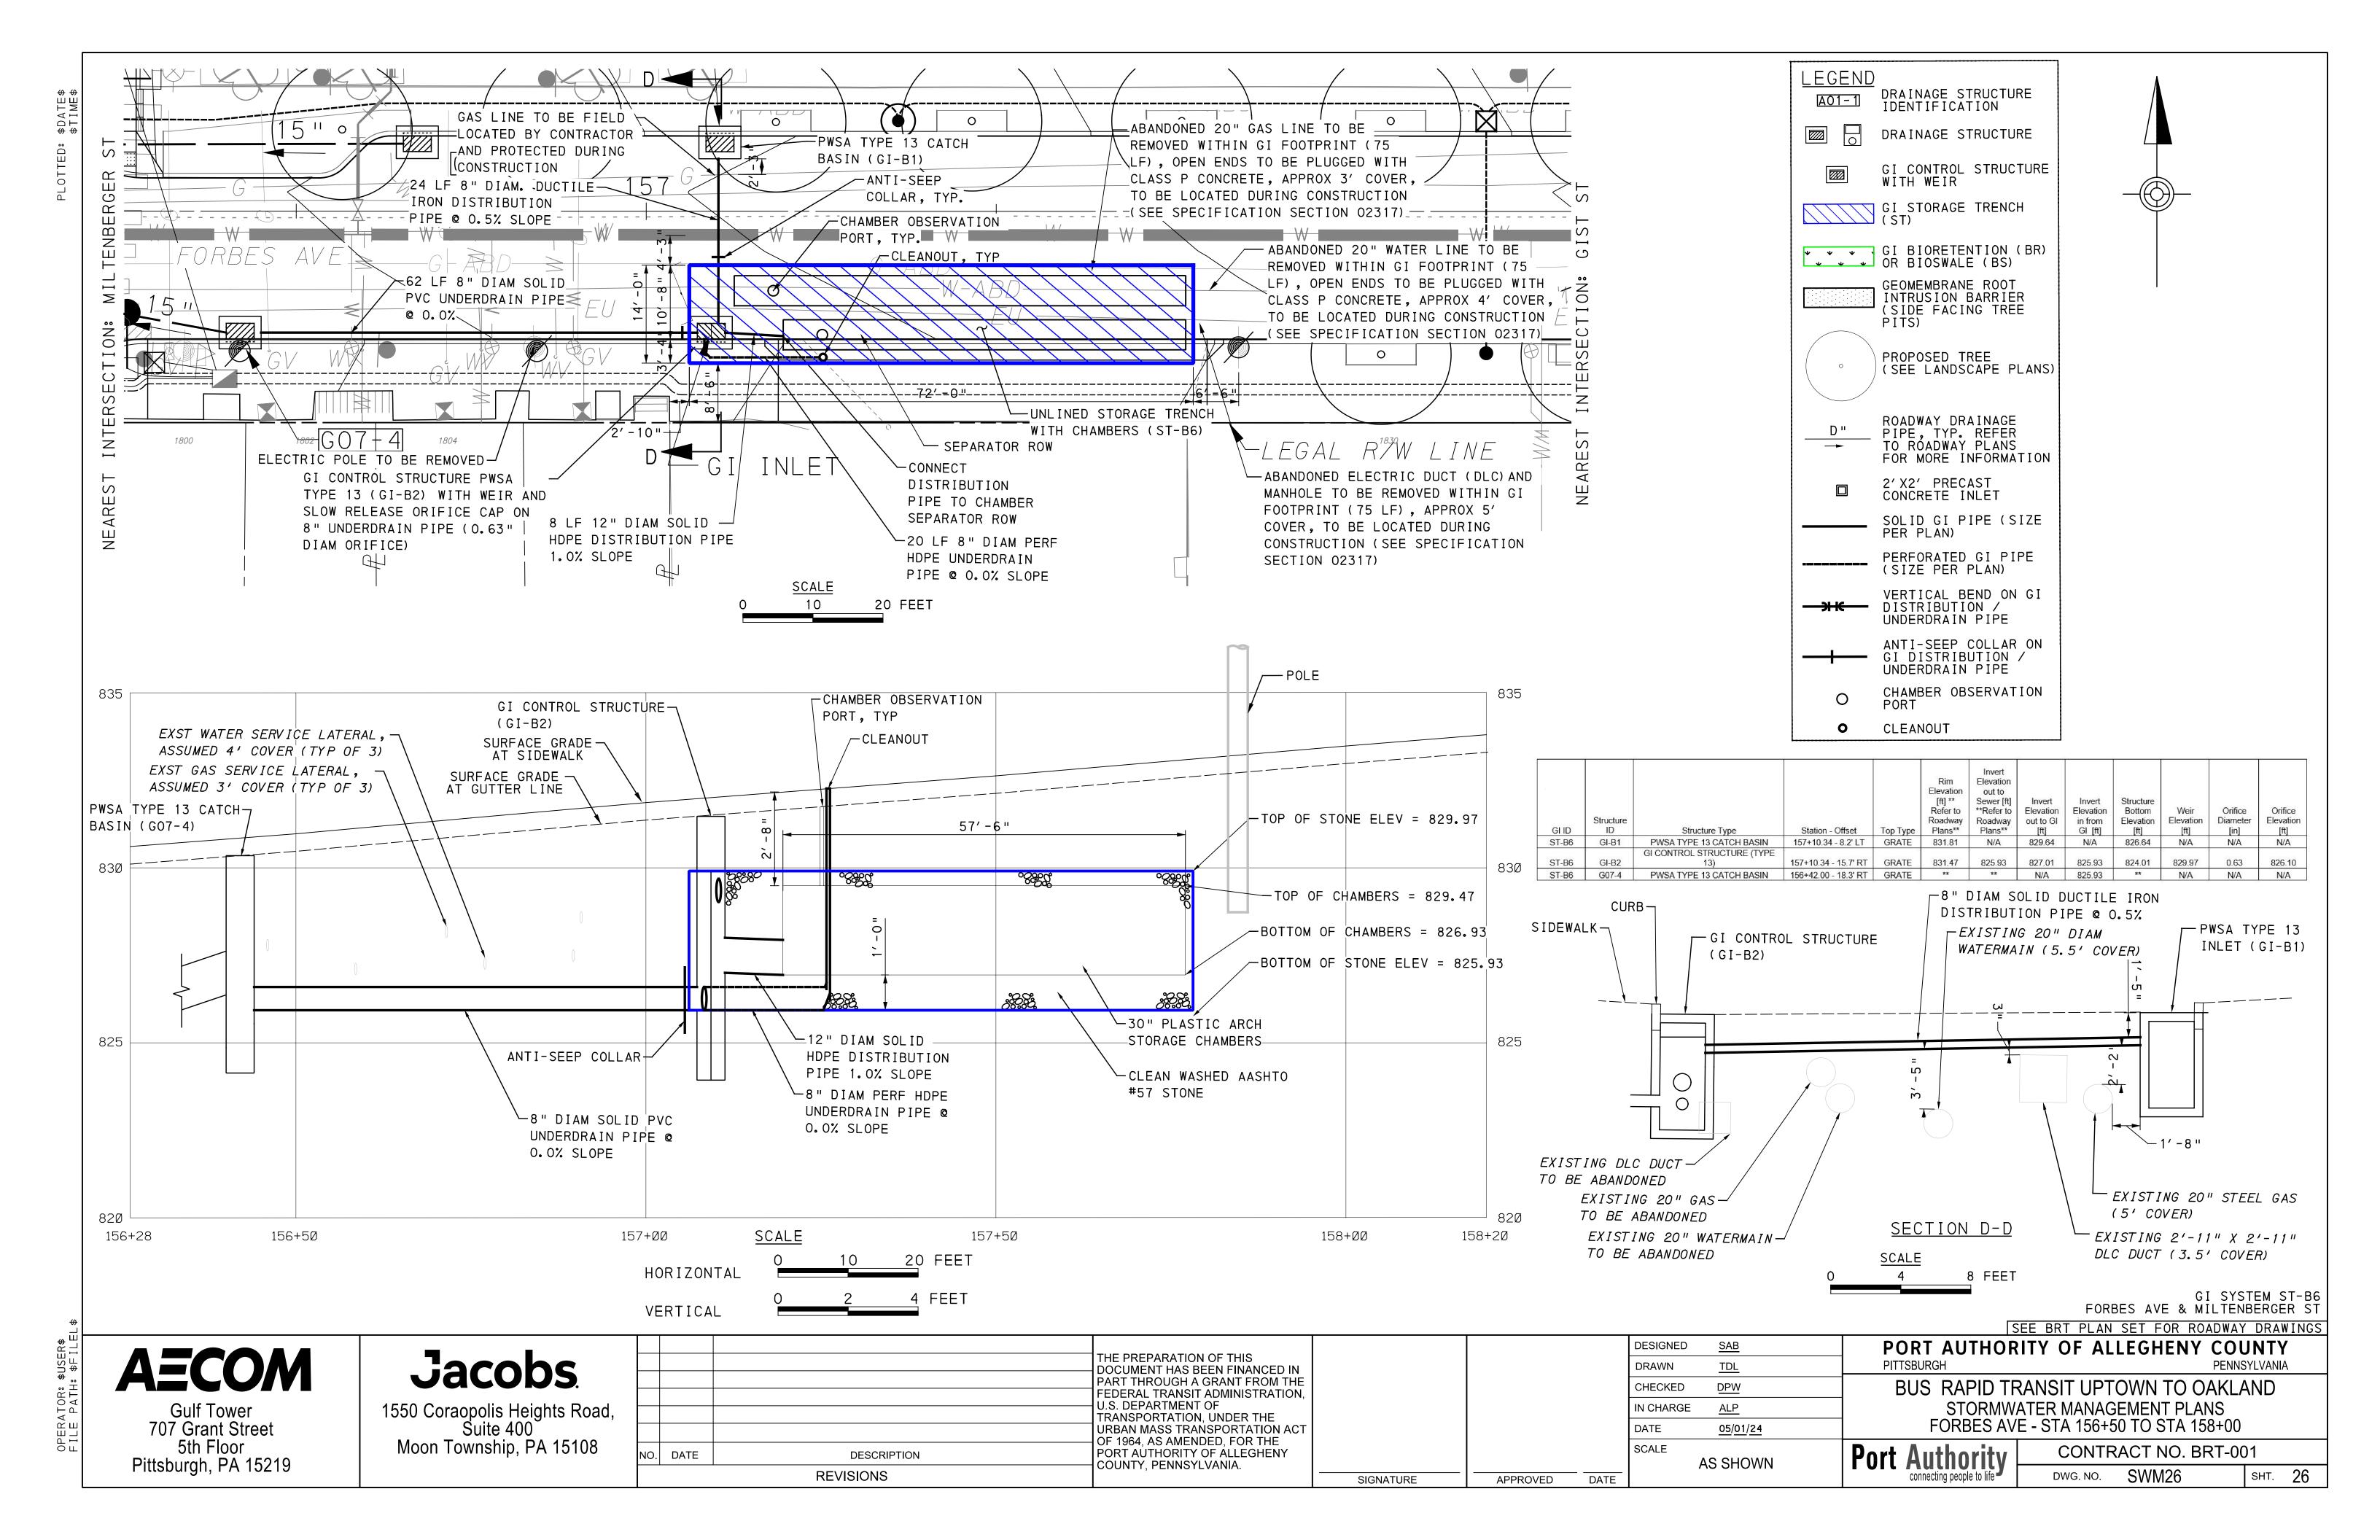


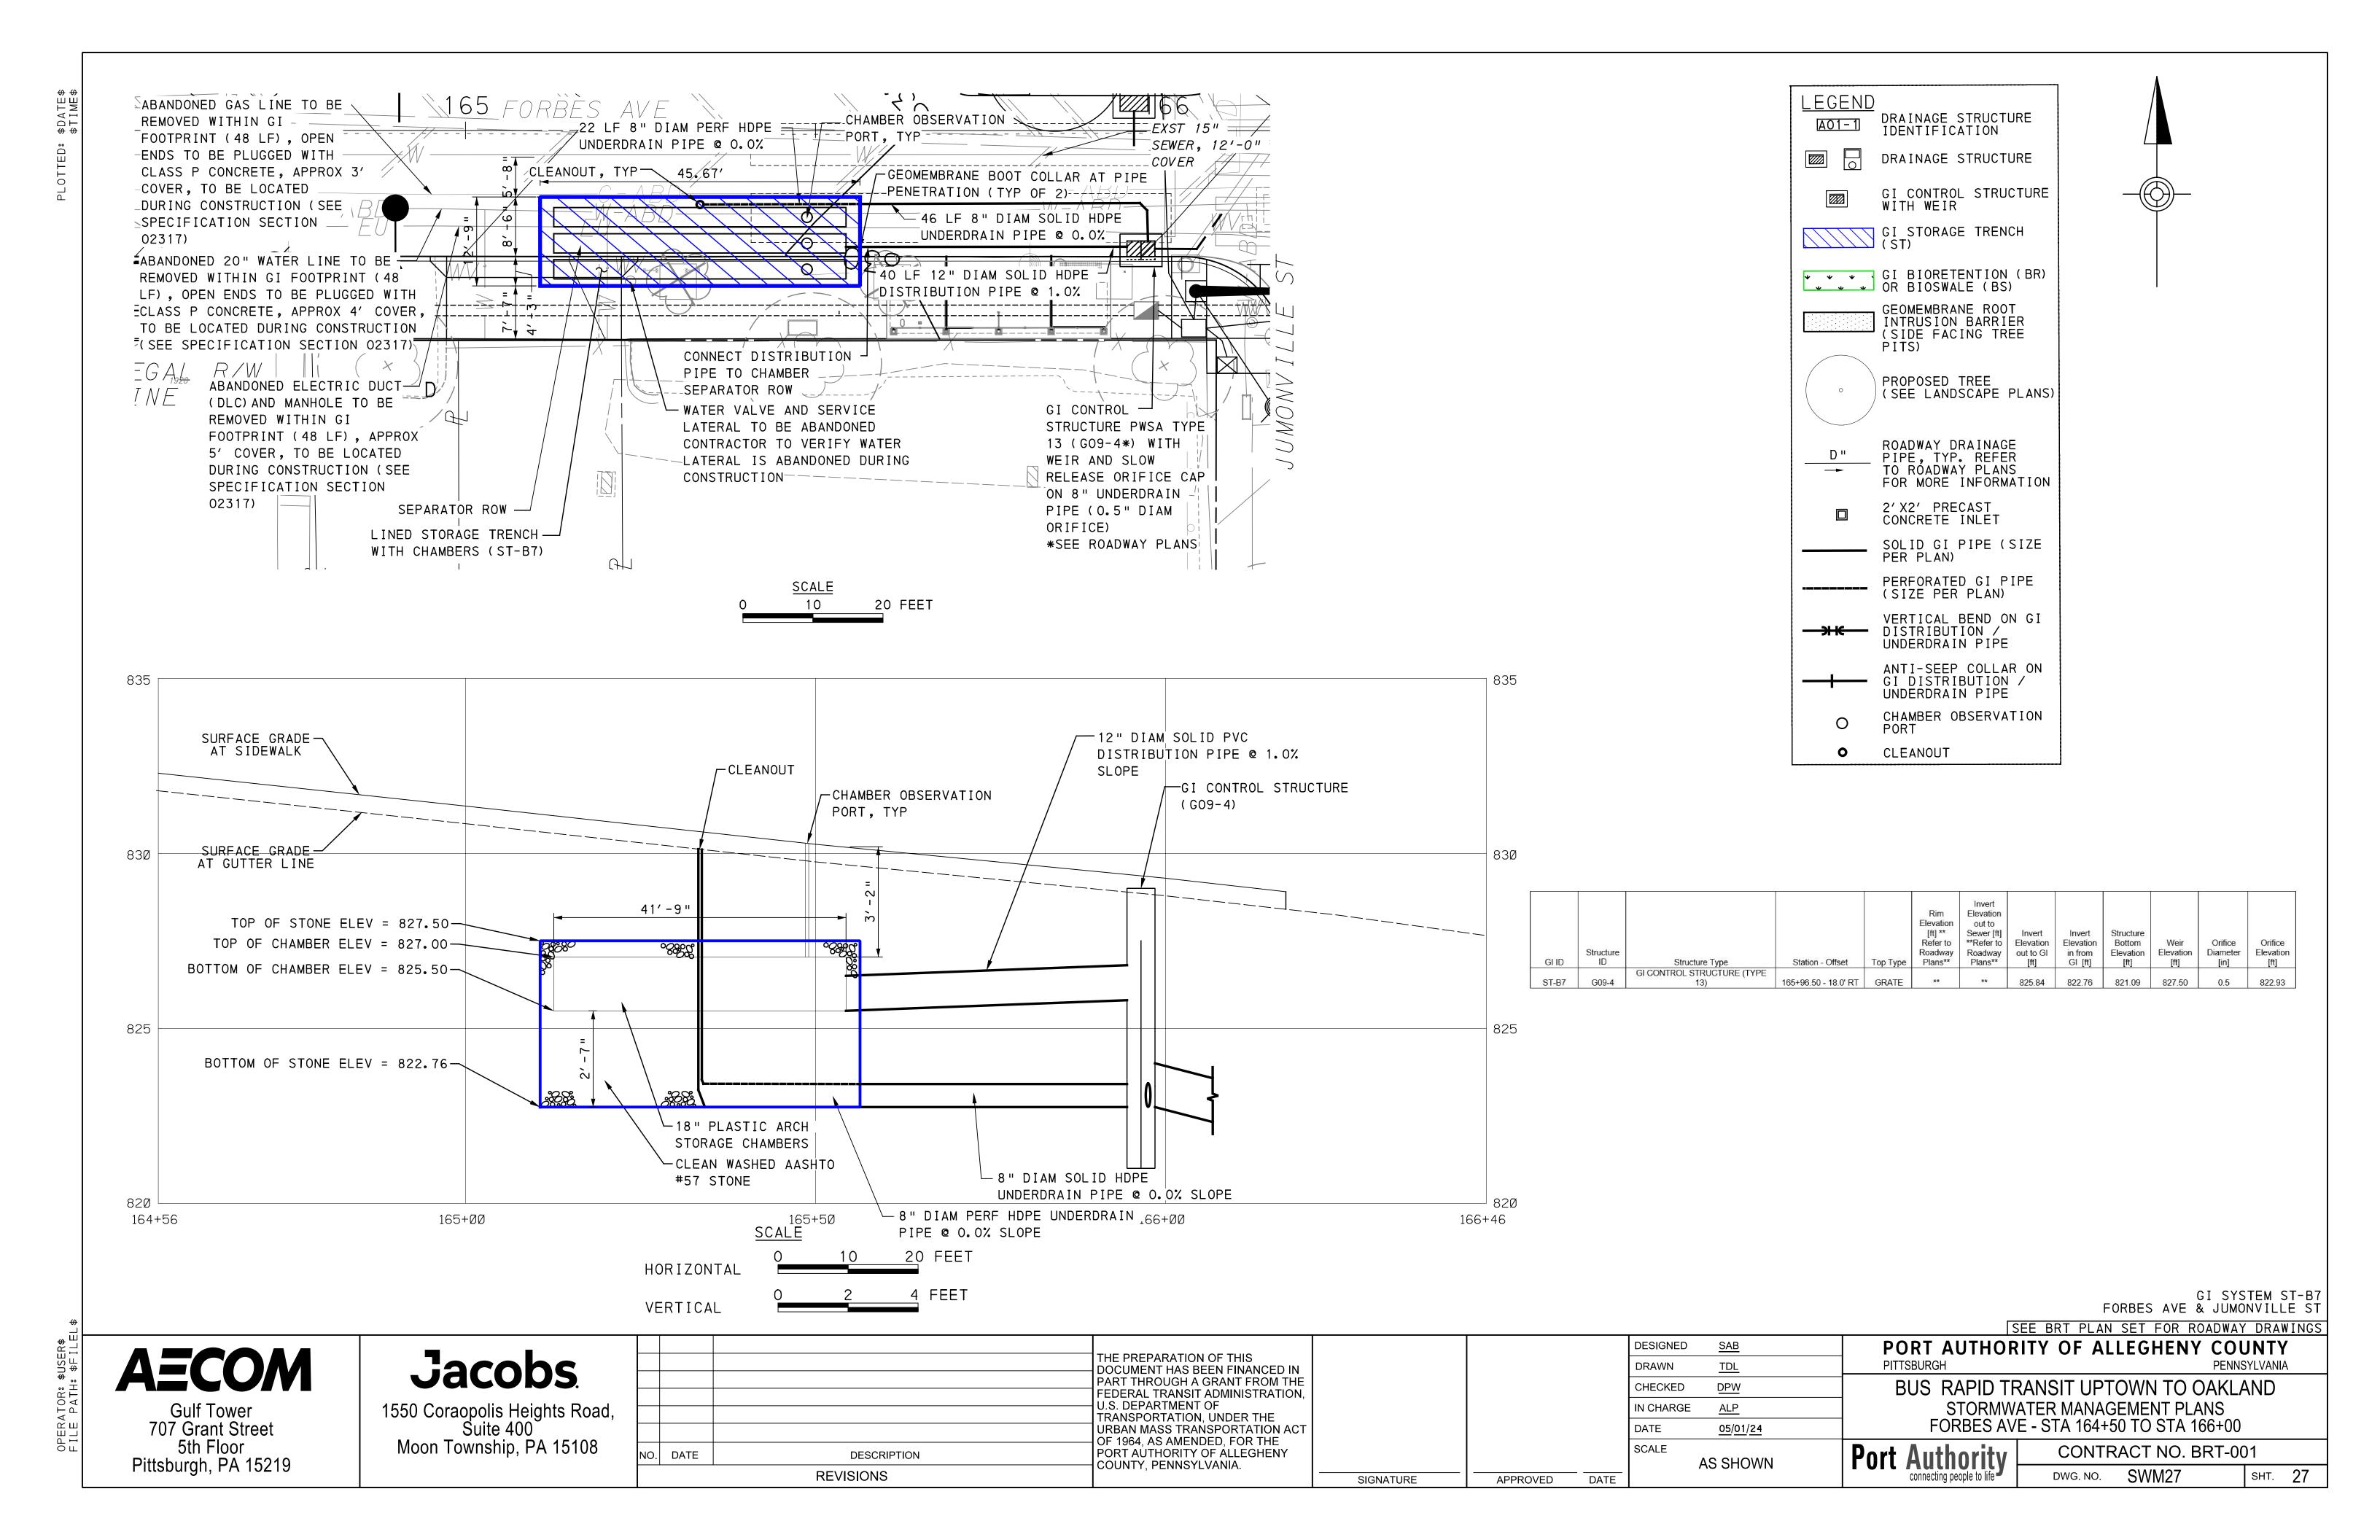

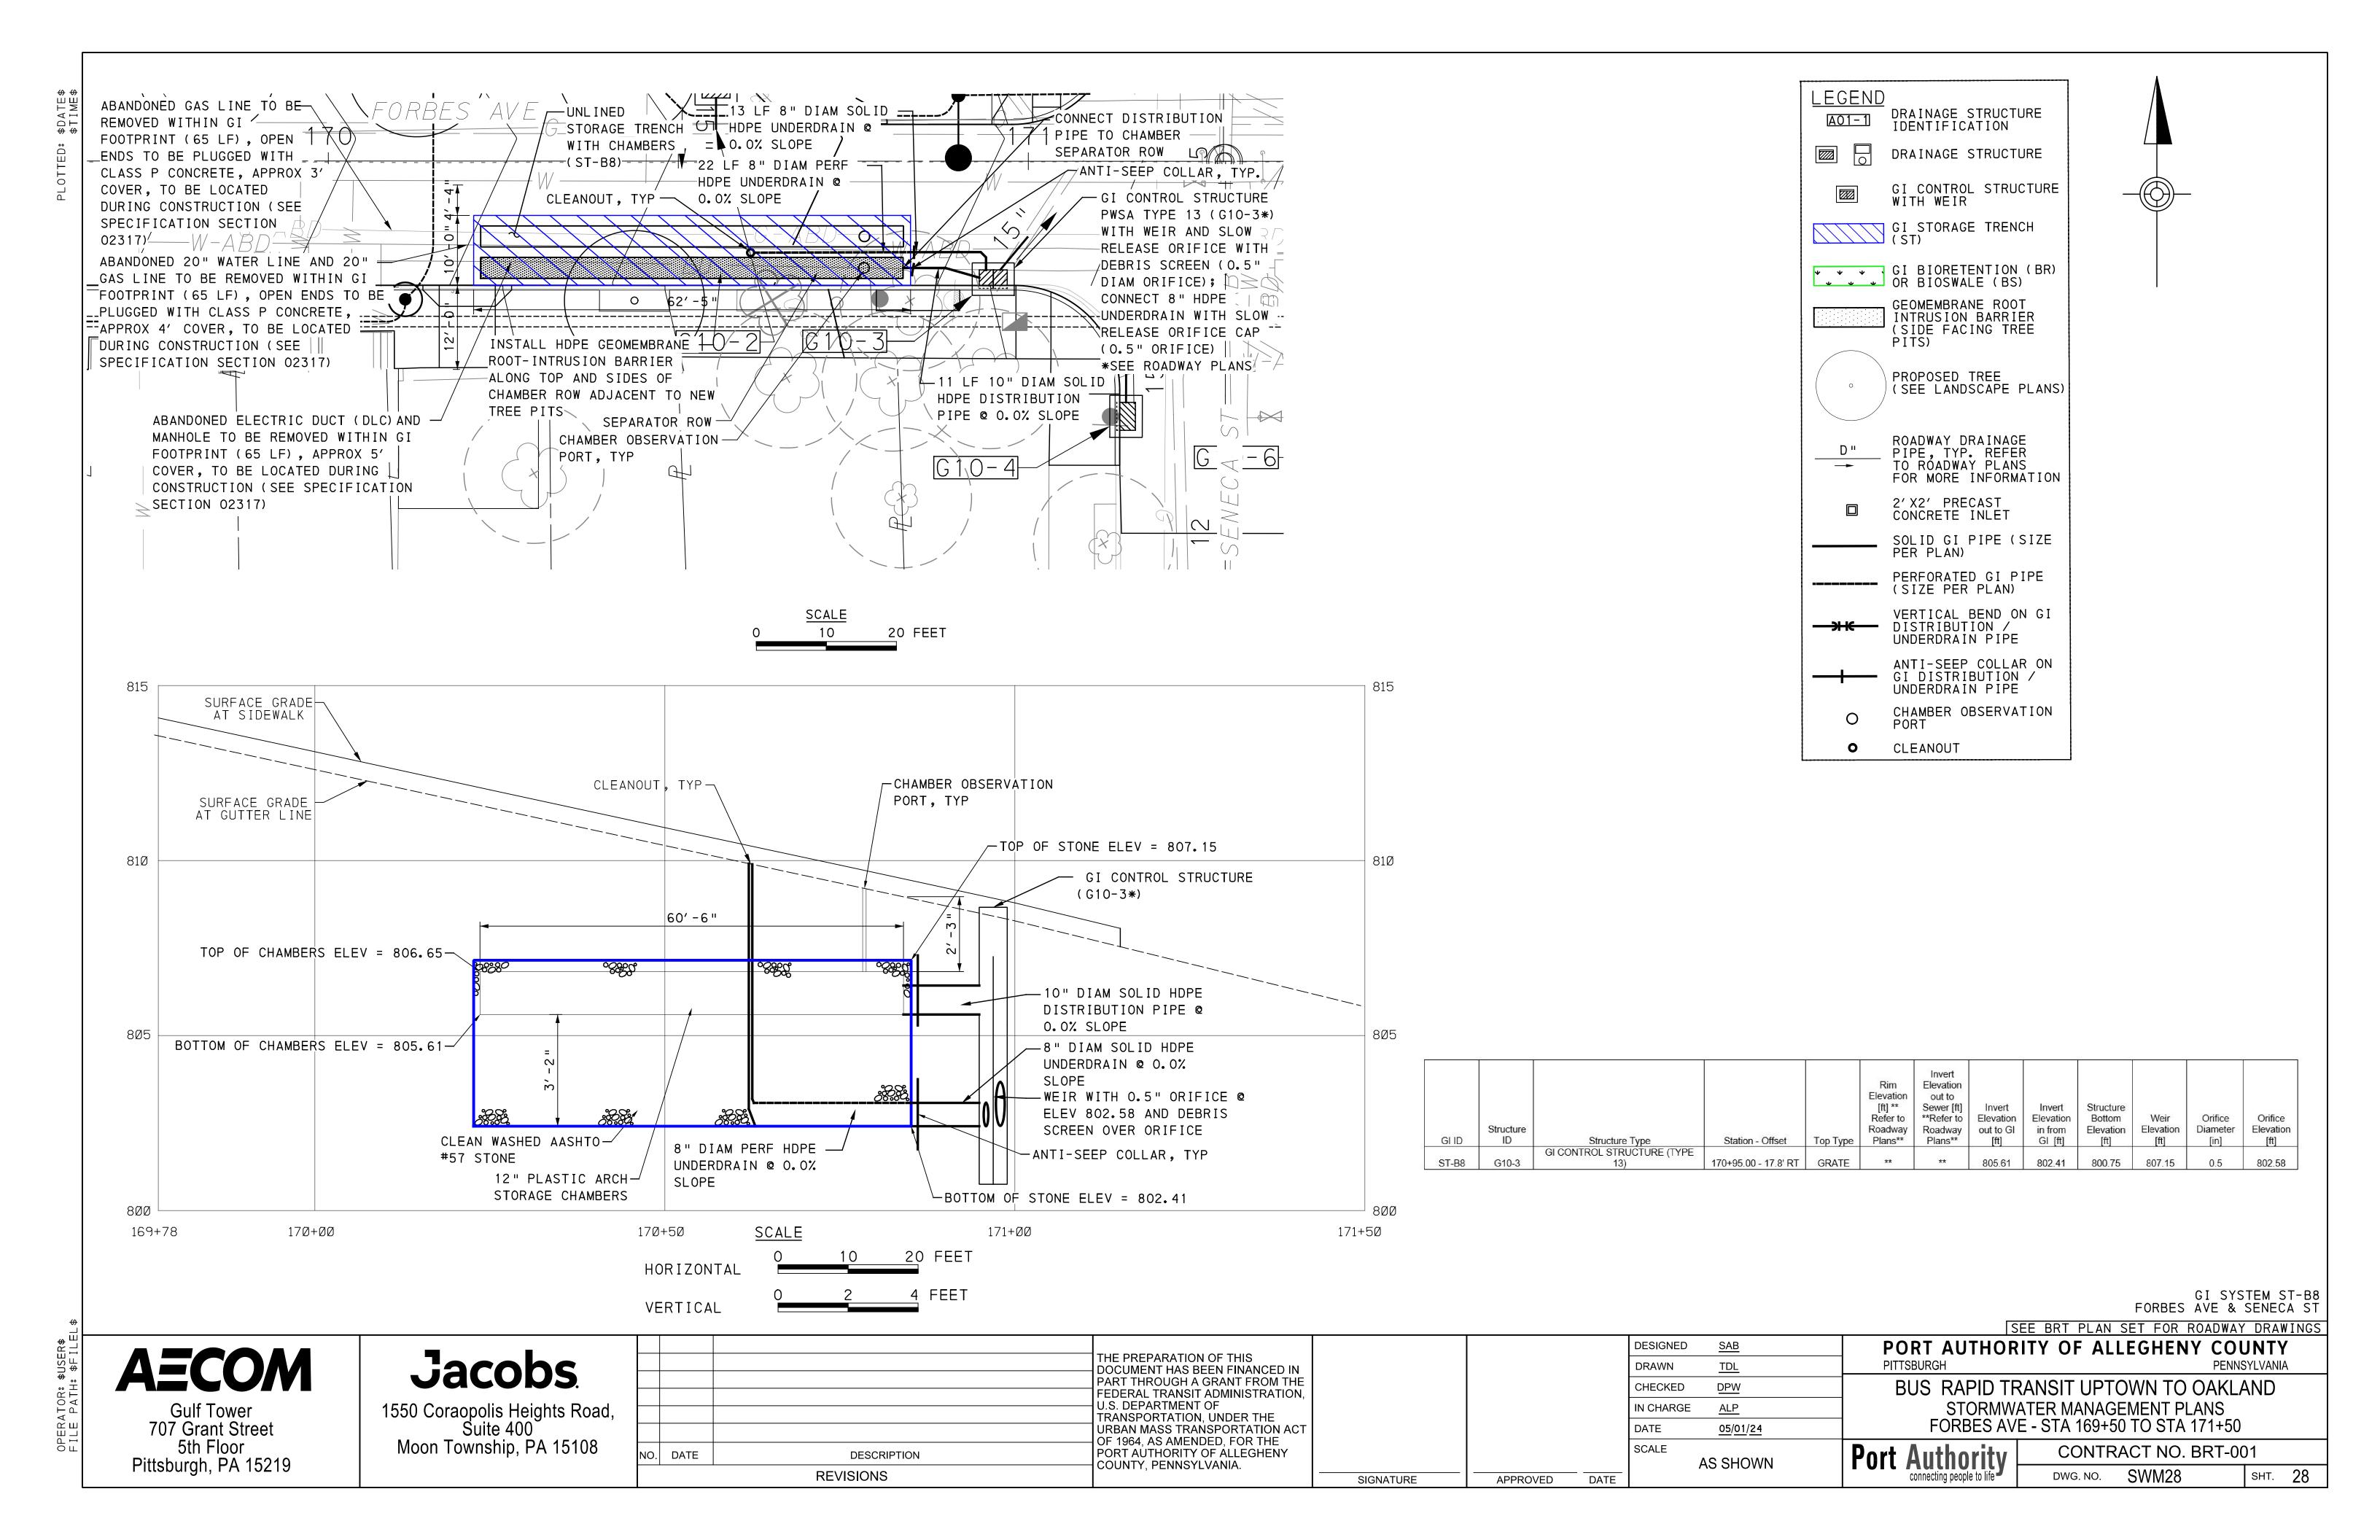

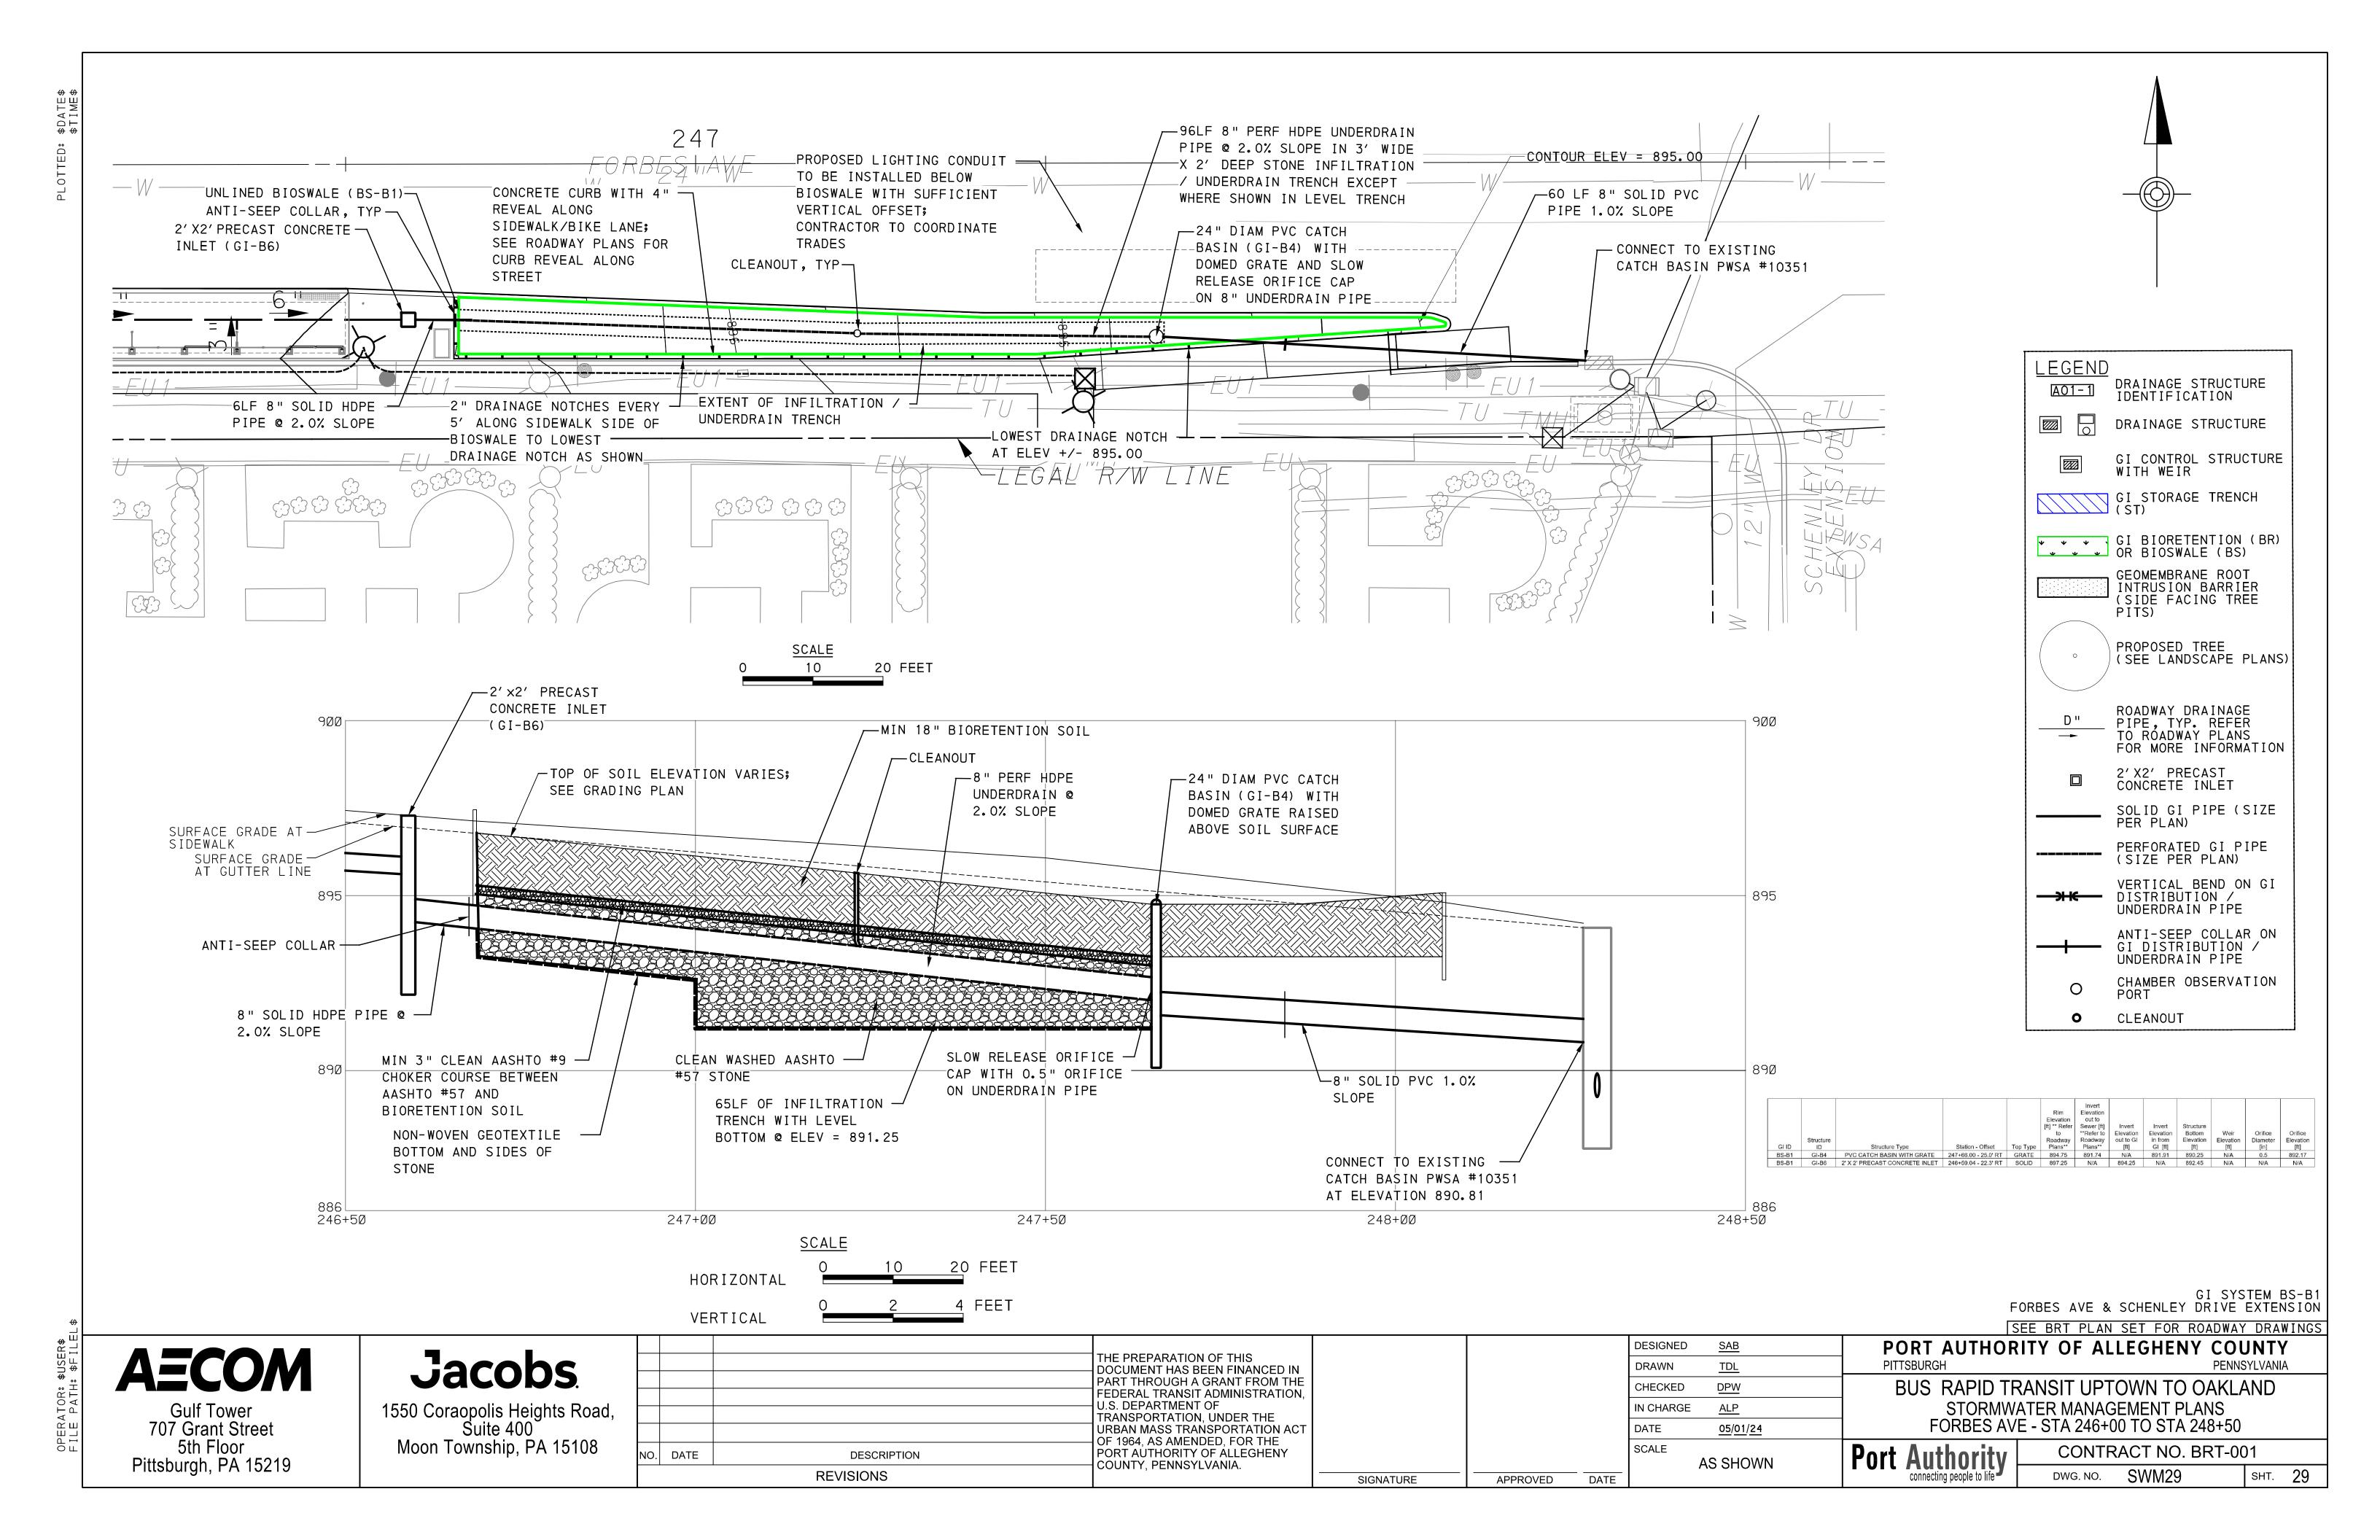

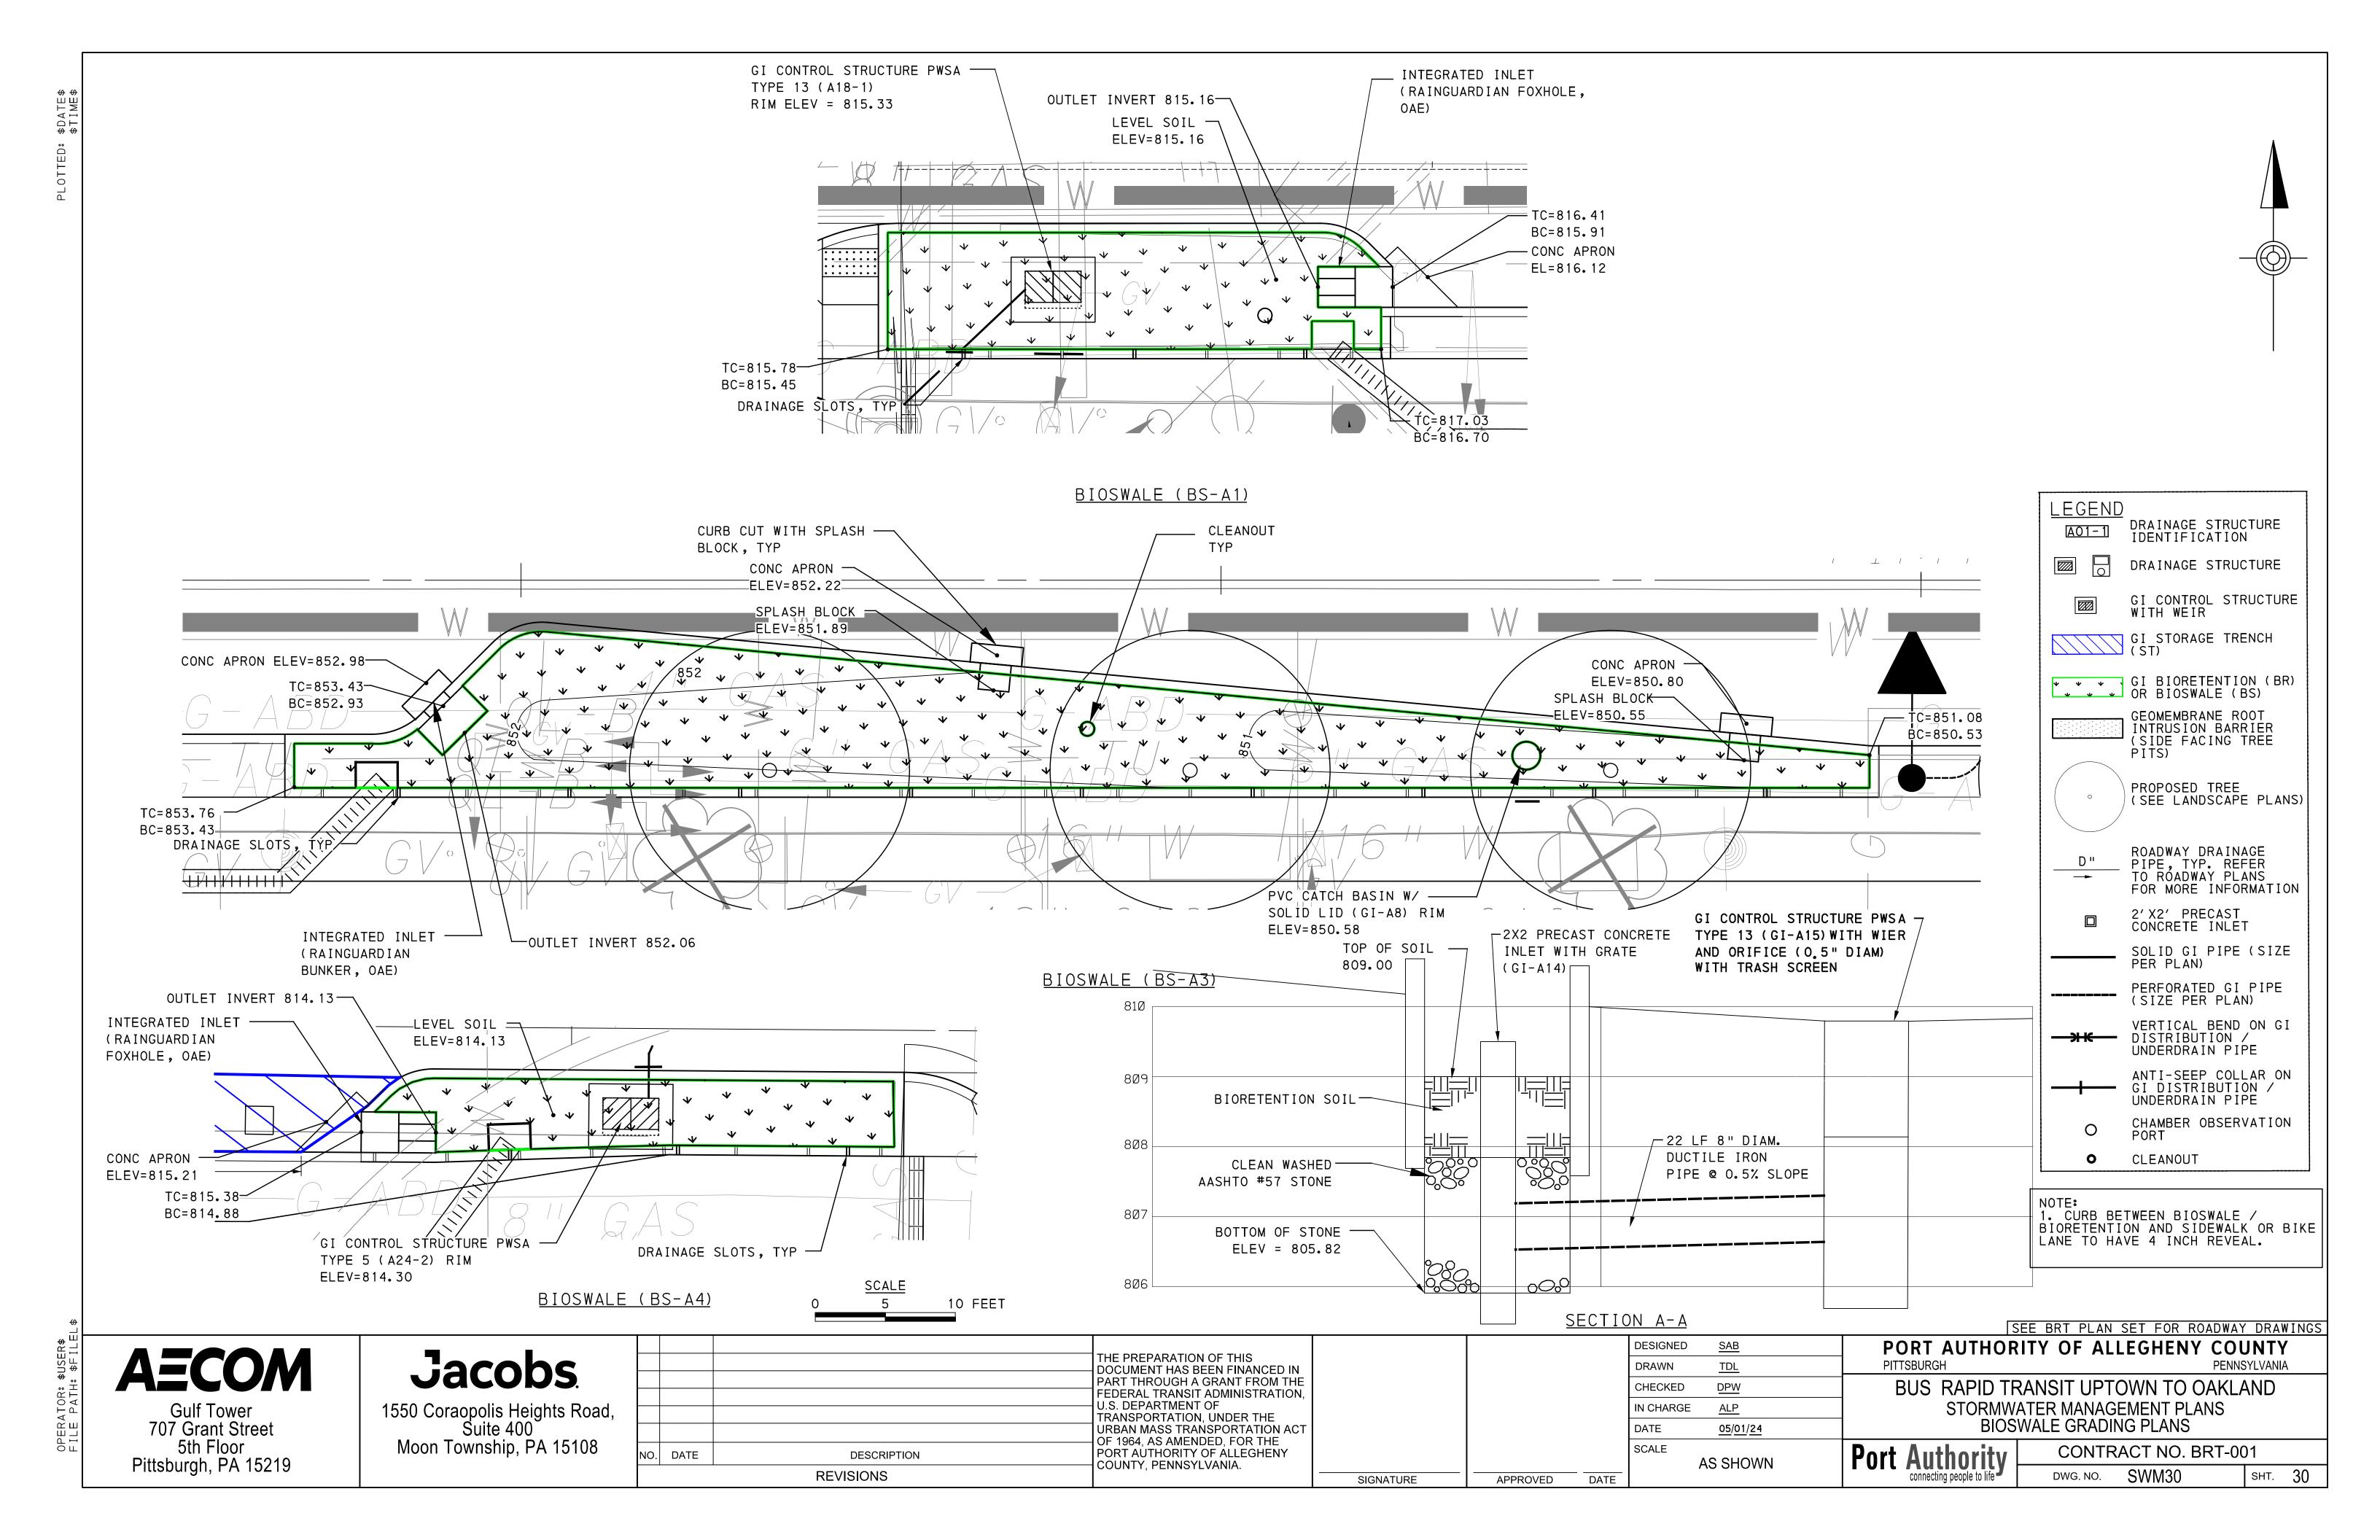

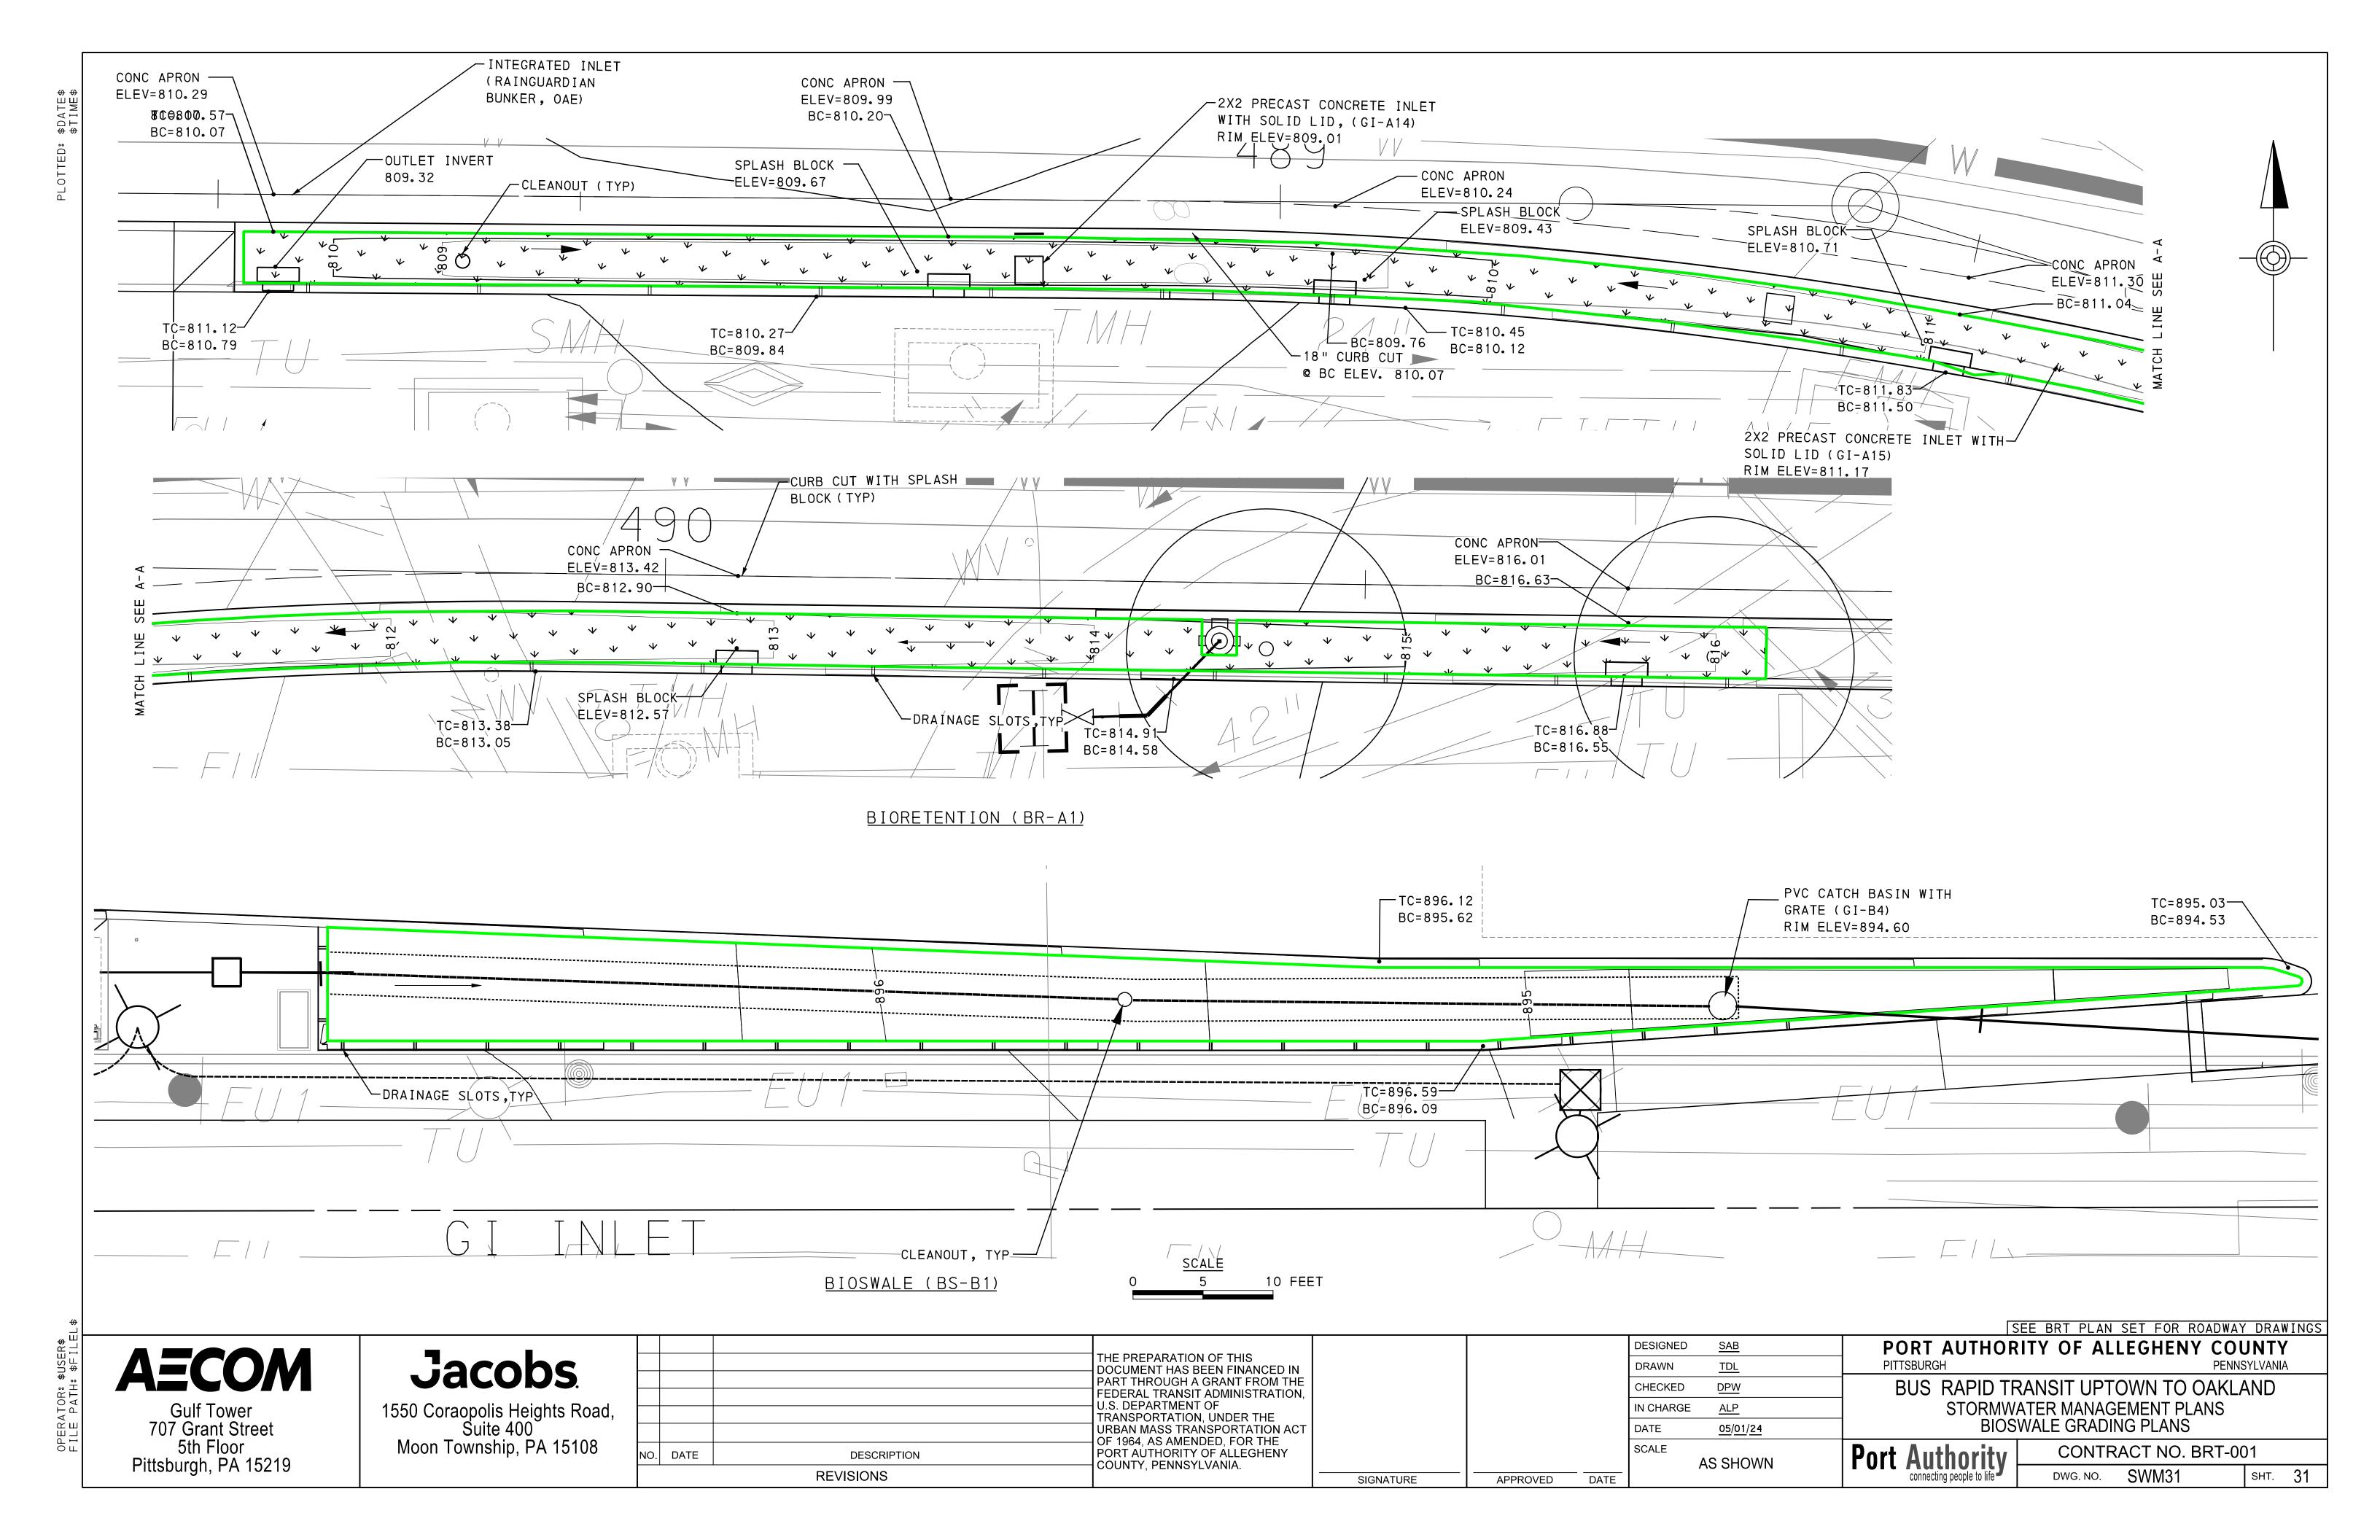


PLANT LIST

KEY	BOTANICAL NAME	COMMON NAME	QUANTITY	SIZE	NOTES/ SPACING (REFER TO DETAIL 3/SWM32)
ORNAMENTAL GRASSES					
CA	CALMAGROSTIS X ACUTIFLORA 'KARL FORESTER'	KARL FOERSTER FEATHER REED GRASS	322	#3 CONT.; FULL	18" OC
PV	PANICUM VIRGATUM 'SHENANDOAH'	SHENANDOAH SWITCHGRASS	893	#3 CONT.; FULL	24" OC
MULCH					
	DOUBLE SHREDDED NATURAL WOOD BARK MULCH (SY)		307		

QUANTITIES


- ALL PLANT MATERIAL SHALL BE OF NURSERY STOCK QUALITY AS DEFINED BY THE AMERICAN NURSERY AND LANDSCAPE ASSOCIATION AND GUARANTEED PER THE SPECIFICATIONS.
- 2. ALL DISTURBED AREAS SHALL BE SEEDED AND PLANTED WITHIN 30 DAYS OF CONSTRUCTION COMPLETION.
- REFER TO EROSION AND SEDIMENTATION CONTROL PLANS FOR TEMPORARY SCHEDULES.

- 7. DO NOT PLANT OVER CLEANOUTS, INLETS, OR OTHER SURFACE FEATURES.

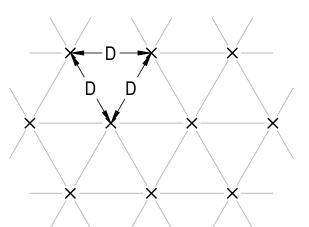

NOTES:

- "D" = PLANT SPACING CENTER LINE TO CENTER LINE. REFER TO PLANT SCHEDULE FOR ON CENTER (OC) SPACING.
- TYPICAL TRIANGULAR PLANT SPACING DIAGRAM NOT TO SCALE

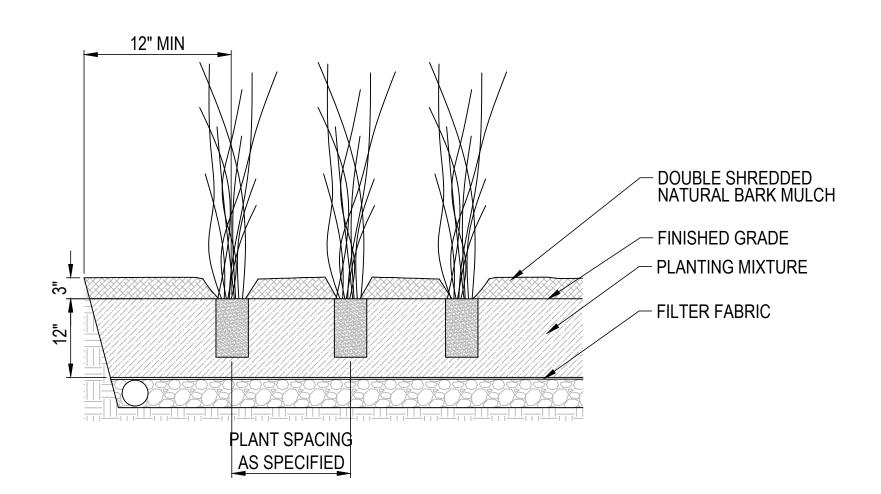

TYPICAL PLANTING - ORNAMENTAL GRASSES

NOT TO SCALE

SHENANDOAH SWITCHGRASS



KARL FOERSTER FEATHER REED GRASS



NO. DATE

PLANT IMAGES

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	TRANSPORTATION, UNDER THE
	URBAN MASS TRÁNSPORTATION A OF 1964, AS AMENDED, FOR THE
	PORT AUTHORITY OF ALLEGHENY COUNTY, PENNSYLVANIA.
REVISIONS	COOTTI, I EININGTE VAINA.

1	100% DESIGN
1	SUBMITTAL
, CT	NOT FOR CONSTRUCTION

SIGNATURE

DESIGNED	MG	
DRAWN	BB	
CHECKED	SM	
IN CHARGE	MDA	
DATE	03/25/24	
SCALE	AS SHOWN	

PORT AUTHORITY OF ALLEGHENY COUNTY
PITTSBURGH PENNSYLVANIA
BUS RAPID TRANSIT GREEN INFRASTRUCTURE LANDSCAPE PLANS
Dani Anthanita

Port Authority connecting people to life DWG. NO. SWM32

sнт. **32**

NO UNDERGROUND UTILITIES HAVE BEEN SHOWN ON THESE PLANS. IT IS THE RESPONSIBILITY OF THE CONTRACTOR TO USE CARE AND NOT DISRUPT ANY EXISTING UTILITY, ABOVE OR BELOW GROUND.


5. SHOULD DISCREPANCY ARISE BETWEEN THE LANDSCAPE PLAN AND PLANT SCHEDULE, THE PLAN SHALL GOVERN AS TO THE QUANTITY OF PLANT MATERIAL.

HAND WATER TO ESTABLISH PLANTINGS. NO PERMANENT IRRIGATION IS REQUIRED. WATER WELL AFTER PLANTING, SOAKING THE ENTIRE AREA. NEW PLANTS WILL REQUIRE AN INCH OF WATER PER WEEK. IT IS THE RESPONSIBILITY OF THE CONTRACTOR TO ENSURE THE HEALTH OF THE PLANTS.

LANDSCAPE NOTES

ED IN M THI ΪΟΝ,

APPROVED

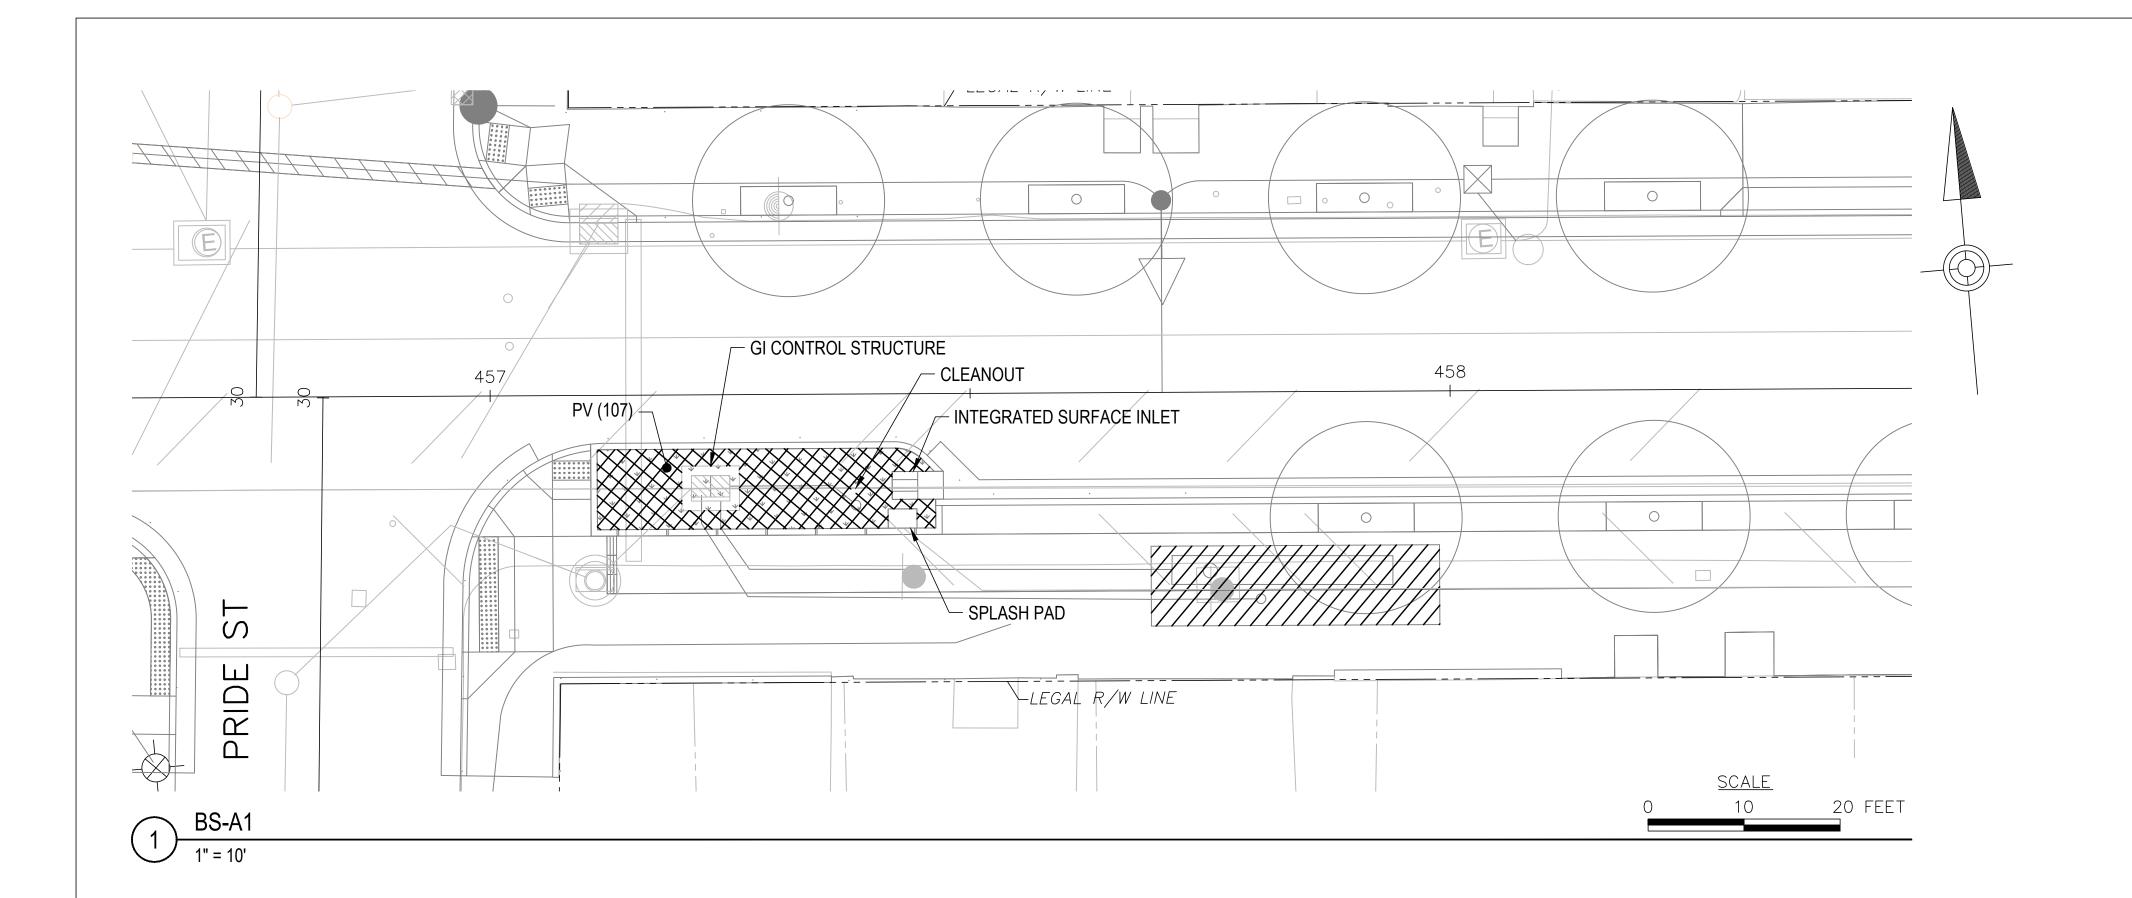

<u>LEGEND</u>

SEE AECOM / KLAVON LANDSCAPE SHEETS FOR TREE TYPES, SIZES AND QUANTITIES.

EXISTING TREE TO BE
REMOVED
(REFER TO AECOM/KLAVON
DRAWINGS)

PROPOSED TREE
(REFER TO AECOM/KLAVON
DRAWINGS)

PROPOSED GI LEGEND

GI BIORETENTION (BR)
OR BIOSWALE (BS)

GI STORAGE TRENCH (ST)

AECOM

Gulf Tower 707 Grant Street 5th Floor Pittsburgh, PA 15219 Jacobs

1550 Coraopolis Heights Road Suite 400 Moon Township, PA 15108

NO. DATE

THE PREPARATION OF THIS

DOCUMENT HAS BEEN FINANCED IN
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TRANSPORTATION, UNDER THE
URBAN MASS TRANSPORTATION ACT
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COUNTY, PENNSYLVANIA.

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SIGNATURE

APPROVED

DESIGNED MG

DRAWN BB

CHECKED SM

IN CHARGE MDA

DATE 03/25/24

SCALE

AS SHOWN


PORT AUTHORITY OF ALLEGHENY COUNTY PENNSYLVANIA


BUS RAPID TRANSIT
GREEN INFRASTRUCTURE
LANDSCAPE PLANS

Port Authority connecting people to life DWG.

DWG. NO. SWM33

3 янт. 33

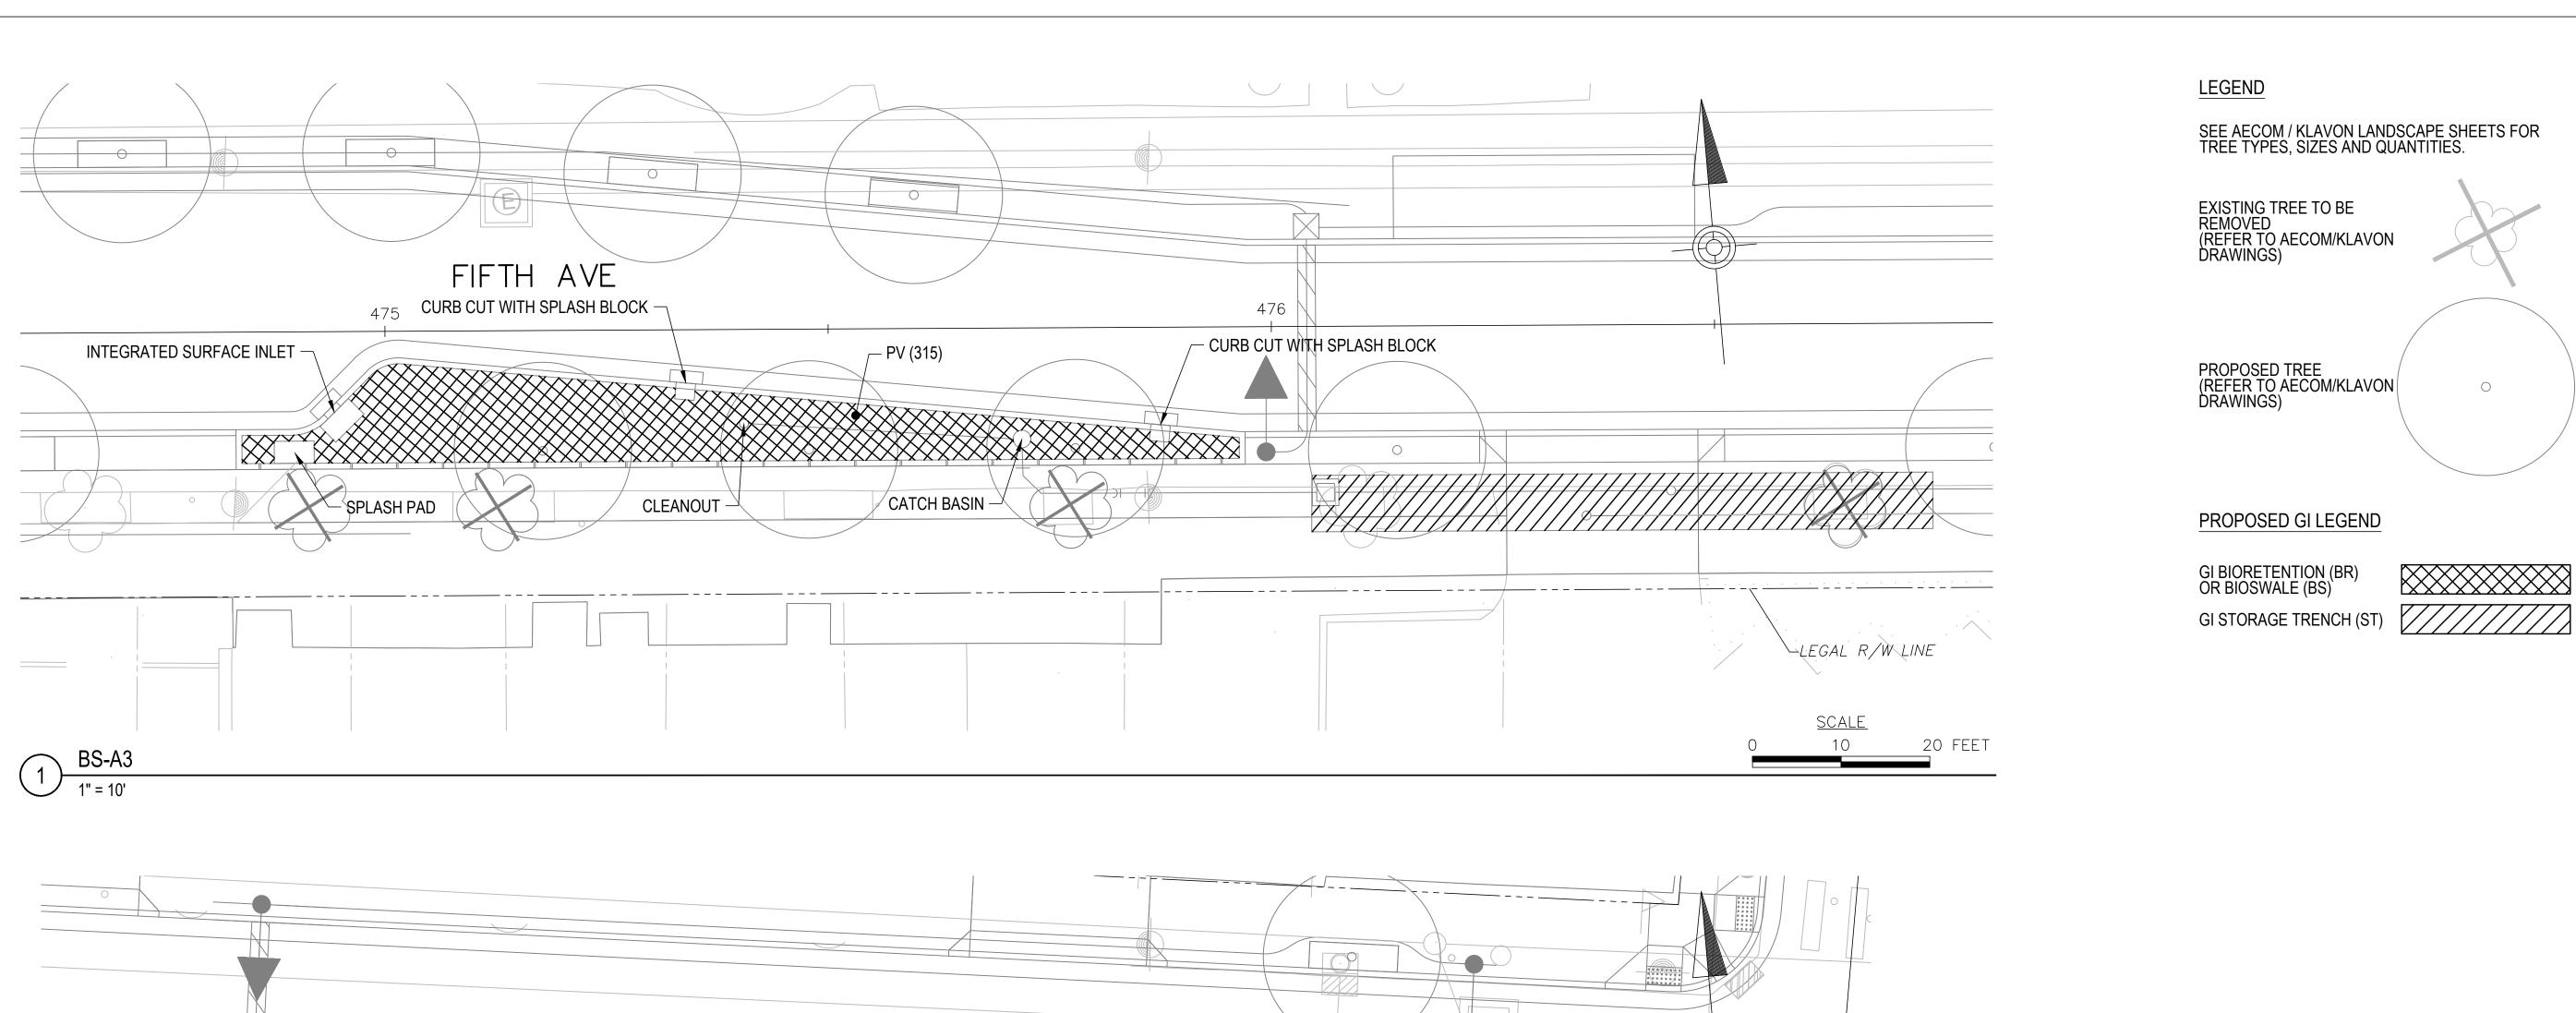

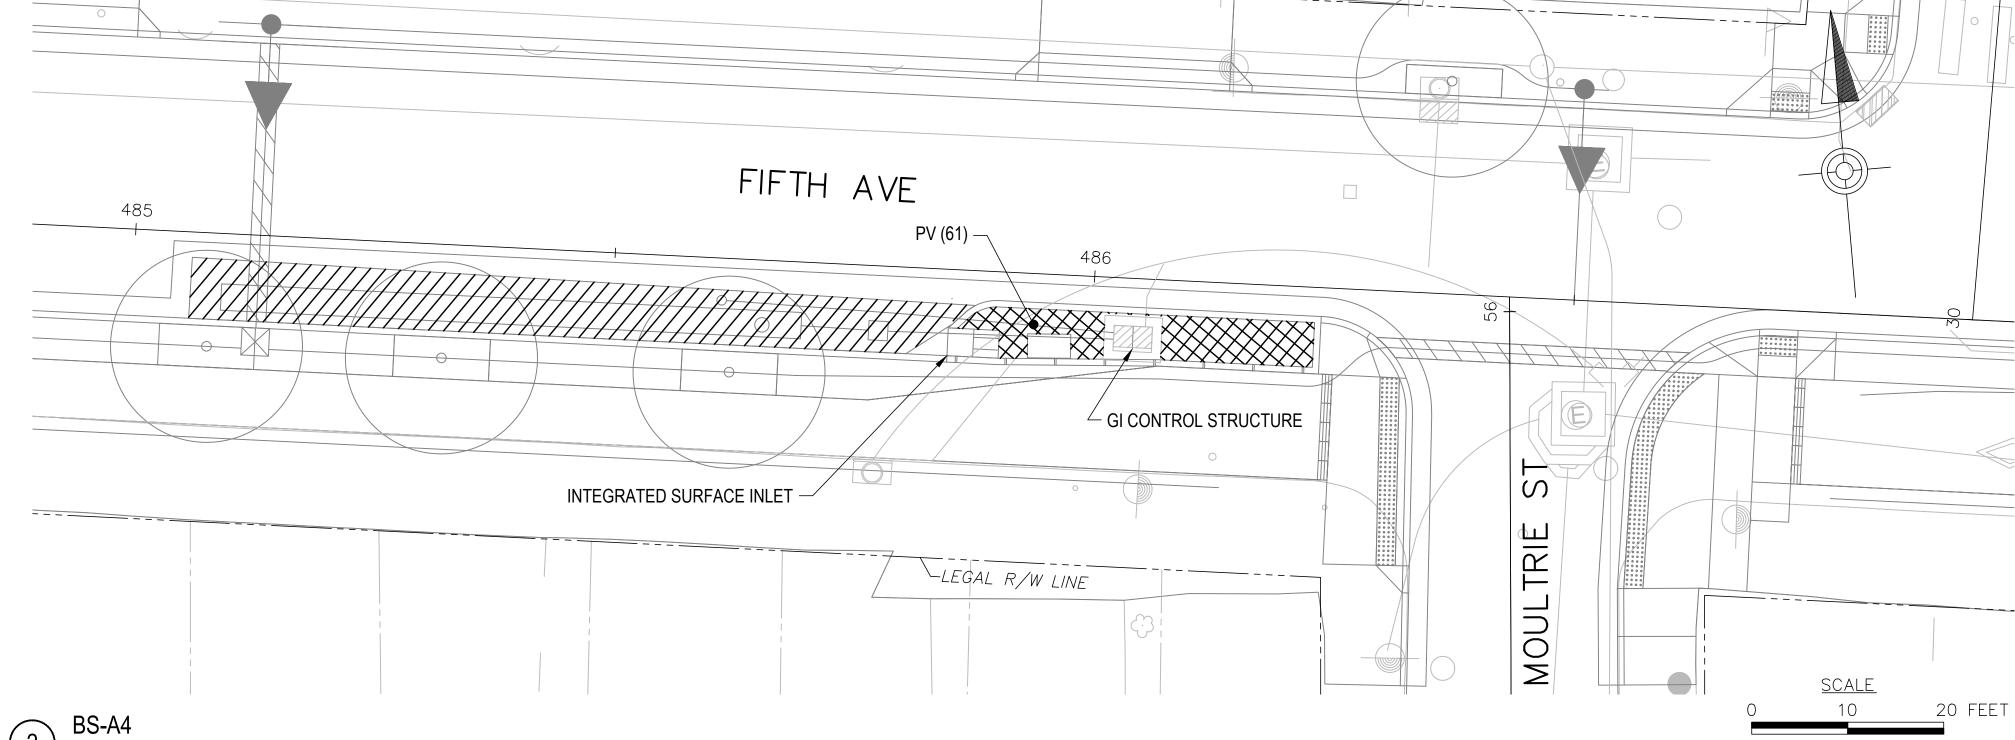

AECOM

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APPROVED

DESIGNED BB DRAWN CHECKED **IN CHARGE** MDA DATE 03/25/24 SCALE AS SHOWN

PORT AUTHORITY OF ALLEGHENY COUNTY PITTSBURGH PENNSYLVANIA BUS RAPID TRANSIT

GREEN INFRASTRUCTURE LANDSCAPE PLANS

Port Authority DWG. NO. SWM34

sнт. **34**

